Notice of Exemption

Appendix E


	Sacramento, CA 95812-3044 County Clerk County of: Sacramento	Folsom, CA 95630
	-	
		(Address)
	ct Title: Greenback Sewer & L	ift Station No.3 Project
Proje	ct Applicant: City of Folsom	
Proje	ct Location - Specific:	
Gre	enback Lane & Folsom-Aubu	rn Road
Proje	ect Location - City: Folsom	Project Location - County: Sacramento
The proj manhole an auto-	es and replacing with a sewer flow vault structure. Work als	
	e of Public Agency Approving Project	
Nam	e of Person or Agency Carrying Out F	Project:
]]]	npt Status: (check one): Ministerial (Sec. 21080(b)(1); 152 Declared Emergency (Sec. 21080(b) Emergency Project (Sec. 21080(b) Categorical Exemption. State type Statutory Exemptions. State code	0(b)(3); 15269(a)); b)(4); 15269(b)(c)); e and section number: Class 2: 15302(c)
The infra	astructure. The project will no	g an existing pump station facility and existing sewer t significantly change the purpose or footprint of the ched project plans for additional details.
	Agency act Person: Nathan Stites	Area Code/Telephone/Extension: 916-461-6167
2	ed by applicant: 1. Attach certified document of exemption been file ature:	otion finding. ed by the public agency approving the project? Yes No Date: 219/2>23 Title: EWR Director
	 Signed by Lead Agency S ity cited: Sections 21083 and 21110, Public I 	Signed by Applicant Resources Code. Date Received for filing at OPR:

ATTACHMENT A PROJECT ENGINEERING PLANS

CITY OF FOLSOM IMPROVEMENT PLANS FOR:

GREENBACK SEWER AND LIFT STATION NO. 3 PROJECT

VOLUME 2: PROJECT DRAWINGS
BID SET DRAWINGS
JANUARY 2023

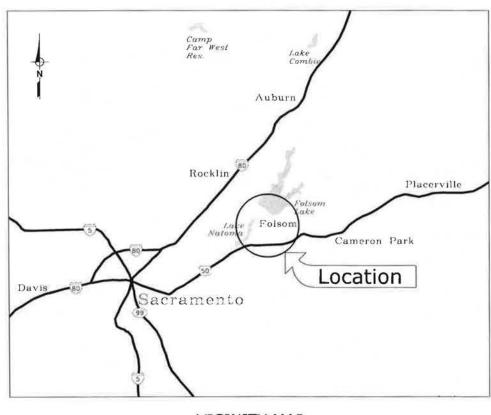






LOCATION MAP

NOT TO SCALE

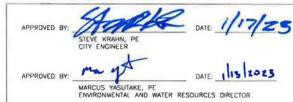



G001

APPROVED BY

No C8947

Eq. (2-3)-24

APPROVED BY

IMPROVEMENT PLANS FOR

Т

PUMP STATION NO. 2 LOCATION: 910 RIVER WAY, FOLSOM, CA. 95630

NO	DESCRIPTION	DATE	ARTER A ST	DESCRIPTION XXXX					
				LATITUDE: XXXXXXX LONGITUDE: XXXXXXX	SCALE HORIZ NA	DRAWN BY:	SMB		CHECKED BY TRB
					VERT NA	DATE:	DATE	R.C.E. C89471 DATE: 6/24/2022	R.C.E. C60715 DATE: 6/20/2022

Water. Engineered.

DWG No.	SHEET No.	DESCRIPTION
GENERA	L	
1	G001	TITLE SHEET, VICINITY MAP AND LOCATION MAP
2	G002	INDEX OF DRAWINGS AND GENERAL NOTES
3	G003	LEGEND, ABBREVIATIONS AND PIPING SYMBOLS
4	G101	BYPASS PLAN
CIVIL		
5	C101	PUMP STATION NO. 3 SITE PLAN
6	C102	YARD PIPING DETAILS
7	C103	SEWER MODIFICATIONS KEY PLAN
8	C104	SEWER MODIFICATIONS PARTIAL PLAN 1
9	C105	SEWER MODIFICATIONS PARTIAL PLAN 2
10	C106	SEWER MODIFICATIONS PARTIAL PLAN 3
11	C107	PIG LAUNCHING CONNECTION PLAN AND SECTION
12	C108	FOLSOM-AUBURN RD/GREENBACK LANE SS MH MODIFICATIONS
13	C109	NEW 3" AIR RELEASE VALVE LOCATIONS AND DETAIL
14	C110	MANHOLE DETAILS
15	C111	BURIED MANHOLE AND AUTOMATIC FLUSHING STATION DETAILS
16	C112	CIVIL PHOTOS
17	C113	CIVIL DETAILS
DEMOLI	TION	
18	D001	PUMP STATION NO. 3 DEMOLITION NOTES
19	D101	EXISTING PUMP STATION NO. 3 SITE CIVIL DEMOLITION PLAN
20	D102	EXISTING PUMP STATION NO. 3 DEMOLITION PLAN
21	D103	EXISTING PUMP STATION NO. 3 DEMOLITION PHOTOS
MECHAN	ICAL	
22	M101	PUMP STATION NO. 3 PIPING PLANS AND SECTIONS
23	M102	HAND WHEEL REHABILITATION






NO.	REVISIONS DESCRIPTION	DATE	ВУ	BENCH MARK ELEV. XXXX DESCRIPTION XXXX	FIELD BOOK			
				LATITUDE: XXXXXXX	SCALE			
				LONGITUDE: XXXXXXX	HORIZ. NA	DRAWN BY: SMB	DESIGN BY: DS	CHECKED BY: TRB
				F =	VERT. NA	DATE: DATE	R.C.E. C89471 DATE: 6/24/2022	R.C.E. C60715 DATE: 6/20/2022


IMPROVEMENT PLANS FOR CT G002

GREENBACK	SEWER	AND	LIFT	STATION	NO.	3	PROJEC
IND	EX OF D	RAWIN	GS AN	D GENERAL	. NOT	ES	

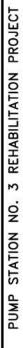





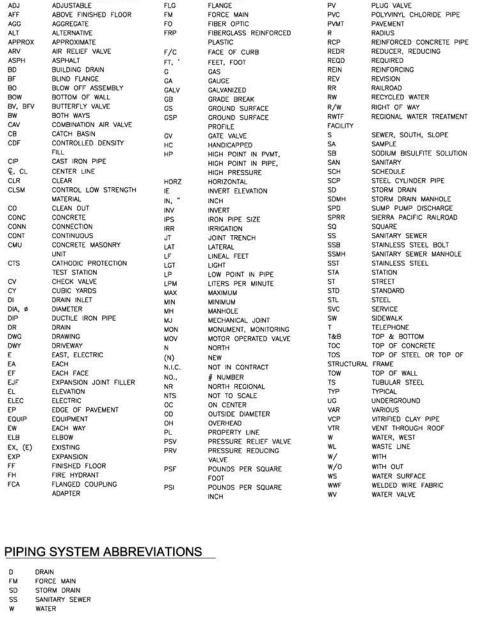

FLOOR CLEANOUT

FLOOR DRAIN

FLOW LINE

ABBREVIATIONS

AGGREGATE BASE

ASPHALT CONCRETE

ASBESTOS CEMENT PIPE

CONCRETE

AC PAVING

ROCK SLOPE PROTECTION

GRAVEL LEVEL SURFACING

CONCENTRIC REDUCER

MECHANICAL JOINT

PRESSURE REGULATING VALVE BACK PRESSURE REGULATING VALVE

DIAPHRAGM OPERATED VALVE

PRESSURE BALANCE OPERATED VALVE

MOTOR OPERATED VALVE

PISTON OPERATED VALVE

FIRE HYDRAN

UTILITY STATION

HOSE BIB VALVE

CHLORINE INSTITUTE CONTAINER VALVE

SOLENOID VALVE

ECCENTRIC REDUCER

- LATERAL DOWN

- \forall -

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GRATING

AB SURFACING

CHECKER PLATED DECK


NATURAL GROUND OR GRADE

REDWOOD TREE


GRANULAR MATERIAL SUCH AS ROCK OR GRAVEL

SECTION & DETAIL DESIGNATIONS

SECTION CUT ON DWG 21

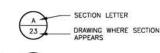

ON DWG 23 THIS SECTION IS IDENTIFIED AS:

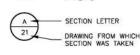

DETAILS ARE CROSS REFERENCED IN A SIMILAR MANNER, EXCEPT THAT DETAILS ARE IDENTIFIED BY NUMBER RATHER THAN LETTER.

PHOTO DETAIL DESIGNATIONS

PUBLIC SERVICE & UTILITY

EASEMENT

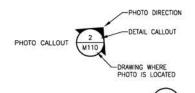


PHOTO DETAIL (M103

FOLSOM

REVISIONS BENCH MARK ELEV. XXXX IELD BOOK DESCRIPTION XXXX SCALE LATITUDE: XXXXXXX CHECKED BY: TRB LONGITUDE: XXXXXXX HORIZ, NA VERT. NA DATE R.C.E. C89471 DATE: 6/24/2022 R.C.E. C60715 DATE: 6/20/2022

EXISTING SPOT ELEVATION

FINISH GRADE SPOT ELEVATION

TEMPORARY SURVEY MONUMENT

PERMANENT SURVEY MONUMENT

EXISTING OVERHEAD ELECTRIC

GROOVED END ADAPTER FLANGE

ELASTOMER & FABRIC EXPANSION
JOINT

FLEXIBLE METAL HOSE

ELBOW UP

EXPANSION JOINT (SEE SPECS

GAUGE OR ROOT VALVE

—III— KNIFE GATE VALVE

FLAP GATE

HOSE VALVE

-IV- BALANCING VALVE

-CIRCUIT SETTER

THERMOSTATICALLY CONTROLLED VALVE

PRESSURE & VACUUM RELIEF VALVE

VACUUM RELIEF VALVE

PRESSURE RELIEF VALVE

IN-LINE, SPRING LOADED RELIEF VALVE

EXISTING STORM DRAIN

RIGHT-OF-WAY

NEW PIPELINE UNDER CONCRETE OR AC

RESTRAINED FLANGED COUPLING HOTH TEE UP

EXISTING PIPELINE

110.50

─(12" W)-

(N)

SINGLE LINE DOUBLE LINE

~~~

- DIAPHRAGM VALVE

ANGLE VALVE

- FLOAT VALVE

PINCH VALVE

-IV- NEEDLE VALVE

CHECK VALVE

No. C89471 Exp. 12-31-24

PUMP DISCHARGE VALVE

-K- DOUBLE LEAF CHECK VALVE

LEGEND

**LEGEND - PIPING** 

THREE WAY VALVE

— GATE VALVE (NORMALLY OPEN)

PLUG VALVE (NORMALLY OPEN)

BALL VALVE (NORMALLY OPEN)

BALL VALVE (NORMALLY CLOSED)

WEST YOST

Water. Engineered.

- BUTTERFLY VALVE

GLOBE VALVE

PLUG VALVE (NORMALLY

GATE VALVE (NORMALLY CLOSED)

CLOSED)

SINGLE LINE DOUBLE LINE

EXISTING FENCE

EXISTING GRADE CONTOURS

NEW GRADE CONTOURS

EXISTING FACILITY

NEW FACILITY

CENTERLINE

DIRECTION OF FLOW

EXISTING EASEMENT

PROPOSED NEW FASEMENT

PLAIN OR GROOVED END MECHANICAL COUPLING

WELDED JOINT

- FLANGED COUPLING ADAPTER

DEMOLISH

FLANGED JOINT


NEW FENCE

IMPROVEMENT PLANS FOR

GREENBACK SEWER AND LIFT STATION NO. 3 PROJECT LEGEND, ABBREVIATIONS AND PIPING SYMBOLS

G003 3 OF 23



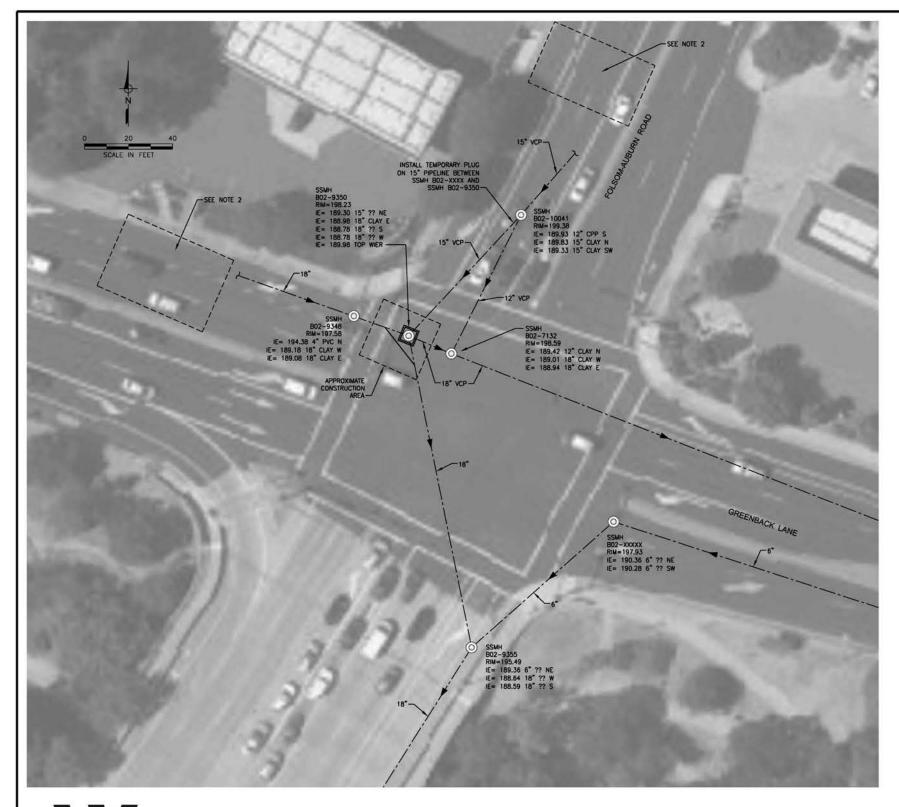

### NOTES

- CONTRACTOR MAY PROPOSE ANOTHER BYPASS SYSTEM, SUCH AS BYPASS PUMPING, WITH APPROVAL BY THE CITY OF FOLSOM.
- PEDESTRIAN AND VEHICULAR ACCESS:
   A THE BYPASS SYSTEM SHALL BE ADEQUATELY PROTECTED AND LOCATED TO MINIMIZE DISRUPTION TO VEHICLE AND PEDESTRIAN TRAFFIC.
- B. AT LOCATIONS WHERE BYPASS PIPING CROSSES ROADWAYS, THE PIPING SHALL BE PLACED IN TRENCHES CONSTRUCTED BY THE CONTRACTOR. TRENCHES SHALL BE PLATED WITH NON-SKID PLATES THAT ARE STAKED AND WELDED TOGETHER TO ALLOW TRAFFIC TO CROSS UNIWEDED. AFTER REMOVING PIPE FROM TRENCH, RESTORE TO ORIGINAL CONDITIONS.
- C. TEMPORARY FENCING AND SIGNAGE SHALL BE PROVIDED TO PREVENT UNAUTHORIZED ACCESS.
- D. MAINTAIN MINIMUM OF ONE LANE OF TRAFFIC DURING NIGHT-TIME WORK HOURS. ALL LANES SHALL BE OPEN AT ALL OTHER TIMES.

| FLOW LOCATION | AVERAGE DRY<br>WEATHER FLOW, MGD | WET WEATHER<br>PEAK FLOW, MGD |
|---------------|----------------------------------|-------------------------------|
| SSMHB02-10041 | 0.6                              | 2.77                          |
| SSMH02-9348   | 0.28                             | 0.72                          |



FOLSOM DISTRICTIVE AV NATURE


| NO. | DESCRIPTION | DATE E | DESCRIPTION        | -            |               |                               |                               |
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|     |             |        | LATITUDE: XXXXXXX  | SCALE        |               |                               |                               |
|     |             |        | LONGITUDE: XXXXXXX | HORIZ, 1"=20 | DRAWN BY: SMB | DESIGN BY: DS                 | CHECKED BY: TRB               |
|     |             |        |                    | VERT. NA     | DATE: DATE    | R.C.E. C89471 DATE: 6/24/2022 | R.C.E. C60715 DATE: 6/20/2022 |

IMPROVEMENT PLANS FOR

GREENBACK SEWER AND LIFT STATION NO. 3 PROJECT BYPASS PLAN





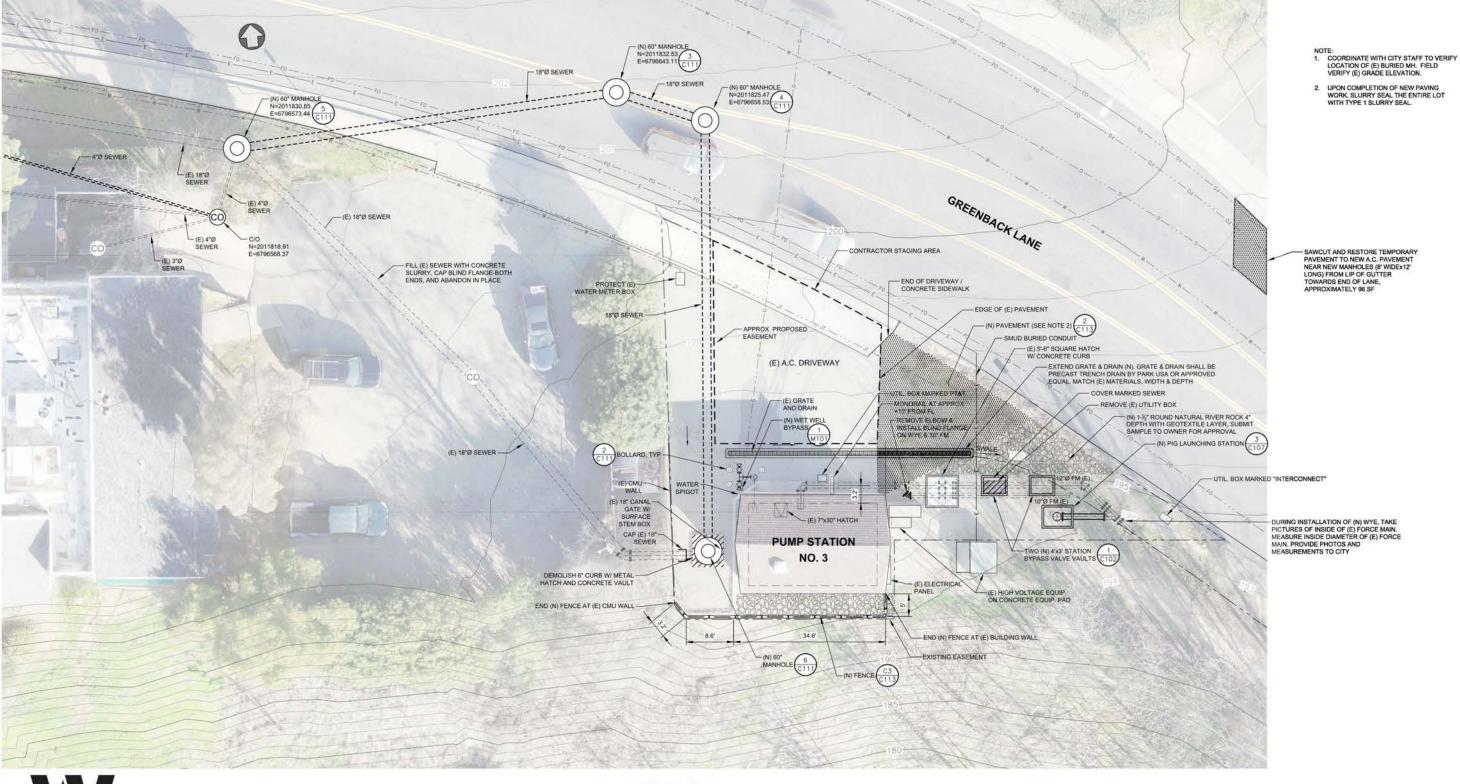



SITE PLAN SCALE: 1" = 8"


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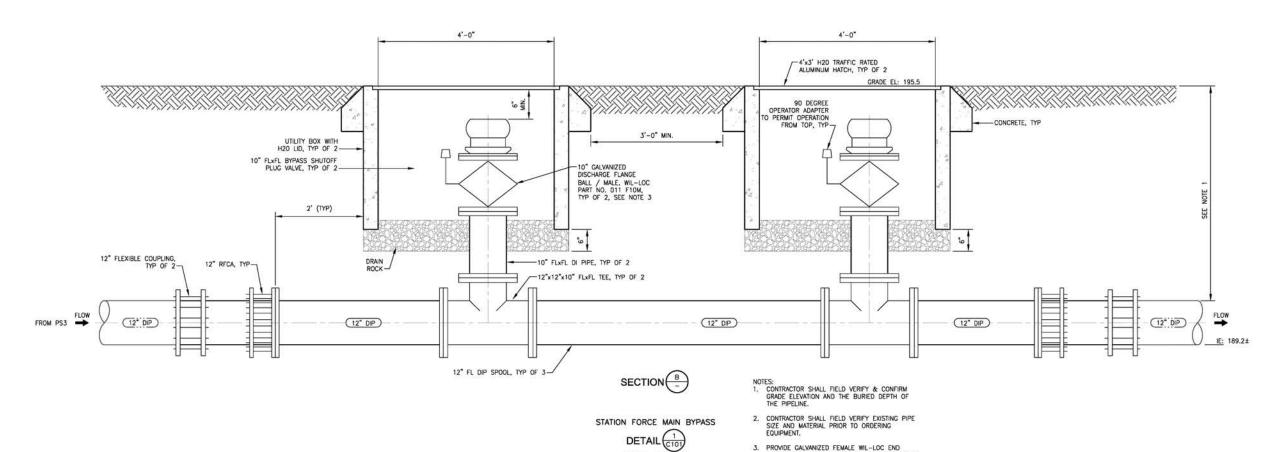
| NO. | REVISIONS<br>DESCRIPTION | DATE | BY | BENCH MARK ELEV. XXXX DESCRIPTION XXXX  | FIELD BOOK         |           |      |                               |                               |
|-----|--------------------------|------|----|-----------------------------------------|--------------------|-----------|------|-------------------------------|-------------------------------|
|     |                          |      |    | LATITUDE: XXXXXXX<br>LONGITUDE: XXXXXXX | SCALE<br>HORIZ, 8° | DRAWN BY: | SMB  | DESIGN BY: DS                 | CHECKED BY: TRB               |
|     |                          |      |    |                                         | VERT. NA           | DATE:     | DATE | R.C.E. C89471 DATE: 6/24/2022 | R.C.E. C60715 DATE: 6/20/2022 |

IMPROVEMENT PLANS FOR

GREENBACK SEWER AND LIFT STATION NO. 3 PROJECT PUMP STATION NO. 3 SITE PLAN

C101 5 OF 23



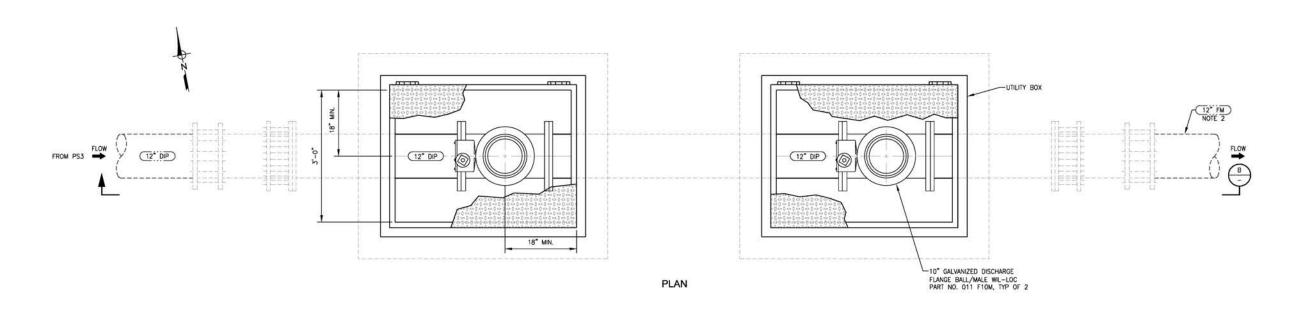

SCALE: 1"=1'-0"

 PROVIDE GALVANIZED FEMALE WILL-LOC END PLUG, PART NO. 101 EC10 CAP AT THE END OF THE CONNECTOR, TYPICAL OF 2.



FOLSOM


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|     |                          |      |    | LATITUDE: XXXXXXX                      | SCALE      |           |      |                               |                               |
|     |                          |      |    | LONGITUDE: XXXXXXX                     | HORIZ, XXX | DRAWN BY: | SMB  | DESIGN BY: DS                 | CHECKED BY: TRB               |
|     |                          |      |    |                                        | VERT. NA   | DATE:     | DATE | R.C.E. C89471 DATE: 6/24/2022 | R.C.E. C60715 DATE: 6/20/2022 |

IMPROVEMENT PLANS FOR

GREENBACK SEWER AND LIFT STATION NO. 3 PROJECT YARD PIPING DETAILS

C102 6 or 23



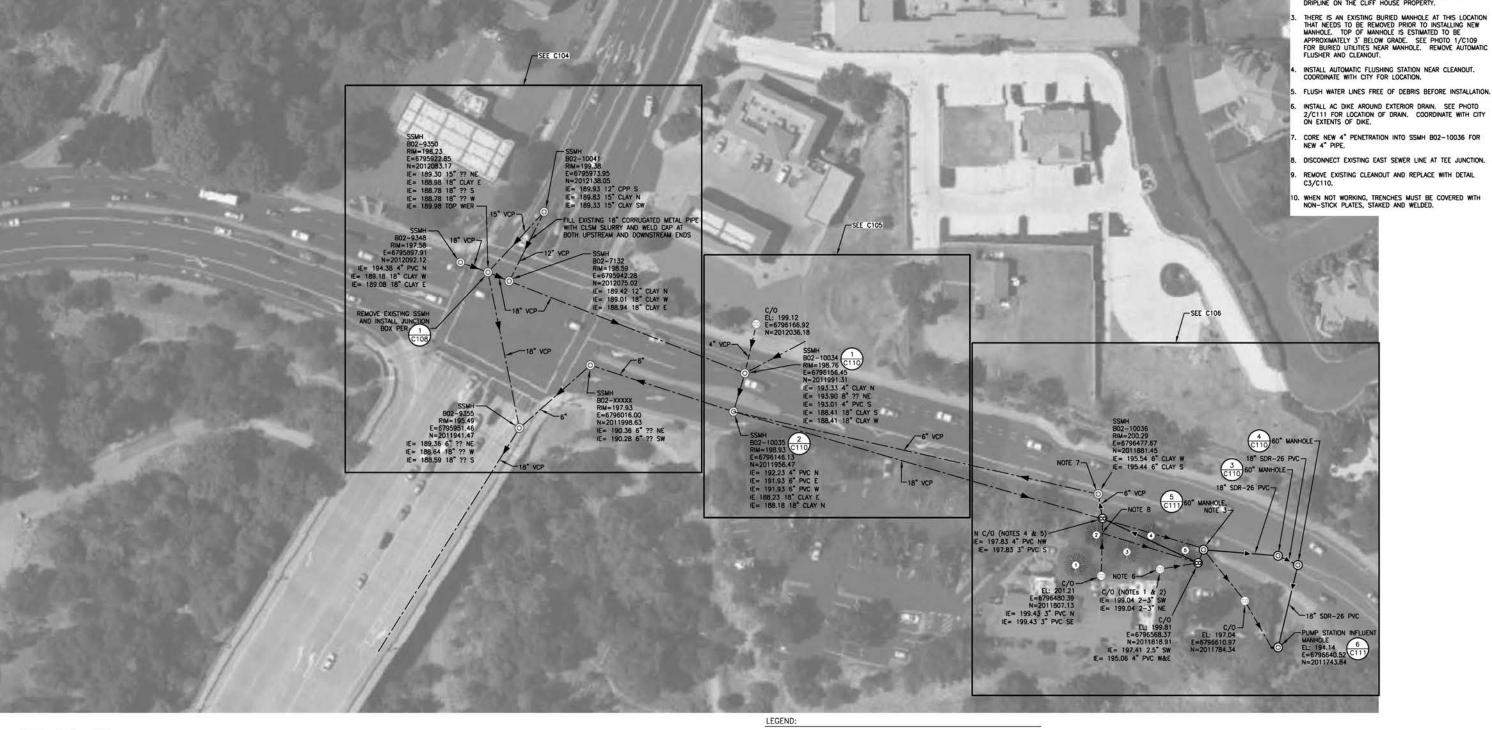

WEST YOST Water. Engineered.

REDWOOD TREE

SCALE IN FEET


FOLSOM

| NO. | REVISIONS<br>DESCRIPTION | DATE | BY | BENCH MARK ELEV. XXXX DESCRIPTION XXXX | FIELD BOOK    |           |      |                               |                               |
|-----|--------------------------|------|----|----------------------------------------|---------------|-----------|------|-------------------------------|-------------------------------|
|     |                          |      |    | LATITUDE: XXXXXXX                      | SCALE         |           |      |                               |                               |
|     |                          |      |    | LONGITUDE: XXXXXXX                     | HORIZ, 1"=40" | DRAWN BY: | SMB  | DESIGN BY: DS                 | CHECKED BY: TRB               |
|     |                          |      |    |                                        | VERT. NA      | DATE:     | DATE | R.C.E. C89471 DATE: 6/24/2022 | R.C.E. C60715 DATE: 6/20/2022 |

IMPROVEMENT PLANS FOR

GREENBACK SEWER AND LIFT STATION NO. 3 PROJECT **EXISTING AND ALTERNATE SERVICE LATERAL LOCATIONS** 

C103 7 oF 23

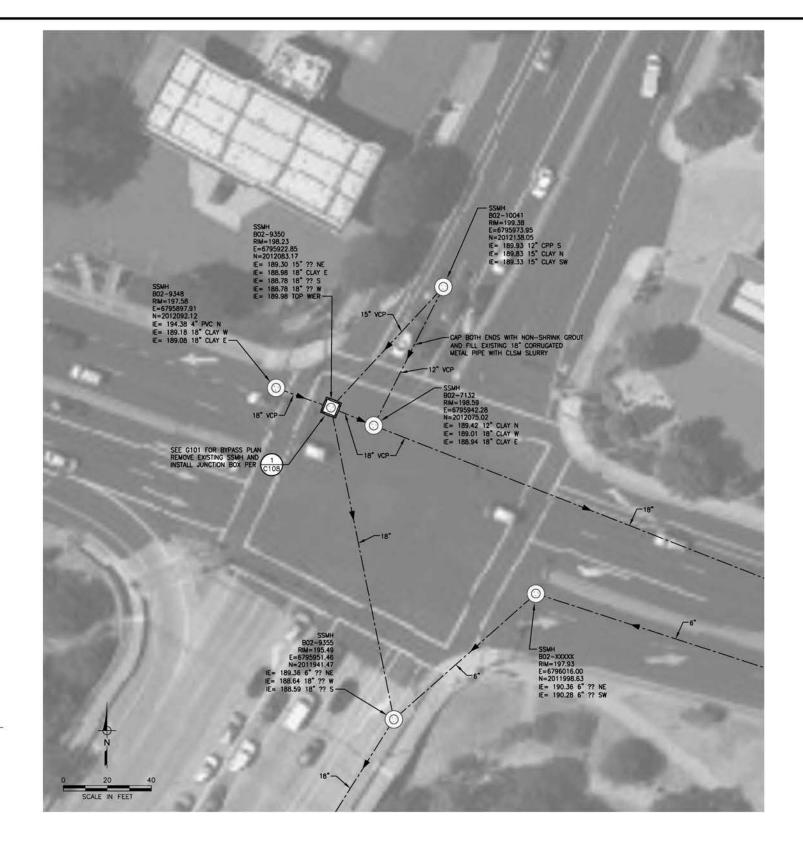





| NO. | DESCRIPTION | DATE | BY | DESCRIPTION XXXX                        | TILLED BOOK            |           |      |                               |                               |
|-----|-------------|------|----|-----------------------------------------|------------------------|-----------|------|-------------------------------|-------------------------------|
|     |             |      |    | LATITUDE: XXXXXXX<br>LONGITUDE: XXXXXXX | SCALE<br>HORIZ, 1"=20" | DRAWN BY: | SMB  | DESIGN BY: DS                 | CHECKED BY: TRB               |
|     |             |      |    | (1) (1) (1) (1) (1) (1) (1) (1) (1) (1) | VERT. NA               | DATE:     | DATE | R.C.E. C89471 DATE: 6/24/2022 | R.C.E. C60715 DATE:6/209/2022 |

NEW SEWER LATERAL

NEW SEWER PIPE (SIZE AS INDICATED)
SANITARY SEWER MANHOLE
SEWER CLEANOUT


IMPROVEMENT PLANS FOR

GREENBACK SEWER AND LIFT STATION NO. 3 PROJECT

SEWER MODIFICATIONS PARTIAL PLAN 1

SHEET C104

8 of 23

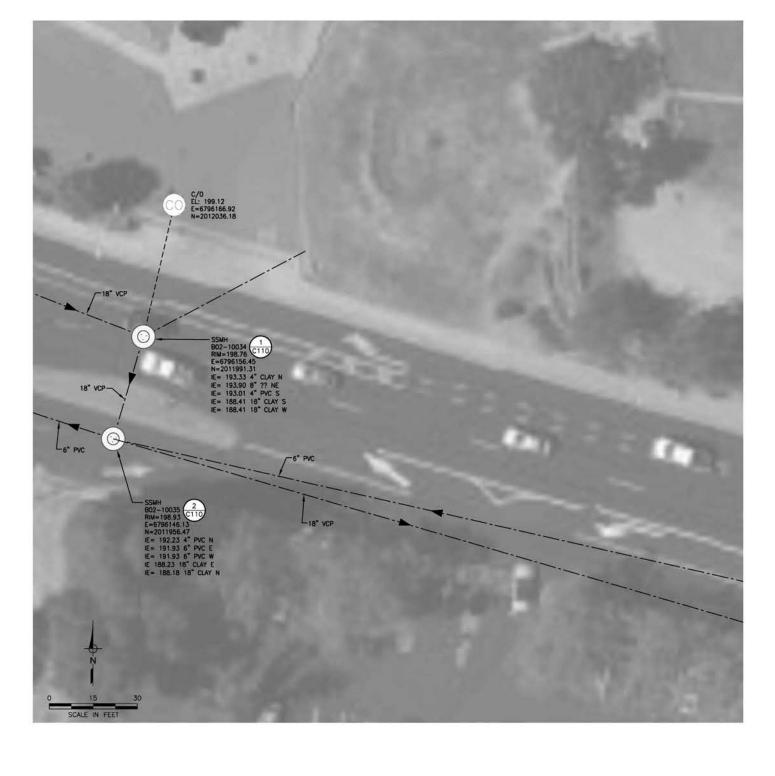



EXISTING SEWER LATERAL

EXISTING SS PIPE

NEW SEWER LATERAL

NEW SEWER PIPE (SIZE AS INDICATED)

SANITARY SEWER MANHOLE

SEWER CLEANOUT





| NO. | REVISIONS<br>DESCRIPTION | DATE | BY | BENCH MARK ELEV. XXXX DESCRIPTION XXXX  | FIELD BOOK             |           |      |                               |                               |
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|     |                          |      |    | LATITUDE: XXXXXXX<br>LONGITUDE: XXXXXXX | SCALE<br>HORIZ, 1"=15" | DRAWN BY: | SMB  | DESIGN BY: DS                 | CHECKED BY: TRB               |
|     |                          |      |    |                                         | VERT. NA               | DATE:     | DATE | R.C.E. C89471 DATE: 6/24/2022 | R.C.E. C60715 DATE: 6/20/2022 |

IMPROVEMENT PLANS FOR

GREENBACK SEWER AND LIFT STATION NO. 3 PROJECT

SEWER MODIFICATIONS PARTIAL PLAN 2


SHEET C105
9 OF 23

- NOTES:

  1. DIGGING ON AND AROUND CLIFF HOUSE PROPERTY SHALL BE COMPLETED USING HAND DIGGING METHODS ONLY.
- A THIRD PARTY CERTIFIED ARBORIST SHALL BE REQUIRED TO BE ON SITE WHEN WORKING IN OR NEAR THE TREE DRIPLINE ON THE CLIFF HOUSE PROPERTY.
- 3. THERE IS AN EXISTING BURIED MANHOLE AT THIS LOCATION THAT NEEDS TO BE REMOVED PRIOR TO INSTALLING NEW MANHOLE. TOP OF MANHOLE IS ESTIMATED TO BE APPROXIMATELY 3' BELOW GRADE. SEE PHOTO 1/C112 FOR BURIED UTILITIES NEAR MANHOLE. REMOVE AUTOMATIC FLUSHER
- 4. INSTALL AUTOMATIC FLUSHING STATION NEAR CLEANOUT. COORDINATE WITH CITY FOR LOCATION.
- 5. FLUSH WATER LINES FREE OF DEBRIS BEFORE INSTALLATION.
- INSTALL AC CURB AROUND EXTERIOR DRAIN. SEE PHOTO 2/C112 FOR LOCATION OF DRAIN. COORDINATE WITH CITY ON EXTENTS OF CURB.
- 7. CORE NEW 4" PENETRATION INTO SSMH B02-10036 FOR NEW 4" PIPE.
- 8. DISCONNECT EXISTING EAST SEWER LINE AT TEE JUNCTION..
- 9. REMOVE EXISTING CLEANOUT AND REPLACE WITH DETAIL C3/C113.
- 10. ONE LANE OF TRAFFIC IN EITHER DIRECTION MUST BE OPEN AT ALL TIMES.

- 11. ANY ON-SITE WORK ASSOCIATED WITH THE PROJECT WHICH TAKES PLACE UNDERNEATH DRIPLINE OF TREES AT 9900 GREENBACK LANE SHALL CONFORM TO THE FOLLOWING:
- a. CITY WILL HAVE AN ARBORIST ON-SITE DURING EXCAVATION.
- THE ARBORIST WILL MONITOR THE HEALTH OF THE TREES TO BE PRESERVED AND ENSURE APPROPRIATE TREE MANAGEMENT ACTIONS TAKE PLACE IN ACCORDANCE WITH THE MOST RECENT VERSION OF THE INTERNATIONAL SOCIETY OF ARBORCULTURE'S BEST MANAGEMENT PRACTICES "MANAGING TREES DURING CONSTRUCTION" AND THE CITY OF FOLSOM'S TREE CARE AND
- c. ALL CONSTRUCTION ACTIVITIES WITHIN THE CRITICAL ROOT ZONE (CRZ) OF TREES SHALL BE PERFORMED UNDER THE DIRECT SUPERVISION OF THE PROJECT ARBORIST.
- d. EXCAVATION WITHIN THE CRZ OF EXISTING TREES SHALL BE PERFORMED VIA HYDRO VACUUM EXCAVATION OR AIR SPADE UNDER THE DIRECT SUPERVISION OF A QUALIFIED PROJECT ARBORIST. ANY NECESSARY ROOT PRUNING FOLLOWING THE EXCAVATION ACTIVITIES SHALL BE PERFORMED WITH SHARP, STERILE HAND TOOLS. ROOTS THAT HAVE BEEN RIPPED, TORN, OR CRUSHED SHALL BE TRACED TO UNDAMAGED TISSUE AND CUT CLEANLY, RESULTING IN A FLAT SURFACE WITH THE ADJACENT BARK FIRMLY ATTACHED.
- ROOTS EXPOSED FROM GRADE CUTS OR TRENCHING SHALL NOT BE ALLOWED TO DRY OUT. THE CUT FACES OF OPEN TRENCHES SHALL BE WET DOWN EVERY 24 HOURS UNTILL BACKFILLED TO PREVENT ROOT DESICCATION. IF ROOTS WILL BE EXPOSED OVERNIGHT OR IF DIRECTED BY THE PROJECT ARBORIST, THE CUT FACES SHALL BE MOISTENED AND COVERED
- f. FOLLOWING BACKFILL OF THE TRENCH, THE AREA SHALL BE THOROUGHLY HAND IRRIGATED.
- ANY PRUNING FOR CONSTRUCTION CLEARANCE SHALL BE PERFORMED BY OR UNDER THE DIRECT SUPERVISION OF THE PROJECT ARBORIST.
- h. THE FOLLOWING ACTIONS ARE PROHIBITED WITHIN THE CRZ:
- PARKING OF VEHICLES, EQUIPMENT, OR STORAGE OF MATERIAL, UNLESS OTHERWISE APPROVED BY THE CITY OF FOLSOM.
- WOUNDING OR BREAKING TREE TRUNKS OR BRANCHES THROUGH CONTACT WITH VEHICLES OR HEAVY EQUIPMENT.
- iii. CONTAMINATION OF SOIL BY WASHING OUT EQUIPMENT OR CONDUCTING VEHICLE MAINTENANCE.
- A CERTIFIED LETTER BY THE PROJECT ARBORIST ATTESTING COMPLIANCE WITH THESE REQUIREMENTS SHALL BE SUBMITTED TO THE CITY AND THE OWNER OF 9900 GREENBACK LANE UPON PROJECT COMPLETION.
- CRZ MEANS THE AREA OF SOIL EXTENDING FROM THE TREE TRUNK WHERE ROOTS REQUIRED FOR FUTURE TREE HEALTH AND SURVIVAL ARE LOCATED. THIS CRITICAL ROOT ZONE AREA FOR ALL TREES EXCEPT HERITAGE TREES IS A CIRCLE WITH A MINIMUM RADIUS OF ONE FOOT FOR EVERY ONE INCH IN TRUNK DIAMETER BREAST HIGH (DBH). REFER TO FIGURE 1/C113.
- k. FOR HERITAGE TREES, THE CRITICAL ROOT ZONE AREA SHALL BE A CIRCLE WITH A MINIMUM RADIUS OF ONE AND ONE—HALF FEET FOR EVERY ONE INCH IN TRUNK DIAMETER AT DSH, UNLESS REDUCED BY THE PROJECT ARBORIST. REFER TO FIGURE 2/C113.



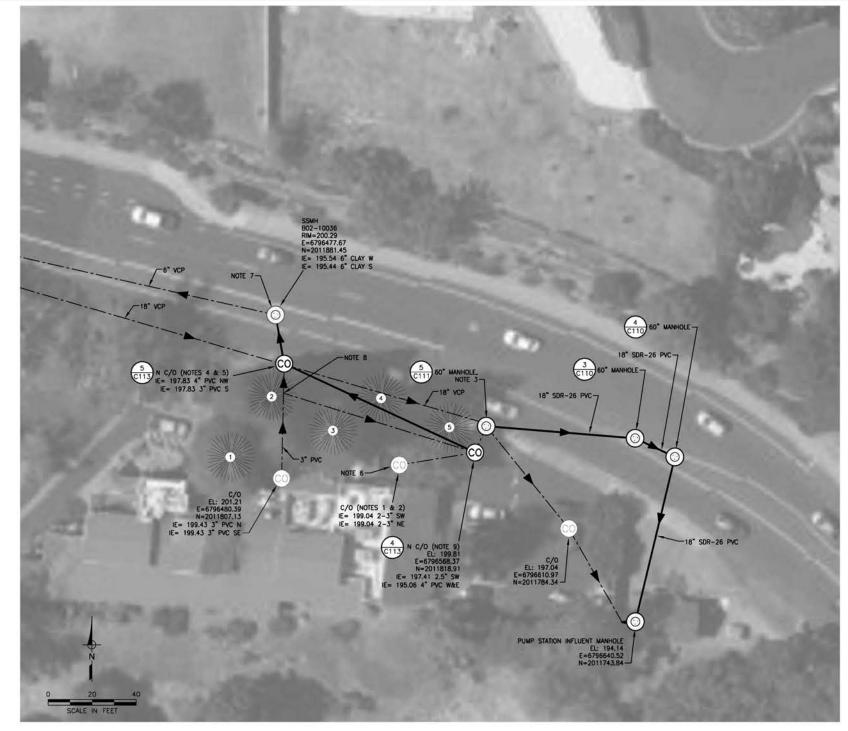

|   | EXISTING SEWER LATERAL             |
|---|------------------------------------|
|   | EXISTING SS PIPE                   |
|   | NEW SEWER LATERAL                  |
|   | NEW SEWER PIPE (SIZE AS INDICATED) |
| 0 | SANITARY SEWER MANHOLE             |
| @ | SEWER CLEANOUT                     |
|   | REDWOOD TREE                       |




REVISIONS BENCH MARK ELEV. XXXX IELD BOOK DESCRIPTION XXXX SCALE LATITUDE: XXXXXXX CHECKED BY: TRB LONGITUDE: XXXXXXX HORIZ. 1"=20" DRAWN BY: SMB VERT. NA DATE: DATE R.C.E. C89471 DATE: 6/24/2022 R.C.E. C60715 DATE: 6/20/2022


IMPROVEMENT PLANS FOR

GREENBACK SEWER AND LIFT STATION NO. 3 PROJECT SEWER MODIFICATIONS PARTIAL PLAN 3

C106 10<sub>0F</sub>23



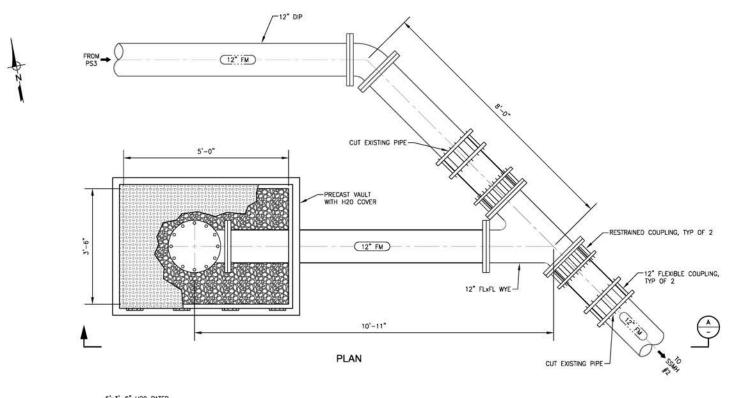

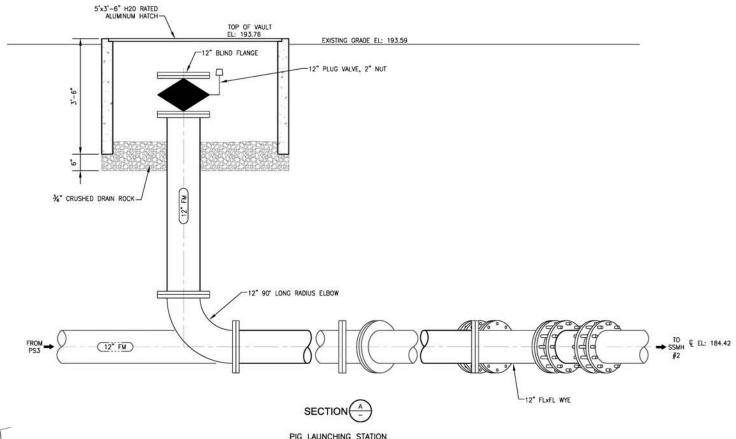

WEST YOST
Water. Engineered.

PIG LAUNCHING STATION

DETAIL 6
C101

SCALE: 3/4"=1"-0"

REVISIONS
DESCRIPTION
DATE BY

DESCRIPTION

XXXX

LATITUDE: XXXXXXXX

LONGITUDE: XXXXXXXX

LONGITUDE: XXXXXXXX

VERT. NA

DATE: DATE


R.C.E. C89471 DATE: 6/24/2022 R.C.E. C60715 DATE: 6/20/2022

IMPROVEMENT PLANS FOR

GREENBACK SEWER AND LIFT STATION NO. 3 PROJECT PIG LAUNCHING CONNECTION PLAN & SECTION

SHEET C107

FOLSOM

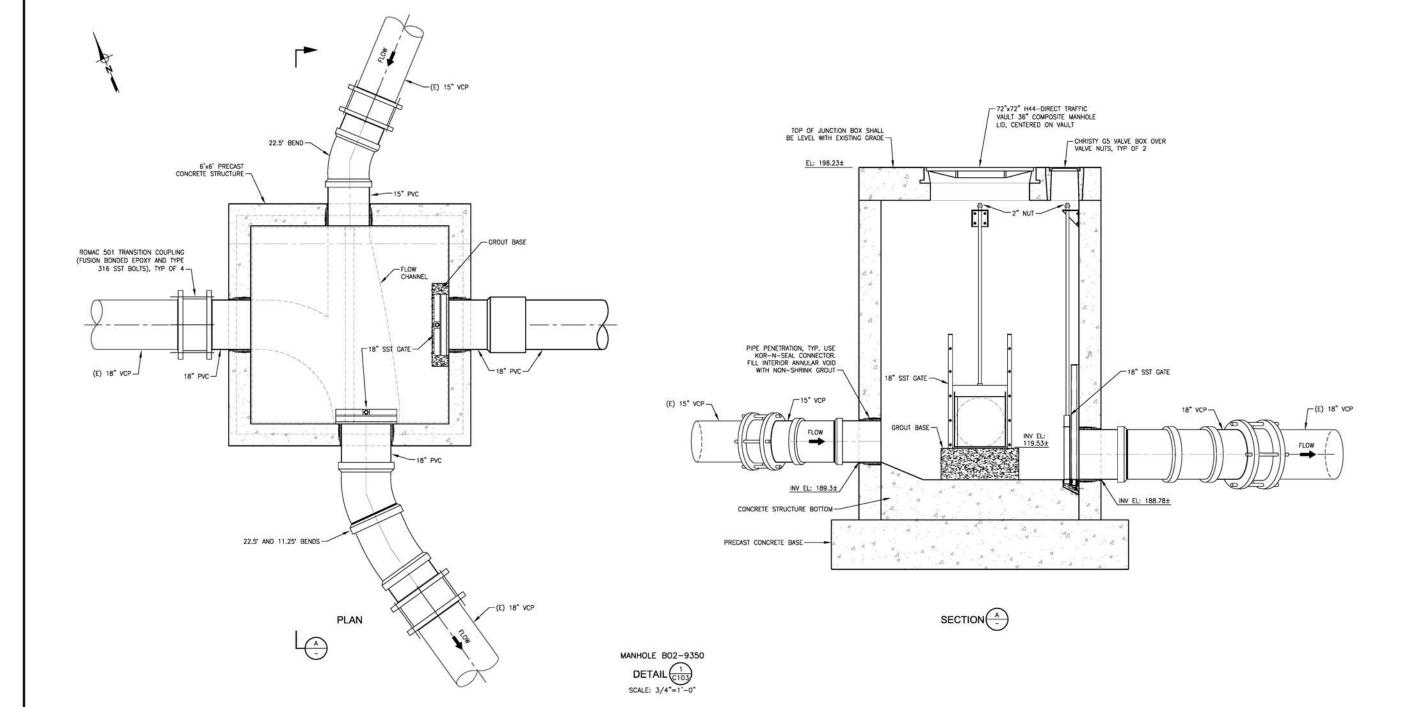






| NO. | REVISIONS<br>DESCRIPTION | DATE | BENCH MARK ELEV. XXXX DESCRIPTION XXXX  | FIELD BOOK                       |                    |             |                                                |                                                  |
|-----|--------------------------|------|-----------------------------------------|----------------------------------|--------------------|-------------|------------------------------------------------|--------------------------------------------------|
|     |                          |      | LATITUDE: XXXXXXX<br>LONGITUDE: XXXXXXX | SCALE<br>HORIZ, 1/2"<br>VERT, NA | DRAWN BY:<br>DATE: | SMB<br>DATE | DESIGN BY: DS<br>R.C.E. C89471 DATE: 6/24/2022 | CHECKED BY: TRB<br>R.C.E. C60715 DATE: 6/20/2022 |

IMPROVEMENT PLANS FOR

GREENBACK SEWER AND LIFT STATION NO. 3 PROJECT FOLSOM-AUBURN RD/GREENBACK LANE SS MH MODIFICATIONS

| SHEET               |
|---------------------|
| C108                |
| 12 <sub>OF</sub> 23 |

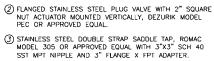


LEGEND:

SST MPT NIPPLE AND 3" FLANGE X FPT ADAPTER.

(4) STAINLESS STEEL SUPPORT BAND—SECURE TO ARV AND SIDEWALL OF SSMH.


 $\bigodot$  arv to be a.r.i. D-020 combination air valve or approved equal.

- (5) LONG RADIUS ELBOW, SAME AS PIPE MATERIAL.
- 6 SCH 40 STAINLESS STEEL PIPE, WRAPPED WITH 20
- TSTANDARD MASONRY SUPPORT (BRICK)
- SSMH CONE 60"X36"X36"
- ③ ¾" CRUSHED ROCK, FILL TO BOTTOM OF SSMH CONE
- @ GMI COMPOSITE FRAME & COVER, OR APPROVED EQUAL
- (3") GRADE RING AS NEEDED
- $\ensuremath{ \begin{tabular}{llll} \begin{tabular}{llll} \begin{tabular}{lllll} \begin{tabular}{llllll} \begin{tabular}{lllll} \begin{tabular}{lllll} \begin{tabular}{llllll} \begin{tabular}{lllll} \begin{tabular}{llllll} \begin{tabular}{llllll} \begin{tabular}{lllll} \begin{tabular}{lllll} \begin{tabular}{lllll} \begin{tabular}{llllll} \begin{tabular}{lllll} \begin{tabular}{lllll} \begin{tabular}{lllll} \begin{tabular}{llllll} \begin{tabular}{lllll} \begin{tabular}{lllll} \begin{tabular}{lllll} \begin{tabular}{llllll} \begin{tabular}{lllll} \begin{tabular}{llllll} \begin{tabular}{lllll} \begin{tabular}{lllll} \begin{tabular}{lllll} \$

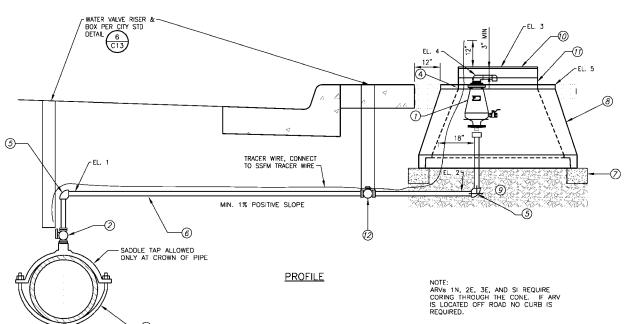

ARV'S AT INVERT ELEVATIONS 188.6, 184.0, 183.9

DETAIL 1

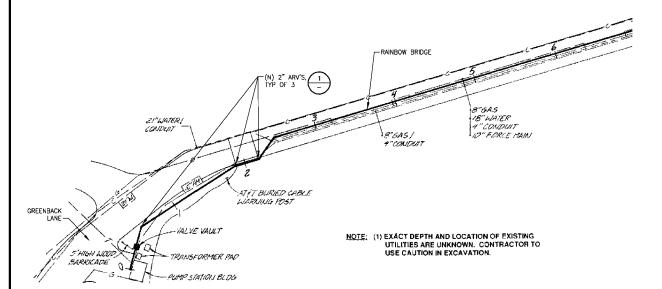

200

190

180

170

160

WEST YOST

Water. Engineered.



REVISIONS
DESCRIPTION

DATE BY

BENCH MARK ELEV. XXXX
DESCRIPTION

XXXX
LATITUDE: XXXXXXXX
LONGITUDE: XXXXXXXX
LONGITUDE: XXXXXXXX
VERT. NA

DATE: DATE

DATE: DATE


R.C.E. C89471 DATE: 6/24/2022 R.C.E. C60715 DATE: 6/20/2022

8810H

IMPROVEMENT PLANS FOR

GREENBACK SEWER AND LIFT STATION NO. 3 PROJECT
NEW 3" AIR RELEASE VALVE LOCATIONS AND DETAIL

SHEET C109 13 OF 23

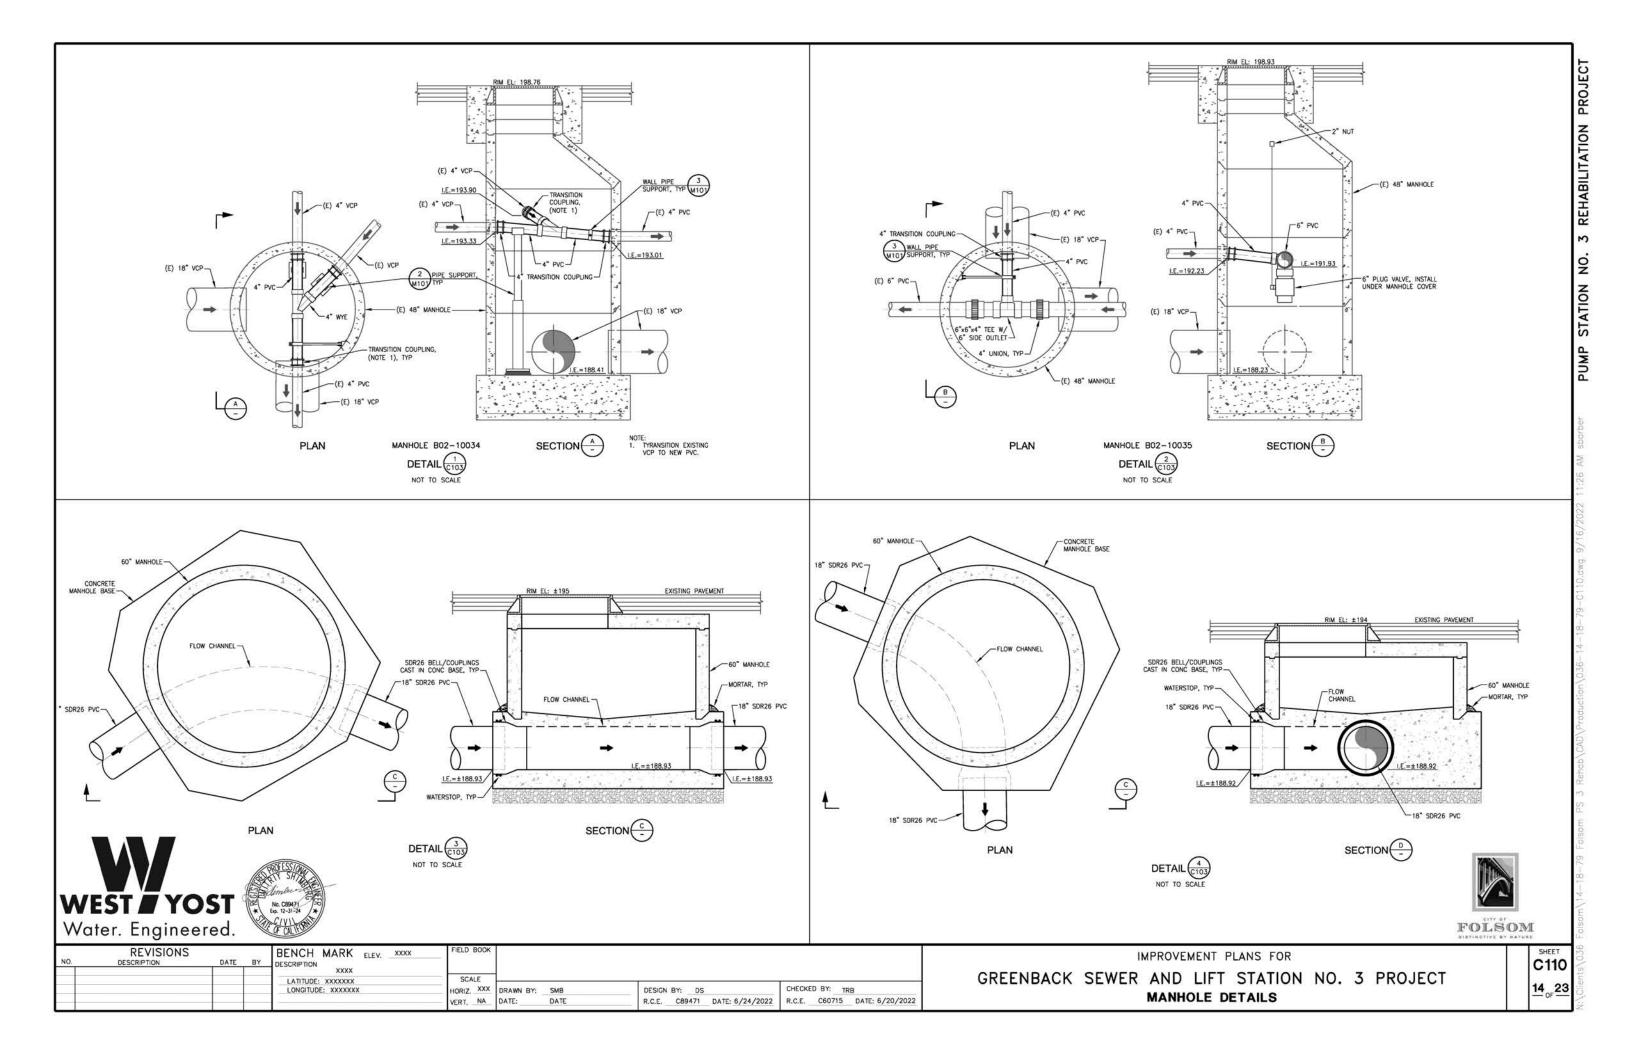





- CONCRETE MANHOLE BASE


(1 C112



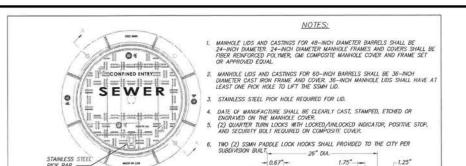

COMPOSITE COVER

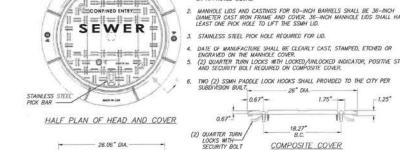

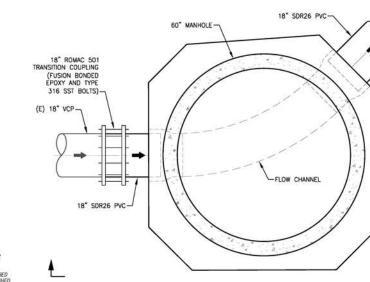

CITY OF FOLSOM

STANDARD 60"

PRE-CAST SEWER MANHOLE

SCALE: NONE DATE: FEBRUARY 2020

25.50" DIA


SECTION A-A COMPOSITE FRAME

CITY OF FOLSOM SEWER MANHOLE FRAME AND COVER SCALE: NONE DATE: FEBRUARY 2020 SECTION A-A PRECAST BASE

ITEM / DESCRIPTION I

PUMP STATION INFLUENT MANHOLE

DETAIL 6 C101 NOT TO SCALE

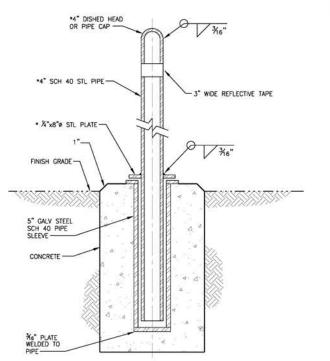

TO SDR BELL/COUPLING MUST BE SMOOTH WITH N LIP OR OFFSET FROM CHANNEL TO BELL

RIM EL: ±194.14-

6" IN LANDSCAPED AREA 12" IN UNIMPROVED AREA

FACTORY INSTALLED INFLOW— AND OUTLFOW SDR-26 BELL/COUPLINGS CAST IN TO MATCH FIPE SLOPE, ANGLE, ETC. AS SPECIFIED BY THE DESIGN ENGINEER AND INCLUDE ASTM C923 WILTER STOP (CONTRET) ON

WATER STOP (CHRISTY OR SAPPROVED EQUAL)

WEST YOST

Water. Engineered.


-MIN. 2" AC LIFT

PER ASTM C478

60" MANHOLE SEE DETAIL SS-01 FOR INTERSECTING SEWERS MANHOLE DETAIL AND PRECAST BASE DETAIL

\*HOT-DIP GALV AFTER FABRICATION PAINT SAFETY YELLOW ABOVE GRADE

REMOVABLE BOLLARD DETAIL (2) NOT TO SCALE

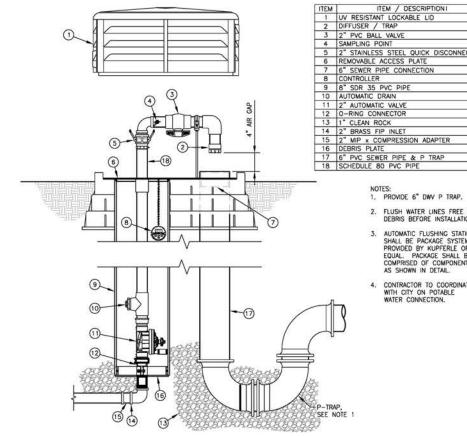


AUTOMATIC FLUSHING STATION DETAIL (1)

NOT TO SCALE

1. PROVIDE 6" DWV P TRAP.

3. AUTOMATIC FLUSHING STATION SHALL BE PACKAGE SYSTEM PROVIDED BY KUPFERLE OR EQUAL. PACKAGE SHALL BE COMPRISED OF COMPONENTS AS SHOWN IN DETAIL.

CONTRACTOR TO COORDINATE WITH CITY ON POTABLE WATER CONNECTION.

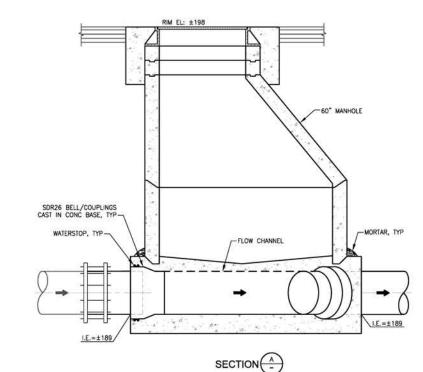

**PLAN** 

DETAIL (5) NOT TO SCALE

FOLSOM

REVISIONS BENCH MARK ELEV. XXXX DESCRIPTION XXXX SCALE LATITUDE: XXXXXXX CHECKED BY: TRB LONGITUDE: XXXXXXX HORIZ. XXX DRAWN BY: VERT. NA DATE: DATE R.C.E. C89471 DATE: 6/24/2022 R.C.E. C60715 DATE: 6/20/2022

IMPROVEMENT PLANS FOR

GREENBACK SEWER AND LIFT STATION NO. 3 PROJECT BURIED MANHOLE AND AUTOMATIC FLUSHING STATION DETAILS

C111 15<sub>OF</sub> 23



EXISTING BURIED MANHOLE

PHOTO (1)

NOTE: PROTECT ALL EXISTING UTILITIES AROUND BURIED MANHOLE.



EXISTING CLIFFHOUSE EXTERIOR DRAIN PHOTO  $\frac{2}{-}$ 

NOTE: 3 INCH CURBE TO BE 10 FOOT BY 10 FOOT CENTERED ON DRAIN.






| NO. | DESCRIPTION | DATE | DESCRIPTION XXXX                     | • ]                             |                          |                                                |                                                |
|-----|-------------|------|--------------------------------------|---------------------------------|--------------------------|------------------------------------------------|------------------------------------------------|
|     |             |      | LATITUDE: XXXXXXX LONGITUDE: XXXXXXX | SCALE<br>HORIZ, XXX<br>VERT, NA | DRAWN BY: SMB DATE: DATE | DESIGN BY: DS<br>R.C.E. C89471 DATE: 6/24/2022 | CHECKED BY: TRB  R.C.E. C60715 DATE: 6/20/2022 |


IMPROVEMENT PLANS FOR


GREENBACK SEWER AND LIFT STATION NO. 3 PROJECT

CIVIL PHOTOS

SHEET C112 16 OF 23

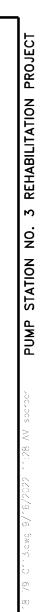

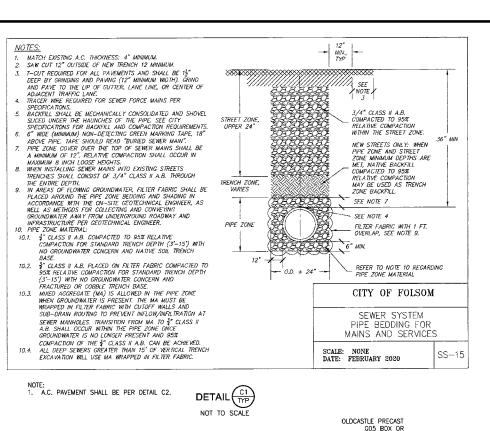

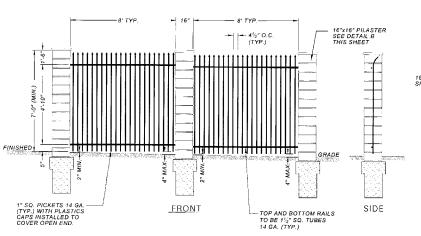

OLDCASTLE PRECAST

4" JIM CAP OR APPROVED EQUAL


CLEANOUT SAME DIAMETER
AS SERVICE SEWER-


CLASS II A.B.-

4" BUILDING SEWER,

INV. EL: 195.06'/

APPROVED EQUAL

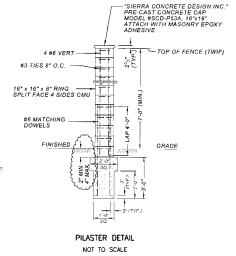

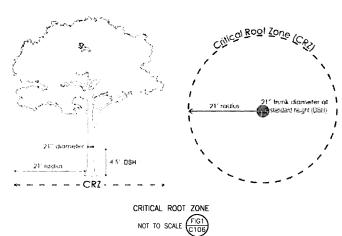

WROUGHT IRON FENCE AND PILASTER DETAIL C3 NOT TO SCALE

5' MAX


PROPERTY LINE OR EASEMENT

-1/8 :ONG RADIUS BEND


-3' BACK OF WALK


CLASS II A.B.

Heritage Tree - Critical Root Zone

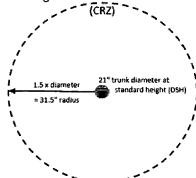

CRITICAL ROOT ZONE NOT TO SCALE (FIG2)

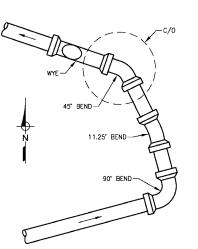

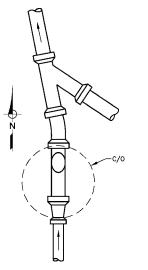

CLEANOUT PLAN DETAIL NOT TO SCALE

FOLSOM

- ASPHALT CONCRETE 9" COMPACTED THICKNESS

COMPACTED SUBGRADE (TOP 6 INCHES) UNTREATED AGGREGATE


BASE, 10" COMPACTED THICKNESS, 95% RELATIVE

ALL PAVEMENT SHALL BE PLACED PER THIS DETAIL UNLESS NOTED OTHERWISE.

STANDARD PAVEMENT

DETAIL C2

NOT TO SCALE

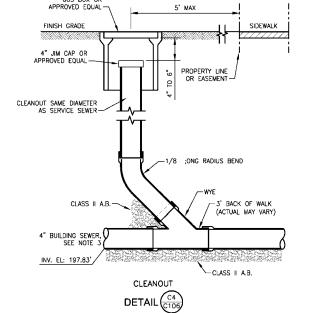

NOTES:
1. CLEANOUT TO GRADE SHALL BE PVC SDR-26 (ASTM F679).

- 2. FOR ALL SERVICES, INSTALL ROUND, CONCRETE TRAFFIC TYPE OLDCASTLE PRECAST G05 BOX OR APPROVED EQUAL WITH CAST IRON
- 3. IF WATER MAIN IS TO BE INSTALLED AT THE BACK OF THE SIDEWALK, SEWER CLEANOUT LOCATION TO BE DETERMINED IN THE FIELD BY THE CITY.
- DEPTH AT PROPERTY LINE SHOULD BE 4' MINIMUM, 5' MAXIMUM. EXISTING CONDITIONS MAY VARY.
- CLOSED CIRCUIT TELEVISION REQUIRED PRIOR TO BUILDING OCCUPANCY PERMIT. CONTRACTOR TO ARRANGE CCTC 48 HOURS OR MORE IN ADVANCE WITH CITY INSPECTOR.
- REFER TO FOLSOM MUNICIPAL CODE 13.08 FOR PUBLIC & PRIVATE OWNERSHIP, OPERATION AND MAINTENANCE RESPONSIBILITIES.



- FOR ALL SERVICES, INSTALL ROUND, CONCRETE TRAFFIC TYPE OLDCASTLE PRECAST GOS BOX OR APPROVED EQUAL WITH CAST IRON
- 3. IF WATER MAIN IS TO BE INSTALLED AT THE BACK OF THE SIDEWALK, SEWER CLEANOUT LOCATION TO BE DETERMINED IN THE FIELD BY THE
- DEPTH AT PROPERTY LINE SHOULD BE 4' MINIMUM, 5' MAXIMUM. EXISTING CONDITIONS MAY VARY.
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REVISIONS BENCH MARK ELEV. DESCRIPTION XXXX SCALE LATITUDE: XXXXXXX CHECKED BY: TRB LONGITUDE: XXXXXXX HORIZ. XXX DRAWN BY: VERT. NA DATE: DATE R.C.E. C89471 DATE: 6/24/2022 R.C.E. C60715 DATE: 6/20/2022

IMPROVEMENT PLANS FOR

GREENBACK SEWER AND LIFT STATION NO. 3 PROJECT CIVIL DETAILS

C113 17 23

WEST **YOST** Water. Engineered.

CLEANOUT DETAIL C5

CLEANOUT PLAN DETAIL (C) NOT TO SCALE

## **DEMOLITION LEGEND**

## SYMBOL

## DESCRIPTION



STRUCTURE, PAVEMENT, AND EQUIPMENT



PIPING DEMOLITION



KEY NOTE

STRUCTURAL DEMOLITION NOTES

**GENERAL DEMOLITION NOTES** 

PROCEEDING WITH ANY DEMOLITION WORK.

1. REFINISH CONCRETE SURFACES DAMAGED BY DEMOLITION TO MATCH SURROUNDING SURFACES.

NEEDED AND SHALL COORDINATE WITH THE CITY ON LOCATIONS.

2. PROTECT ALL EXISTING IMPROVEMENTS, FACILITIES, AND/OR STRUCTURES NOT DESIGNATED FOR REMOVAL AND REPLACEMENT.

5. CONTRACTOR SHALL REMOVE AND REPLACE OR RELOCATE ALL SIGNAGE AS

 DURING CONSTRUCTION, THE CONTRACTOR SHALL NOT ALTER, DAMAGE, OR REMOVE ANY PARTS OF THE EXISTING STRUCTURE, PIPING, OR EQUIPMENT UNLESS SPECIFICALLY INDICATED IN THE CONTRACT DOCUMENTS.

2. CONTRACTOR SHALL FIELD VERIFY ALL EXISTING CONDITIONS PRIOR TO

3. COMPLY WITH REQUIREMENTS OF SPECIFICATION SECTION 02221, DEMOLITION, ABANDONMENT, REMOVAL AND REMAINDER OF CONTRACT DOCUMENTS.

4. THE CONTRACTOR SHALL COORDINATE DEMOLITION WITH NEW WORK TO ENSURE PROPER INSTALLATION OF NEW ITEMS AT EXISTING FACILITIES. THE CONTRACTOR SHALL COORDINATE WITH THE CITY TO FIELD VERIFY AND DEMOLISH EXISTING FACILITIES AS NEEDED TO CONSTRUCT THE NEW FACILITIES AS INDICATED OR AS

- 3. WHERE EQUIPMENT OR MATERIAL ANCHORED TO CONCRETE OR MASONRY IS REMOVED AND ANCHOR BOLTS ARE NOT TO BE REUSED, BURN BACK THE ANCHOR BOLTS TO NOT LESS THAN 3/4-INCH BENEATH THE SURFACE. REPAIR THE HOLE TO BE FLUSH WITH THE EXISTING SURFACE USING NON-SHRINK NON-METALLIC GROUT FOR CONCRETE AND MASONRY. WHEN THE ANCHOR IS STAINLESS STEEL, IT MAY BE CUT FLUSH WITH THE CONCRETE OR MASONRY SURFACE IF APPROVED BY THE ENGINEER.
- 4. UNLESS OTHERWISE NOTED ON THE CONTRACT DOCUMENTS, WHERE CONCRETE REMOVAL SHALL LEAVE STEEL REINFORCING BARS LEFT EXPOSED, CONCRETE ELEMENT SHALL BE OVERCUT 2-INCHES BEYOND FINAL SURFACE AND BE FILLED BACK WITH APPROVED CONCRETE REPAIR MATERIAL

## **ELECTRICAL DEMOLITION NOTES**

- 1. GENERAL AND DETAILED ELECTRICAL DEMOLITION REQUIREMENTS ARE SPECIFIED IN
- KEY ELECTRICAL DEMOLITION REQUIREMENTS ARE SUMMARIZED BELOW. CONTRACTOR SHALL REFER TO SECTION 02221 FOR THE DESCRIPTION OF REQUIREMENTS RELATED TO ELECTRICAL AND INSTRUMENTATION REMOVALS FOR DEMOLITION, SALVAGE, RELOCATION AND ELECTRICAL RE-CONNECTION.
- A. NOT ALL EXISTING CONDUITS ARE SHOWN ON THE DRAWINGS. LOCATE EXISTING ELECTRICAL WIRES AND CONDUITS BEFORE STARTING DEMOLITION OR EXCAVATION FOR NEW WORK.
- B. UNLESS OTHERWISE NOTED ON THE DRAWINGS, REMOVE EXISTING FLECTRICAL EQUIPMENT, COMPONENTS AND PANELS, AND RELATED EXPOSED CONDUIT AND ALL WIRE ASSOCIATED WITH THE EQUIPMENT INDICATED FOR REMOVAL
- C. UNLESS OTHERWISE NOTED ON THE DRAWINGS, WHERE A PIECE OF EQUIPMENT IS REMOVED, REMOVE ALL ELECTRICAL CONDUCTORS AND CABLES BACK TO THEIR SOURCE, AND REMOVE ALL ASSOCIATED CONDUITS AND RACEWAYS BACK TO THEIR SOURCE. BURIED CONDUITS MAY BE CAPPED AND ABANDONED IN PLACE
- D. UNLESS OTHERWISE NOTED ON THE DRAWINGS, WHERE PORTIONS OF CONDUITS AND RACEWAYS BEING REMOVED ARE EMBEDDED IN SLABS OR WALLS, REMOVE CONDUIT TO TWO-INCHES WITHIN THE SURFACE INTO WHICH THEY ARE EMBEDDED AND PERMANENTLY SEAL THE RESULTING VOID WITH NON-SHRINK
- E. UNLESS OTHERWISE SPECIFIED OR NOTED ON THE DRAWINGS, PROTECT IN PLACE EXISTING ELECTRICAL AND INSTRUMENTATION EQUIPMENT AND DEVICES AND RELATED CONDUIT AND WIRING ASSOCIATED WITH EQUIPMENT NOT INDICATED FOR REMOVAL ON THE DRAWINGS.
- F. REFINISH CONCRETE SURFACES DAMAGED BY REMOVAL OF ELECTRICAL OR INSTRUMENTATION EQUIPMENT AND RELATED CONDUIT TO MATCH SURROUNDING SURFACES, AS SPECIFIED IN SECTION 02221.




BENCH MARK ELEV. XXXX REVISIONS IELD BOOK DESCRIPTION XXXX SCALE LATITUDE: XXXXXXX CHECKED BY: TRB LONGITUDE: XXXXXXX HORIZ. NA DRAWN BY: VERT. NA DATE: DATE R.C.E. C89471 DATE: 6/241/2022 R.C.E. C60715 DATE: 6/20/2022



GREENBACK SEWER AND LIFT STATION NO. 3 PROJECT **PUMP STATION NO. 3 DEMOLITION NOTES** 

FOLSOM

D001 18\_23

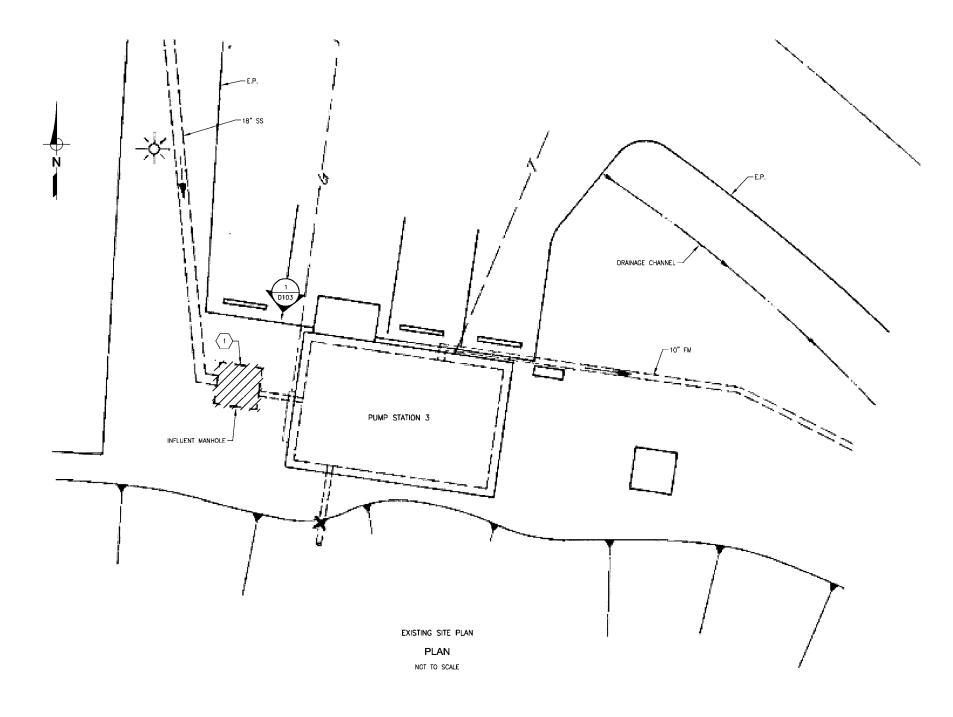

GENERAL NOTES:

1. EXISTING CONDITIONS SHOWN ON THIS DRAWING ARE FROM THE "RAINBOW BRIDGE LIFT STATION IMPROVEMENT PLANS" BY PSOMAS (RECORD DRAWING DATED 1991).

- EXACT DEPTH AND LOCATION OF EXISTING UTILITIES UNKNOWN. LOCATE ALL ON SITE UTILITIES BEFORE EXCAVATION OR DEMOLITION.
- 3. REFER TO C101 FOR SITE LAYOUT.

KEY NOTES:

1 REMOVE EXISTING INFLUENT JUNCTION BOX (APPROX. 6'x6'). INSTALL NEW CONCRETE MANHOLE AS SHOWN ON C101.




| NO. D | REVISIONS<br>SCRIPTION | DATE | · · · | BENCH MARK ELEV. XXXX                                   | FIELD BOOK |                    |             |                                             |                                                      |
|-------|------------------------|------|-------|---------------------------------------------------------|------------|--------------------|-------------|---------------------------------------------|------------------------------------------------------|
| NO.   | SCRIPTION              | DATE | Б1    | DESCRIPTION XXXX  LATITUDE: XXXXXXX  LONGITUDE: XXXXXXX |            | DRAWN BY:<br>DATE: | SMB<br>DATE | DESIGN BY: DS<br>R.C.E. C89471 DATE: 6/24/2 | CHECKED BY: TRB<br>222 R.C.E. C60715 DATE: 6/20/2022 |

IMPROVEMENT PLANS FOR

GREENBACK SEWER AND LIFT STATION NO. 3 PROJECT EXISTING PUMP STATION NO. 3 SITE CIVIL DEMOLITION PLAN

SHEET D101

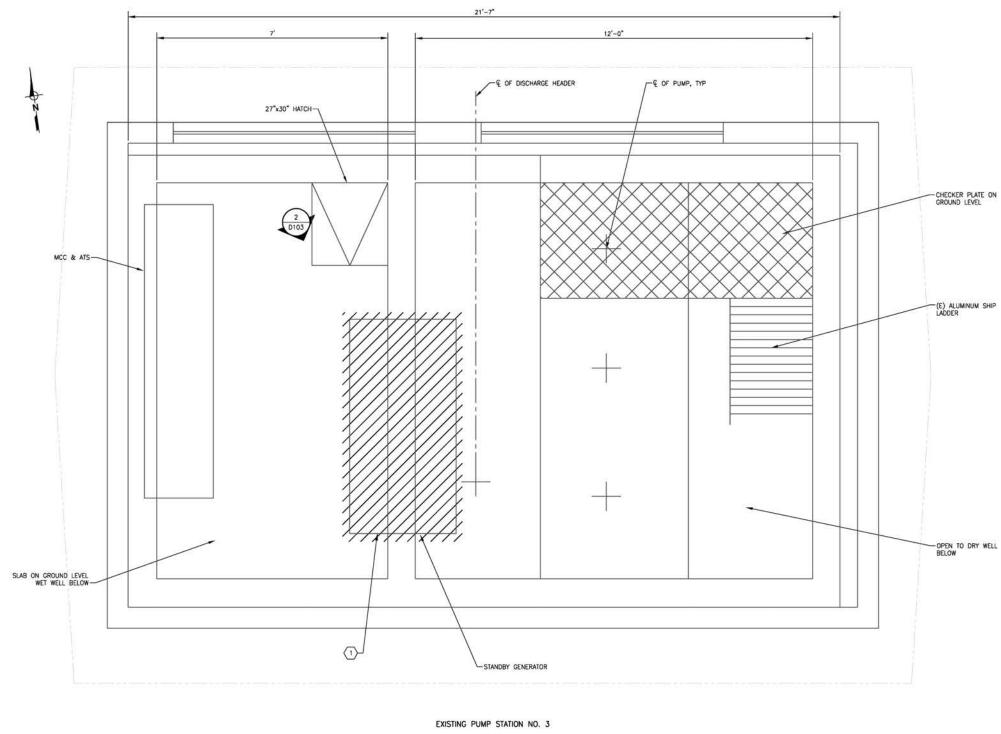

KEY NOTES:

The move existing standby generator and associated wiring and appurerances. Remove concrete pad to flush with finished grade. Remove all piping and associated appurerances connected to generator.

**PLAN** 

SCALE: 3/4"=1"-0"






| NO. | REVISIONS<br>DESCRIPTION | DATE | BY | DESCRIPTION SAME   | FIELD BOOK           |       |      |                                                |                 |
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|     |                          |      |    | LATITUDE: XXXXXXX  | SCALE<br>HORIZ. ¾"=1 |       | 646  | DECICH DV. DC                                  | CHECKED BY: TRB |
|     |                          |      |    | LONGITUDE: XXXXXXX |                      | DATE: | DATE | DESIGN BY: DS<br>R.C.E. C89471 DATE: 6/24/2022 | 1-14/4/25       |

IMPROVEMENT PLANS FOR

GREENBACK SEWER AND LIFT STATION NO. 3 PROJECT EXISTING PUMP STATION NO. 3 DEMOLITION PLAN

D102 20<sub>OF</sub> 23



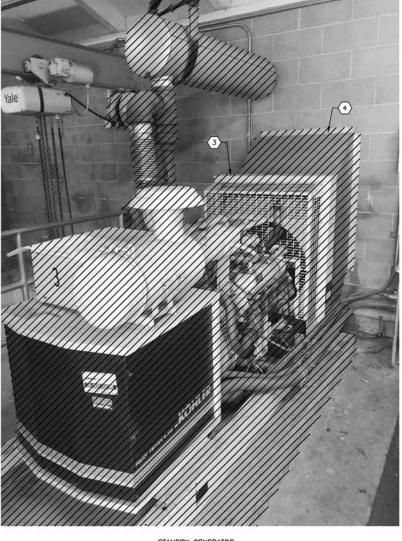






- $\overbrace{\mbox{$1$}} \mbox{ REMOVE ENTIRE INFLUENT VAULT, FLUSH WITH GRADE, AND METAL HATCH.}$
- REMOVE EXISTING STANDBY GENERATOR. REMOVE EXHAUST DUCT, SILENCER AND LOUVER. REMOVE CONDUIT BACK TO MCC.

   FILL LOUVER GAP WITH INFILL WALL PER 1 0103

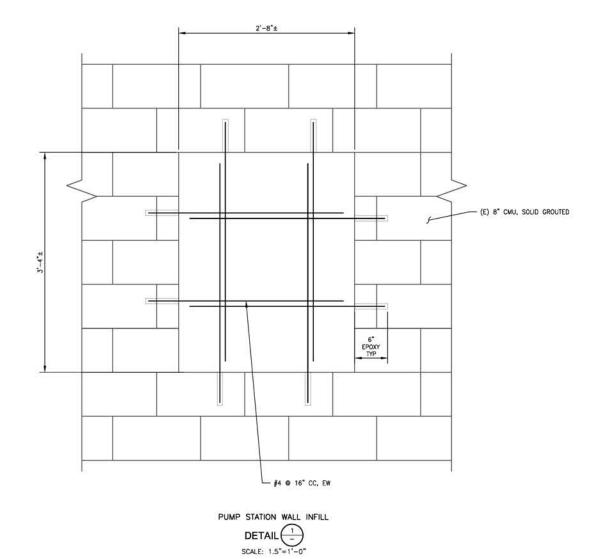






| NO. | REVISIONS<br>DESCRIPTION | DATE | BY | BENCH MARK ELEV. XXXX DESCRIPTION XXXXX | FIELD BOOK  |                    |             |                                                |                                                  |
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IMPROVEMENT PLANS FOR

GREENBACK SEWER AND LIFT STATION NO. 3 PROJECT **EXISTING PUMP STATION NO. 3 DEMOLITION PHOTOS** 


SHEET D103 21<sub>OF</sub>23

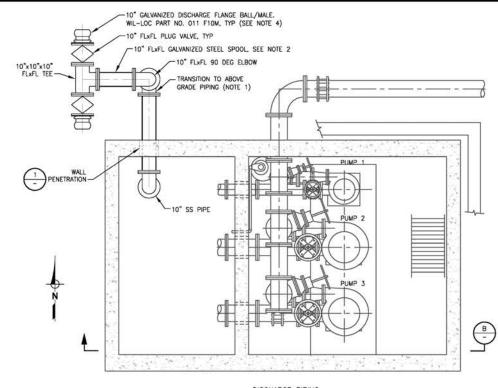

## DISCHARGE PIPING

## **PLAN**

SCALE: 3/8"=1'-0"

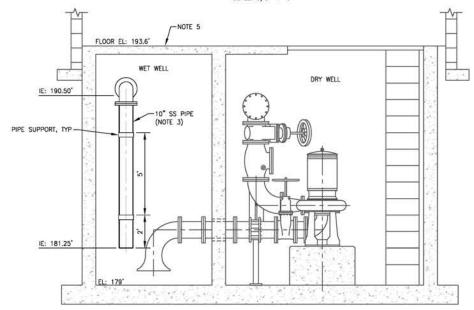


PUMP 2 AND 3 SUCTION AND DISCHARGE





Water. Engineered.




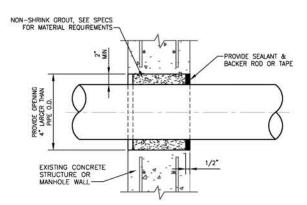


WALL PENETRATION DETAIL 1 NOT TO SCALE

- NOTES:

  1. AT TRANSITION FROM BELOW GRADE TO
  ABOVE GRADE PIPING, INSTALL RISER CLAMP
  AROUND 10\* STAINLESS STEEL PIPE PRIOR
  TO TRANSITIONING TO GALVANIZED STEEL PIPE.
  INSTALL INSULATING FLANGE BETWEEN
  GALVANIZED STEEL PIPE AND STAINLESS
  STEEL PIPE.
- INSTALL PIPE SUPPORT UNDER 10" SPOOL (DETAIL 2).
- INSTALL WALL PIPE SUPPORTS IN WET WELL TO SUFFICIENTLY SUPPORT 10" STAINLESS STEEL PIPING (DETAIL 3). PIPE SUPPORTS SHALL BE NO MORE THAN 5' APART ON PIPE AND WITHIN 2' OF BENDS AND PIPE TERMINATION.
- INSTALL END CAP ON WIL-LOC DISCHARGE CONNECTION, TYP 2. GALYANIZED A-STYLE END CAP SOCKET/FEMALE, WIL-LOC PART NO. 101 EC10, TYP 2.

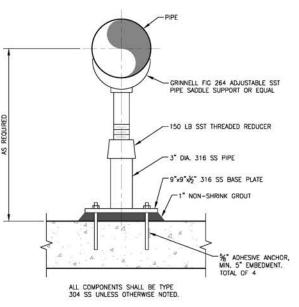



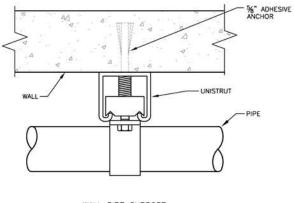






| DESCRIPTION | DATE | BY | BENCH MARK ELEV. XXXX  DESCRIPTION XXXX | FIELD BOOK  |               |                               |                               |
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|             |      |    | LATITUDE: XXXXXXX                       | SCALE       |               | 1                             |                               |
|             |      |    | LONGITUDE: XXXXXXX                      | HORIZ. 3/8" | DRAWN BY: SMB | DESIGN BY: DS                 | CHECKED BY: TRB               |
|             | 1    |    |                                         | VERT. NA    | DATE: DATE    | R.C.E. C89471 DATE: 6/24/2022 | R.C.E. C60715 DATE: 6/20/2022 |

IMPROVEMENT PLANS FOR

GREENBACK SEWER AND LIFT STATION NO. 3 PROJECT PUMP STATION PIPING PLANS AND SECTIONS

M101 22<sub>OF</sub> 23

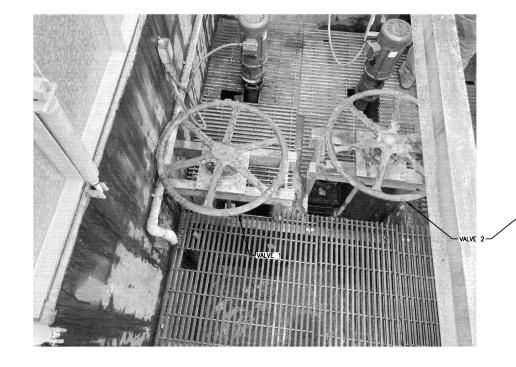

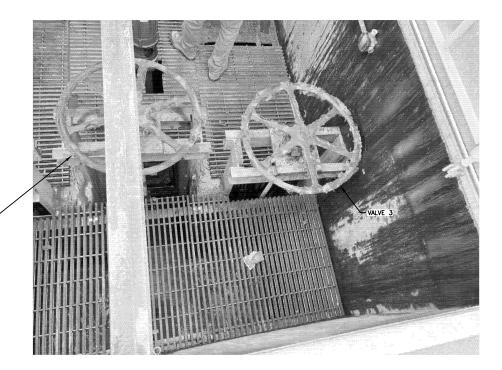


PHOTO DETAIL (PH-1)

PHOTO DETAIL (PH-2)

### GENERAL NOTES:

- 1. HAND WHEELS (3) TO BE REPLACED.
- MANUAL GATE OPERATORS: PROVIDE HANDWHEEL
   TYPE OPERATORS MEETING REQUIREMENTS OF AWWA
   C561 PERTAINING TO MANUAL LIFTING DEVICES.
   a. HANDWHEEL TYPE OPERATORS: NON-GEARED.
- PUMP STATION 2 LOCATION: 910 RIVER WAY, FOLSOM, CA. 95630.





| NC | REVISIONS<br>DESCRIPTION | DATE | BY | BENCH MARK ELEV. XXXX | FIELD BOOK |               |                               |                               |
|----|--------------------------|------|----|-----------------------|------------|---------------|-------------------------------|-------------------------------|
|    |                          |      |    | XXXX                  |            |               |                               |                               |
| _  |                          |      |    | LATITUDE: XXXXXXX     | SCALE      |               |                               |                               |
| _  |                          |      |    | LONGITUDE: XXXXXXX    | HORIZ. NA  | DRAWN BY: SMB | DESIGN BY: DS                 | CHECKED BY: TDH               |
| _  |                          |      |    |                       | VERT. NA   | DATE: DATE    | R.C.E. #89471 DATE: 6/24/2022 | R.C.E. 051550 DATE: 6/20/2022 |
|    |                          |      |    |                       |            |               |                               |                               |

IMPROVEMENT PLANS FOR

GREENBACK SEWER AND LIFT STATION NO. 3 PROJECT HAND WHEEL REHABILITATION

SHEET M102
23 05 23