Appendix PPS

Project Plans



1155 & 1185 TERRA BELLA AVE

MOUNTAIN VIEW, CA







PROJECT SUMMARY

The proposed development is a 1.3-acre site in the left a behavior more in the site is located east of N Shoreline Blvd, across the Terra Bella Ave. (APN:153-16-011) and 1155 Terra Bella Ave. (APN: 153-16-012). The site is located east of N Shoreline Blvd, across the The proposed development is a 1.3-acre site in the Terra Bella neighborhood in Mountain View, CA, comprising two parcels, 1185 street from the recently approved Shoreline Gateway mixed-use office-residential development. A MVgo bus stop is located on the corner of Shoreline Blvd and Terra Bella. The closest existing residential neighborhood is over 500-ft distance away.

The proposed project will be in full compliance with the City of Mountain View's current zoning code for the ML and MM zones, including height, FAR, setback and parking requirements.

The existing building on the site has been demolished, and the proposed project is envisioned as a freestanding three-story office building of approximately 20,000 sf size on the Terra Bella frontage, and associated surface parking lot adjacent to the new building. The office entry plaza echoes the plaza across the street, and the entire street frontage is designed to create a very pedestrian-friendly experience.

The building massing steps down from three to two floors towards its western façade, making room for generous roof decks on the third floor for working and socializing. In addition, a series of outdoor spaces on the ground floor create a strong indoor-outdoor relationship for the office building.

Architecturally, a warm clean aesthetic is envisioned, with Corten steel and other rainscreen paneling, combined with a curtain-wall glass stair tower, and artistic metal elements. This warm aesthetic will nicely complement the existing and forthcoming architecture in the neighborhood.

Sustainability: Photovoltaic panels will be located on a portion of the office roof, as well as on the carports in the center of the surface parking lot. Electric Vehicle parking stalls are incorporated into the parking lot. The project aims for equivalent to LEED Gold rating.

ating.							
PLANNING AND BUILDING							
CODE DATA							
Address	1155 & 1185 Te	erra Bella Ave., Mou	untain View, CA 94043				
A DAL.	1185 Terra Bella (•					
APN:	1155 Terra Bella (APN: 153-16-012)					
Existing Land Use Designation	ons:						
General Plan Designation:		General Industr	ial				
Zoning Designation:		MM (General Ir	ndustrial), and ML (Lin	nited Indus	trial)		
Proposed Land Use Designat	tions:						
General Plan Designation:		General Industr	ial				
Zoning Designation:		MM (General In	dustrial), and ML (Lim	ited Industi	rial)		
Building Code							
2019 California Building Code	9						
Building Height: ±44'-0" (to to	op of roof)		Building Stories: 3				
Occupancy Groups			Construction Types				
Office		В	Type V-B				
Assembly (Roof Decks)		A-3					
Lot Area (1155 Terra Bella & 118	85 Terra Bella)	1.31 acres		57,024	sf		
Office Gross SF				19,958	sf	F.A.R.	0.35

PROJECT TEAM

APPLICANT:	LANDSCAPE ARCHITECT:	STRUCTURAL ENGINEER:
Devcor Partners II, LLC.	The Guzzardo Partnership Inc.	DCI Engineers
171 Main Street, #232	181 Greenwich Street	135 Maine St., Suite 3 San Francisco, CA. 94
Los Altos, CA. 94022	San Francisco, CA. 94111	Contact: Jeff D. Brink
Contact: Sean Corrigan	Contact: Paul Lettieri, Principal	Phone: 415.781.1505
Erik Corrigan	Phone: 415.433.4672	
Phone: 650.559.6500		MEP ENGINEER:

ARCHITECT / PLANNER: **CIVIL ENGINEER:**

Kier and Wright Studio T-Square, Inc. 1970 Broadway, Suite 615 3350 Scott Blvd., Building 22 Oakland, CA. 94612 Santa Clara, CA. 95054 Contact: Chek Tang, Principal Contact: Nektarios Matheou

Phone: 408.727.6665 Chris Lee, Principal Phone: 510.451.2850

DCI Engineers 135 Maine St., Suite 1800

San Francisco, CA. 94105 Contact: Jeff D. Brink, Principal Phone: 415.781.1505

PAE Consulting Engineers, Inc. 48 Golden Gate Avenue San Francisco, CA 94102 Contact: Tim Quiring, Assoc. Principal Phone: 206.486.9593

WASTE MANAGEMENT:

American Trash Management, Inc. 1900 Powell St., Suite 890 Emeryville, CA. 94608

Contact: Steven Seltzer, Vice President

Phone: 415.292.5402

PROJECT INFO

Rear: 0'

Parking: min 1/300 SF

Total Property: 57,024 SF (1.3 acre)	MM ZONING: (For 1155 Terra Bella Ave.)
ML ZONING: (For 1185 Terra Bella Ave.)	FAR: 0.35
FAR: 0.35	Height: No reduction (50' in height if located
Height: 40' + 1:2 incline plane	within 200' of any R District)
Setback:	Setback:
Front: 20' Min., 30' Average	Front: 25' Min.
Side: 30' Aggregate	Side: 0'

Rear: 0'

Parking: 1/300 SF

VICINITY



ZONING

	Current Zoning ML	Proposed Development	In Compliance
Land Use	Commercial	Commercial Office	Yes
FAR	0.35	0.35 FAR on 1.3 ac	Yes
Height	40' + 1:2 Incline Plane	40' + 1:2 Incline Plane	Yes - See Sections
Setbacks			
Front	20' min, 30' avg	20' min, 30' avg	Yes, see A2.5
Side	30' aggregate	30' aggregate	Yes
Rear	0'	10'	Yes
	1 car/300 SF		
Parking	(67 parking stalls)	75 parking stalls	Yes

	Current Zoning MM	Proposed Development	In Compliance
Land Use	Commercial	Office Parking	Yes
FAR	0.35	0	Yes
Height	No Restriction	No Building Proposed	Yes
Setbacks			
Front	25' min	25' min	Yes
Side	0'	30' aggregate	Yes
Rear	0'	10'	Yes
Parking	1 car/300 SF	(see table above)	Yes

	Parking Ratio Req.	Parking Required	Parking Proposed
Vehicular*	1 car/300 SF	67	75
Incl. Accessible			3
incl EV *	15%	12	12
EV regular			10
EV Accessible**			2
Loading Space	1 space / 10,000 - 30,000 SF	1	1
Bike	5%	3.35	5
Long Term	80%	4	4
Short Term	20%	1	1
Clean Air	Between 51-75 stalls -	6	6
Vehicles***	6 stalls required	U	U

- Regular parking stall and Regular EV stall size: 8.5'x18'
- ** EV accessible stalls provided in compliance with CBC Chapter 11B-228.3.1 & Table 11B-228.3.2.1
- 1 EV accessible parking stall, size 9' x 18'
- 1 EV van accessible parking stall, size 12' x 18',
- *** Designated parking for clean air vehicles based on Cal Green Code 5.106.5.2

Y MA	AP			SHE	ET INDEX
101 BAYS	HORE FREEWAY		CREEK BIKE TRAIL	G0.0 G1.0 G2.0 G3.0 G4.0 G5.0 C0.0 A1.0	EXISTING SITE CONDITIONS CONTEXT SITE PLAN AERIAL PERSPECTIVE (CONTEXT)
WA	N SHORELINE BLVD	TERRA BELLA AVE	85 N	A2.3	AERIAL PERSPECTIVE PERSPECTIVE VIEW PERSPECTIVE VIEW PERSPECTIVE VIEW PERSPECTIVE VIEW PERSPECTIVE VIEW BUILDING PLAN - LEVEL 1 BUILDING PLAN - LEVELS 2 AND 3 BUILDING PLAN - ROOF LEVEL F.A.R. CALCULATIONS
G COI	MPLIANCE - SUMI	MARY		A2.4 A2.5 A2.6 A3.0 A3.1	EAST ELEVATION & PERSPECTIVE
	Current Zoning ML	Proposed Development	In Compliance	A3.2 A3.3	SOUTH ELEVATION & PERSPECTIVE WEST ELEVATION & PERSPECTIVE
	Commercial 0.35	Commercial Office 0.35 FAR on 1.3 ac	Yes Yes	A3.4 A4.0	BUILDING SECTIONS
nt	40' + 1:2 Incline Plane 20' min, 30' avg	40' + 1:2 Incline Plane 20' min, 30' avg	Yes - See Sections Yes, see A2.5	A4.1 A4.2 A4.3	WALL SECTIONS WALL SECTIONS WALL SECTIONS
•	30' aggregate 0' 1 car/300 SF	30' aggregate 10'	Yes Yes	A5.0 A5.1	
	(67 parking stalls)	75 parking stalls	Yes	L1.01	SCHEMATIC LANDSCAPE PLAN
	Current Zoning MM	Proposed Development	In Compliance	L2.01 L3.01	ACCESSIBLE PATH OF TRAVEL PLAN
	Commercial 0.35 No Restriction	Office Parking 0 No Building Proposed	Yes Yes Yes	L4.01 L4.02 L5.01	TREE CANOPY PLAN HYDRO-ZONE PLAN
nt	25' min 0' 0'	25' min 30' aggregate 10'	Yes Yes Yes	L6.01 L7.01 L8.01	LIGHTING PLAN
	1 car/300 SF	(see table above)	Yes	C1.0	TOPOGRAPHIC SURVEY
	Parking Ratio Req.	Parking Required	Parking Proposed	C2.0 C2.1	PRELIMINARY GRADING SECTIONS
•* sible	1 car/300 SF	67	75 3	C3.0 C4.0	PRELIMINARY UTILITY STORMWATER CONTROL PLAN
ble**	15%	12	12 10 2	C5.0 SL-1 SL-2	FIRE PLAN ELECTROLIER TITLE SHEET ELECTROLIER PLAN
ace	1 space / 10,000 - 30,000 SF	1	1	PM-1	

SCHEMATIC LANDSCAPE PLAN
ACCESSIBLE PATH OF TRAVEL PLAN
LAND USE CALCULATIONS
PLANTING PLAN
TREE CANOPY PLAN
HYDRO-ZONE PLAN
LANDSCAPE IMAGES + MATERIALS
LIGHTING PLAN
TREE DISPOSITION PLAN
TOPOGRAPHIC SURVEY
PRELIMINARY GRADING
SECTIONS
PRELIMINARY UTILITY
STORMWATER CONTROL PLAN
FIRE PLAN
ELECTROLIER TITLE SHEET
ELECTROLIER PLAN
PHOTOMETRIC DETAILS
PHOTOMETRIC OVERALL
MECH. SITE PLAN
MECHANICAL PLAN - LEVEL 1
MECHANICAL PLAN - LEVELS 2 & 3
MECHANICAL PLAN - ROOF LEVEL
TRASH ENCLOSURE

TRASH SERVICE AND SCHEDULE

TRASH ENCLOSURE



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- Architecture
- Planning Urban Design
- 1970 Broadway, Suite 615

Oakland, California 94612 (510) 451 - 2850

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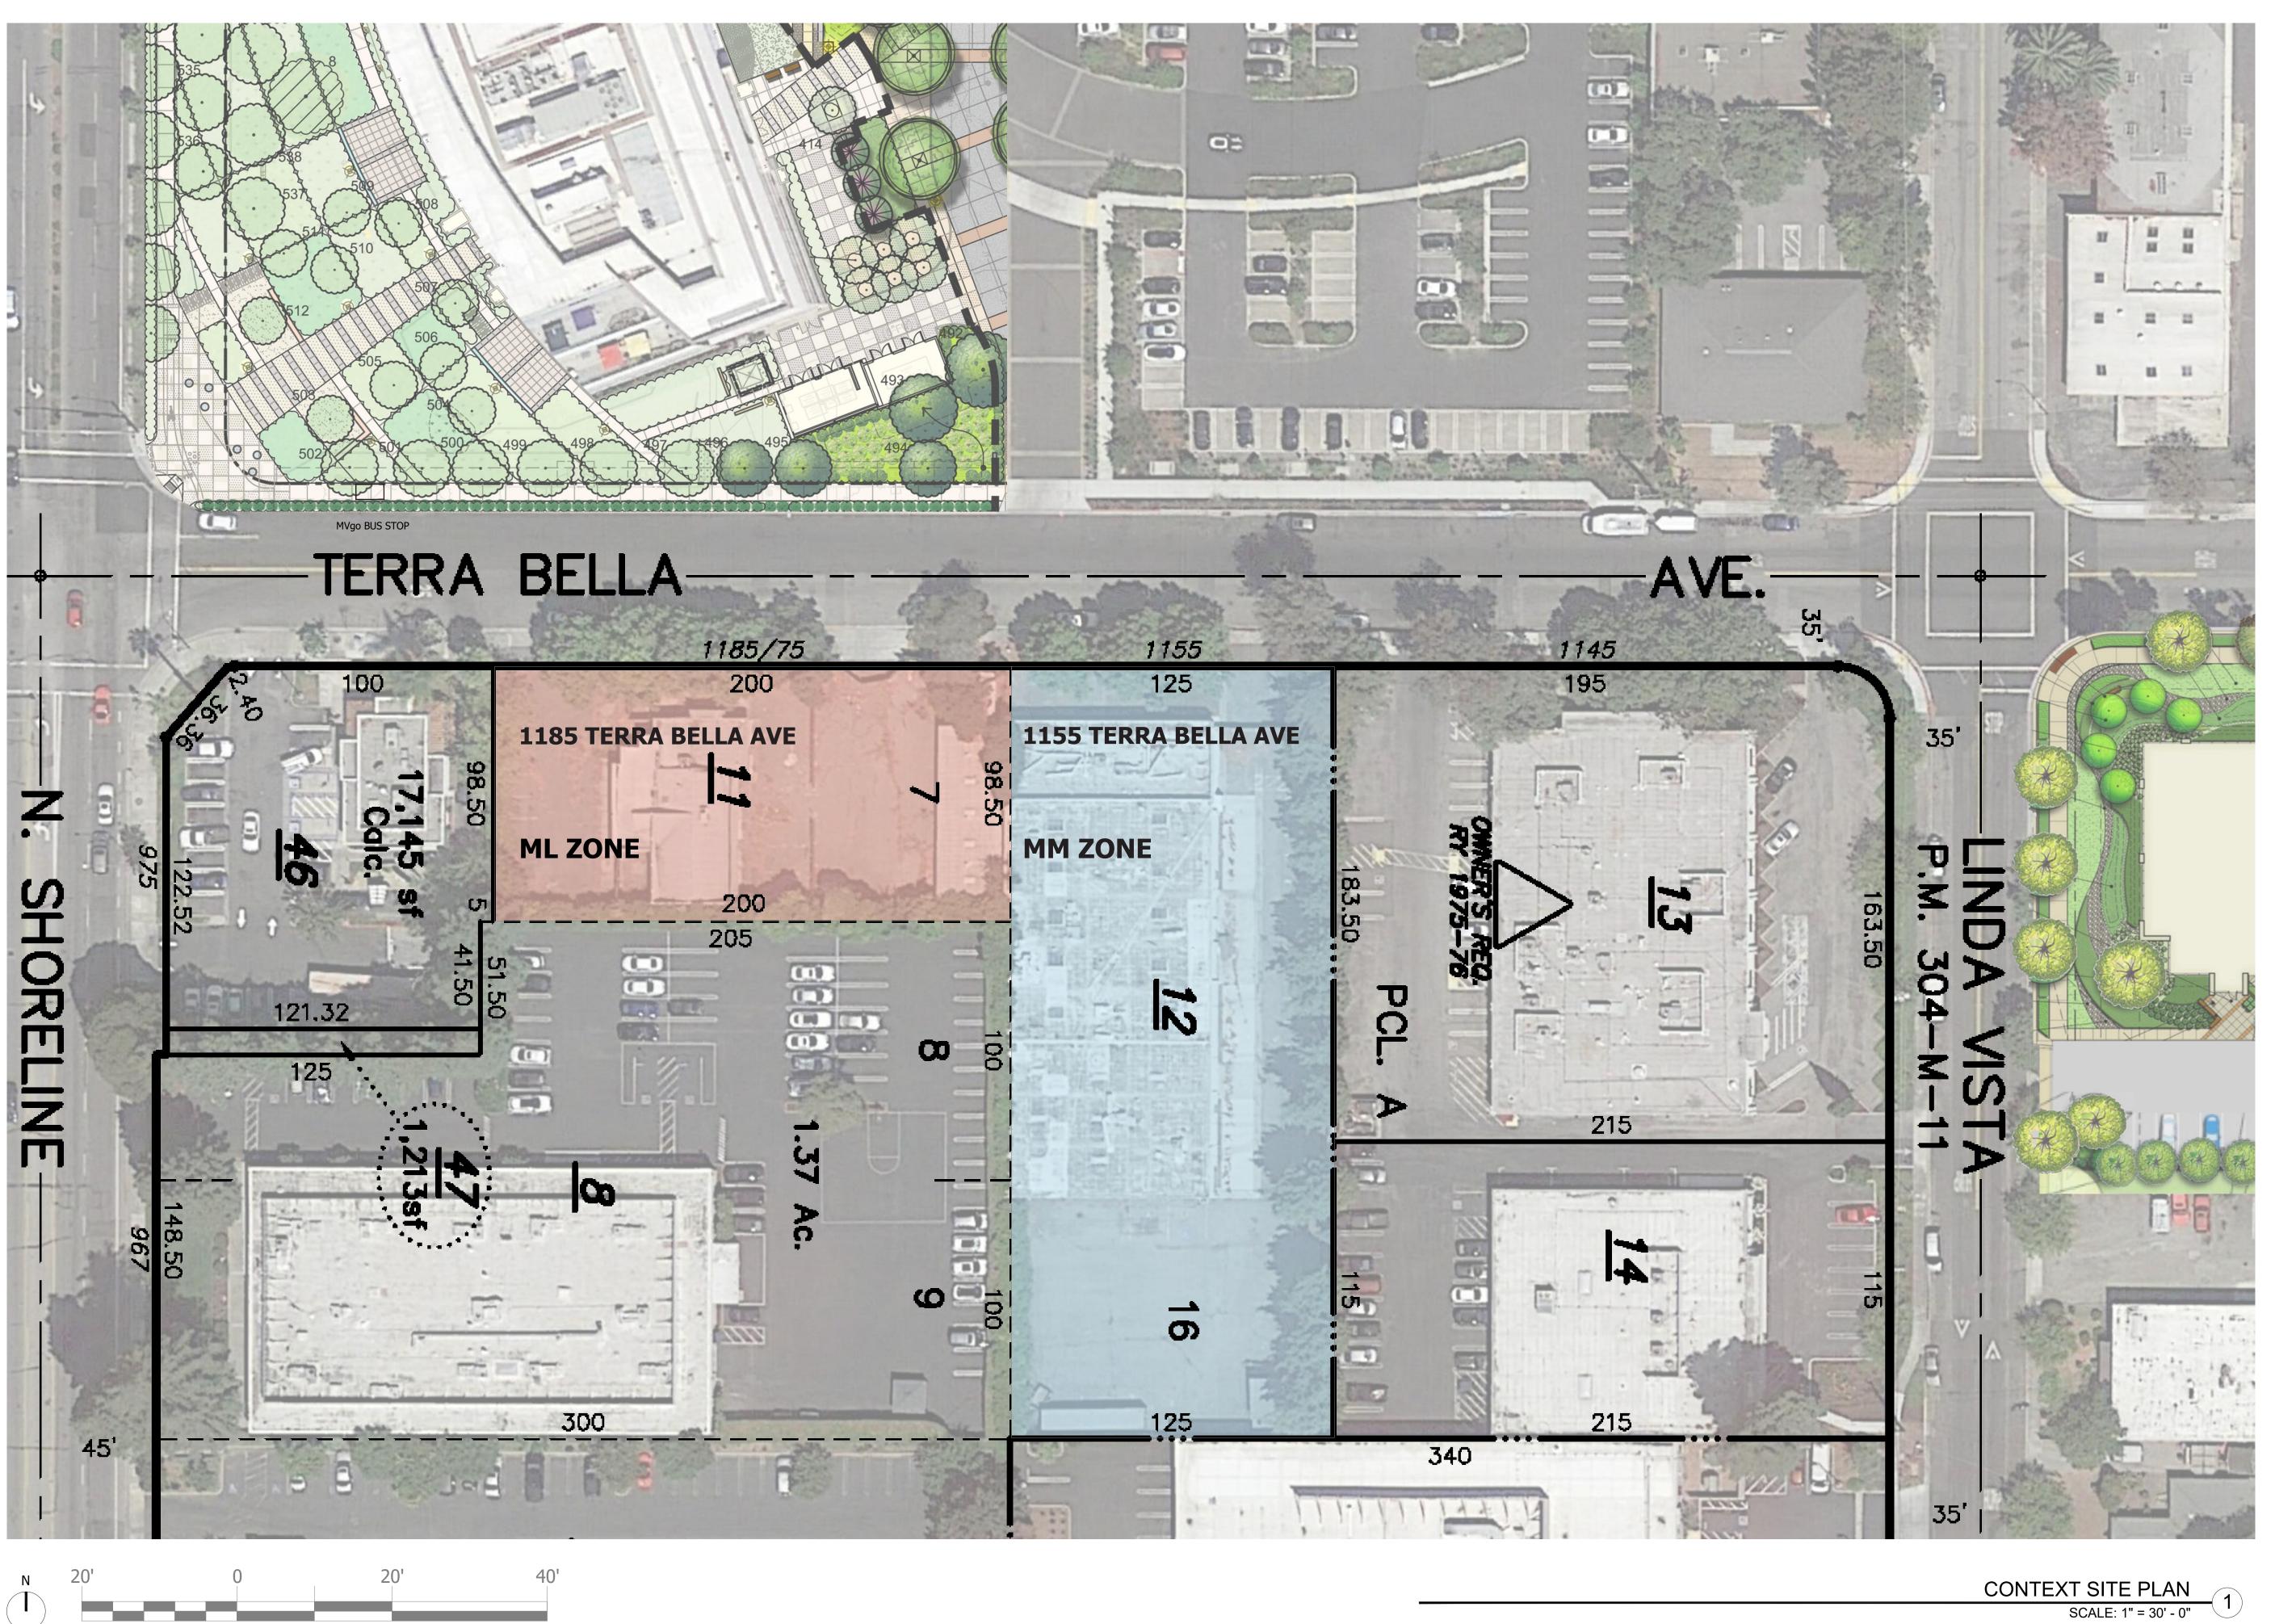
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PARTNERS

Sheet Title: **PROJECT INFORMATION**

20006 Job No. 08/26/2021 Date: Scale: Drawn By:

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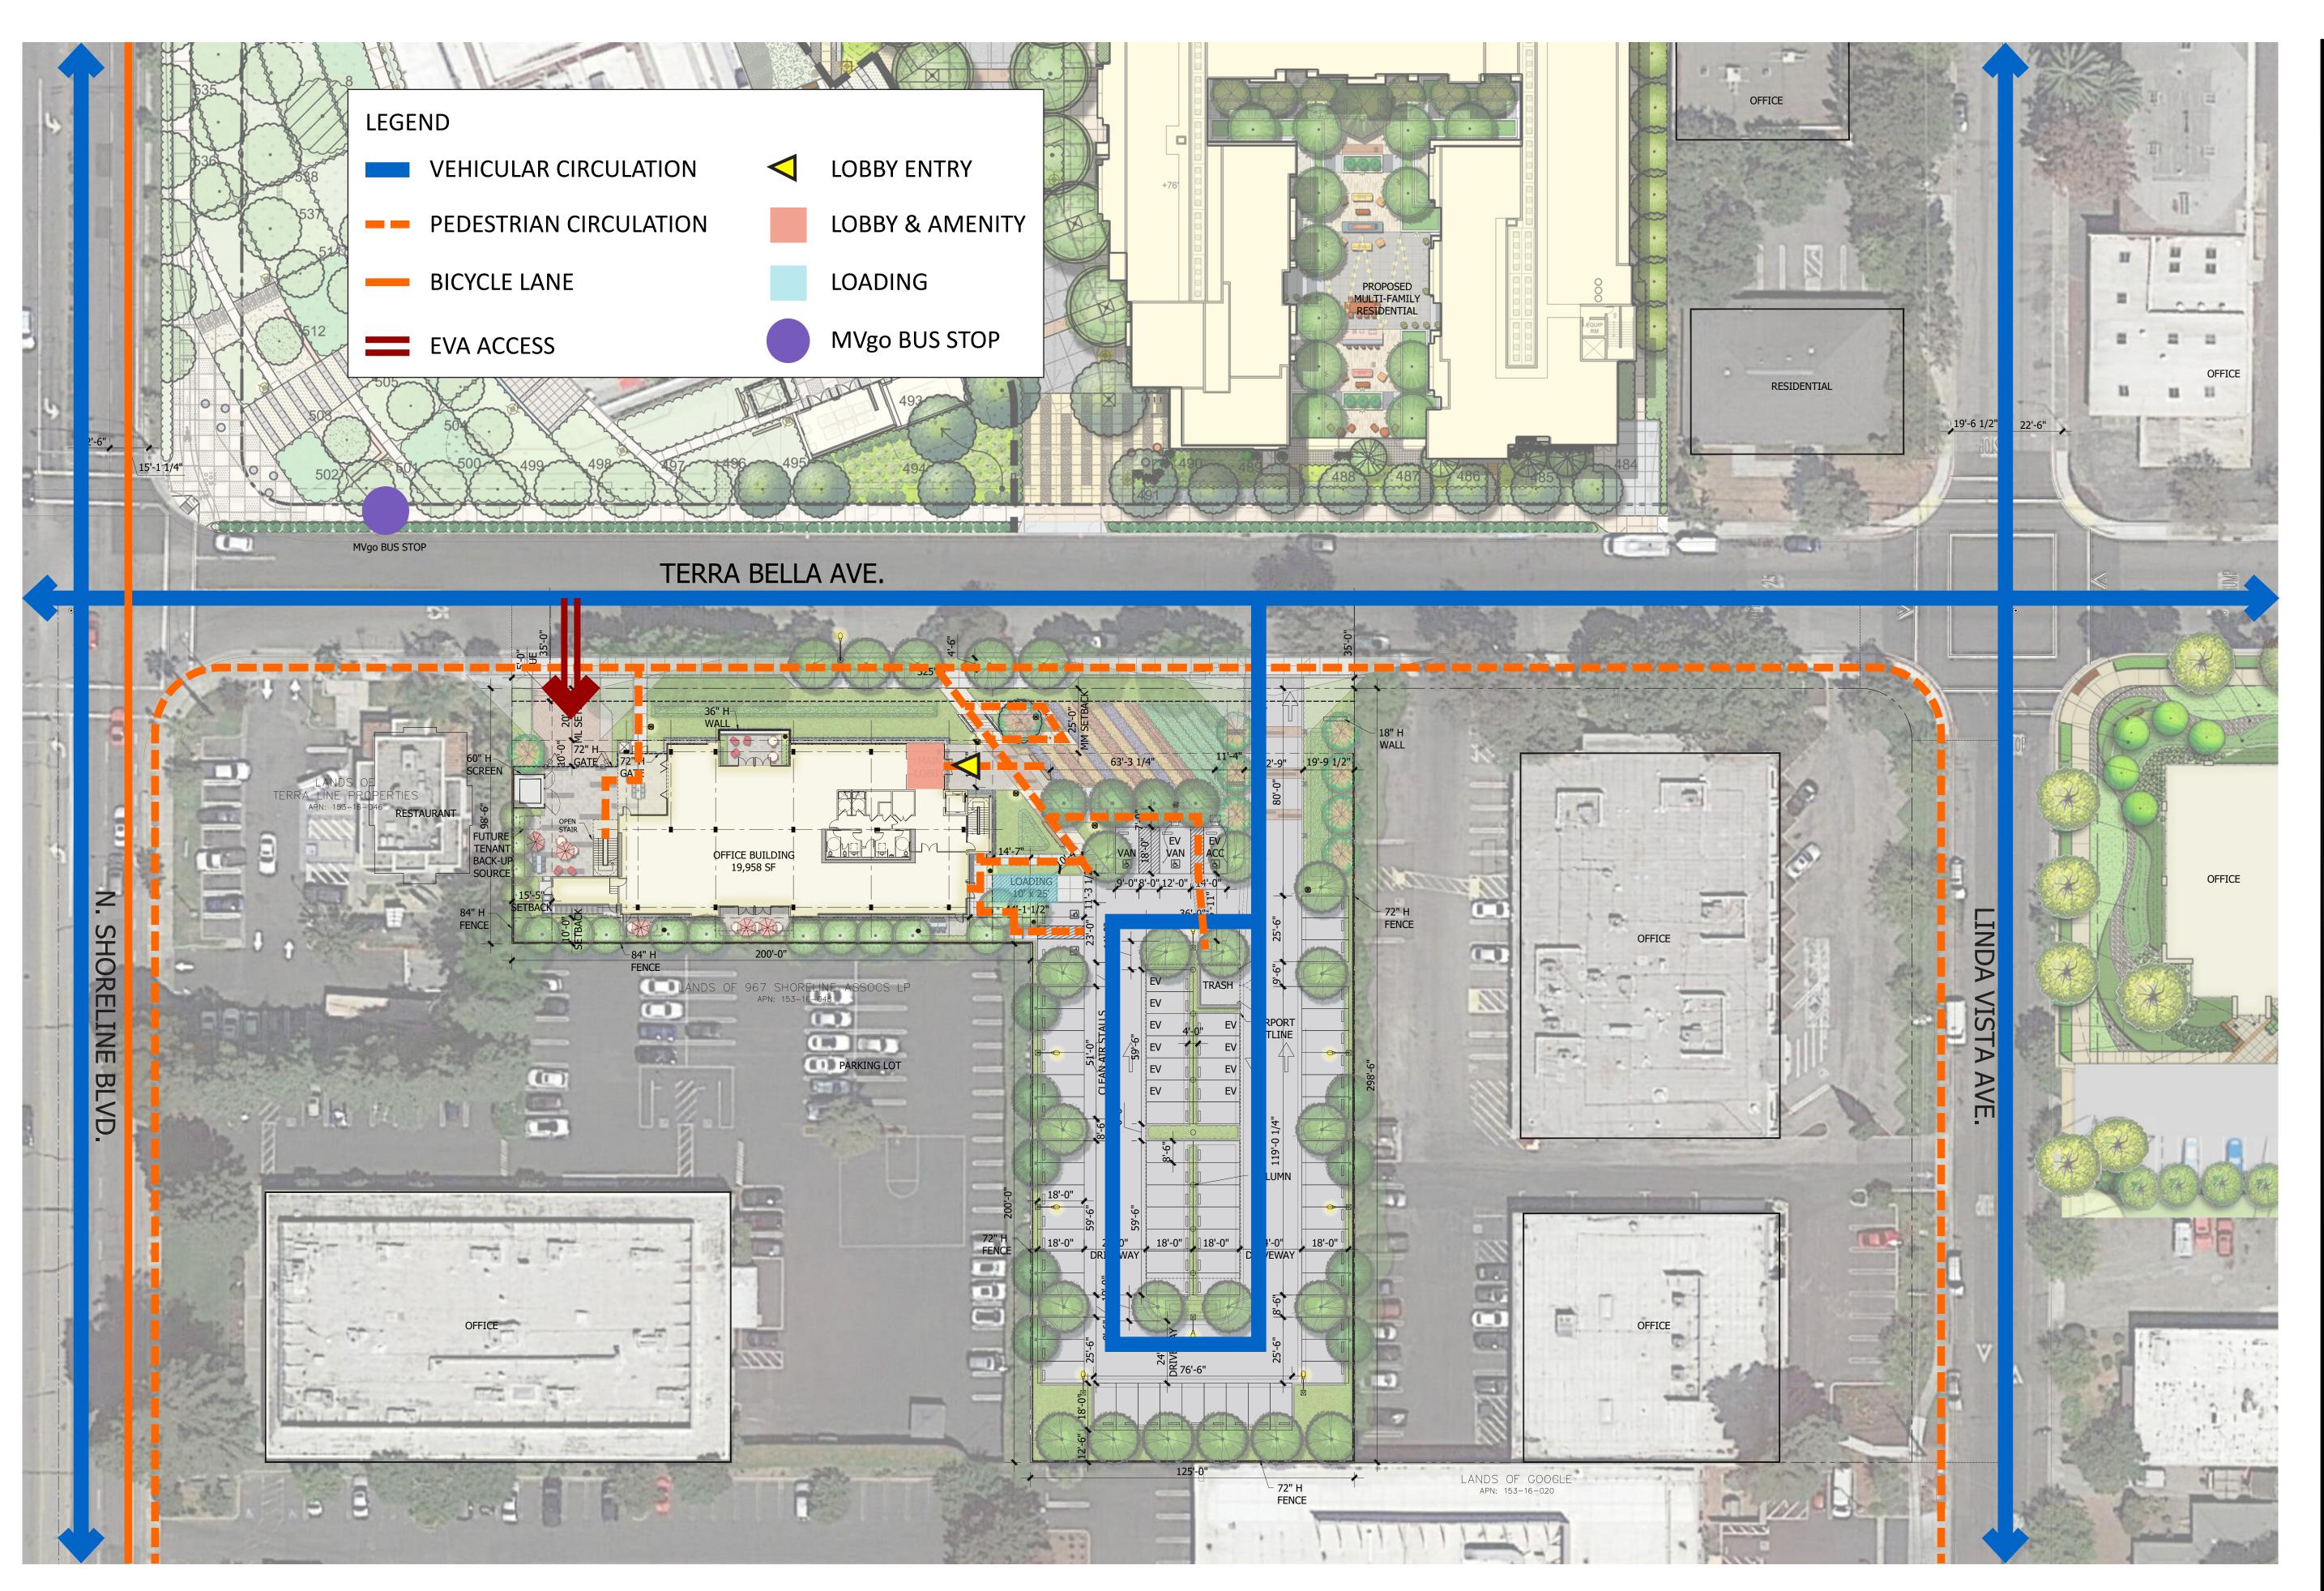
1155

CONTEXT SITE PLAN

08/26/2021 1" = 40' - 0" Drawn By:

Sheet No:

G3.0





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SITE CIRCULATION DIAGRAM

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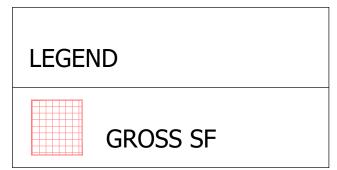
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AERIAL PERSPECTIVE

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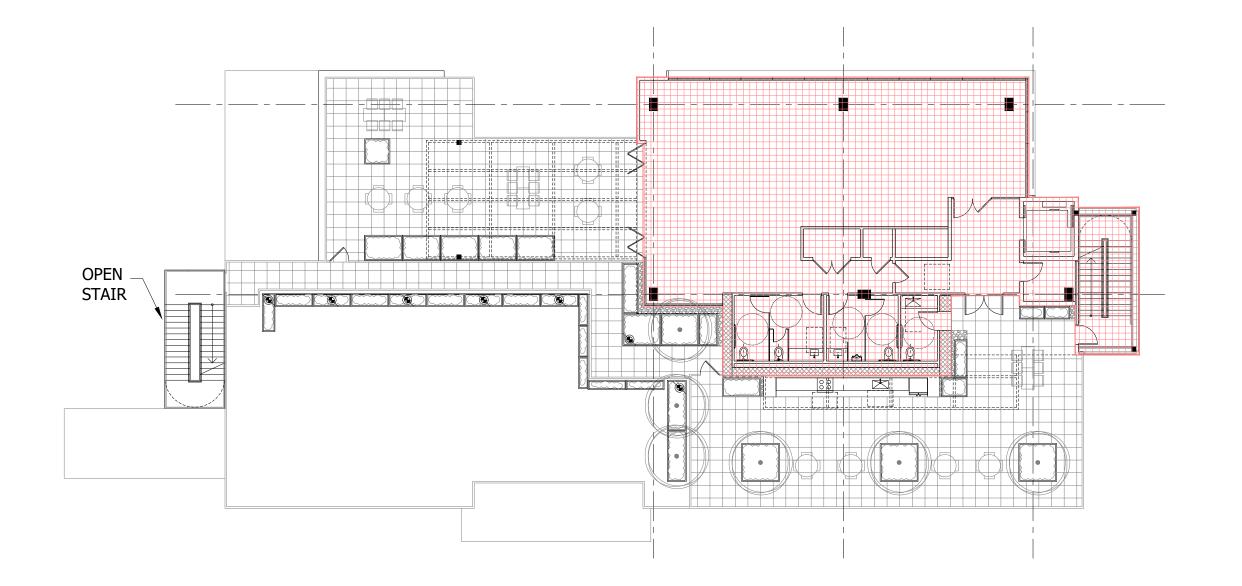
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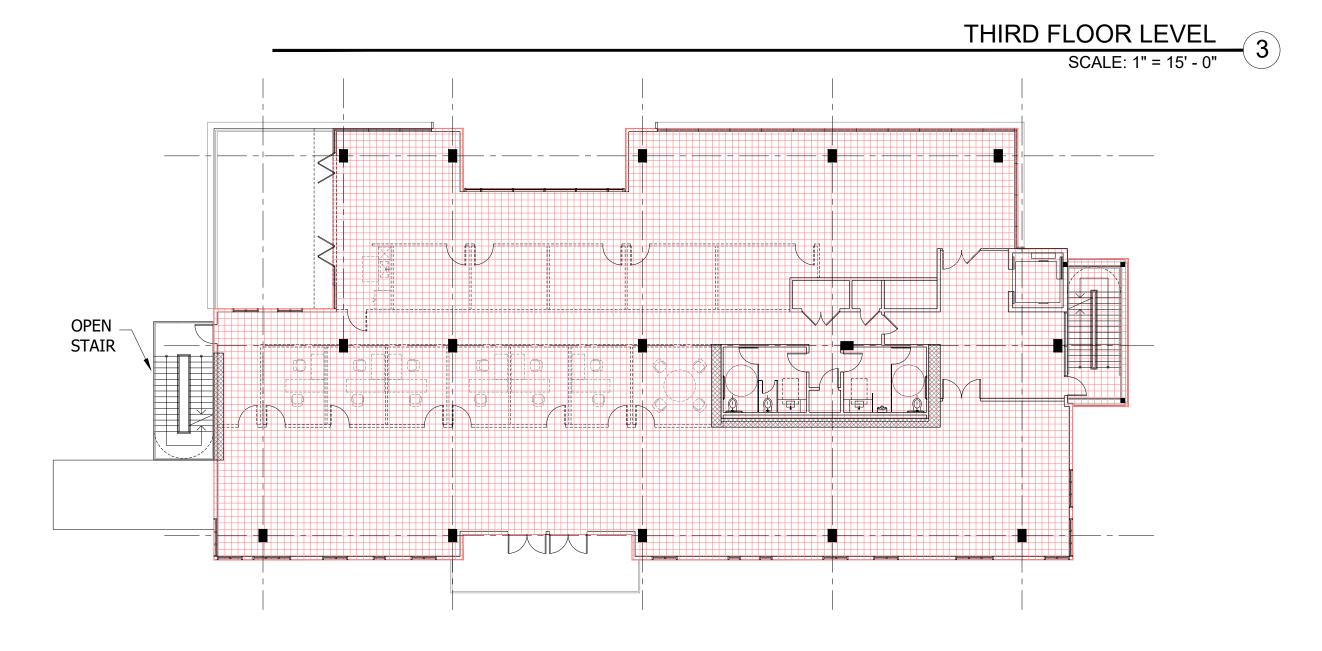
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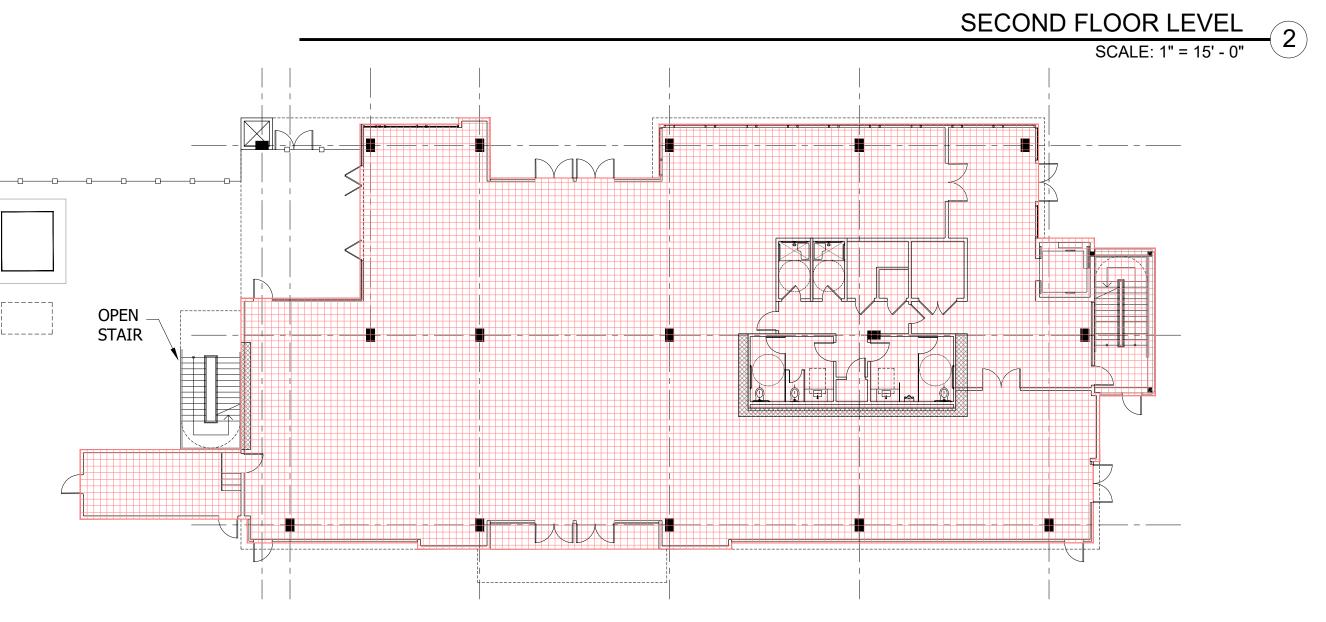


TERRA BELLA OFF	ICE BUILDING AREA CALCULATIONS
FLOOR LEVELS	GROSS SF *
LEVEL 1	8,586 SF
LEVEL 2	8,407 SF
LEVEL 3	2,965 SF
TOTAL	19,958 SF
FAR	19,958 SF / 57,024 SF = 0.34987 FAR
ALLOWABLE FAR	57,024 SF x 0.35 = 19,958 SF

* NOTE: AREA MEASURED TO THE EXTERIOR FACE OF BUILDING WALLS, INCLUDING DECKS THAT ARE NOT OPEN TO THE SKY. EXCLUDES PORTIONS OF DECKS WHICH PROJECT BEYOND THE FACE OF THE BUILDING AND EXTERIOR STAIRWAYS. NO DEDUCTIONS FOR SHAFTS OR ENCLOSED STAIRWAYS ARE INCLUDED.







FIRST FLOOR LEVEL

SCALE: 1" = 15' - 0"



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r Partners

1185 Devcor 1155




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F.A.R. CALCULATIONS

20006 Job No. 08/26/2021 Date: 1" = 15' - 0" Scale: Drawn By:

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A2.3



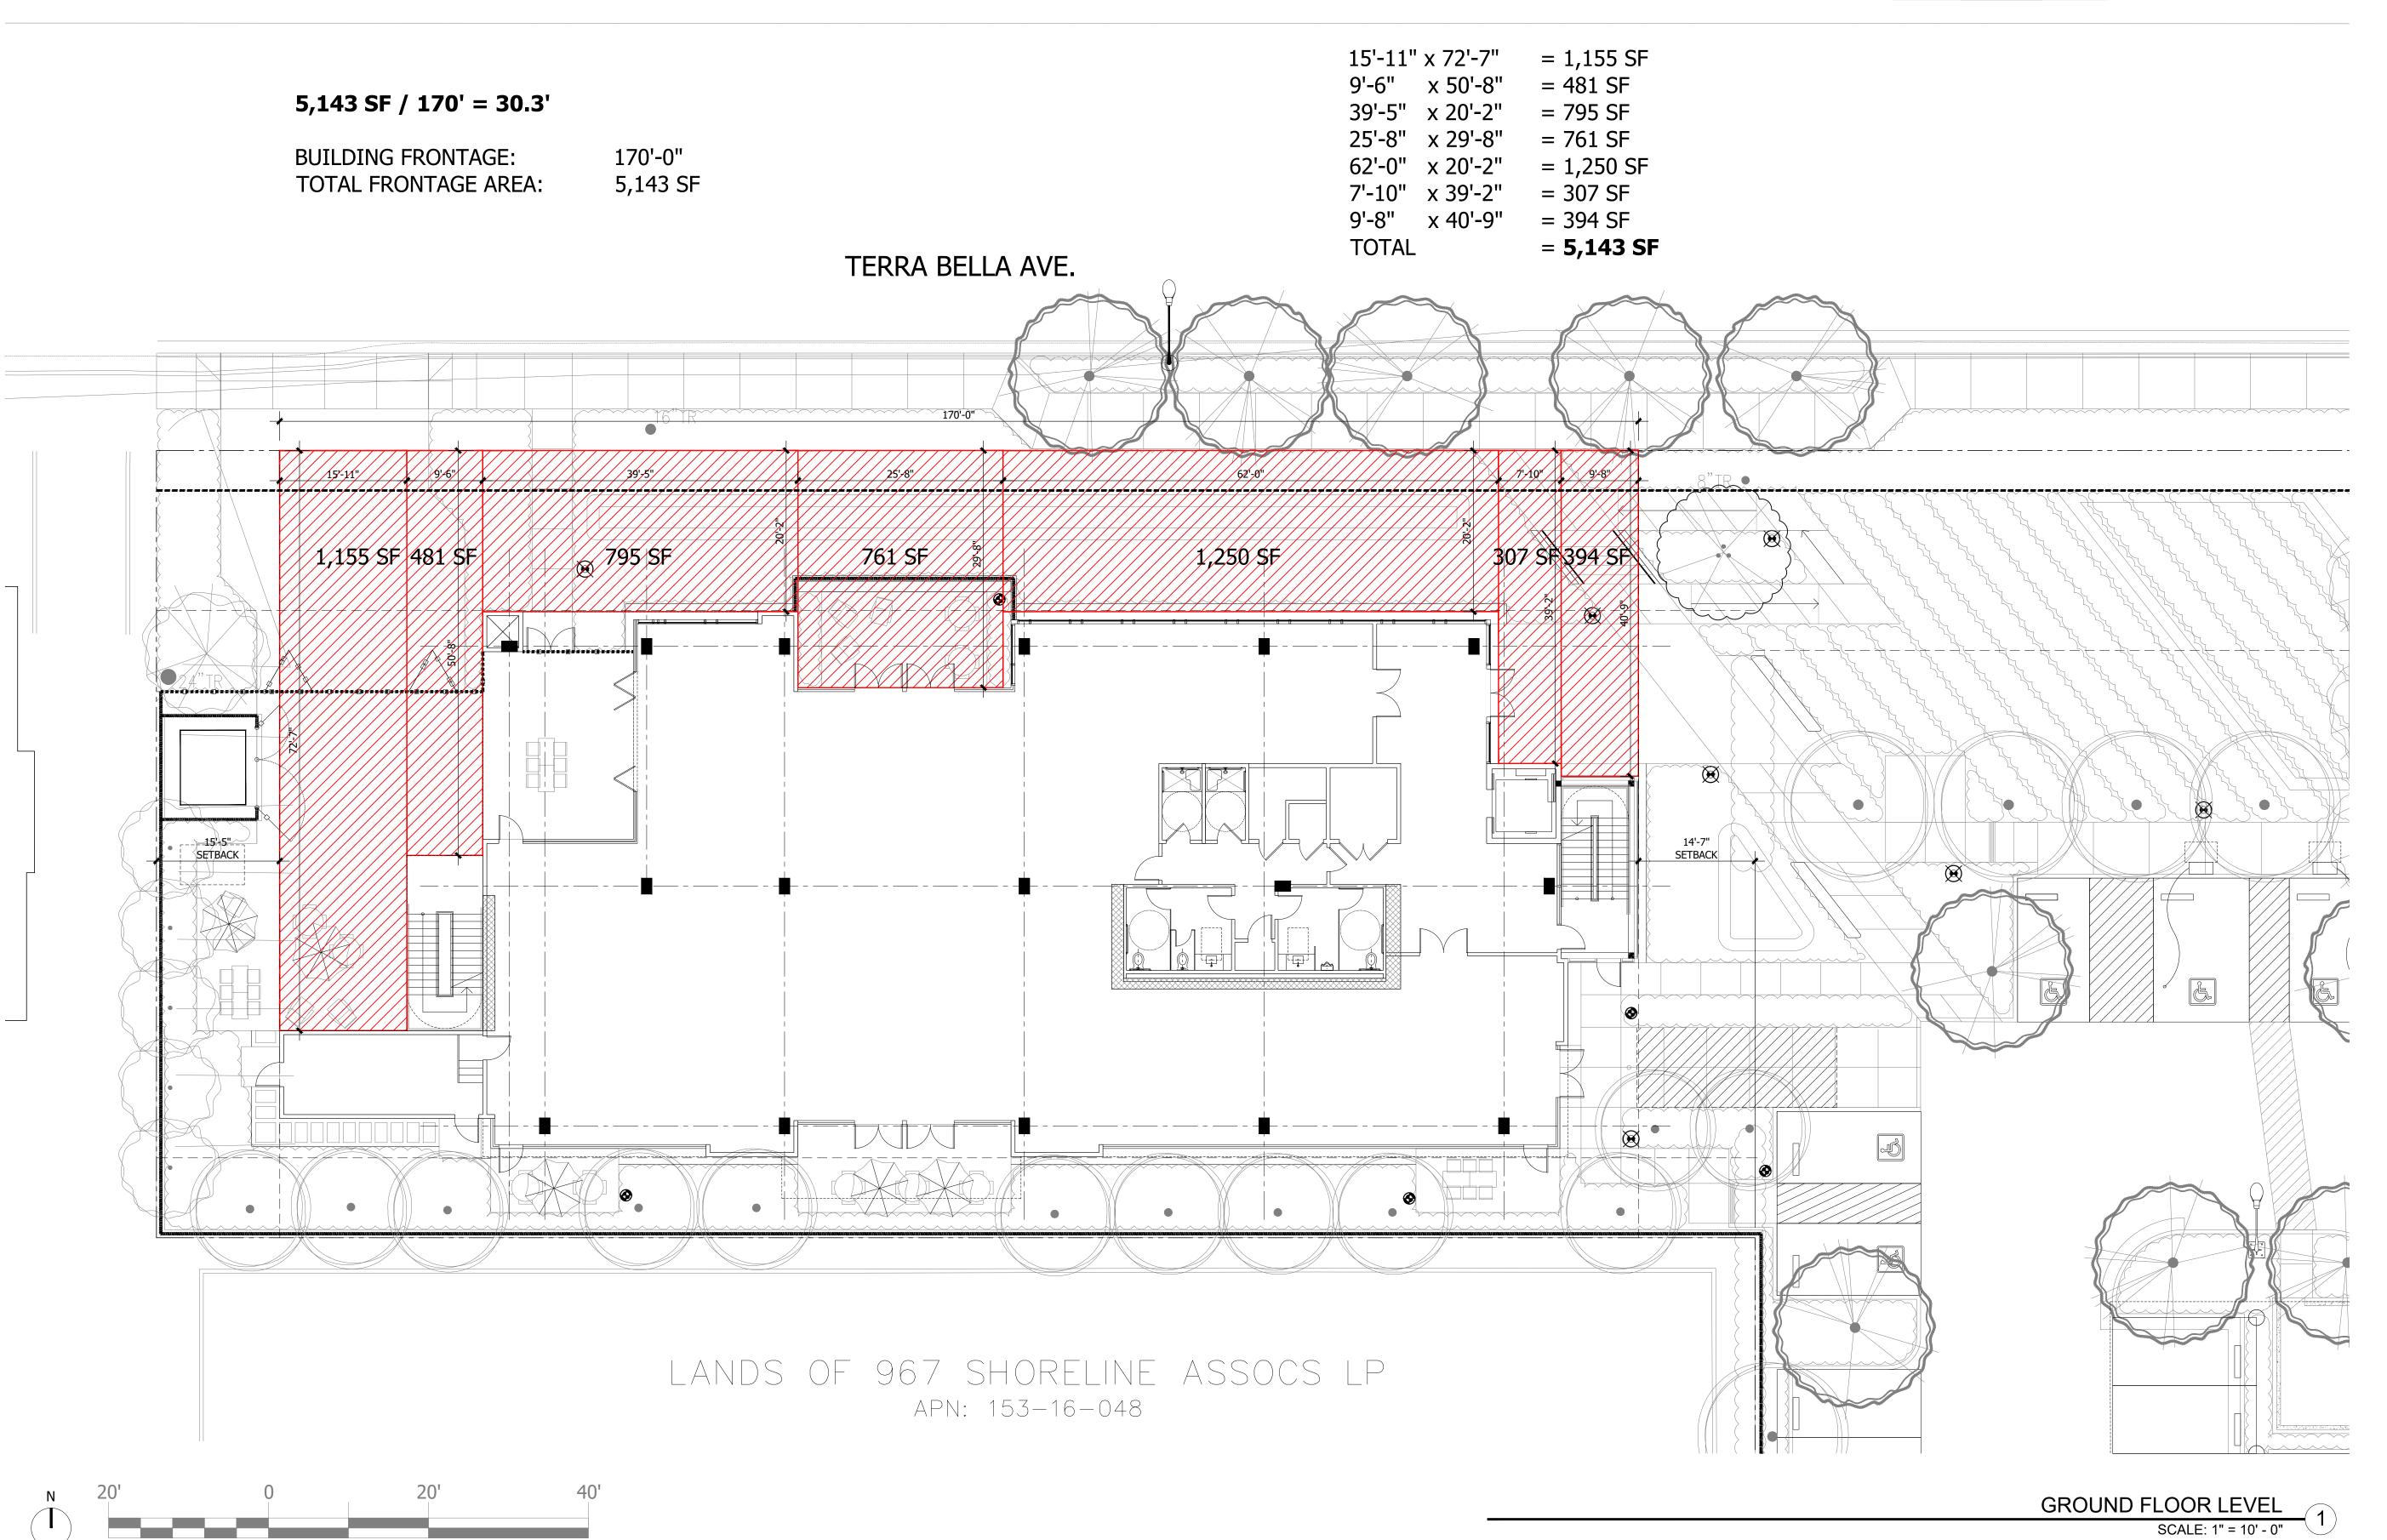

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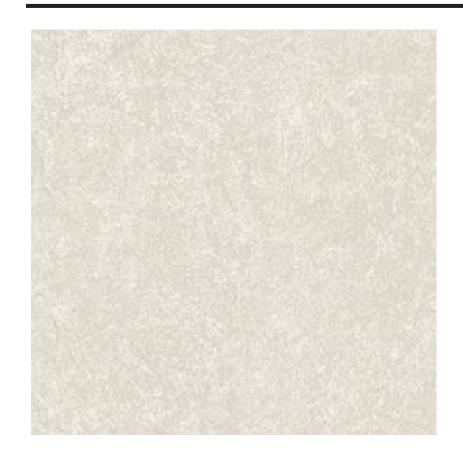
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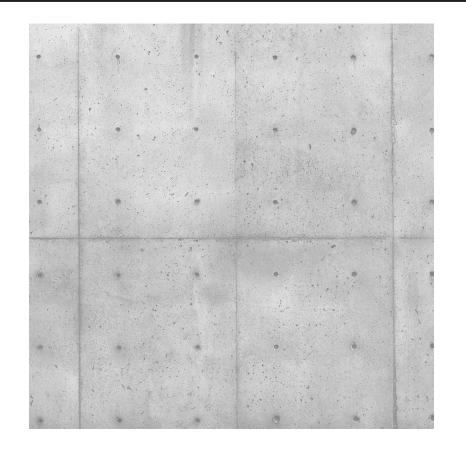
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COLORS AND MATERIAL



A1-1 COMPOSITE PANEL TRESPA METEON NA11 FRENCH LIMESTONE MATT-ROCK FINISH




A1-2 PRECAST CONCRETE WAINSCOT BASE



A2-1 ALUMINUM FRAME DARK GREY



A2-2 CORTEN STEEL PANELS ENFOLD FACADE

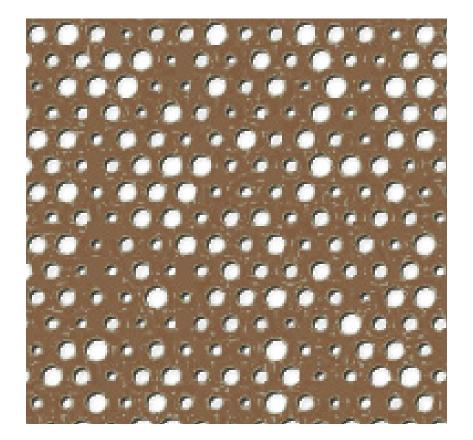

A2-3 PERFORATED CORTEN PANELS ENFOLD FACADE PATTERN B47

WINDOWS AND STOREFRONT



B1-1 STOREFRONT WINDOW/DOOR WALTERS & WOLF OR SIMILAR ALUMINUM



B1-2 BUTT JOINT GLASS SYSTEM WALTERS & WOLF OR SIMILAR



B1-3 ALUMINUM WINDOW W/ ALUMINUM TRIM SURROUND WALTERS & WOLF OR SIMILAR




B1-4 FOLDING GLASS WALLS SOLAR INNOVATIONS OR SIMILAR



C1-2 SOLAR CARPORTS

STAIR, RAILING, TRELLIS

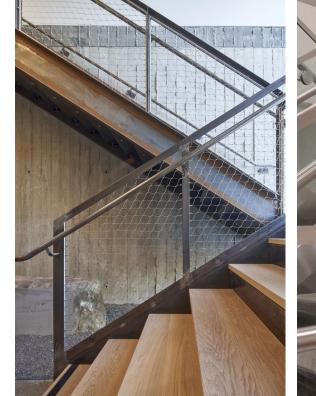


B1-5 INTERIOR METAL STAIR WOOD FINISH TREADS / GLASS RAIL



B1-6 GLASS RAILING WITH FRITTED GLASS




VIRACON - THREAT FACTOR 24 1/8" dots (screen 5006) 40% Coverage

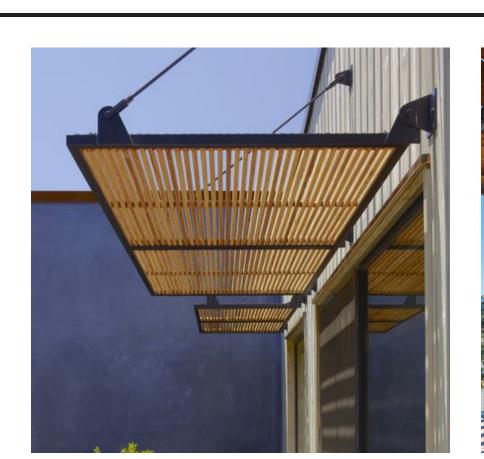

C1-1 SUN SHADE

METAL / WOOD-COLOR TRELLIS NOTE: MATERIAL SELECTION MAY USE EQUAL QUALITY ALTERNATIVES PENDING ON AVAILABILITY AT THE TIME OF CONSTRUCTION

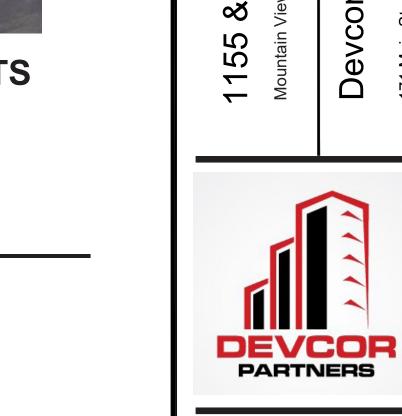

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Sheet Title: **COLORS AND MATERIALS**

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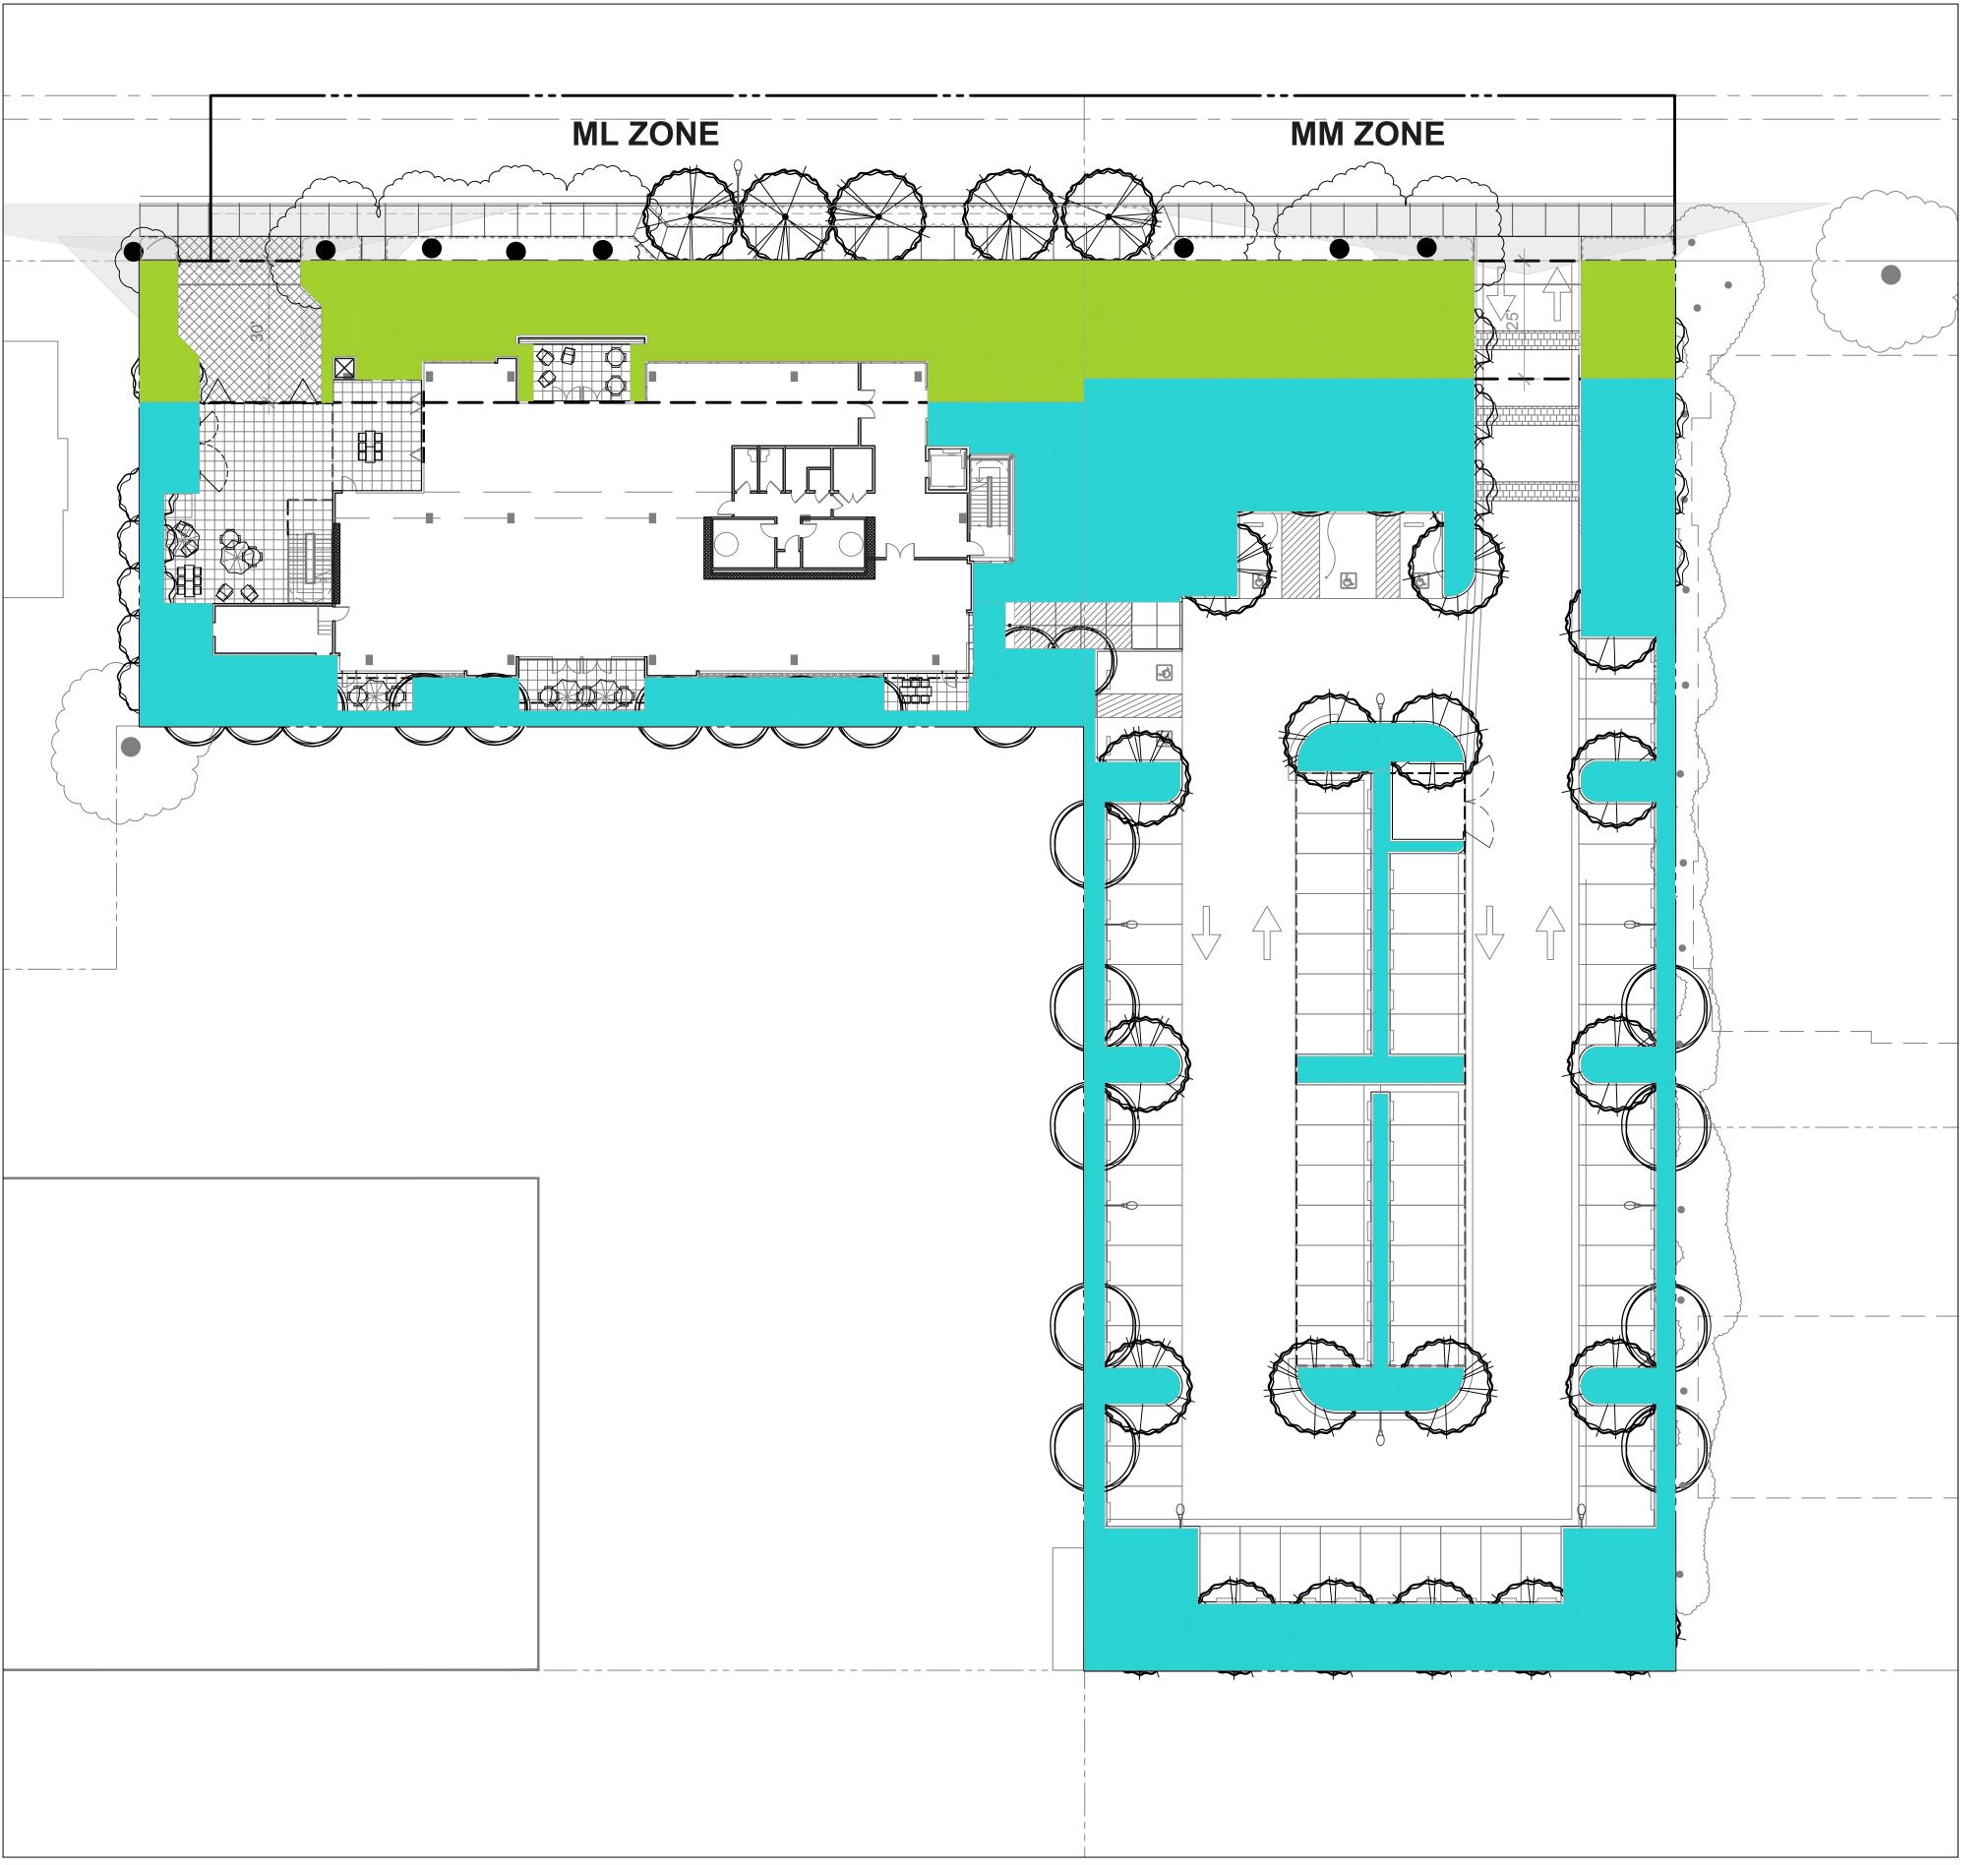
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LAND USE CALCULATIONS

ML ZONE

Area Within Setback: 6000 sf
Proposed Landscape Within Setback: 4025 sf
% Landscape (66.7% min.) 67%

Whole Site Area: 19,700 sf
Proposed Landscape Area: 7,443 sf
% Landscape (15% min.) 38%

MM ZONE

Area Within Setback: 3125 sf
Proposed Landscape Within Setback: 2558 sf
% Landscape (50% min.) 82%

Whole Site Area: 37,312.5 sf
Proposed Landscape Area: 12,506 sf
% Landscape (10% min.) 33%



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Bella Ave.

Partners, LLC.

08/26/2021 PLANNING SUBMITTAL

Sheet Title: LAND USE CALCULATIONS

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Job No. 20036

Date: 08/26/2021


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Drawn By: EE

Choot No

L3.01

Scale: 1" = 20'

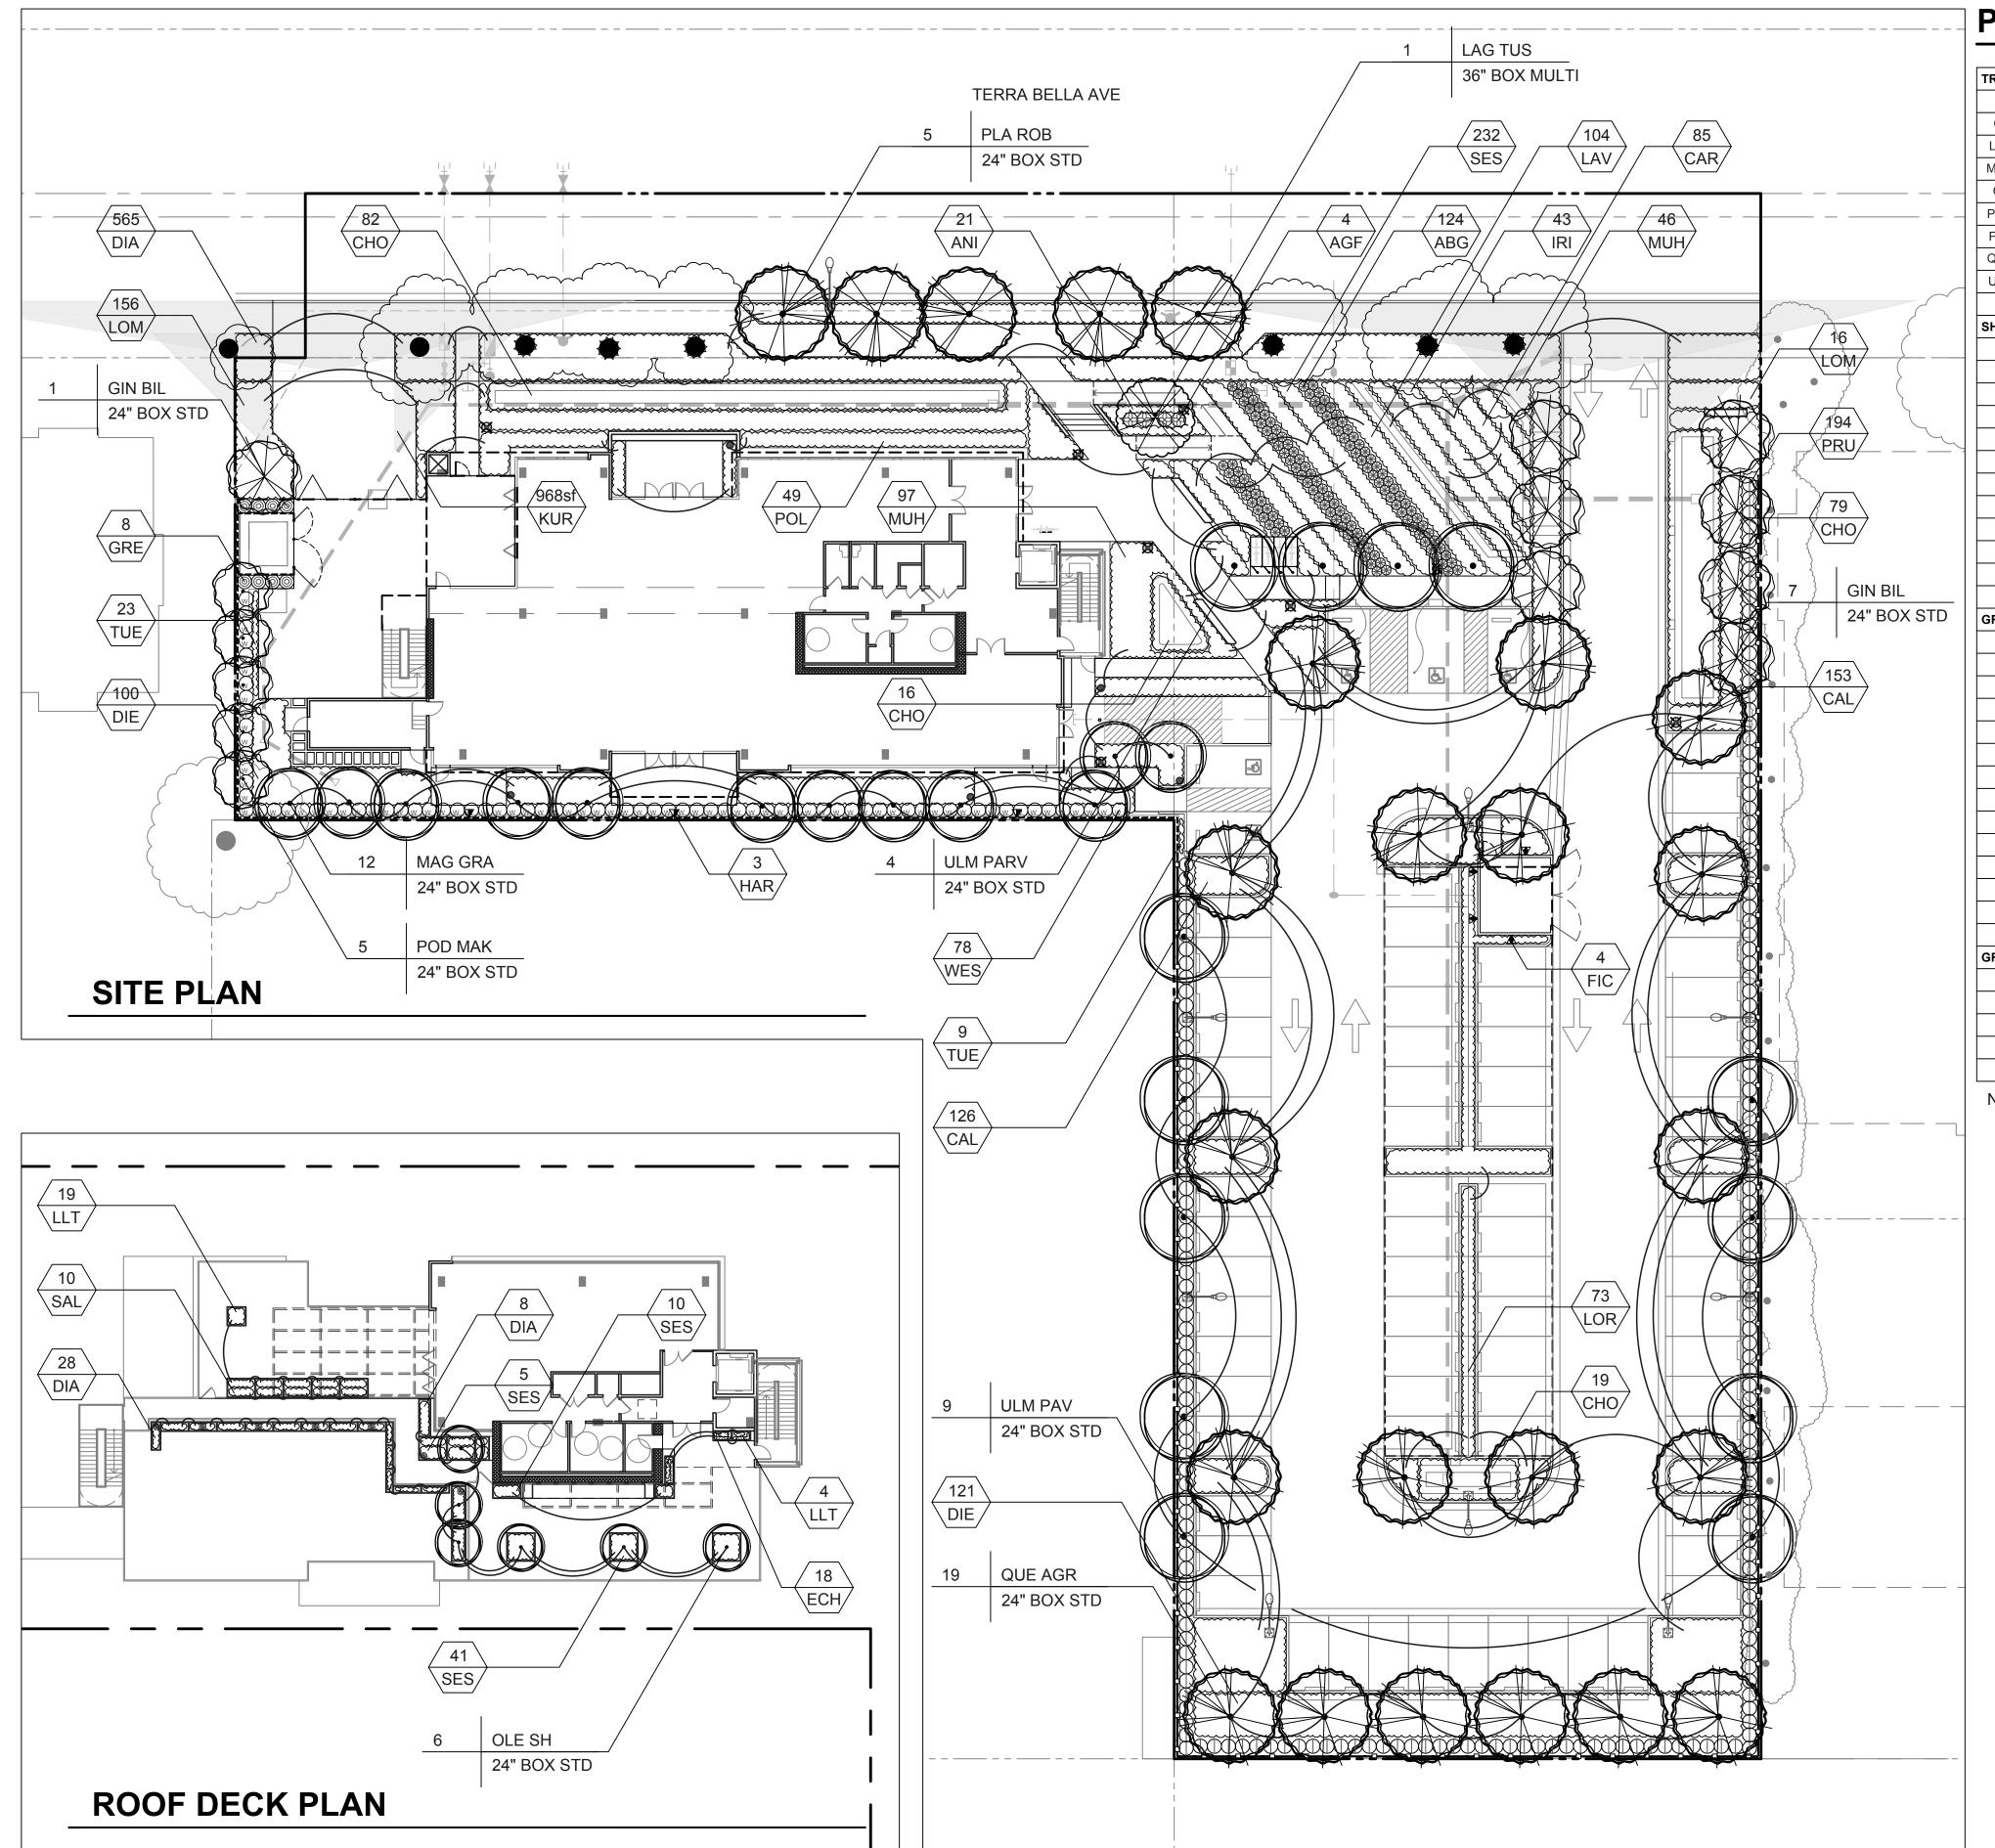

Scale: 1" = 20'

PRELIMINARY PLANT LIST

KEY	SIZE	BOTANICAL NAME	COMMON NAME		APPRX QTY	COMMENTS	WATER US
GIN BIL	Per Plan	Ginkgo biloba 'Princeton Sentry'	Princeton Sentry Ginkgo		8		М
LAG TUS	Per Plan	Lagerstroemia 'Tuscarora'	Crape Myrtle		1	Multi-trunk	L
MAG GRA	Per Plan	Magnolia g. 'Samuel Somers	Samuel Somers Southern N	Magnolia	12		M
OLE SH	Per Plan	Olea e. 'Swan Hill'	Fruitless Olive		6	Contained in Pot	VL
POD MAK	Per Plan	Podocarpus macrophyllus 'Maki'	Yew Pine		5	Std, Low Branchin	g M
PLA ROB	Per Plan	Platanus racemosa 'Roberts'	Roberts Plane Tree		5	Native	VL
QUE AGR	Per Plan	Quercus agrifolia	Coast Live Oak		19	Native	VL
ULM PAR	Per Plan	Ulmus ch. 'Parvifolia'	Chinese Elm		13		M
			Total Propos	sed Trees	69		
SHRUBS / V	INES		-1		•		
KEY	SIZE	BOTANICAL NAME	COMMON NAME	SPACING	APPRX QTY	COMMENTS	WATER US
AGF	15 gal	Agave attenuata 'Blue Flame'	Blue Flame Foxtail Agave	Per Plan	4		L
ABG	5 gal	Agave attenuata 'Blue Glow'	Blue Glow Agave	24" o.c.	124		L
CAL	5 gal	Callistemon viminalis 'Little John'	Dwarf Callistemon	36" o.c.	279		L
FIC	5 gal	Ficus pumila	Creeping Fig	Per Plan	4	Vine	M
GRE	15 gal	Grevillea 'Red Hooks'	Red Hooks Grevillea	Per Plan	8		L
HAR	5 gal	Hardenbergia v. 'Happy Wanderer'	Purple Lilac Vine	Per Plan	3	Vine	M
LOR	5 gal	Loropetalum ch. 'Daruma'	Dwarf Purple Fringe Flower	36" o.c.	73		M
POL	5 gal	Polystichum munitum	Western Sword Fern	36" o.c.	49	Native	M
PRU	5 gal	Prunus caroliniana 'Bright N Tight'	Carolina Cherry Laurel	36" o.c.	194		L
	_		•				
WES	5 gal	Westringia fruticosa 'Morning Light'	Coast Rosemary	36" o.c.	78		L
WES	5 gal	Westringia fruticosa 'Morning Light'	Coast Rosemary	36" o.c.	78		L
WES GRASSES /	_		Coast Rosemary	36" o.c.	78		L
	_		Coast Rosemary COMMON NAME		78 APPRX QTY	COMMENTS	
GRASSES /	PERRENIA	LS				COMMENTS	
GRASSES /	PERRENIA SIZE	LS BOTANICAL NAME	COMMON NAME	SPACING	APPRX QTY	COMMENTS C3*, Native	WATER US
GRASSES / KEY ANI	PERRENIA SIZE 5 gal	BOTANICAL NAME Anigozanthos 'Harmony'	COMMON NAME Yellow Kangaroo Paw	SPACING 24" o.c.	APPRX QTY		WATER US
GRASSES / KEY ANI CAR	PERRENIA SIZE 5 gal 1 gal	BOTANICAL NAME Anigozanthos 'Harmony' Carex tumulicola	COMMON NAME Yellow Kangaroo Paw Berkeley Sedge	SPACING 24" o.c. 24" o.c.	APPRX QTY 21 85	C3*, Native	WATER US L L
GRASSES / KEY ANI CAR CHO	PERRENIA SIZE 5 gal 1 gal 5 gal	BOTANICAL NAME Anigozanthos 'Harmony' Carex tumulicola Chondropetalum tectorum	COMMON NAME Yellow Kangaroo Paw Berkeley Sedge Cape Rush	SPACING 24" o.c. 24" o.c. 36" o.c.	APPRX QTY 21 85 196	C3*, Native	WATER US L L
GRASSES / KEY ANI CAR CHO DIA	PERRENIA SIZE 5 gal 1 gal 5 gal 5 gal	BOTANICAL NAME Anigozanthos 'Harmony' Carex tumulicola Chondropetalum tectorum Dianella c. 'Cassa Blue'	COMMON NAME Yellow Kangaroo Paw Berkeley Sedge Cape Rush Blue Flax Lily	SPACING 24" o.c. 24" o.c. 36" o.c. 24" o.c.	APPRX QTY 21 85 196 601	C3*, Native	WATER US L L M
GRASSES / KEY ANI CAR CHO DIA DIE	PERRENIA SIZE 5 gal 1 gal 5 gal 5 gal 5 gal	BOTANICAL NAME Anigozanthos 'Harmony' Carex tumulicola Chondropetalum tectorum Dianella c. 'Cassa Blue' Dietes bicolor	COMMON NAME Yellow Kangaroo Paw Berkeley Sedge Cape Rush Blue Flax Lily Fortnight Lily	SPACING 24" o.c. 24" o.c. 36" o.c. 24" o.c.	APPRX QTY 21 85 196 601 221	C3*, Native	WATER US L L M L
GRASSES / KEY ANI CAR CHO DIA DIE IRI	PERRENIA SIZE 5 gal 1 gal 5 gal 5 gal 5 gal 5 gal 5 gal	BOTANICAL NAME Anigozanthos 'Harmony' Carex tumulicola Chondropetalum tectorum Dianella c. 'Cassa Blue' Dietes bicolor Iris douglasiana	COMMON NAME Yellow Kangaroo Paw Berkeley Sedge Cape Rush Blue Flax Lily Fortnight Lily Pacific Coast Iris	SPACING 24" o.c. 24" o.c. 36" o.c. 24" o.c. 36" o.c. 36" o.c.	APPRX QTY 21 85 196 601 221 43	C3*, Native	WATER US L L L L L L
GRASSES / KEY ANI CAR CHO DIA DIE IRI LAV	PERRENIA SIZE 5 gal 1 gal 5 gal 5 gal 5 gal 5 gal 5 gal 5 gal	BOTANICAL NAME Anigozanthos 'Harmony' Carex tumulicola Chondropetalum tectorum Dianella c. 'Cassa Blue' Dietes bicolor Iris douglasiana Lavandula angustifolia	COMMON NAME Yellow Kangaroo Paw Berkeley Sedge Cape Rush Blue Flax Lily Fortnight Lily Pacific Coast Iris English Lavender	SPACING 24" o.c. 24" o.c. 36" o.c. 24" o.c. 36" o.c. 30" o.c.	APPRX QTY 21 85 196 601 221 43 104	C3*, Native	WATER US L L L L L L L
GRASSES / KEY ANI CAR CHO DIA DIE IRI LAV LLT	PERRENIA SIZE 5 gal 1 gal 5 gal 5 gal 5 gal 5 gal 5 gal 1 gal 1 gal	BOTANICAL NAME Anigozanthos 'Harmony' Carex tumulicola Chondropetalum tectorum Dianella c. 'Cassa Blue' Dietes bicolor Iris douglasiana Lavandula angustifolia Lomandra longifolia 'Lime Tuff'	COMMON NAME Yellow Kangaroo Paw Berkeley Sedge Cape Rush Blue Flax Lily Fortnight Lily Pacific Coast Iris English Lavender Lime Tuff Mat Rush	SPACING 24" o.c. 24" o.c. 36" o.c. 24" o.c. 36" o.c. 30" o.c. 18" o.c.	APPRX QTY 21 85 196 601 221 43 104 23	C3*, Native	WATER US L L M L L L
GRASSES / KEY ANI CAR CHO DIA DIE IRI LAV LLT LOM	PERRENIA SIZE 5 gal 1 gal 5 gal 5 gal 5 gal 5 gal 5 gal 1 gal 5 gal 5 gal 5 gal 5 gal 5 gal	BOTANICAL NAME Anigozanthos 'Harmony' Carex tumulicola Chondropetalum tectorum Dianella c. 'Cassa Blue' Dietes bicolor Iris douglasiana Lavandula angustifolia Lomandra longifolia 'Lime Tuff' Lomandra longifolia 'Breeze'	COMMON NAME Yellow Kangaroo Paw Berkeley Sedge Cape Rush Blue Flax Lily Fortnight Lily Pacific Coast Iris English Lavender Lime Tuff Mat Rush Dwarf Mat Rush	SPACING 24" o.c. 24" o.c. 36" o.c. 24" o.c. 36" o.c. 30" o.c. 30" o.c. 18" o.c.	APPRX QTY 21 85 196 601 221 43 104 23 172	C3*, Native C3* C3*, Native	WATER US L L L L L L L L L
GRASSES / KEY ANI CAR CHO DIA DIE IRI LAV LLT LOM MUH	PERRENIA SIZE 5 gal 1 gal 5 gal	BOTANICAL NAME Anigozanthos 'Harmony' Carex tumulicola Chondropetalum tectorum Dianella c. 'Cassa Blue' Dietes bicolor Iris douglasiana Lavandula angustifolia Lomandra longifolia 'Lime Tuff' Lomandra longifolia 'Breeze' Muhlenbergia rigens	COMMON NAME Yellow Kangaroo Paw Berkeley Sedge Cape Rush Blue Flax Lily Fortnight Lily Pacific Coast Iris English Lavender Lime Tuff Mat Rush Dwarf Mat Rush Deer Grass	SPACING 24" o.c. 24" o.c. 36" o.c. 36" o.c. 30" o.c. 30" o.c. 30" o.c. 30" o.c.	APPRX QTY 21 85 196 601 221 43 104 23 172 143	C3*, Native C3* C3*, Native	WATER US L L L L L L L L
GRASSES / KEY ANI CAR CHO DIA DIE IRI LAV LLT LOM MUH SAL	PERRENIA SIZE 5 gal 1 gal 5 gal	BOTANICAL NAME Anigozanthos 'Harmony' Carex tumulicola Chondropetalum tectorum Dianella c. 'Cassa Blue' Dietes bicolor Iris douglasiana Lavandula angustifolia Lomandra longifolia 'Lime Tuff' Lomandra longifolia 'Breeze' Muhlenbergia rigens Salvia greggii 'Navajo Purple'	COMMON NAME Yellow Kangaroo Paw Berkeley Sedge Cape Rush Blue Flax Lily Fortnight Lily Pacific Coast Iris English Lavender Lime Tuff Mat Rush Dwarf Mat Rush Deer Grass Purple Sage	SPACING 24" o.c. 24" o.c. 36" o.c. 36" o.c. 30" o.c. 18" o.c. 30" o.c. 24" o.c.	APPRX QTY 21 85 196 601 221 43 104 23 172 143 10	C3*, Native C3* C3*, Native	WATER US L L M L L L L L L L L L L
GRASSES / KEY ANI CAR CHO DIA DIE IRI LAV LLT LOM MUH SAL	PERRENIA SIZE 5 gal 1 gal 5 gal 1 gal 5 gal 1 gal 5 gal 1 gal 5 gal 1 gal	BOTANICAL NAME Anigozanthos 'Harmony' Carex tumulicola Chondropetalum tectorum Dianella c. 'Cassa Blue' Dietes bicolor Iris douglasiana Lavandula angustifolia Lomandra longifolia 'Lime Tuff' Lomandra longifolia 'Breeze' Muhlenbergia rigens Salvia greggii 'Navajo Purple'	COMMON NAME Yellow Kangaroo Paw Berkeley Sedge Cape Rush Blue Flax Lily Fortnight Lily Pacific Coast Iris English Lavender Lime Tuff Mat Rush Dwarf Mat Rush Deer Grass Purple Sage	SPACING 24" o.c. 24" o.c. 36" o.c. 36" o.c. 30" o.c. 18" o.c. 30" o.c. 24" o.c.	APPRX QTY 21 85 196 601 221 43 104 23 172 143 10	C3*, Native C3* C3*, Native	WATER US L L L L L L L L L L L L L
GRASSES / KEY ANI CAR CHO DIA DIE IRI LAV LLT LOM MUH SAL SES	PERRENIA SIZE 5 gal 1 gal 5 gal 1 gal 5 gal 1 gal 5 gal 1 gal 5 gal 1 gal	BOTANICAL NAME Anigozanthos 'Harmony' Carex tumulicola Chondropetalum tectorum Dianella c. 'Cassa Blue' Dietes bicolor Iris douglasiana Lavandula angustifolia Lomandra longifolia 'Lime Tuff' Lomandra longifolia 'Breeze' Muhlenbergia rigens Salvia greggii 'Navajo Purple'	COMMON NAME Yellow Kangaroo Paw Berkeley Sedge Cape Rush Blue Flax Lily Fortnight Lily Pacific Coast Iris English Lavender Lime Tuff Mat Rush Dwarf Mat Rush Deer Grass Purple Sage	SPACING 24" o.c. 24" o.c. 36" o.c. 36" o.c. 30" o.c. 30" o.c. 18" o.c. 36" o.c. 24" o.c.	APPRX QTY 21 85 196 601 221 43 104 23 172 143 10	C3*, Native C3* C3*, Native	WATER US L L M L L L L L L L
GRASSES / KEY ANI CAR CHO DIA DIE IRI LAV LLT LOM MUH SAL SES	PERRENIA SIZE 5 gal 1 gal 5 gal 5 gal 5 gal 5 gal 5 gal 5 gal 7 gal 5 gal 7 gal 8 gal 9 gal	BOTANICAL NAME Anigozanthos 'Harmony' Carex tumulicola Chondropetalum tectorum Dianella c. 'Cassa Blue' Dietes bicolor Iris douglasiana Lavandula angustifolia Lomandra longifolia 'Lime Tuff' Lomandra longifolia 'Breeze' Muhlenbergia rigens Salvia greggii 'Navajo Purple' Sesleria autumnalis	COMMON NAME Yellow Kangaroo Paw Berkeley Sedge Cape Rush Blue Flax Lily Fortnight Lily Pacific Coast Iris English Lavender Lime Tuff Mat Rush Dwarf Mat Rush Deer Grass Purple Sage Autumn Moor Grass	SPACING 24" o.c. 24" o.c. 36" o.c. 36" o.c. 30" o.c. 30" o.c. 18" o.c. 36" o.c. 24" o.c.	APPRX QTY 21 85 196 601 221 43 104 23 172 143 10 288	C3*, Native C3* C3*, Native	WATER US L L L L L L L L L L L M
GRASSES / KEY ANI CAR CHO DIA DIE IRI LAV LLT LOM MUH SAL SES GROUNDCO	PERRENIA SIZE 5 gal 1 gal 5 gal 1 gal 5 gal 5 gal 7 gal 8 gal 8 gal 9 gal	BOTANICAL NAME Anigozanthos 'Harmony' Carex tumulicola Chondropetalum tectorum Dianella c. 'Cassa Blue' Dietes bicolor Iris douglasiana Lavandula angustifolia Lomandra longifolia 'Lime Tuff' Lomandra longifolia 'Breeze' Muhlenbergia rigens Salvia greggii 'Navajo Purple' Sesleria autumnalis	COMMON NAME Yellow Kangaroo Paw Berkeley Sedge Cape Rush Blue Flax Lily Fortnight Lily Pacific Coast Iris English Lavender Lime Tuff Mat Rush Dwarf Mat Rush Deer Grass Purple Sage Autumn Moor Grass COMMON NAME	SPACING 24" o.c. 24" o.c. 36" o.c. 24" o.c. 30" o.c. 30" o.c. 30" o.c. 48" o.c. 36" o.c. 56" o.c. 58" o.c. 24" o.c.	APPRX QTY 21 85 196 601 221 43 104 23 172 143 10 288	C3*, Native C3* C3*, Native	WATER US L L L L L L L W W U L L L L L L L L L

- 1. C3* Denotes plants suitable for stormwater treatment planting, per the Appendix D



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08/26/2021 PLANNING SUBMITTAL

Sheet Title: PLANTING PLAN

20036 Job No. 08/26/2021 1" = 20'-0"


Sheet No:


Drawn By: EE

of the SCVURPPP C.3 Stormwater Handbook. S.C.D.


2. Water Use based on WUCOLS IV.

3. Kurapia ** - Available through Delta Bluegrass Co, 800.637.8873

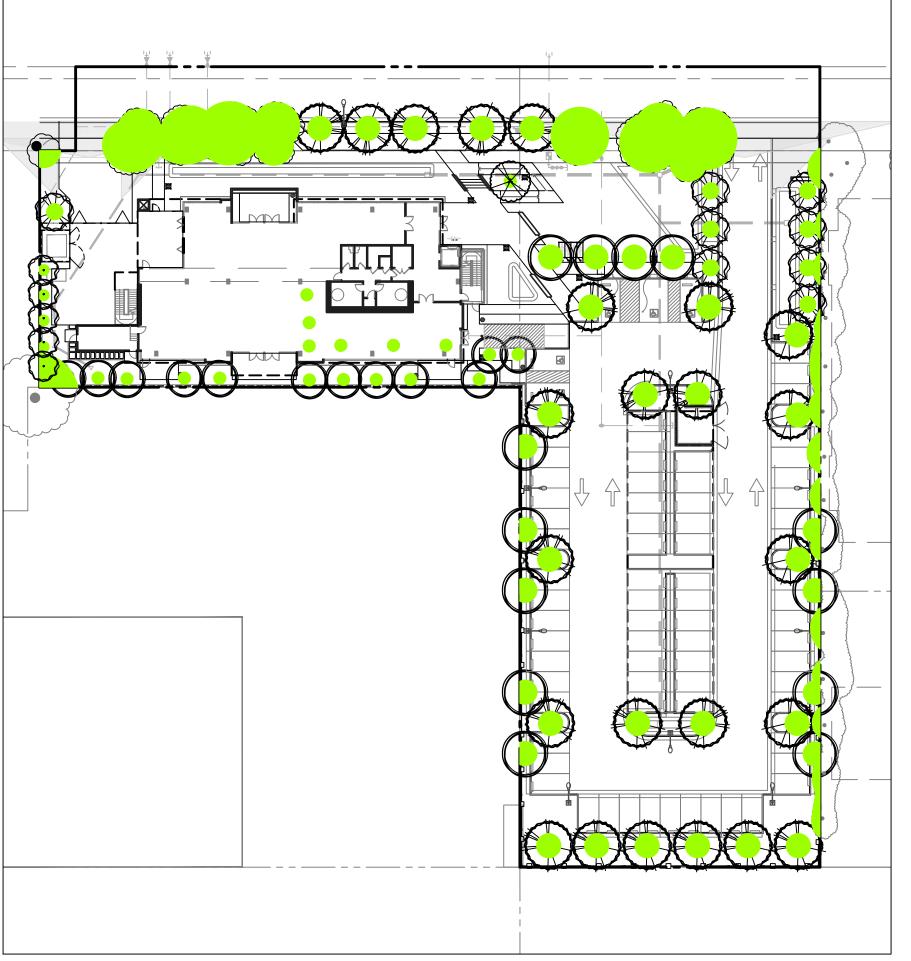


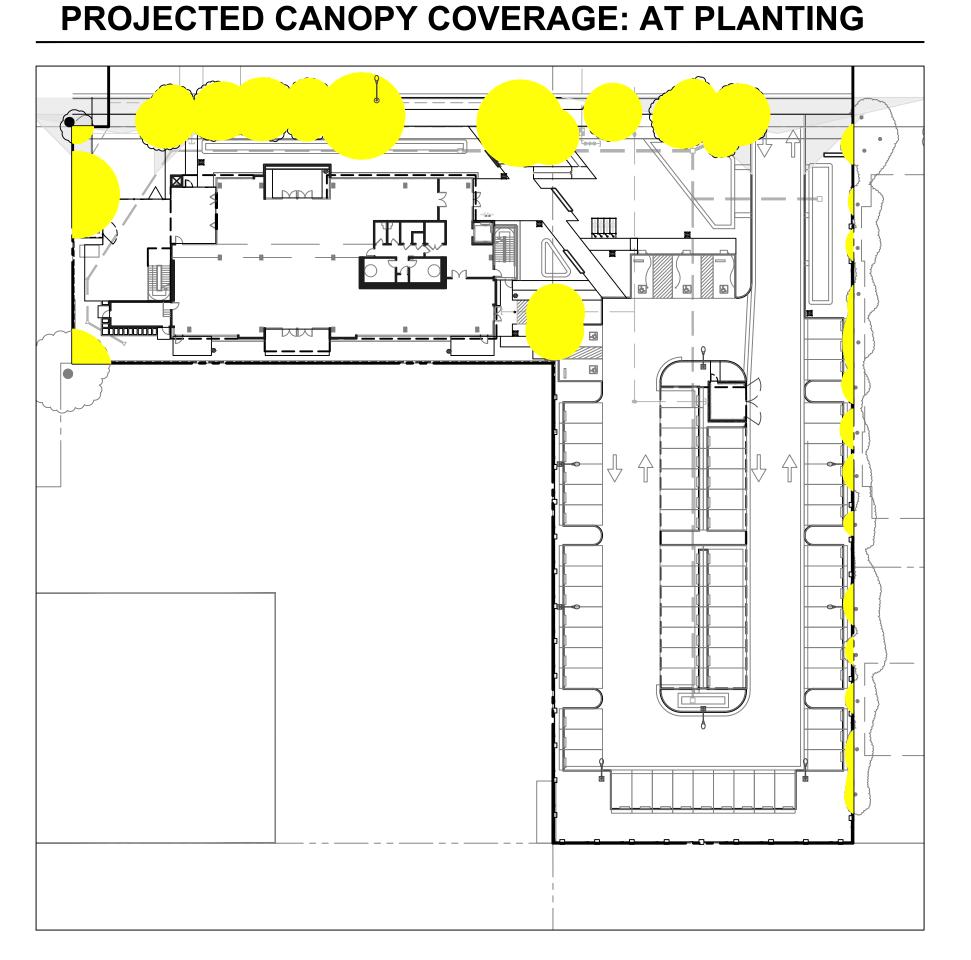

EXISTING CANOPY COVERAGE

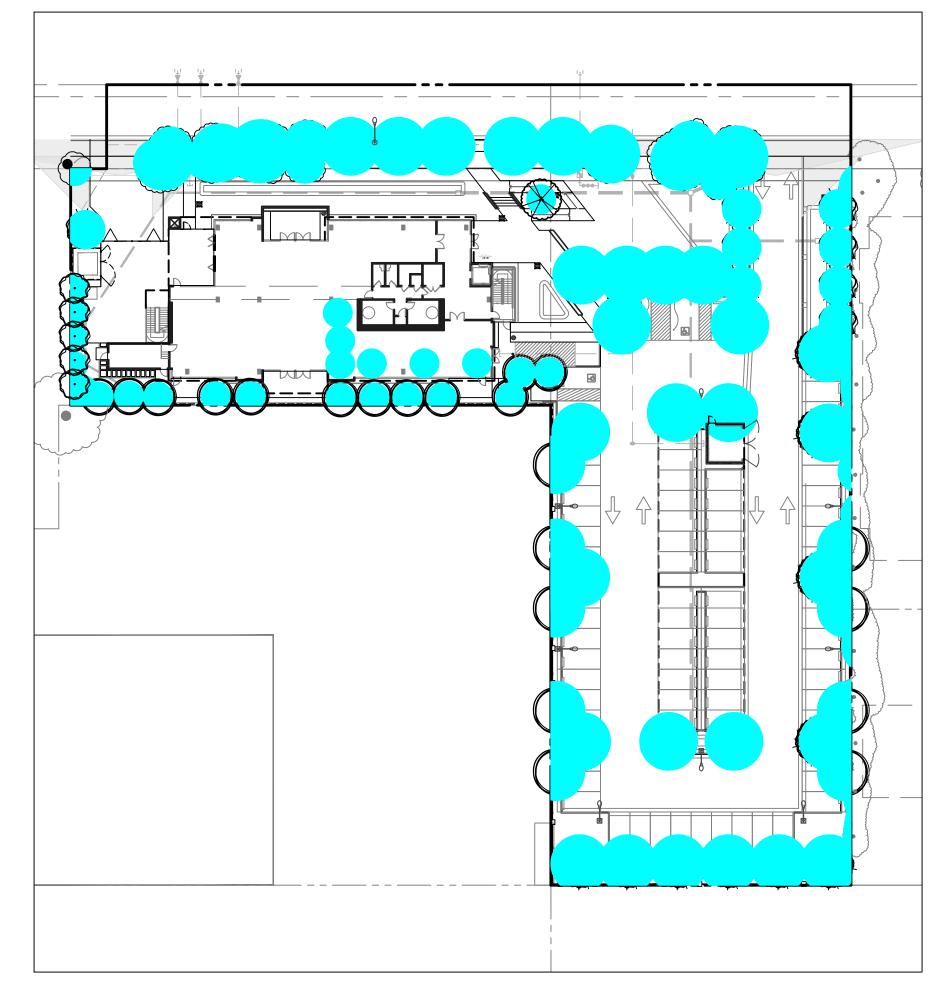

PROJECTED CANOPY COVERAGE: AFTER 5 YEARS

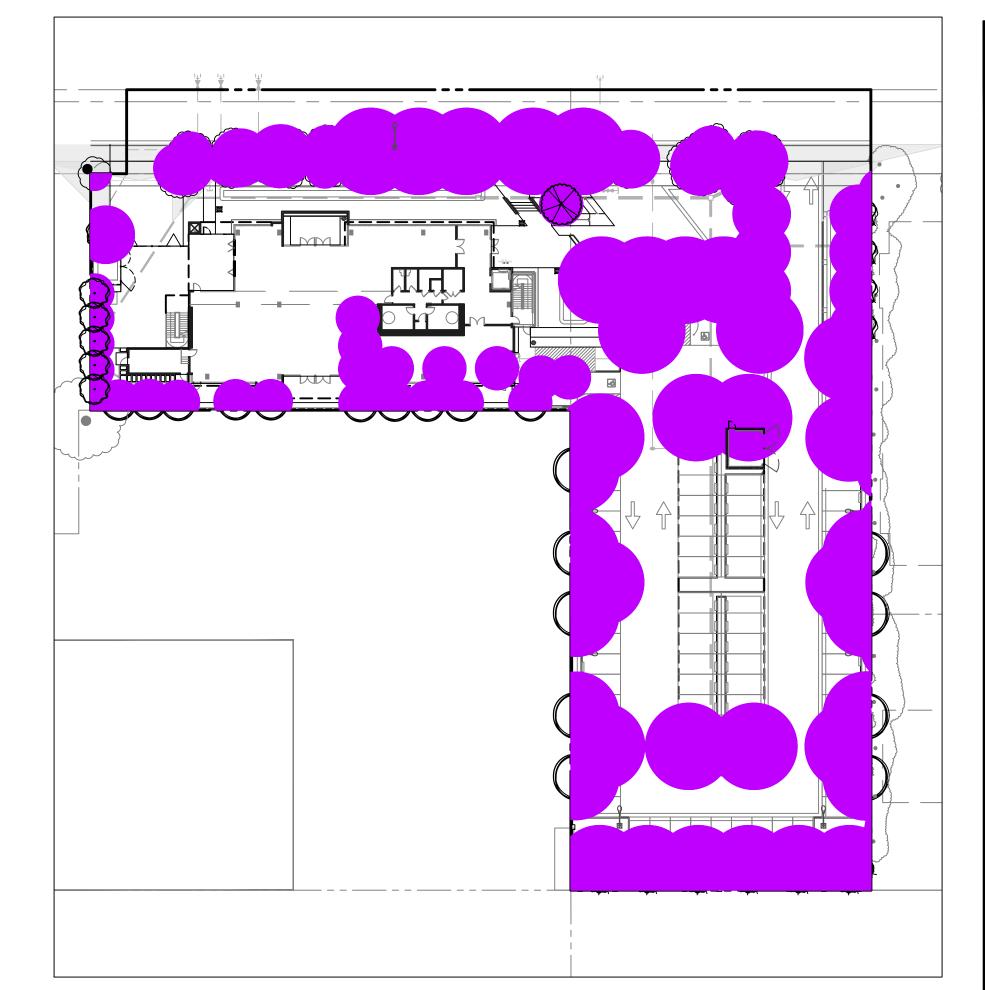

PROJECTED CANOPY COVERAGE: AFTER 15 YEARS (MATURITY)

TREE CANOPY COVERAGE CALCULATIONS

Total Lot Area: 67,875 sf *	AREA	% SITE
EXISTING CANOPY COVERAGE	7,481 sf	11%
CANOPY AT PLANTING	7,567 sf	11%
CANOPY AT 5 YEARS	20,684 sf	30%
CANOPY AT 15 YEARS	32,129 sf	47%
 CANOPY COVERAGE CALCULA' EXISTING TREES TO REMAIN. CANOPY COVERAGE IS CALCUL CANOPIES OUTSIDE PROPERTY CALCULATIONS. Tree Canopy at Planting — Tree Canopy after 5 years growth — Tree Canopy after 15 years growth — 	LATED TO EDGE OF PRO	OPERTY LINE.
Property Line ——		
Existing Tree Canopy ——		
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Sheet Title:
TREE CANOPY
PLAN

155

Job No. 20036


Date: 08/26/2021

Scale: 1" = 20'-0"

Drawn By: EE

Sheet No

L4.02

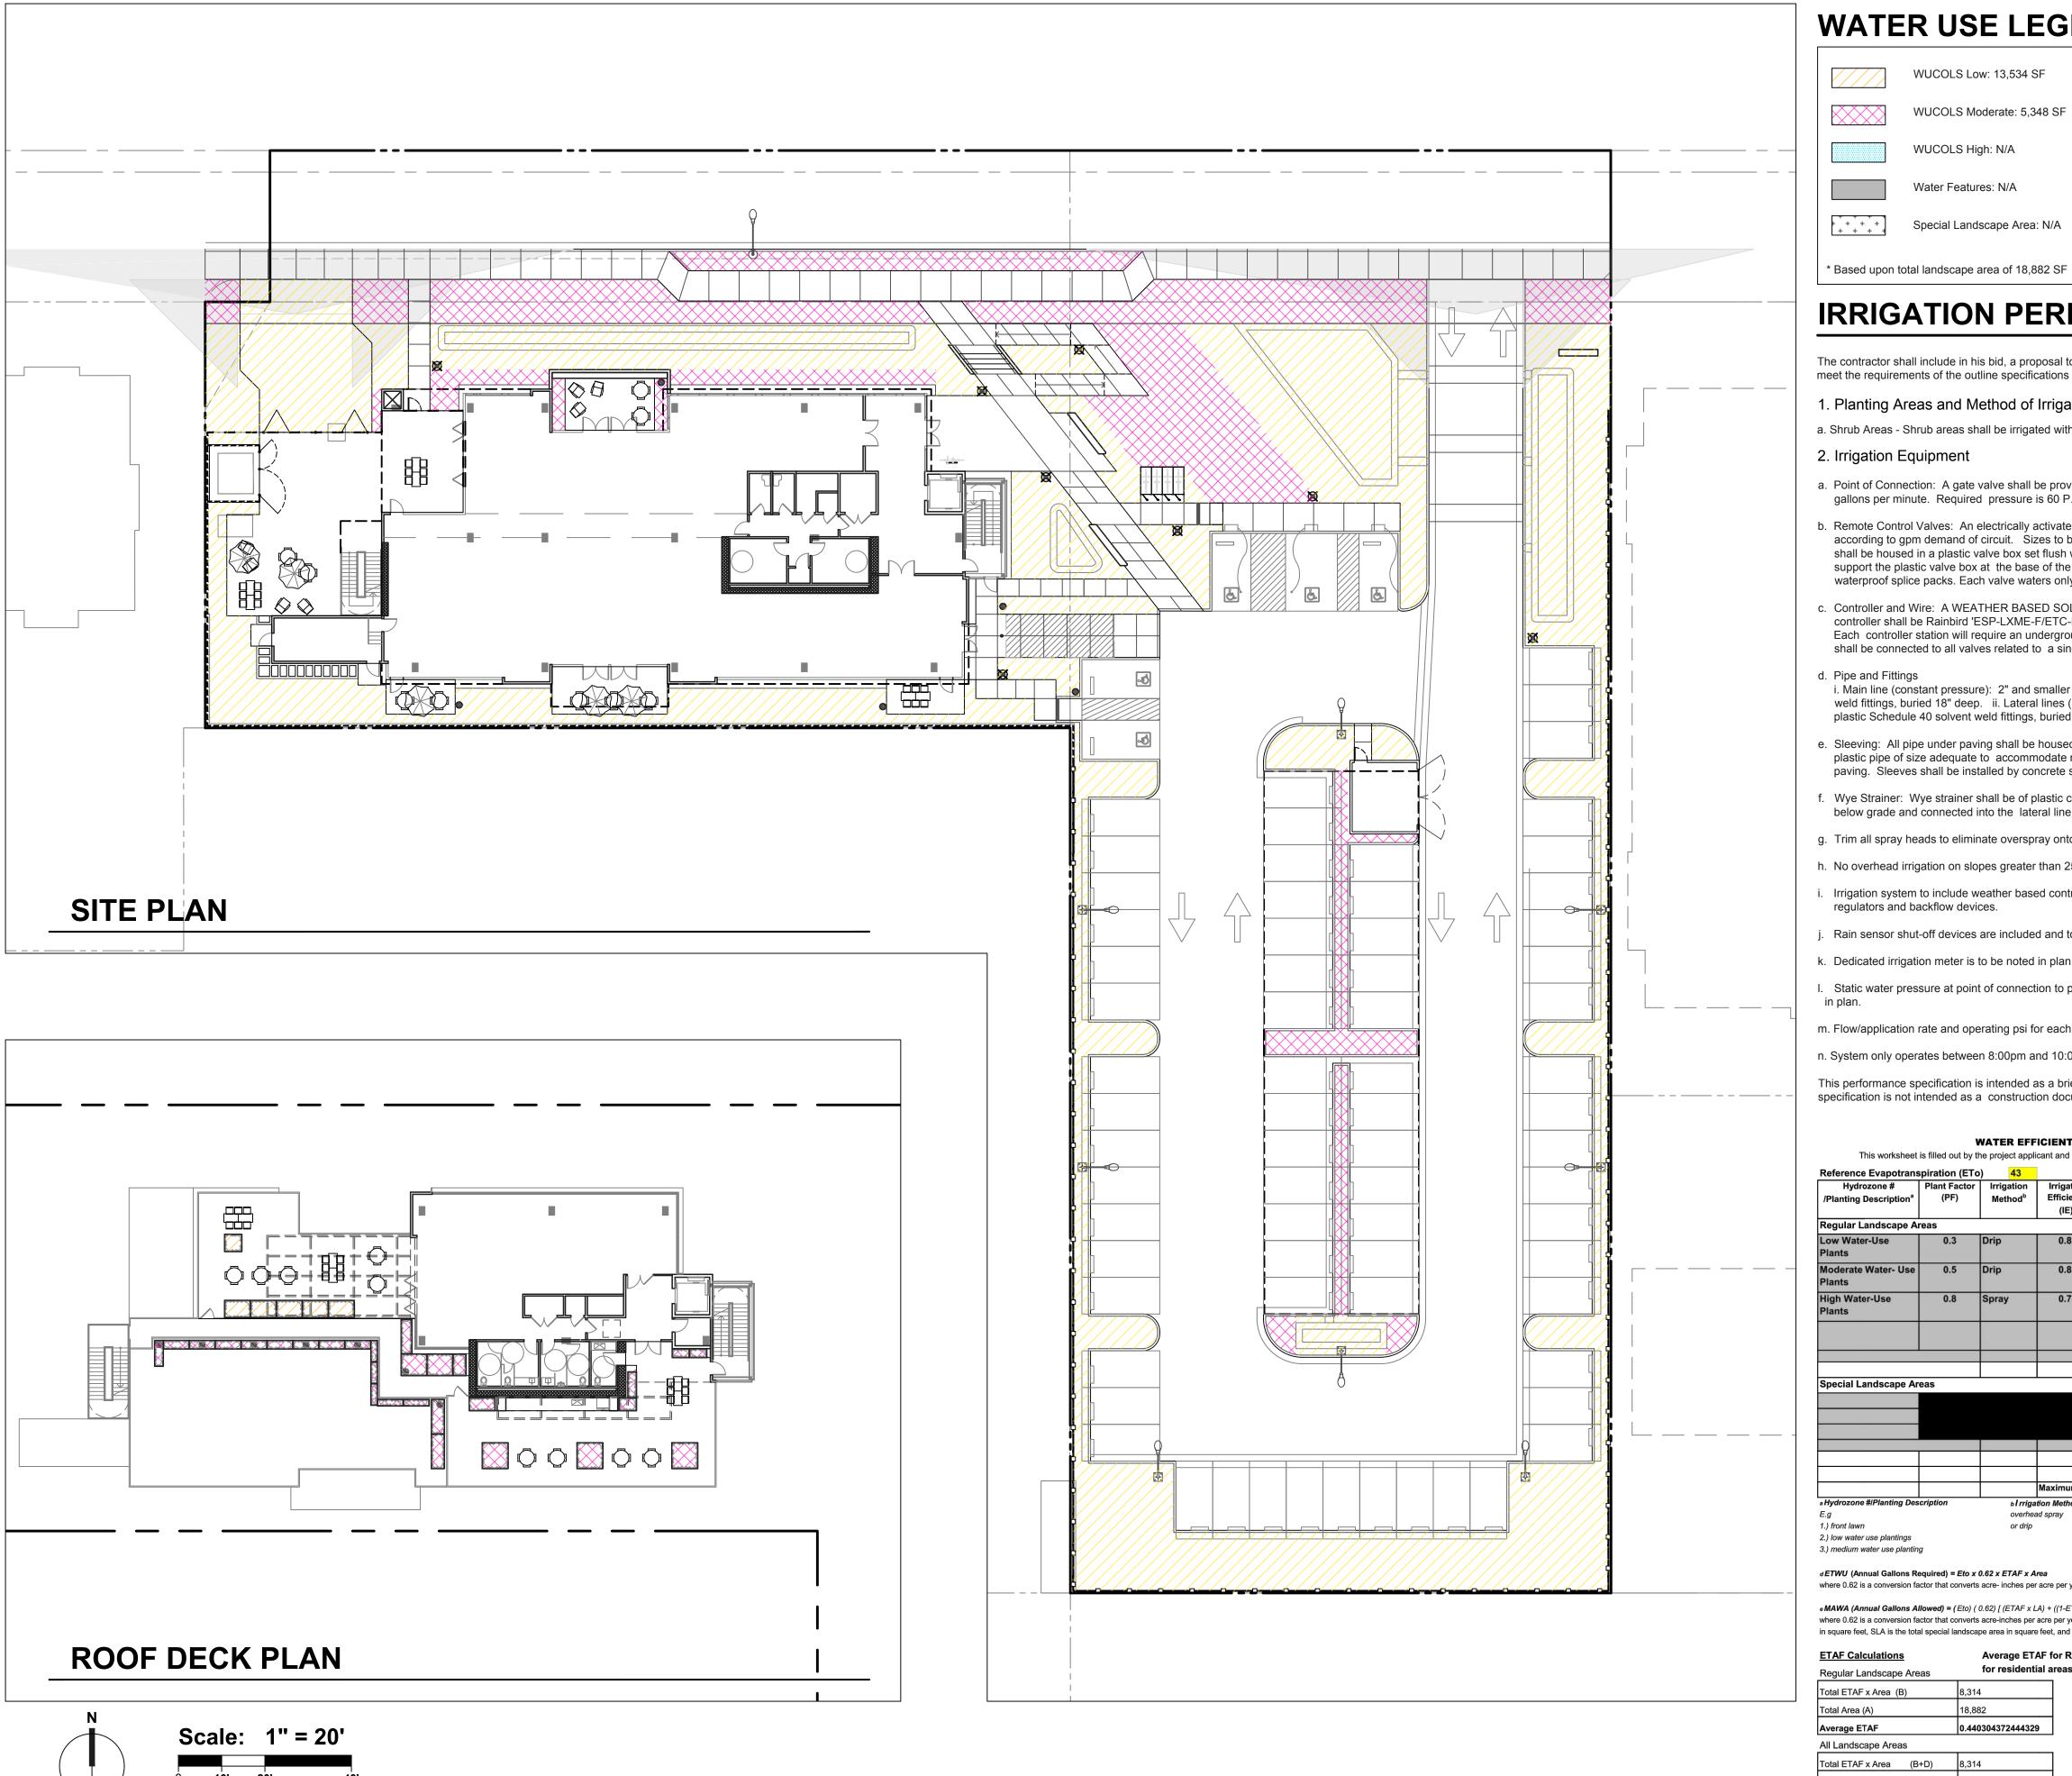

WATER USE LEGEND

WUCOLS Low: 13,534 SF WUCOLS Moderate: 5,348 SF WUCOLS High: N/A Water Features: N/A

NOTE: Site plan meets Water Conservation in Landscape Regulations Option 2. Refer to WELO Calculations, this sheet.

Special Landscape Area: N/A

IRRIGATION PERFORMANCE SPECIFICATIONS

The contractor shall include in his bid, a proposal to install individual landscape irrigation systems for the street frontage. All proposals shall meet the requirements of the outline specifications below:

1. Planting Areas and Method of Irrigation

a. Shrub Areas - Shrub areas shall be irrigated with drip emitters (one per shrub, two per tree).

2. Irrigation Equipment

a. Point of Connection: A gate valve shall be provided under work of another section. Irrigation demand is not to exceed sixty (60) gallons per minute. Required pressure is 60 P.S.I. or more.

b. Remote Control Valves: An electrically activated solenoid control valve shall control each circuit of sprinklers. Size will vary according to gpm demand of circuit. Sizes to be 3/4" through 2". Valves shall be Rainbird ECV series, anti-siphon valves Valve shall be housed in a plastic valve box set flush with grade. Pea gravel shall be installed below valve, 6" deep. Four bricks shall support the plastic valve box at the base of the box, below grade. Solenoid control wire shall be spliced using epoxy-filled waterproof splice packs. Each valve waters only one type of hydrozone.

c. Controller and Wire: A WEATHER BASED SOLID-STATE CONTROLLER shall control the operation of the irrigation system. The controller shall be Rainbird 'ESP-LXME-F/ETC-LX' The controller shall be mounted outdoors. The housing shall be weatherproof. Each controller station will require an underground AWG-UF 14-1 control wire to the valve location. A common wire AWG-UF 12-1 shall be connected to all valves related to a single controller.

i. Main line (constant pressure): 2" and smaller pipe shall be plastic PVC 1120 Schedule 40 with plastic PVC Schedule 40 solvent weld fittings, buried 18" deep. ii. Lateral lines (non-constant pressure) to sprinklers: Pipe shall be plastic PVC 1120-200 PSI with plastic Schedule 40 solvent weld fittings, buried 12" deep.

e. Sleeving: All pipe under paving shall be housed in a PVC plastic pipe sleeve. Sleeving material shall be 1120-200 P.S.I. PVC plastic pipe of size adequate to accommodate necessary pipes and wiring. Sleeves shall extend beyond walk, curb, or edge of paving. Sleeves shall be installed by concrete subcontractor.

f. Wye Strainer: Wye strainer shall be of plastic construction with 150 mesh PVC screen. Strainer shall be placed in a valve box below grade and connected into the lateral line downstream of the drip irrigation remote control valves.

g. Trim all spray heads to eliminate overspray onto walks and building.

h. No overhead irrigation on slopes greater than 25%, within 24" of nonpervious surface or areas less than 8' wide.

i. Irrigation system to include weather based controllers, main and lateral lines, valves, sprinkler heads, quick couplers, pressure regulators and backflow devices.

j. Rain sensor shut-off devices are included and to be noted in plan.

k. Dedicated irrigation meter is to be noted in plan.

I. Static water pressure at point of connection to public water supply is to be noted

m. Flow/application rate and operating psi for each station is to be noted in plan.

n. System only operates between 8:00pm and 10:00am.

This performance specification is intended as a brief description of the methods of irrigation to be applied to this project. This specification is not intended as a construction document.

WATER EFFICIENT LANDSCAPE WORKSHEET

Hydrozone # /Planting Description ^a	Plant Factor (PF)	Irrigation Method ^b	Irrigation Efficiency (IE) ^c	ETAF (PF/IE)	Landscape Area (sq. ft.)	ETAF x Area	Estimated Tota Water Use (ETWU) ^e
Regular Landscape A	reas	•					
Low Water-Use Plants	0.3	Drip	0.81	0.37	13,534	5,013	133,63
Moderate Water- Use Plants	0.5	Drip	0.81	0.62	5,348	3,301	88,01
High Water-Use Plants	0.8	Spray	0.75	1.07	0	0	
						0	
					(A)	(B)	
				Totals	18,882	8,314	
Special Landscape Ar	eas	,	7.1	-			,
				1		0	
				1		0	
				1		0	
					(C)	(D)	
				Totals	Ó	Ó	
						ETWU Total	221,64
			Maximum Alle	owed Water All	owance (MAW	A)e	221,64
a Hydrozone #/Planting Des	cription	ь I rriga	ation Method	c Irrigation Effic	ciency		
E.g		overhe	ad spray	0.75 for spray	head		
1.) front lawn		or drip		0.81 for drip			
2.) low water use plantings							

dETWU (Annual Gallons Required) = Eto x 0.62 x ETAF x Area

where 0.62 is a conversion factor that converts acre- inches per acre per year to gallons per square foot per year.

e MAWA (Annual Gallons Allowed) = (Eto) (0.62) [(ETAF x LA) + ((1-ETAF) x SLA)] where 0.62 is a conversion factor that converts acre-inches per acre per year to gallons per square foot per year, LA is the total landscape area in square feet, SLA is the total special landscape area in square feet, and ETAF is .55 for residential areas and 0.45 for non-residential areas.

Average ETAF for Regular Landscape Areas must be 0.55 or below ETAF Calculations for residential areas, and 0.45 or below for non-residential areas. Regular Landscape Areas

Total ETAF x Area (B) Average ETAF All Landscape Areas

Fotal ETAF x Area (B+D) 8,314 (A+C) 18,882 itewide ETAF (B+D) ÷ (A+C) | 0.44030437244432



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Sheet Title: HYDRO-ZONE PLAN

20036 Job No. 08/26/2021 1" = 20'-0"

Sheet No:

Drawn By: EE














BIKE LOCKER







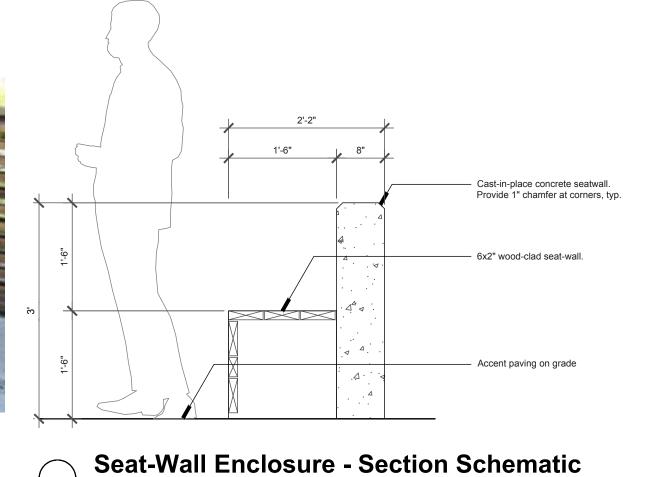






Omega Fence at Parking Lot


BIKE RACK


FENCES AND SCREEN WALLS





Horizontal Slat Screening Fence

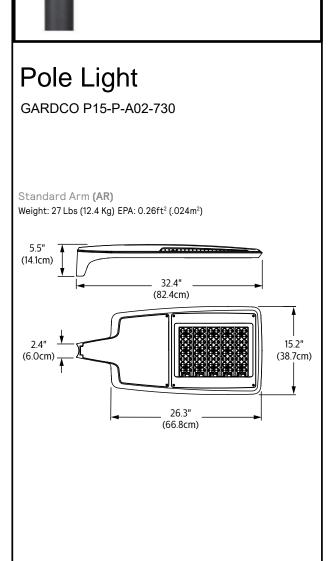


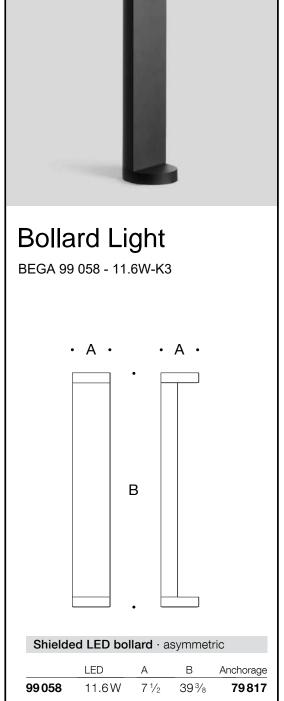

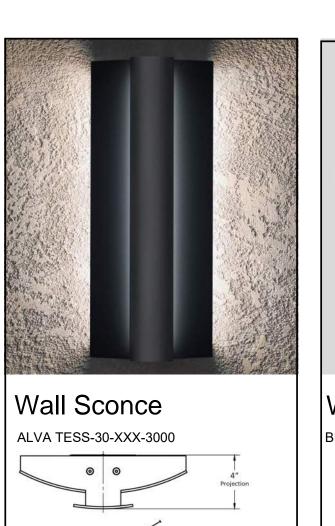

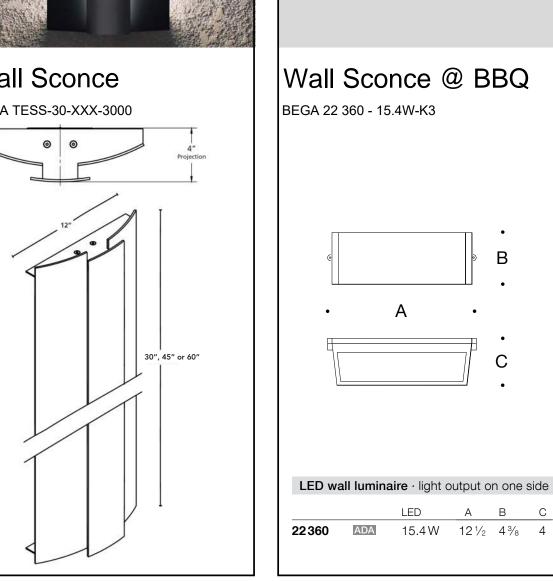

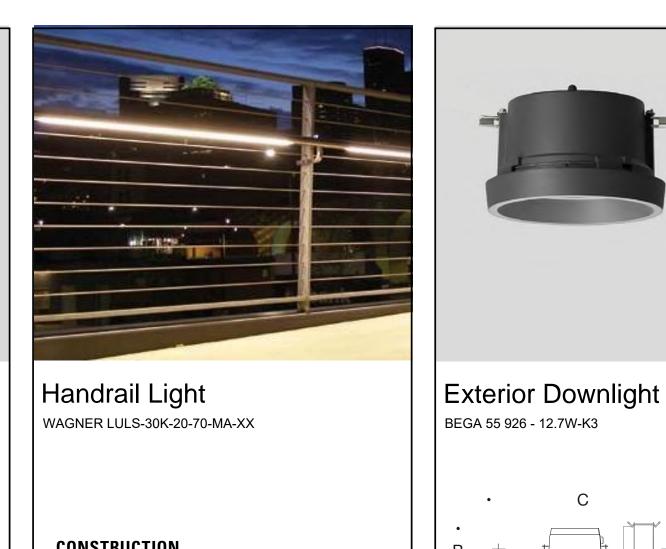


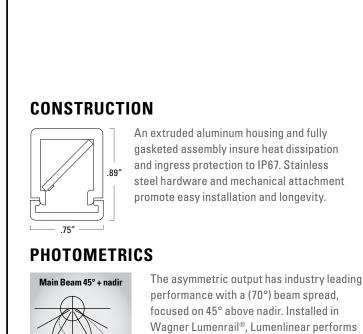


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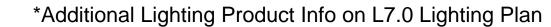
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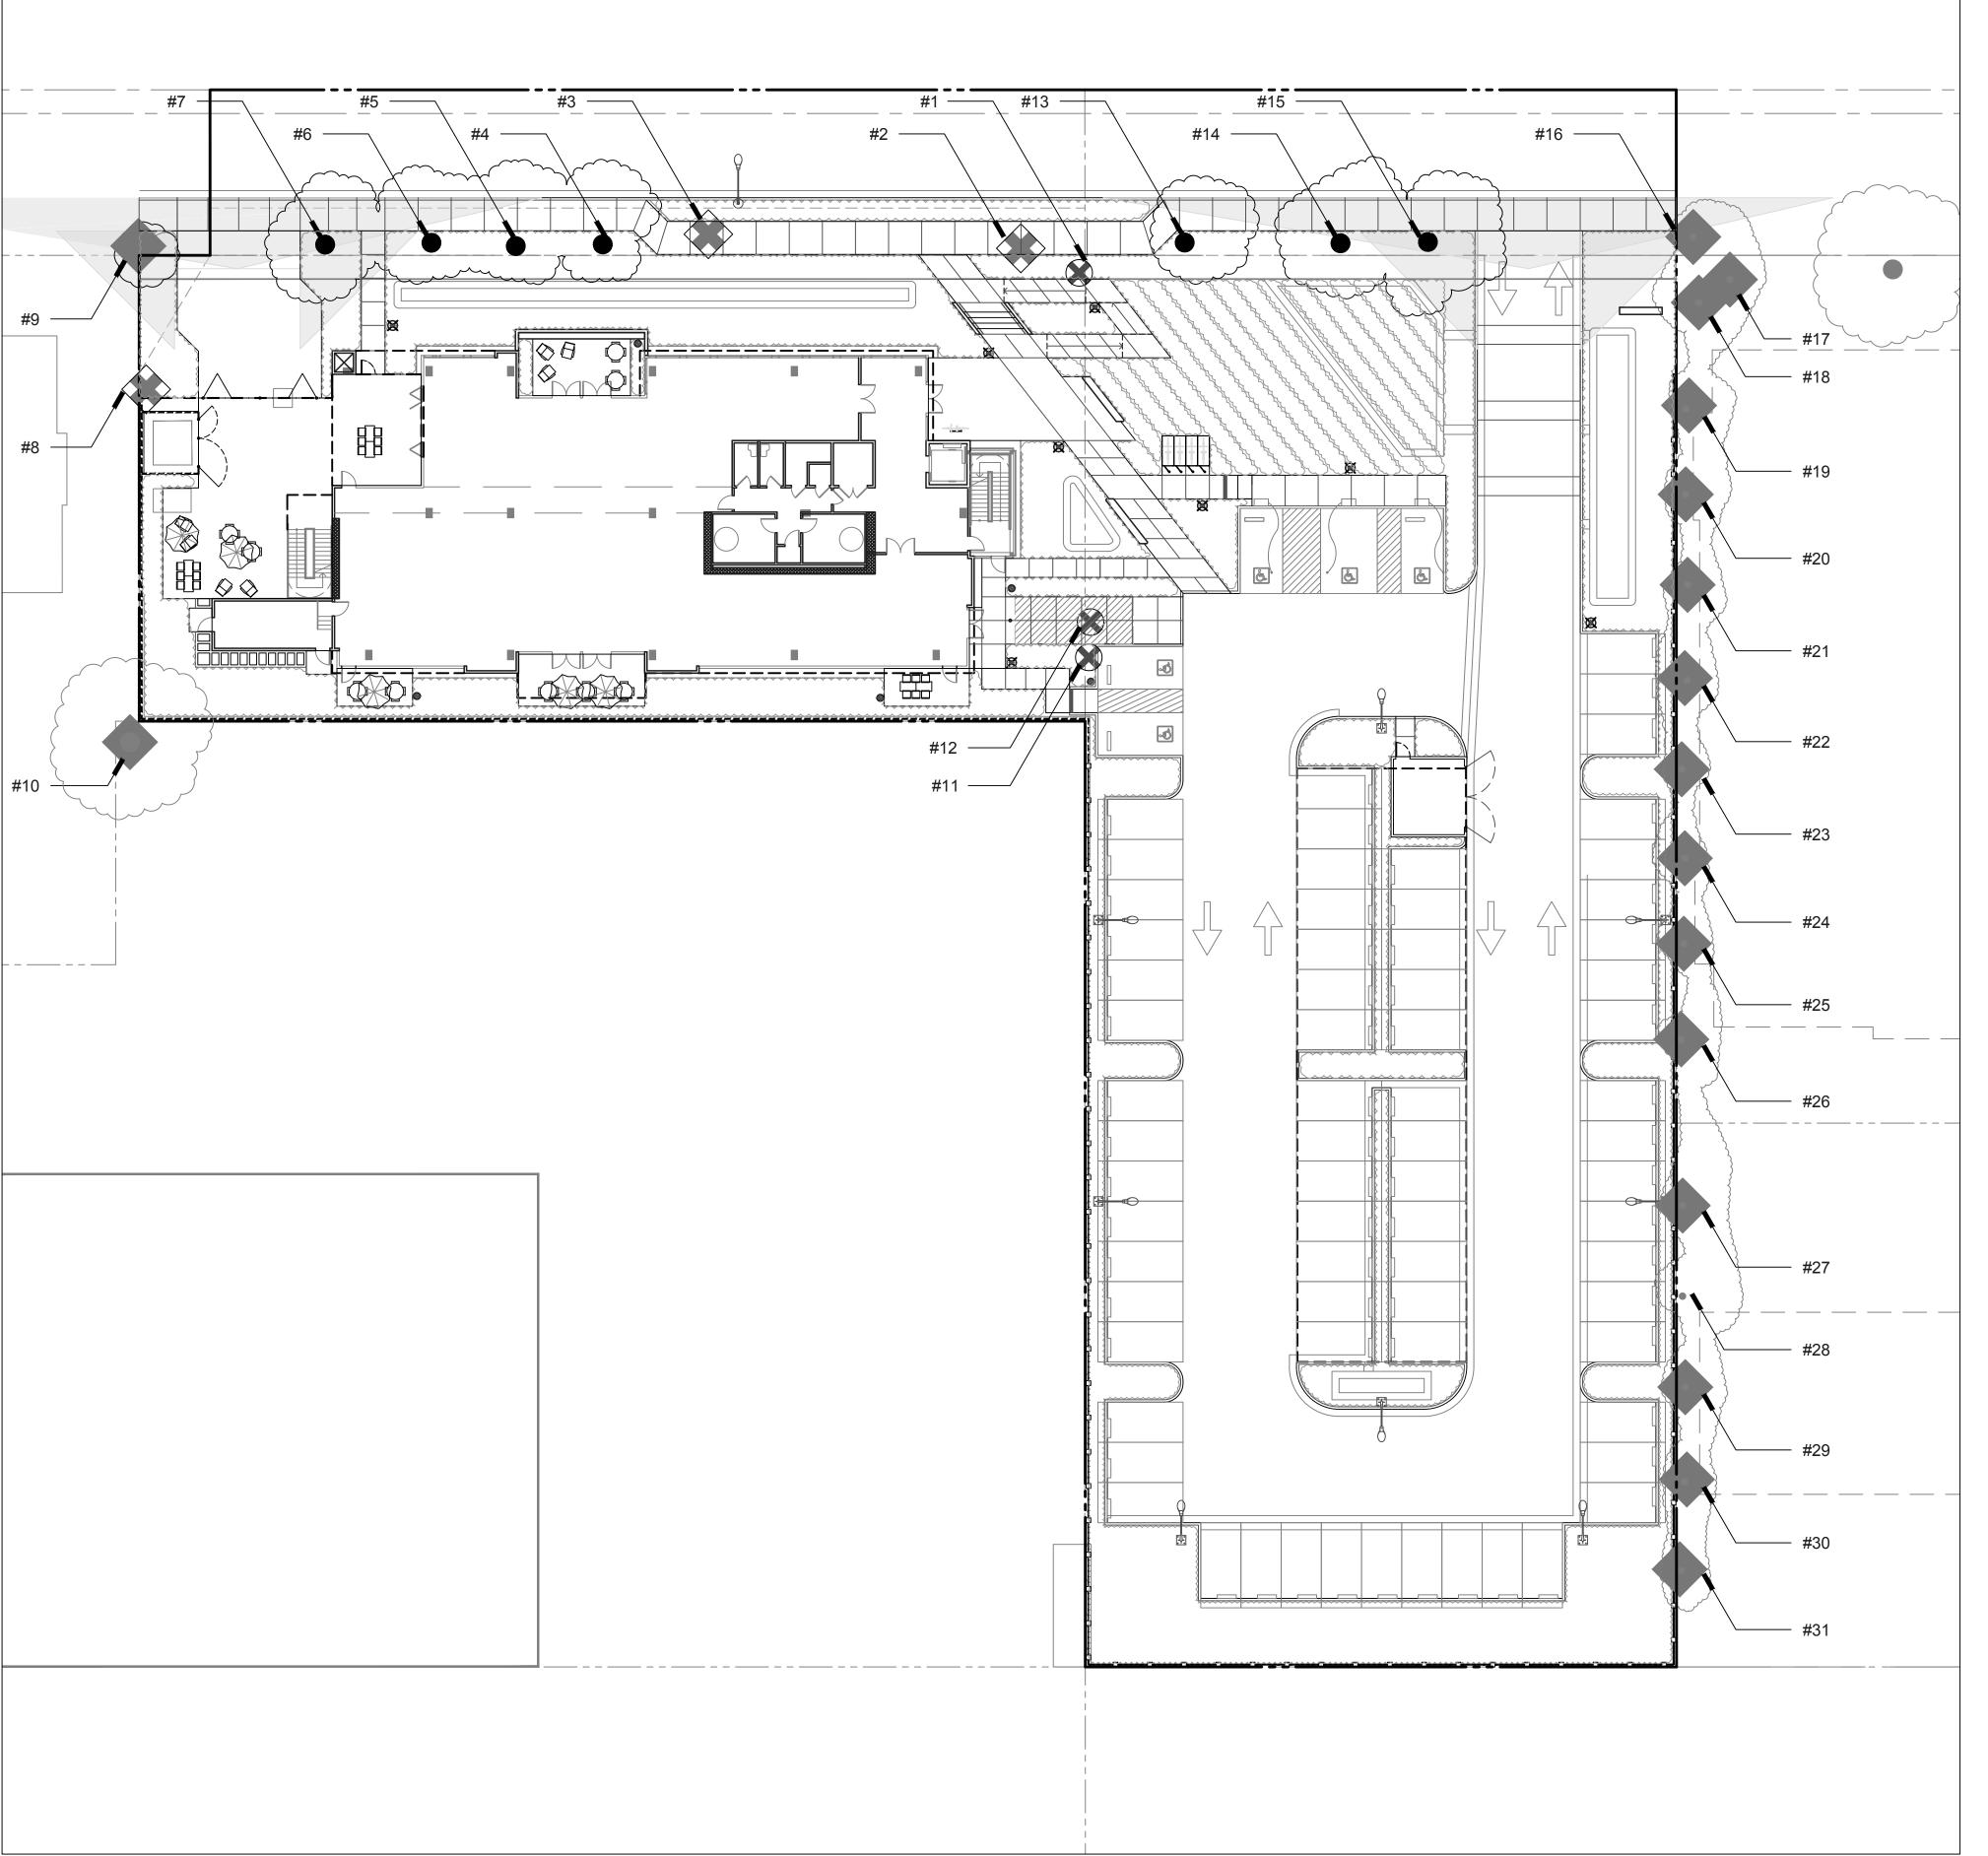
Sheet Title: LANDSCAPE IMAGES + MATERIALS

20036 Job No. 08/26/2021 1" = 20'-0" Drawn By: EE

Sheet No:

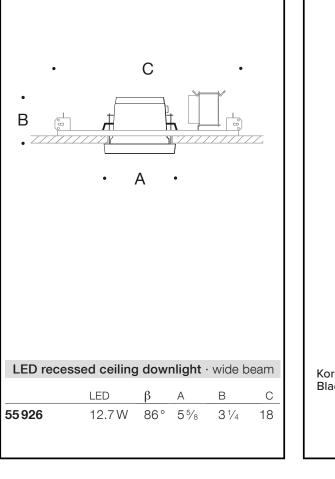L6.01

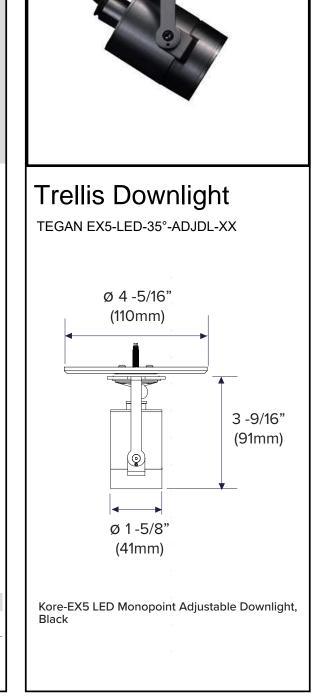SITE LIGHTING



TREE DISPOSITION LEGEND

	REMAIN		REMOVE	
ON-SITE TREES	KEY	QTY.	KEY	QTY.
HERITAGE TREE		0	♦	1
NON-HERITAGE TREE	•	0	⊗	3
STREET TREES	KEY	QTY.	KEY	QTY.
HERITAGE TREE		1	♦	2
NON-HERITAGE TREE	•	7	⊗	0
OFF-SITE TREES	KEY	QTY.	KEY	QTY.
HERITAGE TREE		16	♦	0
NON-HERITAGE TREE	•	1	⊗	0
TOTALS	KEY	QTY.	KEY	QTY.
HERITAGE TREE		17	♦	3
NON-HERITAGE TREE	•	8	⊗	3

REPLACEMENT RATIO FOR HERITAGE TREES:

3 HERITAGE TREES REMOVEDX 2 2:1 MITIGATION REQUIREMENT

3 NON-HERITAGE TREES REMOVED
(1 1:1 MITIGATION REQUIREMENT

X 22:1 MITIGATION REQUIREMENTX 11:1 MITIGATION REQUIREMENT= 6REPLACEMENT TREES REQUIRED3REPLACEMENT TREES REQUIRED

TOTAL NUMBER OF PROPOSED ON-SITE TREES (24" box min): 63

TREE PROTECTION NOTES: REFER TO RECOMMENDATIONS IN ARBORIST REPORT DATED JULY 24, 2020.



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Sheet Title:
TREE DISPOSITION
PLAN

Job No. 20036


Date: 08/26/2021

Scale: 1" = 20'-0"

Drawn By: EE

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Scale: 1" = 20'

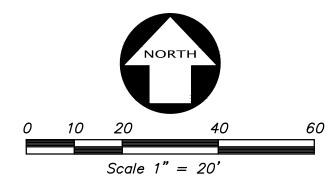

LEGEND

AREA DRAIN

STORM DRAIN CATCH BASIN

STORM DRAIN JUNCTION BOX

STORM DRAIN MANHOLE

FL
FLOW LINE

FF
FINISH FLOOR

IE
INVERT ELEVATION


PV
PAVEMENT

RE
RIM ELEVATION

SPOT ELEVATION

STORM DRAIN LINE

TOP OF CURB

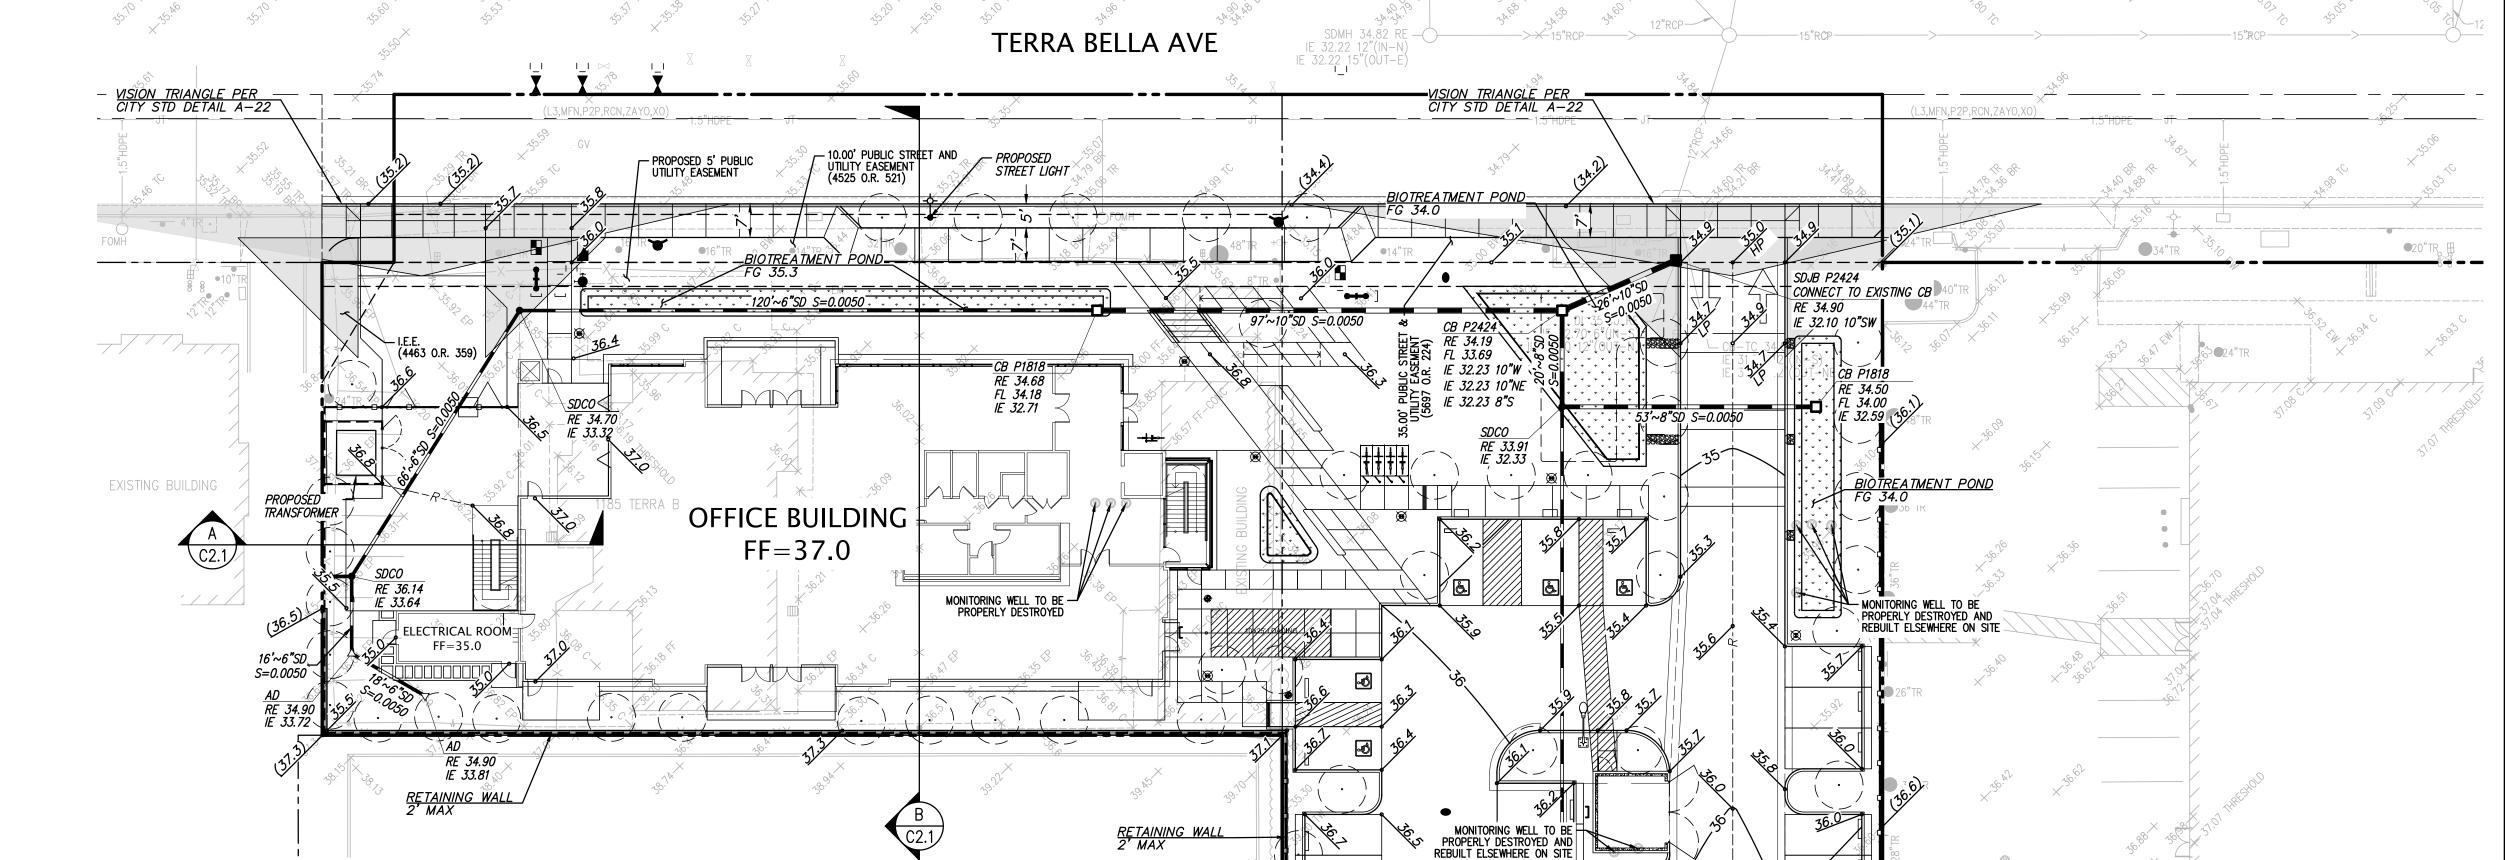

C2.1

DRAIN-THRU GUTTER

MONITORING WELL TO BE PROTECTED 399

GRADING NOTES

- 1. ALL GRADING SHALL BE DONE IN ACCORDANCE WITH RECOMMENDATIONS IN THE GEOTECHNICAL AND FOUNDATION INVESTIGATION PREPARED FOR THIS SITE BY TBD.
- 2. CONTRACTOR SHALL DETERMINE HIS OWN EARTH QUANTITIES AND BASE HIS BID ACCORDINGLY.
- 3. TOP OF CURB ELEVATION IS 0.5' ABOVE THE A.C. PAVING AND SPOT ELEVATIONS ARE TO FINISHED SURFACE (UNLESS OTHERWISE NOTED).
- 4. COMPACTION TO BE DETERMINED USING ASTM D1557, LATEST EDITION LABORATORY TEST PROCEDURE.
- 5. STORM DRAIN DESIGNATED AS "SD" SHALL BE CLASS III RCP, SDR 35 PVC OR HDPE AS STATED BELOW. PVC AND HDPE PIPES SHALL ONLY BE USED WHEN MINIMUM COVER REQUIREMENTS ARE MET AS SPECIFIED IN THE PVC PIPE BEDDING DETAIL AS SHOWN ON THESE PLANS. SUBSTITUTIONS FOR ANY PIPE WITH A PARTICULAR MATERIAL SPECIFIED ON THIS PLAN SHALL ONLY BE MADE WITH THE WRITTEN APPROVAL OF THE ENGINEER.
- 6. STORM DRAIN PIPE SHALL BE: 10" DIAMETER AND SMALLER SDR 35 PVC OR HDPE WITH RUBBER GASKETS MEETING ASTM F477. 12" DIAMETER TO BE SDR 35 PVC, CLASS III RCP OR BLUE SEAL HDPE AS MANUFACTURED BY HANCOR WITH WATER TIGHT JOINTS MEETING ASTM F477 AND ASTM D3212. 15" THROUGH 24" DIAMETERS; PIPE TO BE CLASS III RCP OR BLUE SEAL HDPE AS SPECIFIED ABOVE. PIPES LARGER THAN 24" IN DIAMETER SHALL BE CLASS III RCP UNLESS OTHERWISE NOTED. NO MATERIAL SUBSTITUTION SHALL BE ALLOWED FOR DUCTILE IRON PIPE
- 7. ALL UTILITY STRUCTURES INCLUDING, BUT NOT LIMITED TO MANHOLES, CATCH BASINS, WATER VALVES, FIRE HYDRANTS, TELEPHONE AND ELECTRIC VAULTS, AND PULL BOXES, THAT LIE WITHIN THE PUBLIC RIGHT—OF—WAY EASEMENTS OR AREAS AFFECTED BY WORK ON THIS PROJECT SHALL BE ADJUSTED TO GRADE BY THE CONTRACTOR OR THE RESPECTIVE UTILITY COMPANY FOR WHICH THE CONTRACTOR IS RESPONSIBLE TO AFFECT COORDINATION.
- 8. THE TYPES, LOCATIONS, SIZES AND/OR DEPTHS OF EXISTING UNDERGROUND UTILITIES AS SHOWN ON THESES IMPROVEMENT PLANS WERE OBTAINED FROM SOURCES OF VARYING RELIABILITY. THE CONTRACTOR IS CAUTIONED THAT ONLY ACTUAL EXCAVATION WILL REVEAL THE TYPES, EXTENT, SIZES, LOCATIONS AND DEPTHS OF SUCH UNDERGROUND UTILITIES. A REASONABLE EFFORT HAS BEEN MADE TO LOCATE AND DELINEATE ALL KNOWN UNDERGROUND UTILITIES. HOWEVER, THE ENGINEER CAN NOT ASSUME RESPONSIBILITY FOR THE COMPLETENESS OR ACCURACY OF THEIR DELINEATION OF SUCH UNDERGROUND UTILITIES WHICH MAY BE ENCOUNTERED, BUT ARE NOT SHOWN ON THESE DRAWINGS.
- 9. CONTRACTOR SHALL UNCOVER AND EXPOSE ALL EXISTING UTILITY AND SEWER LINES WHERE THEY ARE TO BE CROSSED, ABOVE OR BELOW, BY THE NEW FACILITY BEING CONSTRUCTED IN ORDER TO VERIFY THE GRADE AND TO ASSURE THAT THERE IS SUFFICIENT CLEARANCE. PIPE SHALL NOT BE STRUNG NOR TRENCHING COMMENCED UNTIL ALL CROSSINGS HAVE BEEN VERIFIED FOR CLEARANCE. IF THE CONTRACTOR FAILS TO FOLLOW THIS PROCEDURE, HE WILL BE SOLELY RESPONSIBLE FOR ANY EXTRA WORK OR MATERIAL REQUIRED IF MODIFICATIONS TO THE DESIGN ARE NECESSARY.
- 10. THE CONTRACTOR SHALL SET HIS STRING OR WIRE THROUGH AT LEAST THREE GRADE STAKES TO VERIFY GRADE. IF THE STAKES DO NOT PRODUCE A UNIFORM GRADE, NOTIFY THE ENGINEER IMMEDIATELY AND HAVE THE GRADES CHECKED PRIOR THE TRENCHING OR PLACEMENT OF CONCRETE
- 11. ADJUSTMENTS TO BUILDING PAD ELEVATIONS OR PARKING LOT GRADES TO ACHIEVE EARTHWORK BALANCE SHALL BE MADE ONLY WITH APPROVAL OF THE ENGINEER.
- 12. ALL WORK, ON-SITE AND IN THE PUBLIC RIGHT-OF-WAY, SHALL CONFORM TO THE CITY OF SAN JOSE STANDARDS AND REQUIREMENTS.
- 13. HISTORICAL OVERLAND RELEASE THROUGH ADJACENT PROPERTY. TOTAL IMPERVIOUS AREA REDUCED BY IMPLEMENTATION OF NEW PERVIOUS AREA

EARTHWORK SUMMARY

JT: <u>259 CY</u>

FILL: 1,394 CY

NOTE:
THE EARTHWORK QUANTITIES LISTED ON THESE PLANS ARE STATED ONLY FOR CALCULATION OF GRADING AND BUILDING PERMIT FEES. THESE QUANTITIES DO NOT INCLUDE TRENCH OR FOOTING SPOILS, SHRINK OR SWELL FROM COMPACTING EFFORTS OR OTHER VARIABLES. THE ENGINEER MAKES NO REPRESENTATION THIS SITE WILL BALANCE. THE CONTRACTOR SHALL DETERMINE HIS OWN EARTHWORK QUANTITIES AND BASE

HIS BID ACCORDINGLY.

STUDIO

Architecture Planning

Urban Design

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Devcor Par

Sheet Title: PRELIMINARY GRADING

Job No. 20006


Date: 08/26/2021

Scale: AS SHOWN

Drawn By: MC

Sheet No:

C2.

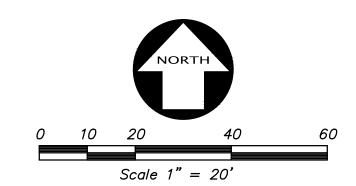


LEGEND

TREATMENT CONTROL MEASURE

TRIBUTARY AREA LIMITS

BIO-RETENTION TREATMENT AREA DRAINAGE MANAGEMENT AREA

SELF RETAINING AREA

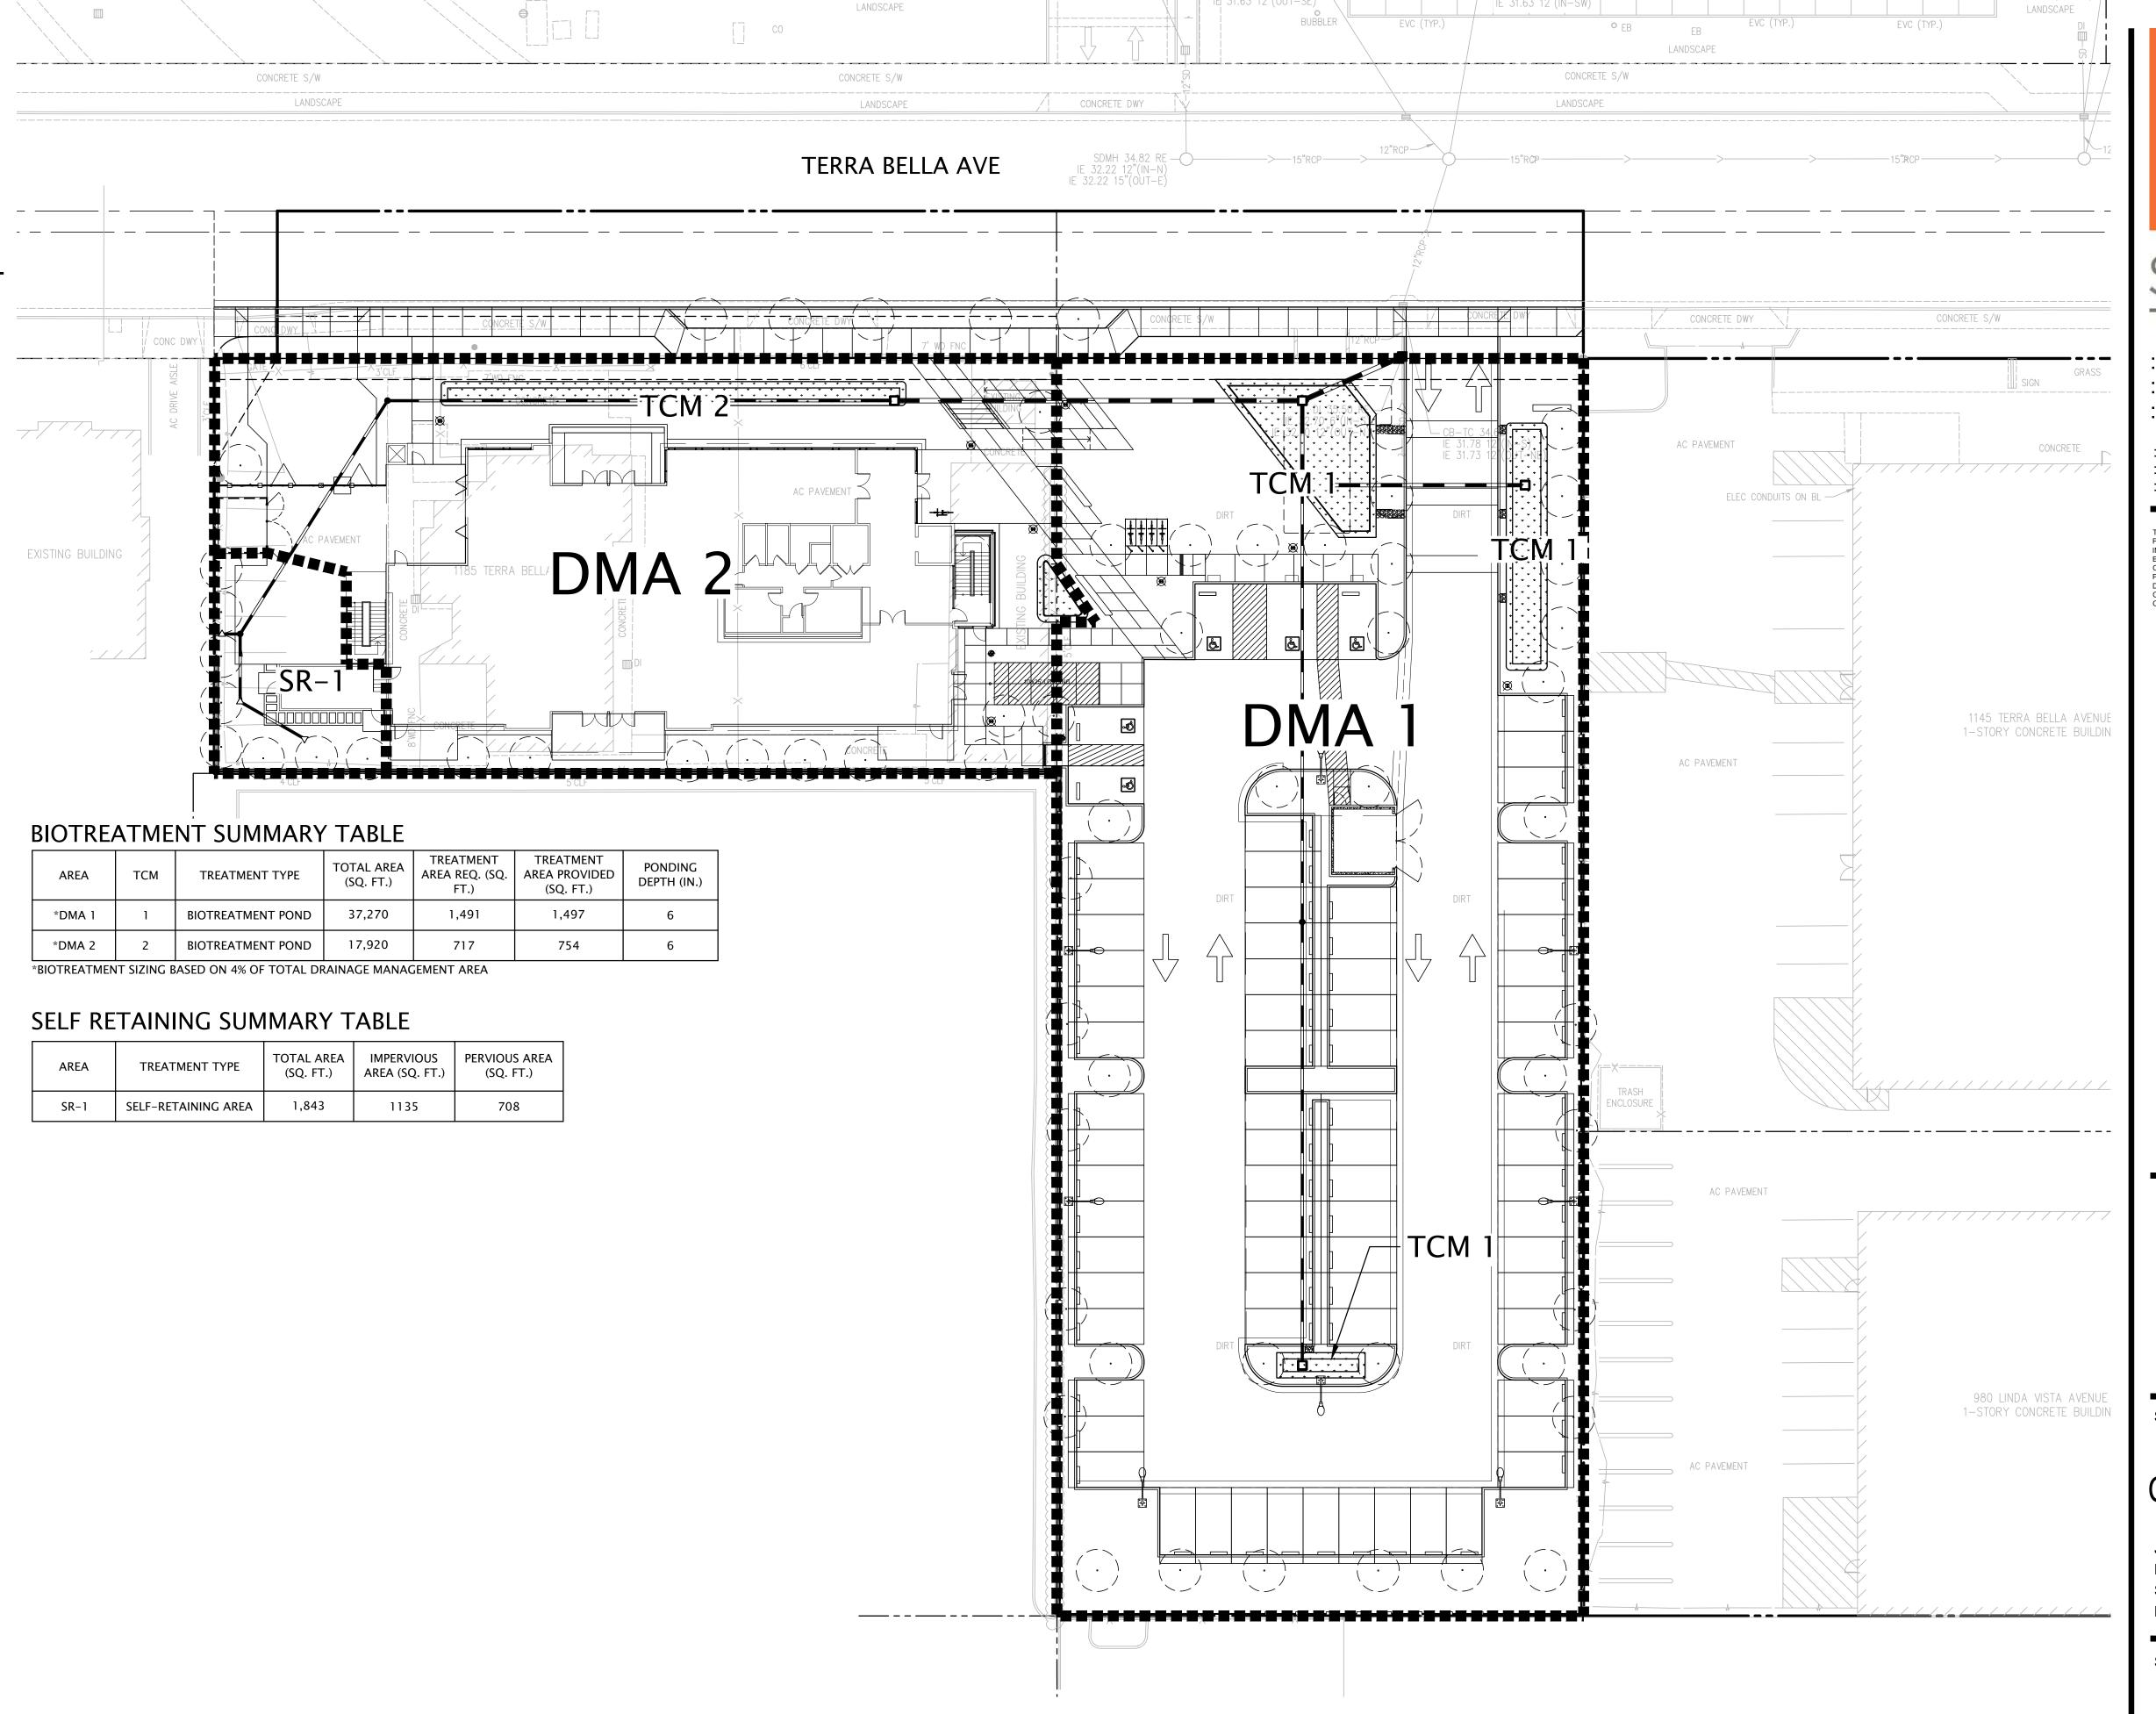

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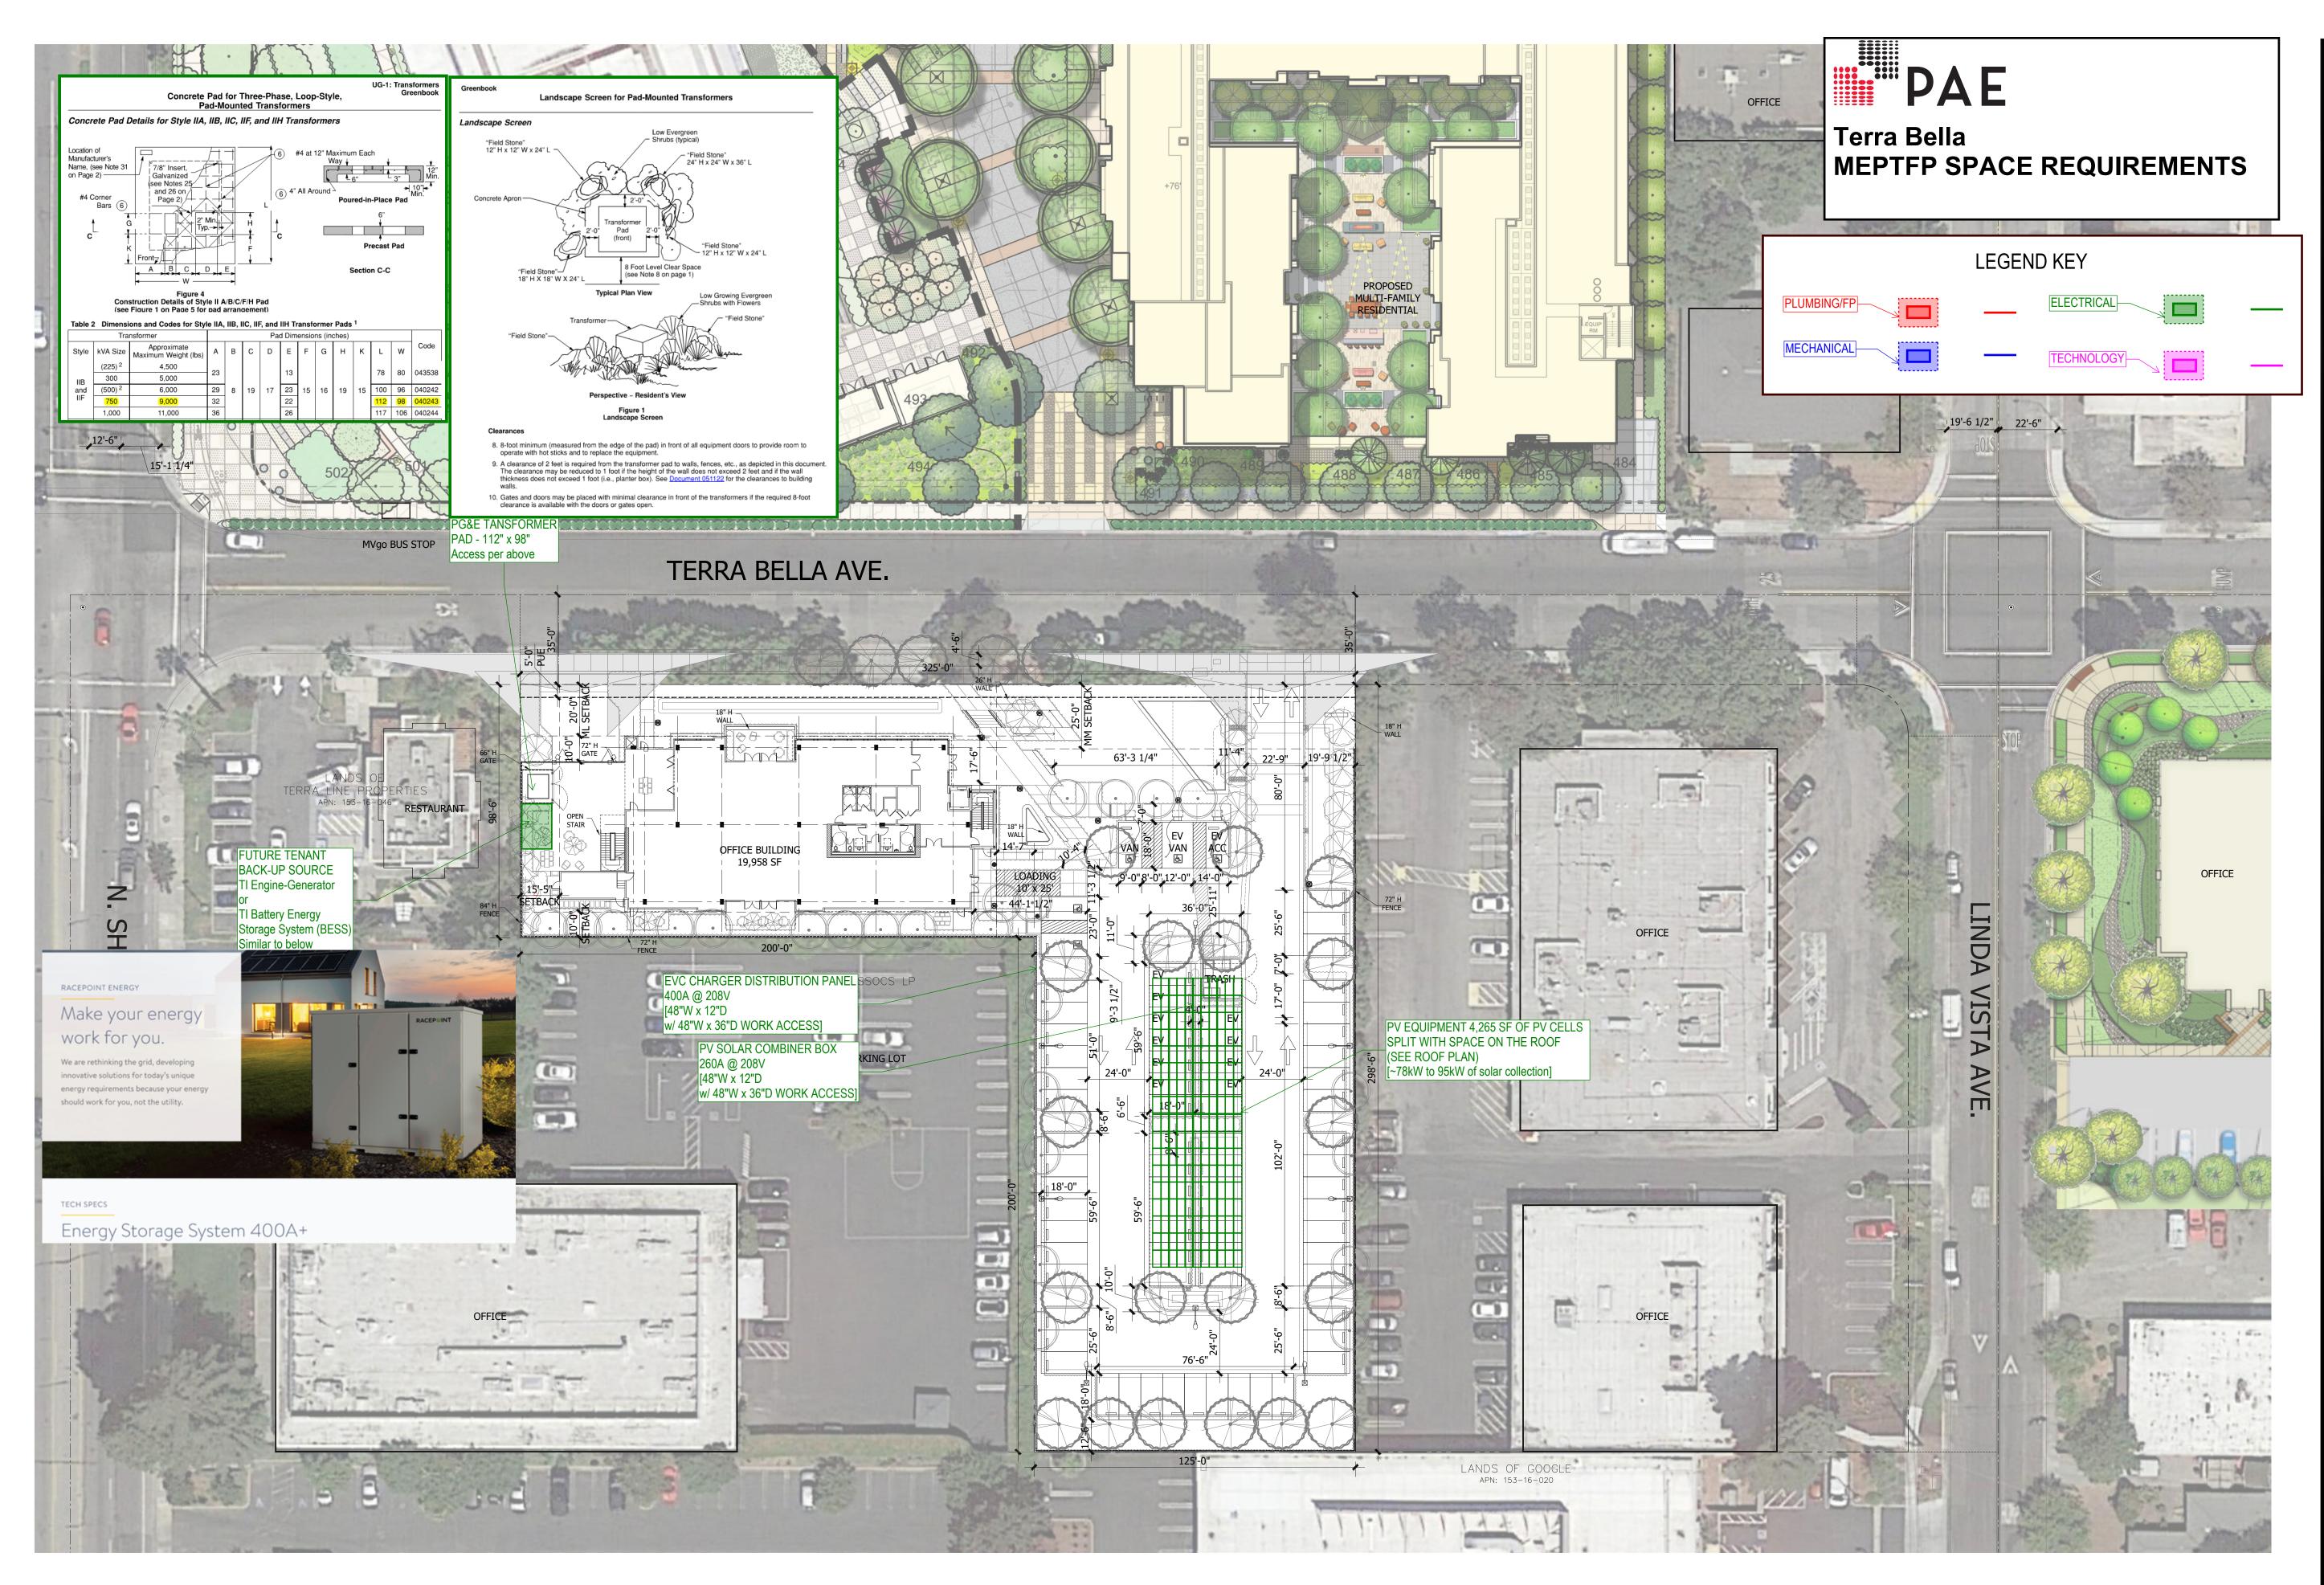
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Sheet Title: STORMWATER CONTROL PLAN

20006 Job No. 08/26/2021 AS SHOWN Drawn By: MC

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Devcor Parti 171 Main Street, #232 Los Altos, CA 94022



Sheet Title:

85

1155

MECHANICAL SITE PLAN

Job No. 20006

Date: 08/26/2021

Scale: 1" = 30' - 0"

Drawn By:

Sheet No:

M1.0