

EXISTING GRADES ARE BASED ON INFORMATION PROVIDED BY: KIER AND WRIGHT.
 CONTRACTOR SHALL VERIFY EXISTING GRADES FOR ACCURACY PRIOR TO THE START OF
 GRADING, NOTIFY THE OWNER'S REPRESENTATIVE IMMEDIATELY SHOULD CONFLICTS ARISE
 AND REDIRECT WORK TO AVOID DELAY.

2. THE CONTRACTOR SHALL VERIFY THE LOCATIONS OF ALL EXISTING UTILITIES, STRUCTURES AND SERVICES BEFORE COMMENCING WORK. THE LOCATIONS OF UTILITIES, STRUCTURES AND SERVICES SHOWN IN THE CONTRACT DOCUMENTS SHALL BE DEEMED TO BE APPROXIMATIONS ONLY. ALL DISCREPANCIES BETWEEN WHAT IS SHOWN AND THE ACTUAL FIELD CONDITIONS SHALL BE REPORTED TO THE OWNER'S REPRESENTATIVE. THE CONTRACTOR SHALL CONTACT UNDER GROUND SERVICE ALERT (USA) AT (800) 227-2600 PRIOR TO ANY DEMOLITION OR EXCAVATION. UPON COMPLETION OF USA MARKING OPERATIONS, CONTRACTOR SHALL RECORD ALL UTILITY MARKINGS ON A SEPARATE SET OF DRAWINGS. THIS SET SHALL BE KEPT ON-SITE FOR REFERENCE FOR DURATION OF CONTRACT.

PROPOSED GRADES SHALL MEET EXISTING GRADES WITH A SMOOTH AND CONTINUOUS TRANSITION SO AS TO AVOID TRAPPING WATER. CONTRACTOR SHALL NOTIFY DISTRICT REPRESENTATIVE IF PUDDLING IS SUSPECTED AND REDIRECT WORK SO AS TO AVOID DELAY WHILE AWAITING RESPONSE.

4. ALL EXISTING DRAINAGE STRUCTURES, BOXES, UTILITY VAULTS ETC. SHALL BE BROUGHT TO FINAL FINISH GRADE PRIOR TO FINAL SURFACE TREATMENT.

THE CITRUS HEIGHTS WATER DISTRICT HAS A 10' WATER EASEMENT THAT RUNS THROUGH THE PROPERTY. THE WATER MAIN LINE THAT IS IN THE EASEMENT IS ABANDONED IN PLACE AND IS LIKELY STEEL PIPE, PARTS MY BE ASBESTOS CEMENT PIPE. THERE SHOULD NOT BE ANY CONFLICTS WITH THE ABANDONED MAIN LINE UNLESS THE STRUCTURES BEING INSTALLED ARE 36 INCHES BELOW FINISHED GRADE. IF THE ABANDONED WATER MAIN IS REACHED AND IT IS ASBESTOS CEMENT PIPE, THE PIPE WILL NEED TO BE REMOVED AND DISCARDED IN A SPECIFIC MANNER IN ADHERENCE TO STANDARD SAFETY PROTOCOLS.

GRADING LEGEND

DESCRIPTION

PROPOSED CONTOUR

PROPOSED SUBGRADE CONTOUR

CIVIL ENGINEERING SPORT PLANNING & DESIGN 1843 Iron Point Rd. Suite 140 Folsom, CA 95630

ANDSCAPE

No. 4089

EXPIRATION DATE:
JULY 2021

VERDE DESIGN

LANDSCAPE ARCHITECTURE

tel: 916.415.6554 fax: 916.415.6525

www.VerdeDesignInc.com

IDENTIFICATION STAMP

DIV. OF THE STATE ARCHITEC

REVIEWED FOR

SS 🗹 FLS 🗹 ACS 🗹

APP: 02-118588 INC:

CONSULTANT

FG 32.00 PROPOSED FINISH GRADE ELEVATION OF SOFTSCAPE PROPOSED FINISH SURFACE ELEVATION OF HARDSCAPE HP/HPS 32.00 HIGH POINT/ HIGH POINT OF SWALE LP/LPS 31.00 LOW POINT/ LOW POINT OF SWALE RIM 31.00 LOW POINT/ RIM ELEVATION OF DRAIN SG 32.00 PROPOSED FINISH SUGRADE ELEVATION TC 32.50 TOP OF CURB FINISHED FLOOR ELEVATION TOP OF TRENCH DRAIN CENTER LINE OF SWALE CROWN OF FIELD, OR RIDGE LINE

LOW POINT OF FIELD SUBGRADE/ PERFORATED DRAIN LINE LOCATION

LIMIT OF GRADING - CONFORM TO EXISTING GRADES AT THIS LINE

CONFORM TO EXISTING GRADE

FLOW DIRECTION IN SOFTSCAPE

EXISTING CONTOUR

EXISTING ELEVATION

GRADE BREAK

SHEET TITLE

GRADING PLAN - NORTH


PROJECT NAME

MESA VERDE
HIGH SCHOOL
ATHLETIC FACILITY
IMPROVEMENTS


PROJECT ADDRESS

7501 CARRIAGE DRIVE CITRUS HEIGHTS, CA 95621

000//	111712		DAIL
50%	08/13/202		
DSA S	SUBMITTAL		10/15/202
DSA B	BACKCHECK SUBMITTA	\L	01/20/202
NO.	REVISIONS		DATE
\bigvee			
DRAW	'N BY	CHECKED BY	
QH CS/			MB
DATE ISSUED SCALE			
01/20/2021 1" = 2			20'-0"
PROJ. NO. 1819500			
SHEET			
L-151			

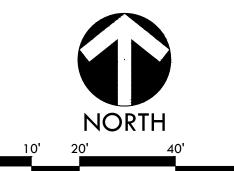

GRADING PLAN - NORTH

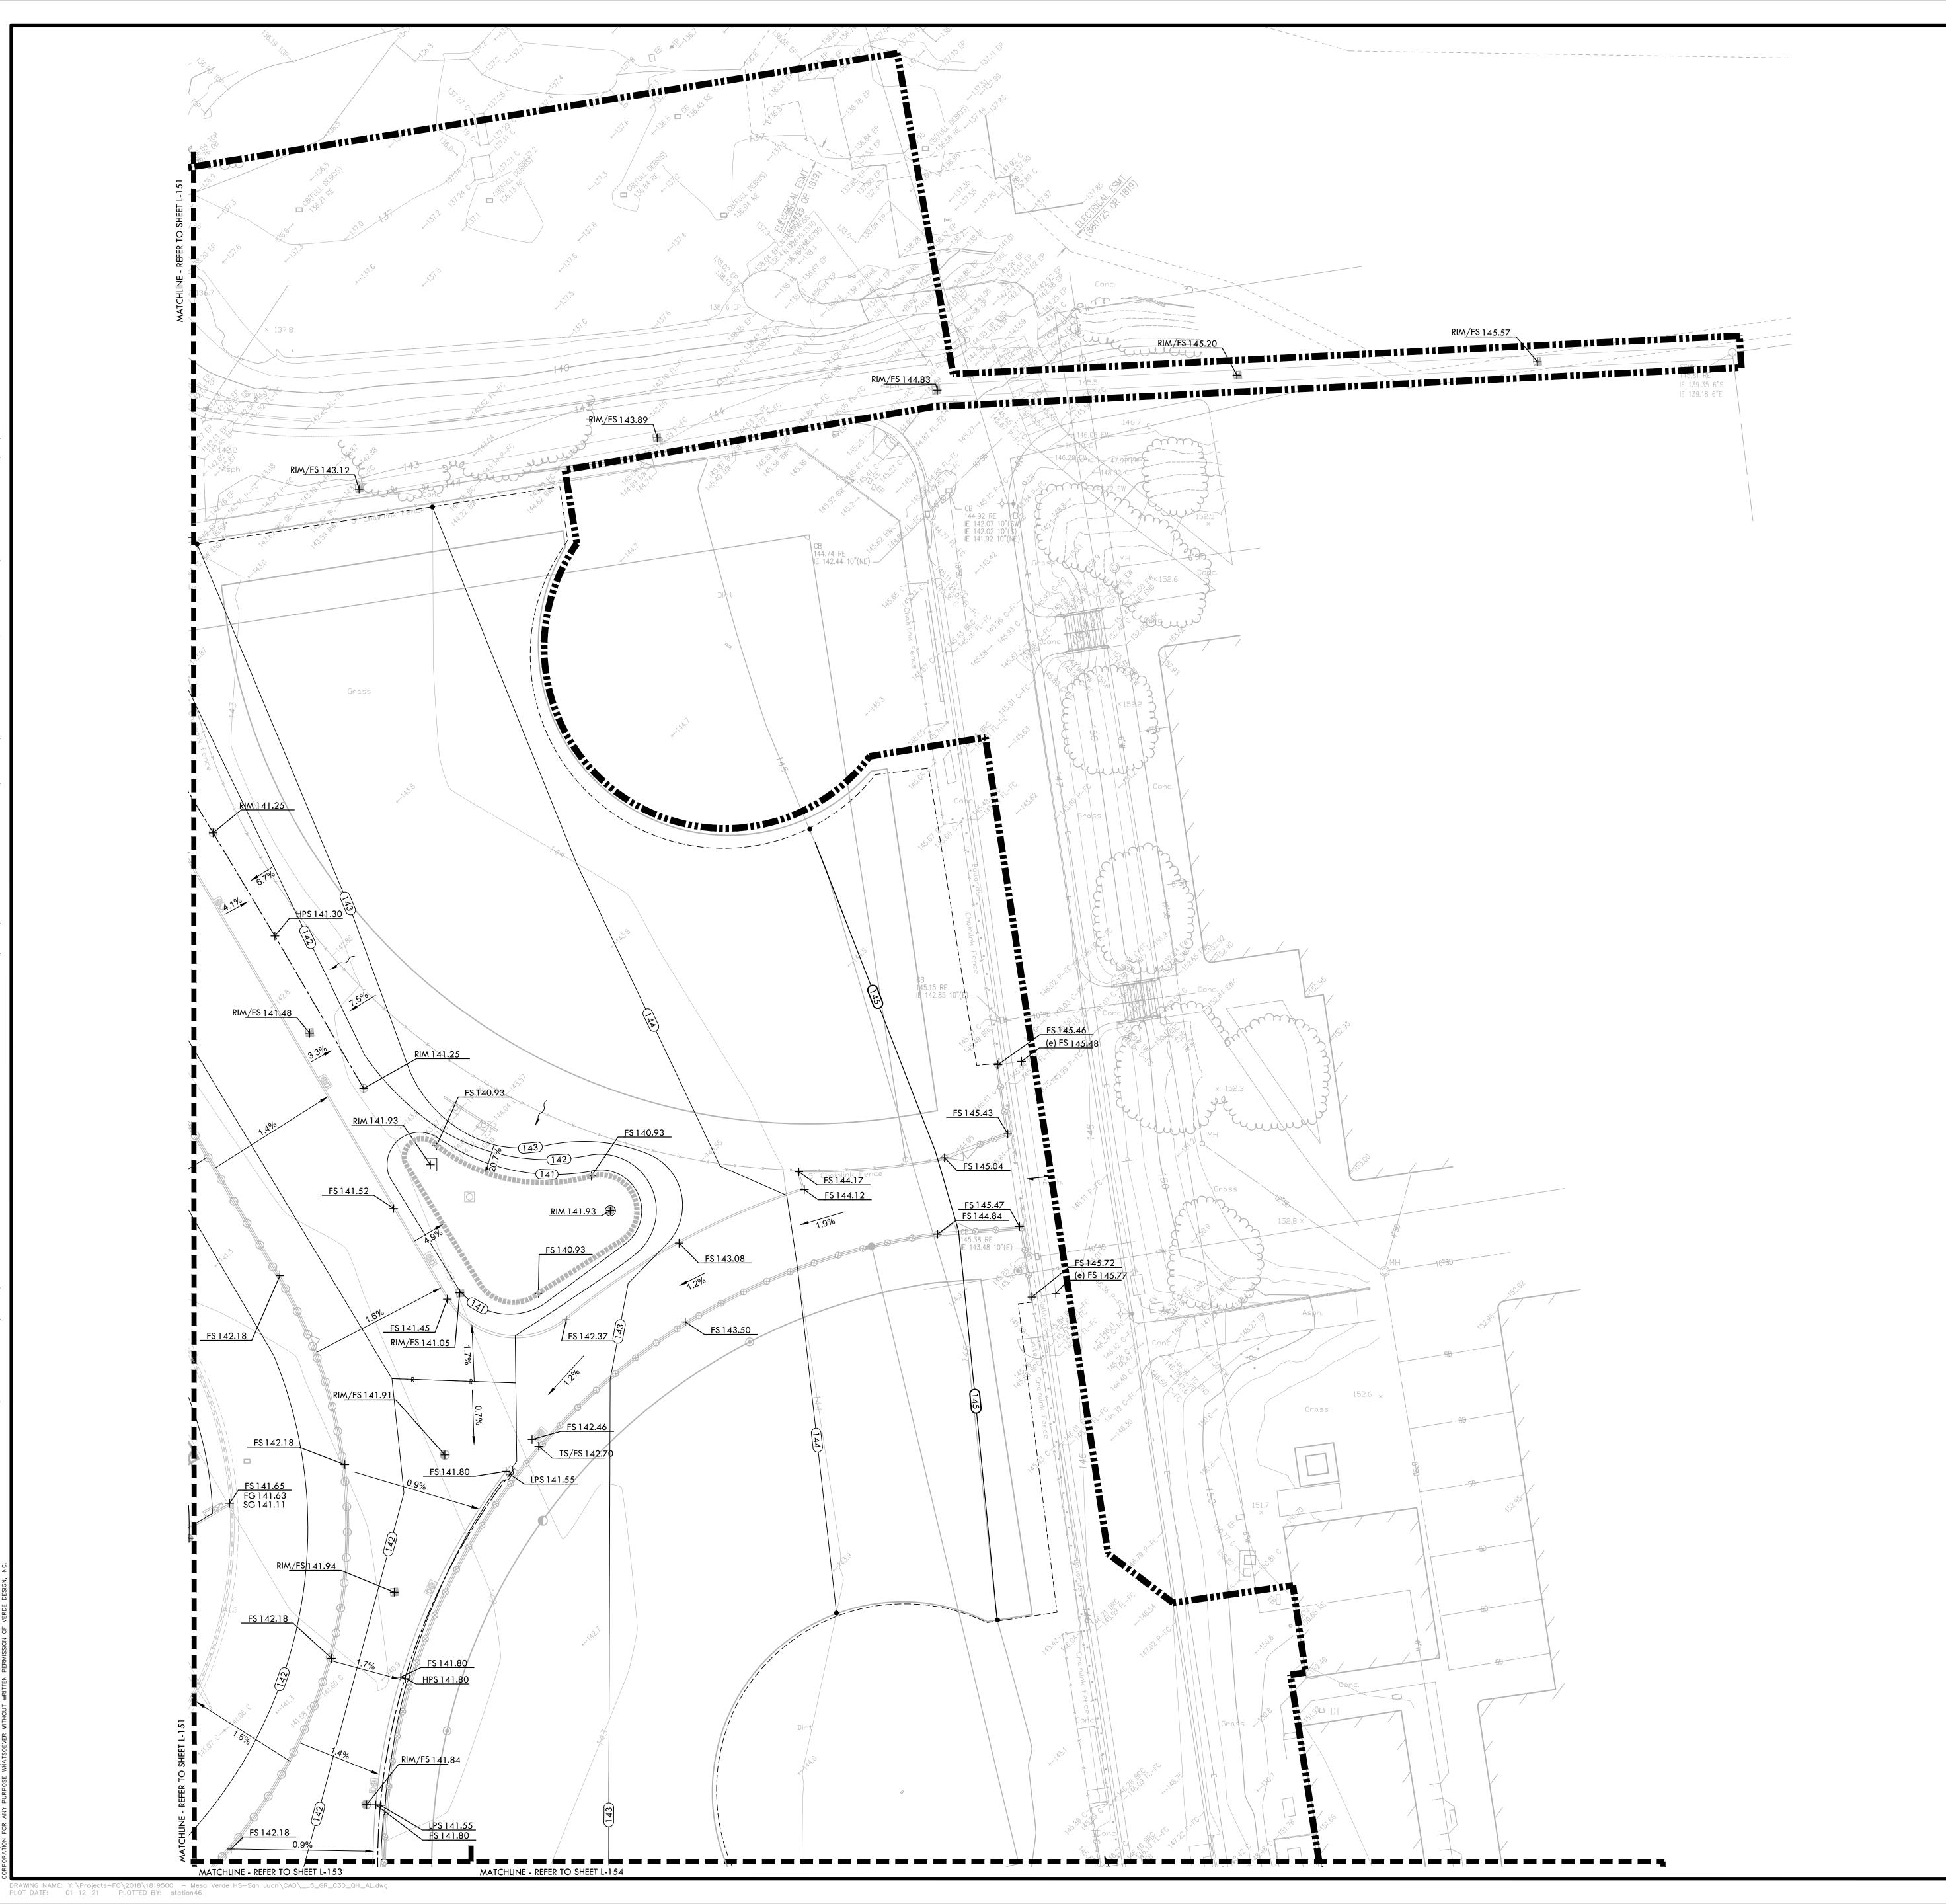

EXISTING GRADES ARE BASED ON INFORMATION PROVIDED BY: KIER AND WRIGHT. CONTRACTOR SHALL VERIFY EXISTING GRADES FOR ACCURACY PRIOR TO THE START OF GRADING, NOTIFY THE OWNER'S REPRESENTATIVE IMMEDIATELY SHOULD CONFLICTS ARISE AND REDIRECT WORK TO AVOID DELAY.

THE CONTRACTOR SHALL VERIFY THE LOCATIONS OF ALL EXISTING UTILITIES, STRUCTURES AND SERVICES BEFORE COMMENCING WORK. THE LOCATIONS OF UTILITIES, STRUCTURES AND SERVICES SHOWN IN THE CONTRACT DOCUMENTS SHALL BE DEEMED TO BE APPROXIMATIONS ONLY. ALL DISCREPANCIES BETWEEN WHAT IS SHOWN AND THE ACTUAL FIELD CONDITIONS SHALL BE REPORTED TO THE OWNER'S REPRESENTATIVE. THE CONTRACTOR SHALL CONTACT UNDER GROUND SERVICE ALERT (USA) AT (800) 227-2600 PRIOR TO ANY DEMOLITION OR EXCAVATION. UPON COMPLETION OF USA MARKING OPERATIONS, CONTRACTOR SHALL RECORD ALL UTILITY MARKINGS ON A SEPARATE SET OF DRAWINGS. THIS SET SHALL BE KEPT ON-SITE FOR REFERENCE FOR DURATION OF

PROPOSED GRADES SHALL MEET EXISTING GRADES WITH A SMOOTH AND CONTINUOUS TRANSITION SO AS TO AVOID TRAPPING WATER. CONTRACTOR SHALL NOTIFY DISTRICT REPRESENTATIVE IF PUDDLING IS SUSPECTED AND REDIRECT WORK SO AS TO AVOID DELAY WHILE AWAITING RESPONSE.

ALL EXISTING DRAINAGE STRUCTURES, BOXES, UTILITY VAULTS ETC. SHALL BE BROUGHT TO FINAL FINISH GRADE PRIOR TO FINAL SURFACE TREATMENT.

THE CITRUS HEIGHTS WATER DISTRICT HAS A 10' WATER EASEMENT THAT RUNS THROUGH THE PROPERTY. THE WATER MAIN LINE THAT IS IN THE EASEMENT IS ABANDONED IN PLACE AND IS LIKELY STEEL PIPE, PARTS MY BE ASBESTOS CEMENT PIPE. THERE SHOULD NOT BE ANY CONFLICTS WITH THE ABANDONED MAIN LINE UNLESS THE STRUCTURES BEING INSTALLED ARE 36 INCHES BELOW FINISHED GRADE. IF THE ABANDONED WATER MAIN IS REACHED AND IT IS ASBESTOS CEMENT PIPE, THE PIPE WILL NEED TO BE REMOVED AND DISCARDED IN A SPECIFIC MANNER IN ADHERENCE TO STANDARD SAFETY PROTOCOLS.

GRADING LEGEND

SYM	DESCRIPTION	STAMP
85	PROPOSED CONTOUR	REG/C
SG 85	PROPOSED SUBGRADE CONTOUR	\ ★
FG 32.00	PROPOSED FINISH GRADE ELEVATION OF SOFTSCAPE	\
F\$ 32.00	PROPOSED FINISH SURFACE ELEVATION OF HARDSCAPE	CONSULTANT
HP/HPS 32.00	HIGH POINT/ HIGH POINT OF SWALE	
LP/LPS 31.00	LOW POINT/ LOW POINT OF SWALE	
RIM 31.00	LOW POINT/ RIM ELEVATION OF DRAIN	
SG 32.00	PROPOSED FINISH SUGRADE ELEVATION	
TC 32.50	TOP OF CURB	
FF 99.00	FINISHED FLOOR ELEVATION	
TD 99.00	TOP OF TRENCH DRAIN	
	CENTER LINE OF SWALE	
R	CROWN OF FIELD, OR RIDGE LINE	
L	LOW POINT OF FIELD SUBGRADE/ PERFORATED DRAIN LINE LOCATION	
1,	CONFORM TO EXISTING GRADE	
	LIMIT OF GRADING - CONFORM TO EXISTING GRADES AT THIS LINE	
~~	FLOW DIRECTION IN SOFTSCAPE	
102	EXISTING CONTOUR	
+ 102.1	EXISTING ELEVATION	
- GB GB	GRADE BREAK	

LANDSCAPE ARCHITECTURE CIVIL ENGINEERING SPORT PLANNING & DESIGN 1843 Iron Point Rd. Suite 140 Folsom, CA 95630 tel: 916.415.6554 fax: 916.415.6525 www.VerdeDesignInc.com

VERDE DESIGN

IDENTIFICATION STAMP

DIV. OF THE STATE ARCHITECT

REVIEWED FOR

SS 🗹 FLS 🗹 ACS 🗹

APP: 02-118588 INC:




GRADING PLAN - SOUTH

MESA VERDE HIGH SCHOOL ATHLETIC FACILITY **IMPROVEMENTS**

7501 CARRIAGE DRIVE CITRUS HEIGHTS, CA 95621

UBMITTAL		DATE			
50% SUBMITTAL		08/13/2020			
OSA SUBMITTAL		10/15/2020			
DSA BACKCHECK SUBMI	TTAL	01/20/202			
O. REVISIONS		DATE			
Δ					
$\overline{\wedge}$					
$\overline{\triangle}$					
RAWN BY	CHECKED BY	'			
QH	CS/	′MB			
ATE ISSUED	SCALE				
01/20/2021	1" = 2	20'-0"			
ROJ. NO.	ROJ. NO.				
1819500					
HEET NO.					

L-152 **GRADING PLAN - SOUTH**

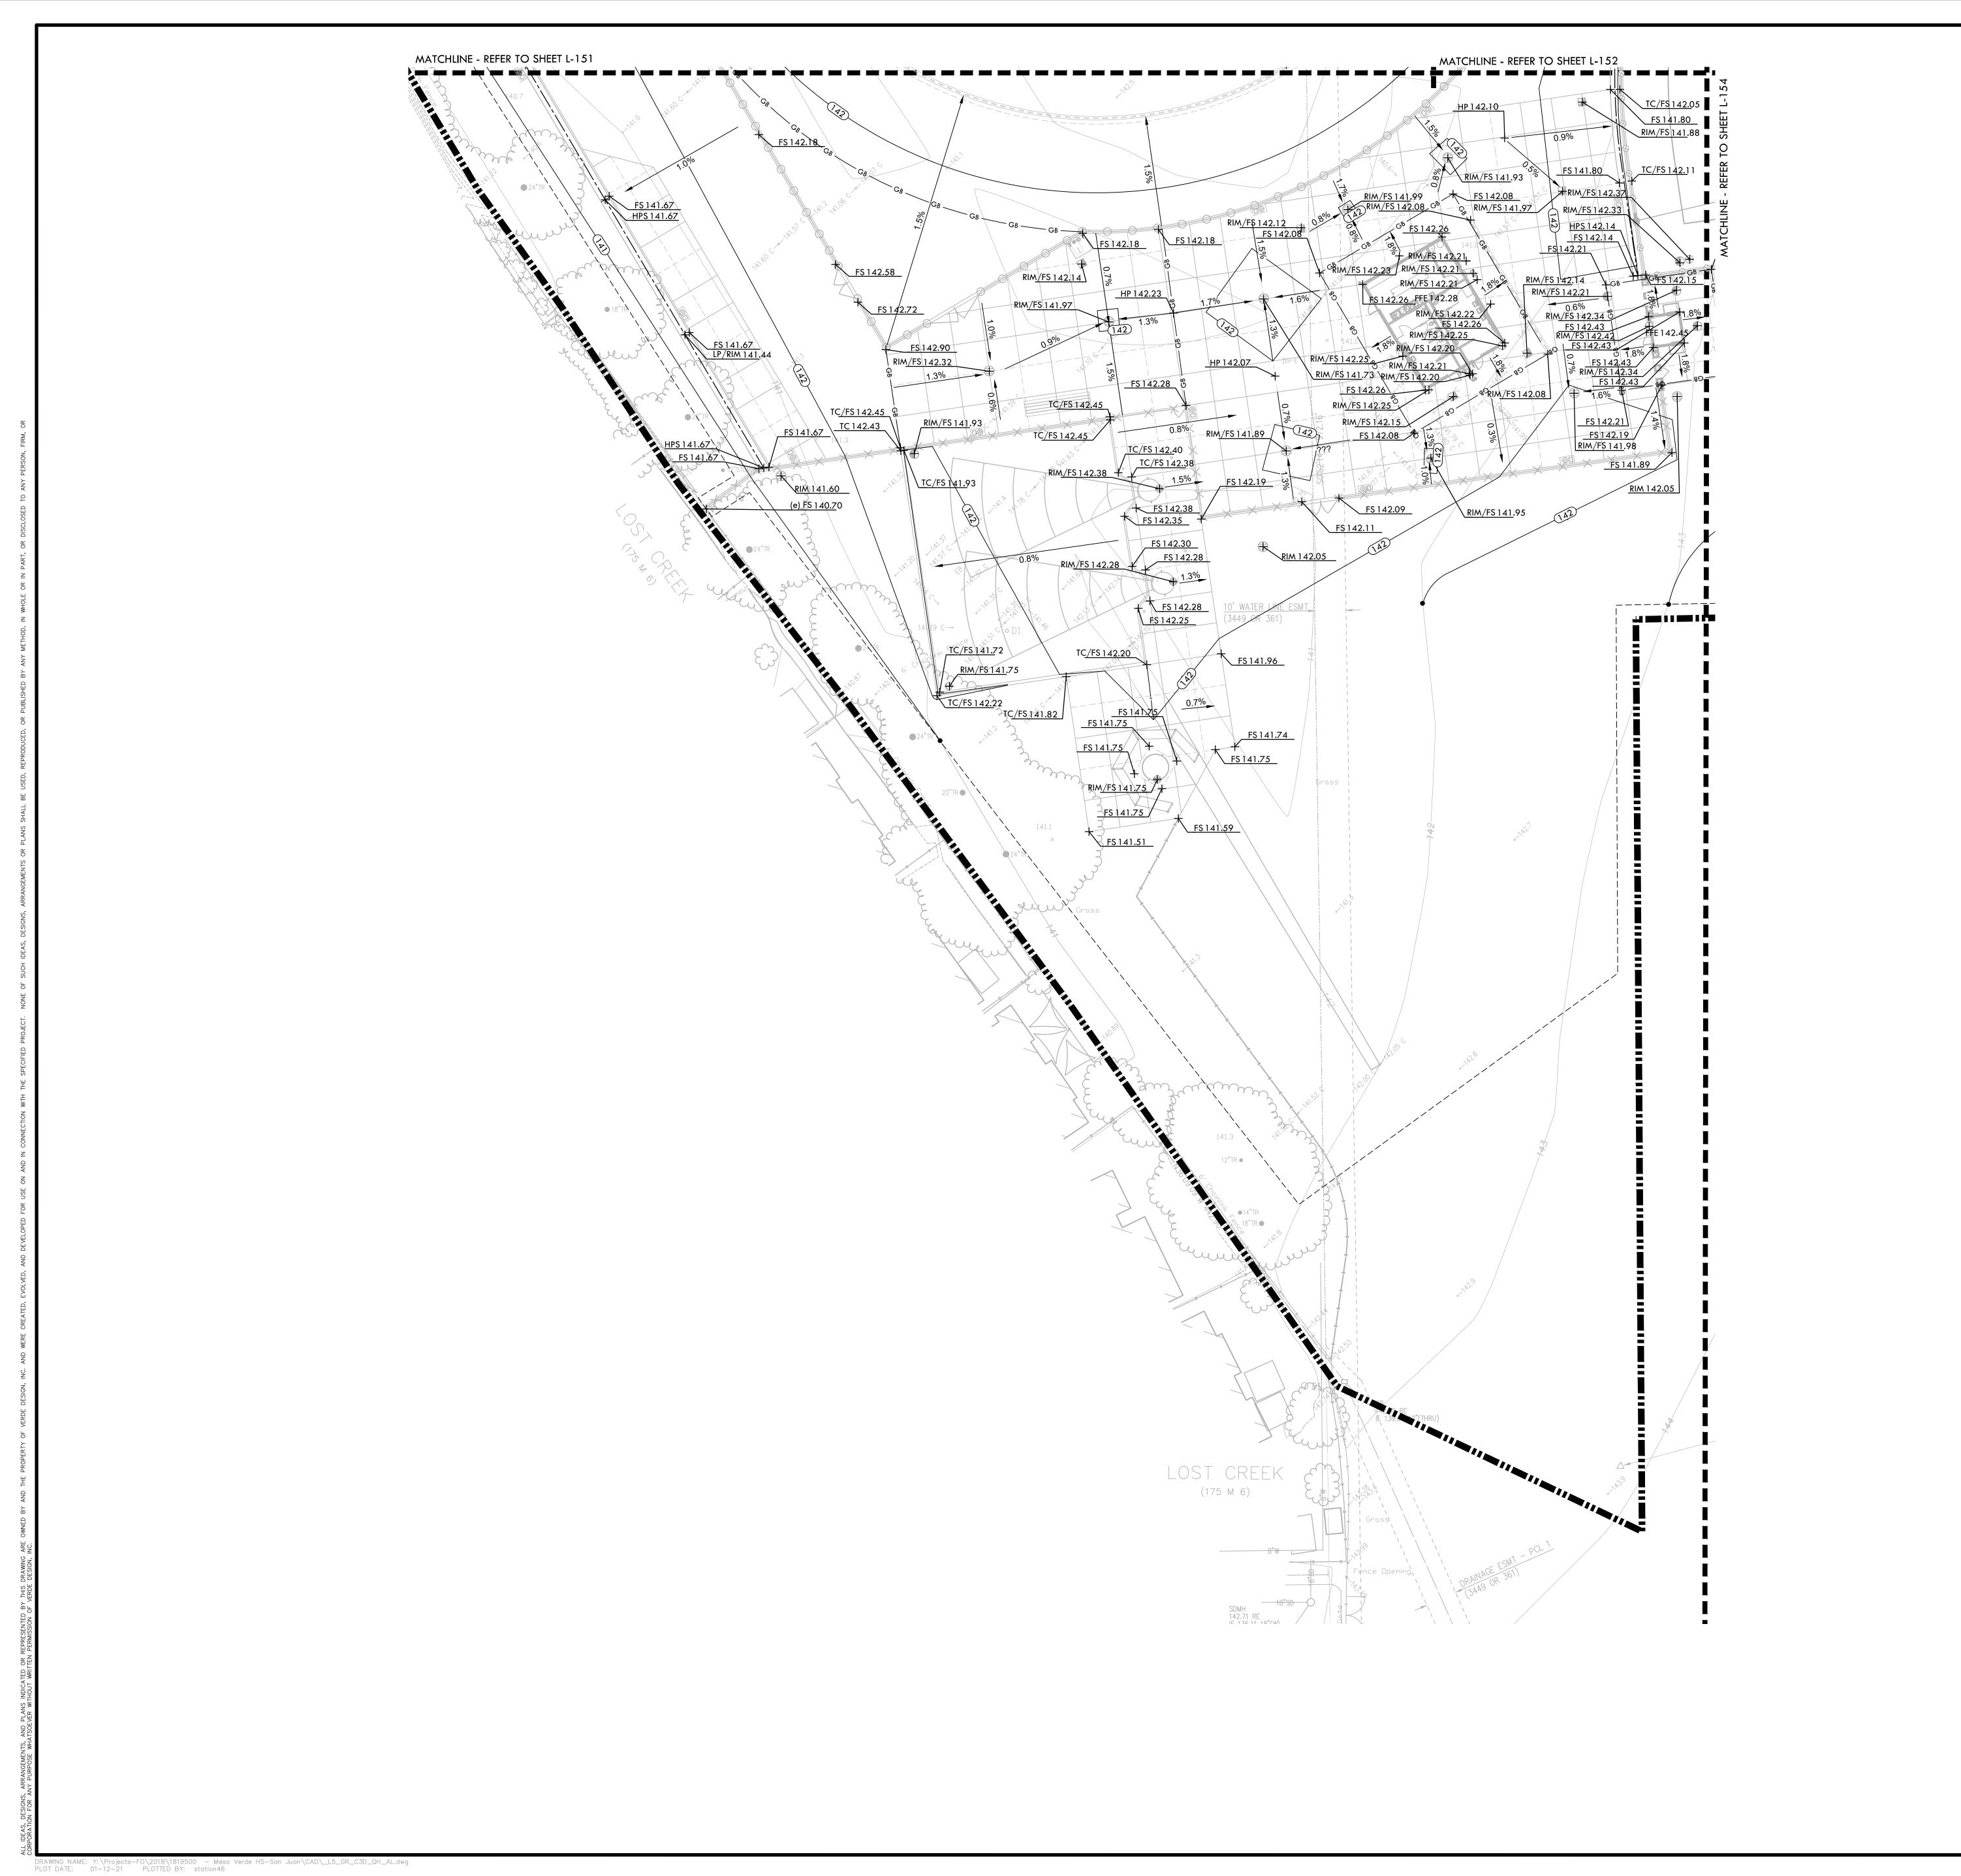

EXISTING GRADES ARE BASED ON INFORMATION PROVIDED BY: KIER AND WRIGHT.
 CONTRACTOR SHALL VERIFY EXISTING GRADES FOR ACCURACY PRIOR TO THE START OF
 GRADING, NOTIFY THE OWNER'S REPRESENTATIVE IMMEDIATELY SHOULD CONFLICTS ARISE
 AND REDIRECT WORK TO AVOID DELAY.

2. THE CONTRACTOR SHALL VERIFY THE LOCATIONS OF ALL EXISTING UTILITIES, STRUCTURES AND SERVICES BEFORE COMMENCING WORK. THE LOCATIONS OF UTILITIES, STRUCTURES AND SERVICES SHOWN IN THE CONTRACT DOCUMENTS SHALL BE DEEMED TO BE APPROXIMATIONS ONLY. ALL DISCREPANCIES BETWEEN WHAT IS SHOWN AND THE ACTUAL FIELD CONDITIONS SHALL BE REPORTED TO THE OWNER'S REPRESENTATIVE. THE CONTRACTOR SHALL CONTACT UNDER GROUND SERVICE ALERT (USA) AT (800) 227-2600 PRIOR TO ANY DEMOLITION OR EXCAVATION. UPON COMPLETION OF USA MARKING OPERATIONS, CONTRACTOR SHALL RECORD ALL UTILITY MARKINGS ON A SEPARATE SET OF DRAWINGS. THIS SET SHALL BE KEPT ON-SITE FOR REFERENCE FOR DURATION OF CONTRACT.

PROPOSED GRADES SHALL MEET EXISTING GRADES WITH A SMOOTH AND CONTINUOUS TRANSITION SO AS TO AVOID TRAPPING WATER. CONTRACTOR SHALL NOTIFY DISTRICT REPRESENTATIVE IF PUDDLING IS SUSPECTED AND REDIRECT WORK SO AS TO AVOID DELAY WHILE AWAITING RESPONSE.

4. ALL EXISTING DRAINAGE STRUCTURES, BOXES, UTILITY VAULTS ETC. SHALL BE BROUGHT TO FINAL FINISH GRADE PRIOR TO FINAL SURFACE TREATMENT.

5. THE CITRUS HEIGHTS WATER DISTRICT HAS A 10' WATER EASEMENT THAT RUNS THROUGH THE PROPERTY. THE WATER MAIN LINE THAT IS IN THE EASEMENT IS ABANDONED IN PLACE AND IS LIKELY STEEL PIPE, PARTS MY BE ASBESTOS CEMENT PIPE. THERE SHOULD NOT BE ANY CONFLICTS WITH THE ABANDONED MAIN LINE UNLESS THE STRUCTURES BEING INSTALLED ARE 36 INCHES BELOW FINISHED GRADE. IF THE ABANDONED WATER MAIN IS REACHED AND IT IS ASBESTOS CEMENT PIPE, THE PIPE WILL NEED TO BE REMOVED AND DISCARDED IN A SPECIFIC MANNER IN ADHERENCE TO STANDARD SAFETY PROTOCOLS.

DESCRIPTION

PROPOSED CONTOUR

EXISTING ELEVATION

GRADE BREAK

GRADING LEGEND

VERDE DESIGN LANDSCAPE ARCHITECTURE CIVIL ENGINEERING SPORT PLANNING & DESIGN

IDENTIFICATION STAMP

DIV. OF THE STATE ARCHITEC

REVIEWED FOR

SS 🗹 FLS 🗹 ACS 🗹

APP: 02-118588 INC:

DATE: 01/20/2021

1843 Iron Point Rd. Suite 140 Folsom, CA 95630 tel: 916.415.6554 fax: 916.415.6525 www.VerdeDesignInc.com



CONSULTANT

—(\$G 85)— PROPOSED SUBGRADE CONTOUR FG 32.00 PROPOSED FINISH GRADE ELEVATION OF SOFTSCAPE PROPOSED FINISH SURFACE ELEVATION OF HARDSCAPE HP/HPS 32.00 HIGH POINT/ HIGH POINT OF SWALE LP/LPS 31.00 LOW POINT/ LOW POINT OF SWALE RIM 31.00 LOW POINT/ RIM ELEVATION OF DRAIN SG 32.00 PROPOSED FINISH SUGRADE ELEVATION TC 32.50 TOP OF CURB FF 99.00 FINISHED FLOOR ELEVATION TOP OF TRENCH DRAIN CENTER LINE OF SWALE CROWN OF FIELD, OR RIDGE LINE LOW POINT OF FIELD SUBGRADE/ PERFORATED DRAIN LINE LOCATION CONFORM TO EXISTING GRADE LIMIT OF GRADING - CONFORM TO EXISTING GRADES AT THIS LINE FLOW DIRECTION IN SOFTSCAPE **EXISTING CONTOUR**

SHEET TITLE

GRADING PLAN - THROWS AREA


DJECT NAME


MESA VERDE
HIGH SCHOOL
ATHLETIC FACILITY
IMPROVEMENTS

PROJECT ADDRESS

7501 CARRIAGE DRIVE CITRUS HEIGHTS, CA 95621

50%	08/13/202			
DSA S	10/15/202			
DSA E	BACKCHECK SUBMITTA	AL.	01/20/20	
NO.	REVISIONS		DATE	
DRAW	'N BY	CHECKED BY		
QH CS/			MB	
DATE ISSUED SCALE				
01/20/2021 $1" = 2$			20'-0"	
PROJ. NO.				
1819500				
SHEET NO. L-153				

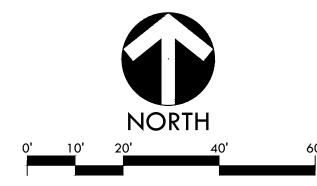

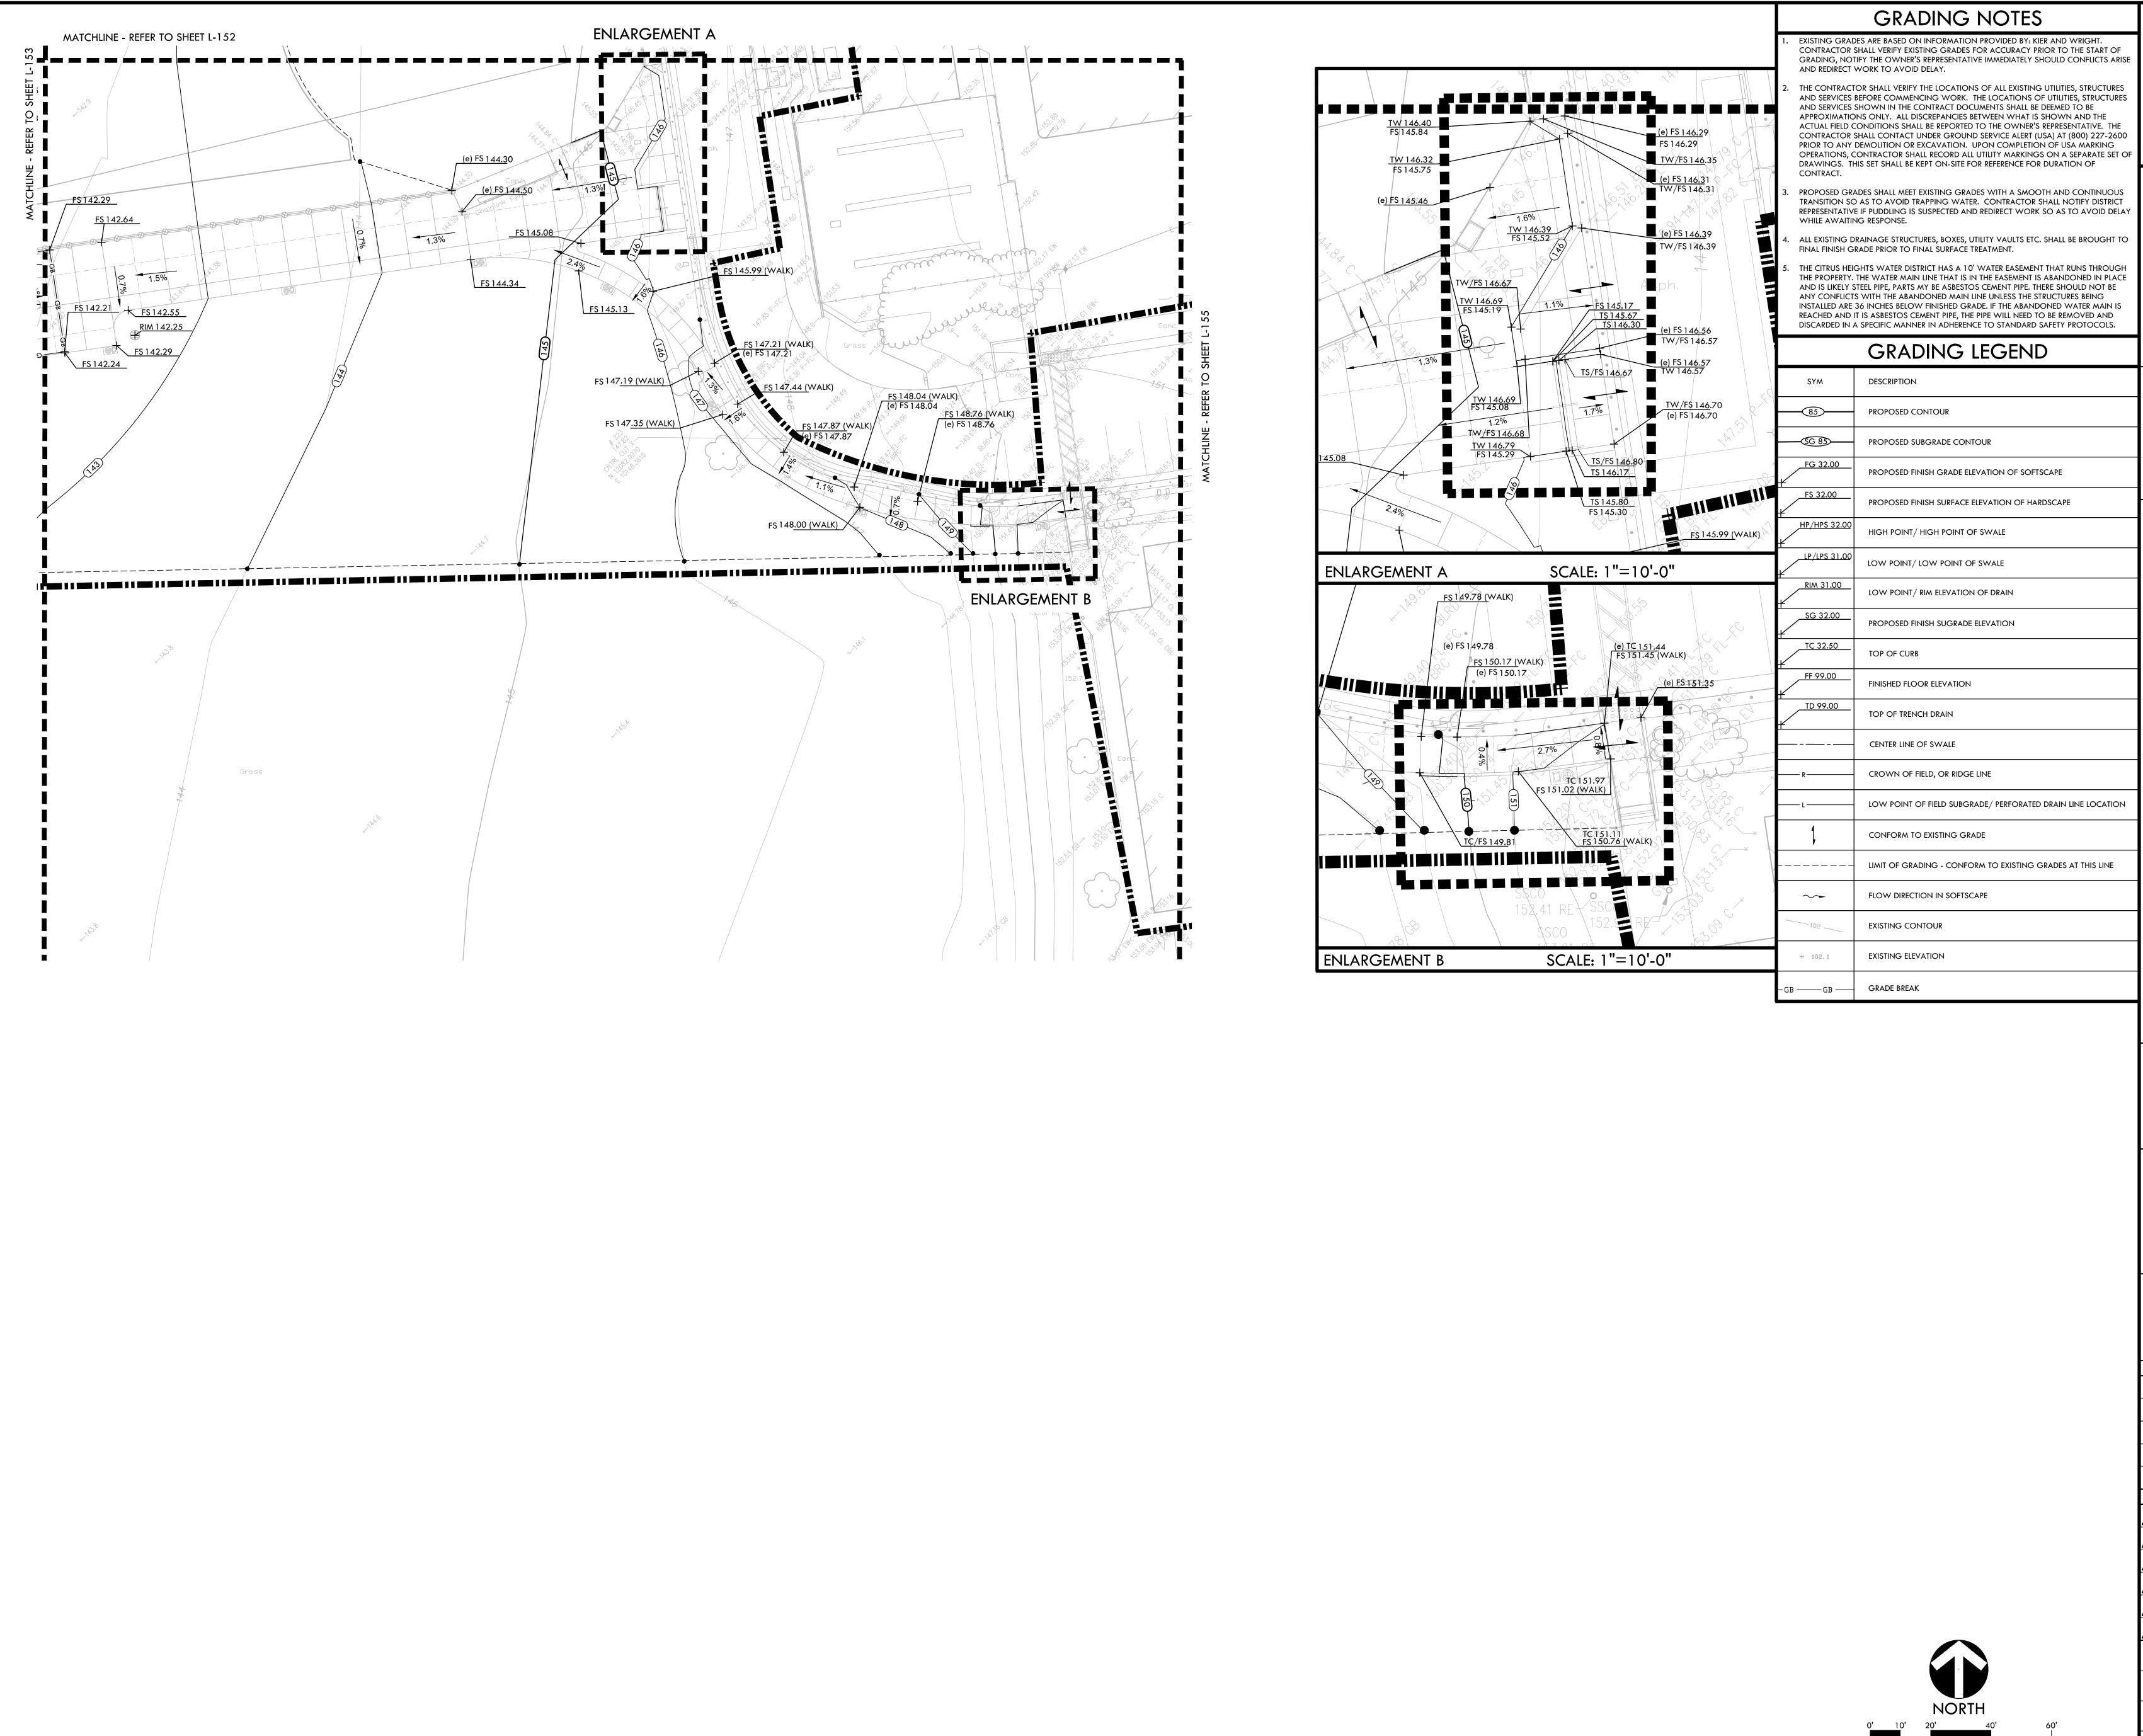

DRAWING NAME: Y:\Projects-F0\2018\1819500 - Mesa Verde HS-San Juan\CAD_L5_GR_C3D_QH_AL.dwg
PLOT DATE: 01-13-21 PLOTTED BY: station46

IDENTIFICATION STAMP DIV. OF THE STATE ARCHITECT

APP: 02-118588 INC:

REVIEWED FOR

SS FLS ACS D

DATE: 01/20/2021



fax: 916.415.6525

WWW.VerdeDesignInc.com

ANDSCAPE

No. 4089

Signature

EXPIRATION DATE:
JULY 2021

CONSULTANT

CHEET TITLE

GRADING PLAN - STADIUM ENTRY WAY AND WALK


PROJECT NAME

MESA VERDE
HIGH SCHOOL
ATHLETIC FACILITY
IMPROVEMENTS

PROJECT ADDRESS

7501 CARRIAGE DRIVE CITRUS HEIGHTS, CA 95621

SUBMITTAL			DATE
50%	50% SUBMITTAL		
DSA S	SUBMITTAL		10/15/2020
DSA B	ACKCHECK SUBMITTA	L	01/20/202
NO.	REVISIONS		DATE
\triangle			
\triangle			
\triangle			
DRAW	N BY	CHECKED BY	
QH CS/		MB	
DATE ISSUED SCALE			
01/20/2021 1" = 2			20'-0"
PROJ. NO.			
1819500			
SHEET NO. L-154			

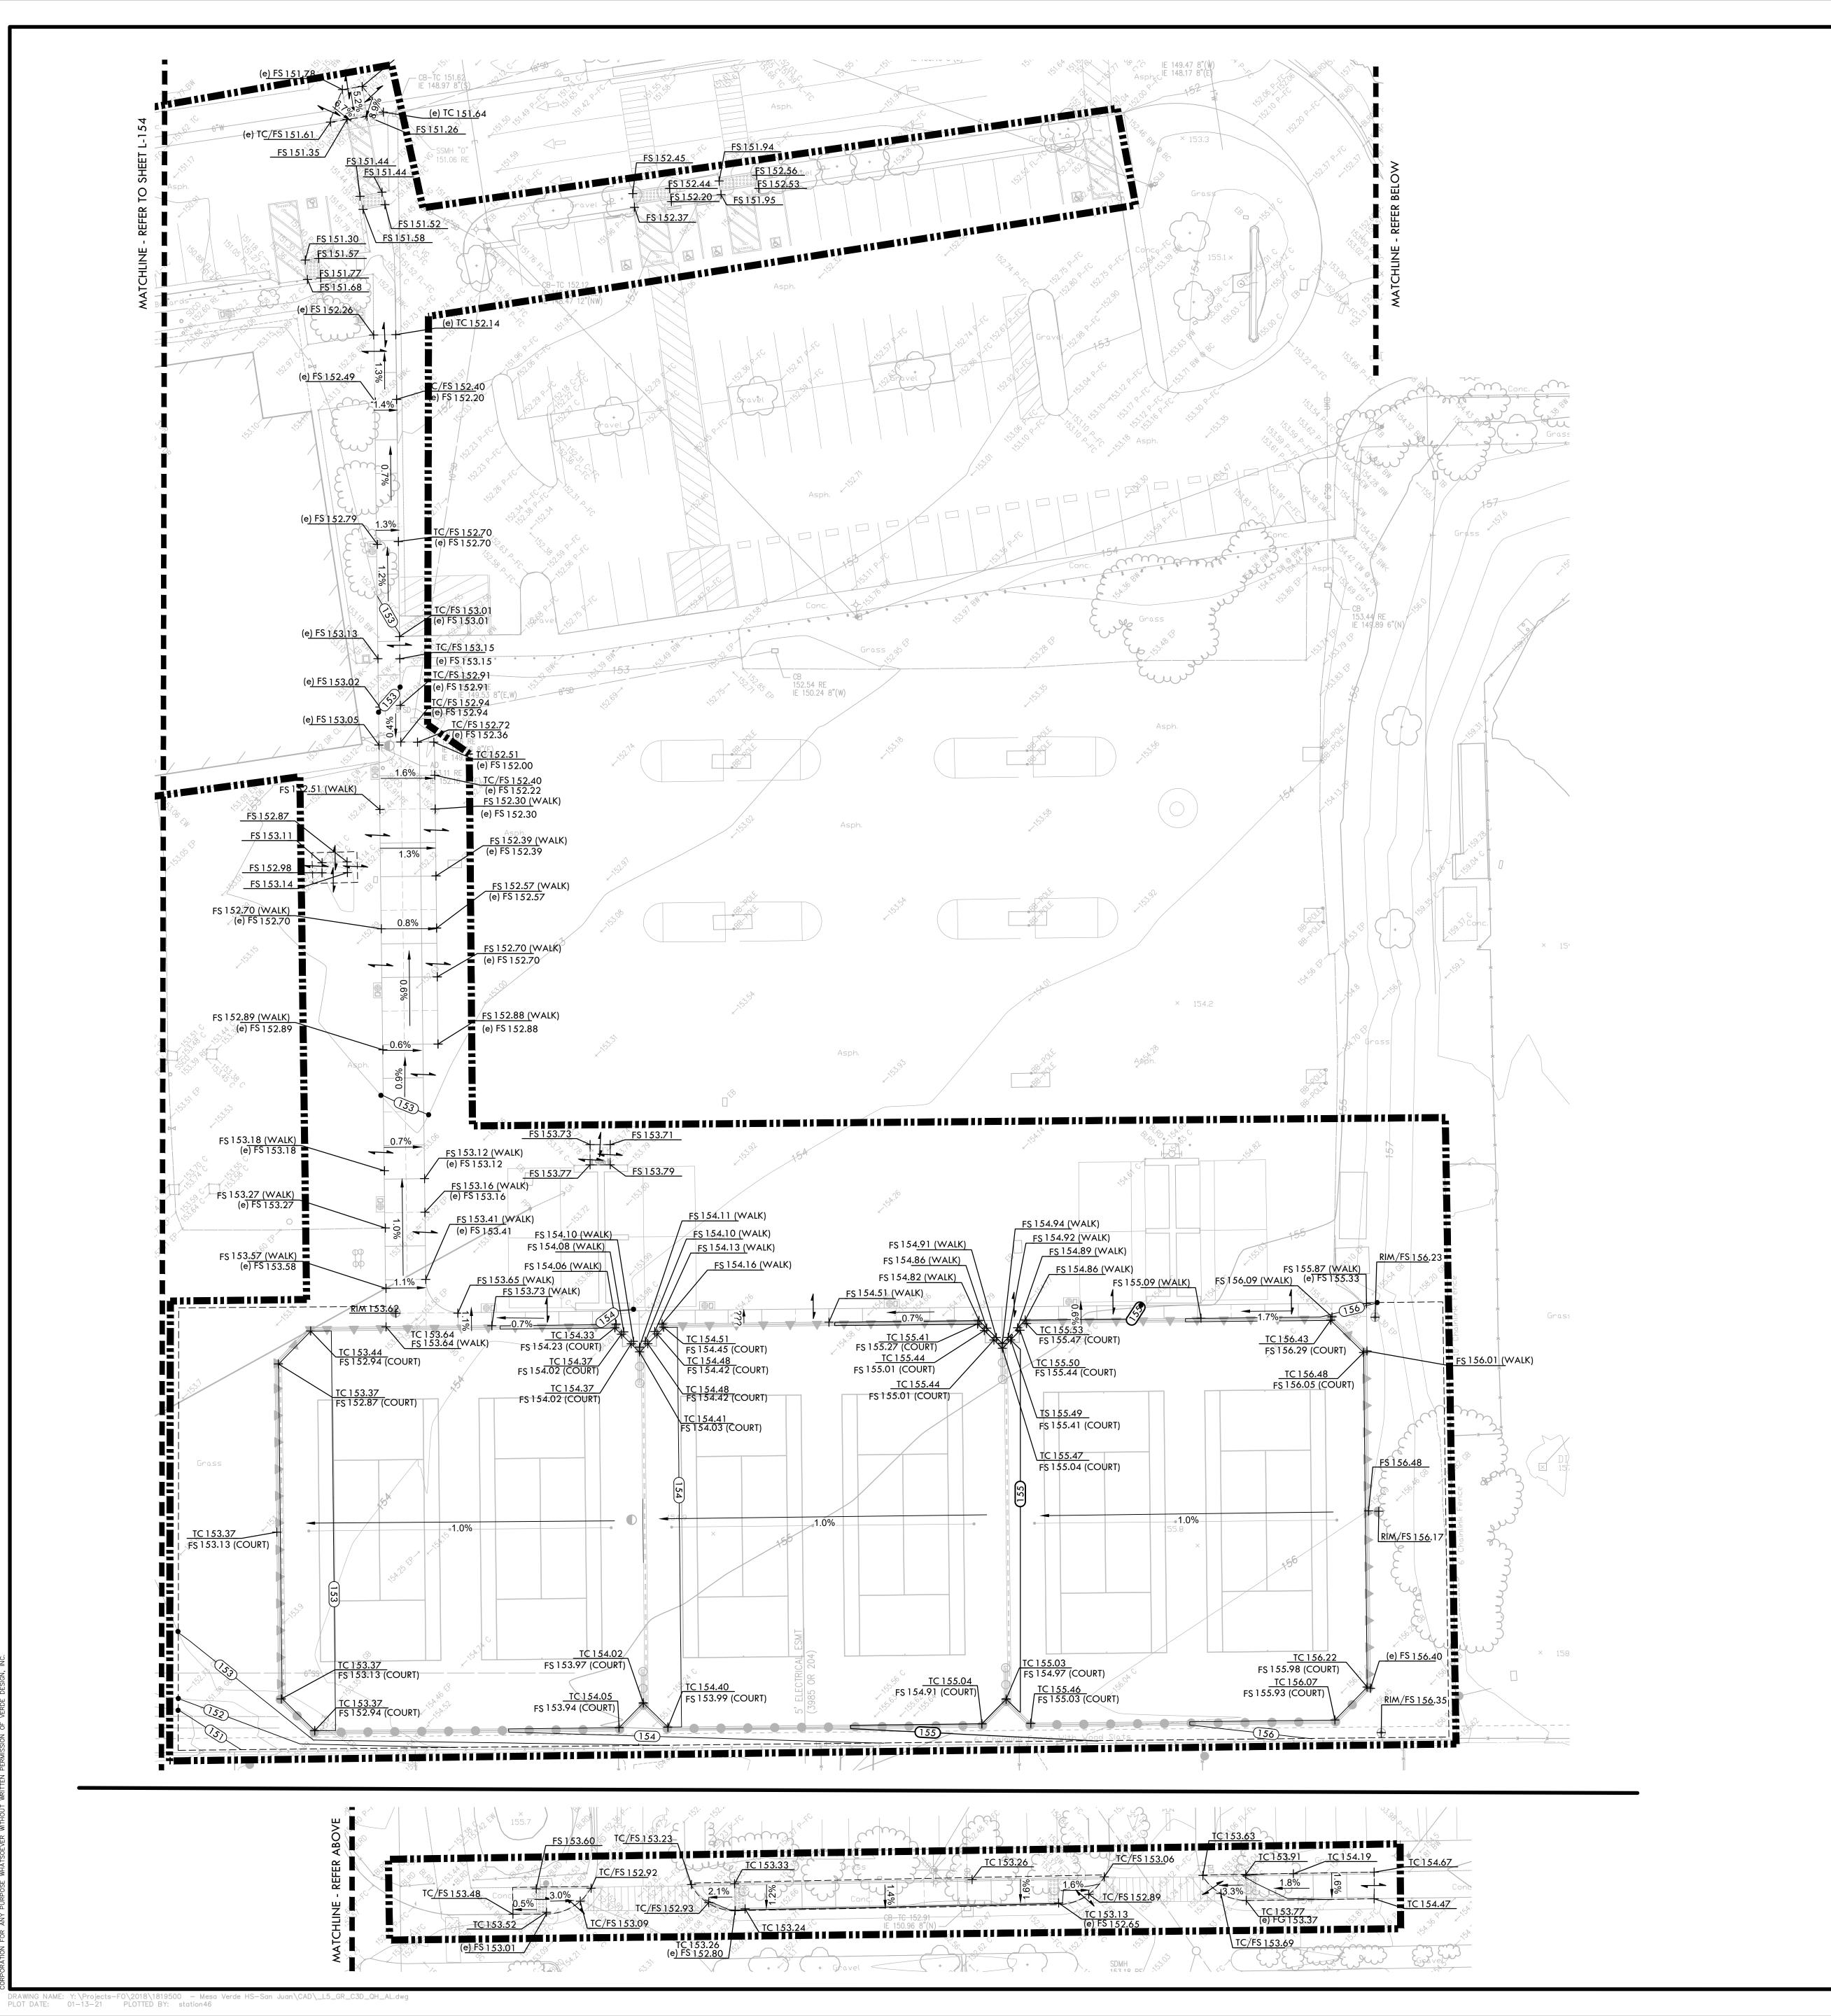

EXISTING GRADES ARE BASED ON INFORMATION PROVIDED BY: KIER AND WRIGHT. CONTRACTOR SHALL VERIFY EXISTING GRADES FOR ACCURACY PRIOR TO THE START OF GRADING, NOTIFY THE OWNER'S REPRESENTATIVE IMMEDIATELY SHOULD CONFLICTS ARISE AND REDIRECT WORK TO AVOID DELAY.

THE CONTRACTOR SHALL VERIFY THE LOCATIONS OF ALL EXISTING UTILITIES, STRUCTURES AND SERVICES BEFORE COMMENCING WORK. THE LOCATIONS OF UTILITIES, STRUCTURES AND SERVICES SHOWN IN THE CONTRACT DOCUMENTS SHALL BE DEEMED TO BE APPROXIMATIONS ONLY. ALL DISCREPANCIES BETWEEN WHAT IS SHOWN AND THE ACTUAL FIELD CONDITIONS SHALL BE REPORTED TO THE OWNER'S REPRESENTATIVE. THE CONTRACTOR SHALL CONTACT UNDER GROUND SERVICE ALERT (USA) AT (800) 227-2600 PRIOR TO ANY DEMOLITION OR EXCAVATION. UPON COMPLETION OF USA MARKING OPERATIONS, CONTRACTOR SHALL RECORD ALL UTILITY MARKINGS ON A SEPARATE SET OF DRAWINGS. THIS SET SHALL BE KEPT ON-SITE FOR REFERENCE FOR DURATION OF

PROPOSED GRADES SHALL MEET EXISTING GRADES WITH A SMOOTH AND CONTINUOUS TRANSITION SO AS TO AVOID TRAPPING WATER. CONTRACTOR SHALL NOTIFY DISTRICT REPRESENTATIVE IF PUDDLING IS SUSPECTED AND REDIRECT WORK SO AS TO AVOID DELAY WHILE AWAITING RESPONSE.

ALL EXISTING DRAINAGE STRUCTURES, BOXES, UTILITY VAULTS ETC. SHALL BE BROUGHT TO FINAL FINISH GRADE PRIOR TO FINAL SURFACE TREATMENT.

THE CITRUS HEIGHTS WATER DISTRICT HAS A 10' WATER EASEMENT THAT RUNS THROUGH THE PROPERTY. THE WATER MAIN LINE THAT IS IN THE EASEMENT IS ABANDONED IN PLACE AND IS LIKELY STEEL PIPE, PARTS MY BE ASBESTOS CEMENT PIPE. THERE SHOULD NOT BE ANY CONFLICTS WITH THE ABANDONED MAIN LINE UNLESS THE STRUCTURES BEING INSTALLED ARE 36 INCHES BELOW FINISHED GRADE. IF THE ABANDONED WATER MAIN IS REACHED AND IT IS ASBESTOS CEMENT PIPE, THE PIPE WILL NEED TO BE REMOVED AND DISCARDED IN A SPECIFIC MANNER IN ADHERENCE TO STANDARD SAFETY PROTOCOLS.

GRADING LEGEND

DESCRIPTION

PROPOSED CONTOUR

PROPOSED SUBGRADE CONTOUR

IDENTIFICATION STAMP

DIV. OF THE STATE ARCHITEC

REVIEWED FOR

SS 🗹 FLS 🗹 ACS 🗹

APP: 02-118588 INC:

VERDE DESIGN LANDSCAPE ARCHITECTURE CIVIL ENGINEERING SPORT PLANNING & DESIGN

1843 Iron Point Rd. Suite 140 Folsom, CA 95630 tel: 916.415.6554 fax: 916.415.6525 www.VerdeDesignInc.com



CONSULTANT

FG 32.00 PROPOSED FINISH GRADE ELEVATION OF SOFTSCAPE PROPOSED FINISH SURFACE ELEVATION OF HARDSCAPE HP/HPS 32.00 HIGH POINT/ HIGH POINT OF SWALE __LP/LPS 31.00 LOW POINT/ LOW POINT OF SWALE RIM 31.00 LOW POINT/ RIM ELEVATION OF DRAIN PROPOSED FINISH SUGRADE ELEVATION TC 32.50 TOP OF CURB FINISHED FLOOR ELEVATION TOP OF TRENCH DRAIN CENTER LINE OF SWALE CROWN OF FIELD, OR RIDGE LINE LOW POINT OF FIELD SUBGRADE/ PERFORATED DRAIN LINE LOCATION CONFORM TO EXISTING GRADE LIMIT OF GRADING - CONFORM TO EXISTING GRADES AT THIS LINE FLOW DIRECTION IN SOFTSCAPE **EXISTING CONTOUR** EXISTING ELEVATION GRADE BREAK

GRADING PLAN - TENNIS


PROJECT NAME

MESA VERDE HIGH SCHOOL ATHLETIC FACILITY **IMPROVEMENTS**


PROJECT ADDRESS


7501 CARRIAGE DRIVE CITRUS HEIGHTS, CA 95621

SUBMITTAL			DATE
50% SUBMITTAL			08/13/2020
DSA S	SUBMITTAL		10/15/2020
DSA E	BACKCHECK SUBMITTA	.L	01/20/202
NO.	REVISIONS		DATE
\triangle			
DRAW	'N BY	CHECKED BY	
QH CS/		MB	
DATE ISSUED SCALE			
01/20/2021 $1" = 2$		20'-0"	
PROJ.		•	
	1819	9500	
SHEET NO.			
L-155			

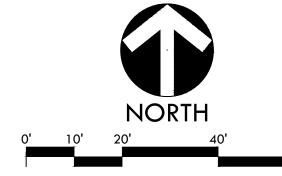



GRADING PLAN - TENNIS

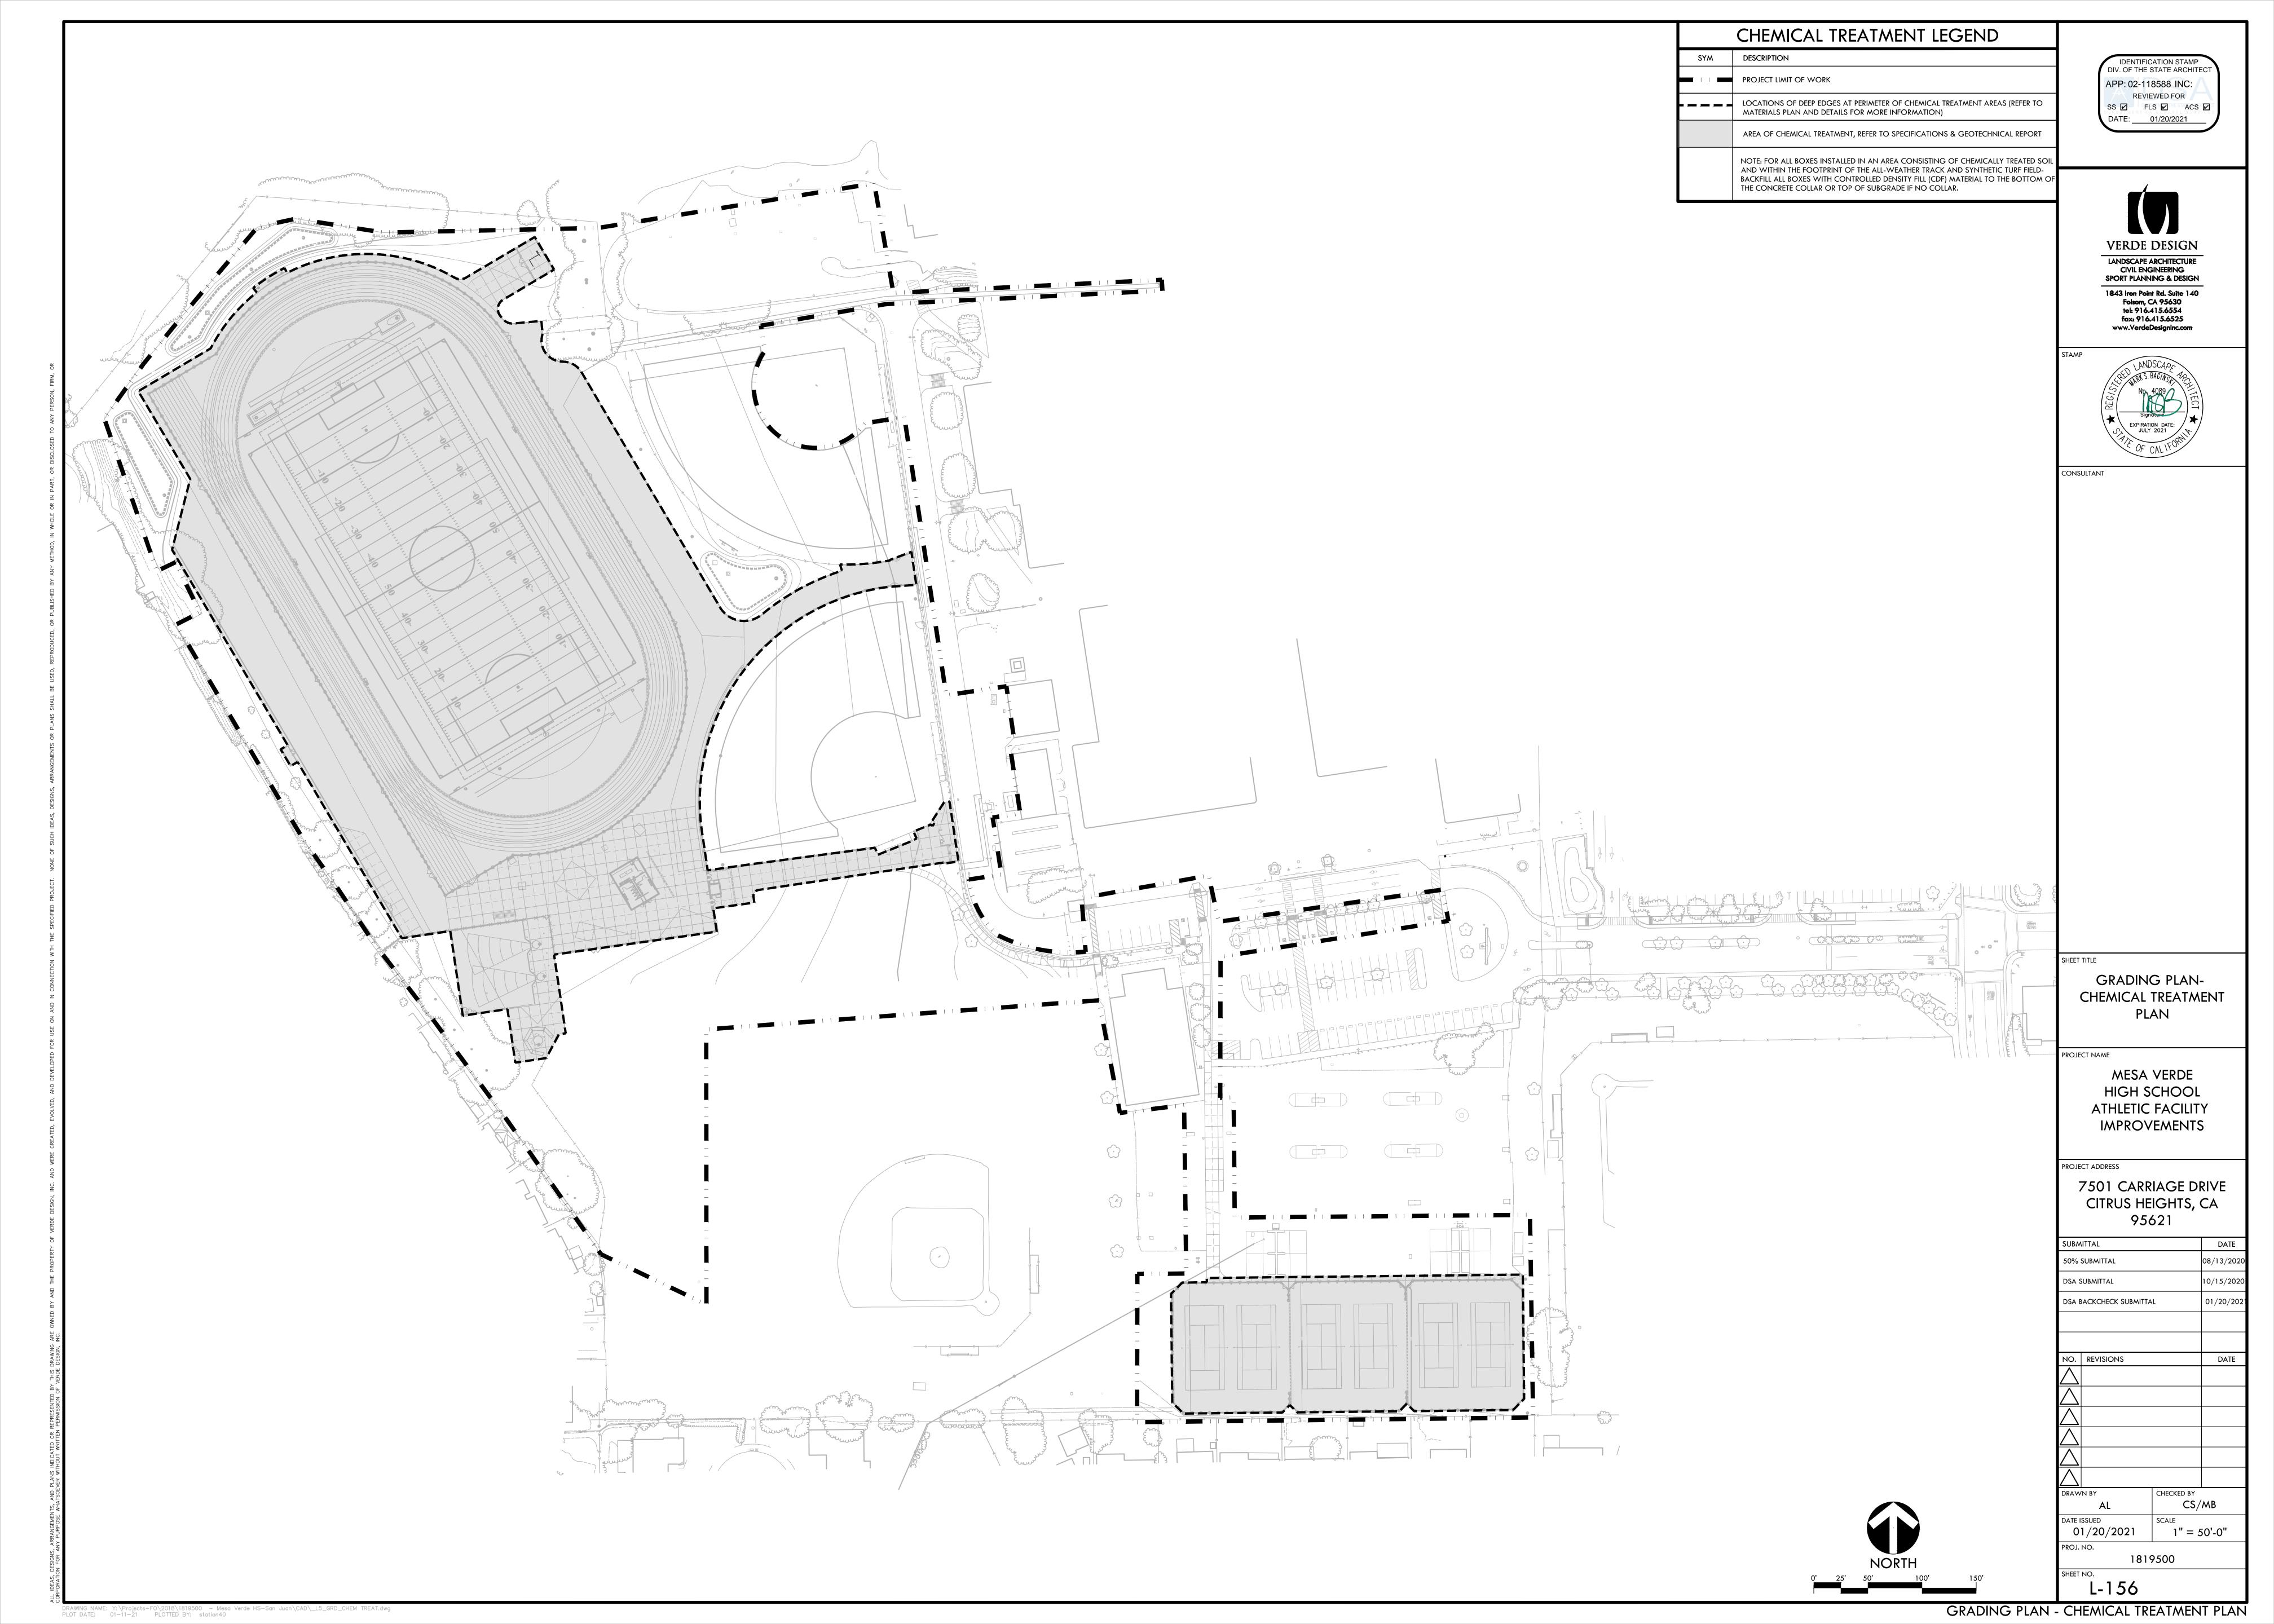


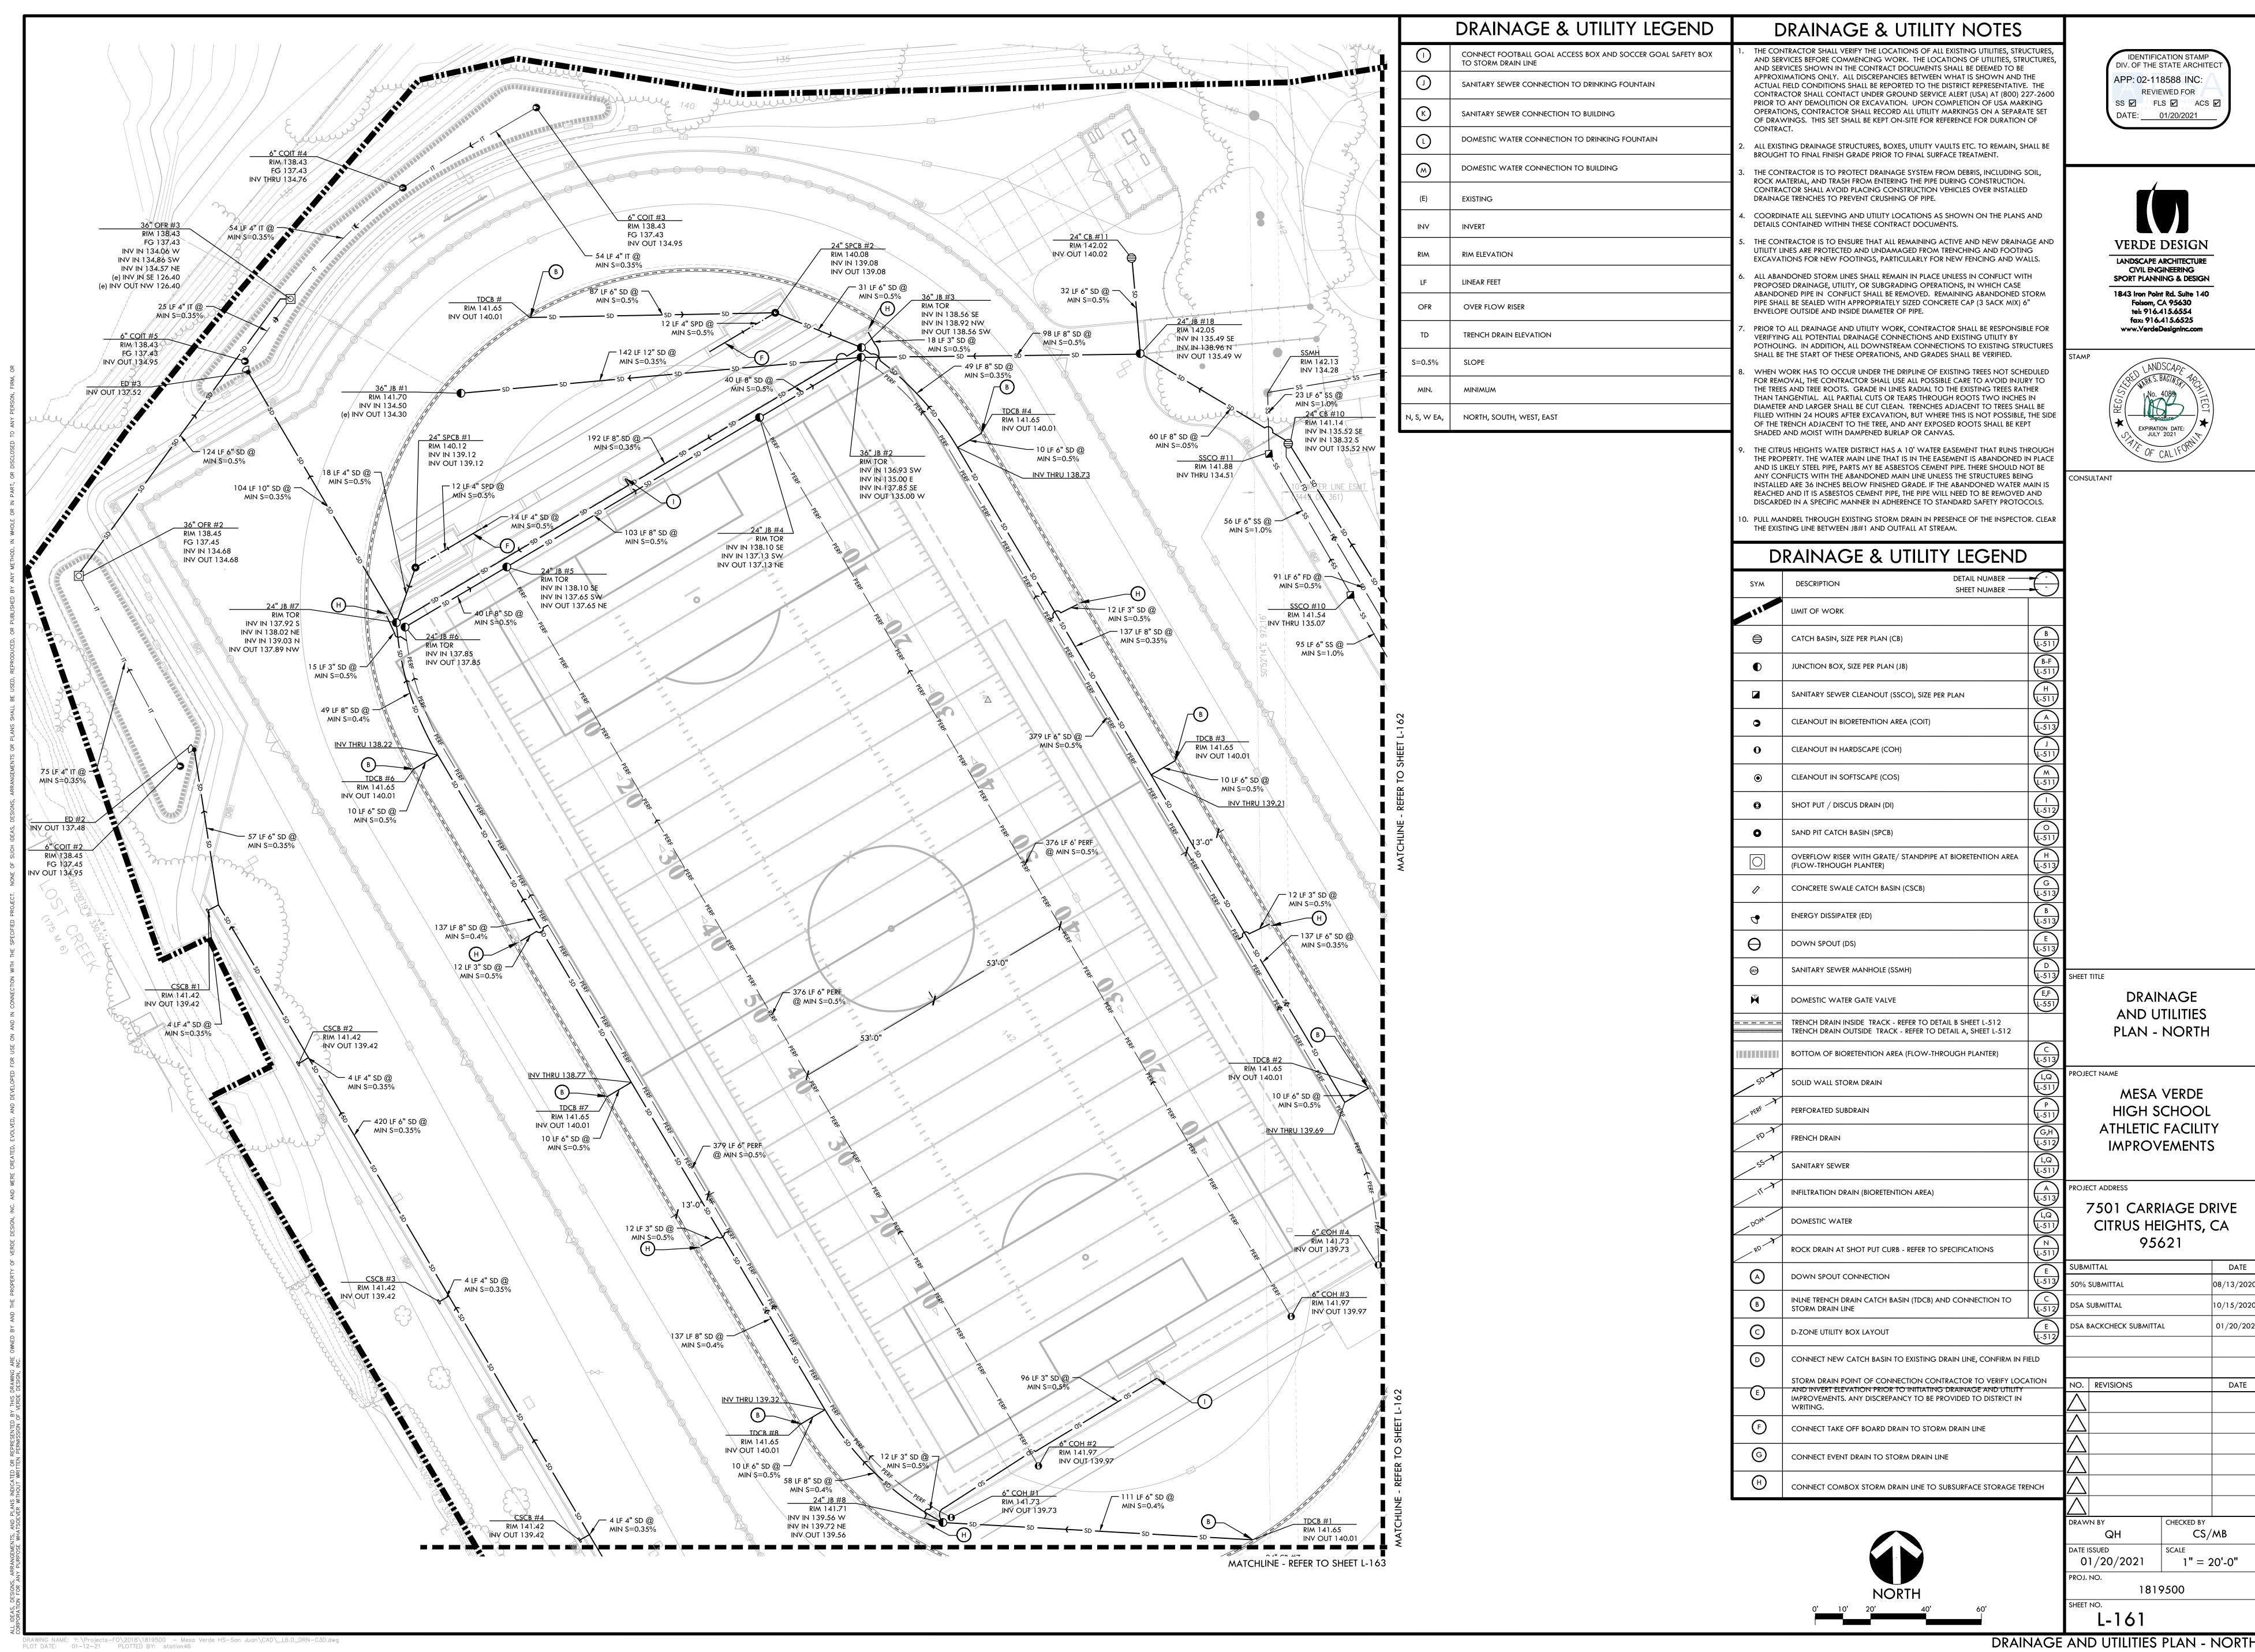

DRAINAGE AND UTILITIES PLAN - NORTH

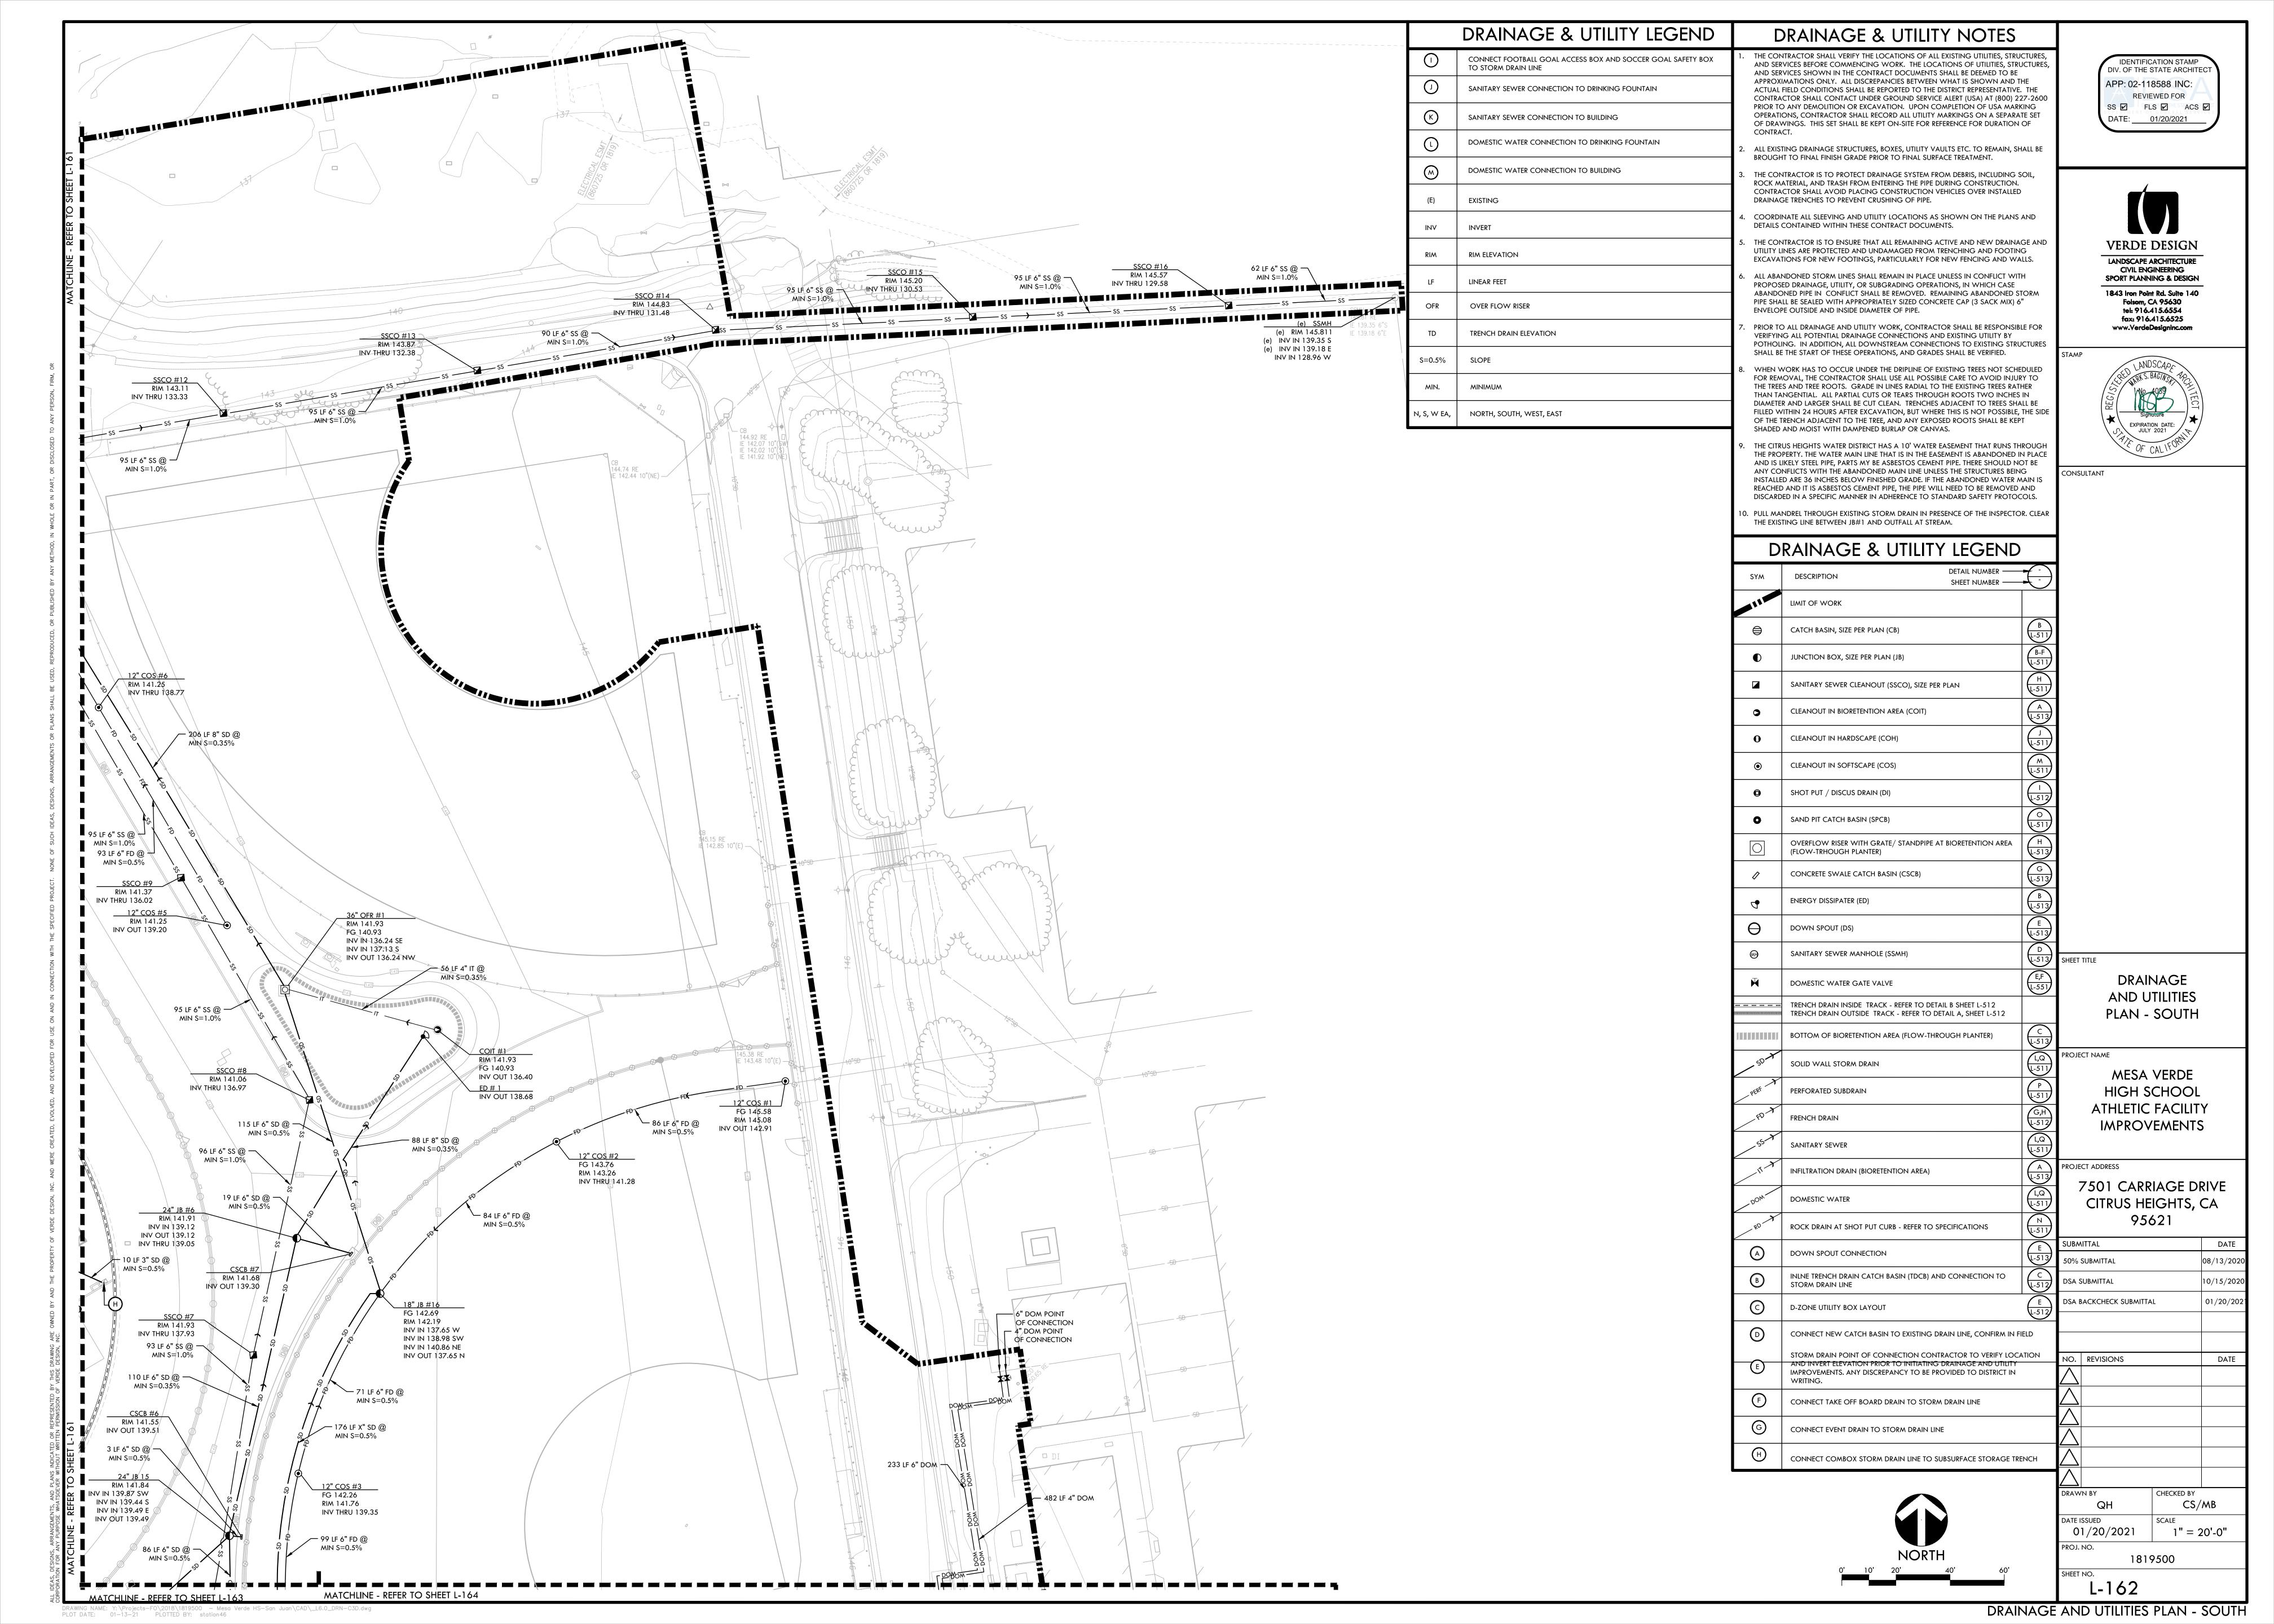

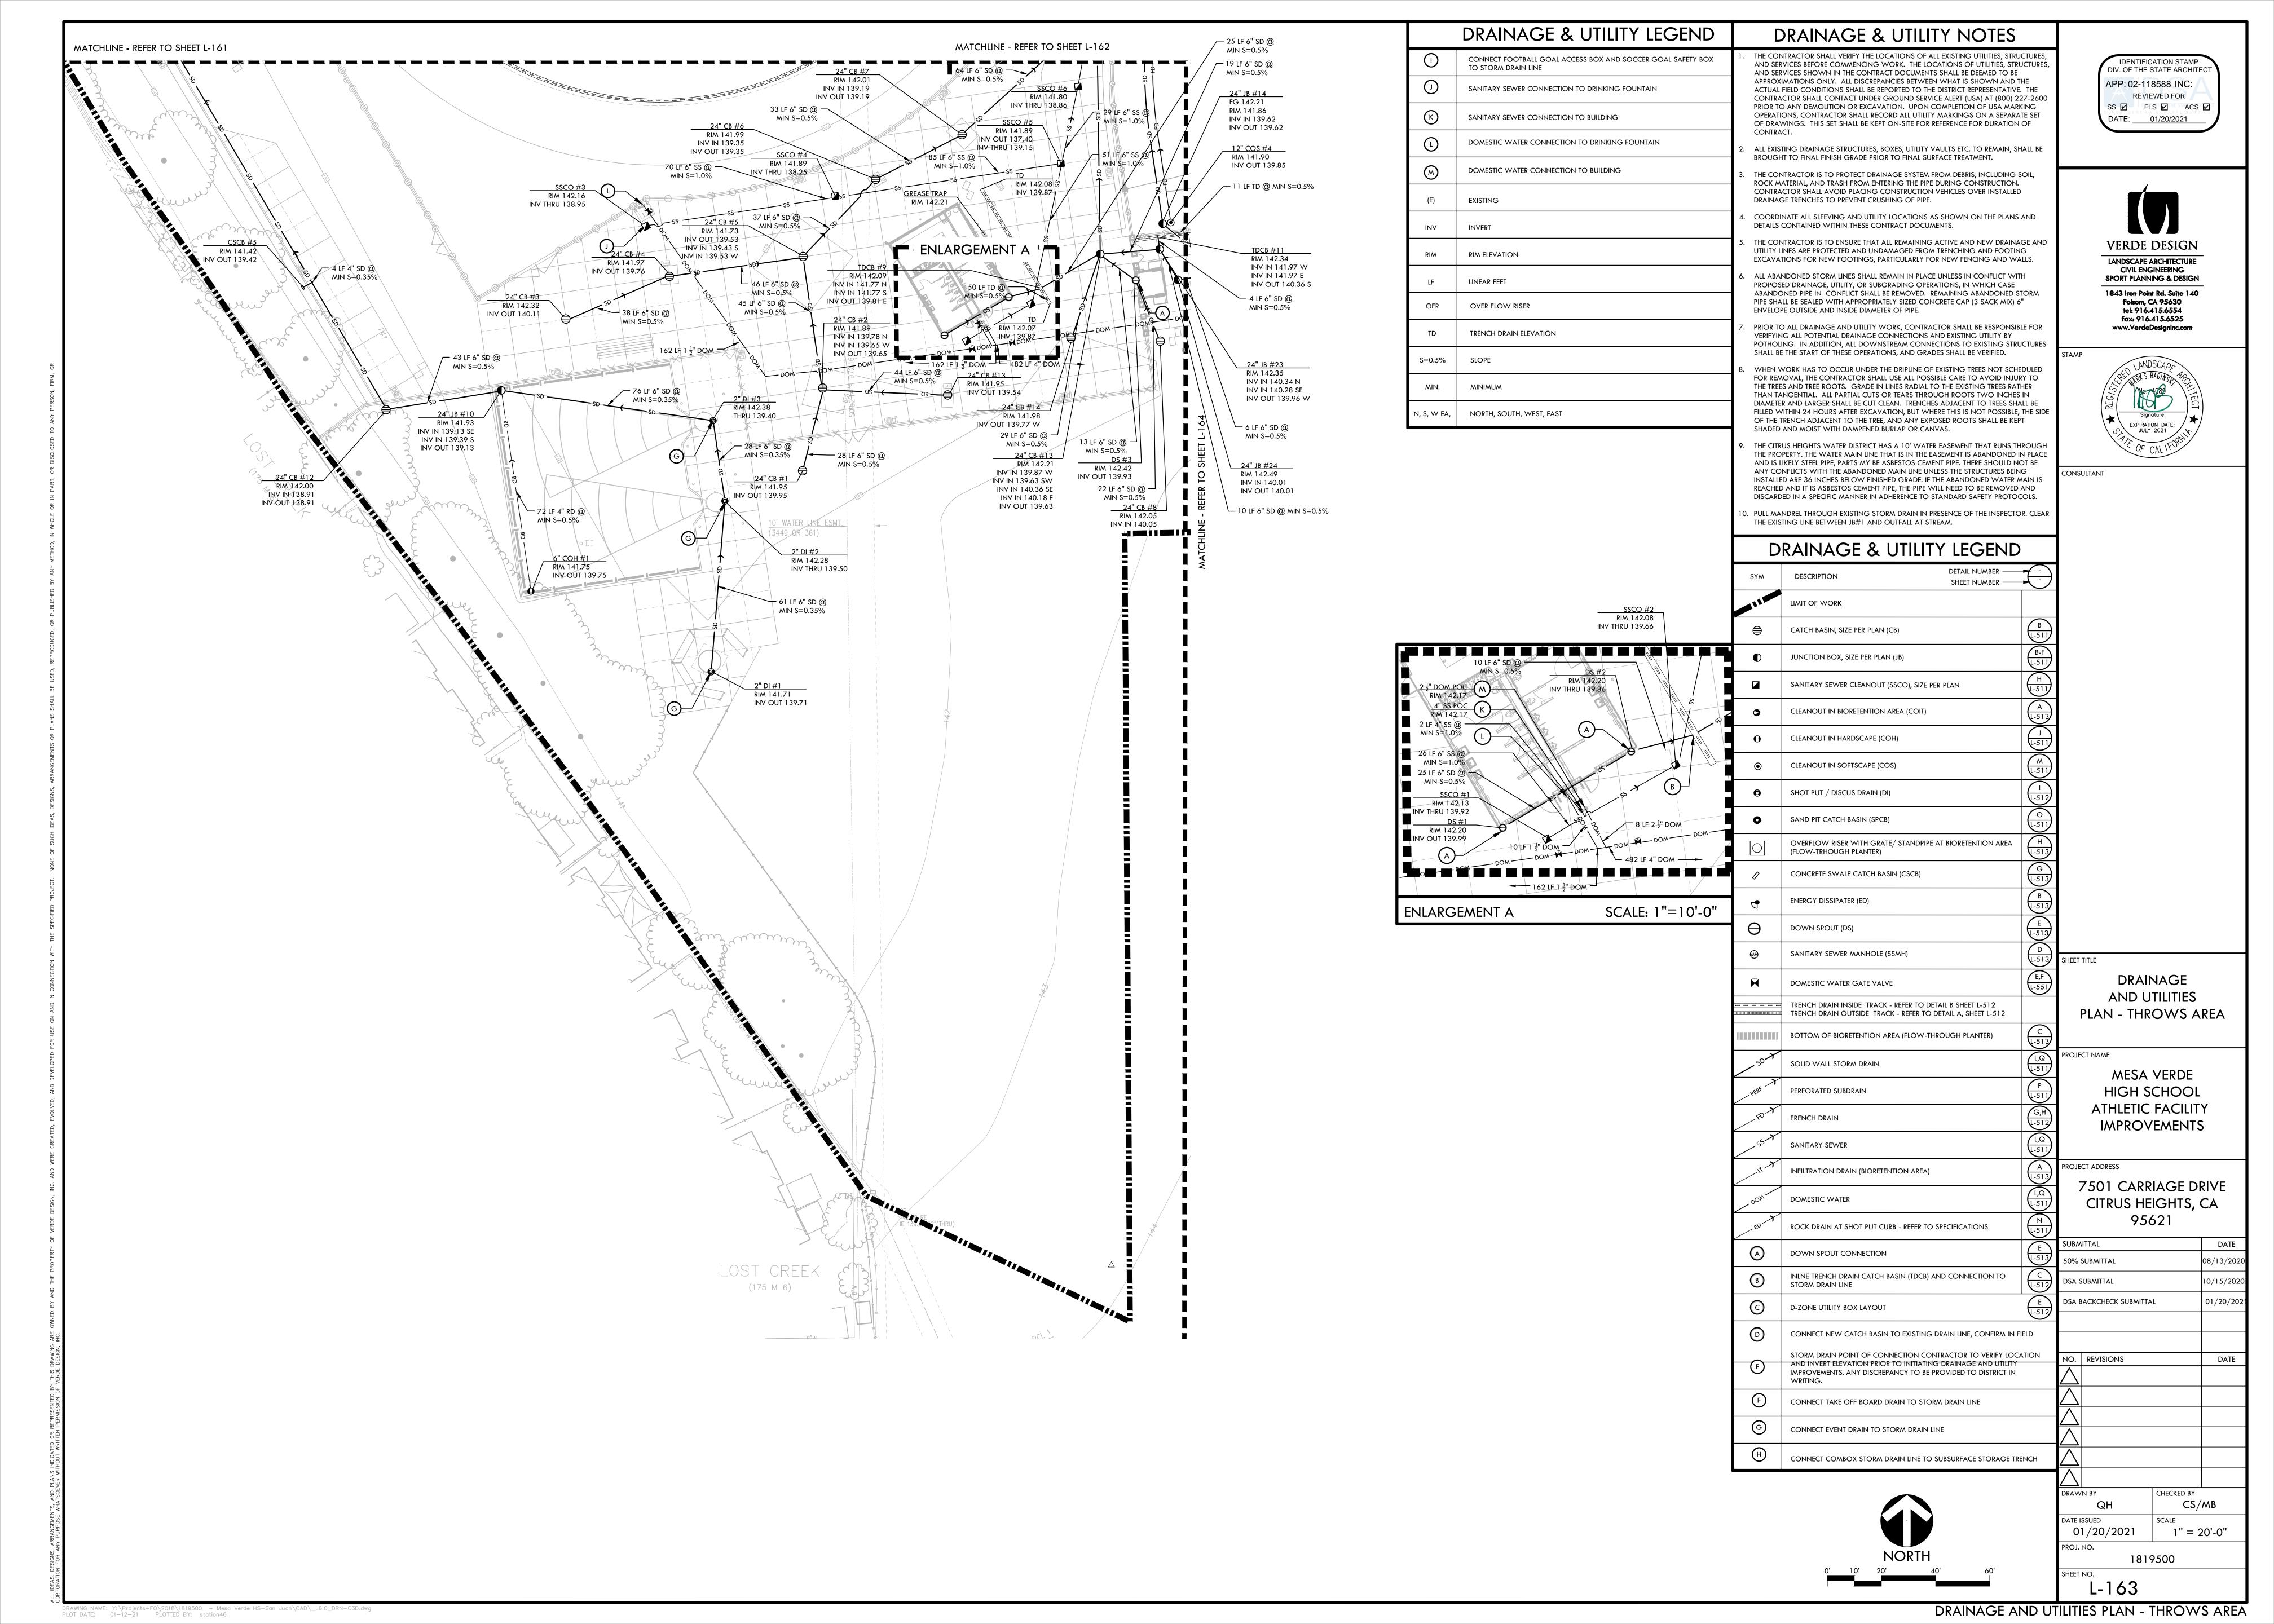

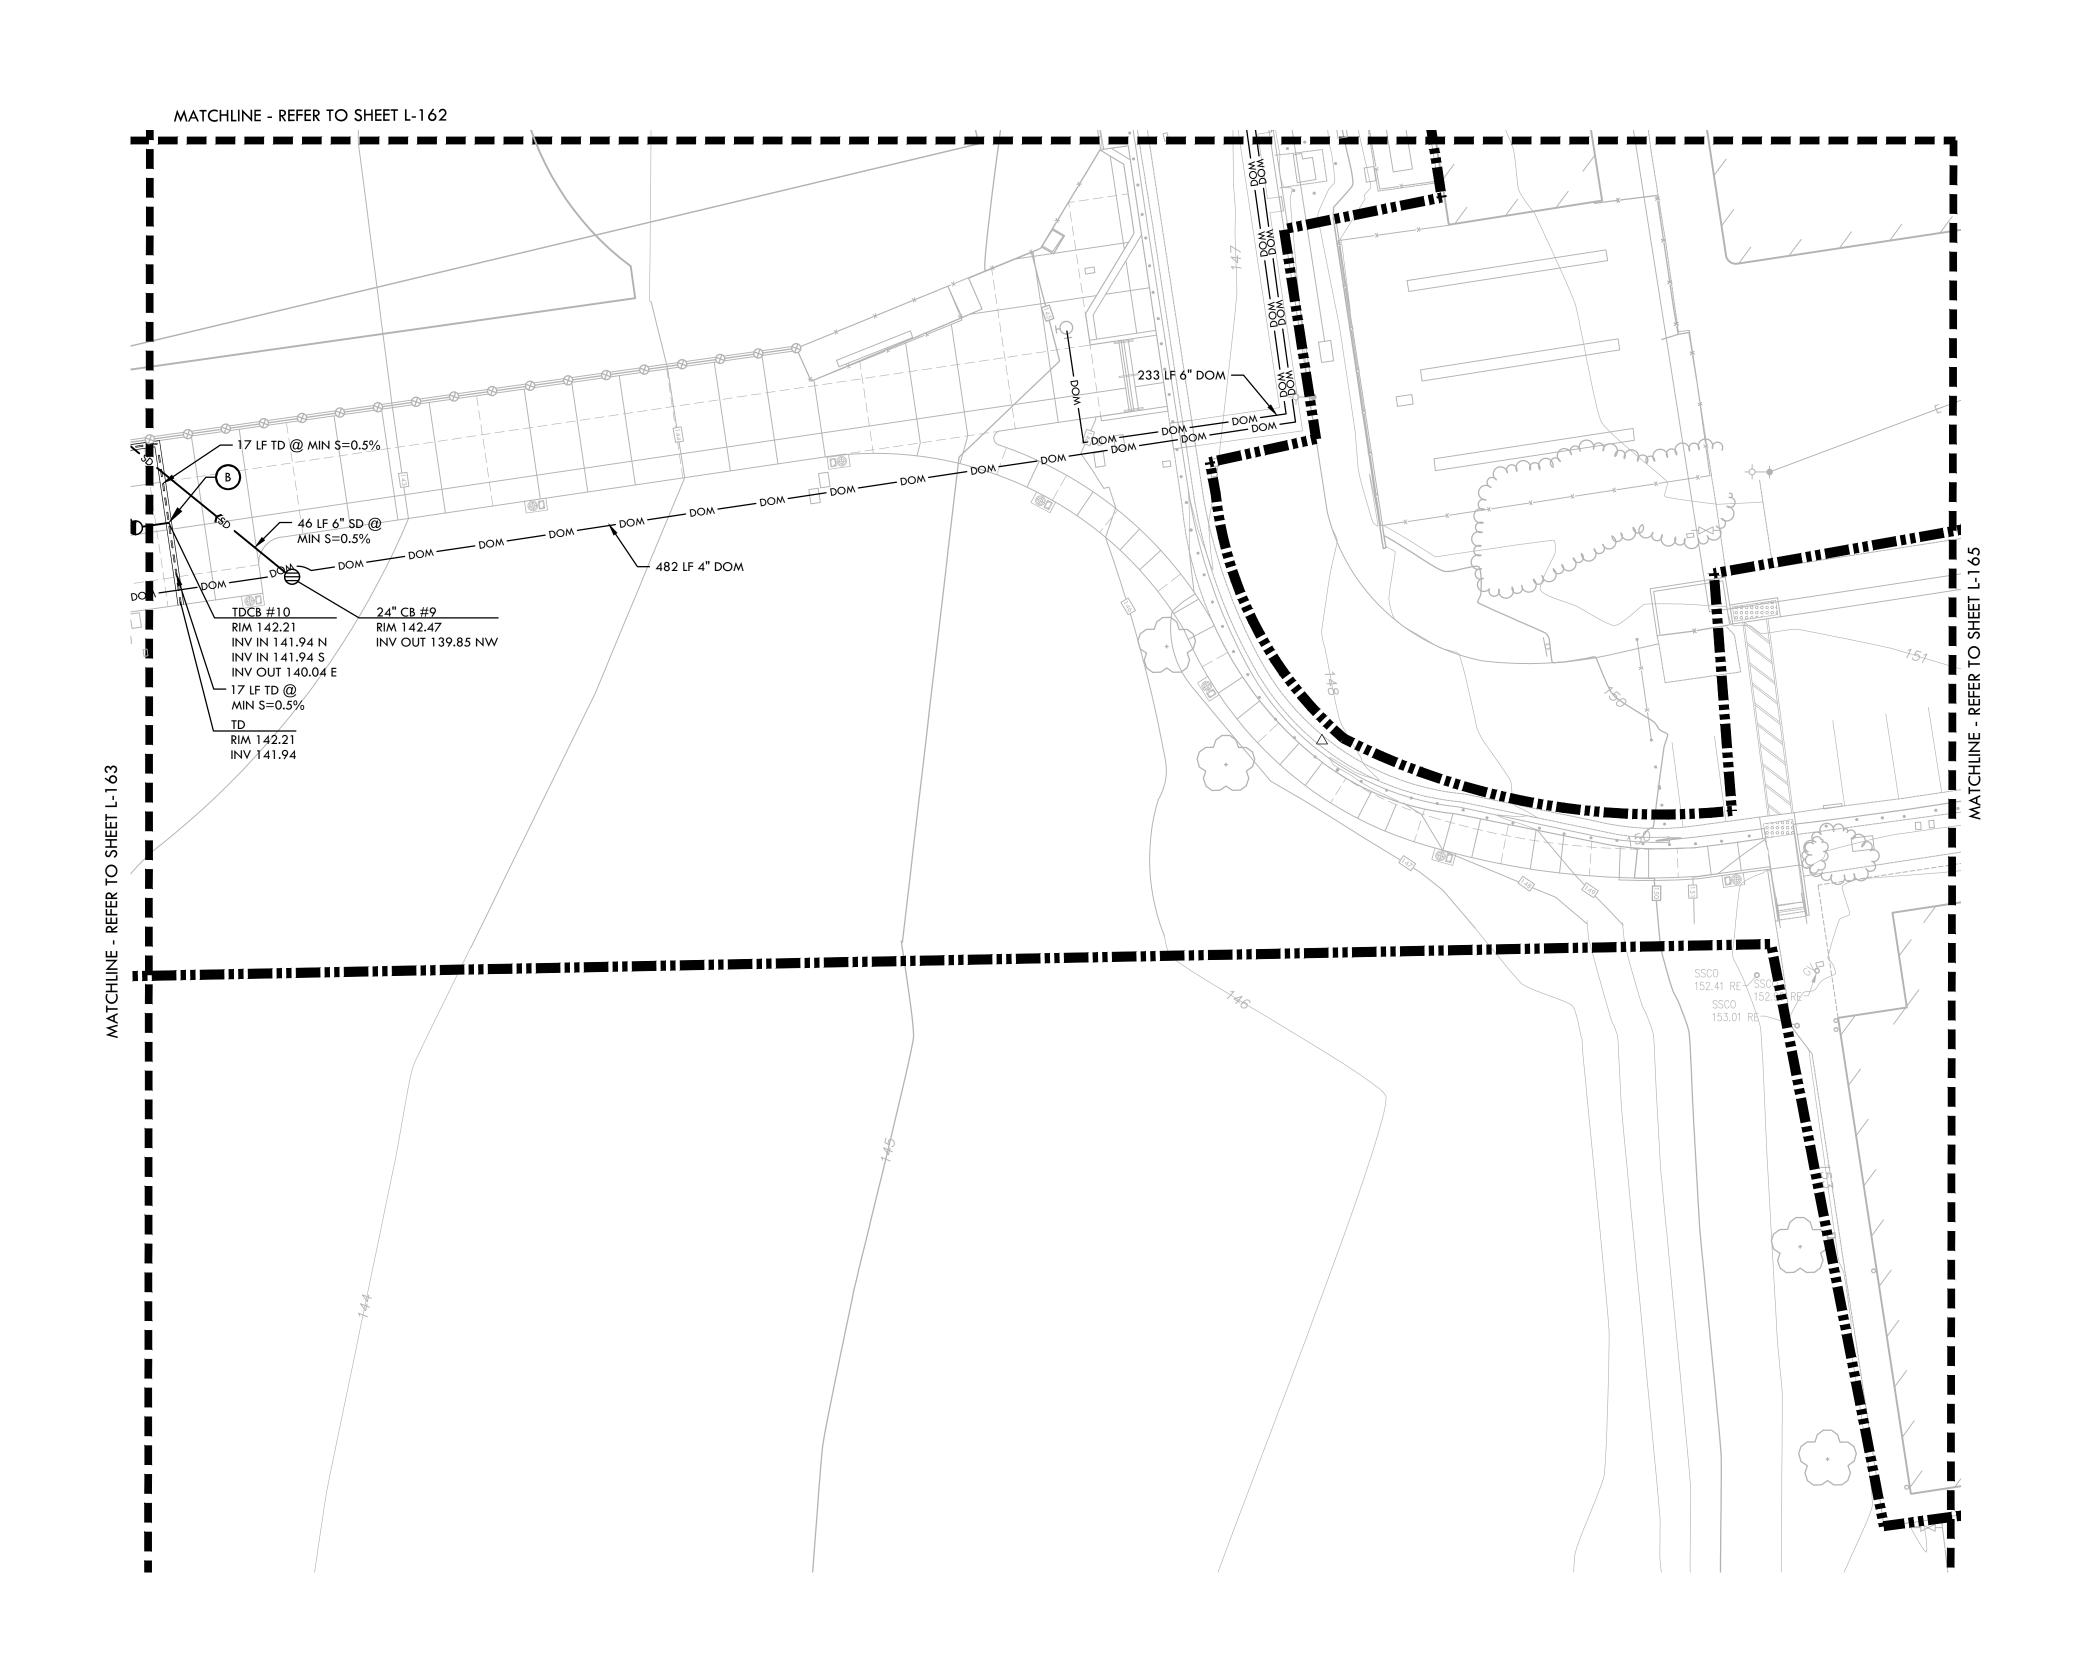

DRAWING NAME: Y:\Projects-F0\2018\1819500 - Mesa Verde HS-San Juan\CAD_L6.0_DRN-C3D.dwg PLOT DATE: 01-13-21 PLOTTED BY: station46

DRAINAGE & UTILITY LEGEND CONNECT FOOTBALL GOAL ACCESS BOX AND SOCCER GOAL SAFETY BOX TO STORM DRAIN LINE SANITARY SEWER CONNECTION TO DRINKING FOUNTAIN SANITARY SEWER CONNECTION TO BUILDING DOMESTIC WATER CONNECTION TO DRINKING FOUNTAIN DOMESTIC WATER CONNECTION TO BUILDING EXISTING INVERT RIM ELEVATION LINEAR FEET ABANDONED PIPE IN CONFLICT SHALL BE REMOVED. REMAINING ABANDONED STORM PIPE SHALL BE SEALED WITH APPROPRIATELY SIZED CONCRETE CAP (3 SACK MIX) 6" OFR OVER FLOW RISER TRENCH DRAIN ELEVATION S=0.5% SLOPE MINIMUM N, S, W EA, NORTH, SOUTH, WEST, EAST

DRAINAGE & UTILITY NOTES THE CONTRACTOR SHALL VERIFY THE LOCATIONS OF ALL EXISTING UTILITIES, STRUCTURES, AND SERVICES BEFORE COMMENCING WORK. THE LOCATIONS OF UTILITIES, STRUCTURES, AND SERVICES SHOWN IN THE CONTRACT DOCUMENTS SHALL BE DEEMED TO BE APPROXIMATIONS ONLY. ALL DISCREPANCIES BETWEEN WHAT IS SHOWN AND THE ACTUAL FIELD CONDITIONS SHALL BE REPORTED TO THE DISTRICT REPRESENTATIVE. THE CONTRACTOR SHALL CONTACT UNDER GROUND SERVICE ALERT (USA) AT (800) 227-2600 PRIOR TO ANY DEMOLITION OR EXCAVATION. UPON COMPLETION OF USA MARKING OPERATIONS, CONTRACTOR SHALL RECORD ALL UTILITY MARKINGS ON A SEPARATE SET OF DRAWINGS. THIS SET SHALL BE KEPT ON-SITE FOR REFERENCE FOR DURATION OF CONTRACT. ALL EXISTING DRAINAGE STRUCTURES, BOXES, UTILITY VAULTS ETC. TO REMAIN, SHALL BE BROUGHT TO FINAL FINISH GRADE PRIOR TO FINAL SURFACE TREATMENT. THE CONTRACTOR IS TO PROTECT DRAINAGE SYSTEM FROM DEBRIS, INCLUDING SOIL, ROCK MATERIAL, AND TRASH FROM ENTERING THE PIPE DURING CONSTRUCTION. CONTRACTOR SHALL AVOID PLACING CONSTRUCTION VEHICLES OVER INSTALLED DRAINAGE TRENCHES TO PREVENT CRUSHING OF PIPE. COORDINATE ALL SLEEVING AND UTILITY LOCATIONS AS SHOWN ON THE PLANS AND DETAILS CONTAINED WITHIN THESE CONTRACT DOCUMENTS. THE CONTRACTOR IS TO ENSURE THAT ALL REMAINING ACTIVE AND NEW DRAINAGE AND UTILITY LINES ARE PROTECTED AND UNDAMAGED FROM TRENCHING AND FOOTING EXCAVATIONS FOR NEW FOOTINGS, PARTICULARLY FOR NEW FENCING AND WALLS. ALL ABANDONED STORM LINES SHALL REMAIN IN PLACE UNLESS IN CONFLICT WITH PROPOSED DRAINAGE, UTILITY, OR SUBGRADING OPERATIONS, IN WHICH CASE

> ENVELOPE OUTSIDE AND INSIDE DIAMETER OF PIPE. PRIOR TO ALL DRAINAGE AND UTILITY WORK, CONTRACTOR SHALL BE RESPONSIBLE FOR VERIFYING ALL POTENTIAL DRAINAGE CONNECTIONS AND EXISTING UTILITY BY POTHOLING. IN ADDITION, ALL DOWNSTREAM CONNECTIONS TO EXISTING STRUCTURES SHALL BE THE START OF THESE OPERATIONS, AND GRADES SHALL BE VERIFIED.

WHEN WORK HAS TO OCCUR UNDER THE DRIPLINE OF EXISTING TREES NOT SCHEDULED FOR REMOVAL, THE CONTRACTOR SHALL USE ALL POSSIBLE CARE TO AVOID INJURY TO THE TREES AND TREE ROOTS. GRADE IN LINES RADIAL TO THE EXISTING TREES RATHER THAN TANGENTIAL. ALL PARTIAL CUTS OR TEARS THROUGH ROOTS TWO INCHES IN DIAMETER AND LARGER SHALL BE CUT CLEAN. TRENCHES ADJACENT TO TREES SHALL BE FILLED WITHIN 24 HOURS AFTER EXCAVATION, BUT WHERE THIS IS NOT POSSIBLE, THE SIDE OF THE TRENCH ADJACENT TO THE TREE, AND ANY EXPOSED ROOTS SHALL BE KEPT SHADED AND MOIST WITH DAMPENED BURLAP OR CANVAS.

THE CITRUS HEIGHTS WATER DISTRICT HAS A 10' WATER EASEMENT THAT RUNS THROUGH THE PROPERTY. THE WATER MAIN LINE THAT IS IN THE EASEMENT IS ABANDONED IN PLACE AND IS LIKELY STEEL PIPE, PARTS MY BE ASBESTOS CEMENT PIPE. THERE SHOULD NOT BE ANY CONFLICTS WITH THE ABANDONED MAIN LINE UNLESS THE STRUCTURES BEING INSTALLED ARE 36 INCHES BELOW FINISHED GRADE. IF THE ABANDONED WATER MAIN IS REACHED AND IT IS ASBESTOS CEMENT PIPE, THE PIPE WILL NEED TO BE REMOVED AND DISCARDED IN A SPECIFIC MANNER IN ADHERENCE TO STANDARD SAFETY PROTOCOLS.

). PULL MANDREL THROUGH EXISTING STORM DRAIN IN PRESENCE OF THE INSPECTOR. CLEAR THE EXISTING LINE BETWEEN JB#1 AND OUTFALL AT STREAM.

DESCRIPTION

LIMIT OF WORK

CATCH BASIN, SIZE PER PLAN (CB)

JUNCTION BOX, SIZE PER PLAN (JB)

CLEANOUT IN BIORETENTION AREA (COIT)

CLEANOUT IN HARDSCAPE (COH)


CLEANOUT IN SOFTSCAPE (COS)

SANITARY SEWER CLEANOUT (SSCO), SIZE PER PLAN

SYM

IDENTIFICATION STAMP DIV. OF THE STATE ARCHITECT APP: 02-118588 INC: REVIEWED FOR SS FLS ACS



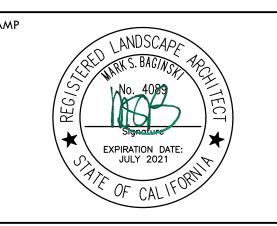

CONSULTANT


www.VerdeDesignInc.com

DRAINAGE & UTILITY LEGEND

DETAIL NUMBER —

SHEET NUMBER —

0	SHOT PUT / DISCUS DRAIN (DI)	L-512			
•	SAND PIT CATCH BASIN (SPCB)	O L-511			
	OVERFLOW RISER WITH GRATE/ STANDPIPE AT BIORETENTION AREA (FLOW-TRHOUGH PLANTER)	H L-513			
0	CONCRETE SWALE CATCH BASIN (CSCB)	G L-513			
4	ENERGY DISSIPATER (ED)	B L-513			
Θ	DOWN SPOUT (DS)	E L-513			
®	SANITARY SEWER MANHOLE (SSMH)	D L-513	SHEET TITLE		
Ā	DOMESTIC WATER GATE VALVE	E,F L-551	DRAINAGE .		
	TRENCH DRAIN INSIDE TRACK - REFER TO DETAIL B SHEET L-512 TRENCH DRAIN OUTSIDE TRACK - REFER TO DETAIL A, SHEET L-512		PLAN - S ENTRY WAY		
	BOTTOM OF BIORETENTION AREA (FLOW-THROUGH PLANTER)	C L-513			
_ SD_X	SOLID WALL STORM DRAIN	L,Q L-511	PROJECT NAME	VEDDE	
PERF	PERFORATED SUBDRAIN	P L-511		VERDE SCHOOL	_
PDY	FRENCH DRAIN	G,H L-512	ATHLETIC IMPROV	FACILITY FACILITY	_
/55/X	SANITARY SEWER	L,Q L-511		, _, , , , , , , , , , , , , , , , , ,	
	INFILTRATION DRAIN (BIORETENTION AREA)	A L-513	PROJECT ADDRESS		
DOM	DOMESTIC WATER	L,Q L-511	7501 CARF CITRUS HE		
RD	ROCK DRAIN AT SHOT PUT CURB - REFER TO SPECIFICATIONS	N L-511		621	
A	DOWN SPOUT CONNECTION	E L-513	SUBMITTAL 50% SUBMITTAL		DATE 08/13/20
В	INLNE TRENCH DRAIN CATCH BASIN (TDCB) AND CONNECTION TO STORM DRAIN LINE	C L-512	DSA SUBMITTAL		10/15/20
©	D-ZONE UTILITY BOX LAYOUT	E L-512	DSA BACKCHECK SUBMITT	AL	01/20/20
D	CONNECT NEW CATCH BASIN TO EXISTING DRAIN LINE, CONFIRM IN F	FIELD			
_	STORM DRAIN POINT OF CONNECTION CONTRACTOR TO VERIFY LOC	ATION	NO. REVISIONS		DATE
E	AND INVERT ELEVATION PRIOR TO INITIATING DRAINAGE AND UTILITY IMPROVEMENTS. ANY DISCREPANCY TO BE PROVIDED TO DISTRICT IN WRITING.		\triangle		27.112
F	CONNECT TAKE OFF BOARD DRAIN TO STORM DRAIN LINE		\triangle		
<u>©</u>	CONNECT EVENT DRAIN TO STORM DRAIN LINE				
H	CONNECT COMBOX STORM DRAIN LINE TO SUBSURFACE STORAGE TR	ENCH			
	NIODTII		DRAWN BY QH DATE ISSUED 01/20/2021 PROJ. NO.	SCALE	/MB 20'-0"
	NORTH 0' 10' 20' 40' 60'		181	9500	

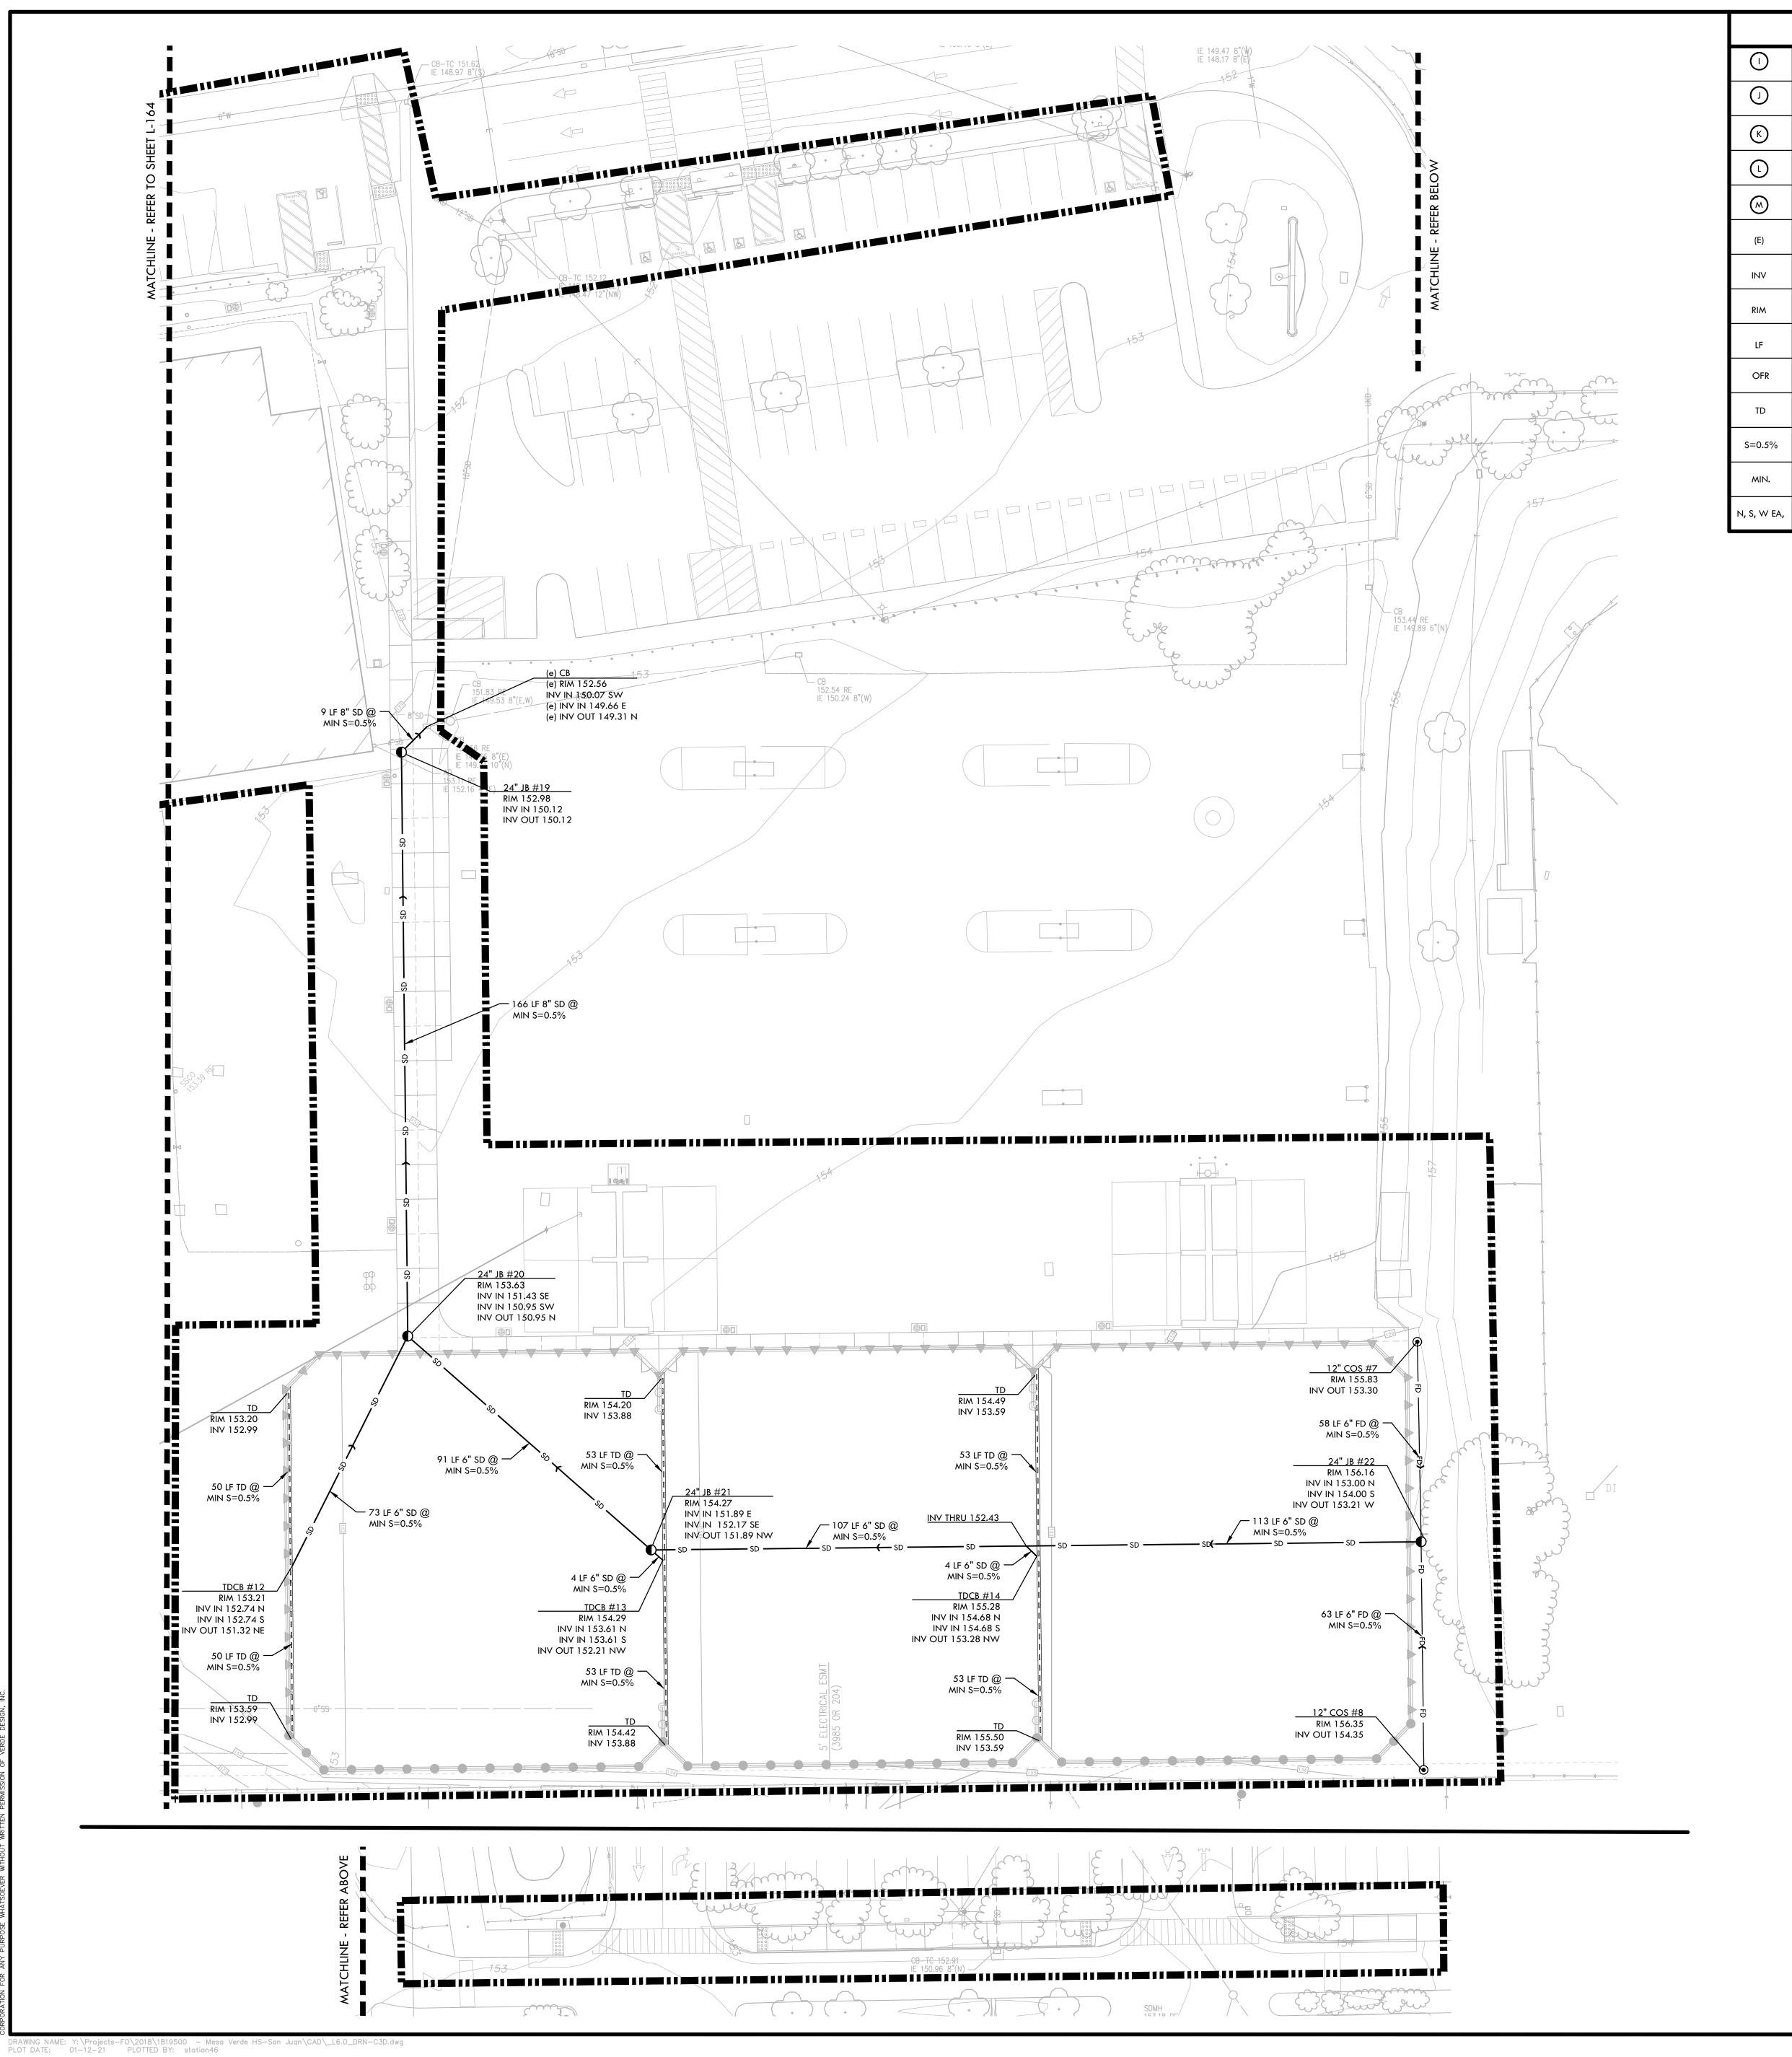

DRAINAGE & UTILITY LEGEND CONNECT FOOTBALL GOAL ACCESS BOX AND SOCCER GOAL SAFETY BOX TO STORM DRAIN LINE SANITARY SEWER CONNECTION TO DRINKING FOUNTAIN SANITARY SEWER CONNECTION TO BUILDING DOMESTIC WATER CONNECTION TO DRINKING FOUNTAIN DOMESTIC WATER CONNECTION TO BUILDING EXISTING INVERT RIM ELEVATION EXCAVATIONS FOR NEW FOOTINGS, PARTICULARLY FOR NEW FENCING AND WALLS. LINEAR FEET OVER FLOW RISER TRENCH DRAIN ELEVATION SLOPE MINIMUM NORTH, SOUTH, WEST, EAST

THE CONTRACTOR SHALL VERIFY THE LOCATIONS OF ALL EXISTING UTILITIES, STRUCTURES, AND SERVICES BEFORE COMMENCING WORK. THE LOCATIONS OF UTILITIES, STRUCTURES, AND SERVICES SHOWN IN THE CONTRACT DOCUMENTS SHALL BE DEEMED TO BE APPROXIMATIONS ONLY. ALL DISCREPANCIES BETWEEN WHAT IS SHOWN AND THE ACTUAL FIELD CONDITIONS SHALL BE REPORTED TO THE DISTRICT REPRESENTATIVE. THE CONTRACTOR SHALL CONTACT UNDER GROUND SERVICE ALERT (USA) AT (800) 227-2600 PRIOR TO ANY DEMOLITION OR EXCAVATION. UPON COMPLETION OF USA MARKING OPERATIONS, CONTRACTOR SHALL RECORD ALL UTILITY MARKINGS ON A SEPARATE SET OF DRAWINGS. THIS SET SHALL BE KEPT ON-SITE FOR REFERENCE FOR DURATION OF CONTRACT.

ALL EXISTING DRAINAGE STRUCTURES, BOXES, UTILITY VAULTS ETC. TO REMAIN, SHALL BE BROUGHT TO FINAL FINISH GRADE PRIOR TO FINAL SURFACE TREATMENT.

DRAINAGE & UTILITY NOTES

THE CONTRACTOR IS TO PROTECT DRAINAGE SYSTEM FROM DEBRIS, INCLUDING SOIL, ROCK MATERIAL, AND TRASH FROM ENTERING THE PIPE DURING CONSTRUCTION. CONTRACTOR SHALL AVOID PLACING CONSTRUCTION VEHICLES OVER INSTALLED DRAINAGE TRENCHES TO PREVENT CRUSHING OF PIPE.

COORDINATE ALL SLEEVING AND UTILITY LOCATIONS AS SHOWN ON THE PLANS AND DETAILS CONTAINED WITHIN THESE CONTRACT DOCUMENTS.

THE CONTRACTOR IS TO ENSURE THAT ALL REMAINING ACTIVE AND NEW DRAINAGE AND UTILITY LINES ARE PROTECTED AND UNDAMAGED FROM TRENCHING AND FOOTING

ALL ABANDONED STORM LINES SHALL REMAIN IN PLACE UNLESS IN CONFLICT WITH PROPOSED DRAINAGE, UTILITY, OR SUBGRADING OPERATIONS, IN WHICH CASE ABANDONED PIPE IN CONFLICT SHALL BE REMOVED. REMAINING ABANDONED STORM PIPE SHALL BE SEALED WITH APPROPRIATELY SIZED CONCRETE CAP (3 SACK MIX) 6" ENVELOPE OUTSIDE AND INSIDE DIAMETER OF PIPE.

PRIOR TO ALL DRAINAGE AND UTILITY WORK, CONTRACTOR SHALL BE RESPONSIBLE FOR VERIFYING ALL POTENTIAL DRAINAGE CONNECTIONS AND EXISTING UTILITY BY POTHOLING. IN ADDITION, ALL DOWNSTREAM CONNECTIONS TO EXISTING STRUCTURES SHALL BE THE START OF THESE OPERATIONS, AND GRADES SHALL BE VERIFIED.

WHEN WORK HAS TO OCCUR UNDER THE DRIPLINE OF EXISTING TREES NOT SCHEDULED FOR REMOVAL, THE CONTRACTOR SHALL USE ALL POSSIBLE CARE TO AVOID INJURY TO THE TREES AND TREE ROOTS. GRADE IN LINES RADIAL TO THE EXISTING TREES RATHER THAN TANGENTIAL. ALL PARTIAL CUTS OR TEARS THROUGH ROOTS TWO INCHES IN DIAMETER AND LARGER SHALL BE CUT CLEAN. TRENCHES ADJACENT TO TREES SHALL BE FILLED WITHIN 24 HOURS AFTER EXCAVATION, BUT WHERE THIS IS NOT POSSIBLE, THE SIDE OF THE TRENCH ADJACENT TO THE TREE, AND ANY EXPOSED ROOTS SHALL BE KEPT SHADED AND MOIST WITH DAMPENED BURLAP OR CANVAS.

THE CITRUS HEIGHTS WATER DISTRICT HAS A 10' WATER EASEMENT THAT RUNS THROUGH THE PROPERTY. THE WATER MAIN LINE THAT IS IN THE EASEMENT IS ABANDONED IN PLACE AND IS LIKELY STEEL PIPE, PARTS MY BE ASBESTOS CEMENT PIPE. THERE SHOULD NOT BE ANY CONFLICTS WITH THE ABANDONED MAIN LINE UNLESS THE STRUCTURES BEING INSTALLED ARE 36 INCHES BELOW FINISHED GRADE. IF THE ABANDONED WATER MAIN IS REACHED AND IT IS ASBESTOS CEMENT PIPE, THE PIPE WILL NEED TO BE REMOVED AND DISCARDED IN A SPECIFIC MANNER IN ADHERENCE TO STANDARD SAFETY PROTOCOLS.

DRAINAGE & UTILITY LEGEND

DETAIL NUMBER —

SHEET NUMBER —

). PULL MANDREL THROUGH EXISTING STORM DRAIN IN PRESENCE OF THE INSPECTOR. CLEAR THE EXISTING LINE BETWEEN JB#1 AND OUTFALL AT STREAM.

SYM

DESCRIPTION

LIMIT OF WORK

CATCH BASIN, SIZE PER PLAN (CB)

JUNCTION BOX, SIZE PER PLAN (JB)

CLEANOUT IN BIORETENTION AREA (COIT)

CLEANOUT IN HARDSCAPE (COH)

CLEANOUT IN SOFTSCAPE (COS)

SHOT PUT / DISCUS DRAIN (DI)

SAND PIT CATCH BASIN (SPCB)

(FLOW-TRHOUGH PLANTER)

ENERGY DISSIPATER (ED)

DOWN SPOUT (DS)

CONCRETE SWALE CATCH BASIN (CSCB)

SANITARY SEWER MANHOLE (SSMH)

TRENCH DRAIN INSIDE TRACK - REFER TO DETAIL B SHEET L-512

INFILTRATION DRAIN (BIORETENTION AREA)

ROCK DRAIN AT SHOT PUT CURB - REFER TO SPECIFICATIONS

TRENCH DRAIN OUTSIDE TRACK - REFER TO DETAIL A, SHEET L-512

BOTTOM OF BIORETENTION AREA (FLOW-THROUGH PLANTER)

DOMESTIC WATER GATE VALVE

SOLID WALL STORM DRAIN

PERFORATED SUBDRAIN

FRENCH DRAIN

SANITARY SEWER

DOMESTIC WATER

SANITARY SEWER CLEANOUT (SSCO), SIZE PER PLAN


OVERFLOW RISER WITH GRATE/ STANDPIPE AT BIORETENTION AREA

IDENTIFICATION STAMP DIV. OF THE STATE ARCHITEC APP: 02-118588 INC: REVIEWED FOR SS 🗹 FLS 🗹 ACS 🗹



fax: 916.415.6525

www.VerdeDesignInc.com

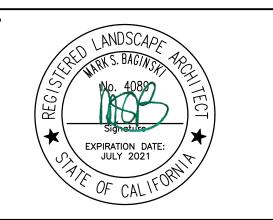

CONSULTANT


DRAINAGE AND UTILITIES **PLAN - TENNIS**


PROJECT NAME MESA VERDE HIGH SCHOOL ATHLETIC FACILITY **IMPROVEMENTS**


PROJECT ADDRESS 7501 CARRIAGE DRIVE CITRUS HEIGHTS, CA


95621


			20pW	MITAL	DATE
	DOWN SPOUT CONNECTION	L-513	50%	SUBMITTAL	08/13/20
	INLNE TRENCH DRAIN CATCH BASIN (TDCB) AND CONNECTION TO STORM DRAIN LINE	C L-512	DSA S	SUBMITTAL	10/15/20
	D-ZONE UTILITY BOX LAYOUT	E L-512	DSA E	BACKCHECK SUBMITTAL	01/20/2
	CONNECT NEW CATCH BASIN TO EXISTING DRAIN LINE, CONFIRM IN F	IELD			
	STORM DRAIN POINT OF CONNECTION CONTRACTOR TO VERIFY LOCA	ATION	NO.	REVISIONS	DATE
	AND INVERT ELEVATION PRIOR TO INITIATING DRAINAGE AND UTILITY IMPROVEMENTS. ANY DISCREPANCY TO BE PROVIDED TO DISTRICT IN WRITING.				
	CONNECT TAKE OFF BOARD DRAIN TO STORM DRAIN LINE		\triangle		
	CONNECT EVENT DRAIN TO STORM DRAIN LINE		\bigwedge		
	CONNECT COMBOX STORM DRAIN LINE TO SUBSURFACE STORAGE TRE	ENCH			
			\wedge		

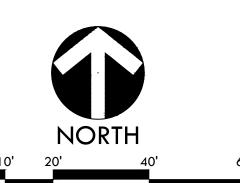

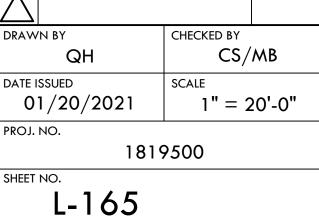

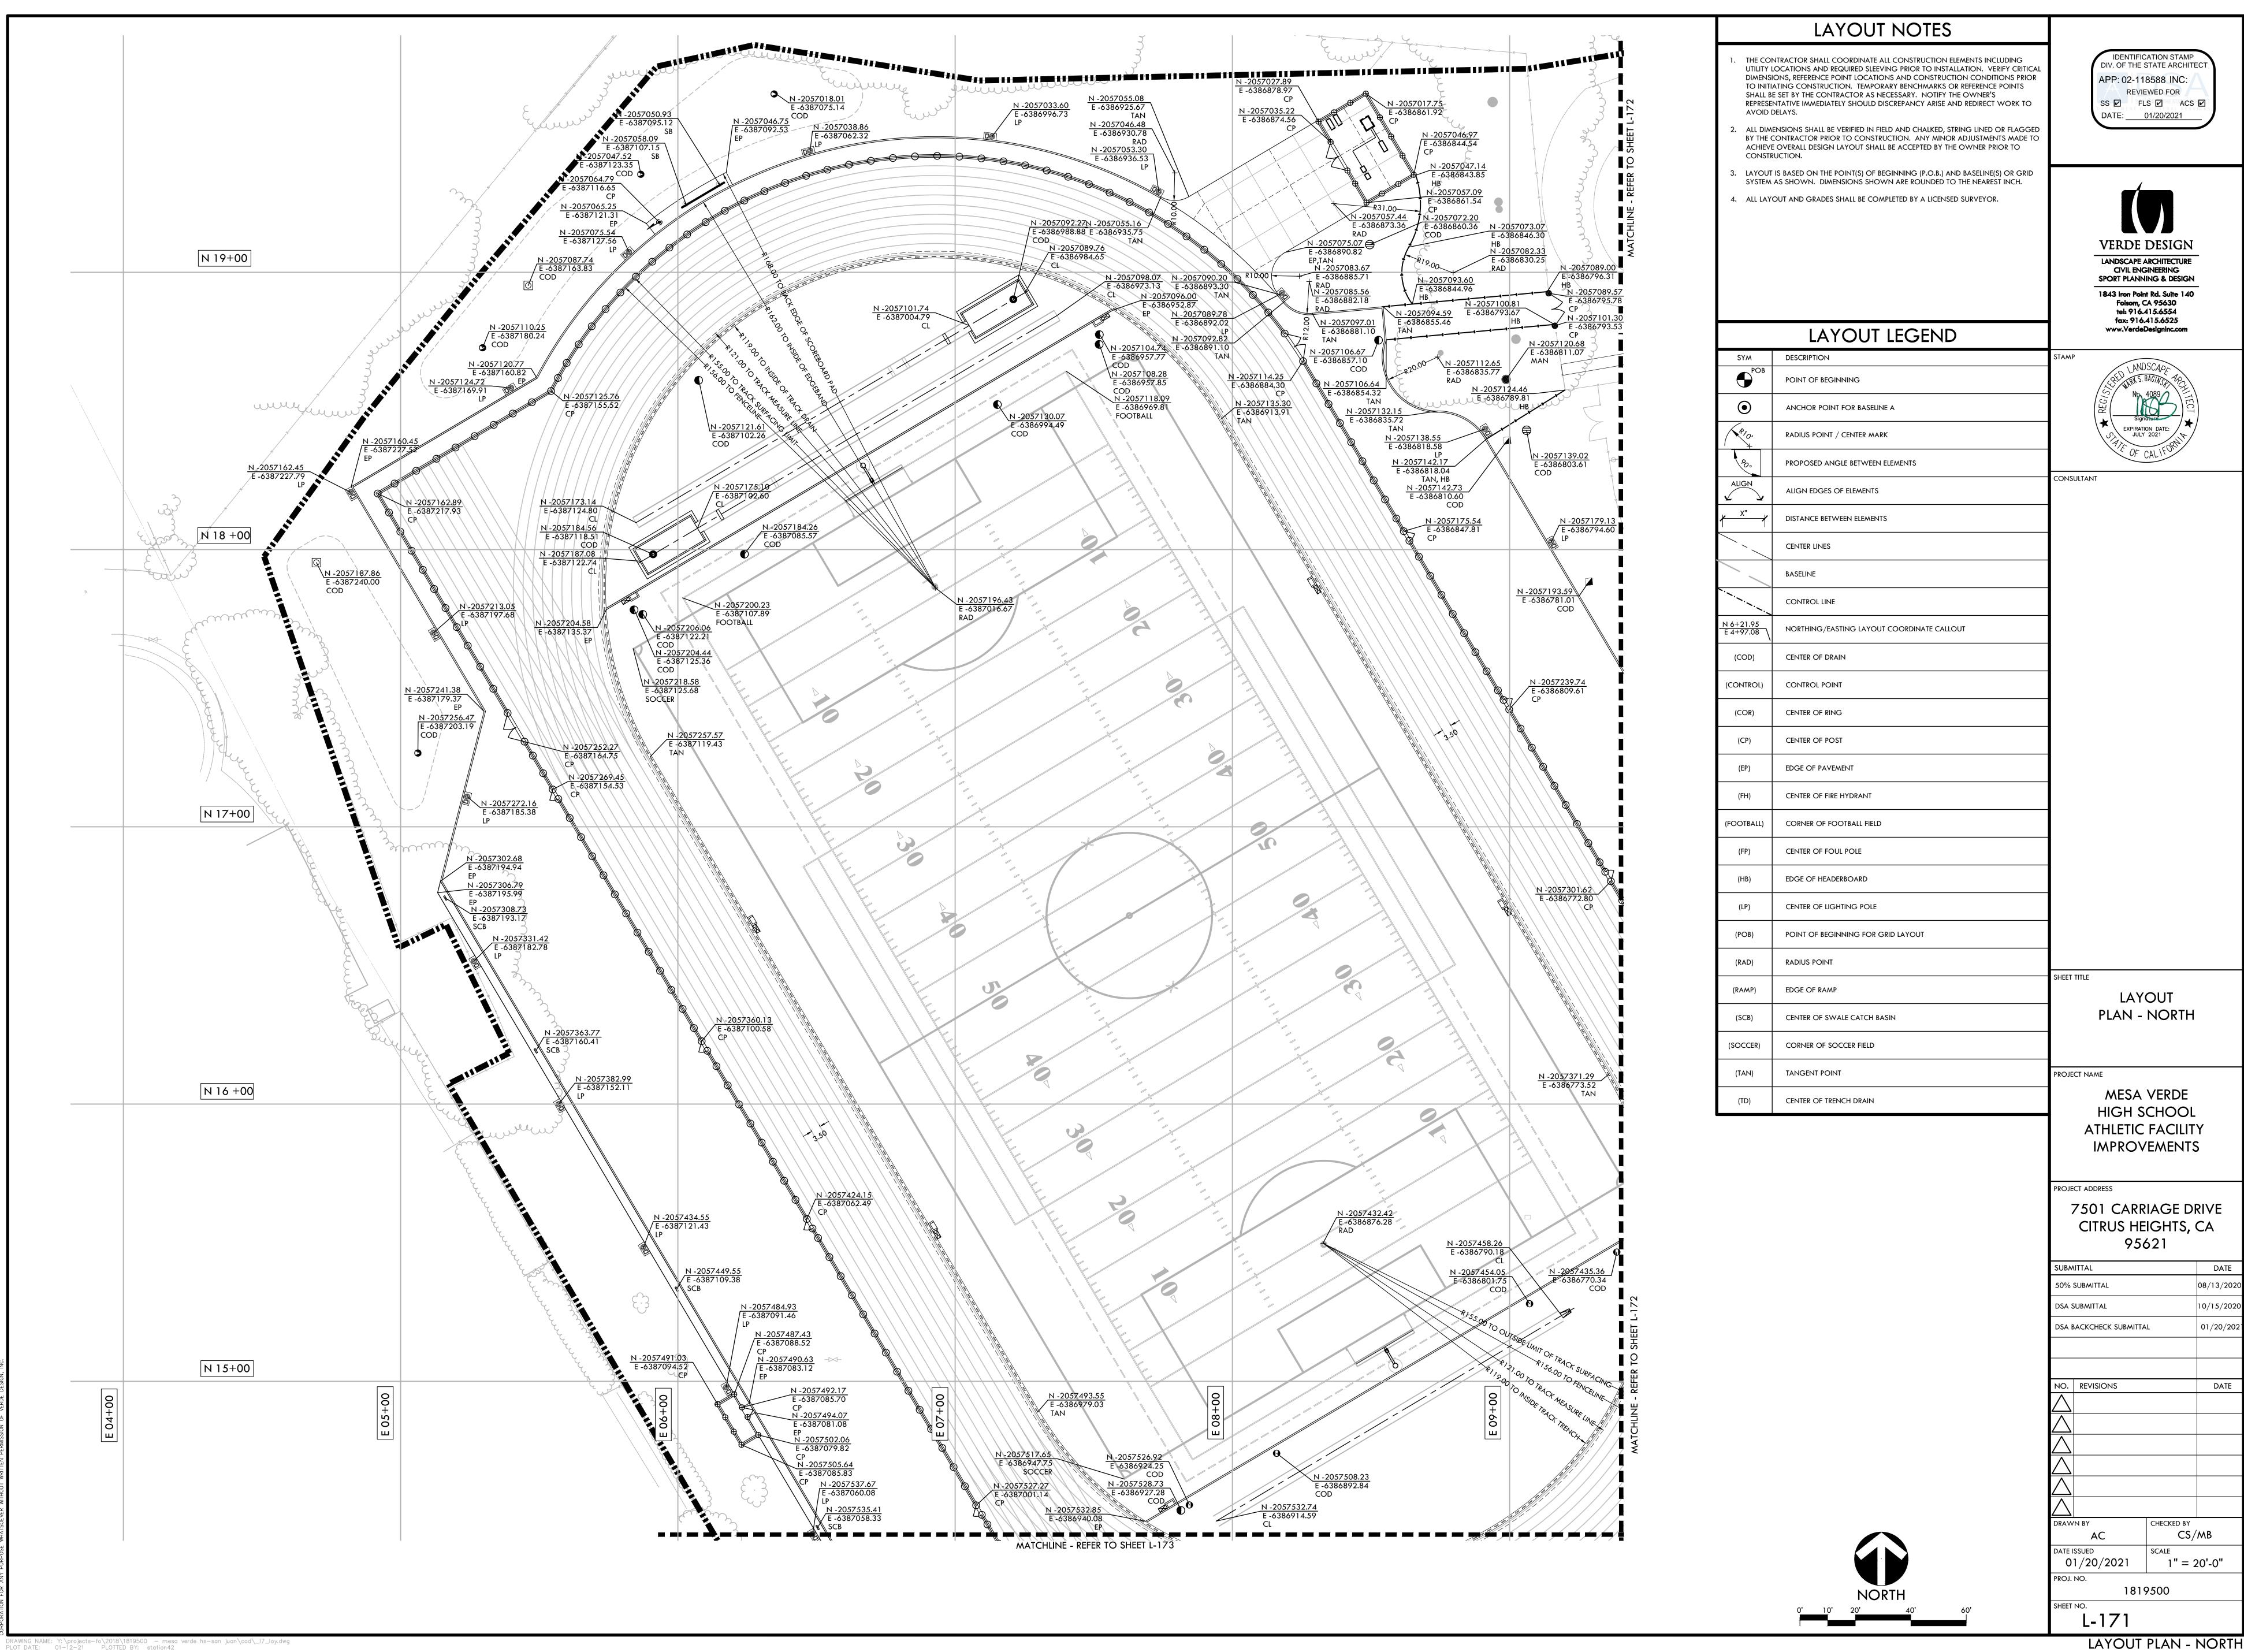


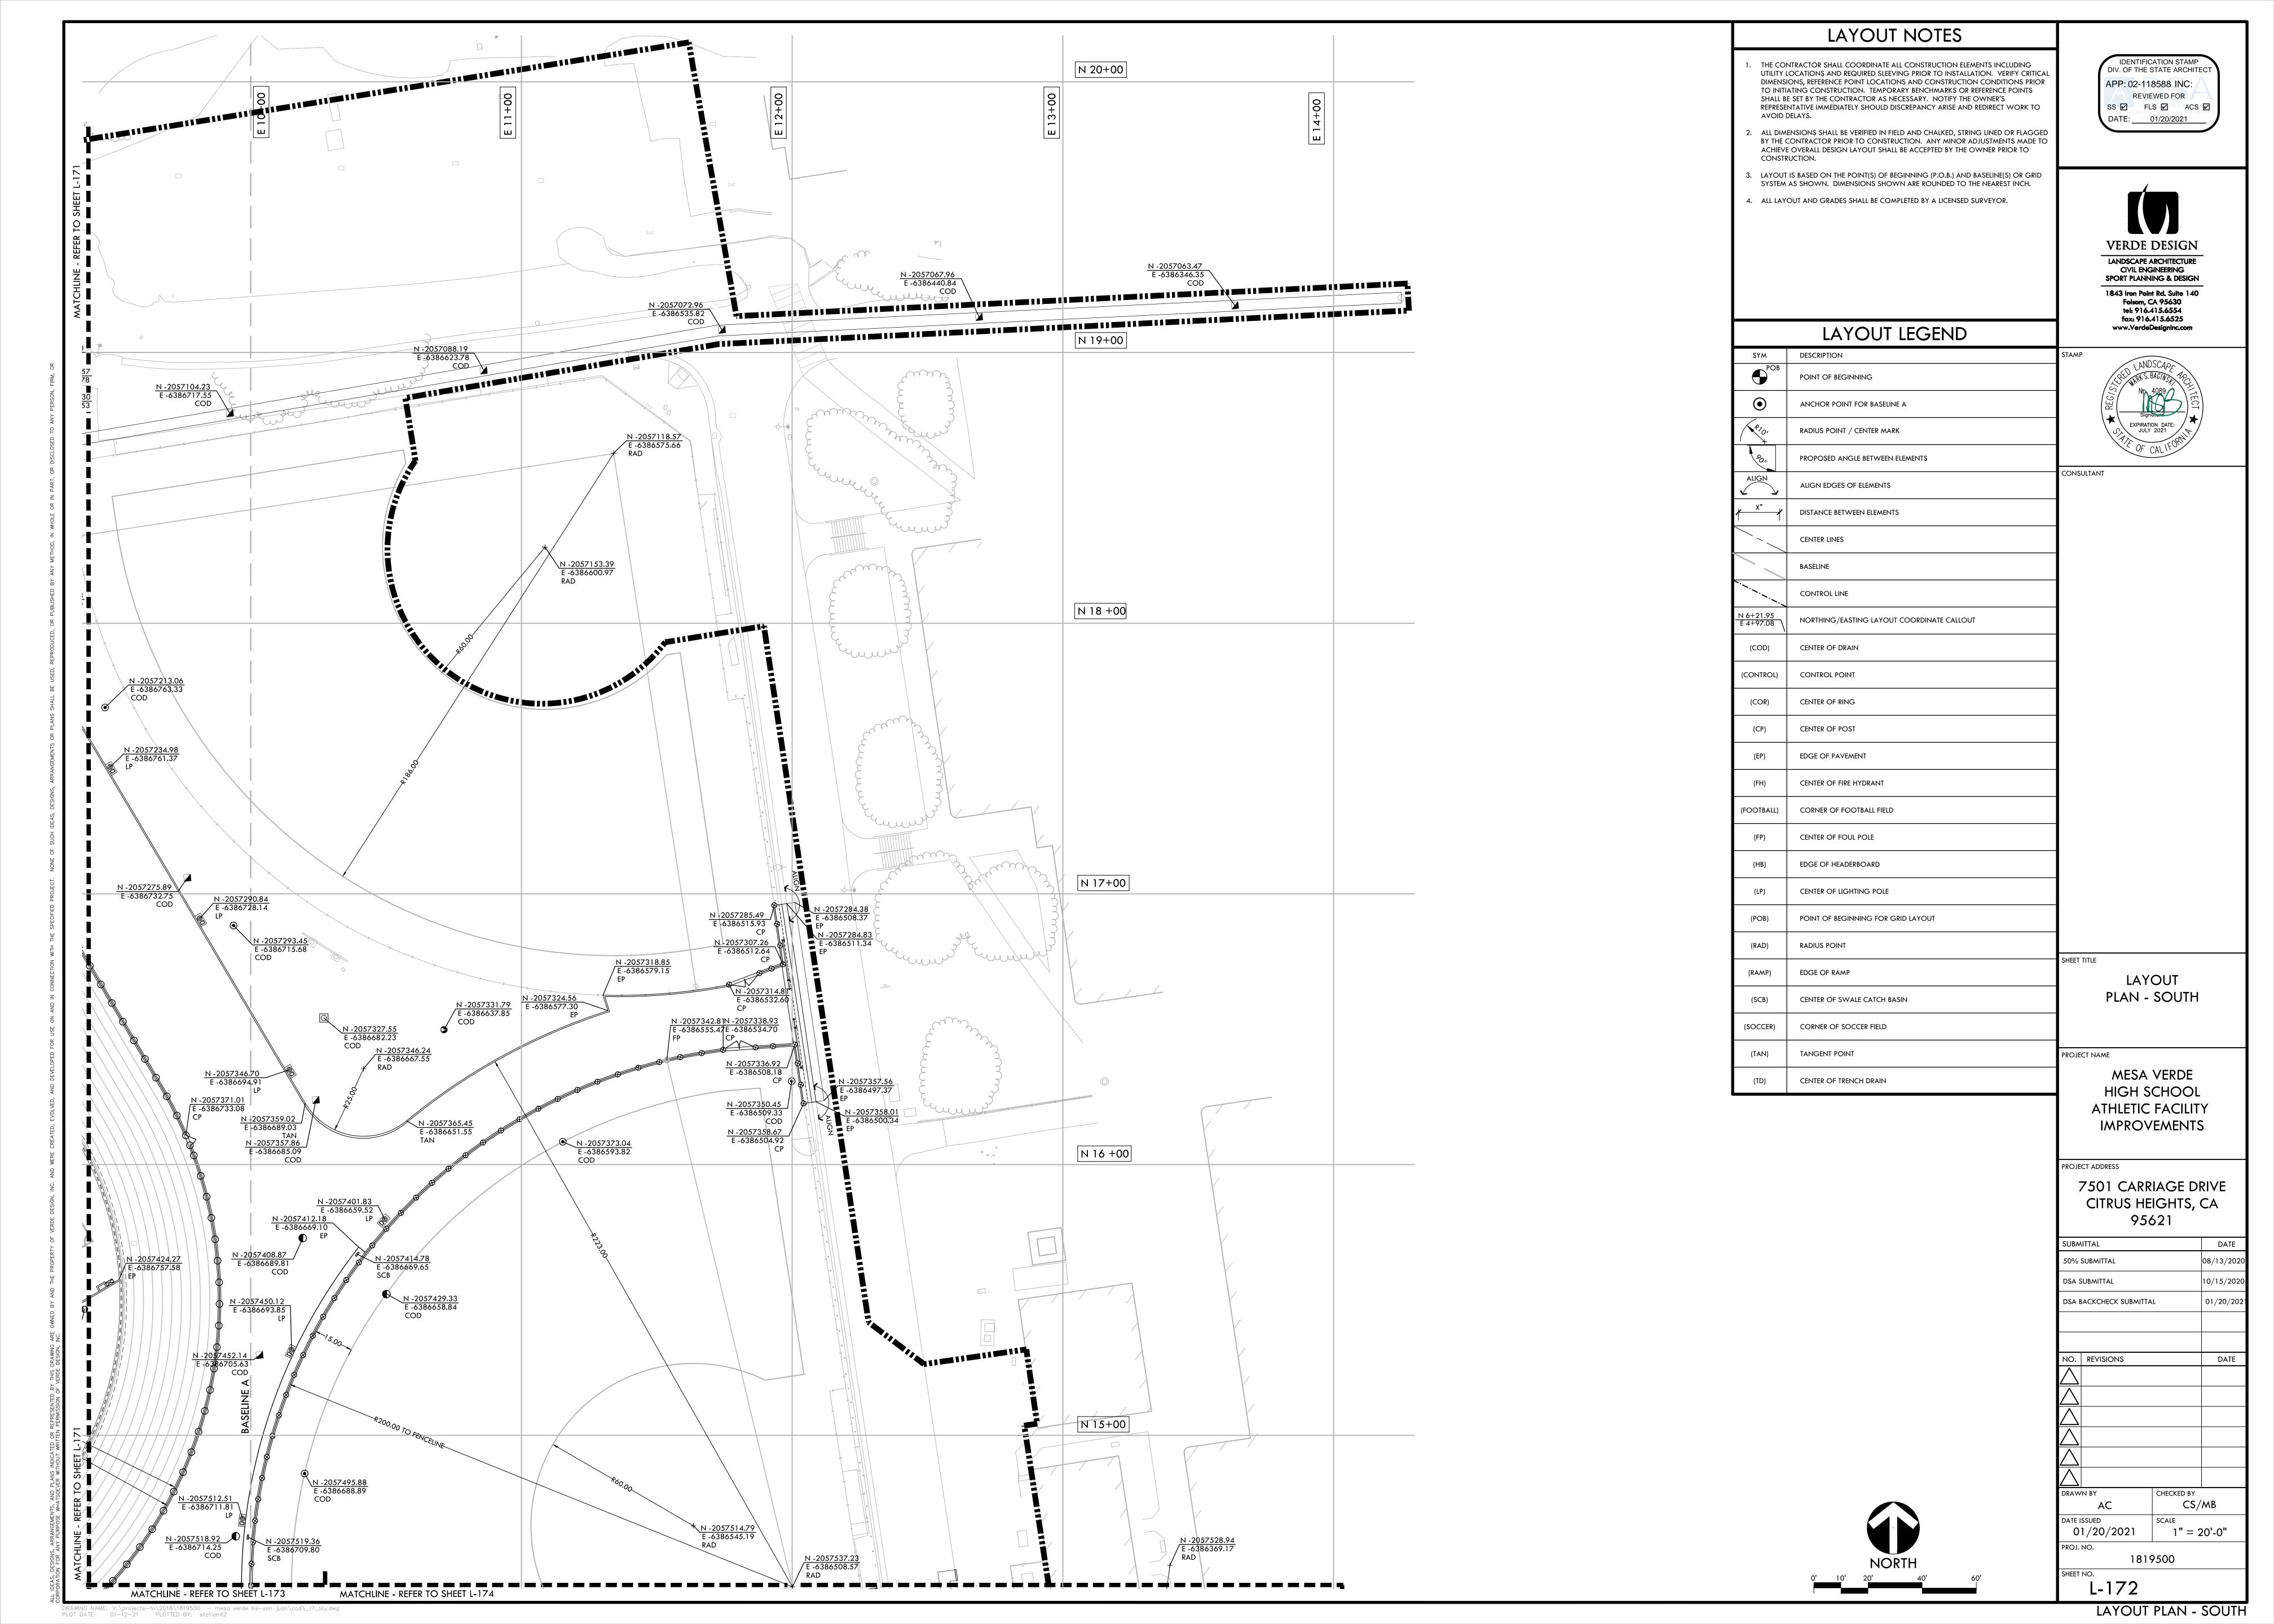

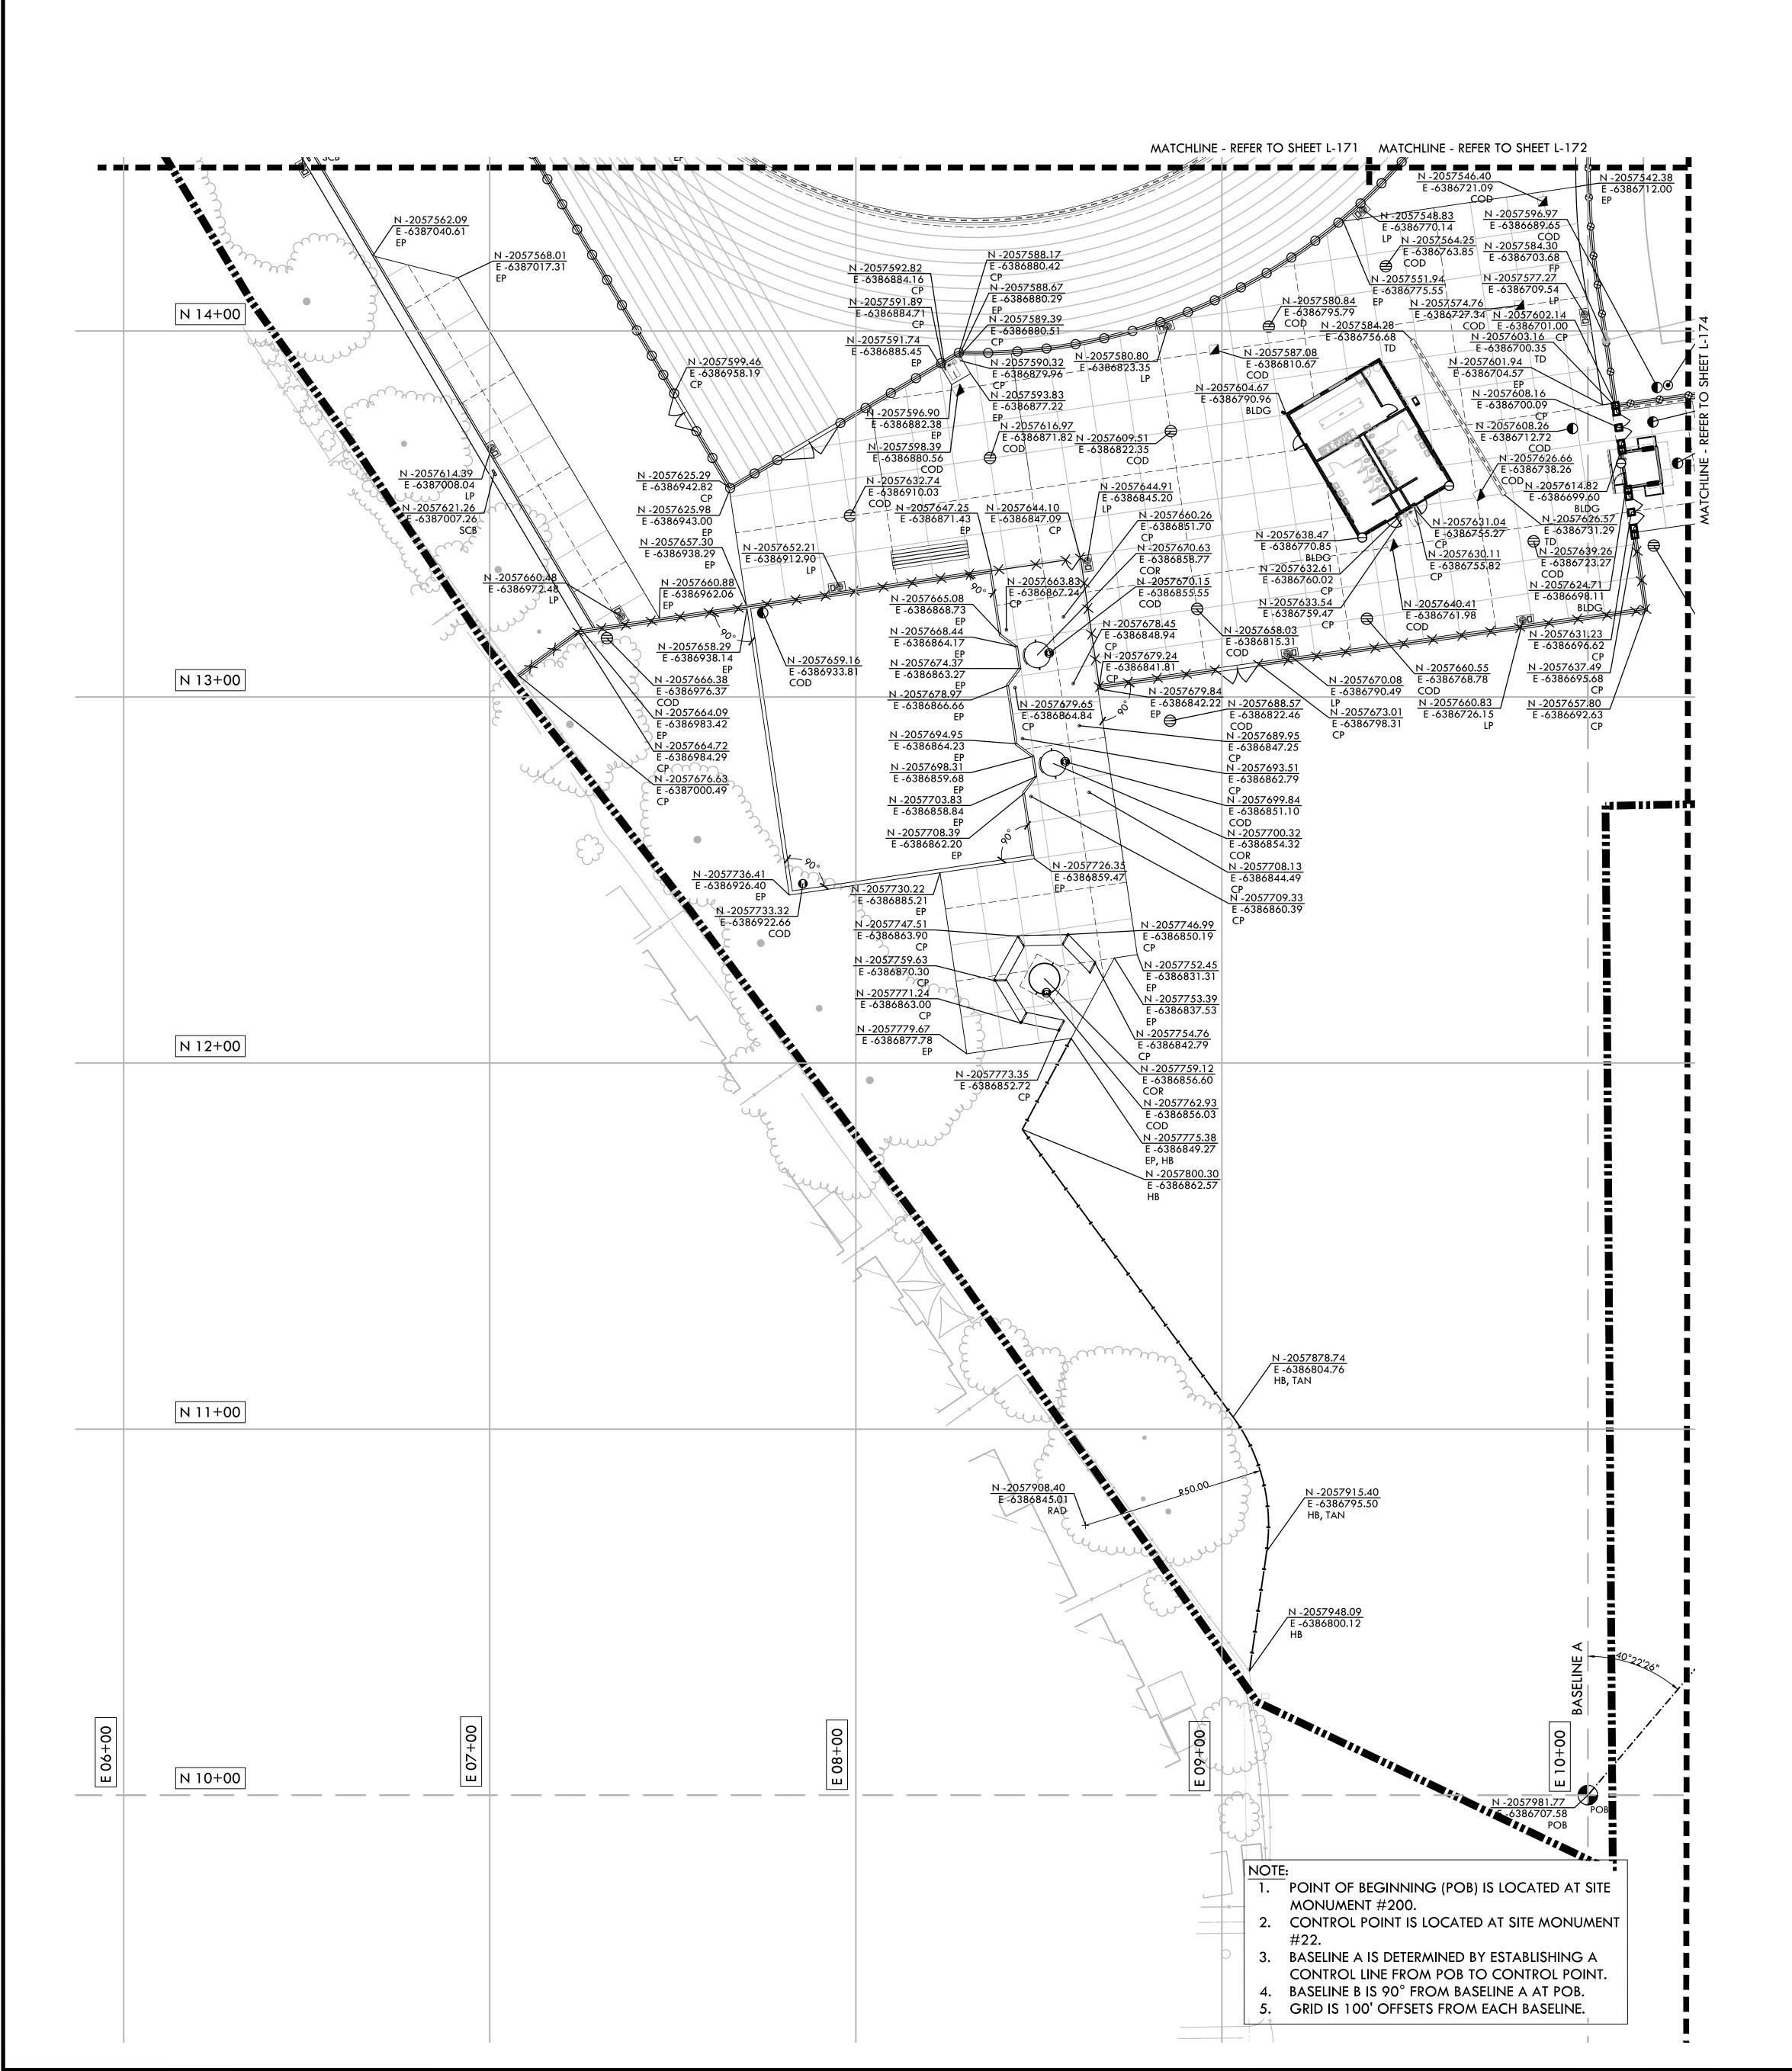

LAYOUT NOTES

- THE CONTRACTOR SHALL COORDINATE ALL CONSTRUCTION ELEMENTS INCLUDING UTILITY LOCATIONS AND REQUIRED SLEEVING PRIOR TO INSTALLATION. VERIFY CRITICAL DIMENSIONS, REFERENCE POINT LOCATIONS AND CONSTRUCTION CONDITIONS PRIOR TO INITIATING CONSTRUCTION. TEMPORARY BENCHMARKS OR REFERENCE POINTS SHALL BE SET BY THE CONTRACTOR AS NECESSARY. NOTIFY THE OWNER'S REPRESENTATIVE IMMEDIATELY SHOULD DISCREPANCY ARISE AND REDIRECT WORK TO
- ALL DIMENSIONS SHALL BE VERIFIED IN FIELD AND CHALKED, STRING LINED OR FLAGGED BY THE CONTRACTOR PRIOR TO CONSTRUCTION. ANY MINOR ADJUSTMENTS MADE TO ACHIEVE OVERALL DESIGN LAYOUT SHALL BE ACCEPTED BY THE OWNER PRIOR TO CONSTRUCTION.
- LAYOUT IS BASED ON THE POINT(S) OF BEGINNING (P.O.B.) AND BASELINE(S) OR GRID SYSTEM AS SHOWN. DIMENSIONS SHOWN ARE ROUNDED TO THE NEAREST INCH.
- 4. ALL LAYOUT AND GRADES SHALL BE COMPLETED BY A LICENSED SURVEYOR.

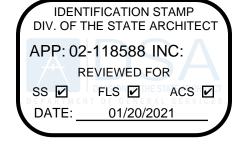



tel: 916.415.6554 fax: 916.415.6525

www.VerdeDesignInc.com

LAYOUT LEGEND

DESCRIPTION

SYM

ОВ	POINT OF BEGINNING	
	ANCHOR POINT FOR BASELINE A	REGISTE
	RADIUS POINT / CENTER MARK	S.
	PROPOSED ANGLE BETWEEN ELEMENTS	
7	ALIGN EDGES OF ELEMENTS	CONSULTANT

\%.	PROPOSED ANGLE BETWEEN ELEMENTS	
ALIGN	ALIGN EDGES OF ELEMENTS	cc
<u> </u>	DISTANCE BETWEEN ELEMENTS	
, ,	CENTER LINES	
	BASELINE	
	CONTROL LINE	
N 6+21.95 E 4+97.08	NORTHING/EASTING LAYOUT COORDINATE CALLOUT	
(COD)	CENTER OF DRAIN	
(CONTROL)	CONTROL POINT	
(COR)	CENTER OF RING	
(CP)	CENTER OF POST	
(EP)	EDGE OF PAVEMENT	
(FH)	CENTER OF FIRE HYDRANT	
(FOOTBALL)	CORNER OF FOOTBALL FIELD	
(FP)	CENTER OF FOUL POLE	
(HB)	EDGE OF HEADERBOARD	
(LP)	CENTER OF LIGHTING POLE	
(POB)	POINT OF BEGINNING FOR GRID LAYOUT	
(RAD)	RADIUS POINT	
(RAMP)	EDGE OF RAMP	SH
(SCB)	CENTER OF SWALE CATCH BASIN	
(SOCCER)	CORNER OF SOCCER FIELD	
(TAN)	TANGENT POINT	PR

CENTER OF TRENCH DRAIN

HEET TITLE LAYOUT PLAN - THROWS AREA


ROJECT NAME


MESA VERDE HIGH SCHOOL ATHLETIC FACILITY **IMPROVEMENTS**

PROJECT ADDRESS

7501 CARRIAGE DRIVE CITRUS HEIGHTS, CA 95621


DUBMITTAL			DATE	
50% SUBMITTAL			08/13/2020	
OSA S	SUBMITTAL		10/15/2020	
DSA B	SACKCHECK SUBMITTA	.L	01/20/2021	
۷٥.	REVISIONS		DATE	
$\overline{\triangle}$				
$\overline{\triangle}$				
$\overline{\triangle}$				
$\overline{\bigwedge}$				
$\overline{\bigwedge}$				
$\overline{\sum}$				
RAW	'N BY	CHECKED BY		
AC		CS/	MB	
PATE ISSUED		SCALE		
01/20/2021		1" = 2	20'-0"	
ROJ. NO.				
1819500				
HEET NO.				
	L-173			

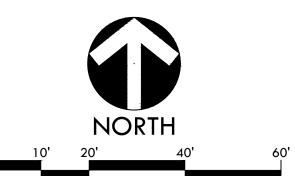

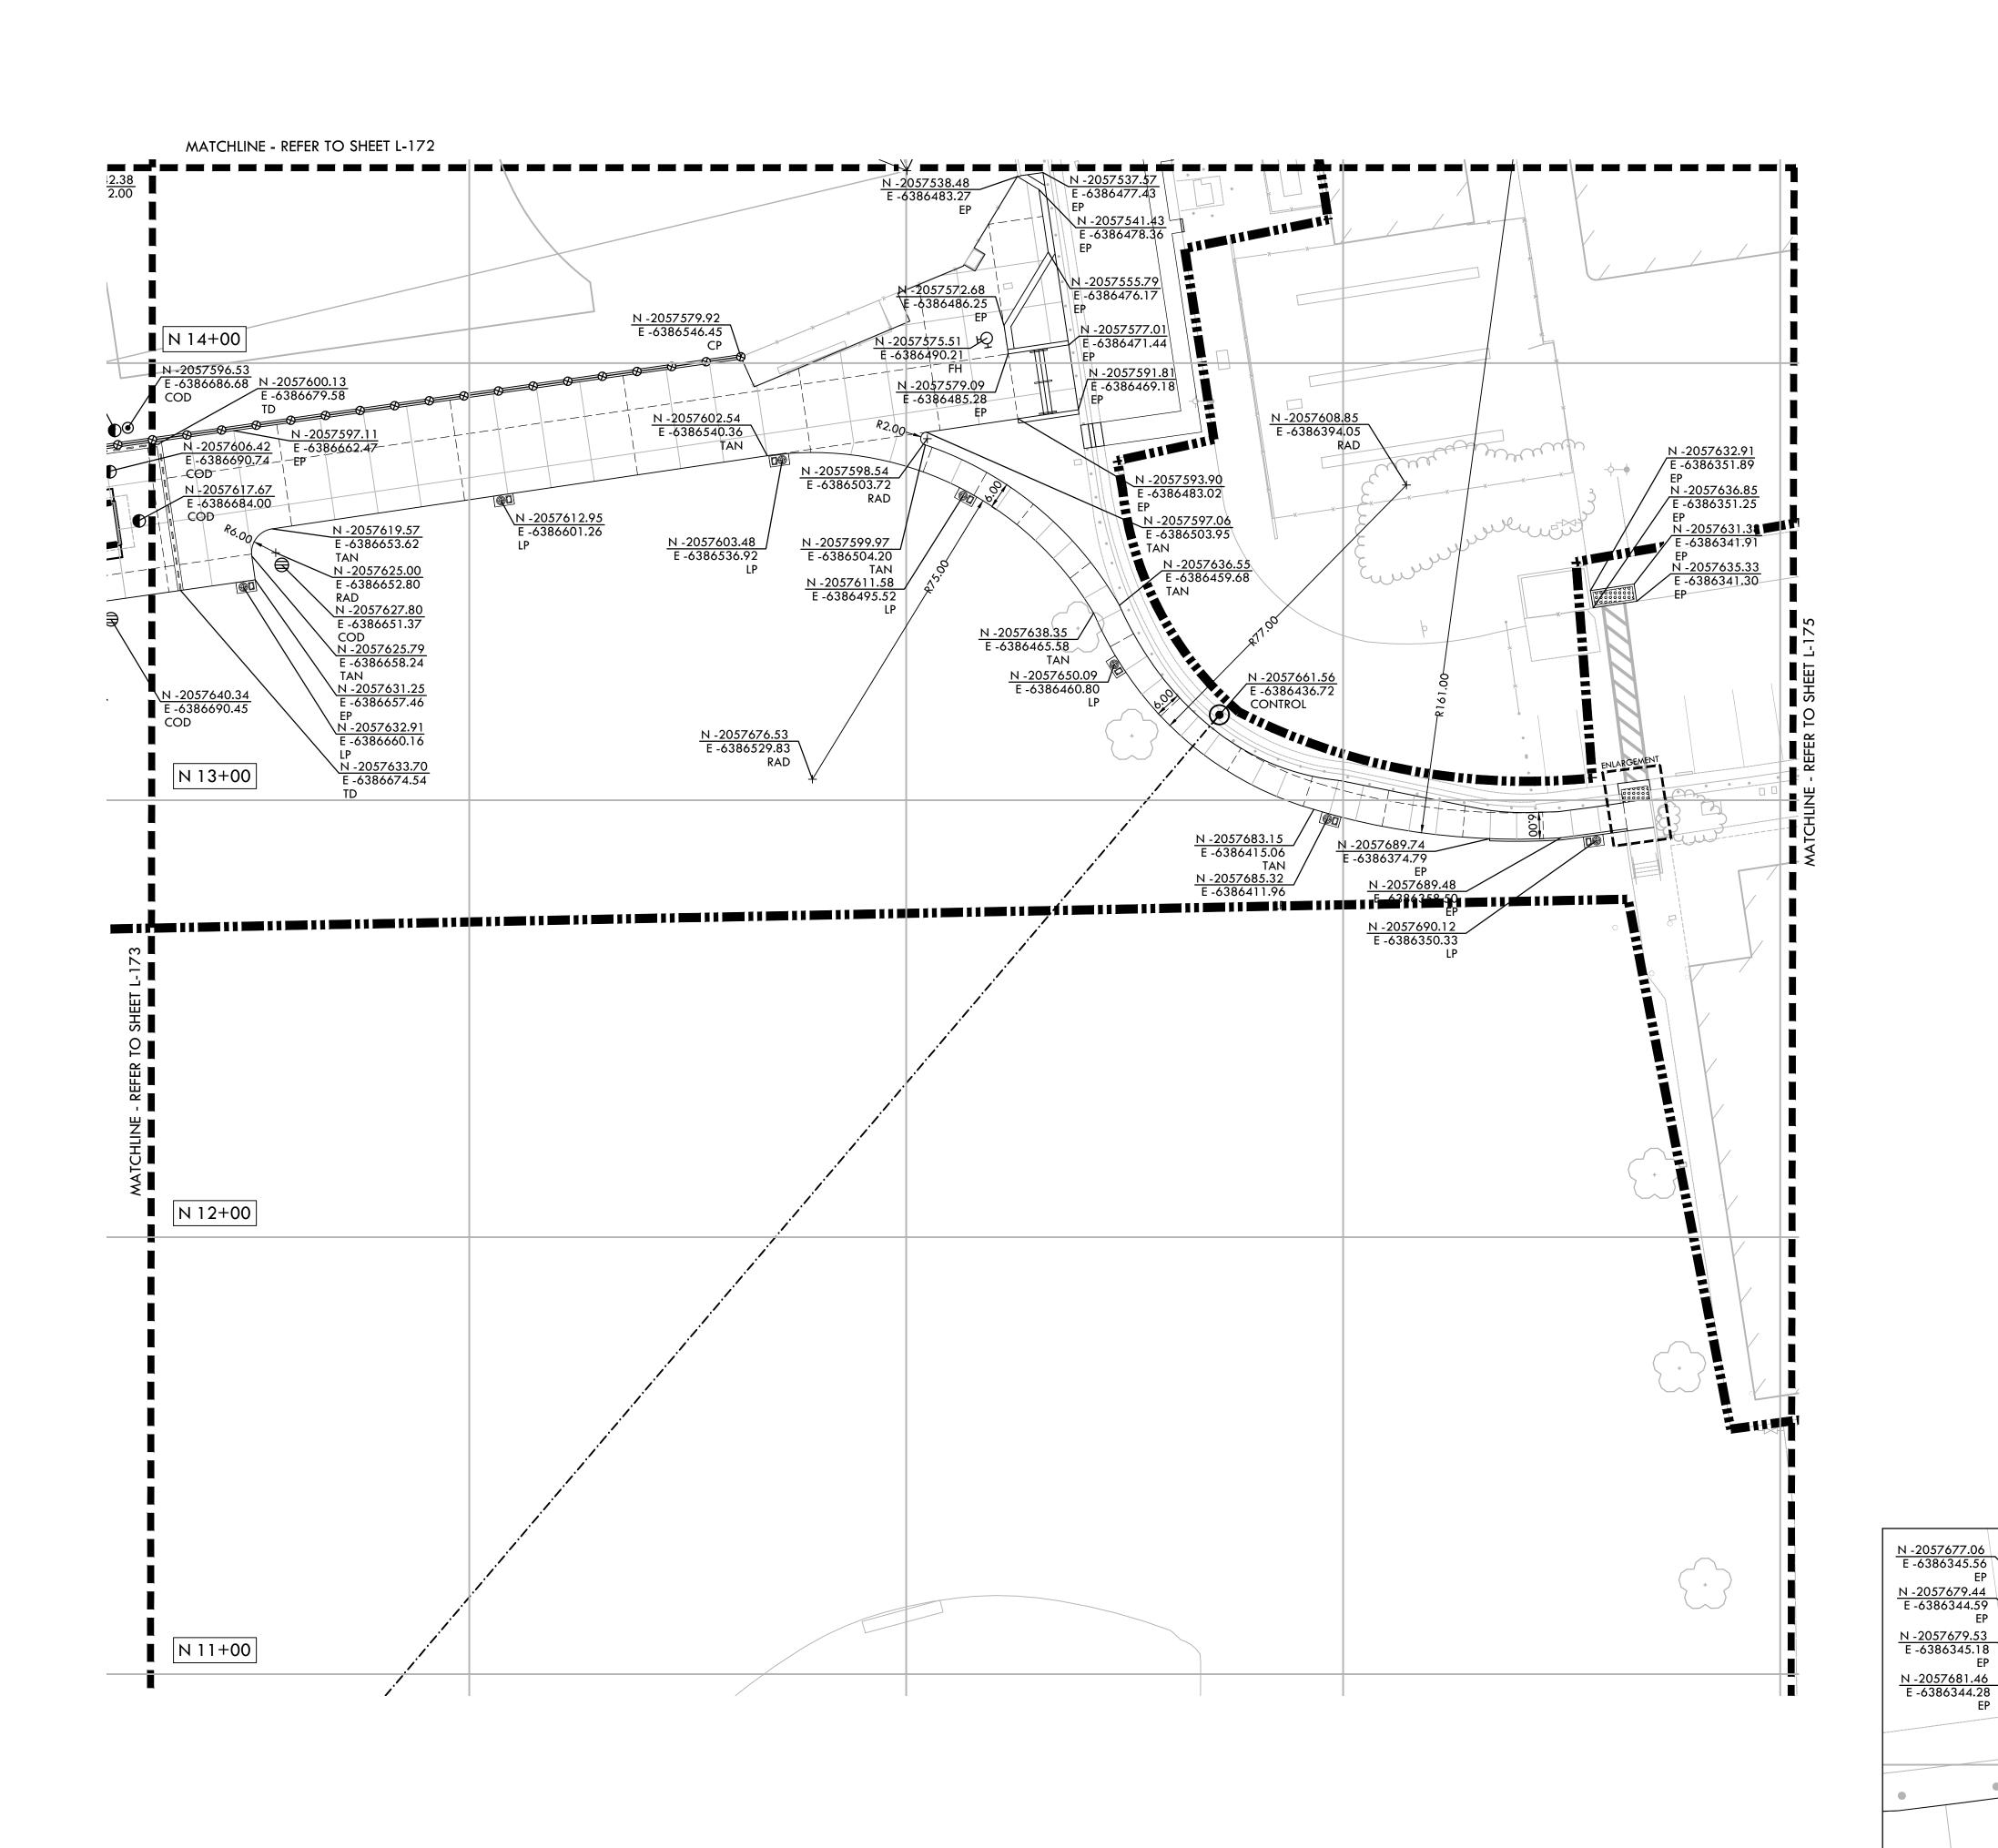

LAYOUT NOTES

- 1. THE CONTRACTOR SHALL COORDINATE ALL CONSTRUCTION ELEMENTS INCLUDING UTILITY LOCATIONS AND REQUIRED SLEEVING PRIOR TO INSTALLATION. VERIFY CRITICAL DIMENSIONS, REFERENCE POINT LOCATIONS AND CONSTRUCTION CONDITIONS PRIOR TO INITIATING CONSTRUCTION. TEMPORARY BENCHMARKS OR REFERENCE POINTS SHALL BE SET BY THE CONTRACTOR AS NECESSARY. NOTIFY THE OWNER'S REPRESENTATIVE IMMEDIATELY SHOULD DISCREPANCY ARISE AND REDIRECT WORK TO AVOID DELAYS.
- 2. ALL DIMENSIONS SHALL BE VERIFIED IN FIELD AND CHALKED, STRING LINED OR FLAGGED BY THE CONTRACTOR PRIOR TO CONSTRUCTION. ANY MINOR ADJUSTMENTS MADE TO ACHIEVE OVERALL DESIGN LAYOUT SHALL BE ACCEPTED BY THE OWNER PRIOR TO CONSTRUCTION.
- 3. LAYOUT IS BASED ON THE POINT(S) OF BEGINNING (P.O.B.) AND BASELINE(S) OR GRID SYSTEM AS SHOWN. DIMENSIONS SHOWN ARE ROUNDED TO THE NEAREST INCH.
- 4. ALL LAYOUT AND GRADES SHALL BE COMPLETED BY A LICENSED SURVEYOR.

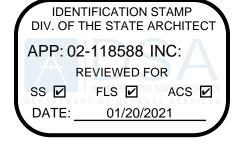



www.VerdeDesignInc.com


LAYOUT LEGEND

SYM DESCRIPTION


CENTER LINES


POB	POINT OF BEGINNING	
•	ANCHOR POINT FOR BASELINE A	REG/CX
P101	RADIUS POINT / CENTER MARK	(
900	PROPOSED ANGLE BETWEEN ELEMENTS	
ALIGN	ALIGN EDGES OF ELEMENTS	CONSULTANT



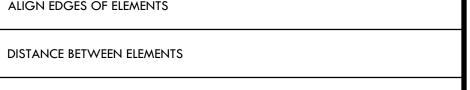


	BASELINE
	CONTROL LINE
N 6+21.95 E 4+97.08	NORTHING/EASTING LAYOUT COORDINATE CALLOUT
(COD)	CENTER OF DRAIN
(CONTROL)	CONTROL POINT
(COR)	CENTER OF RING
(CP)	CENTER OF POST
(EP)	EDGE OF PAVEMENT

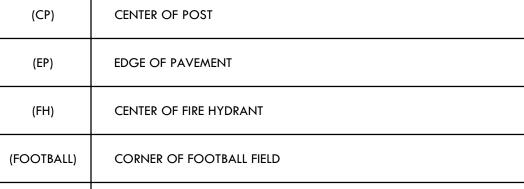

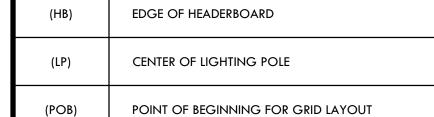

CENTER OF FOUL POLE

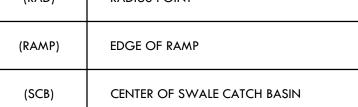

CENTER OF TRENCH DRAIN

(SCB) CENTER OF SWALE CATCH BASIN (SOCCER) CORNER OF SOCCER FIELD (TAN) TANGENT POINT

LAYOUT PLANSTADIUM ENTRY WAY AND WALK

PROJECT NAME MFSA VF

MESA VERDE
HIGH SCHOOL
ATHLETIC FACILITY
IMPROVEMENTS

PROJECT ADDRESS


7501 CARRIAGE DRIVE CITRUS HEIGHTS, CA 95621

	08/13/2		
	1		
DSA SUBMITTAL			
DSA BACKCHECK SUBMITTAL			
	DAT		
CHECKED BY			
CS/	MB		
SCALE			
1"=2	20'-0"		
1			
1819500			
	CHECKED BY CS/ SCALE 1" = 2		


ENLARGEMENT - SCALE: 1"=5'-0"


N -2057687.39 E -6386343.36


N -2057676.15 E -6386338.39

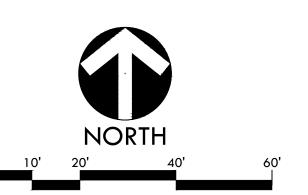



L-174

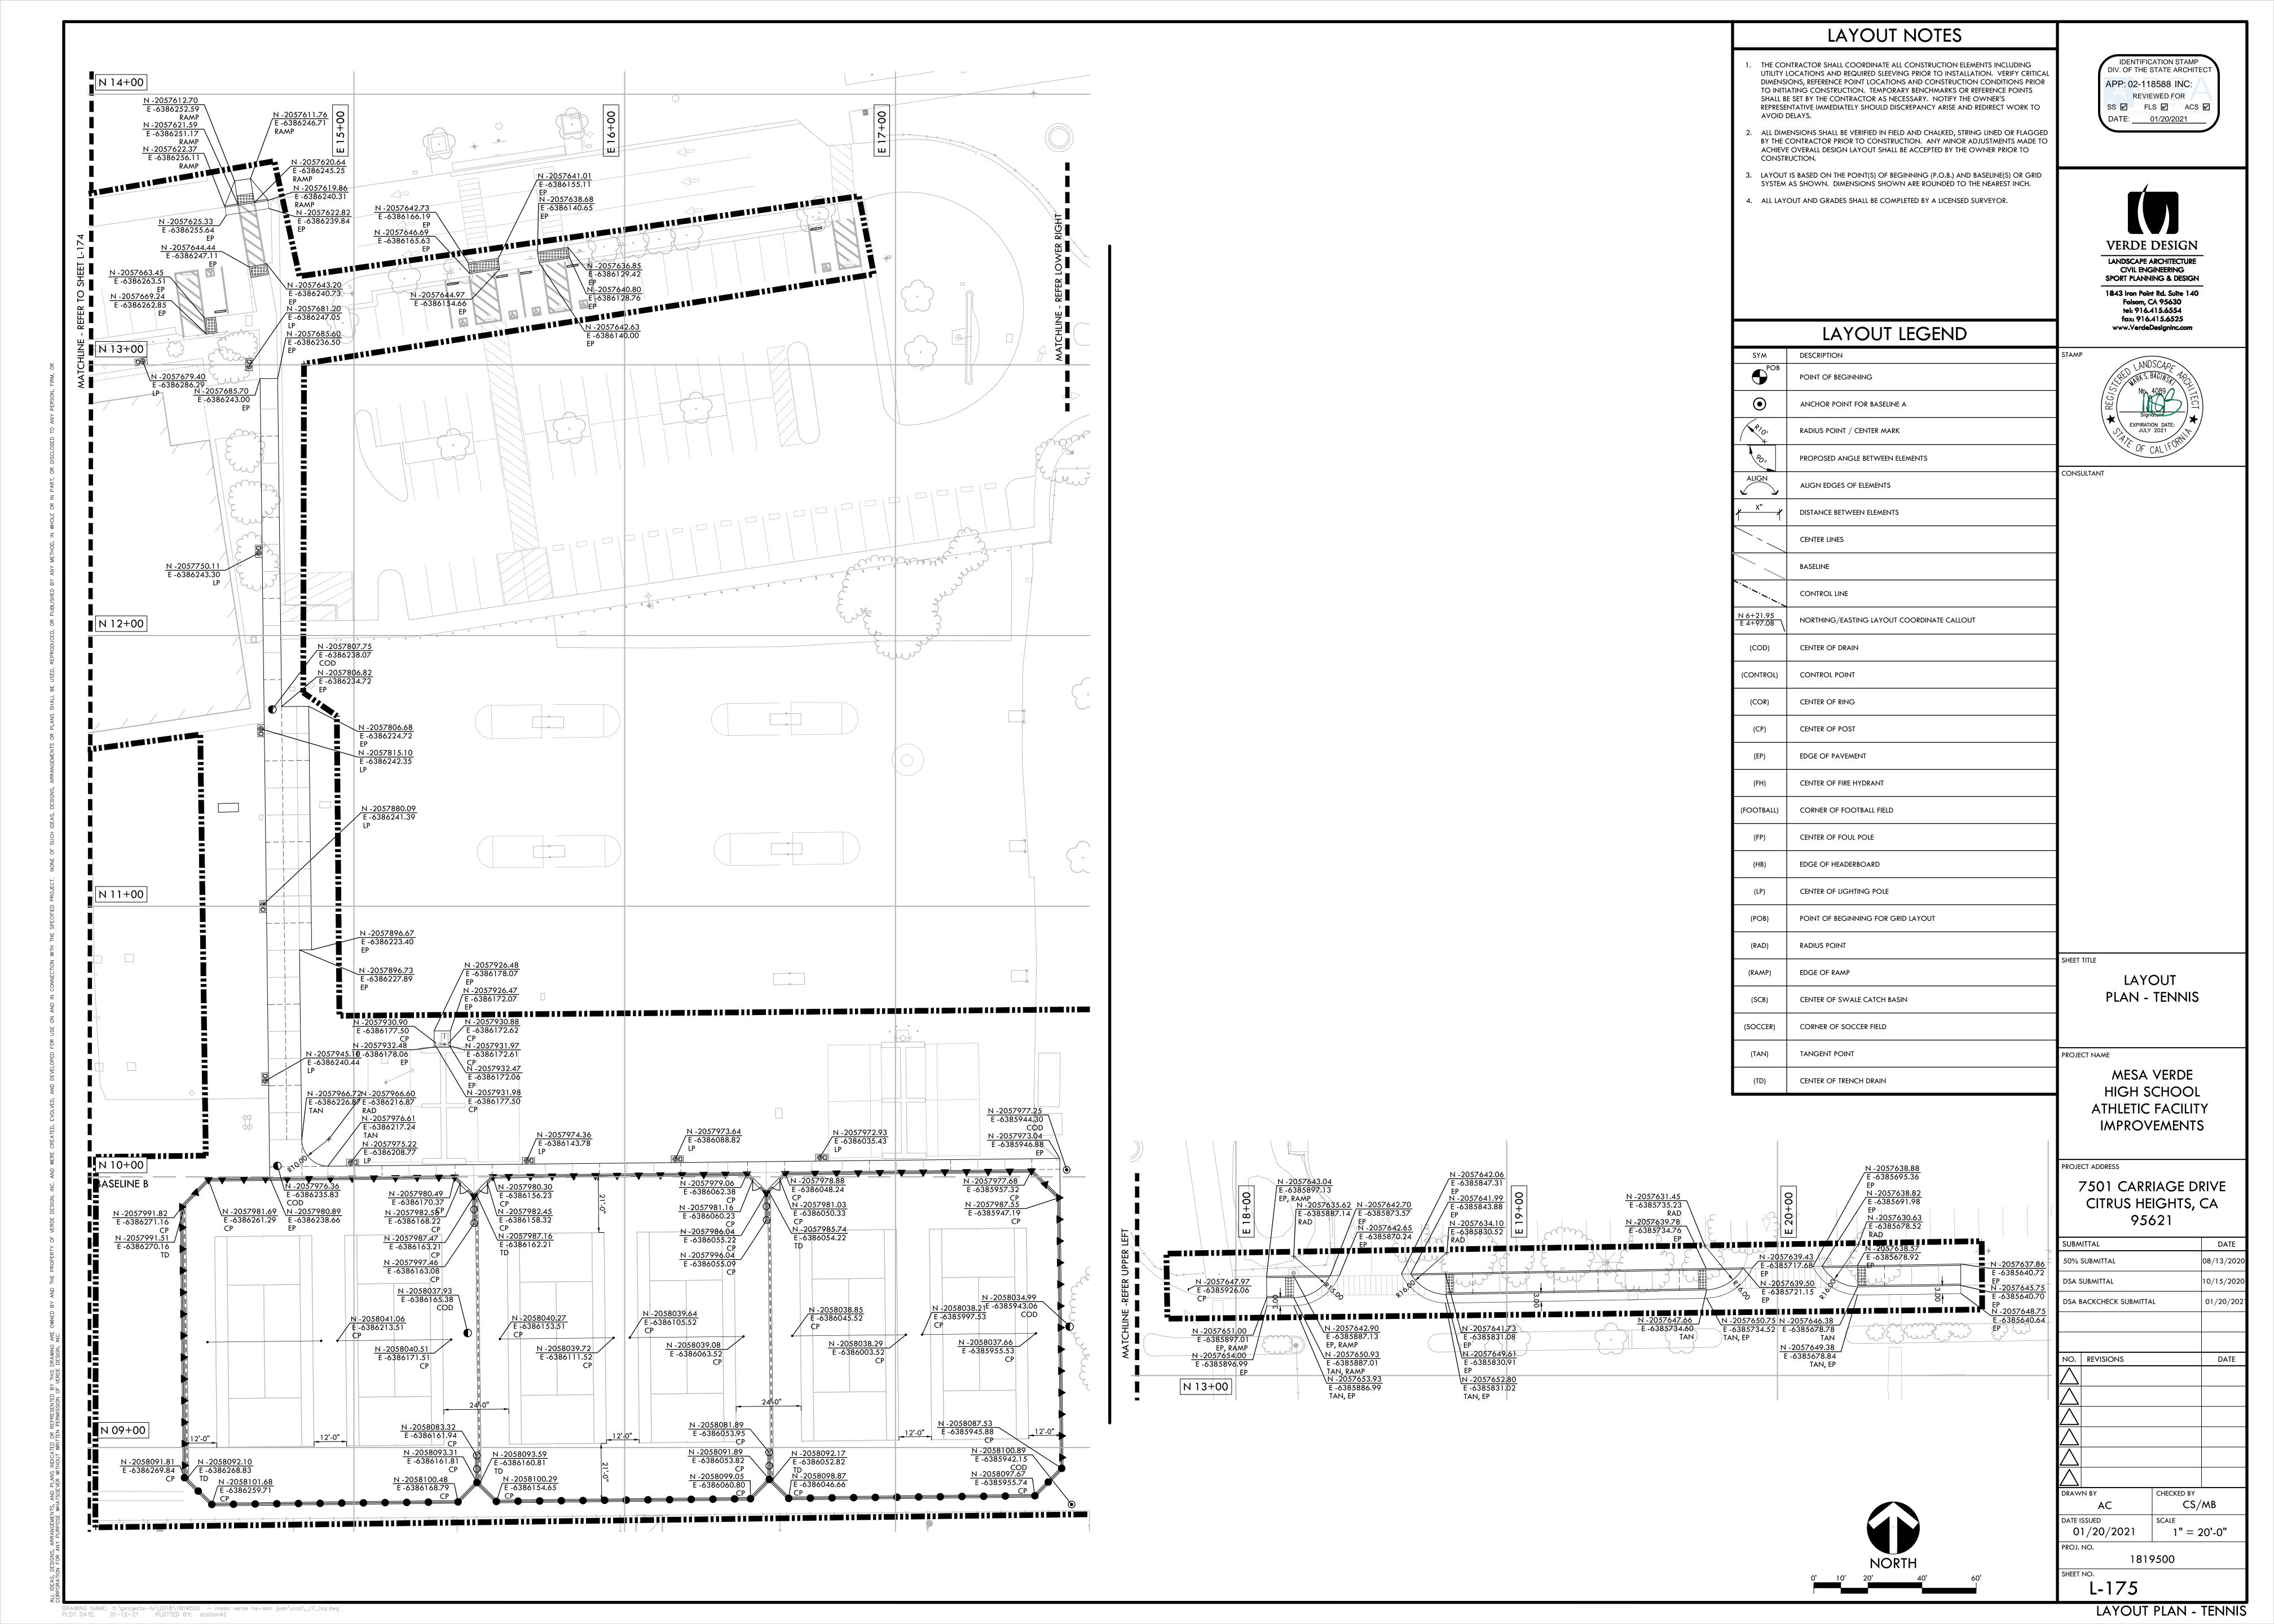

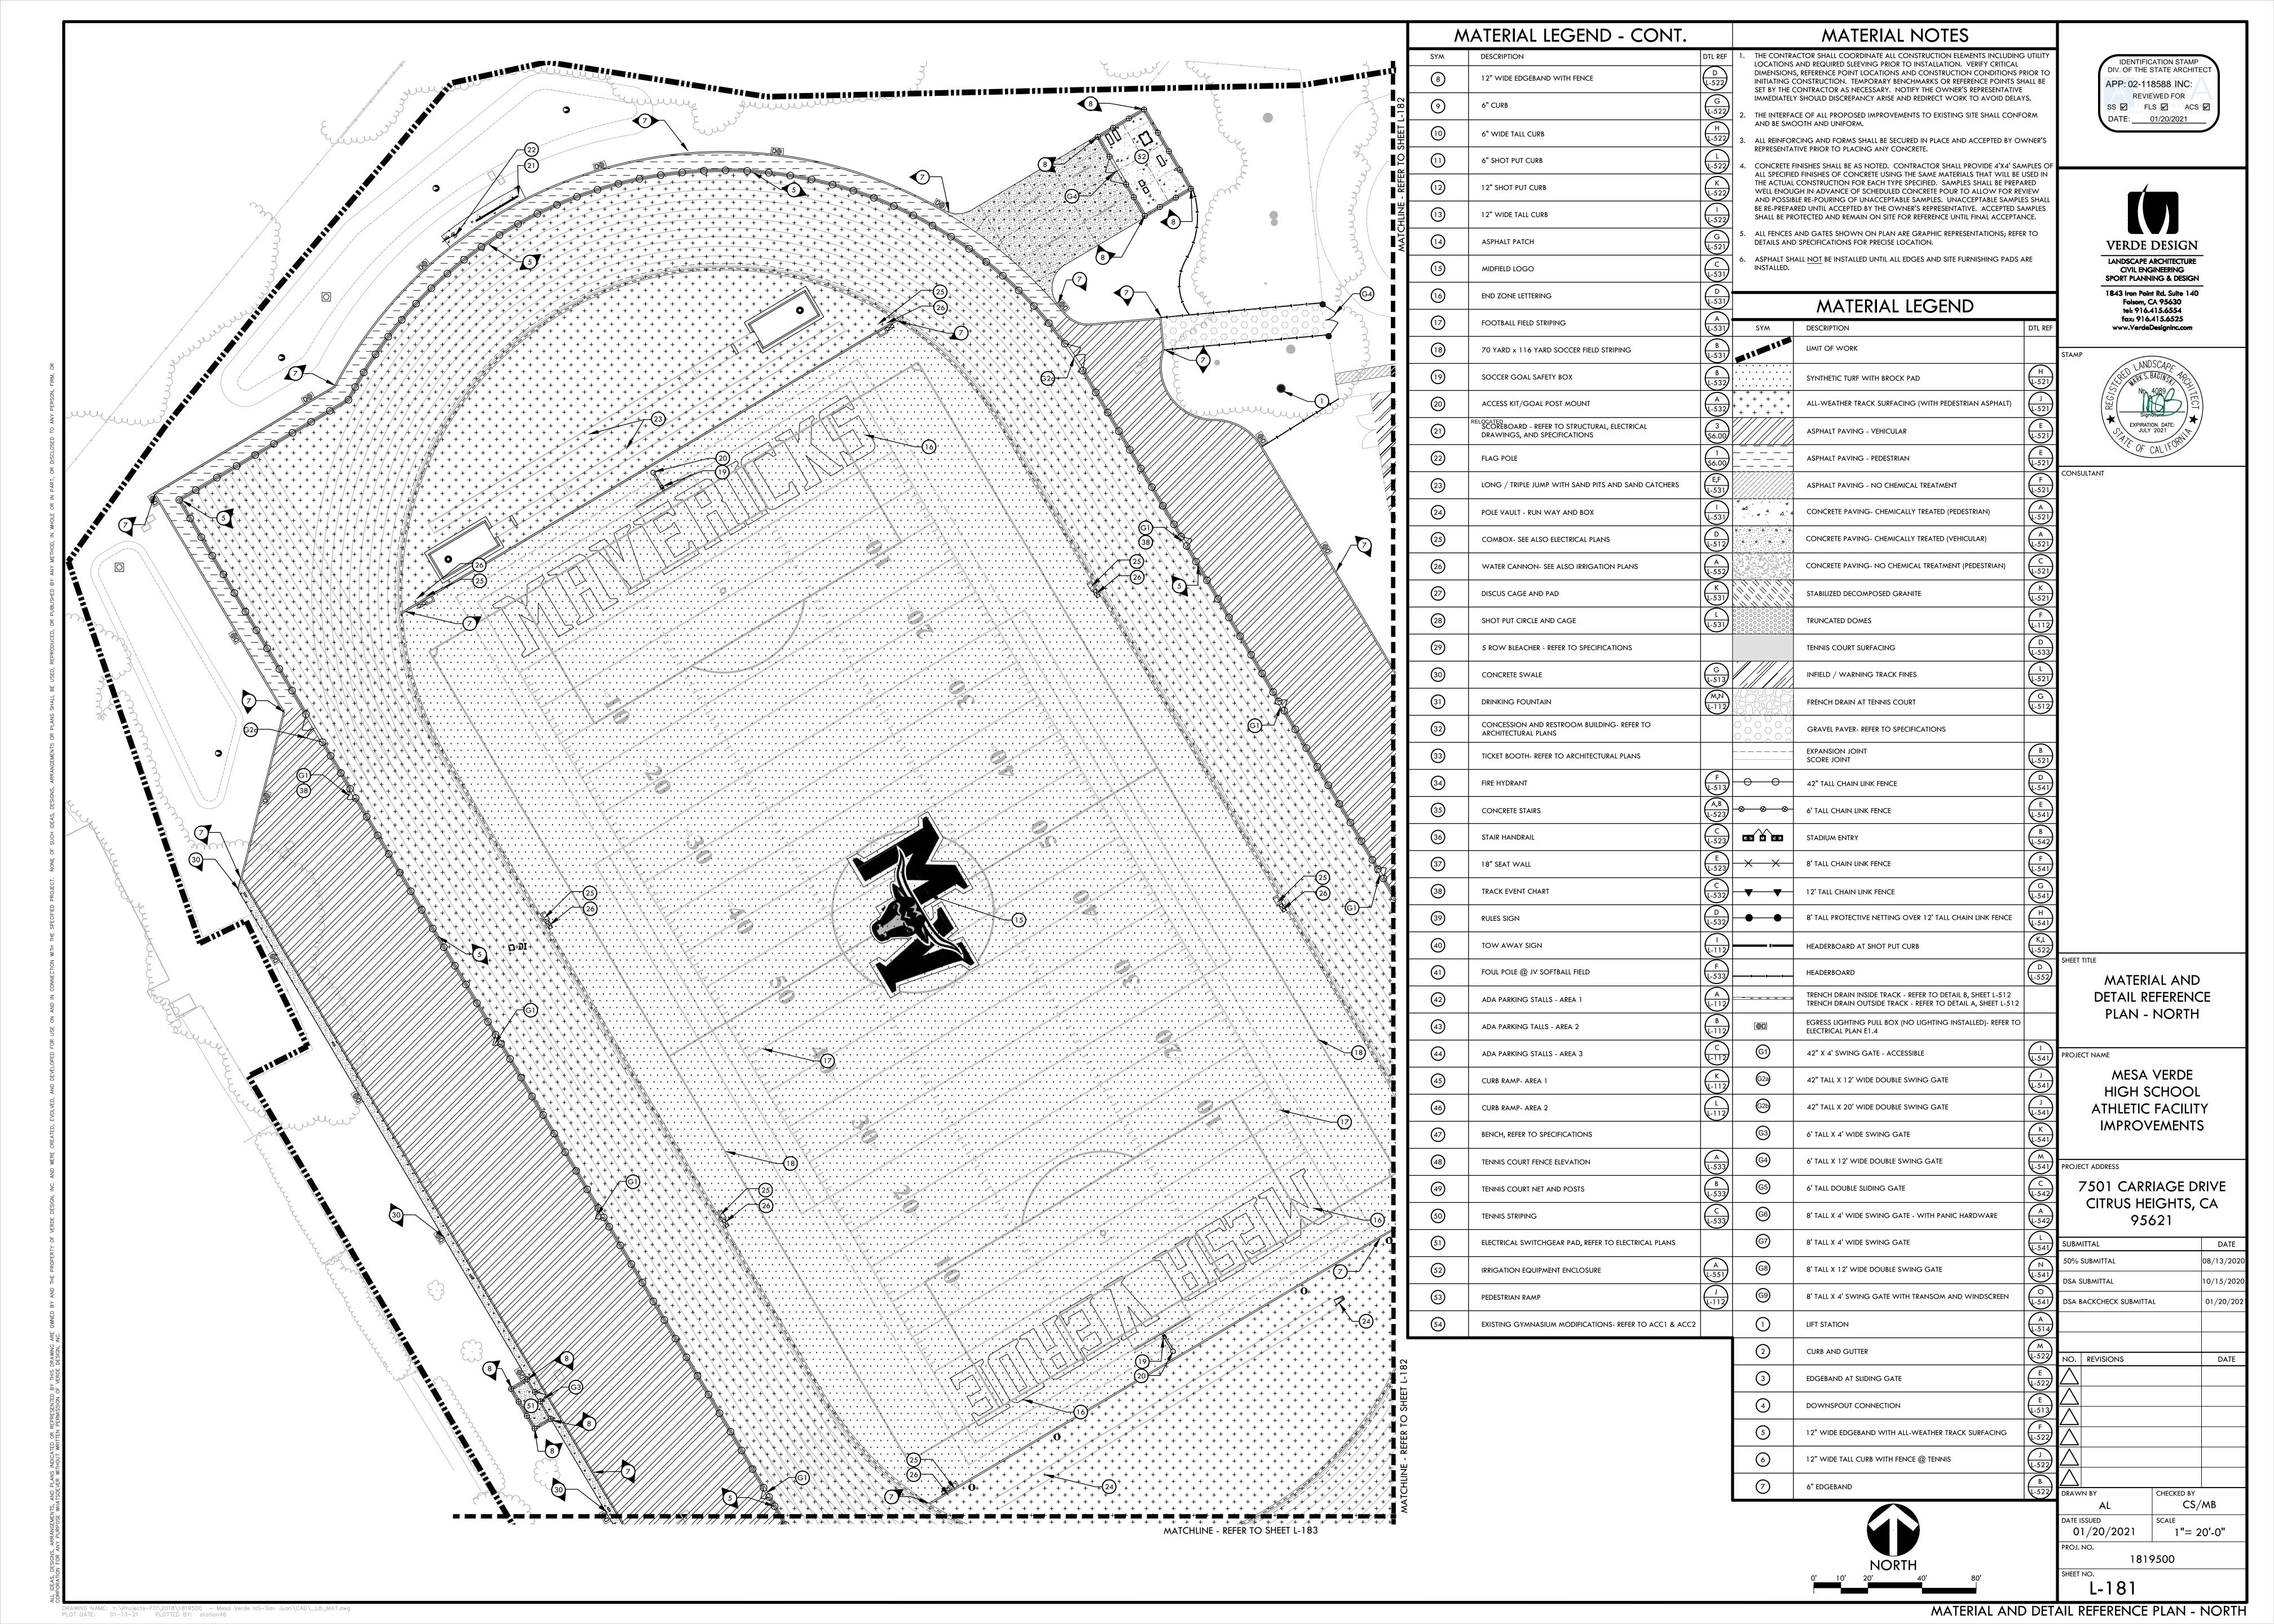

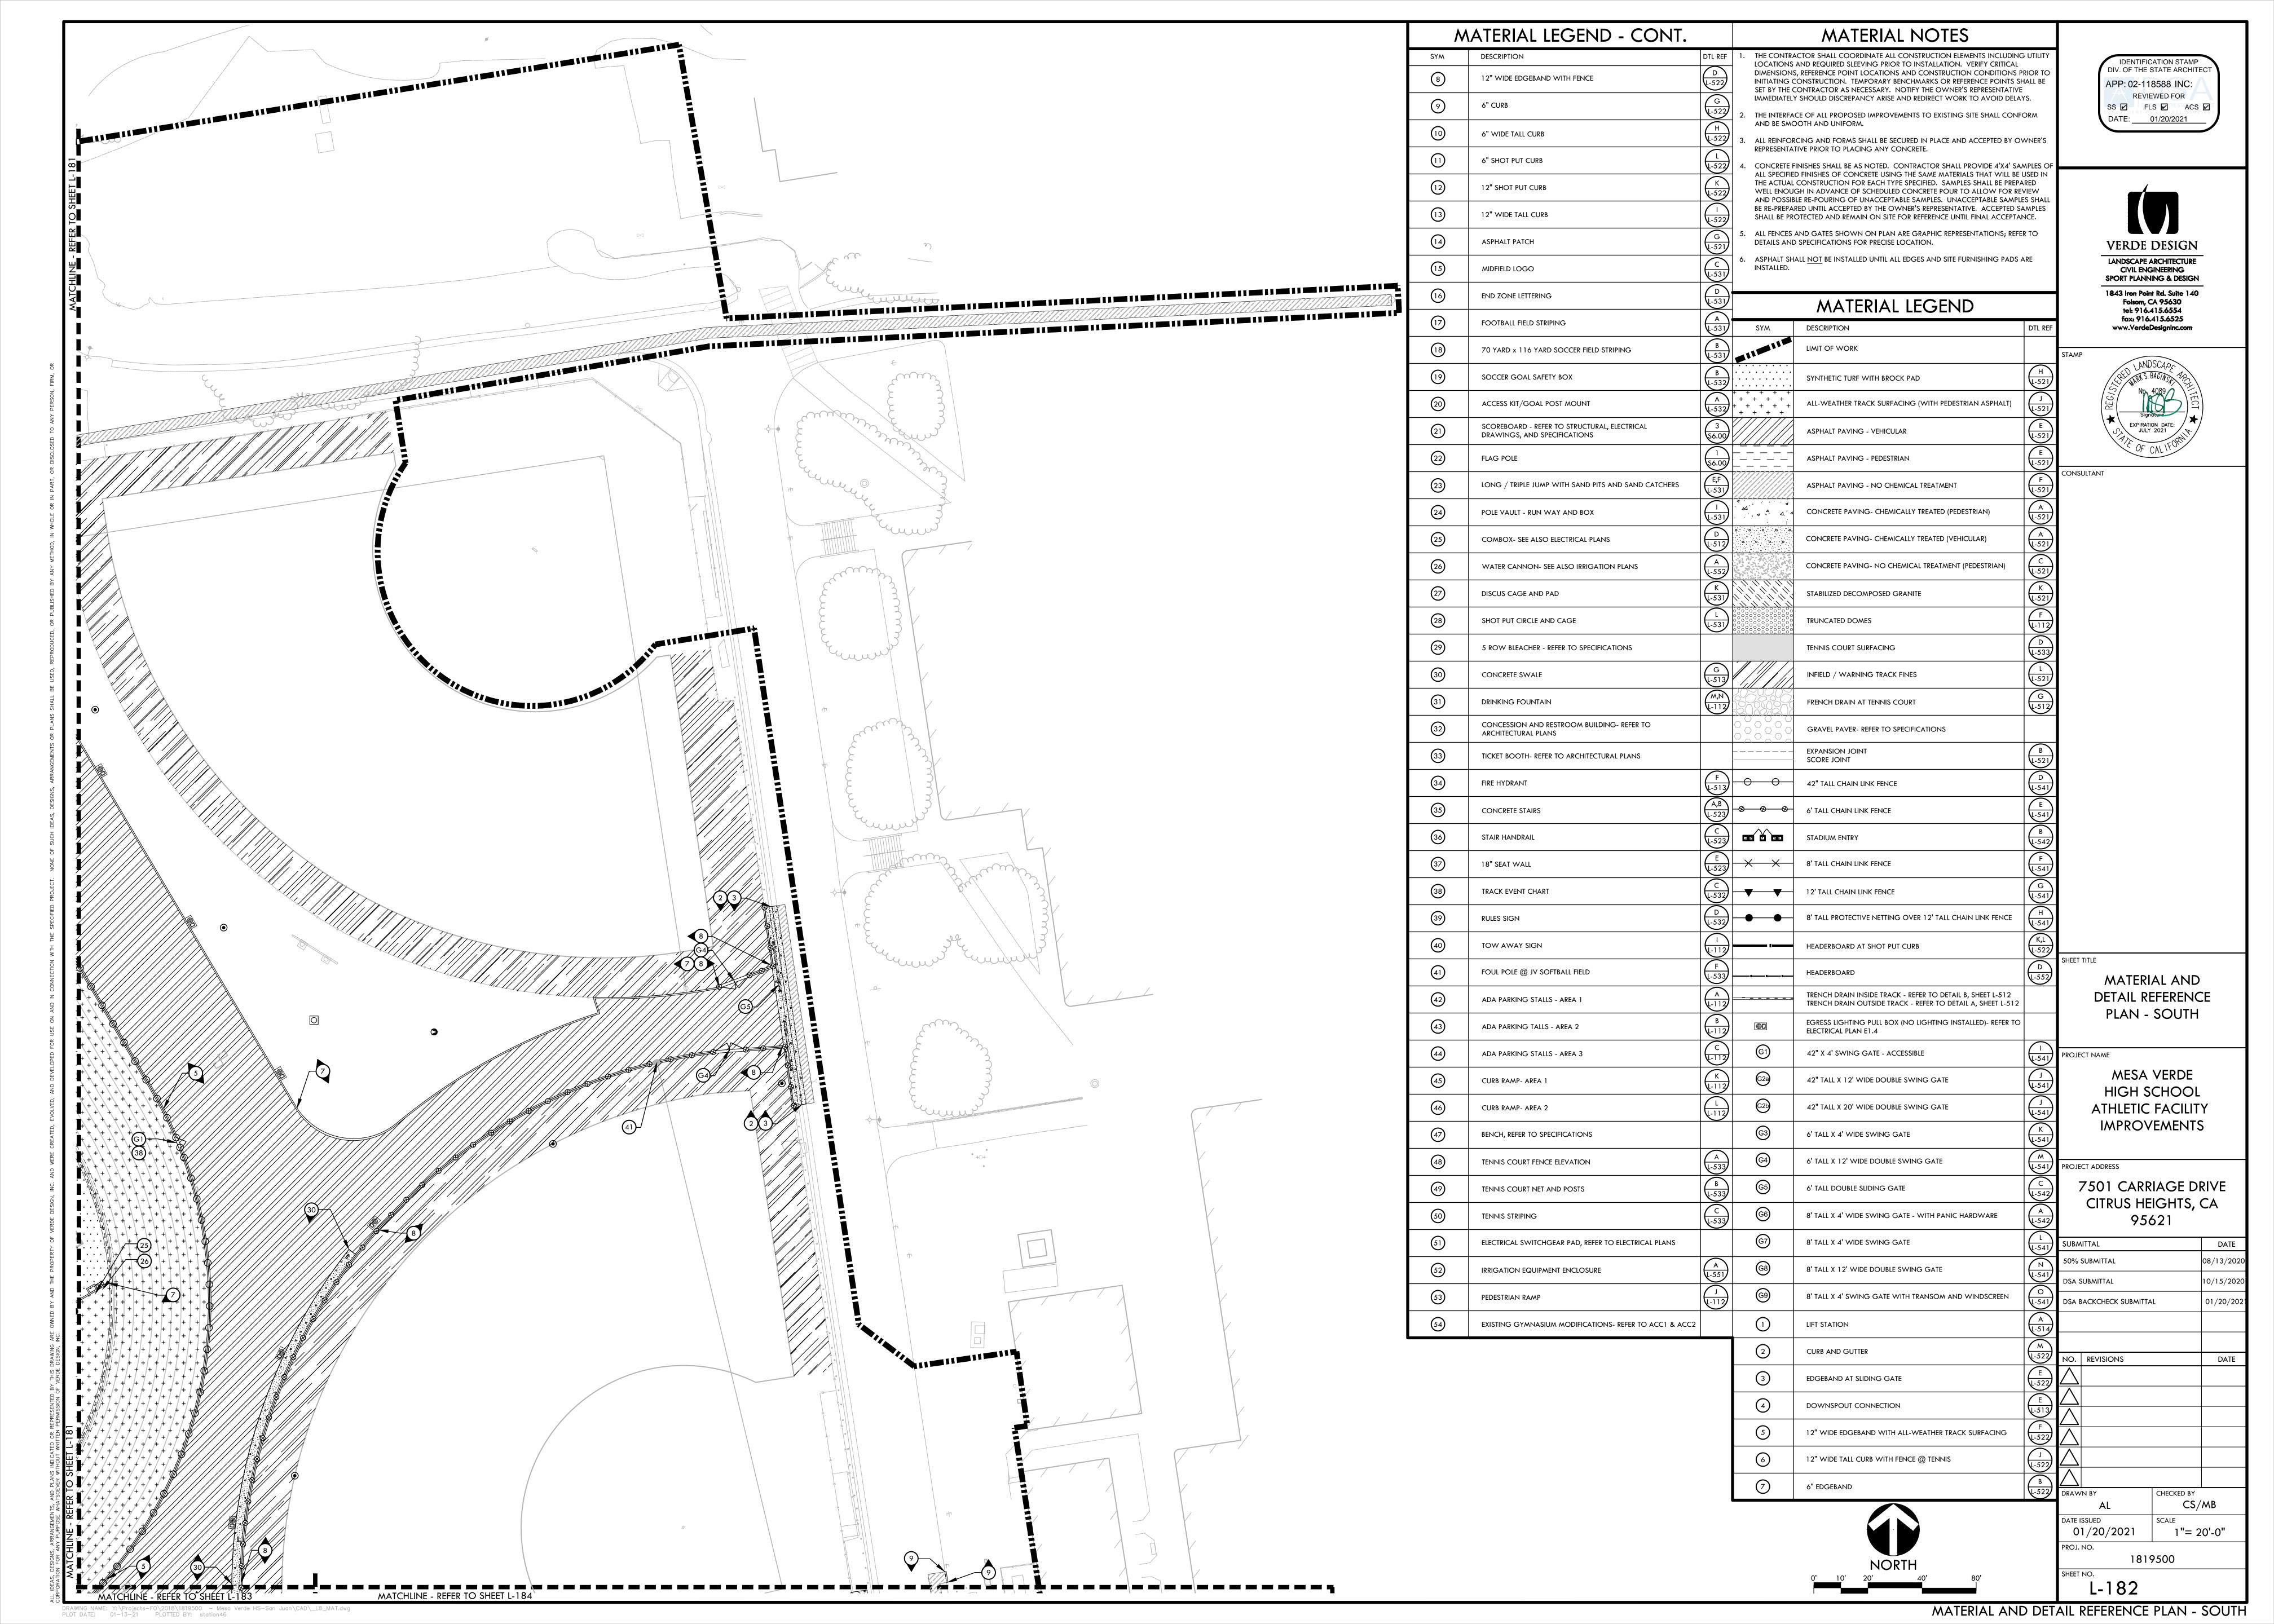

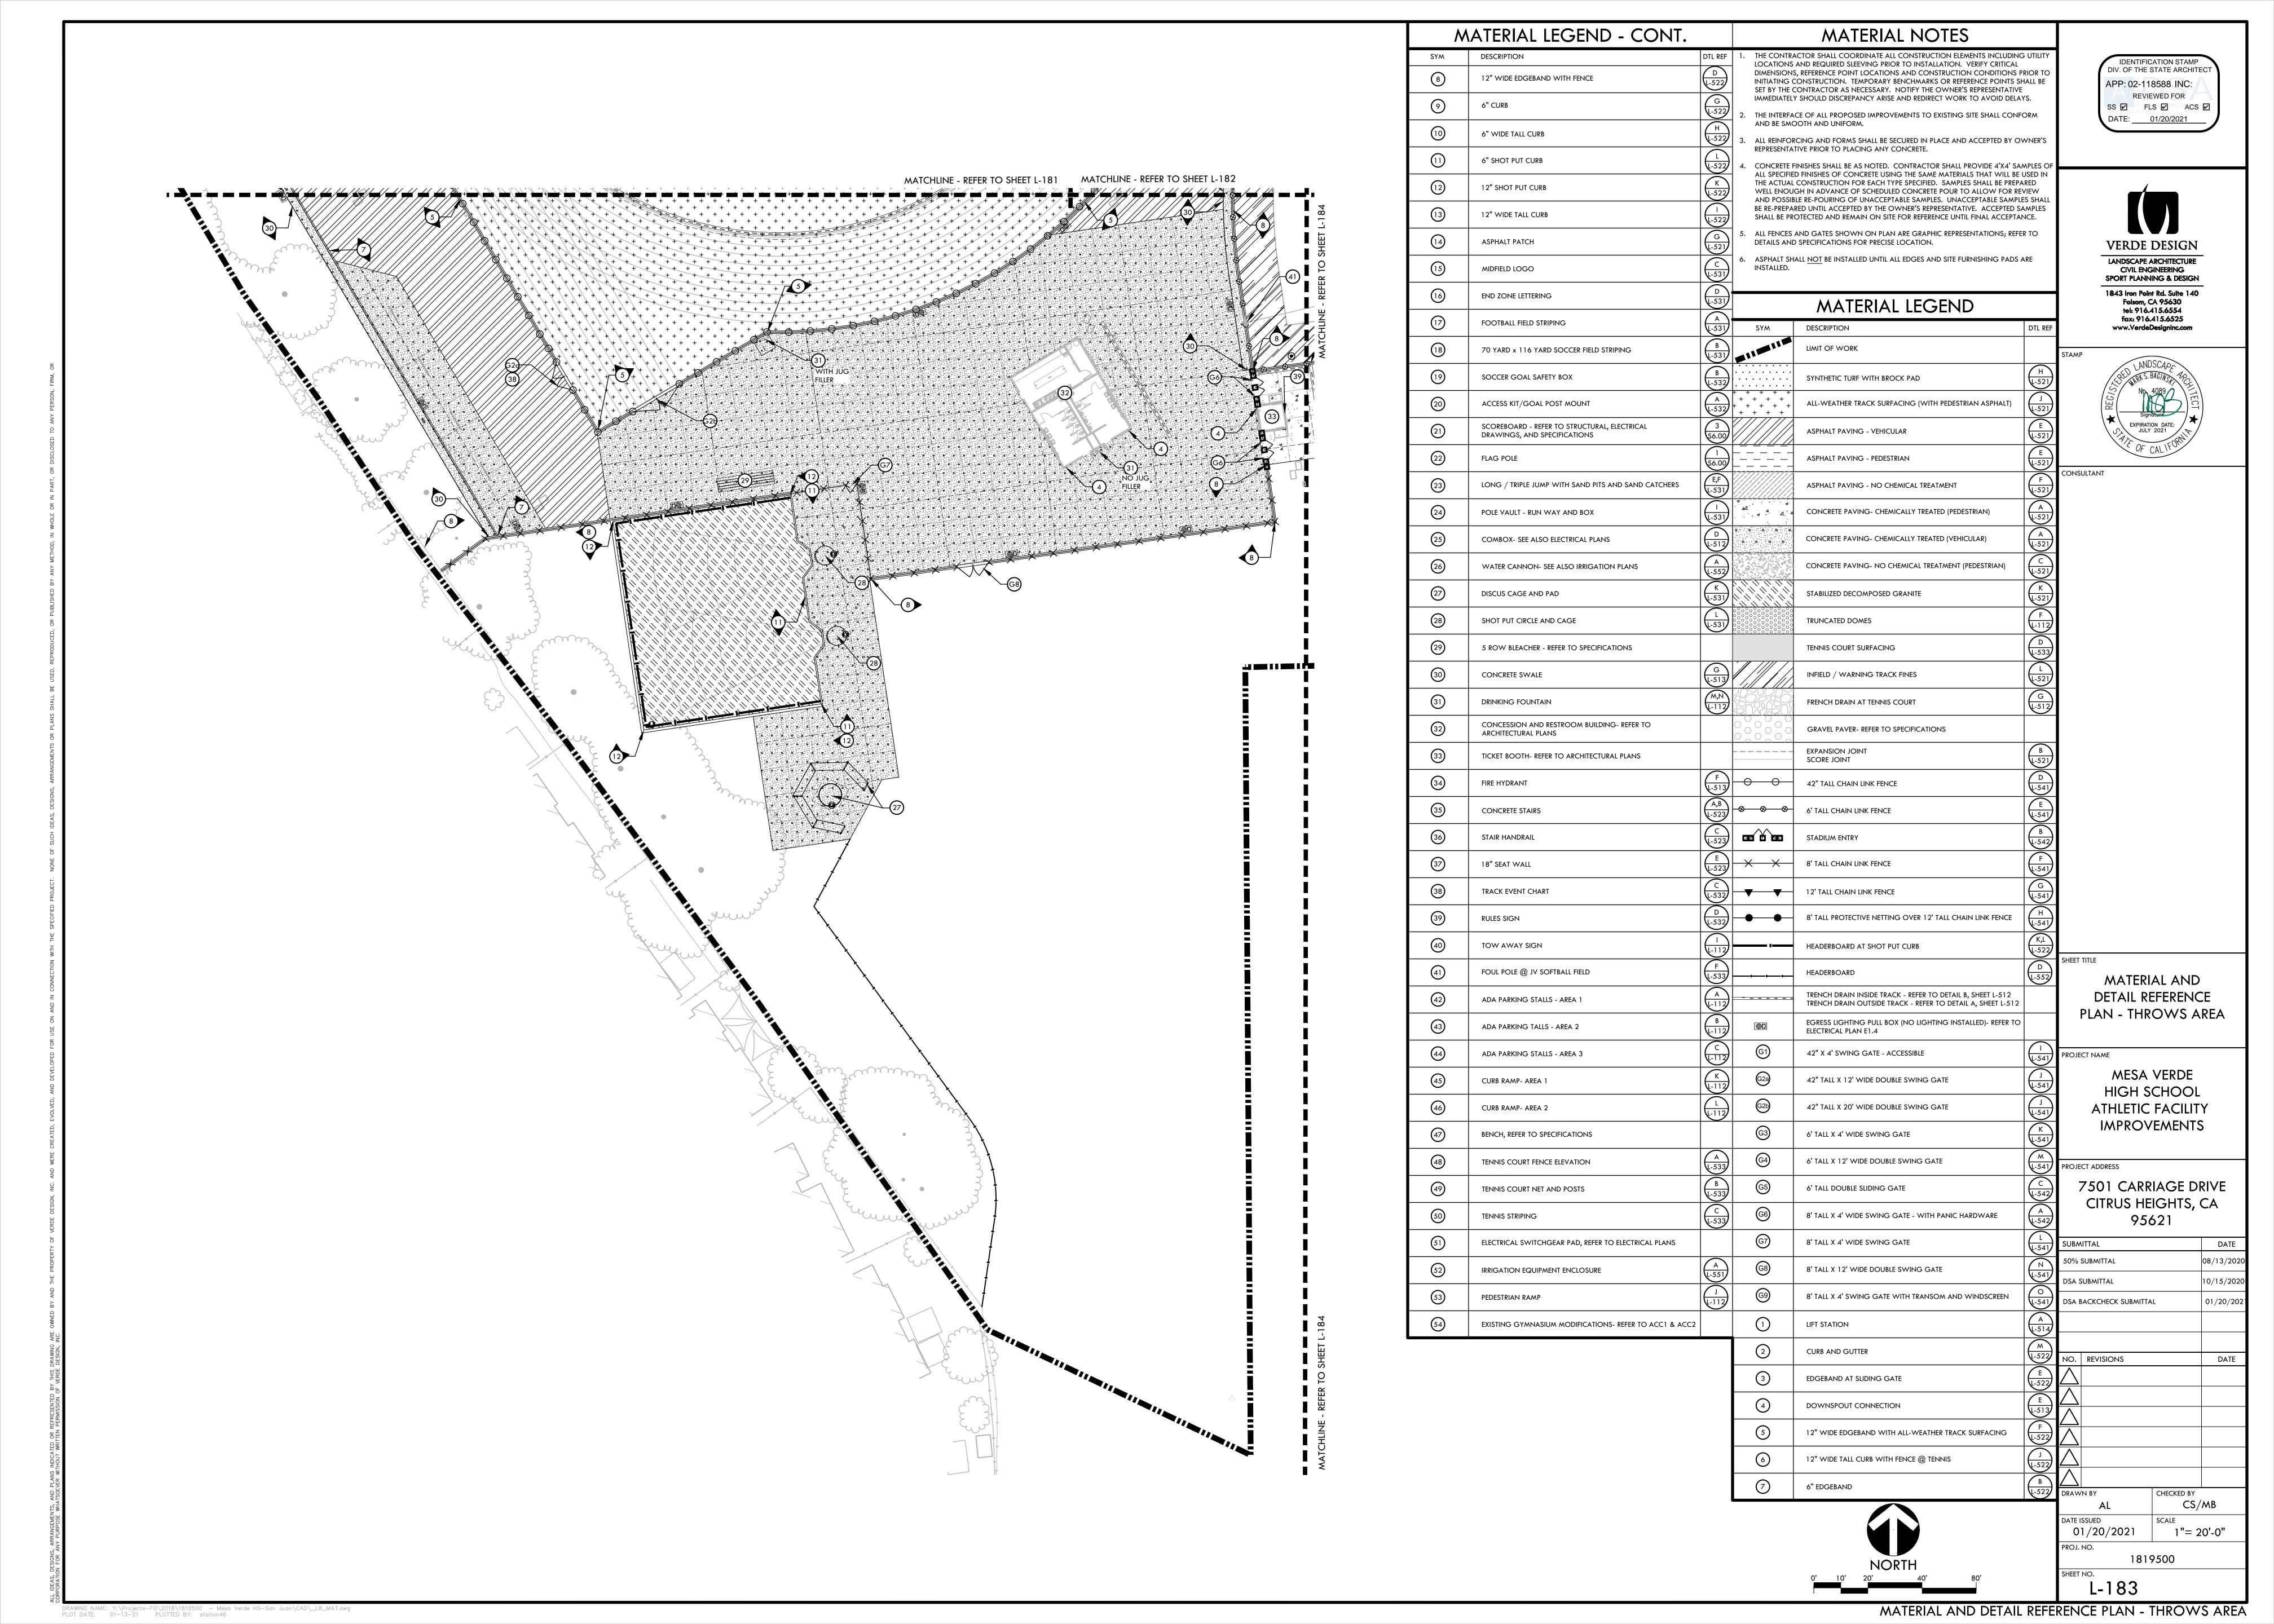

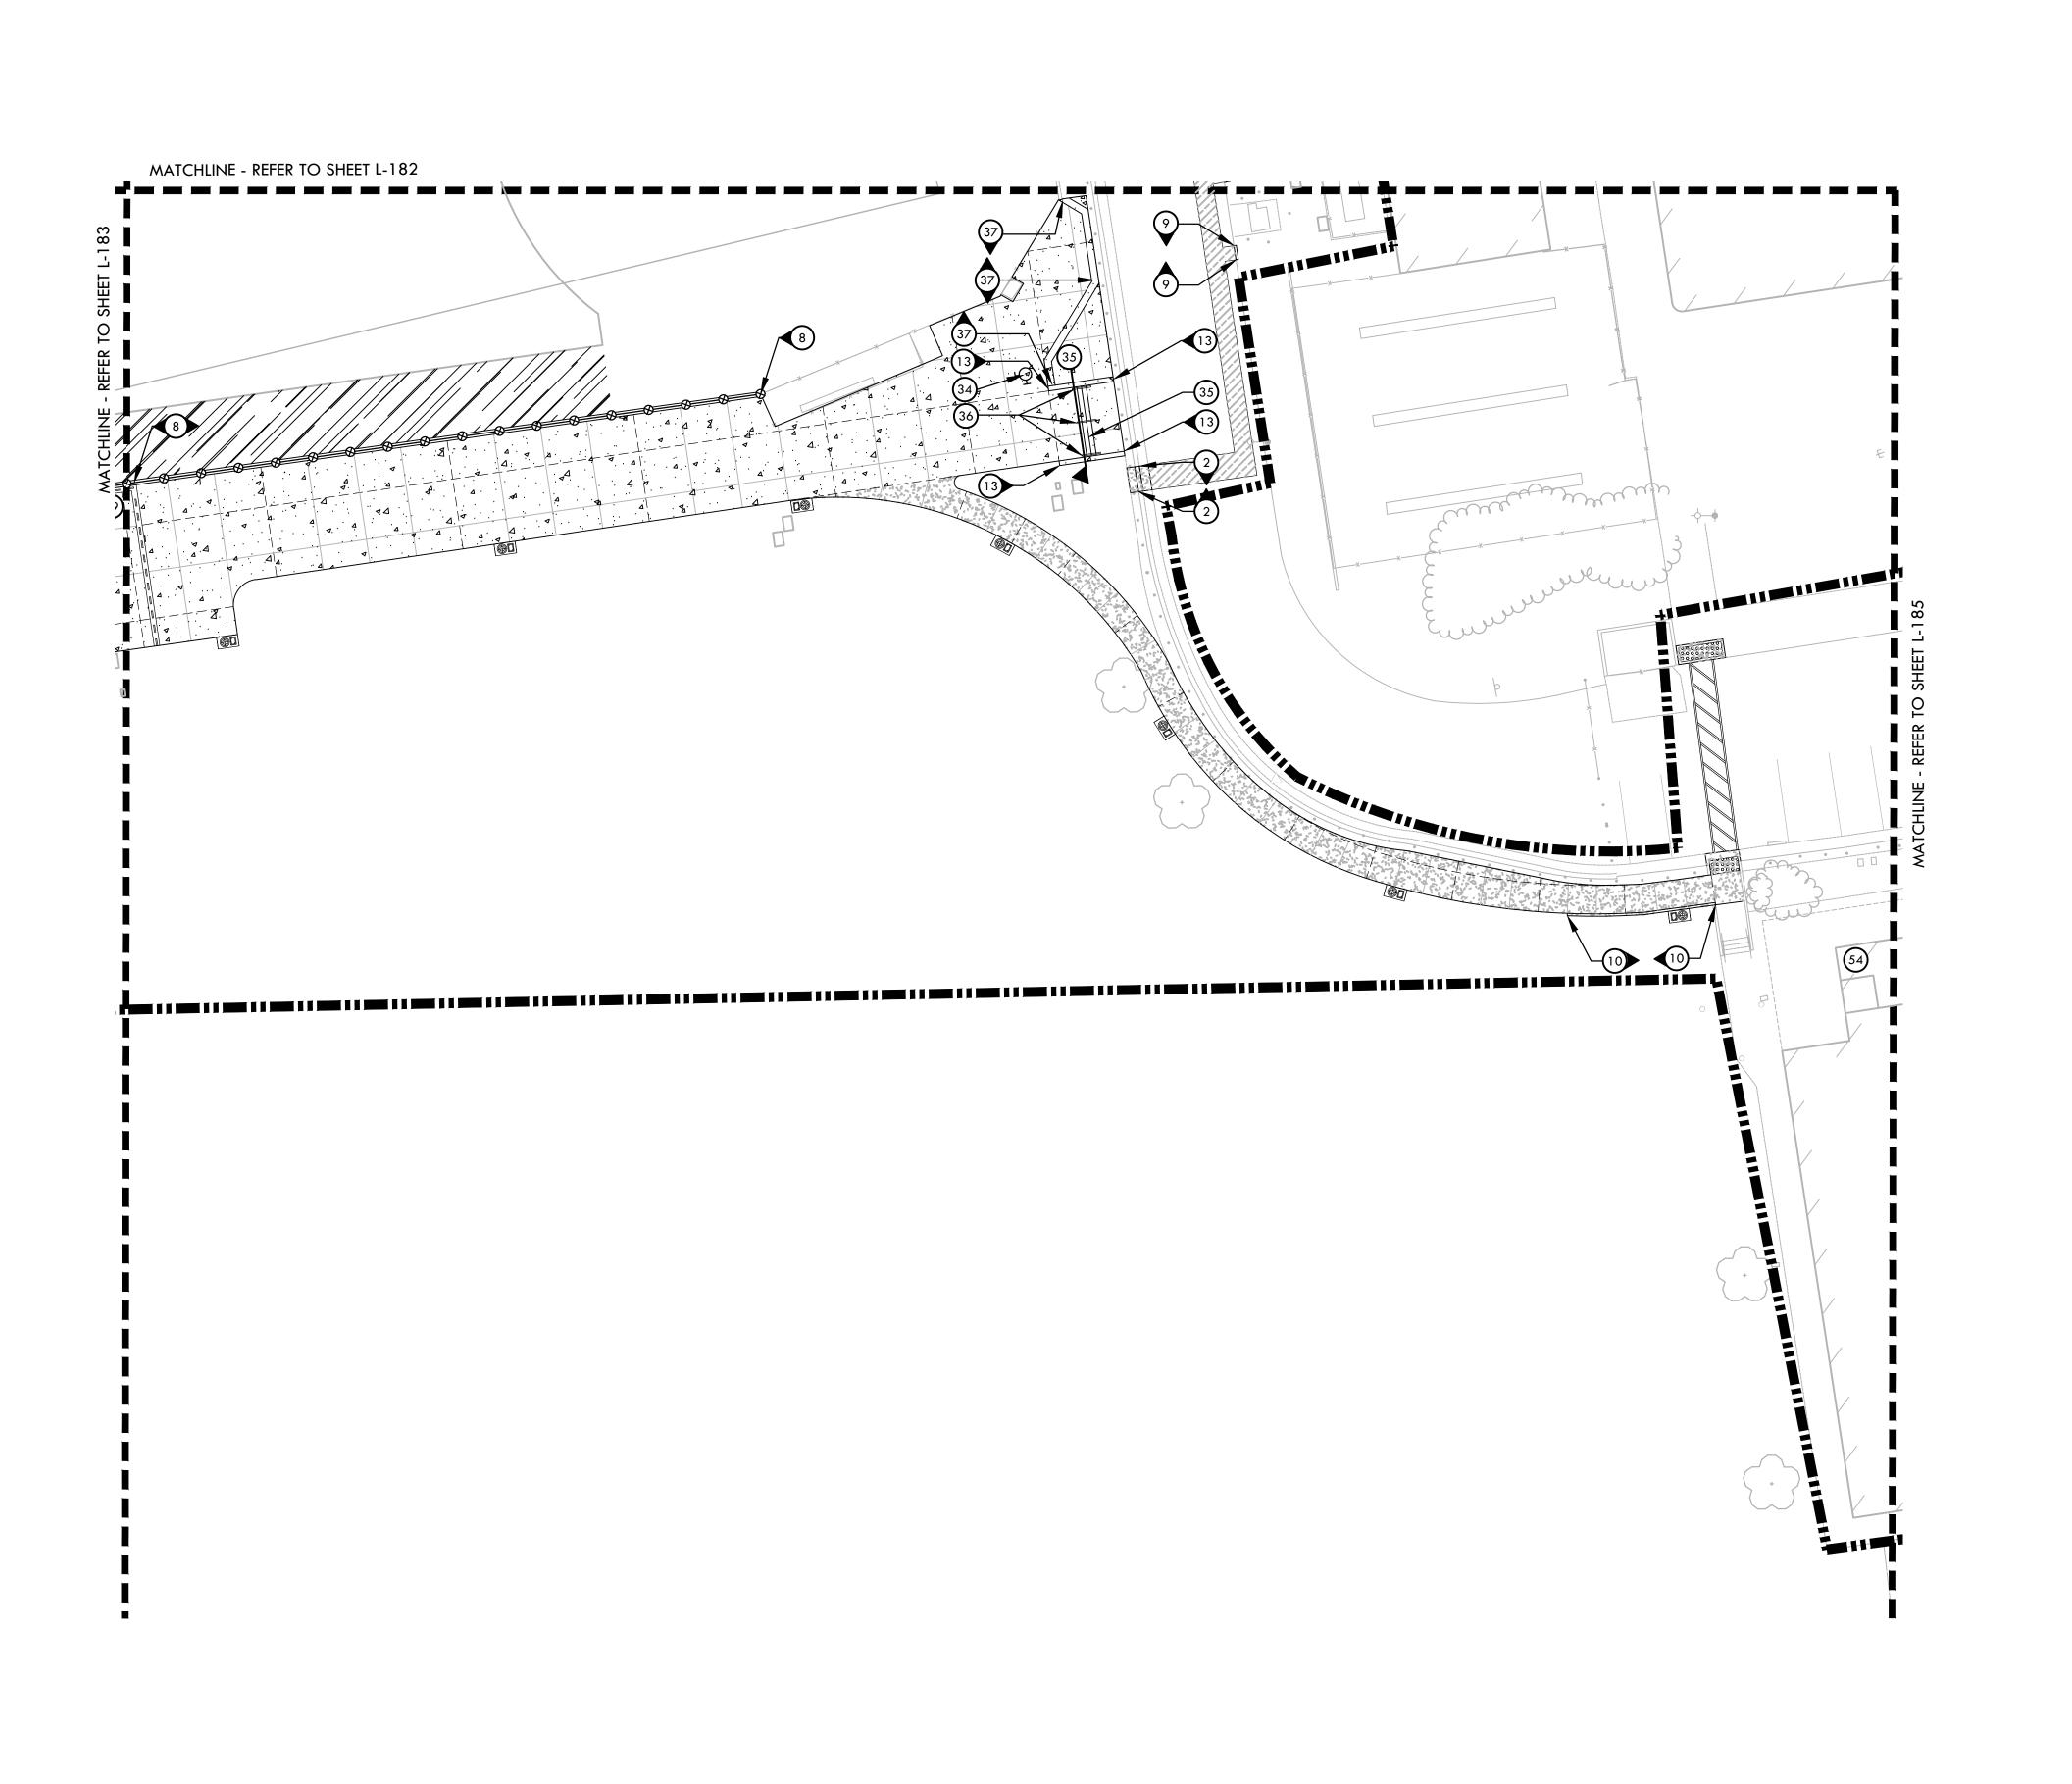

DRAWING NAME: Y:\Projects-F0\2018\1819500 - Mesa Verde HS-San Juan\CAD_L8_MAT.dwg
PLOT DATE: 01-13-21 PLOTTED BY: station46

