

EROSION CONTROL NOTES:

- 1. ALL DISTURBED SLOPES SHALL BE HYDROSEEDED.
- 2. CONTRACTOR TO PROVIDE CONCRETE WASH OUT FACILITY (CSP
- 3. WHERE SILT FENCE CROSSES BEDROCK, OMIT LATH STAKES AND INSTALL GRAVEL BAGS 4 HIGH WITH SILT FENCE SECURED UNDER
- 4. STAKES TO BE POSITIONED ON OUTSIDE OF FENCE.
- 5. JOINING SECTION STAKES TO OVERLAP WITH FENCE FABRIC FOLDED AROUND EACH STAKE ONE FULL TURN. SECURE FABRIC TO STAKE WITH 4 STAPLES.
- 6. STAKES TO BE DRIVEN TIGHTLY TOGETHER TO PREVENT POTENTIAL FLOW-THROUGH OF SEDIMENT AT JOINT. TOPS OF STAKES TO BE SECURED WITH WIRE.
- 7. FOR END STAKE, FENCE FABRIC SHALL BE FOLDED AROUND TWO STAKES ONE FULL TURN AND SECURED WITH 4 STAPLES.
- 8. MINIMUM 4 STAPLES PER STAKE, EQUALLY SPACED.
- 9. MAINTENANCE OPENINGS SHALL BE CONSTRUCTED IN A MANNER TO ENSURE SEDIMENT REMAINS BEHIND SILT FENCE.
- 10. JOINTING SECTIONS SHALL NOT BE PLACED AT SUMP LOCATIONS. 11. GRAVEL BAG ROWS AND LAYERS SHALL BE OFFSET TO ELIMINATE GAPS.
- 12. NO WORK HAVING POTENTIAL TO CAUSE WATER POLLUTION, AS DETERMINED BY THE ENGINEER, SHALL BE PERFORMED UNTIL THE WATER POLLUTION CONTROL PLAN (WPCP) HAS BEEN APPROVED BY THE ENGINEER.
- 13. THE CONTRACTOR SHALL CONSIDER OTHER CONTROL MEASURES, AS NECESSARY, TO SUPPLEMENT THE TEMPORARY CONTROL MEASURES SHOWN ON THESE PLANS, IN ORDER TO MEET THE WATER POLLUTION CONTROL OBJECTIVES.
- 14. ALL VEGETATION SHALL REMAIN, UNLESS OTHERWISE SPECIFIED.
- 15. CONTRACTOR SHALL MAINTAIN ALL EROSION CONTROL DEVICES AND INSTALL NEW DEVICES AS NEEDED.
- 16. CONTRACTOR SHALL REMOVE ALL BMPS FROM SITE UPON COMPLETION OF PROJECT AS DIRECTED BY THE ENGINEER.
- 17. CONTRACTOR SHALL PLACE GRAVEL BAG BERMS AT THE TOE OF ALL TEMPORARY SLOPES.
- 18. ALL DISTURBED AREAS WITHIN THE PIA, EXCLUDING ROCK, SHALL BE COVERED WITH TYPE D EROSION CONTROL MATERIALS.
- 19. THIS PLAN IS A REPRESENTATION ON THE MINIMUM REQUIREMENTS FOR A WPCP. CONTRACTOR SHALL PREPARE AND IMPLEMENT THEIR PROJECT SPECIFIC WPCP PLAN IN ACCORDANCE WITH LOCAL AND STATE REQUIREMENTS.
- 20. THE CONTRACTOR SHALL BE RESPONSIBLE FOR IMPLEMENTING AND MAINTAINING THE EROSION AND SEDIMENT CONTROL MEASURES AND BMP'S SHOWN IN THE WPCP AND PROJECT SWPPP.
- 21. TEMPORARY EROSION CONTROL DEVICES SHOWN ON THE PLAN WHICH INTERFERE WITH THE GRADING WORK SHALL BE RELOCATED OR MODIFIED AS AND WHEN THE QSP, COUNTY INSPECTOR OR OWNER DIRECTS, AS THE WORK PROGRESSES TO MEET "AS GRADED" CONDITIONS.
- 22. ALL LOOSE SOIL AND DEBRIS SHALL BE REMOVED FROM THE STREET AREAS UPON STARTING OPERATIONS AND PERIODICALLY THEREAFTER AS DIRECTED BY THE OWNER.
- 23. EXCEPT WHEN THE QSP, COUNTY, OR OWNER DIRECTS OTHERWISE, ALL DEVICES SHOWN SHALL BE IN PLACE AT THE END OF EACH WORKING DAY WHEN RAIN IS FORECAST, AND SHALL BE MAINTAINED DURING THE RAINY SEASON.
- 24. GRAVEL BAGS SHALL BE STOCKPILED ON SITE, READY TO BE PLACED IN POSITION WHEN RAIN IS FORECAST, OR WHEN THE OWNER SO DIRECTS.
- 25. A "STANDBY EMERGENCY CREW" SHALL BE ALERTED BY THE PERMITTEE OR THE CONTRACTOR TO PERFORM EMERGENCY WORK DURING RAINSTORMS.
- 26. THE CONTRACTOR SHALL MONITOR THE WEATHER FORECAST, AS REQUIRED BY THE PROJECT SWPPP. IN THE EVENT THE FORECAST CALLS FOR A 50% CHANCE OF RAIN OR MORE WITHIN THE NEXT 48 HOUR WORK PERIOD, THE CONTRACTOR SHALL TAKE MEASURES TO MITIGATE THE WORK STOPPAGE DUE TO THE RAIN EVENT. THE CONTRACTOR SHALL LIMIT THE WORK THAT CAN ONLY BE PERFORMED WITHIN THE WORK DAY. EXPOSED EXCAVATIONS OR TRENCHES SHALL BE COVERED AND PROTECTED FROM WATER. CONTRACTOR SHALL GRADE AREAS SUCH THAT WATER DRAINS AWAY FROM WORK AREA.
- 27. CONTRACTOR SHALL INSTALL A TEMPORARY CONSTRUCTION ROADWAY (TC-2) OR GRAVEL MULCH (EC-16) IN ORDER TO PREVENT THE OFF-TRACKING OF SEDIMENT IF THE PROJECT QSP REQUIRES THE CONTRACTOR TO DO SO.
- 28. CONTRACTOR SHALL INSTALL PERIMETER FENCING AROUND WORK AREA IN CONFORMANCE WITH 2009 CASQA STORMWATER BMP MANUAL SECTION WE-1. FENCING SHALL BE CHAIN LINK, AT MINIMUM AND SHALL HAVE FENCE FABRIC ATTACHED.
- 29. THIS PLAN IS A REPRESENTATION OF THE MINIMUM REQUIREMENTS FOR A TEMPORARY EROSION AND SEDIMENT CONTROL PLAN. CONTRACTOR SHALL PREPARE AND IMPLEMENT THEIR PROJECT-SPECIFIC TESC PLAN IN ACCORDANCE WITH STATE, LOCAL, AND SWPPP REQUIREMENTS.

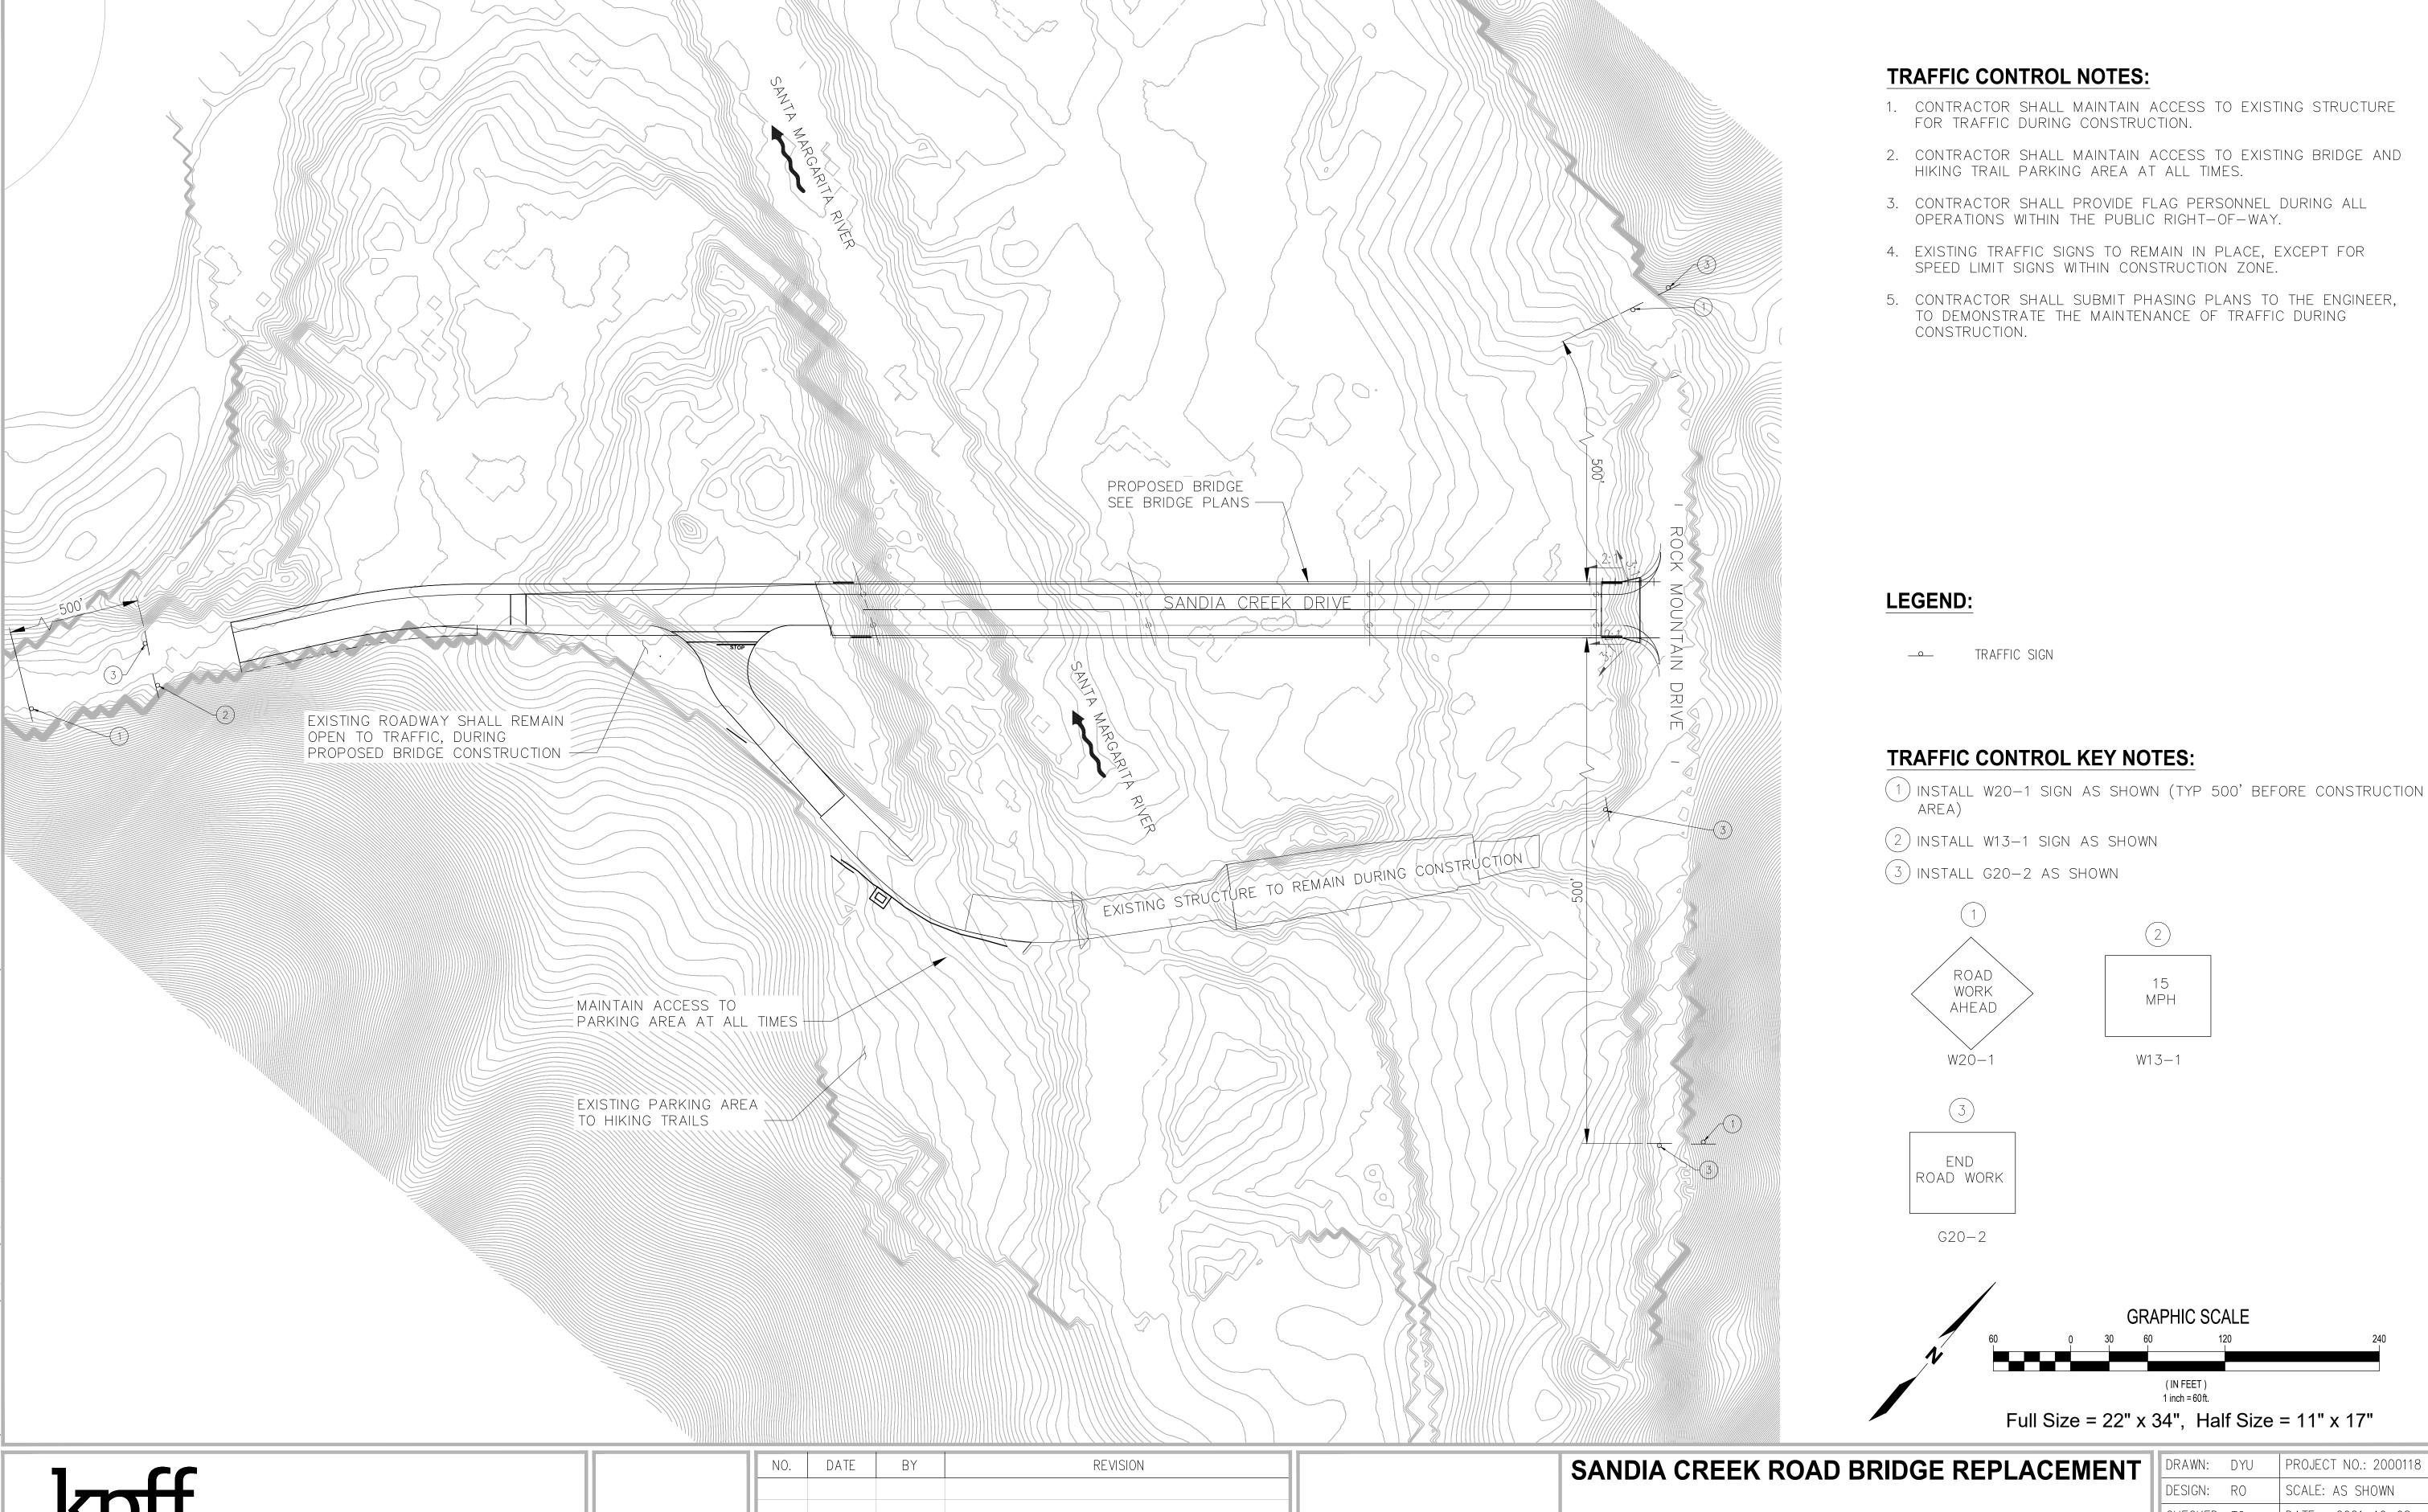
Seattle, Washington 98101 (206) 382-0600 Fax (206) 382-0500

EROSION CONTROL PLAN

PROJECT NO.: 2000118 DESIGN: RO SCALE: AS SHOWN CHECKED: TG DATE: 2021-10-08 DRAWING NO. **05** of **54** SHEET NO.

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SANDIA CREEK ROAD BRIDGE REPLACEMENT

TRAFFIC CONTROL PLAN

TRAFFIC SIGN

ROAD WORK

AHEAD

W20-1

END ROAD WORK

G20-2

MPH

W13 - 1

(IN FEET) 1 inch = 60 ft.

Full Size = 22" x 34", Half Size = 11" x 17"

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