CONCEPTUAL PLANNING SUBMITTAL PACKAGE

MONTIEL OFFICE BUILDING

2355 & 2375 Montiel Road, San Marcos, California 92069







If this sheet is not 30" by 42" it is a reduced print, scale accordingly

41951 REMINGTON AVE, SUITE 250 TEMECULA, CALIFORNIA 92590 (TEL) 951 - 296 - 2828

www.bdg-architects.com ARCHITECT OF RECORD

PROFESSIONAL SEAL

CONSULTANTS

REVISIONS

APPROVAL

PROJECT PHASE

CONCEPTUAL **PLANNING SUBMITTAL**

FOR

MONTIEL OFFICE BUILDING

2375 and 2355 MONTIEL ROAD SAN MARCOS, CALIFORNIA 92069

PROJECT NAME

18116 PROJECT NUMBER

COVER SHEET

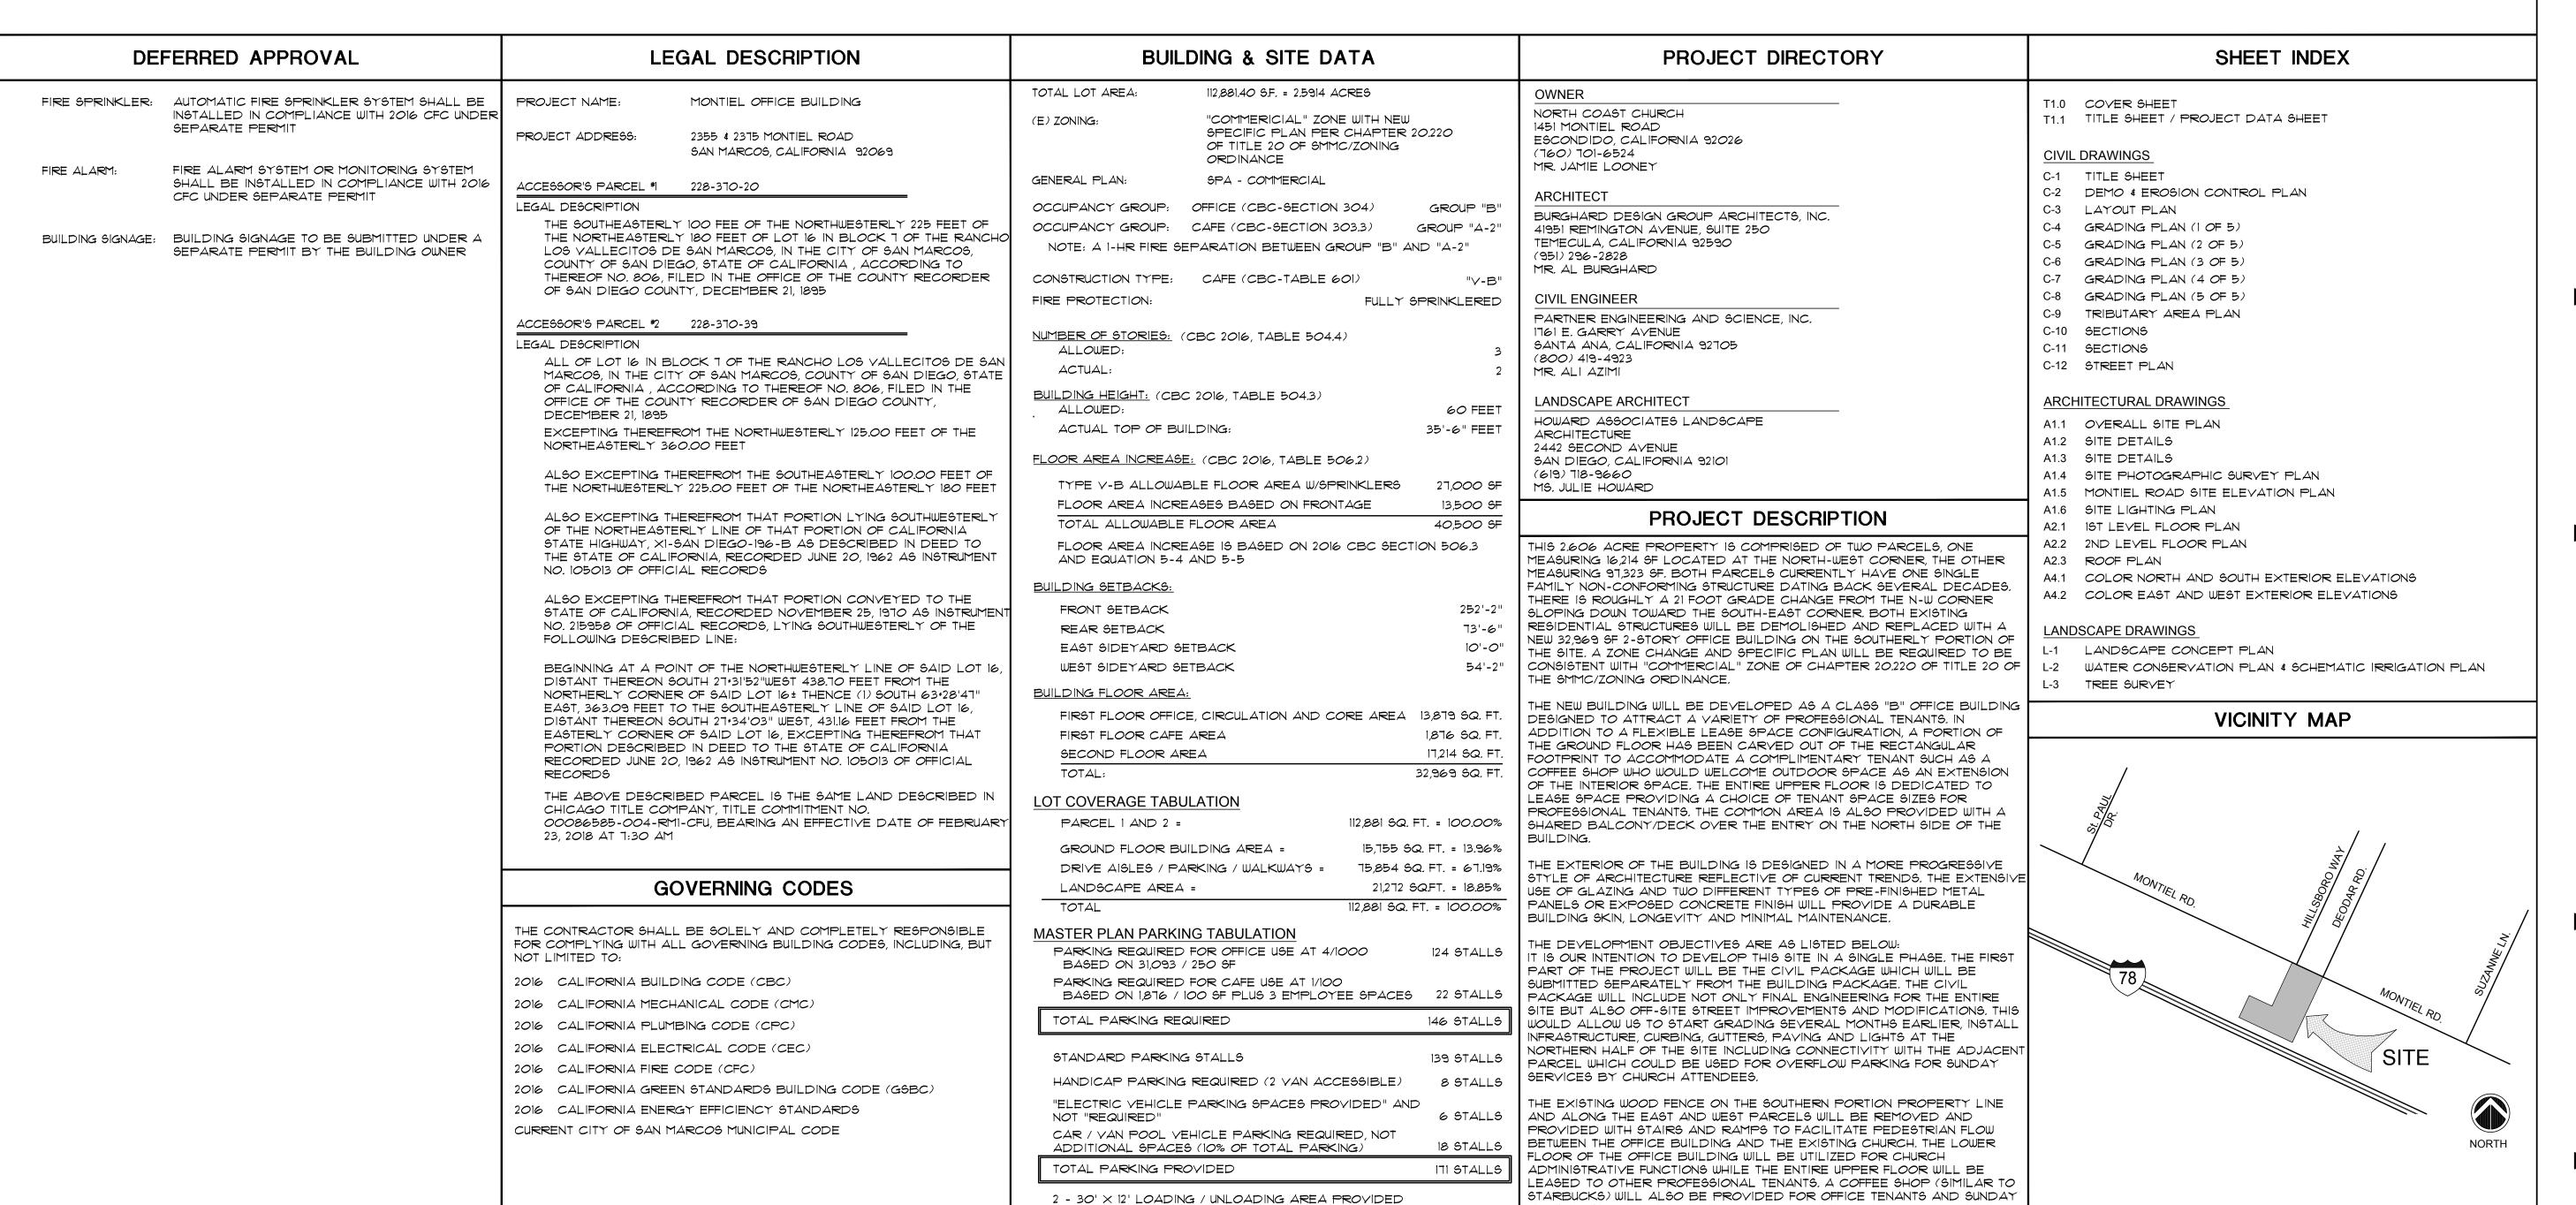
SHEET TITLE

SCALE DATE

CONCEPTUAL PLANNING SUBMITTAL PACKAGE

MONTIEL OFFICE BUILDING


2355 & 2375 Montiel Road San Marcos, California 92069



1 - 9 BIKE RACK PROVIDED

WORSHIP SERVICE. THERE WILL BE NO COOKING OR FOOD PREP IN THE

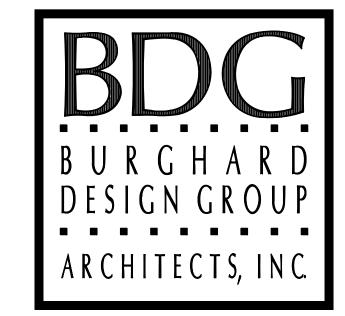COFFEE SHOP AS ALL GOODS WILL BE PRE-PACKAGED ITEMS.



41951 REMINGTON AVE, SUITE 250 TEMECULA, CALIFORNIA 92590 (TEL) 951 · 296 · 2828

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ARCHITECT OF RECORD

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FOE

MONTIEL OFFICE BUILDING

2375 and 2355 MONTIEL ROAD SAN MARCOS, CALIFORNIA 92069

PROJECT NAME

18116
PROJECT NUMBER

TITLE SHEET

SHEET TITLE
T1.1

SHEET NUMBER

NTS 12 FEBRUARY 2019

SCALE DATE

- 2. Imported material shall be obtained from a legal site.
- All cut and fill slopes shall be planted with a mixture of trees, shrubs, and ground cover to control erosion. Slope landscaping shall be installed as soon as practical. Irrigation systems are required and shall be installed for perpetual maintenance of the plant life used for slope stabilization in accordance with Section 17.32.170 of the City's Grading Ordinance.
- Precise locations/elevations of the existing underground utilities are not known. The Contractor shall be solely responsible for making sufficient explorations to locate all utilities and substructures whether shown on the plans or not and to protect them from any possible damage prior to and during construction. The expense of repair or replacement of said utilities and substructures shall be borne by the Contractor. Contractor shall notify the Engineer—of—Work of any potential conflicts sufficiently in time for construction changes to be made and approved.
- The Contractor shall contact the Underground Service Alert at 1—800—422—4133 at least 48 hours prior to excavating to verify the locations of underground facilities of the following utilities:

Pacific Bell/SBC San Diego Gas & Electric/Sempra

Vallecitos Water District

Cox Communications or Adelphia Communications

A Dig Alert Identification Number must be issued before a "Permit to Excavate" is valid per Government Code section 4216/4217.

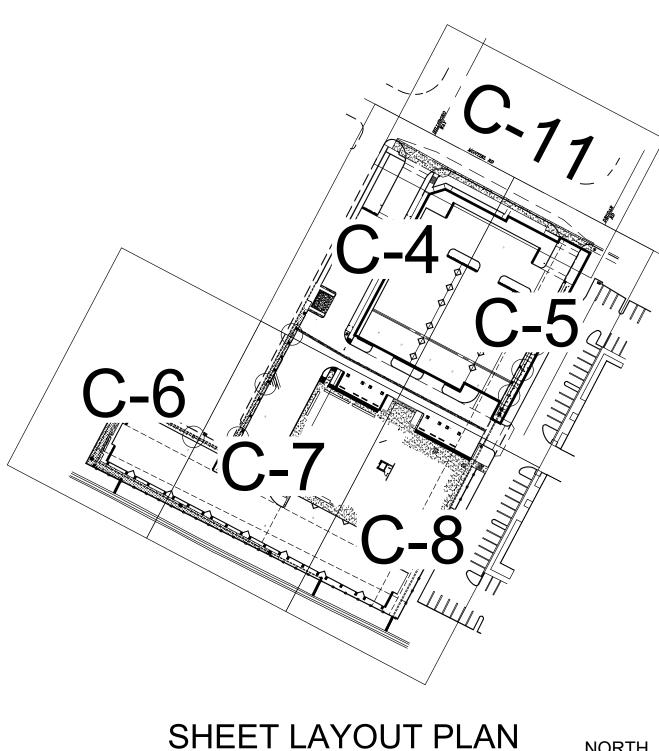
- Approval of these plans by the City does not authorize any work or grading to be performed until the property owner's permission is obtained and a valid grading permit has been issued.
- All operations conducted on the premises, including the warming up, repair, arrival, departure or running of any equipment shall be limited to the hours of 7:00 a.m. to 4:30 p.m., Monday through Friday. No work shall be performed on the premises on Saturday, Sunday, or holidays.
- All major slopes shall be shaped and trimmed as shown on the plans and rounded into existing slopes to produce a contoured transition from cut or fill faces to natural around and abuttina cut or fill slopes. All stones, roots or other waste matter exposed on excavation or embankment slopes shall be removed and disposed of off—site in a legal manner by the Contractor.
- Notwithstanding the minimum standards set forth in the City's Grading Ordinance and the approval of these grading plans, the permittee is responsible for the prevention of damage to adjacent property. No person shall excavate on land so close to the property line as to endanger any system, or any other public or private property without supporting and protecting such property from settling, cracking, erosion, silting, scour or other damage which might result from the grading described on this plan. The City will hold the permittee responsible for correction of non-dedicated improvements, which cause damage to adjacent property.
- 10. The Engineer-of-Work shall be notified when construction commences.
- 11. Contractor shall be responsible for all construction/grading of slopes, pads, street grades and infrastructure improvements according to these plans. The Engineer-of-Work shall be contacted when changes or additions made during the progress of construction or if there is a misunderstanding of these plans or field stakes and an interpretation is needed. Certification from the registered civil engineer stating that the grading has been completed per the approved plan, and the compaction report from the geotechnical engineer on any required fill areas shall be provided prior to building permits being issued.
- 12. Minimum 90% compaction is required in all on—site fill areas with a minimum of 95% compaction six inches (6") below finished subgrade in a public street.
- 13. All trench excavation and backfill in the public right_of_way shall conform to the requirements of the City's Street Excavation Ordinance No. 2003—1196 subject to approval from the Public Works
- 14. Contractor shall be responsible for protecting any monumentation and/or benchmarks. Any monumentation and/or benchmarks, which are disturbed or destroyed by construction, shall be replaced at the Contractor's expense. Such points shall be referenced and replaced with appropriate monumentation by a licensed land surveyor or a registered civil engineer authorized to practice land surveying. A Corner Record or Record of Survey, as appropriate, shall be filed by the licensed land surveyor or registered civil engineer as required by the Land Surveyor's Act.
- 15. Dust control measures, such as the periodic wetting down of the bare and exposed areas, shall be utilized at all times during construction to the satisfaction of the Public Works and/or Building
- 16. All work shown on these plans to be completed in accordance with City Grading Ordinance Chapter
- 17. All grading shall be supervised by an individual appropriately licensed under the Business and Professions Code.
- 18. The Contractor is advised that he is responsible for maintaining the adjoining public streets and rights—of—way in a clean and dust free condition within the limitation of the City Municipal Code Section 14.15.030 "Illicit Discharges Prohibited." This section of the Code prohibits the "washing down" of a street into a public storm drain. The continuous use of street sweeping machines may be advisable.
- 19. The Contractor agrees that he shall assume sole and complete responsibility for job site conditions during the course of construction of this project, including the safety of all persons and property. This requirement shall apply continually and not be limited to normal working hours. The Contractor shall defend, indemnify and hold the owner, the engineer and the City harmless from any and all liability, real or alleged, in connection with the performance of work on this project excepting for liability arising from the sole negligence of the owner, engineer or City.
- 20. A permit must be obtained from the San Marcos Fire Department prior to any blasting. Separate City permits are required prior to any construction, excavation, storage of materials or any other
- 21. A construction, excavation or encroachment permit will be required for any work within the City
- 22. Handicapped parking space(s) shall have a maximum slope not exceeding 2% in any direction.
- 23. Fire Hydrants shall be as follows:
 - Residential "single family detached dwellings" Jones 3700 or Clow 2050, one 4" and
 - Multi-Residential, commercial & Industrial Jones 3775 or Clow 2065, two 4" and one 2 ½" outlets.

PRIVATE WATER/SEWER NOTES


- 1. Private on—site water lines are permitted and inspected under seperate permit and are shown on these plans for informational purposes only.
- 2. Private on—site Fire limes are permitted and inspected under seperate permit and are shown on these plans for informational purposes only.
- 3. Trenching and backfill operation for private fire, water, and sewer lines shall be observed by the Public works inspection for general conformance with the geotechnical specifications. Trenches shall aslo be subject to inspection by the permitting departement for additional requirements.

General Notes:


1. Contractor will be responsible for the repair of all damages incured as a direct result of constuction activities. Prior to the final acceptance and approval of improvements shown on these plans all repair and rehabilitation will be done to facilities disrupted by construction activities. All repair will be in conformance tot he City of San Marcos Standards.



SCALE: 1" = 100'

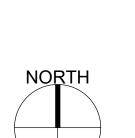

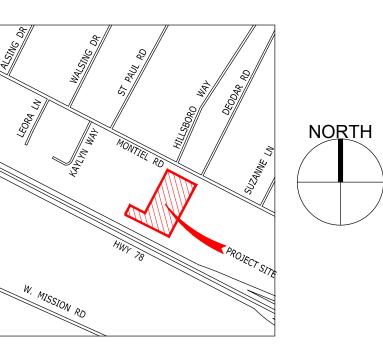CITY OF SAN MARCOS PRELIMINARY GRADING PLANS FOR 2355 AND 2375 MONTIEL ROAD



VICINITY MAP

SITE ADDRESS AND ASSESSOR PARCEL NUMBERS

2355 & 2375 MONTIEL ROAD SAN MARCOS, CA 92069 ASSESSOR PARCEL NO(S): 228-370-20-00 & 228-370-39-00

OWNER

TOMMY VARGAS AND PETER VARGAS 10173 VIA MARMOL ESCONDIDO, CA 92026 TELEPHONE NO.

TOMMY VARGAS TOMMY VARGAS

STORM WATER SUMMARY

MAINTENANCE AGREEMENT DOC #:

WDID: N/A PROJECŤ AREA: DISTURBED AREA: IMPERVIOUS AREA: STORM WATER DEVELOPMENT PROJECT TYPE: PRIORITY CITY BMP ID NO: XX THRU XX FACILITY TYPE: COMMERCIAL

DECLARATION OF RESPONSIBLE CHARGE

I HEREBY DECLARE THAT I AM THE ENGINEER OF WORK FOR THIS PROJECT, THAT I HAVE EXERCISED RESPONSIBLE CHARGE OVER THE DESIGN OF THIS PROJECT AS DEFINED IN SECTION 6703 OF THE BUSINESS ANS PROFESSIONS CODE, AND THAT THE DESIGN IS CONSISTENT WITH CURRENT STANDARDS. I UNDERSTAND THAT THE CHECK OF PROJECT DRAWINGS AND SPECIFICATIONS BY THE CITY OF SAN MARCOS IS CONFINED TO A REVIEW ONLY AND DOES NOT RELIEVE ME AS ENGINEER OF WORK OF MY REPONSIBLITIES FOR THE PROJECT DESIGN.

ALI AZIMIJIRSARAI RCE 48773 EXP. 09/30/20

GEOTECHNICAL ENGINEER CERTIFICATE

THESE PLANS HAVE BEEN REVIEWED BY THE UNDERSIGNED RELATIVE TO GEOTECHNICAL EXIST ASPECTS OF THE PLANS AND HAVE BEEN FOUND TO BE IN CONFORMANCE WITH INTENTIONS OF THE FINDINGS AND RECOMMENDATIONS CONTAINED IN THE GEOTECHNICAL REPORT BY EXISI MATTHEW MARCUS (C-81591) DATED OCTOBER 08, 2018.

SOURCE OF TOPO

FIELD SURVEY CONDUCTED BY PARTNER ENGINEERING AND SCIEMCE ON MAY 20, 2018.

HYDROLOGY/HYDRAULIC REPORT

THE HYDROLOGY/ HYDRAULIC REPORT WAS PERPARED BY PARTNER ENGINÉERING AND SCIENCE (JANUARY 2019)

BASIS OF BEARING

THE BEARINGS SHOWN HEREON ARE BASED ON THE NORTHEASTERLY RIGHT-OF-WAY LINE OF MONTIEL ROAD SHOWN AS HAVING A BEARING OF N62° 15' 00"E ON THE MAP OF RANCHO LOS VALLECITOS DE SAN MARCOS, ACCORDING TO MAP THEREOF NO. 806, FILED IN THE OFFICE OF THE COUNTY RECORDER OF SAN DIEGO COUNTY.

WORK TO BE DONE

EXISTING CABLE TV

Engineering and Science, Inc.®

THE IMPROVEMENTS CONSISTS OF THE FOLLOWING WORK TO BE DONE IN ACCORDANCE WITH THE LATEST EDITION OF THE FOLLOWING DOCUMENTS:

- 1) SAN DIEGO AREA REGIONAL STANDARD DRAWINGS
- STANDARD SPECIFICATIONS FOR PUBLIC WORKS CONSTRUCTION ("GREEN BOOK")
- CITY OF SAN MARCOS GRADING AND EXCAVATION ORDINANCE
- STATE OF CALIFORNIA DEPARTMENT OF TRANSPORTATION (CALTRANS) STANDARDS PLANS STATE OF CALIFORNIA DEPARTMENT OF TRANSPORTATION (CALTRANS) STANDARD SPECIFICATIONS
- STATE OF CALIFORNIA DEPARTMENT OF TRANSPORTATION SUPPLEMENTAL TO MUTCD
- VALLECITOS WATER DISTRICT STANDARD DRAWINGS AND SPECIFICATIONS

LEGEND

	ᄕ	GEND	
ITEM	QTY	STD DWG	SYMBOL
OPERTY LINE			— — -
SHT OF WAY LINE			R/W
PAVING (3" AC/8" CL 2 BASE)			
MOVE EXISTING PAVEMENT EPLACE WITH 3" AC/CL 2 BASE)			
ROPOSED CURB AND GUTTER	XXX LF	SDRSD G-2	
OPOSED CONCRETE SIDEWALK	XXX SF	G-7 & G-9	The state of the s
ROPOSED DRIVEWAY APROACH	XXX SF	G-14	
OPOSED PED. RAMP	XX EA	SDRSD G-27	\bigwedge
DIP WATERLINE			
RE HYDRANT	XX EA	VWD W-4 & W-5	>• <
ORM DRAIN PIPE			
TORM DRAIN TRENCH	XXXX SF	SDRSD D-60	
PE 'A-4' CLEANOUT	XX EA	SDRSD D-9	0
PE 'A' INLET	XX EA	SDRSD D-1	
PE 'B' INLET	XX EA	SDRSD D-2	0
PE 'B-1' INLET	XX EA	SDRSD D-2	0
ALL			
(ISTING CURB AND GUTTER			
SISITNG BERM			
KISTING WALL			
KISTING FENCE			
KISTING PED. RAMP			\bigwedge
KISITNG STREET LIGHT			×
KISTING WATER			———— W———
KISTING FIRE HYDRANT			
ISITNG SEWER			S
KISTING GAS			——————————————————————————————————————
XSITING TELECOMMUNICATIONS			
XISTING ELECTRICAL			E

INSPECTED AND RECOMMENDED FOR ACCEPTANCE

Public Works Inspector

CONSTRUCTION NOTES

#	ITEM	STD PLAN
1	SAWCUT EXISTING PAVEMENT	
2	CONCRETE CURB	SDRSD G-01
3	CONCRETE CURB & GUTTER	SDRSD G-02
4	ASPHALT CONCRETE PAVEMENT	
5	PORTLAND CEMENT CONCRETE PAVEMENT	
6	CONCRETE SIDEWALK	SDRSD G-07
7	CONCRETE DRIVEWAY	SDRSD G-14E
8	CONCRETE TIRE STOP	
9	LANDSCAPE	
10	INFILTRATION BASIN	
11	DETECTIBLE WARNING SURFACE	
12	THERMOPLASTIC WHITE PARKING STALL	
13	THERMOPLASTIC ADA PARKING SYMBOL	
14	THERMOPLASTIC BLUE CROSS HATCH	
15	THERMOPLASTIC WHITE CROSS HATCH	
16	6" ROUND CONCRETE FILLED STEEL BOLLARD	SDRSD W-16
17	CONCRETE GUTTER	
18	ACCESS RAMP	
19	RIP RAP ENERGY DISSIPATOR	SDRSD D-40
20	MANHOLE	SDRSD S-17
21	18" X 18" CATCH BASIN	
22	36"X36" CATCH BASIN	
23	TREE WELL	
24	BIOFILTRATION WITH UNDERDRAIN	
25	MIN. 6" DIA. PERFORATED PIPE	
26	ELECTRICAL TRANSFORMER PAD	
27	FIRE HYDRANT	SDRSD WF-01



SHEET INDEX

DESCRIPTION SHEET NO. TITLE SHEET DEMOLITION PLAN & EROSION CONTROL LAYOUT PLAN GRADING PLAN (1 OF 5) GRADING PLAN (2 OF 5) GRADING PLAN (3 OF 5) GRADING PLAN (4 OF 5) GRADING PLAN (5 OF 5) TRIBUTARY AREA PLAN SECTIONS

SECTIONS STREET PLAN

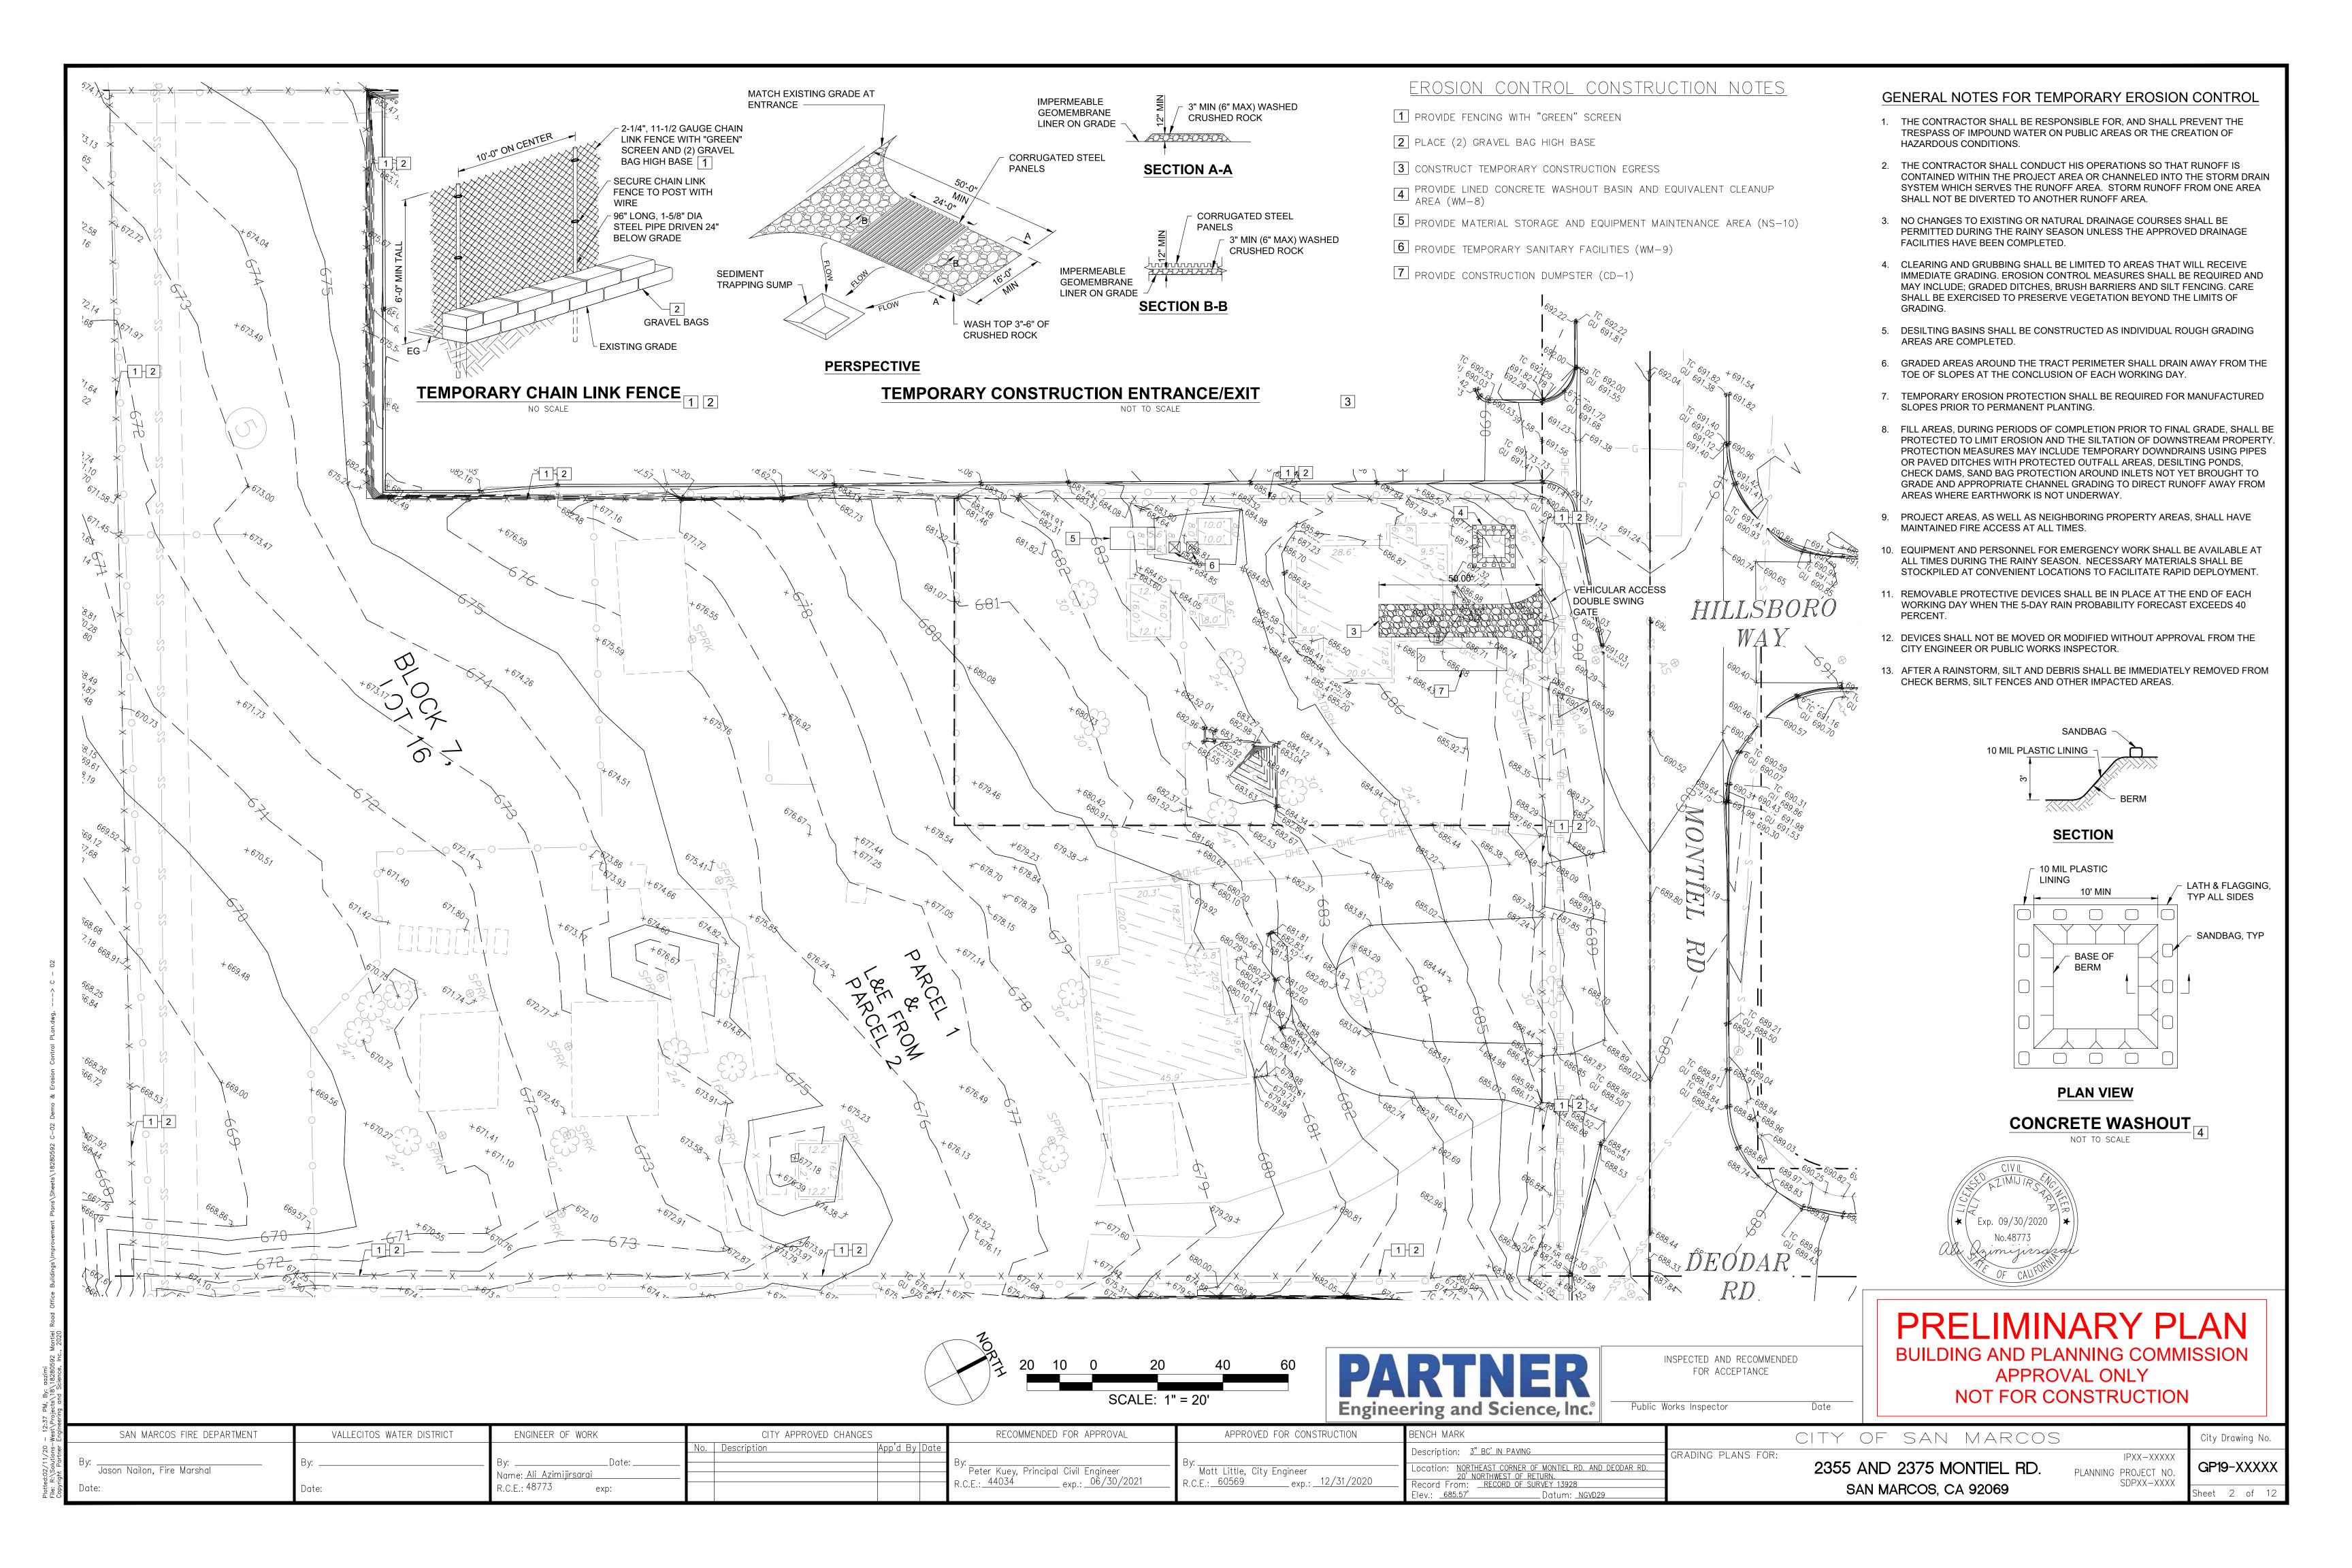
PRELIMINARY PLAN

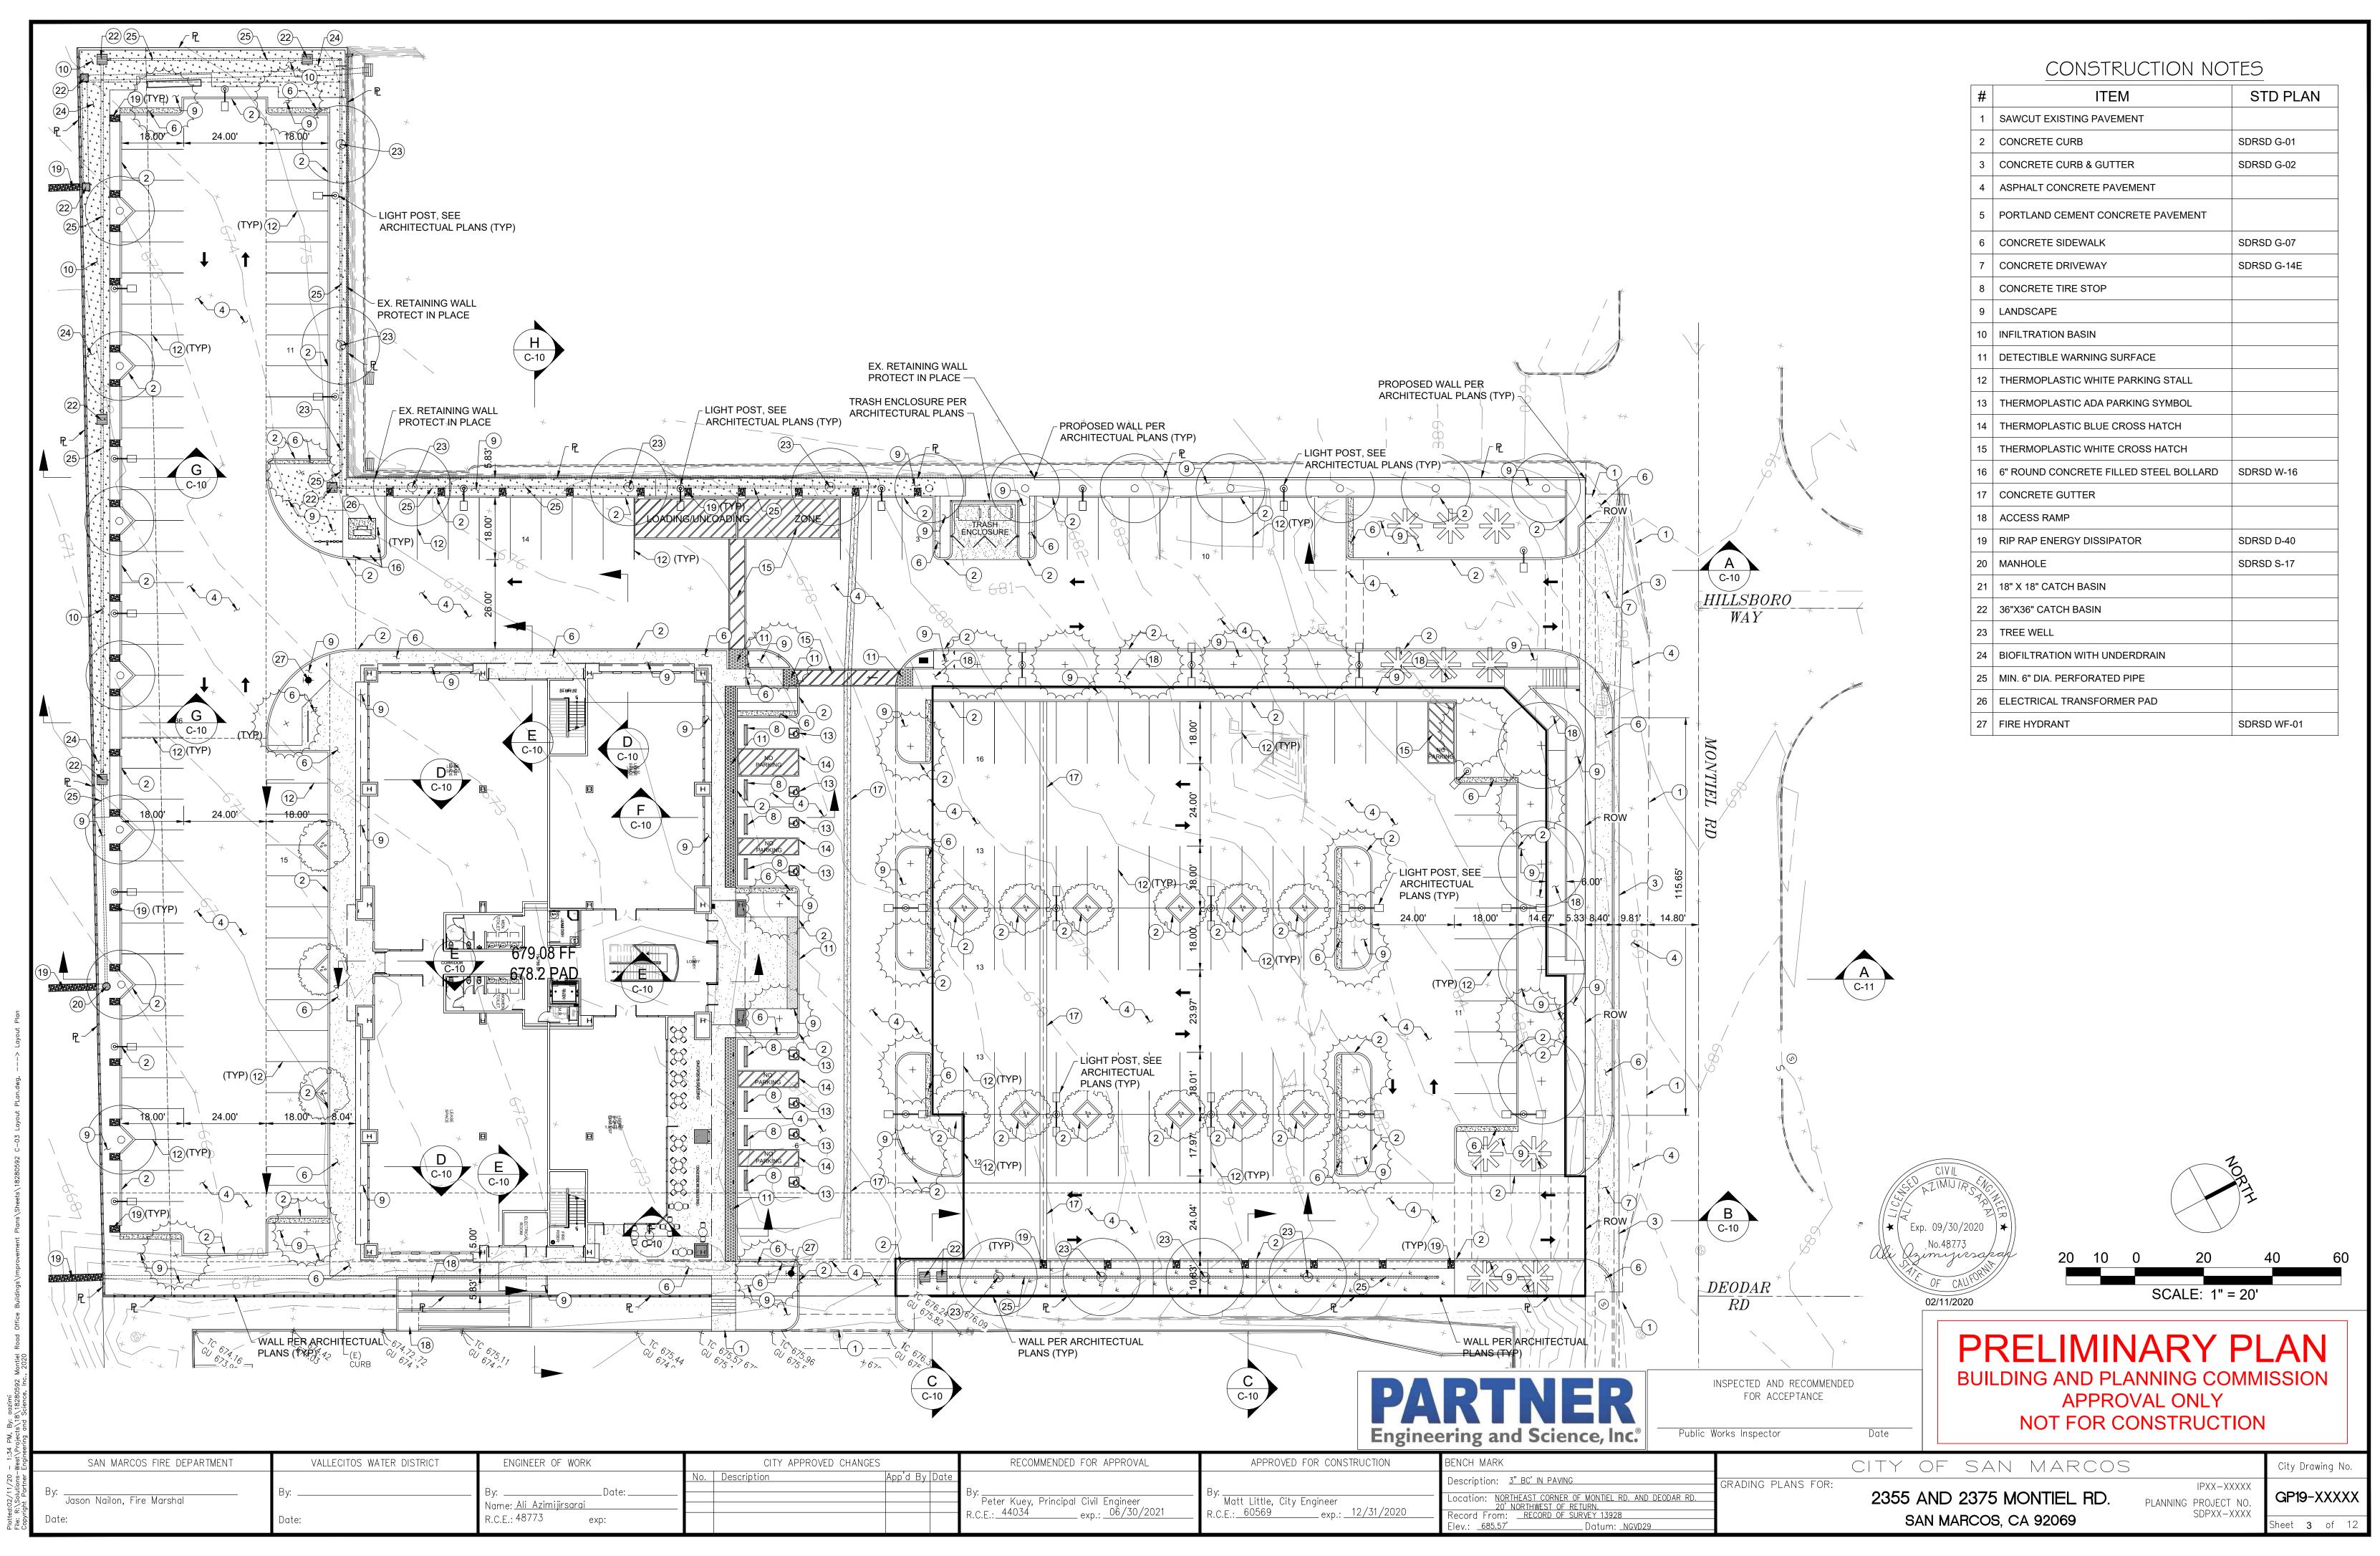
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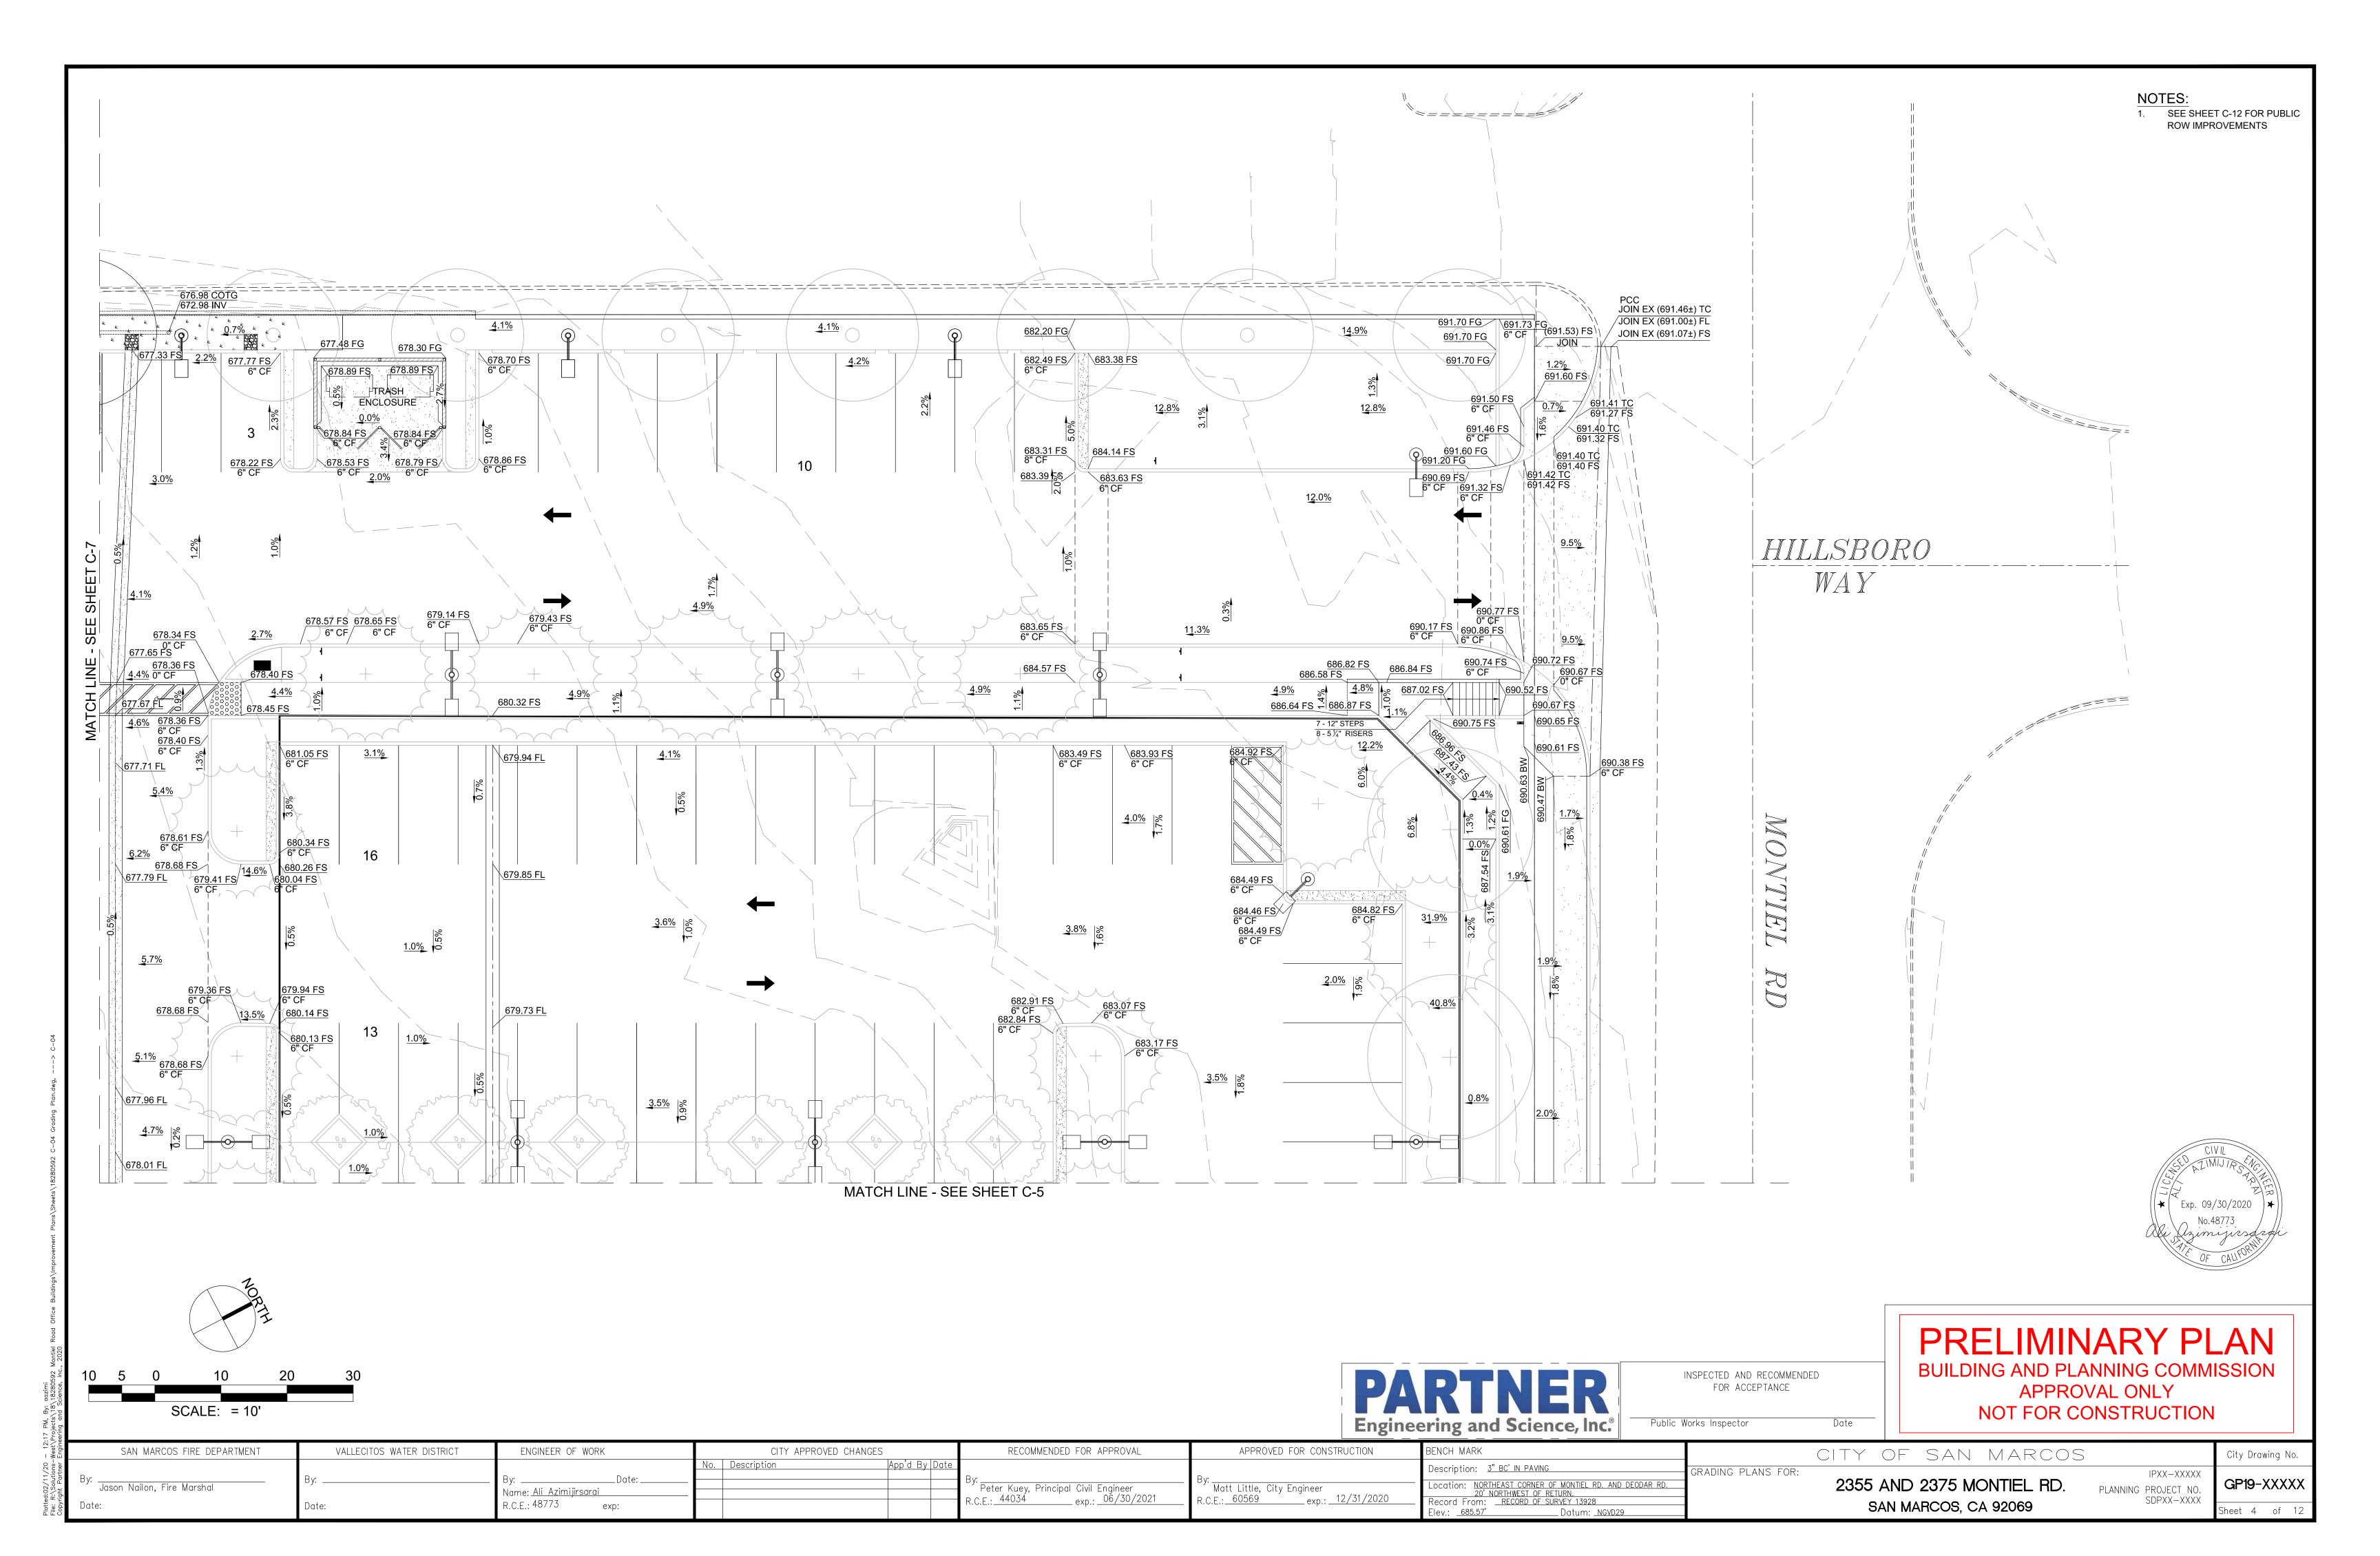
BUILDING AND PLANNING COMMISSION APPROVAL ONLY NOT FOR CONSTRUCTION


RECOMMENDED FOR APPROVAL VALLECITOS WATER DISTRICT APPROVED FOR CONSTRUCTION SAN MARCOS FIRE DEPARTMENT ENGINEER OF WORK CITY APPROVED CHANGES BENCH MARK CITY OF SAN MARCOS City Drawing No No. Description App'd By Dat Description: 3" BC' IN PAVING GRADING PLANS FOR: IPXX-XXXXX 2355 AND 2375 MONTIEL RD. GP19-XXXXX Location: NORTHEAST CORNER OF MONTIEL RD. AND DEODAR RD. Jason Nailon, Fire Marshal Matt Little, City Engineer Peter Kuey, Principal Civil Engineer PLANNING PROJECT NO. 20' NORTHWEST OF RETURN.

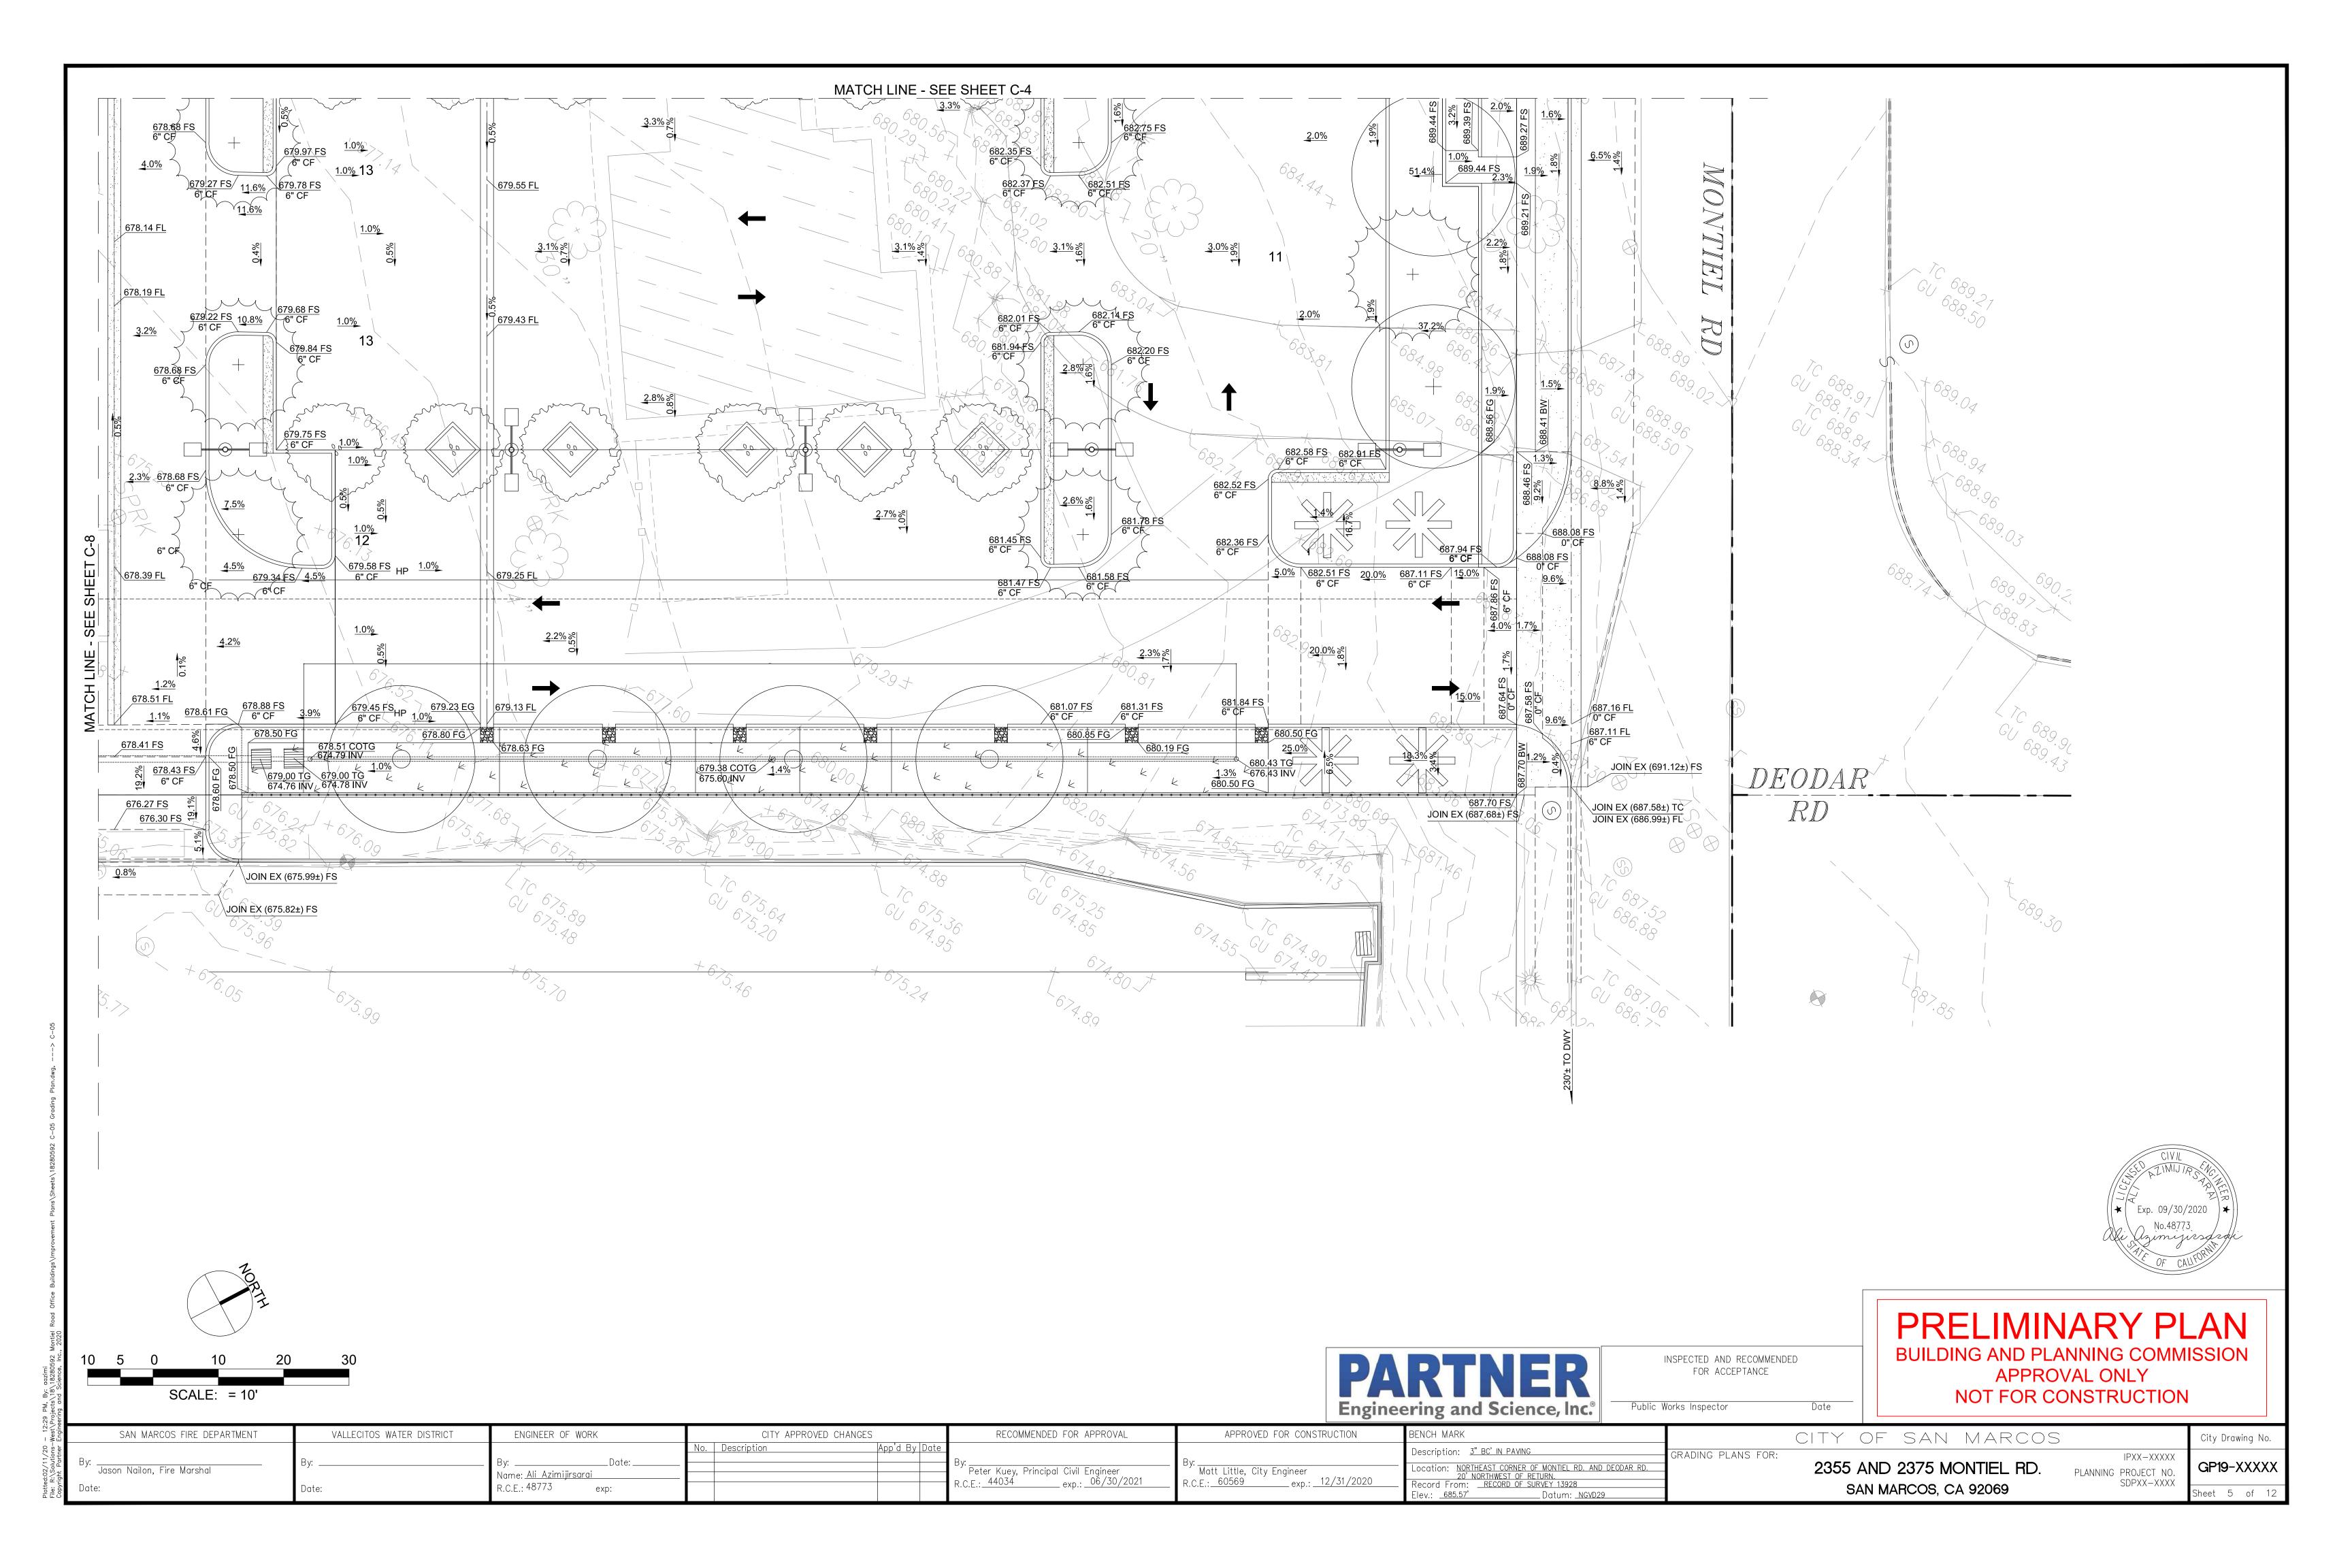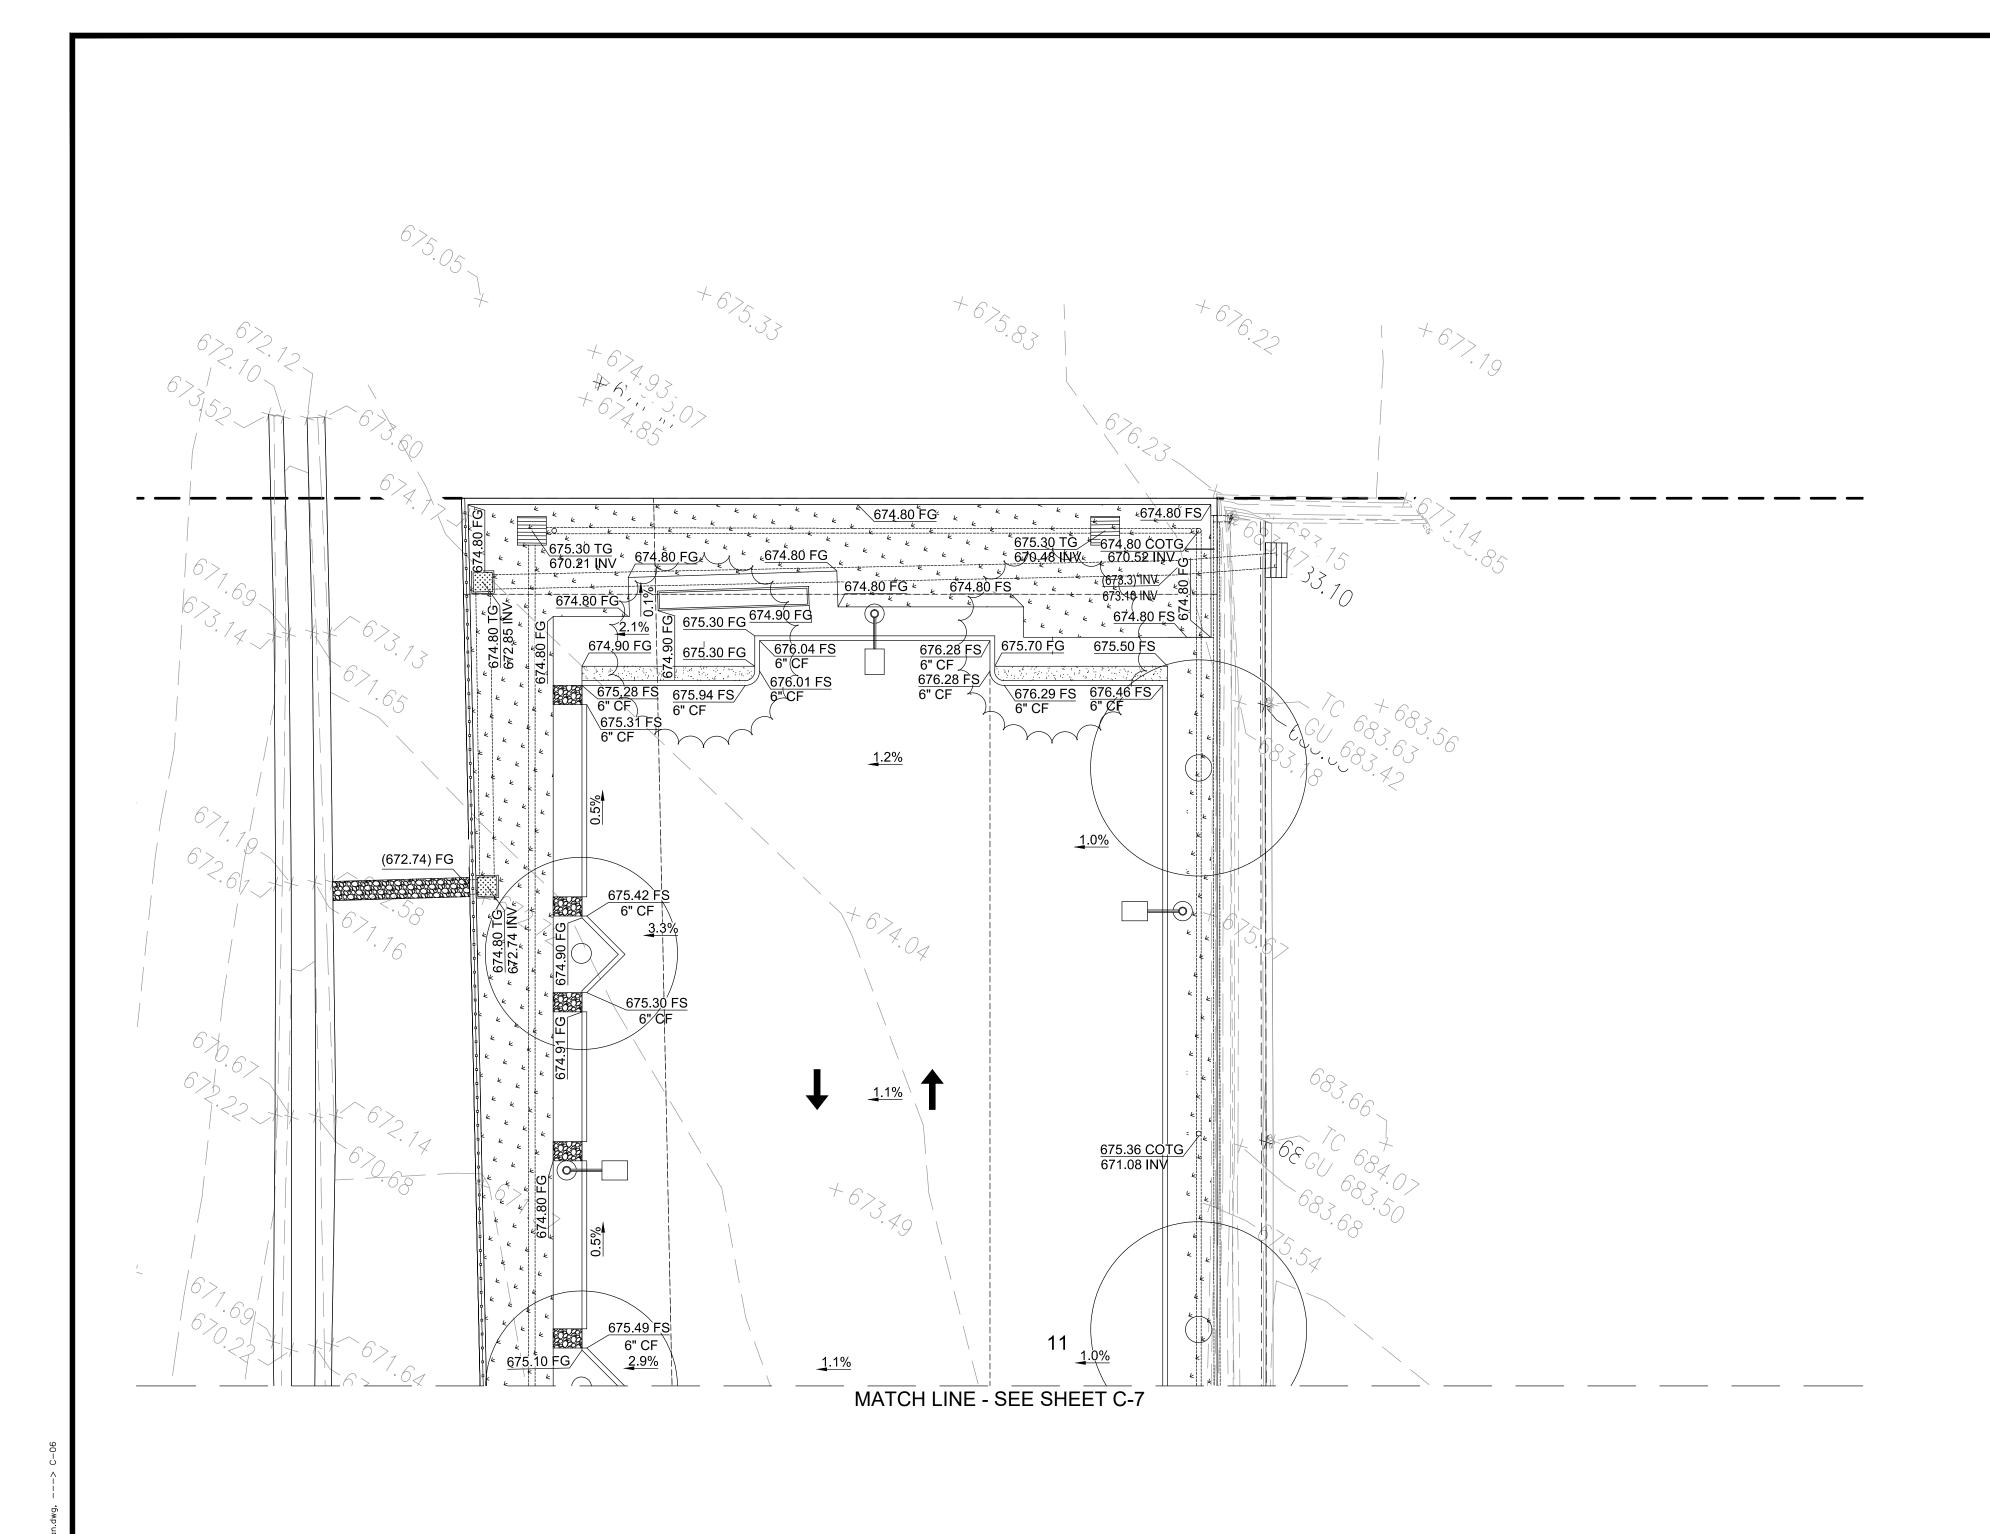
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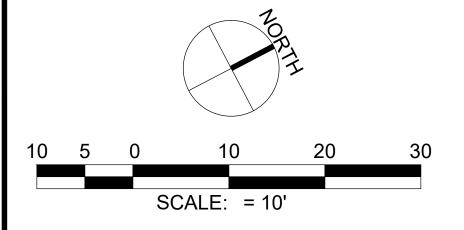












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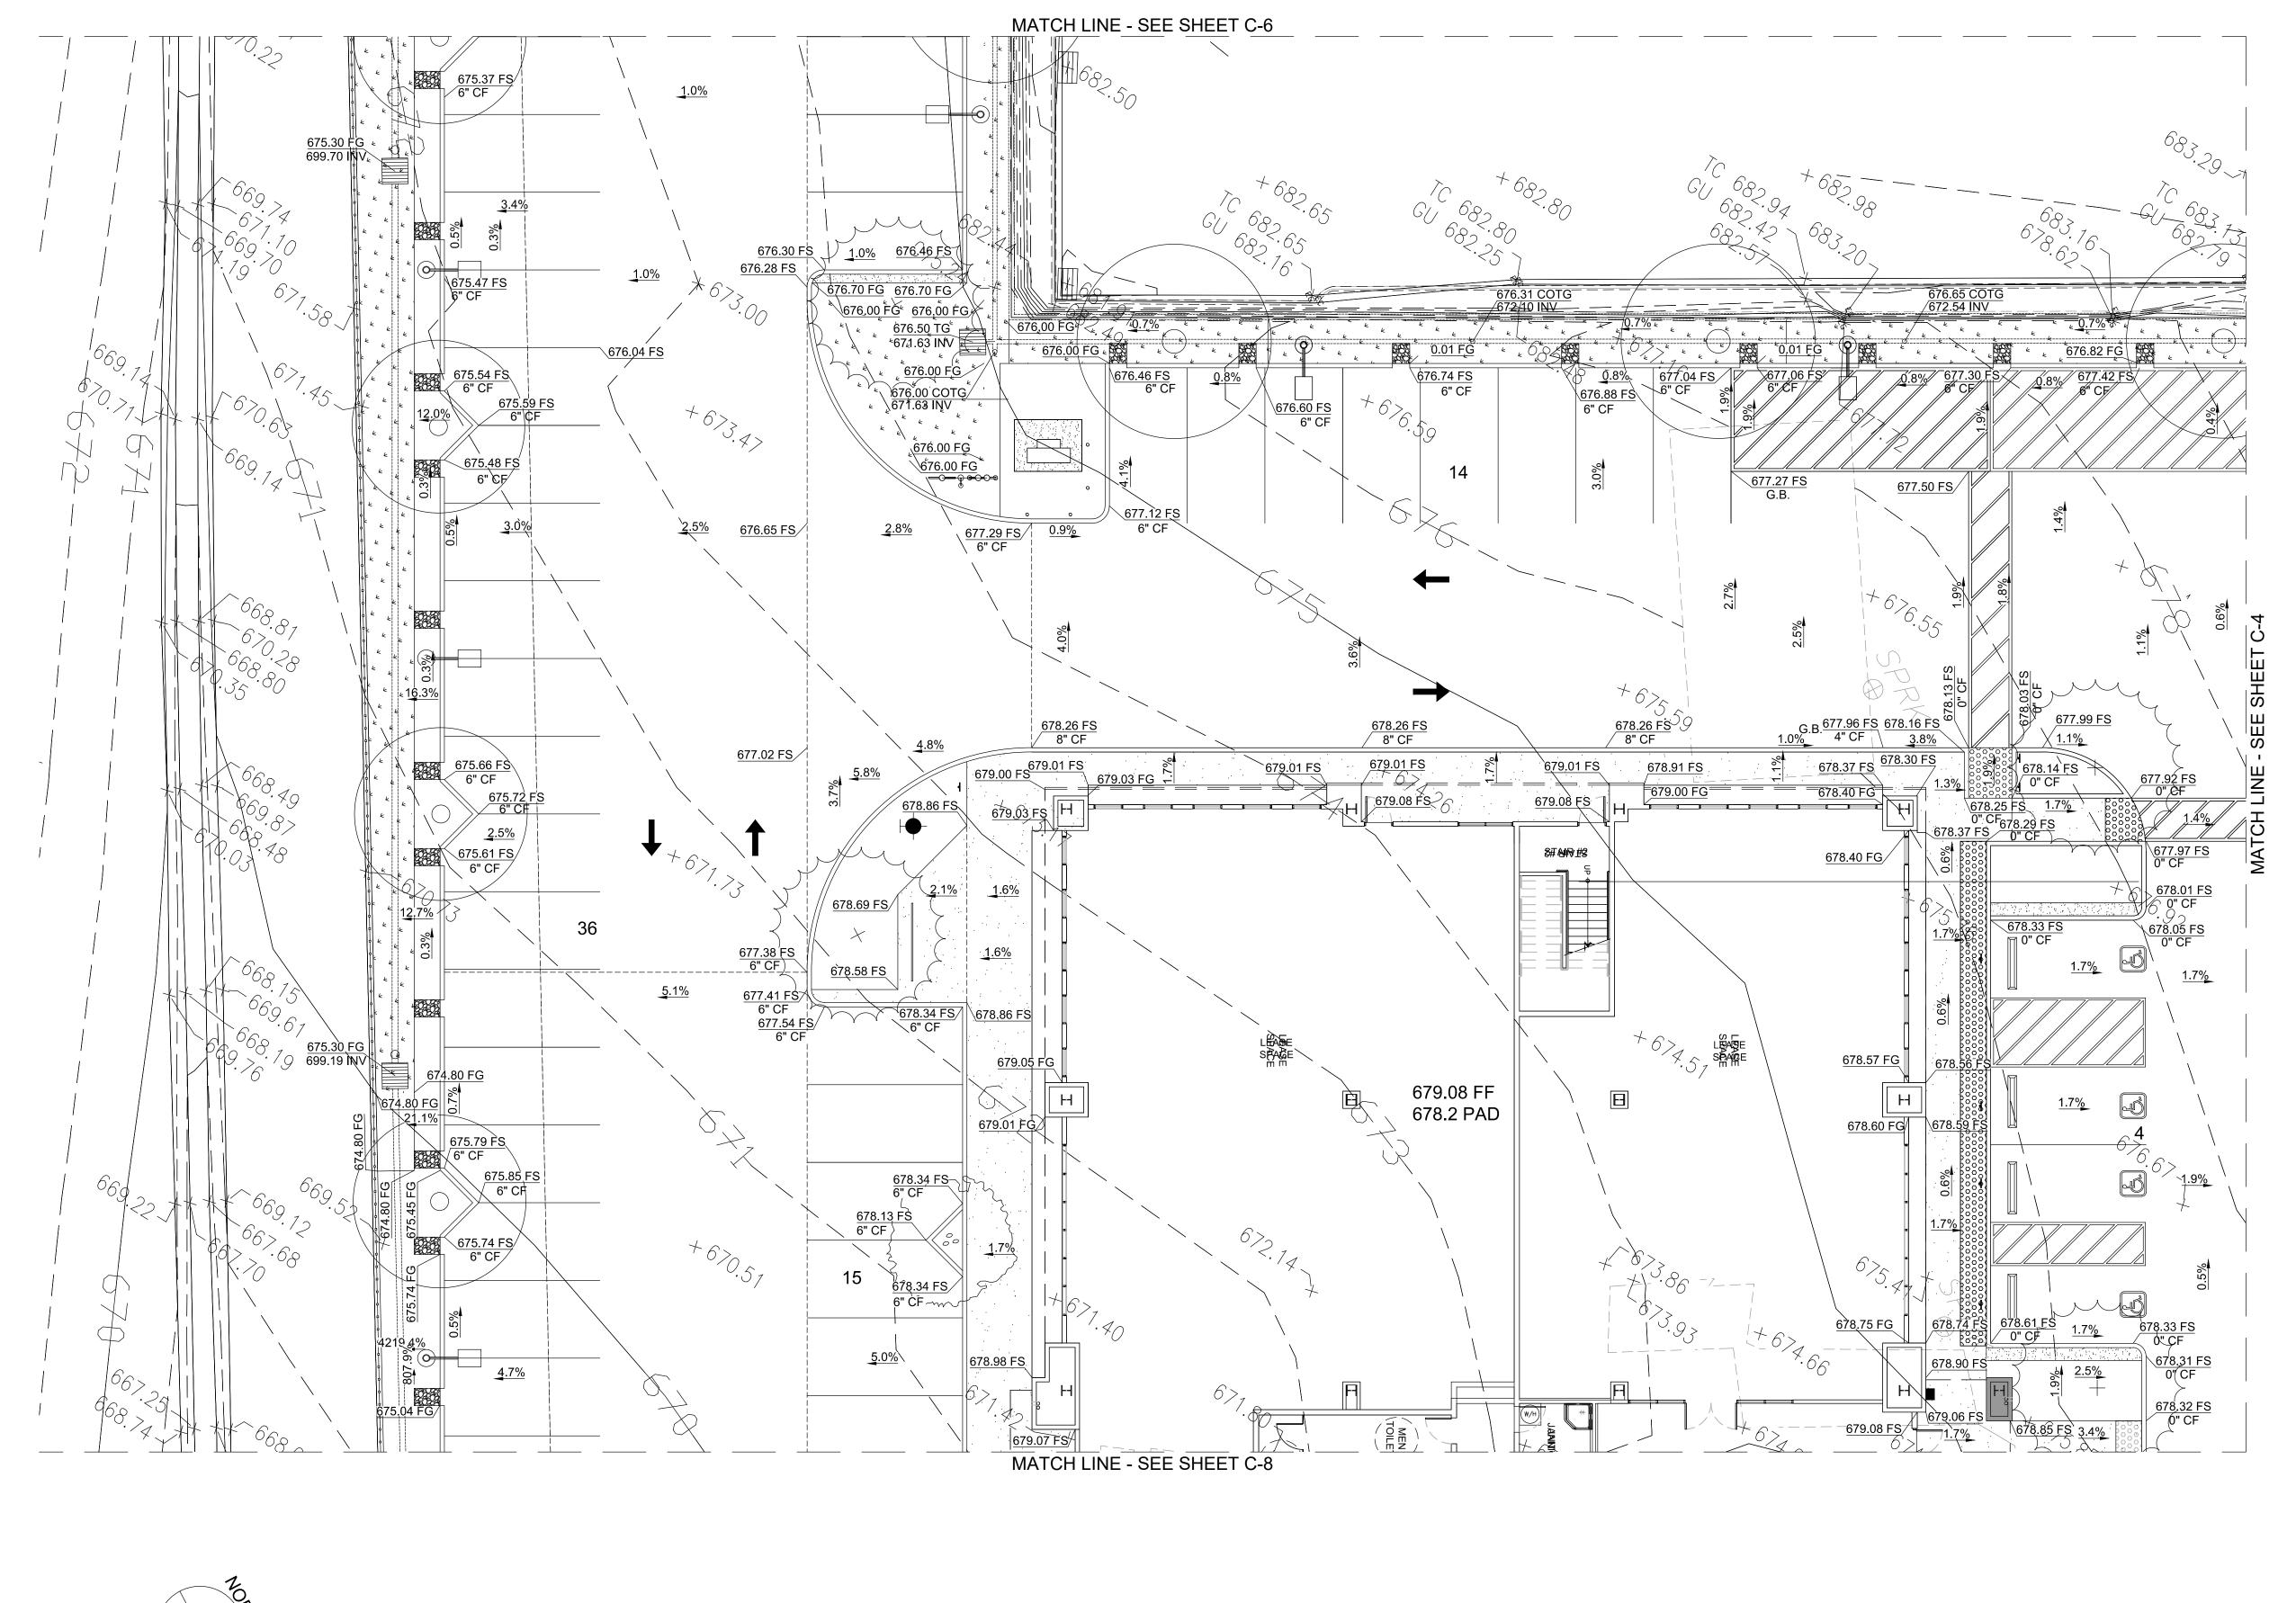
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Tolk Model Miller


PRELIMINARY PLAN BUILDING AND PLANNING COMMISSION

BUILDING AND PLANNING COMMISSION APPROVAL ONLY NOT FOR CONSTRUCTION

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West\ Engine	SAN MARCOS FIRE DEPARTMENT	VALLECITOS WATER DISTRICT	ENGINEER OF WORK	CITY APPROVED CHANGES	RECOMMENDED FOR APPROVAL	APPROVED FOR CONSTRUCTION	BENCH MARK	CITY	OF SAN MARCOS		City Drawing No.
:\Solutions— ght Partner	By:	Ву:	By:Date: Name: Ali Azimi jirsarai	No. Description App'd By Date	By: Peter Kuey, Principal Civil Engineer	By:	Description: 3" BC' IN PAVING Location: NORTHEAST CORNER OF MONTIEL RD. AND DEODAR RD. 20' NORTHWEST OF RETURN.	GRADING PLANS FOR:	AND 2375 MONTIEL RD.	IPXX—XXXXX PLANNING PROJECT NO.	GP19-XXXXX
File: R	Date:	Date:	R.C.E.: 48773 exp:		R.C.E.: 44034 exp.: 06/30/2021	R.C.E.: 60569 exp.: 12/31/2020	Record From: RECORD OF SURVEY 13928 Flev: 685.57' Datum: NGVD29	SA	AN MARCOS, CA 92069	SDPXX-XXXX	Sheet 6 of 12





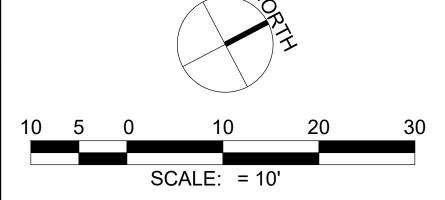

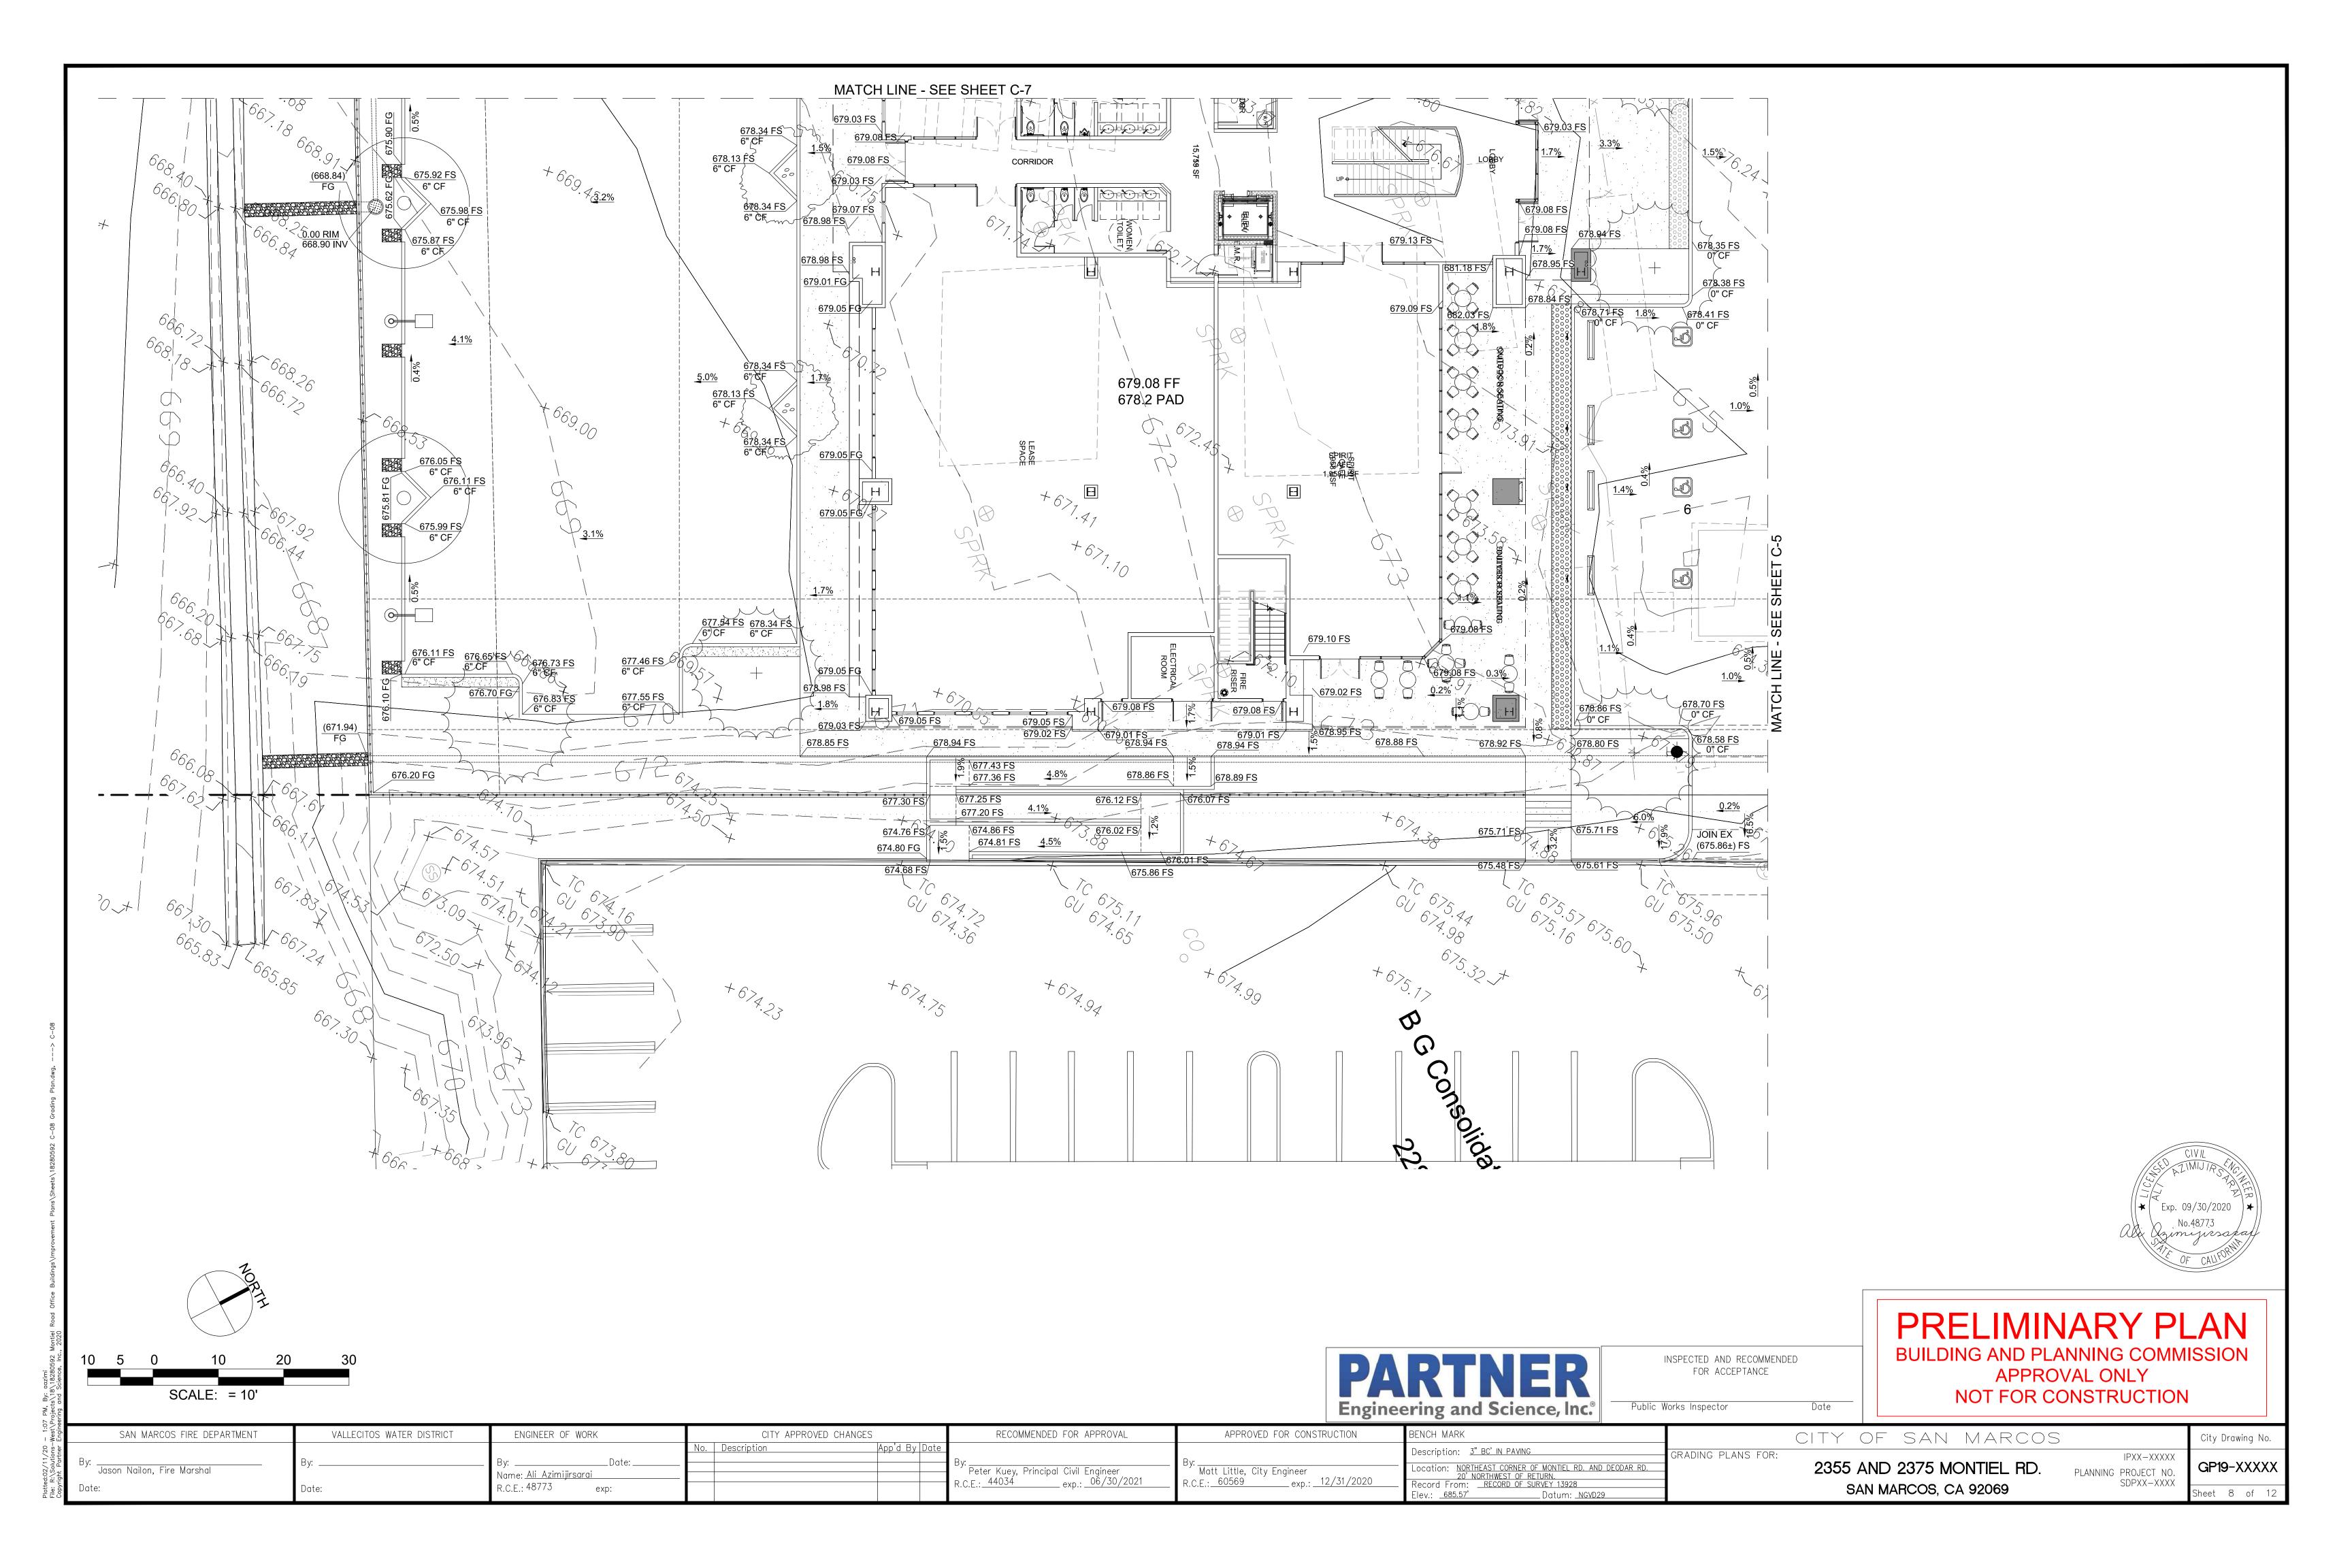
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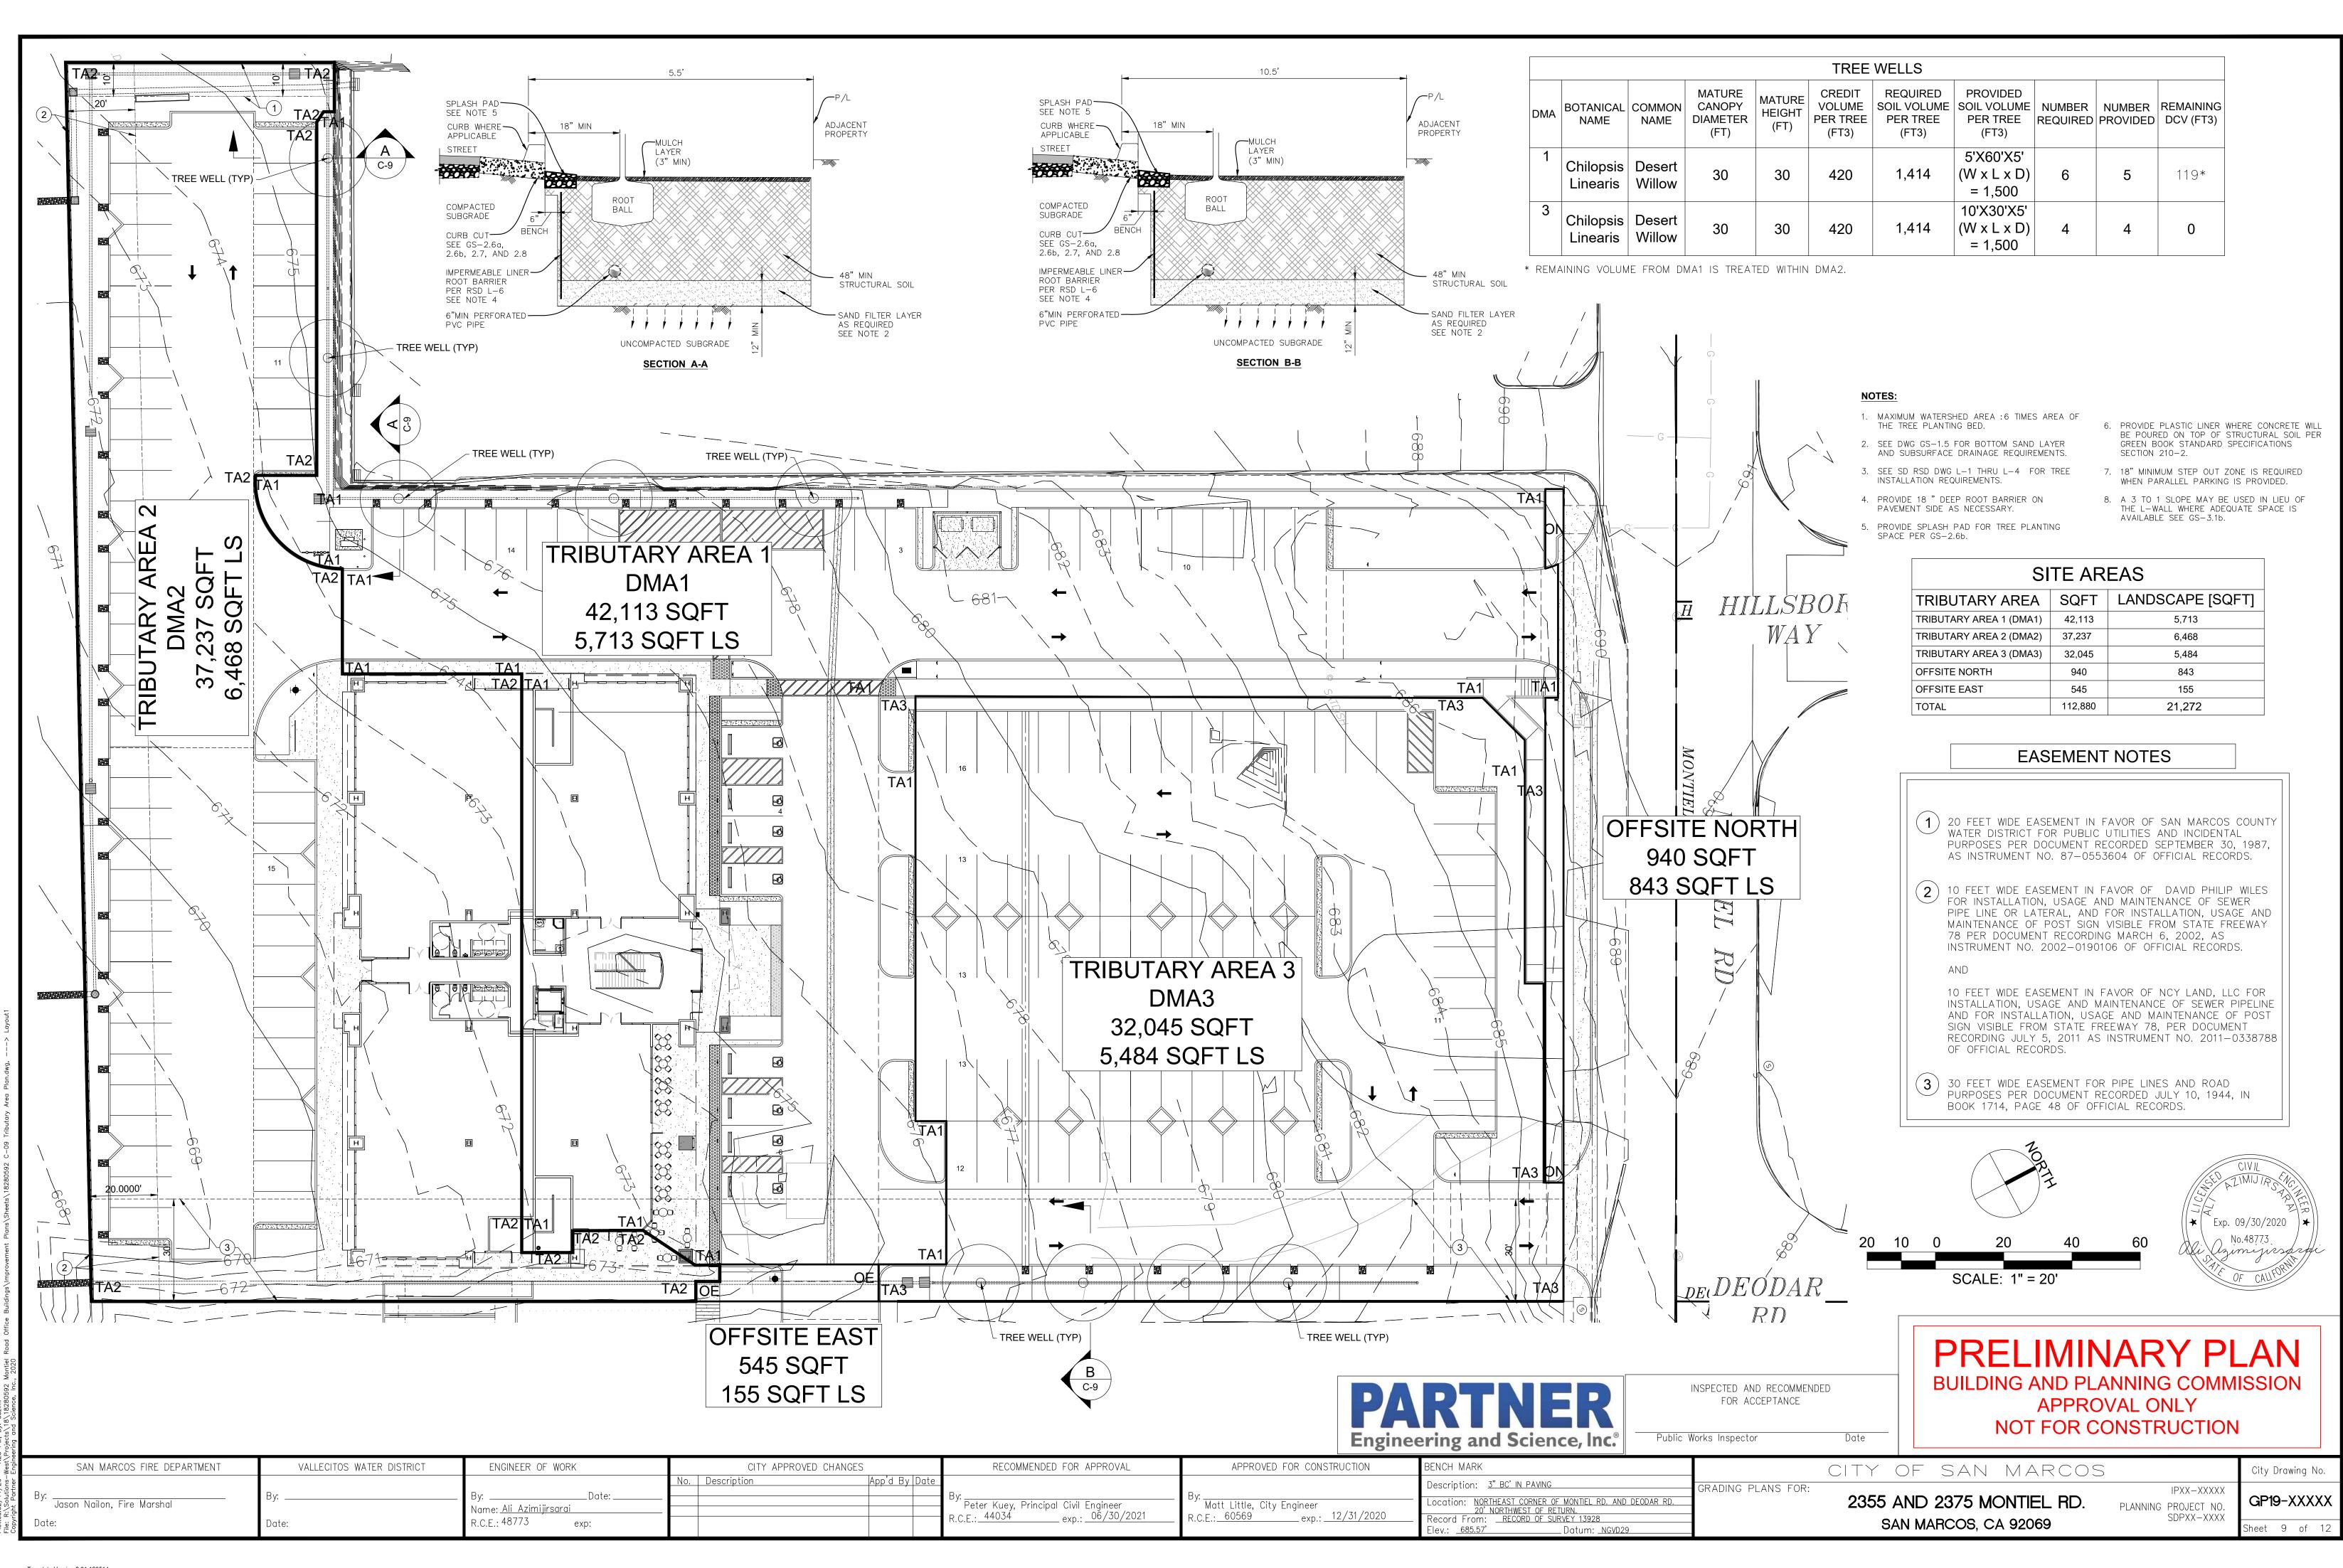
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FOR ACCEPTANCE


Public Works Inspector


PRELIMINARY PLAN BUILDING AND PLANNING COMMISSION APPROVAL ONLY NOT FOR CONSTRUCTION

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West∖ Engine	SAN MARCOS FIRE DEPARTMENT	VALLECITOS WATER DISTRICT	ENGINEER OF WORK	CITY APPROVED CHANGES	RECOMMENDED FOR APPROVAL	APPROVED FOR CONSTRUCTION	BENCH MARK	CITY OF SAN MARCOS	City Drawing No.
utions— artner	Rv.	Dve	Doto:	No. Description App'd By Date	Dur	Dva	Description: 3" BC' IN PAVING	GRADING PLANS FOR:	
R:\Solu ight Pi	Jason Nailon, Fire Marshal	Ву	Name: <u>Ali Azimijirsarai</u>		Peter Kuey, Principal Civil Engineer	Matt Little, City Engineer	Location: NORTHEAST CORNER OF MONTIEL RD. AND DEODAR RD. 20' NORTHWEST OF RETURN.	PLAINING PROJECT NO.	GP19-XXXXX
ile: r	Date:	Date:	R.C.E.: 48773 exp:		R.C.E.: 44034 exp.: 00/30/2021	R.C.E.: 60309 exp.: 12/31/2020	Record From: RECORD OF SURVEY 13928 Flav: 685.57' Datum: NCVD29	SAN MARCOS, CA 92069	Sheet 7 of 12





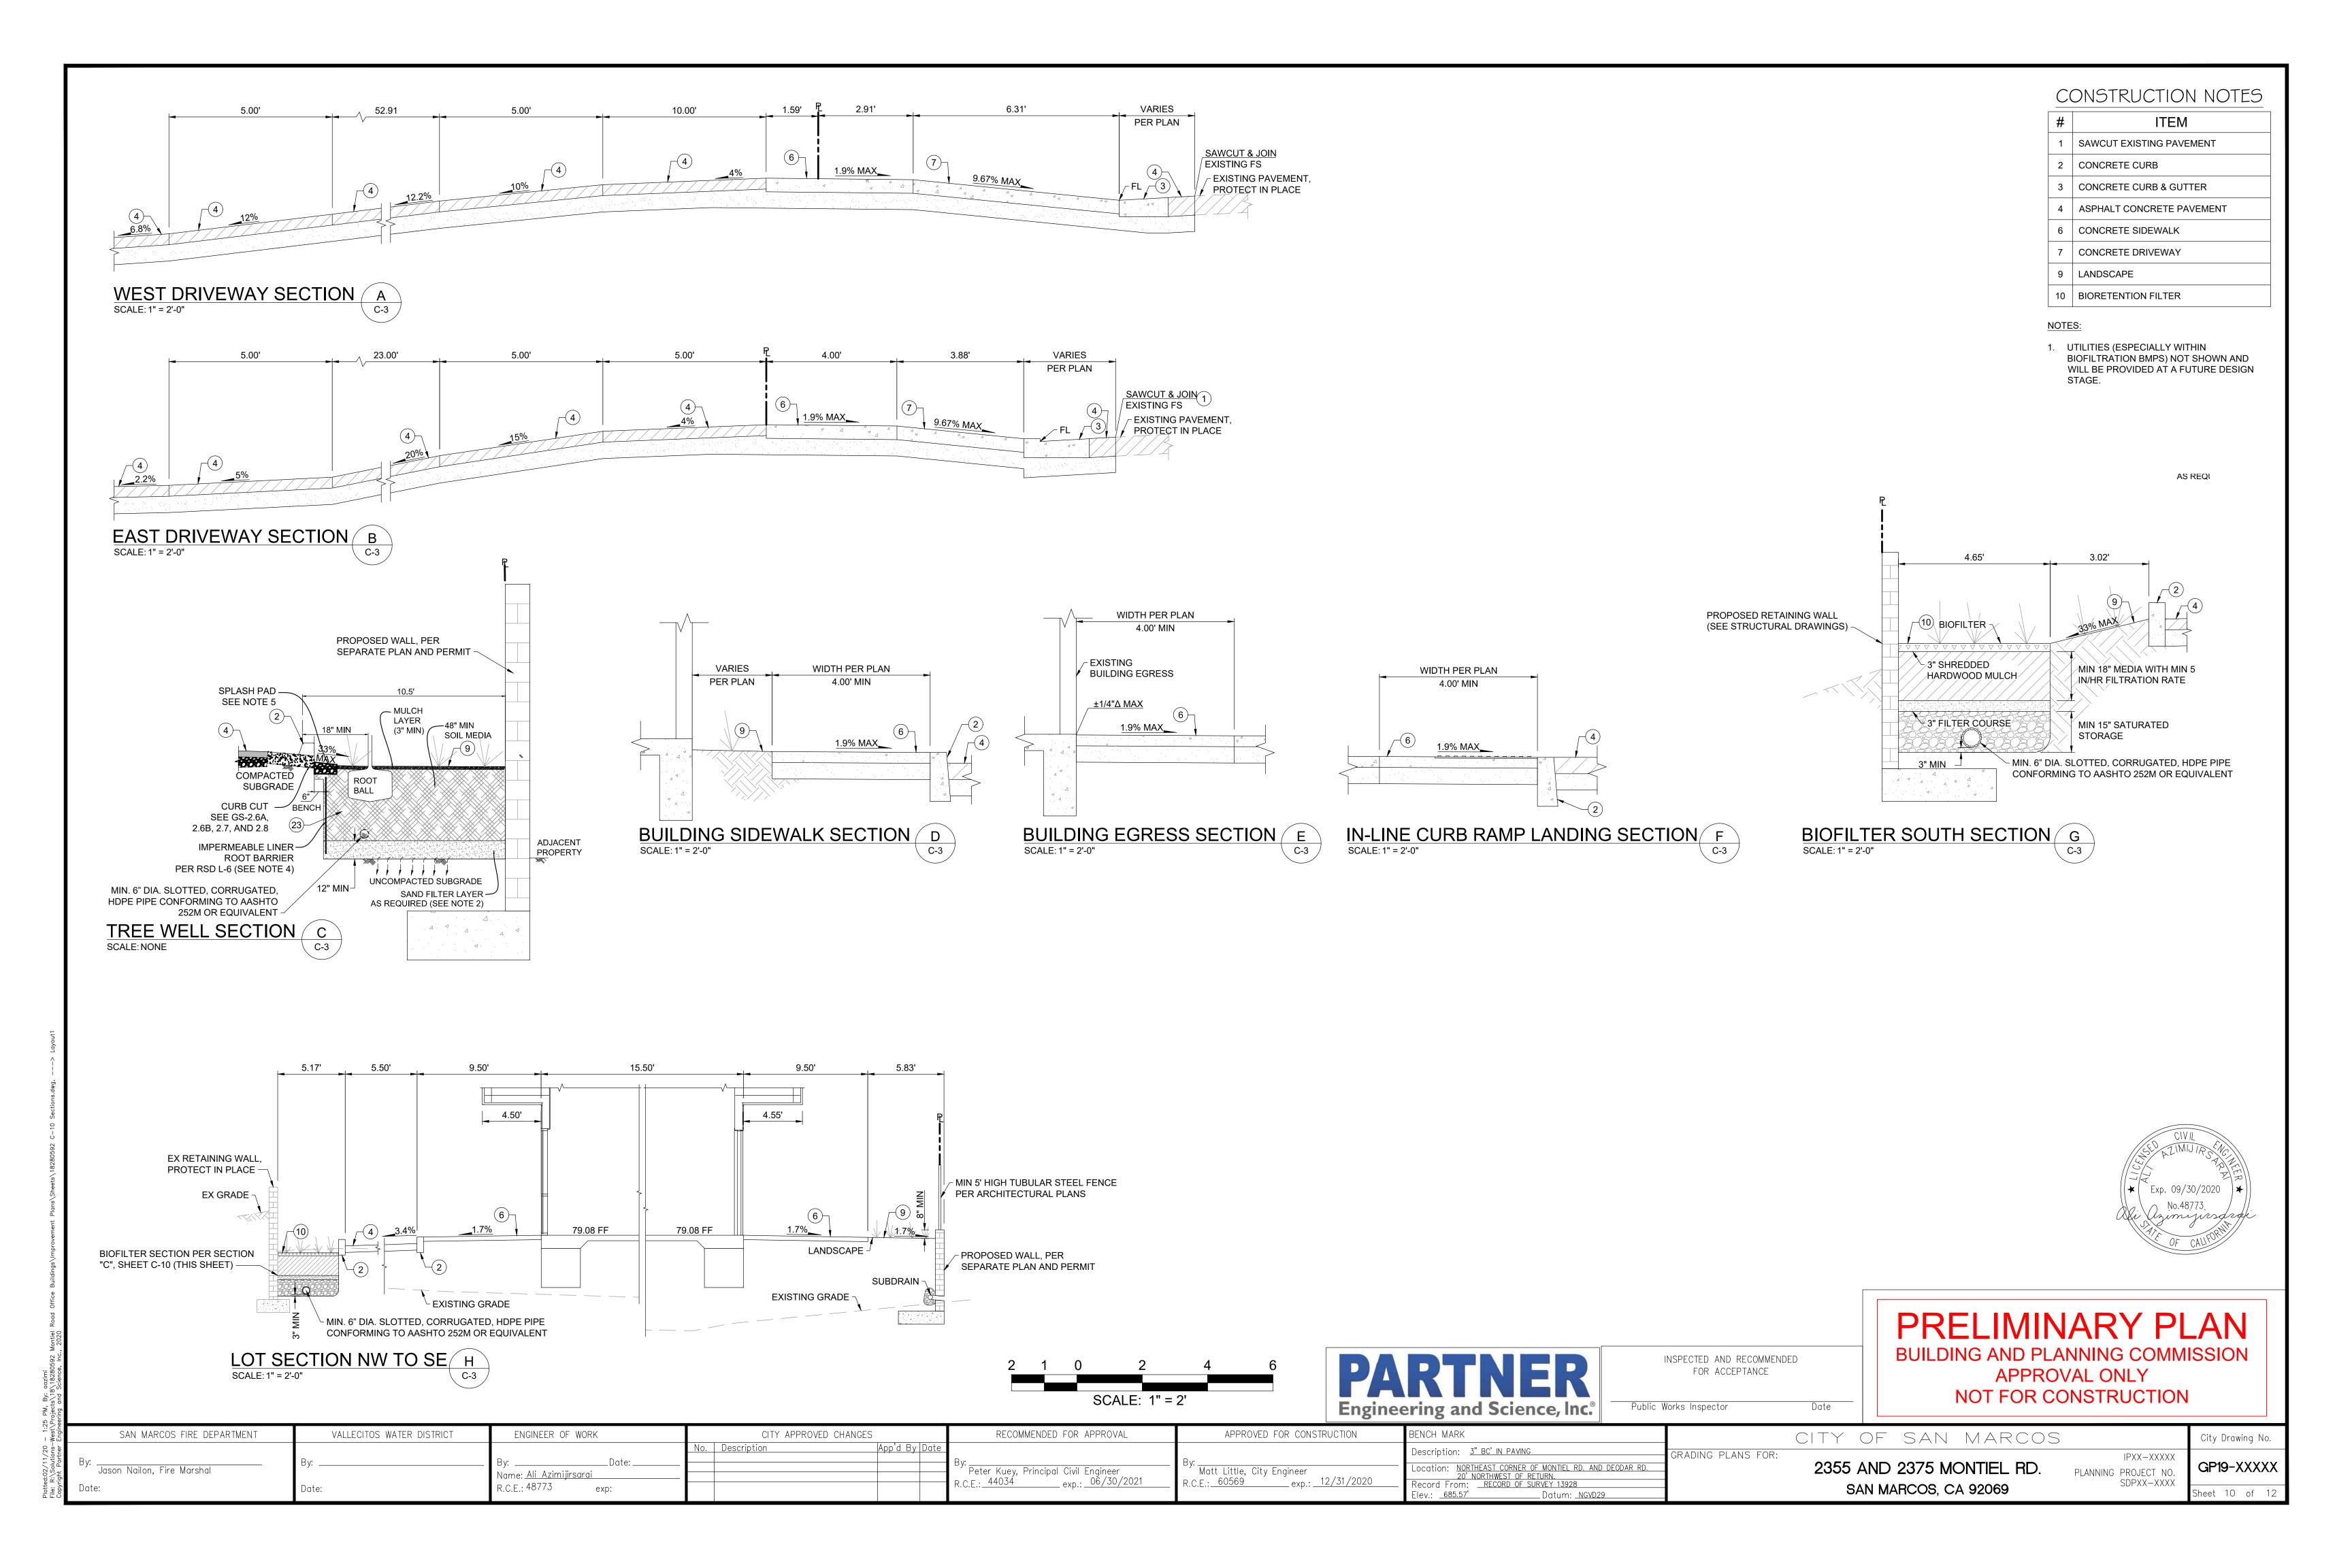


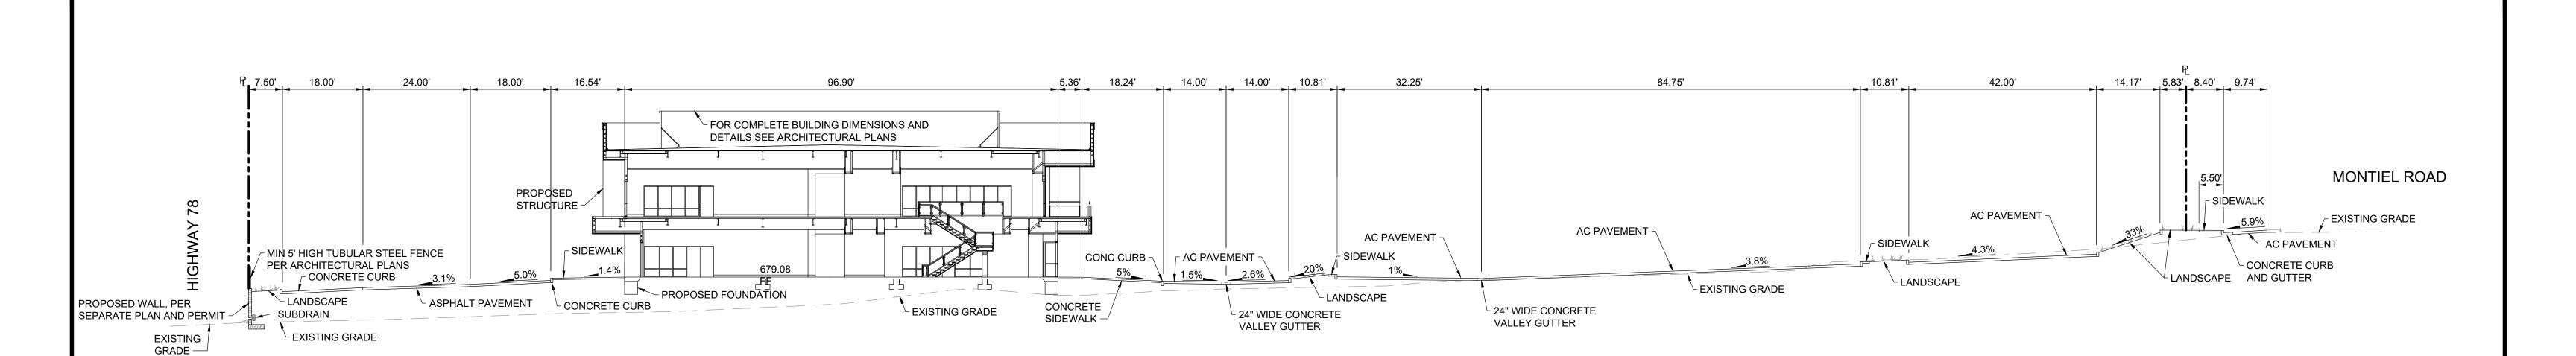

LOT SECTION SW TO NE A
SCALE: 1" = 15'-0"

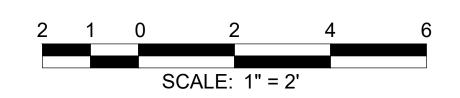C-3








INSPECTED AND RECOMMENDED FOR ACCEPTANCE

Date

Public Works Inspector

PRELIMINARY PLAN
BUILDING AND PLANNING COMMISSION
APPROVAL ONLY
NOT FOR CONSTRUCTION

-West\ Engine	SAN MARCOS FIRE DEPARTMENT	VALLECITOS WATER DISTRICT	ENGINEER OF WORK	CITY APPROVED CHANGES	RECOMMENDED FOR APPROVAL	APPROVED FOR CONSTRUCTION	BENCH MARK	CITY OF SAN MARCOS City Drawing	g No.
Copyright Partners A partners B y: A partners A pa	on Nailon, Fire Marshal	By: Date:	By:Date: Name: <u>Ali Azimijirsarai</u> R.C.E.: 48773 exp:	No. Description App'd By Date	By: Peter Kuey, Principal Civil Engineer R.C.E.: 44034 exp.: 06/30/2021	By: Matt Little, City Engineer R.C.E.:60569exp.:12/31/2020	Description: 3" BC' IN PAVING Location: NORTHEAST CORNER OF MONTIEL RD. AND DEODAR RD. 20' NORTHWEST OF RETURN. Record From: RECORD OF SURVEY 13928 Elev.: 685.57' Datum: NGVD29	GRADING PLANS FOR: 2355 AND 2375 MONTIEL RD. SAN MARCOS, CA 92069 PLANNING PROJECT NO. SDPXX-XXXX Sheet 11 of	XXX of 12

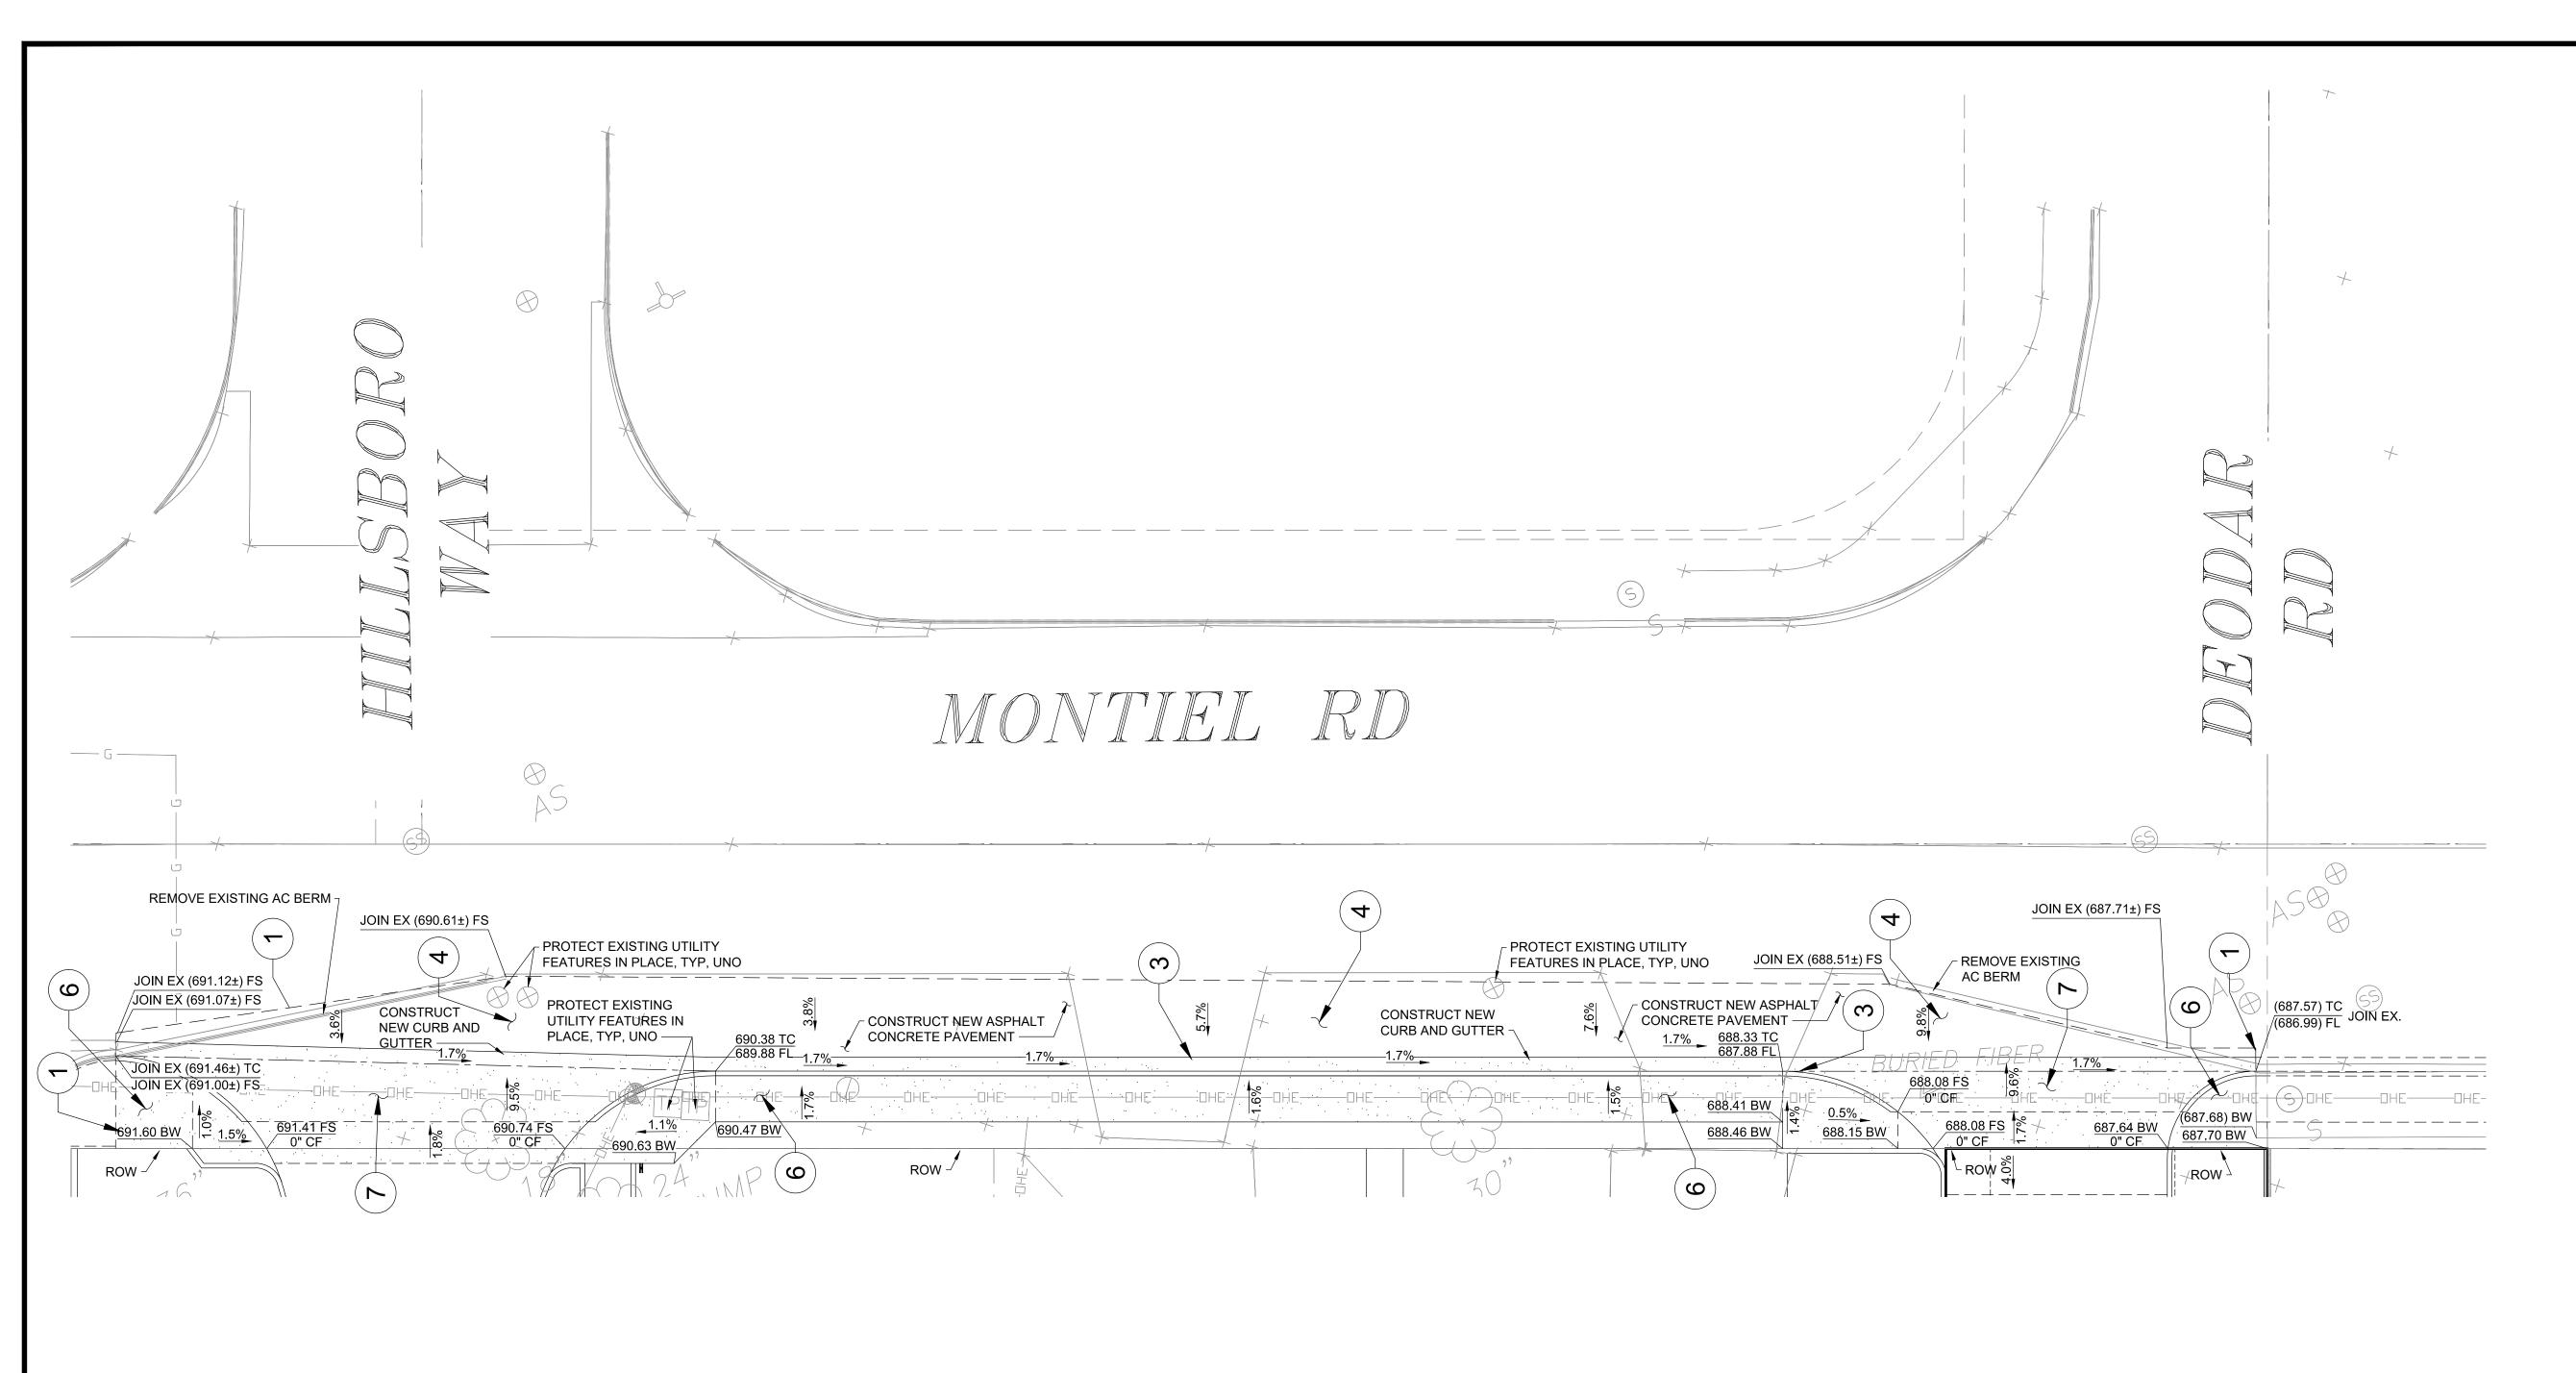

SCALE: = 10'

CONSTRUCTION NOTES

#	ITEM	STD PLAN
1	SAWCUT EXISTING PAVEMENT	
2	CONCRETE CURB	SDRSD G-01
3	CONCRETE CURB & GUTTER	SDRSD G-02
4	ASPHALT CONCRETE PAVEMENT	
5	PORTLAND CEMENT CONCRETE PAVEMENT	
6	CONCRETE SIDEWALK	SDRSD G-07
7	CONCRETE DRIVEWAY	SDRSD G-14F
8	CONCRETE TIRE STOP	

- 1. ALL EXISTING OVERHEAD UTILITY LINES TO BE MOVED UNDERGROUND.
- 2. PAVEMENT THICKNESS SHALL BE THE THICKER OF THE GEOTECHNICAL RECOMENDATIONS OR 1" GREATER THAN THE EXISTING PAVEMENT THICKNESS
- 3. SIDEWALK WITHIN THE PUBLIC RIGHT OF WAY SHALL BE CONSTRUCTED PER THE SDRSD G-07





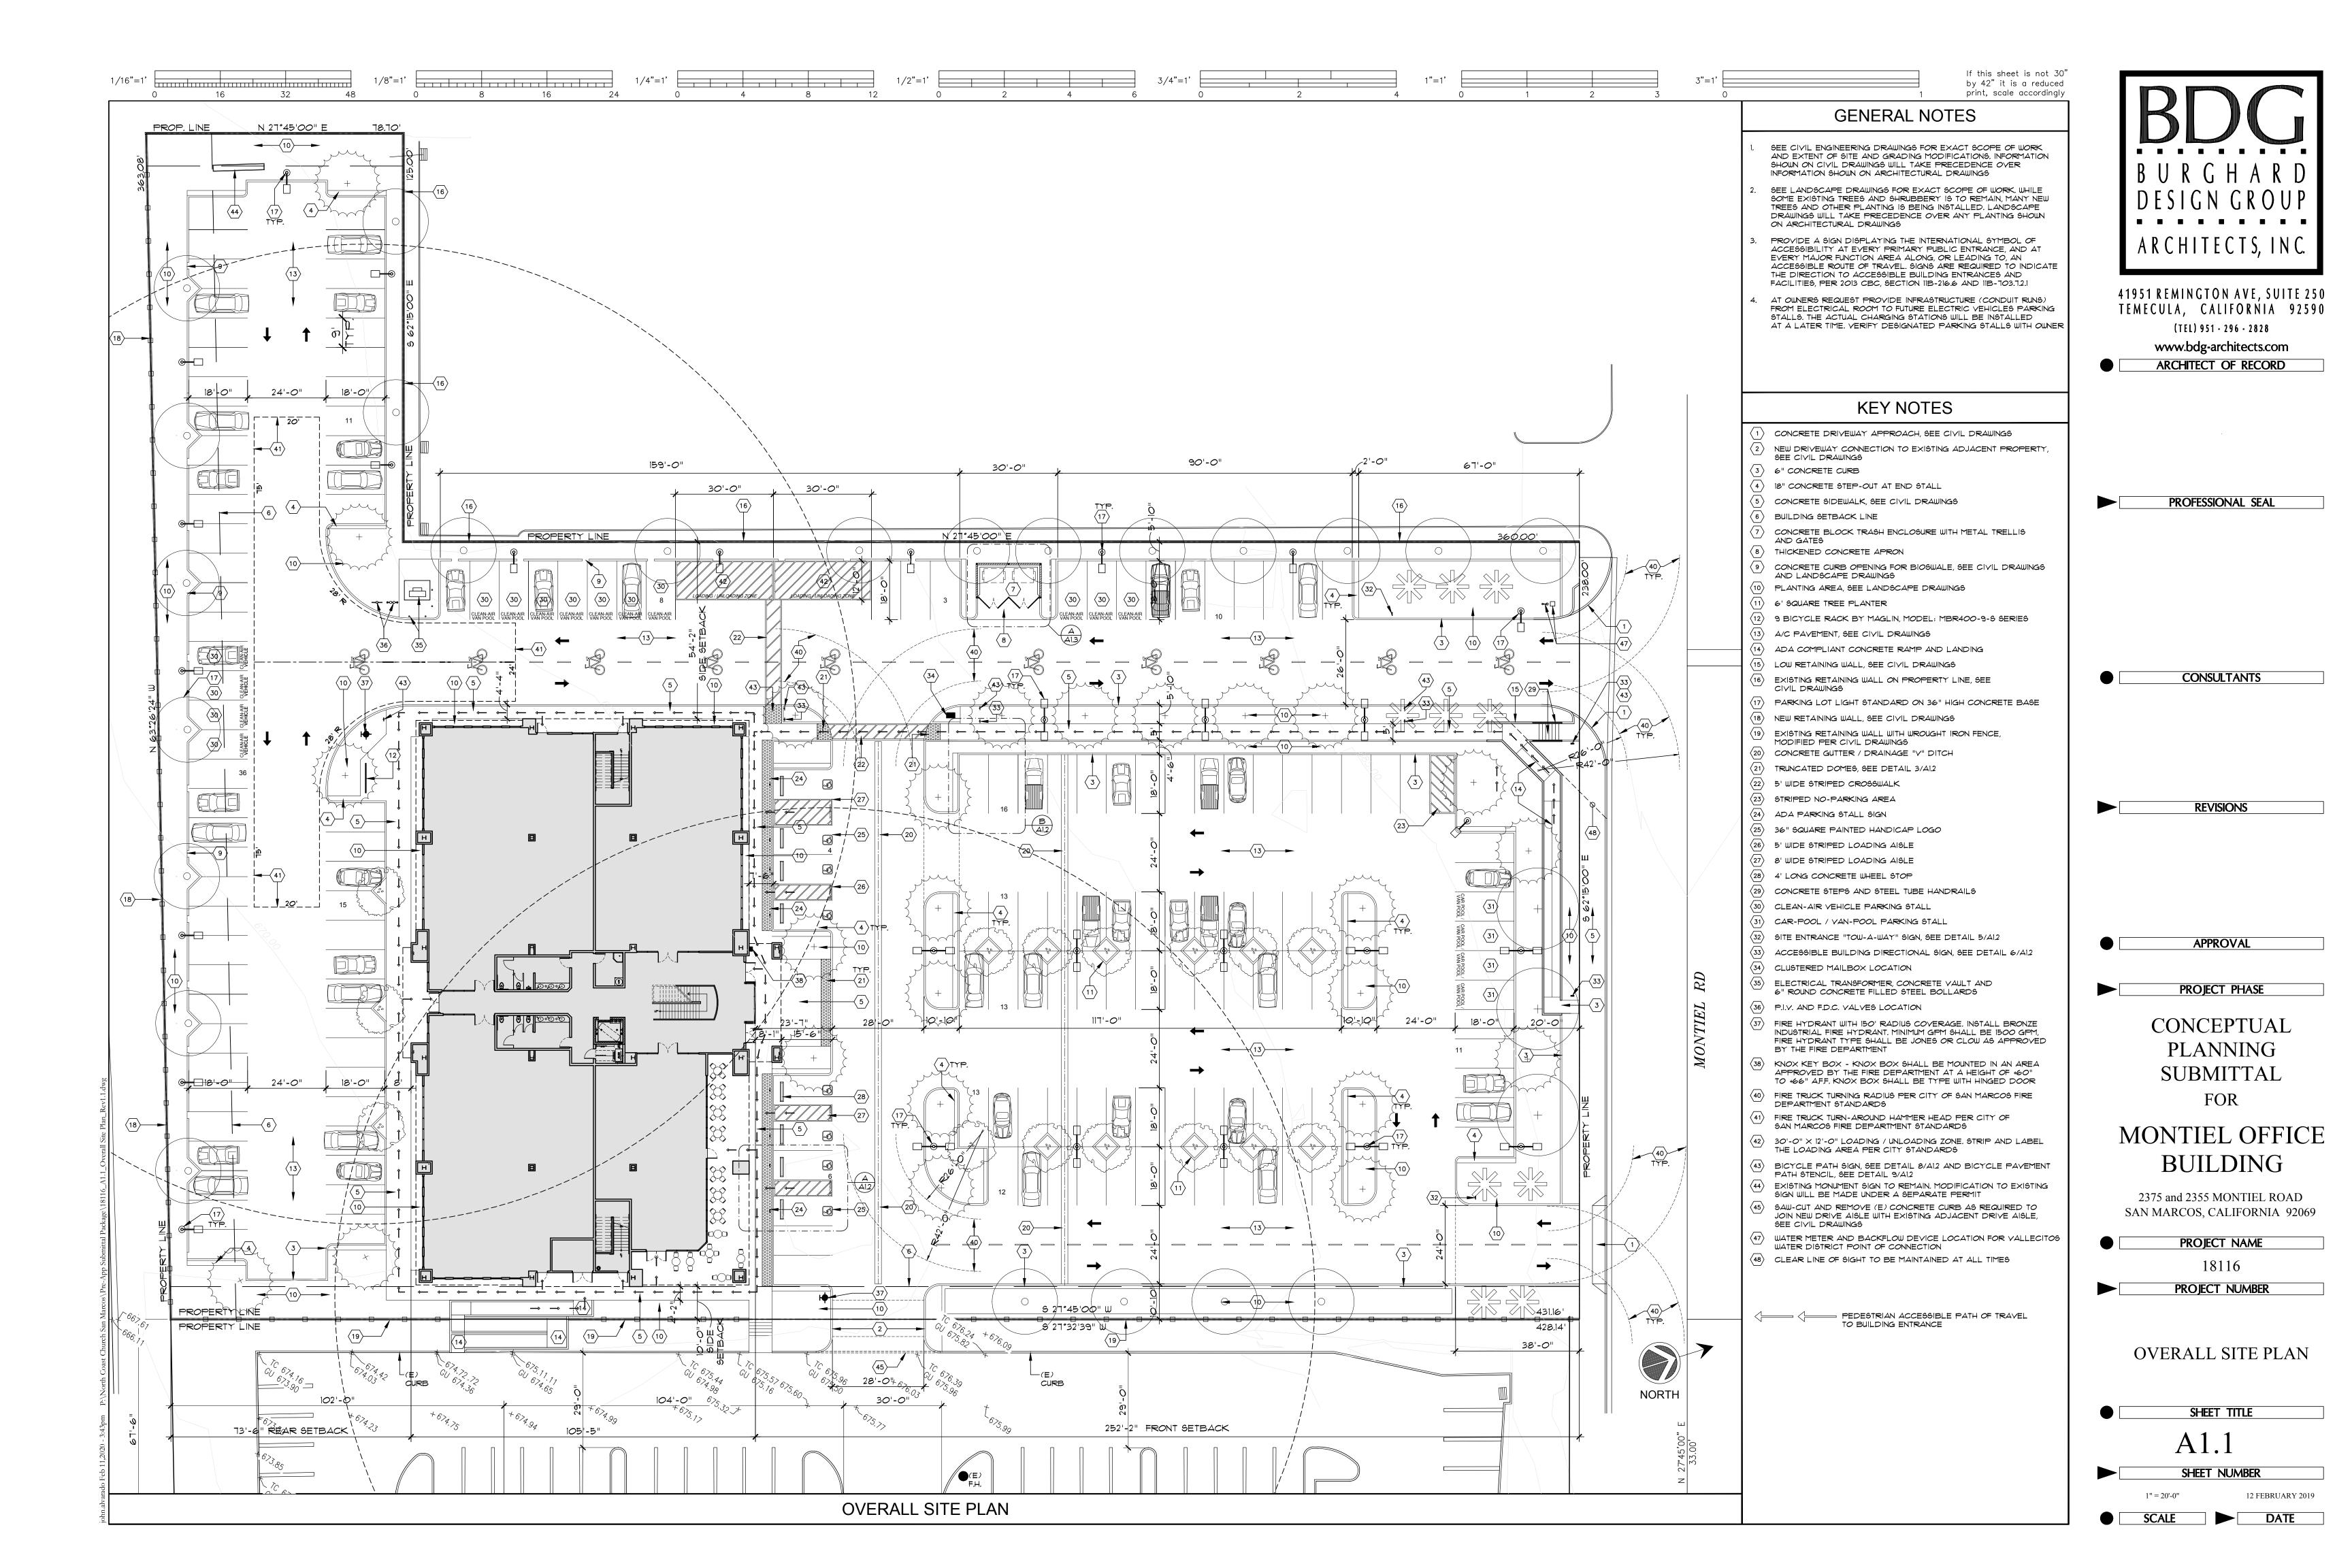
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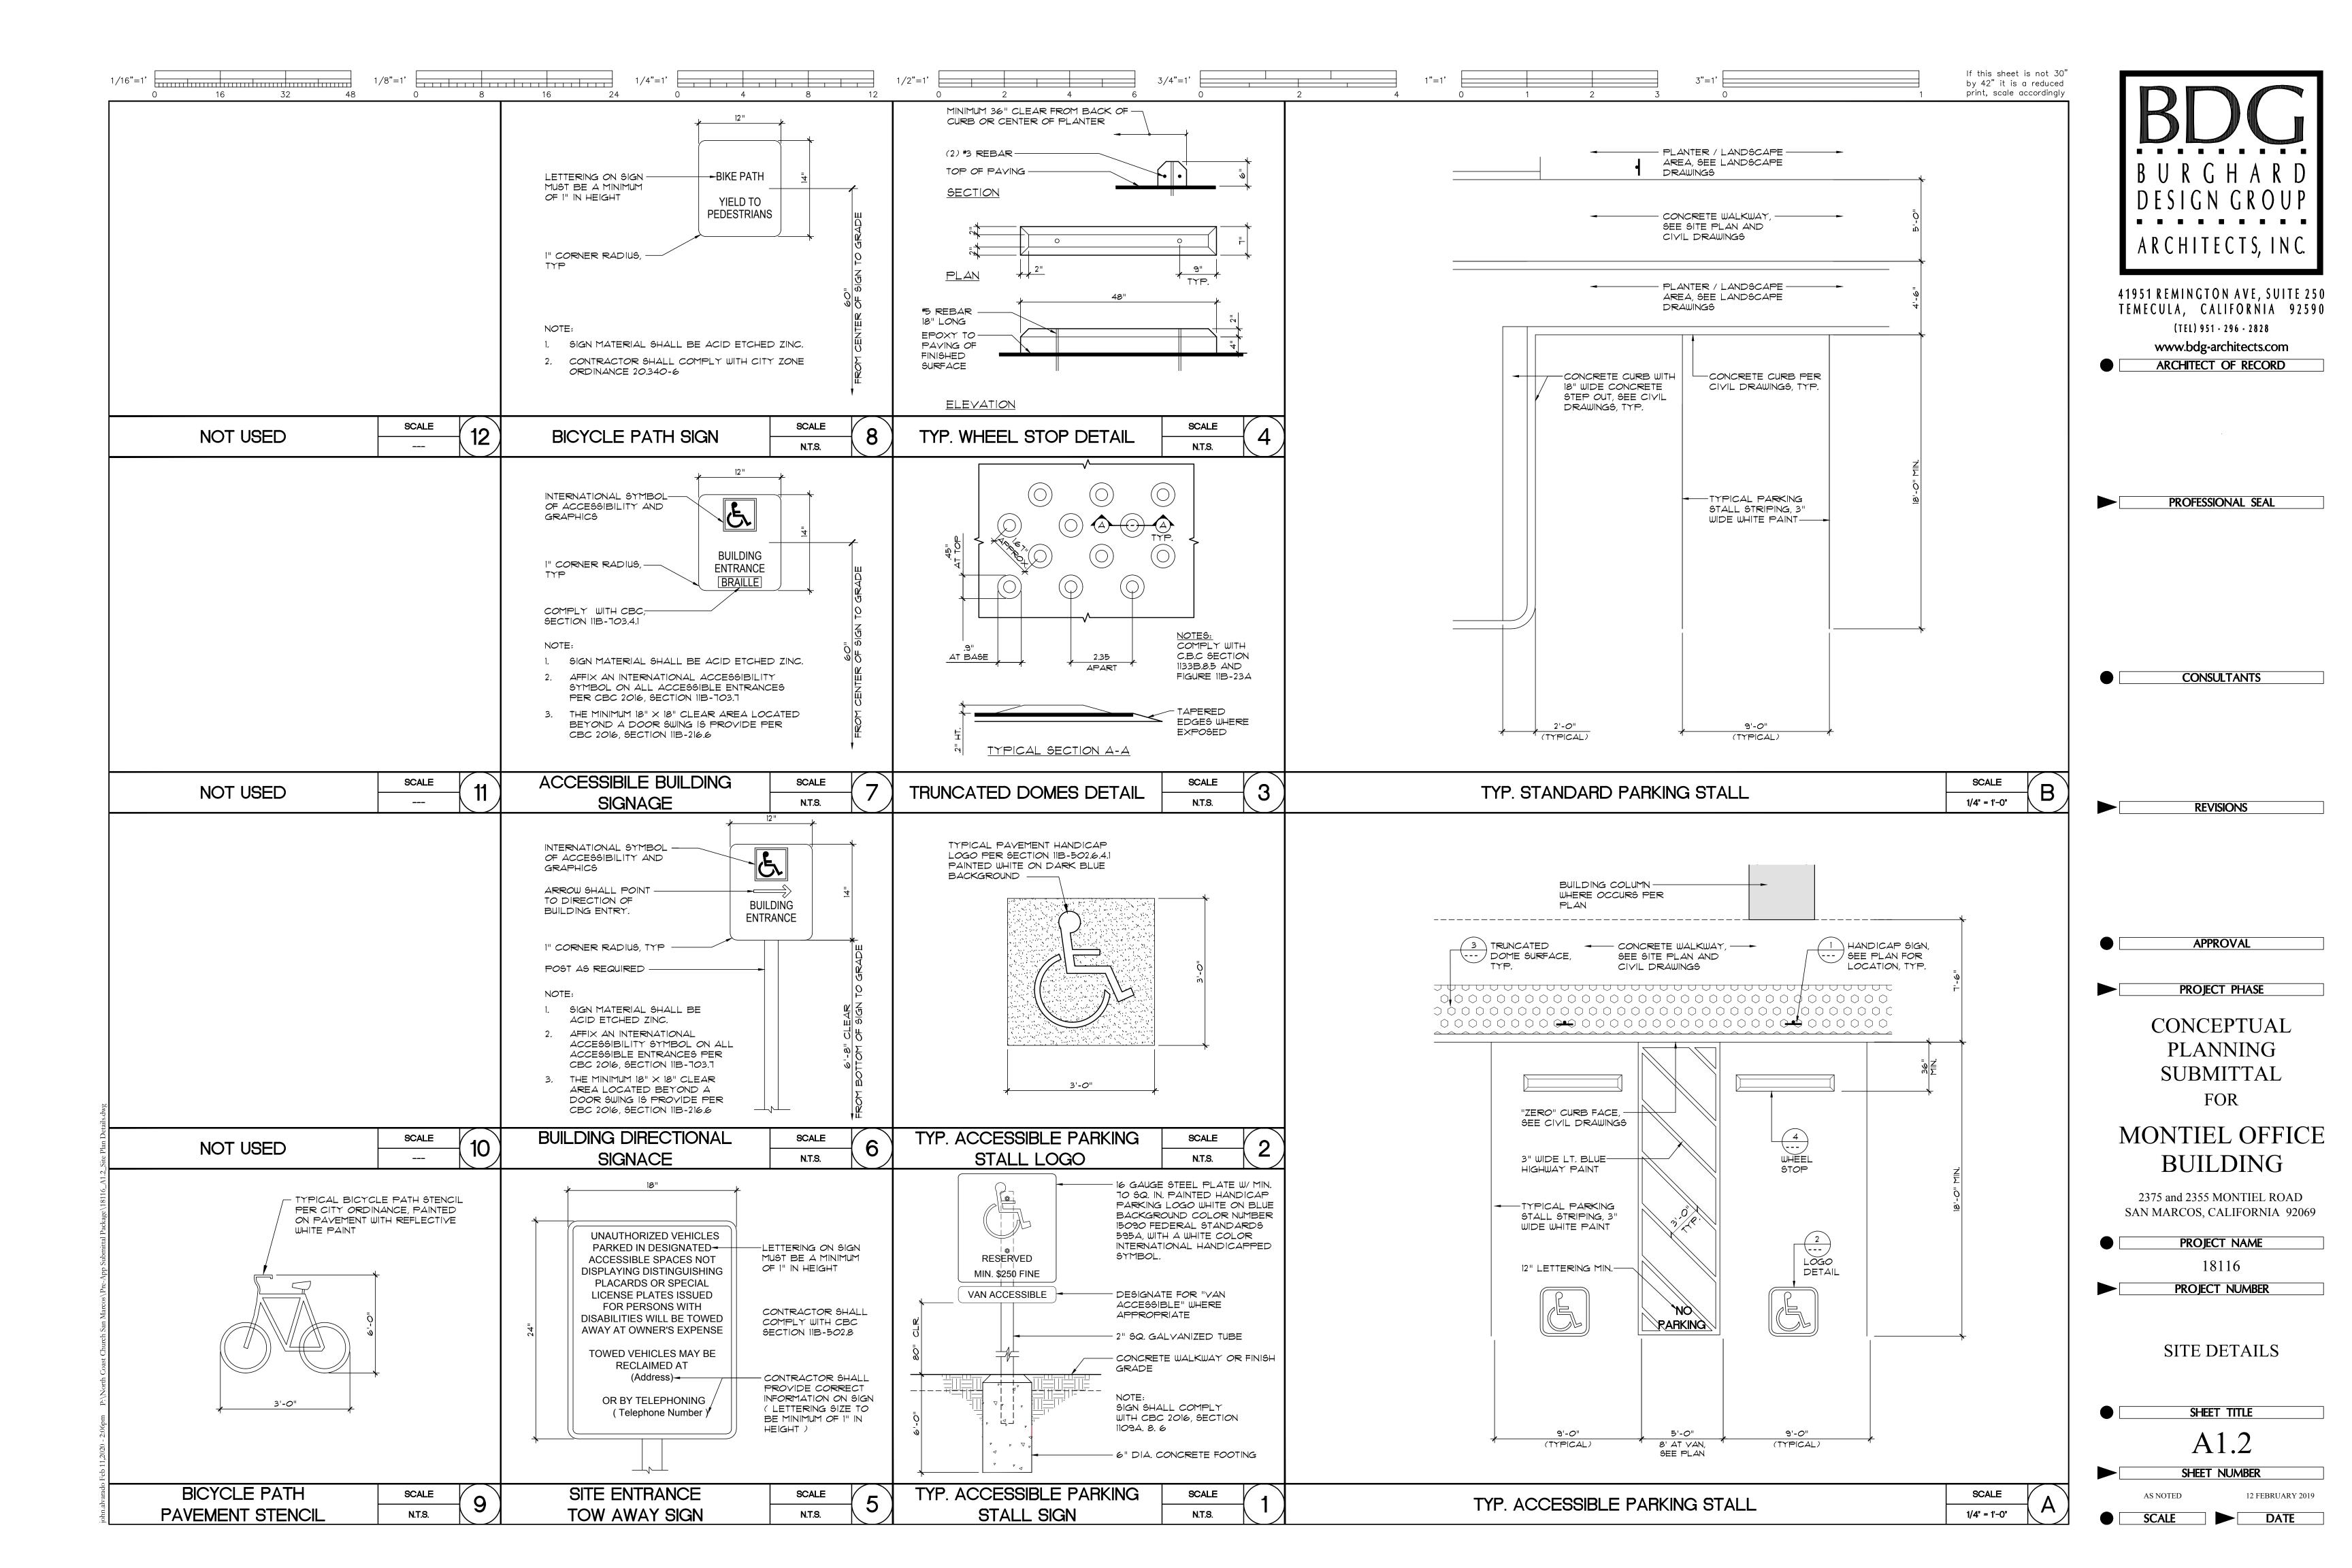
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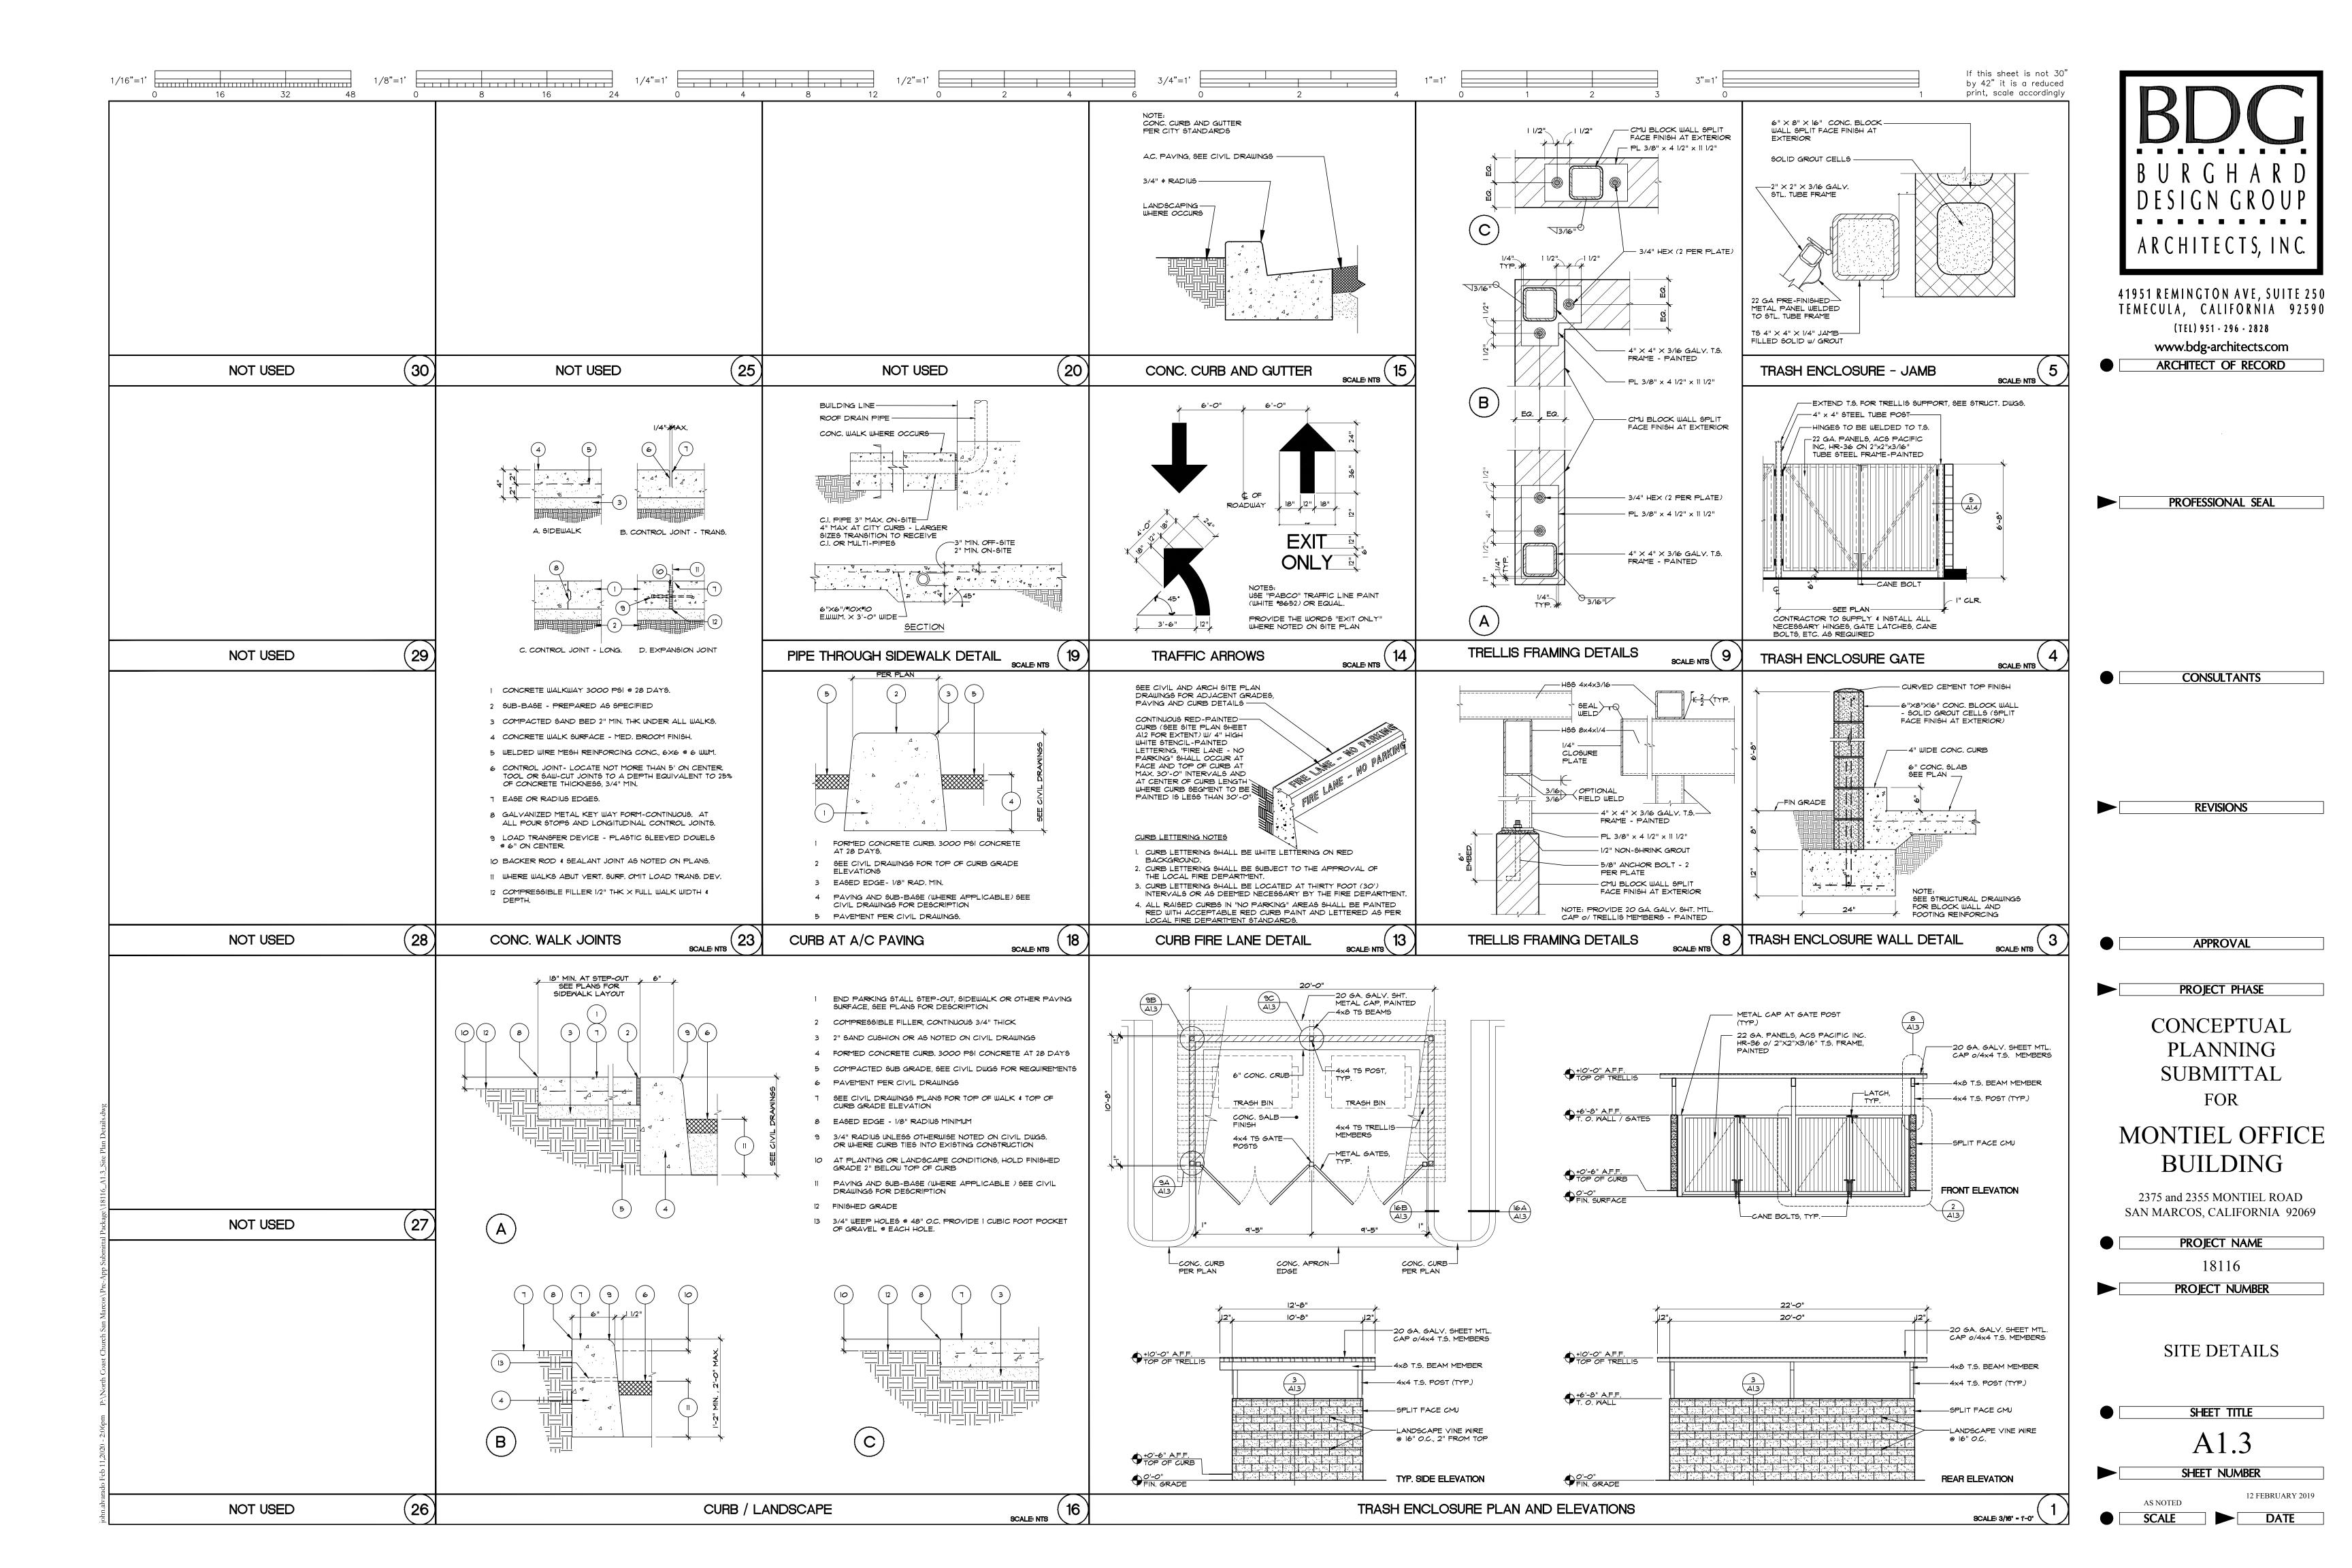
PRELIMINARY PLAN BUILDING AND PLANNING COMMISSION APPROVAL ONLY NOT FOR CONSTRUCTION


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- 1:3 West∖ Engine	SAN MARCOS FIRE DEPARTMENT	VALLECITOS WATER DISTRICT	ENGINEER OF WORK	CITY APPROVED CHANGES	RECOMMENDED FOR APPROVAL	APPROVED FOR CONSTRUCTION	BENCH MARK	CITY OF SAN MARCOS	City Drawing No.
:02/11/20 \Solutions— ht Partner	By: Jason Nailon, Fire Marshal	Ву:	By:Date: Name: Ali Azimijirsarai	No. Description App'd By Date	By:	By:	Description: 3" BC' IN PAVING Location: NORTHEAST CORNER OF MONTIEL RD. AND DEODAR RD. 20' NORTHWEST OF RETURN	GRADING PLANS FOR:	GP19-XXXXX
lotted ile: R: opyrig	Date:	Date:	R.C.E.: 48773 exp:		R.C.E.: 44034 exp.: 06/30/2021	R.C.E.: 60569 exp.: 12/31/2020	Record From: RECORD OF SURVEY 13928	SAN MARCOS, CA 92069	Sheet 12 of 12












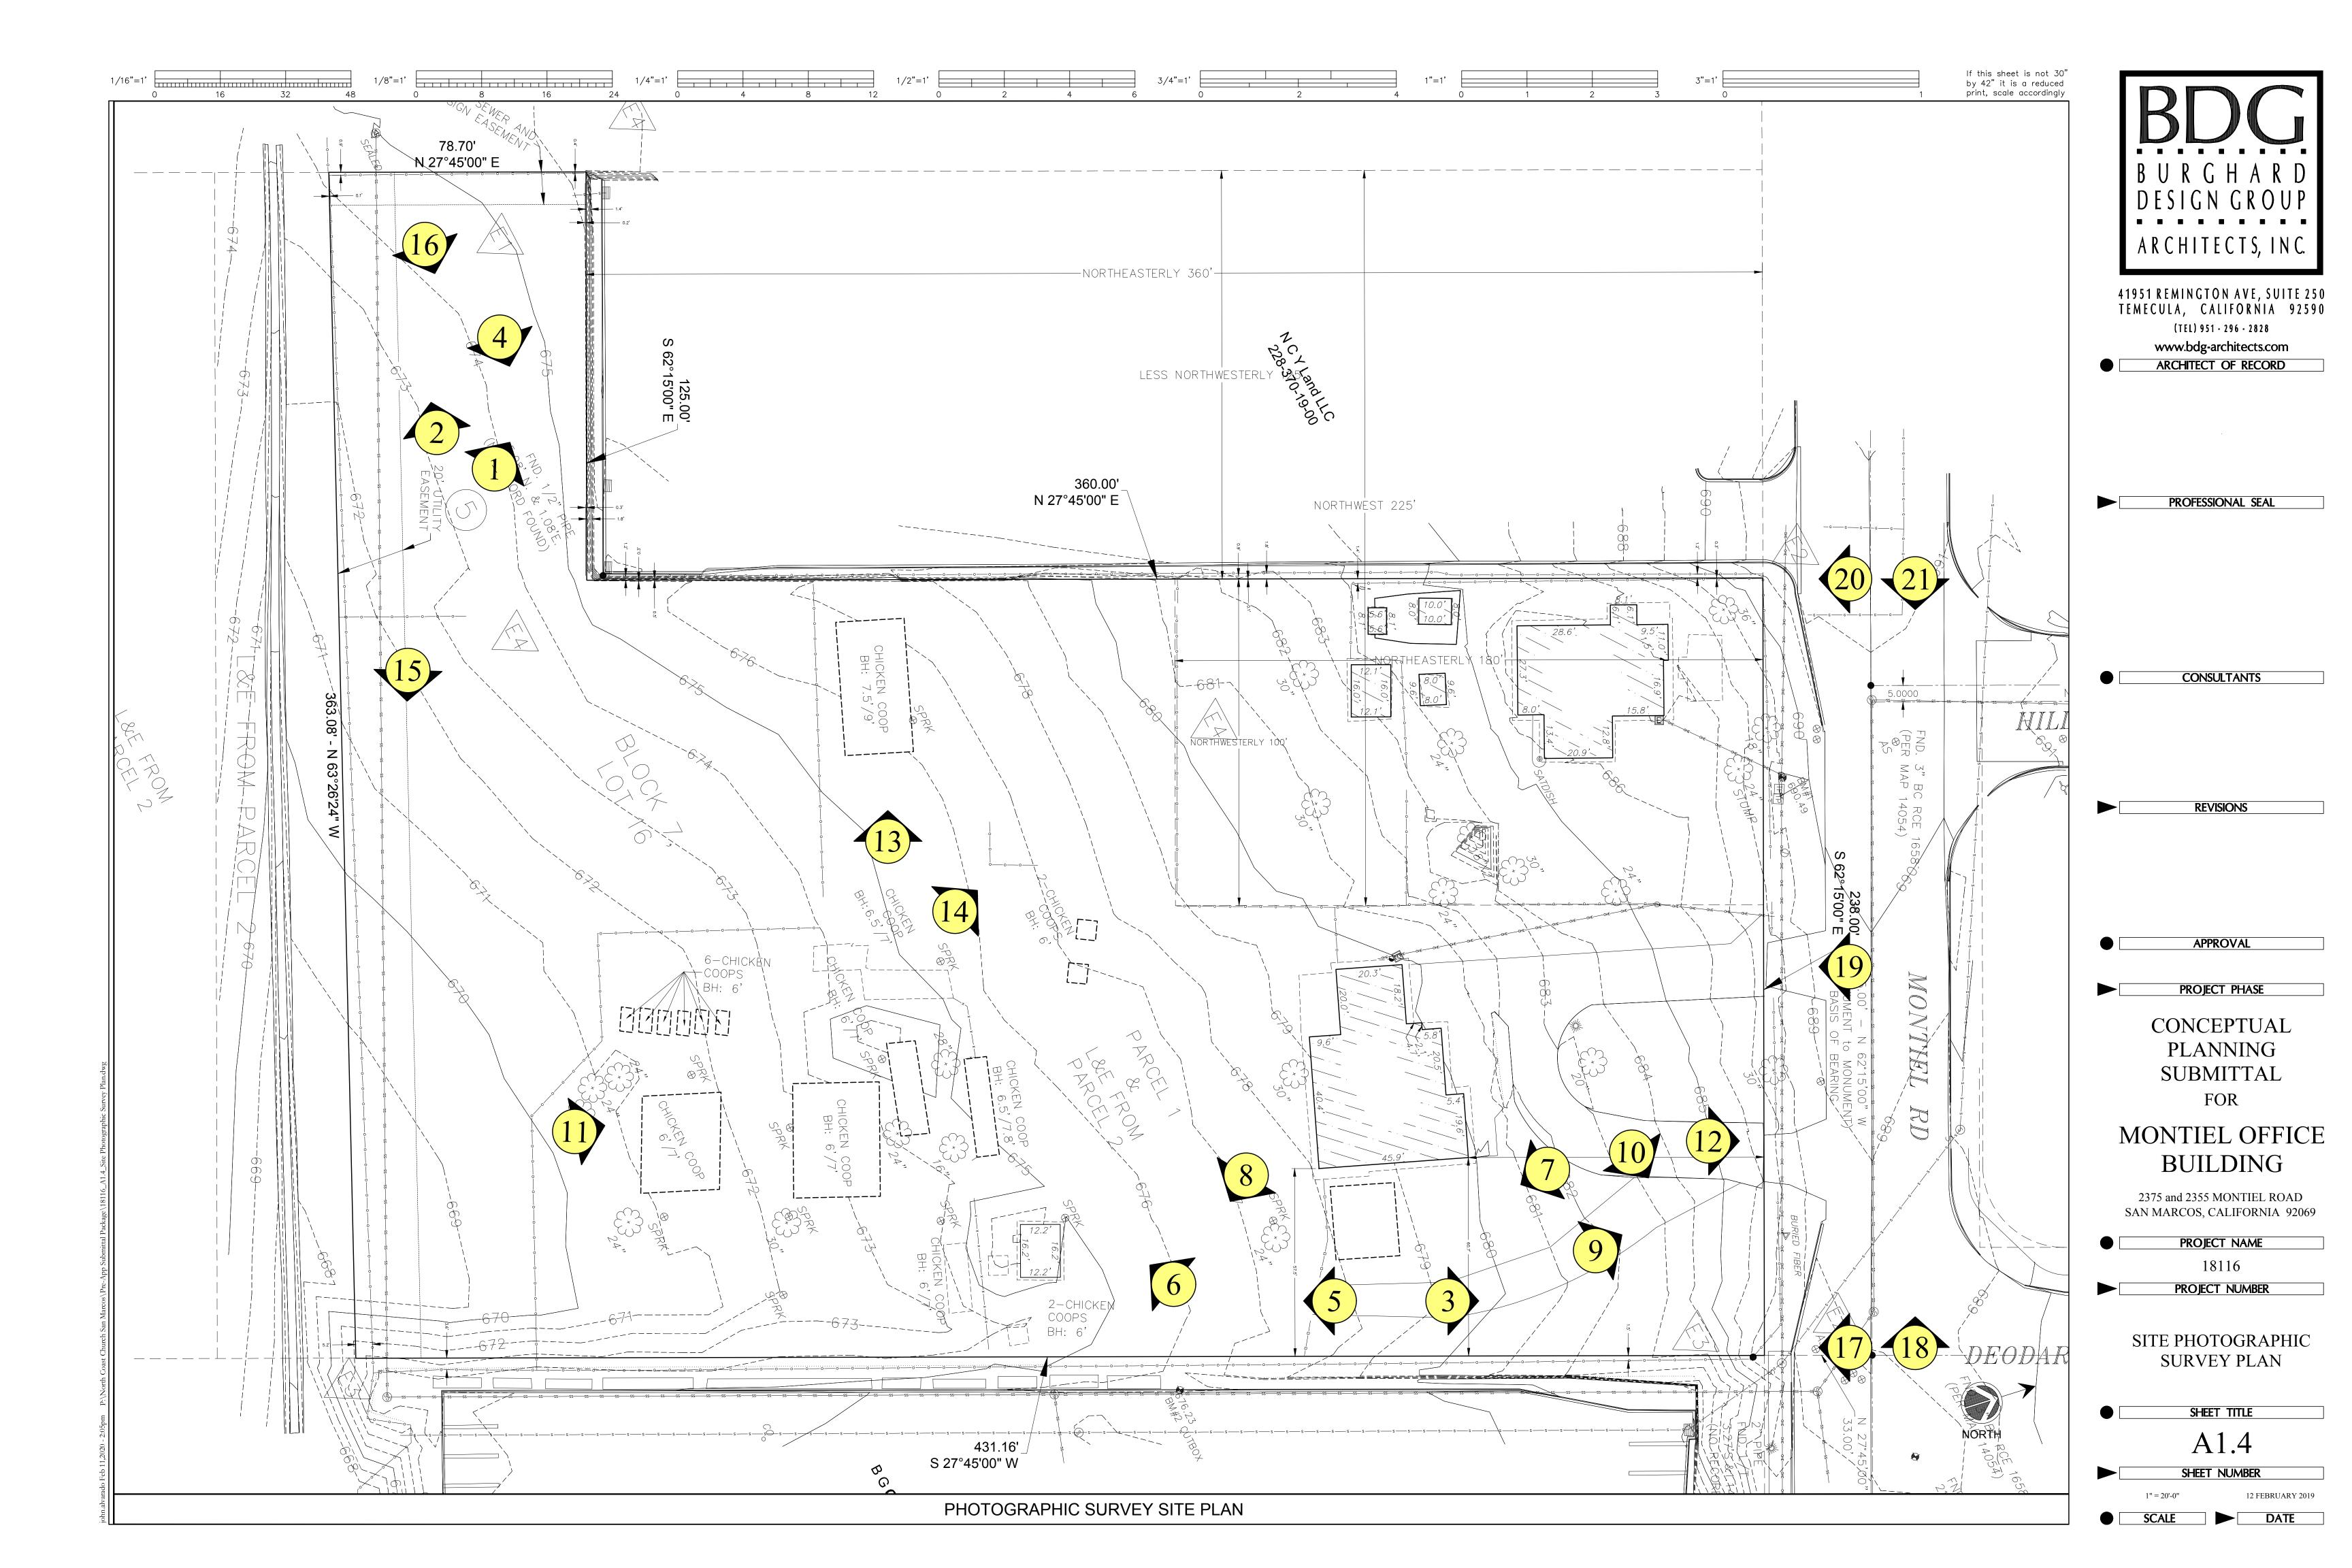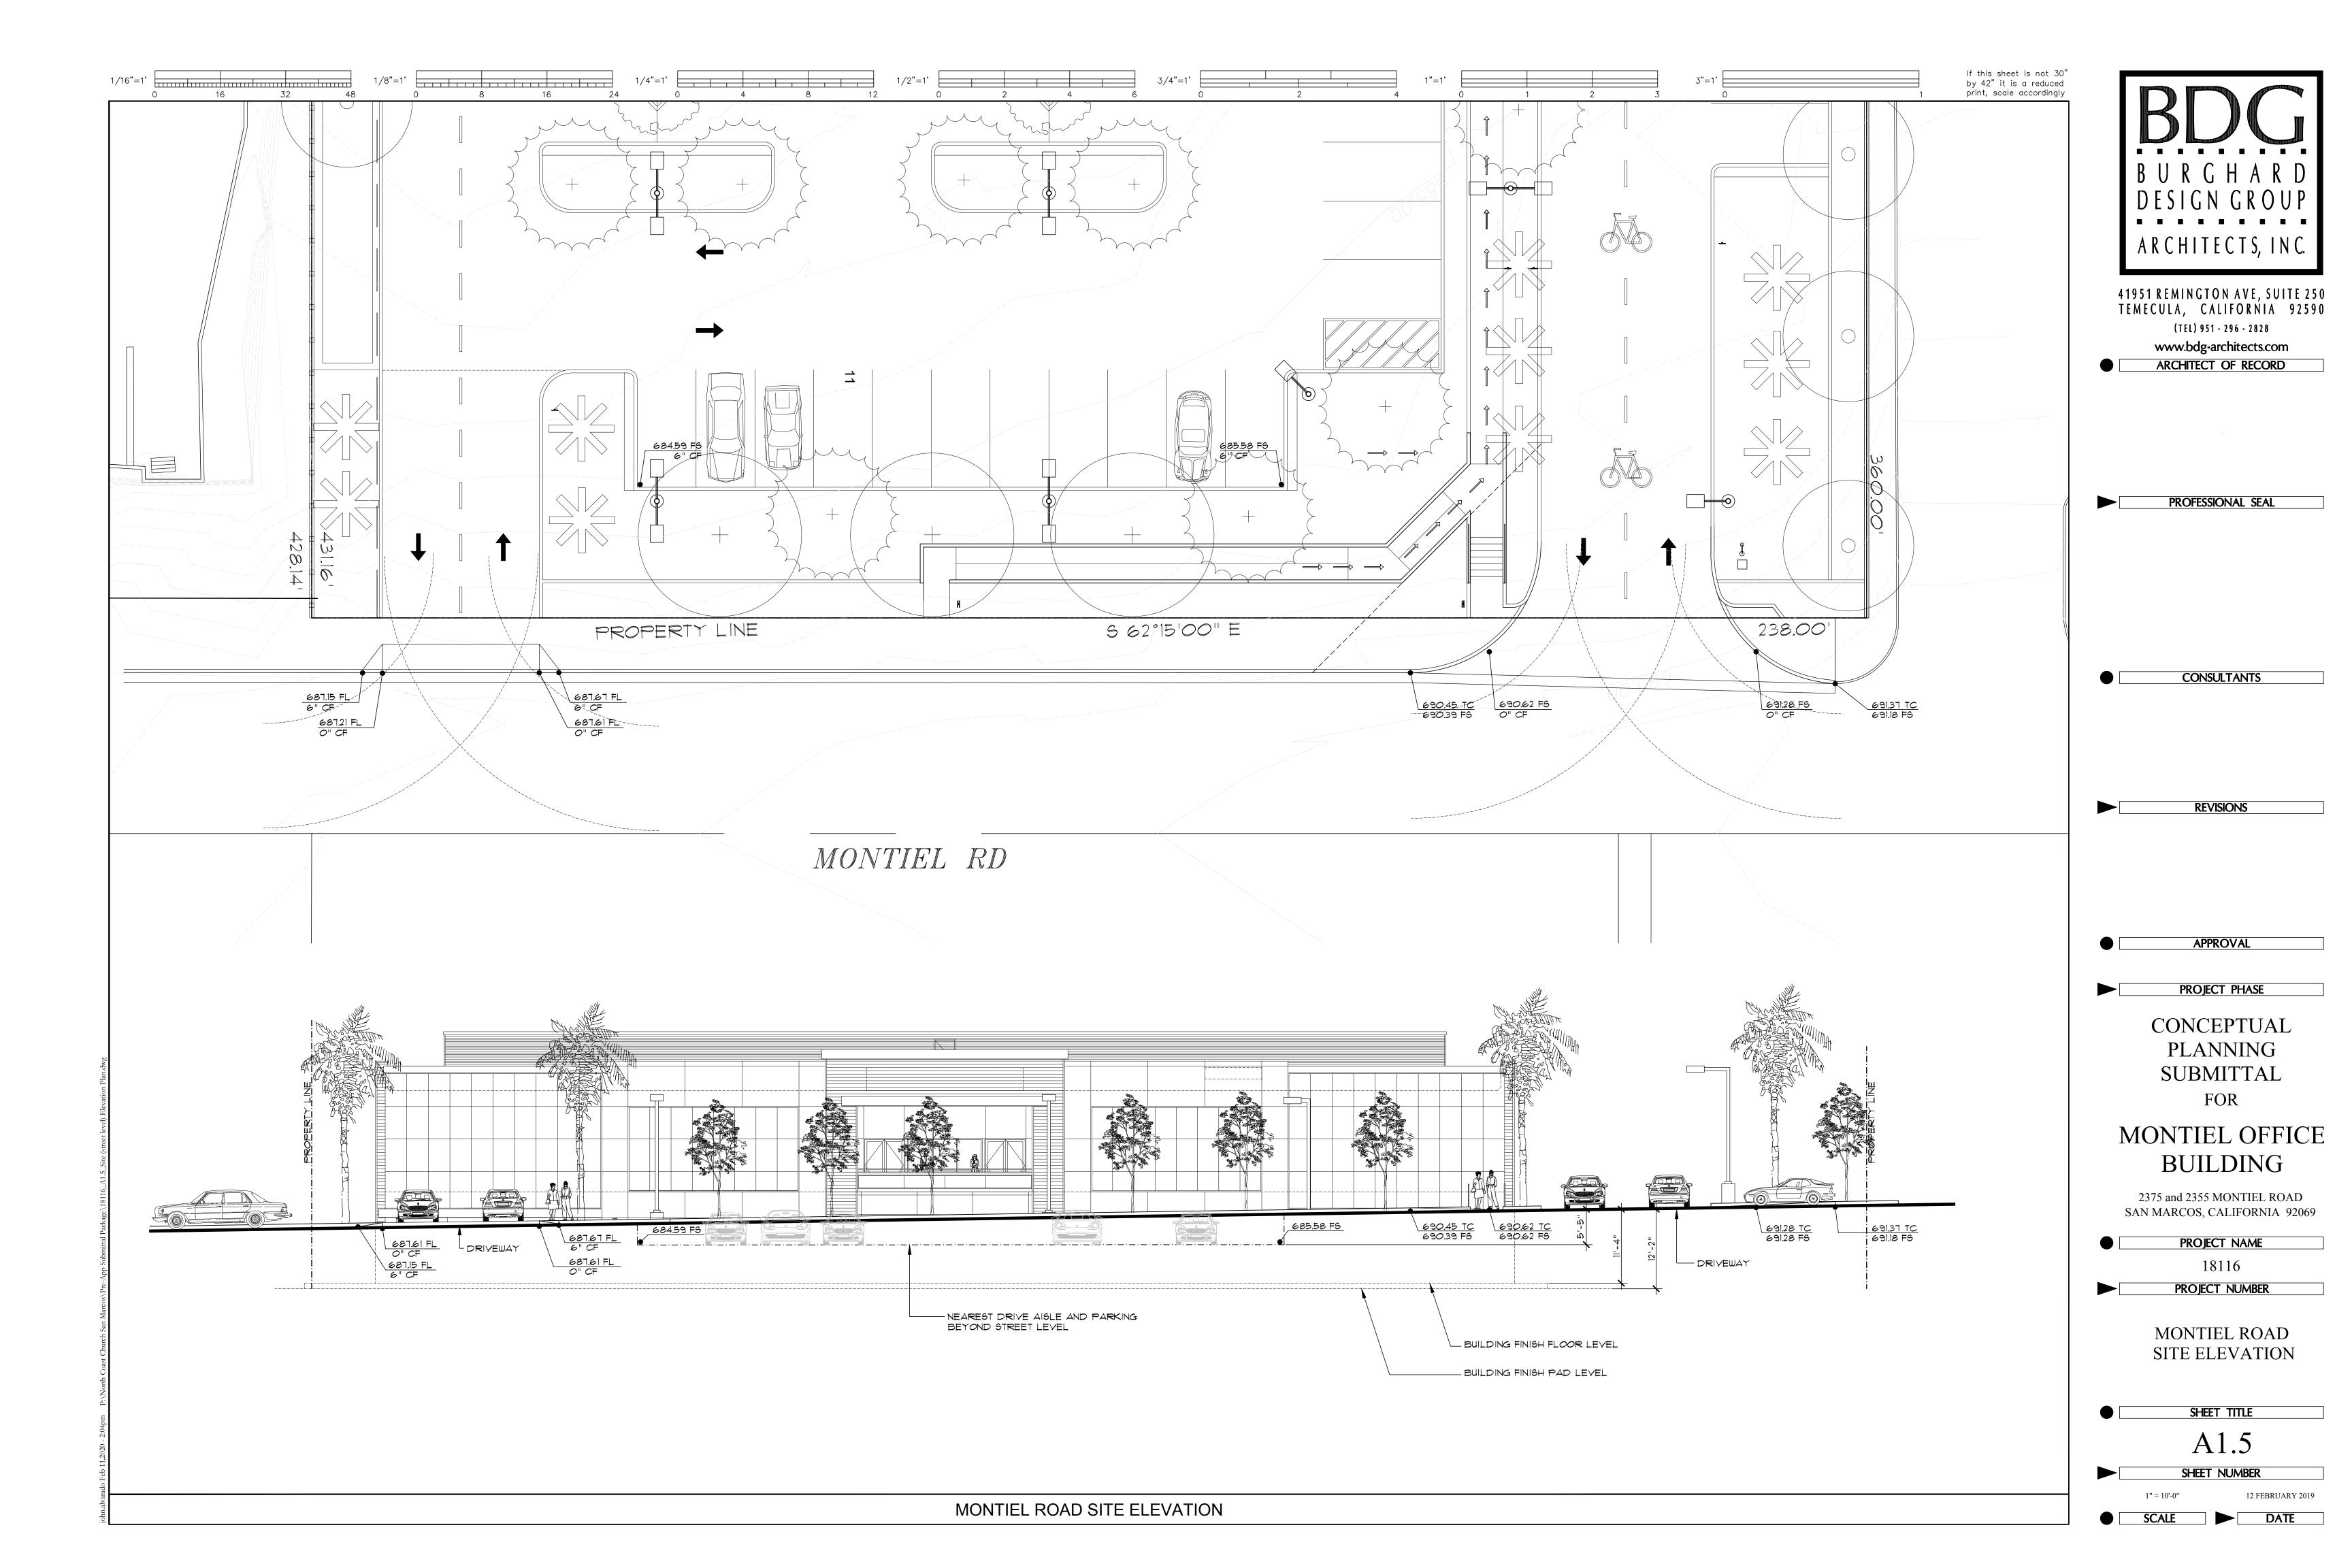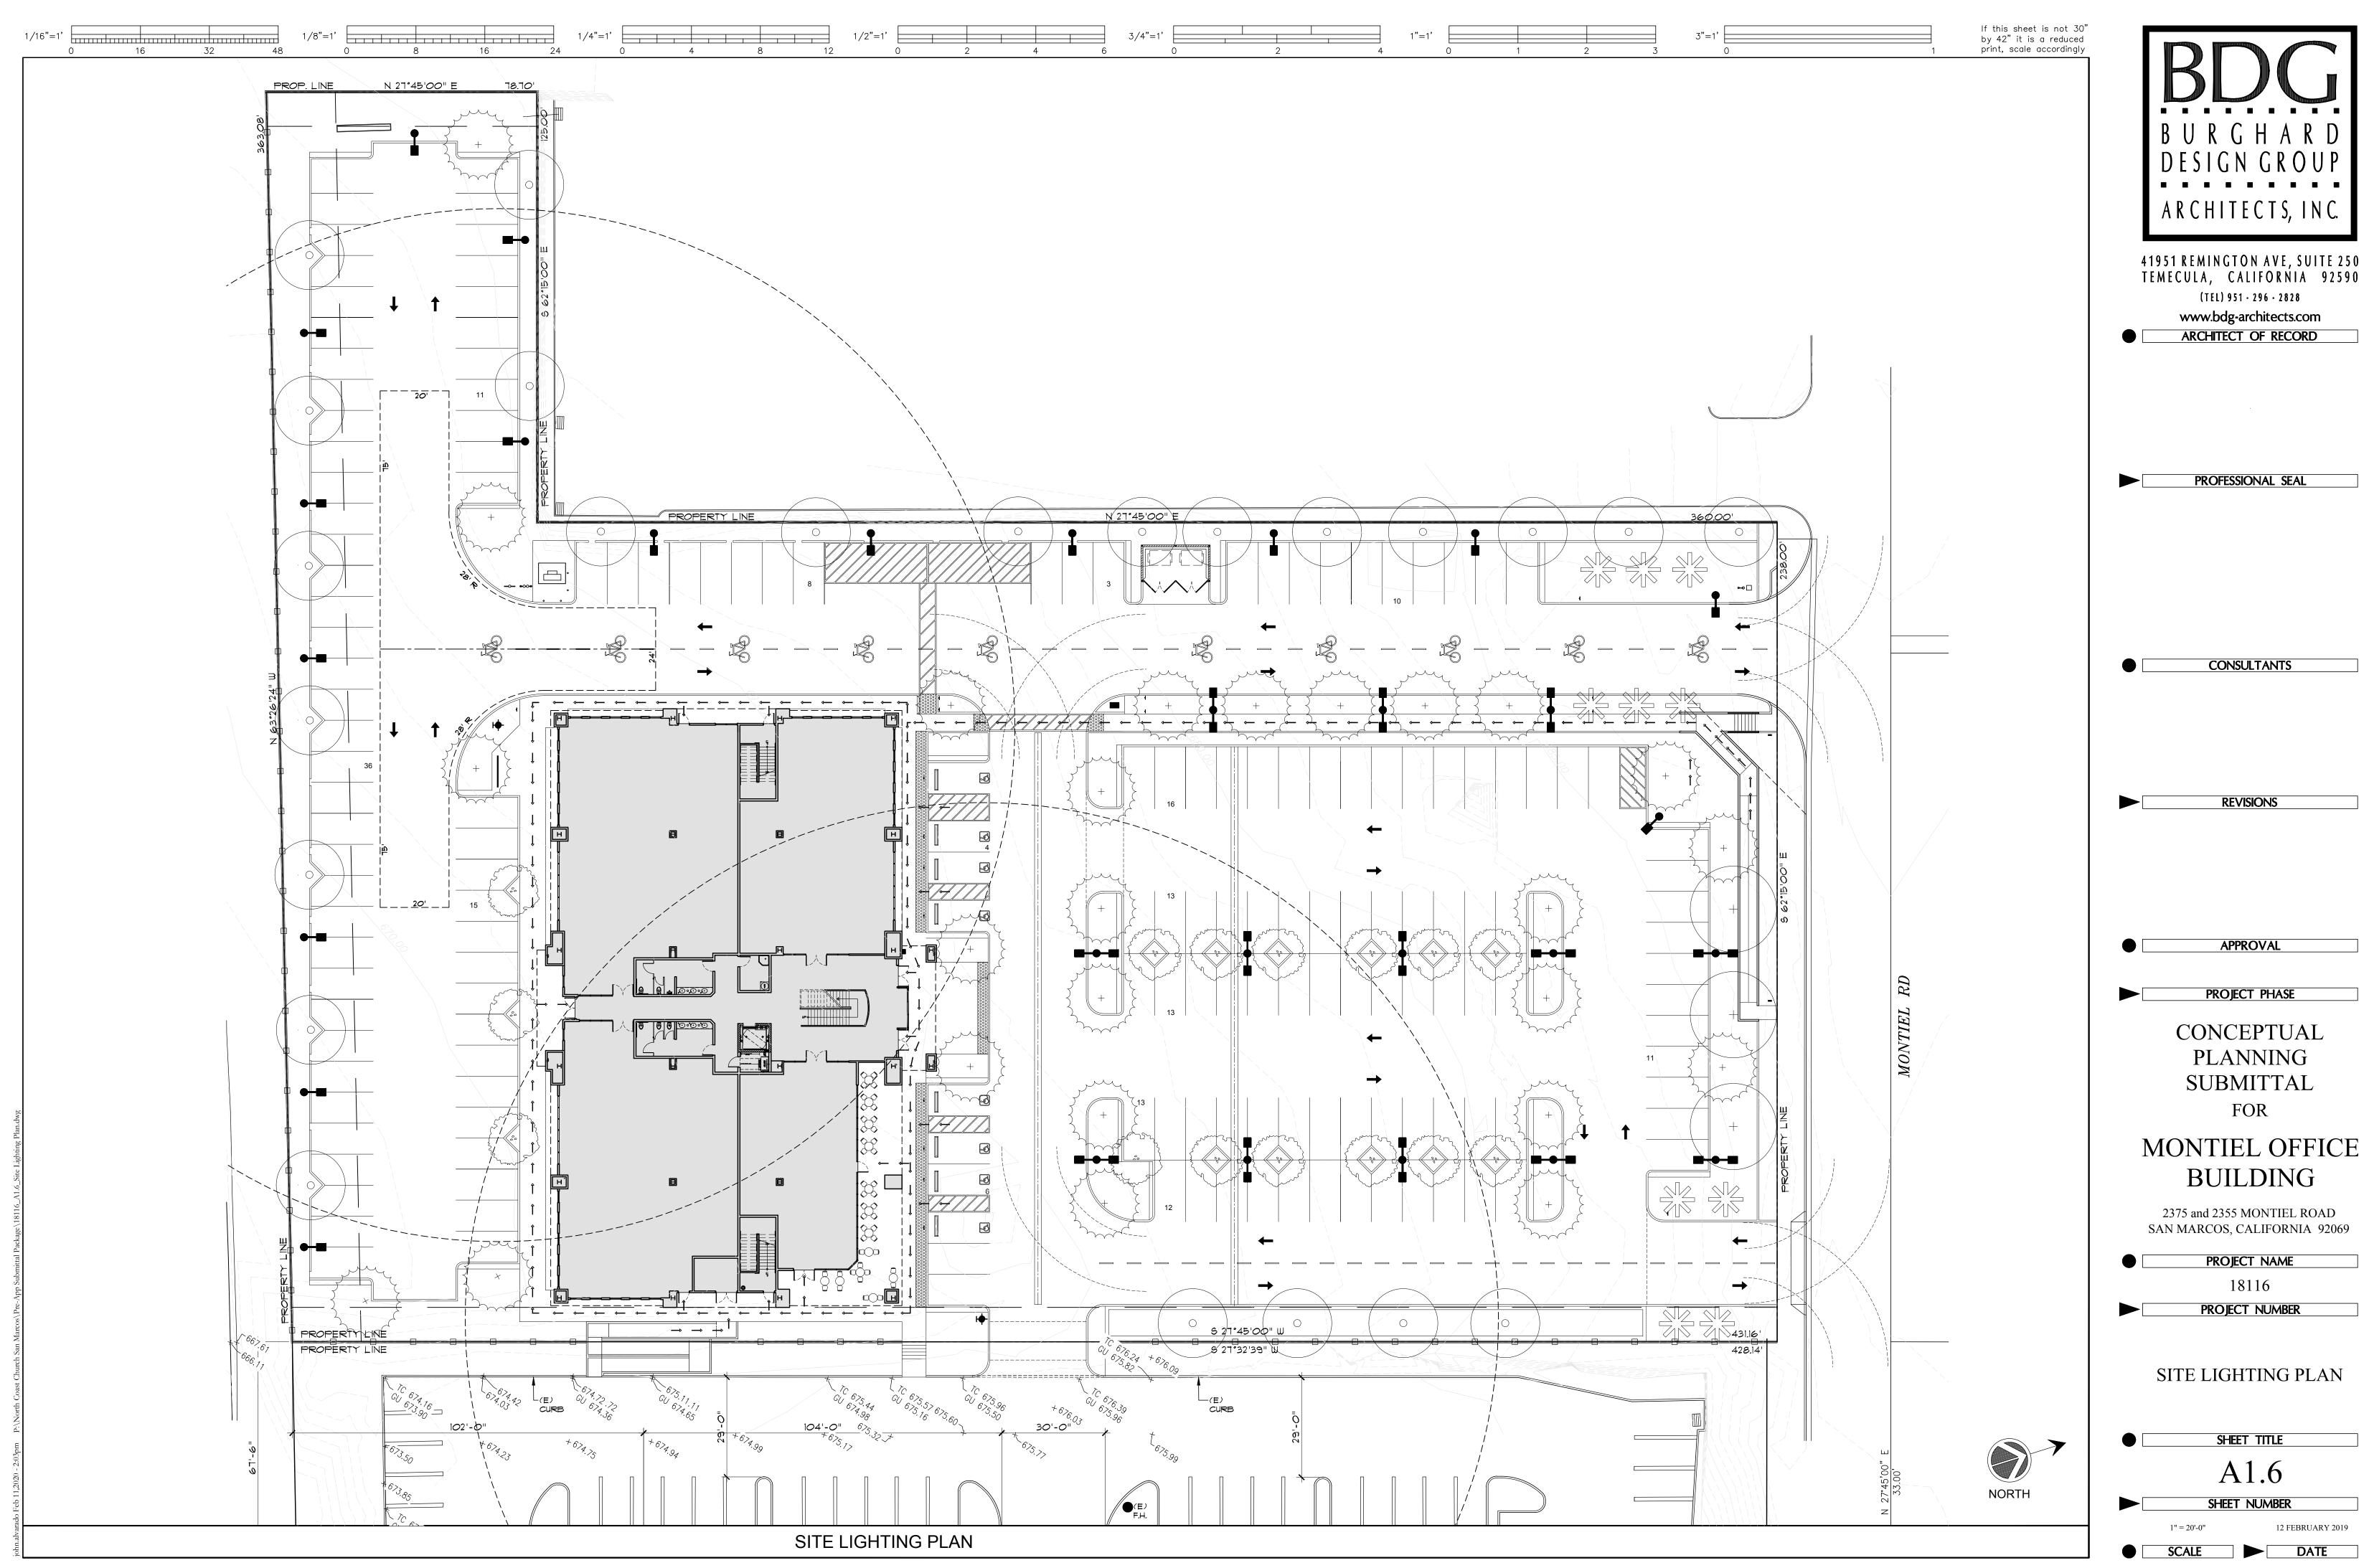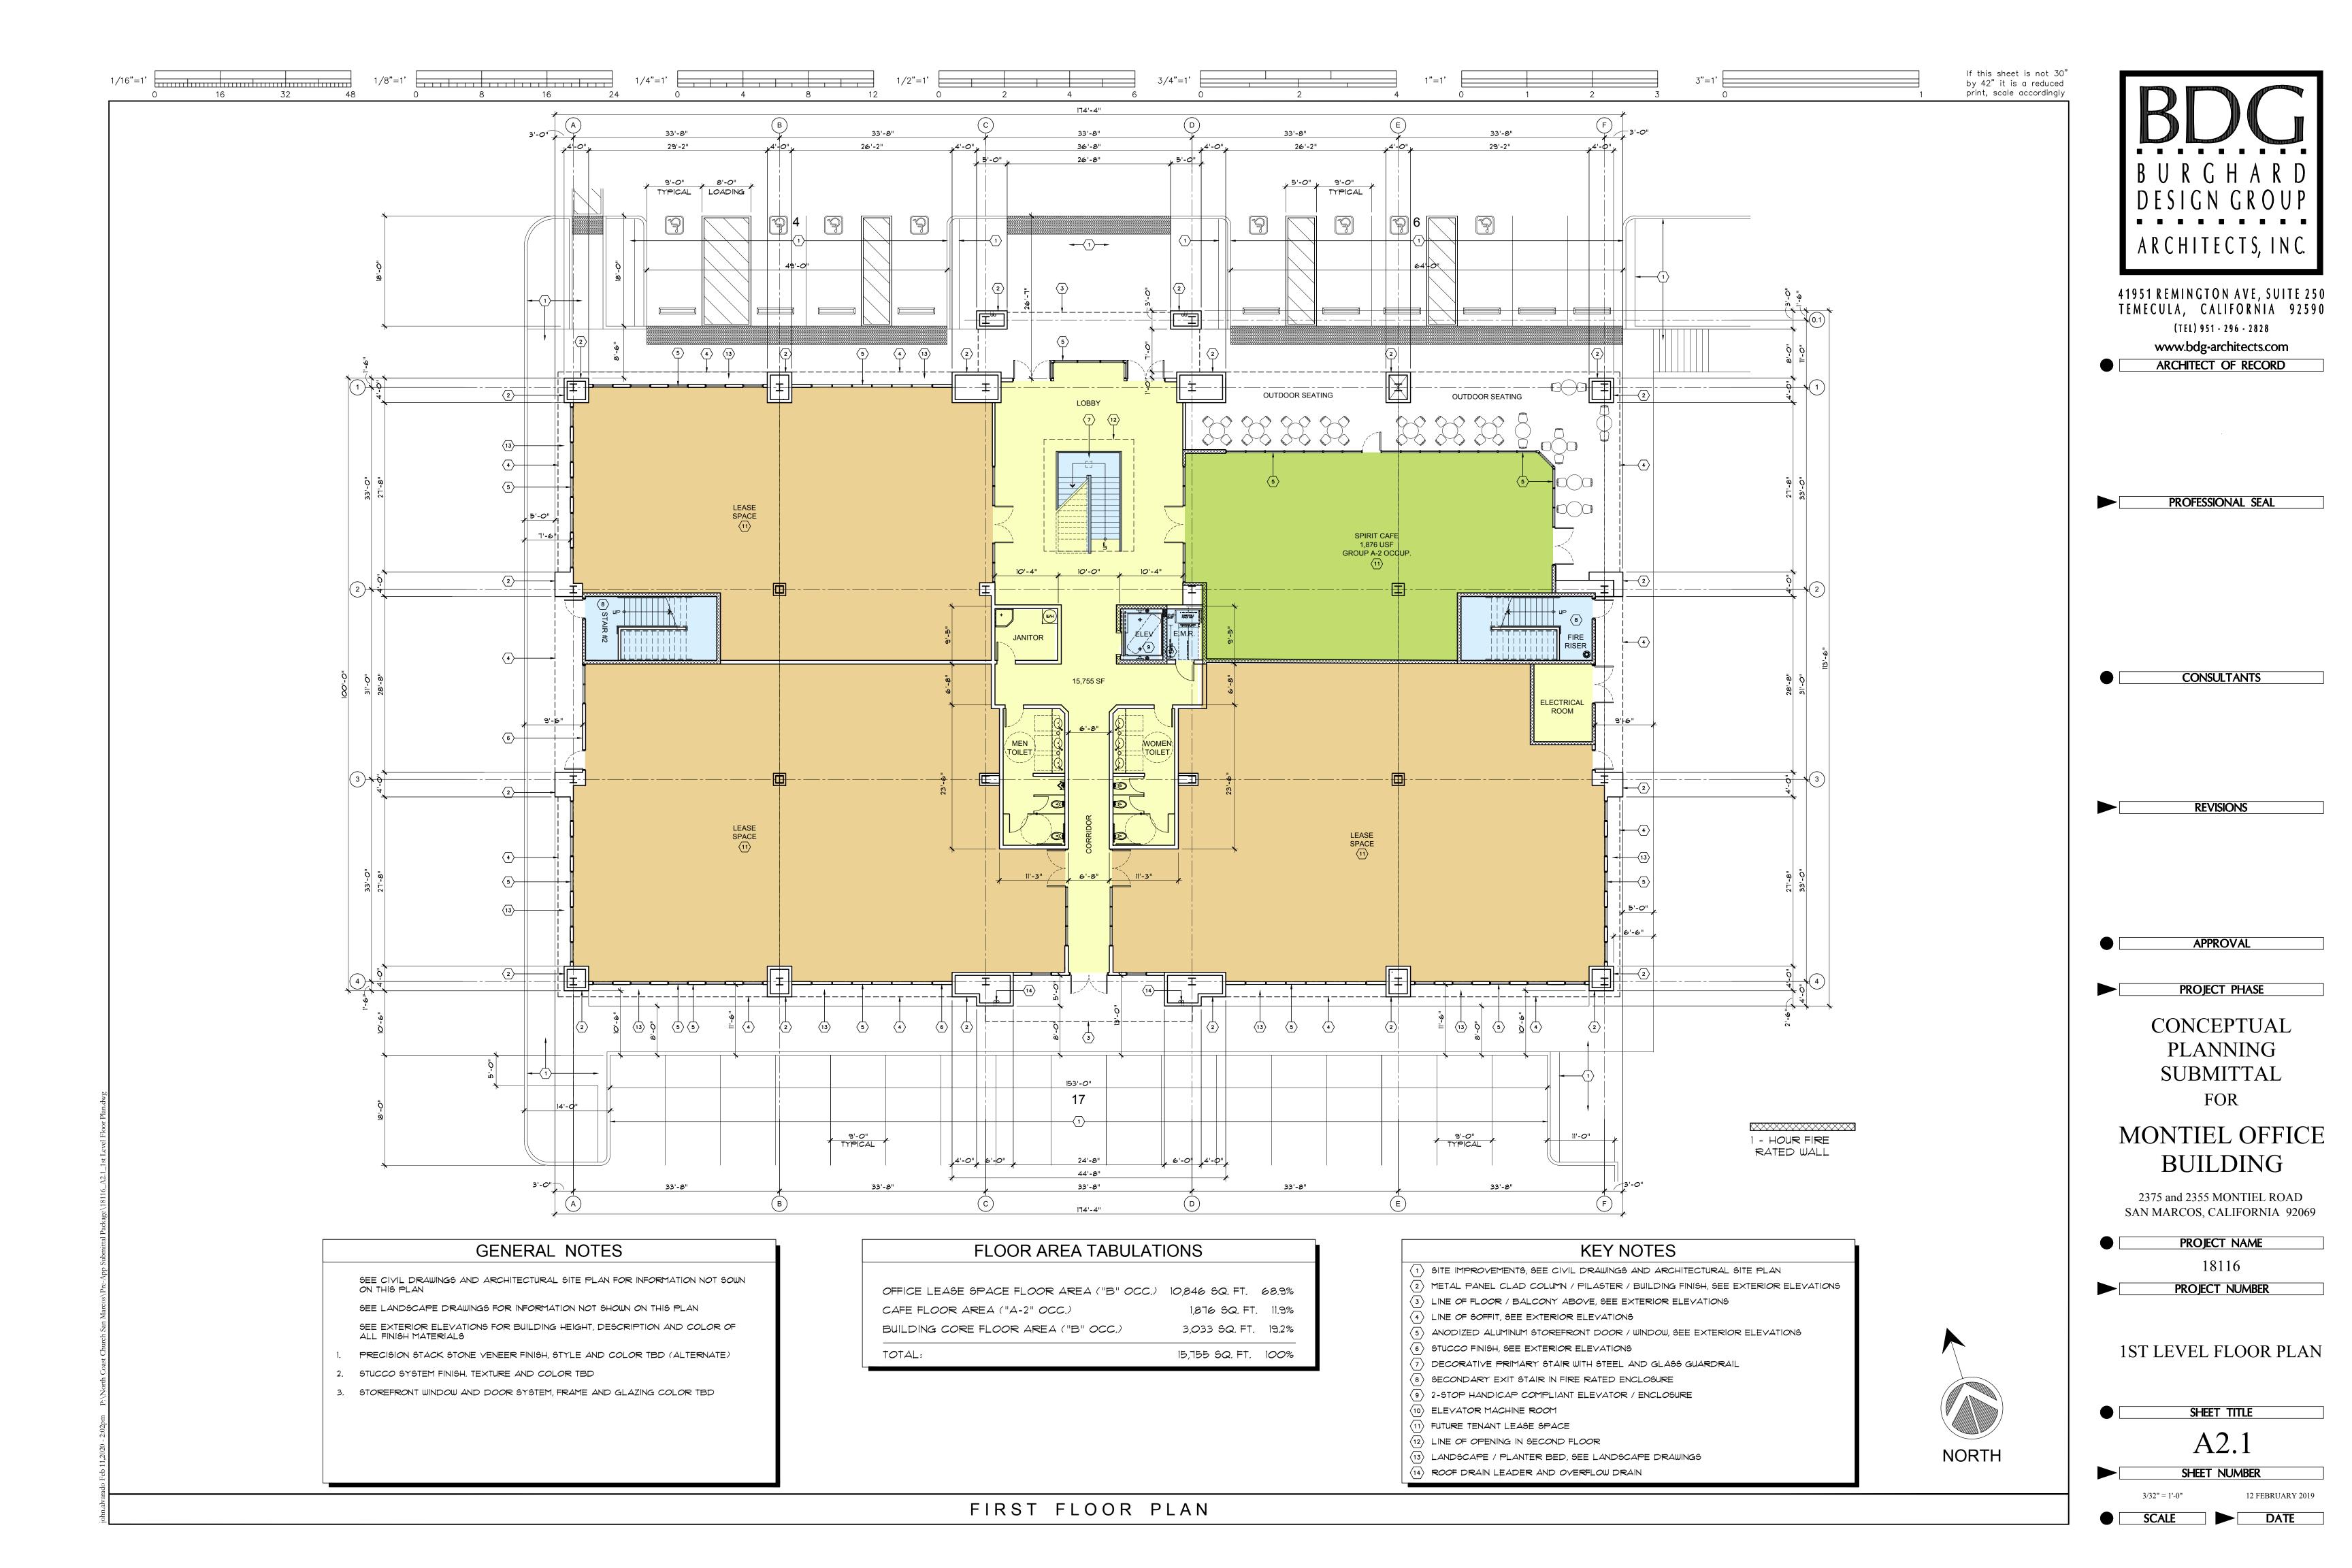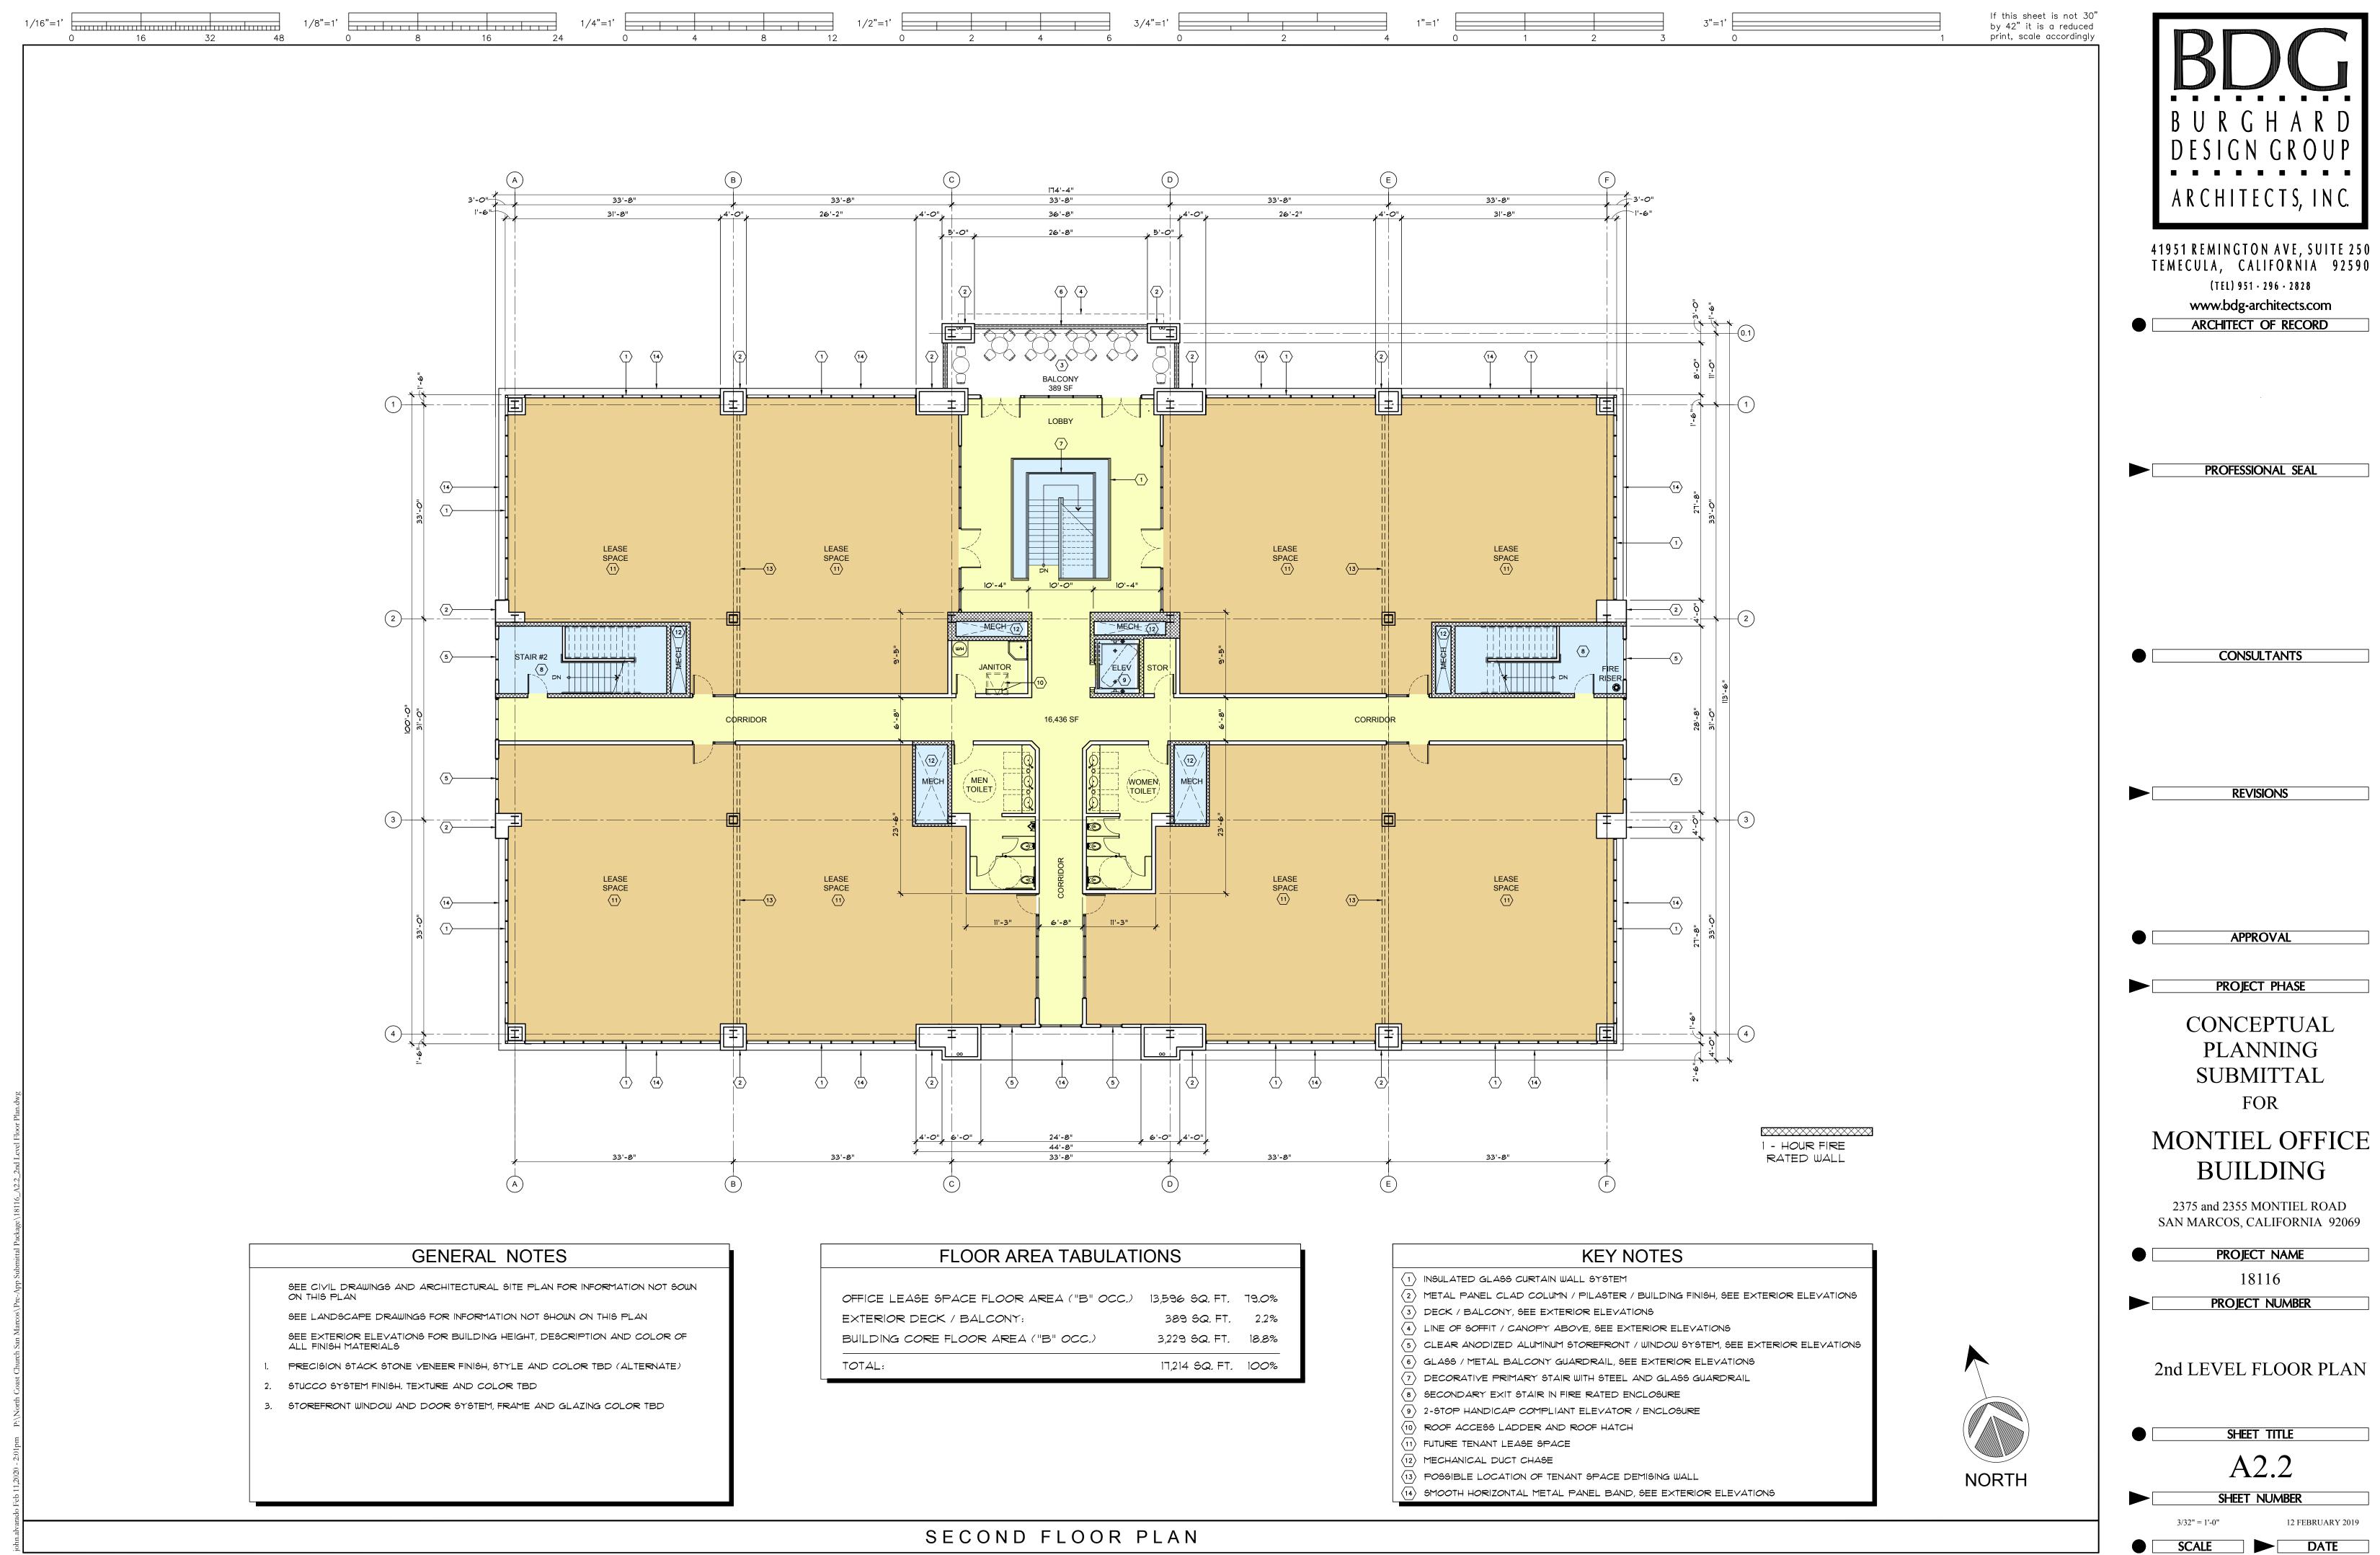


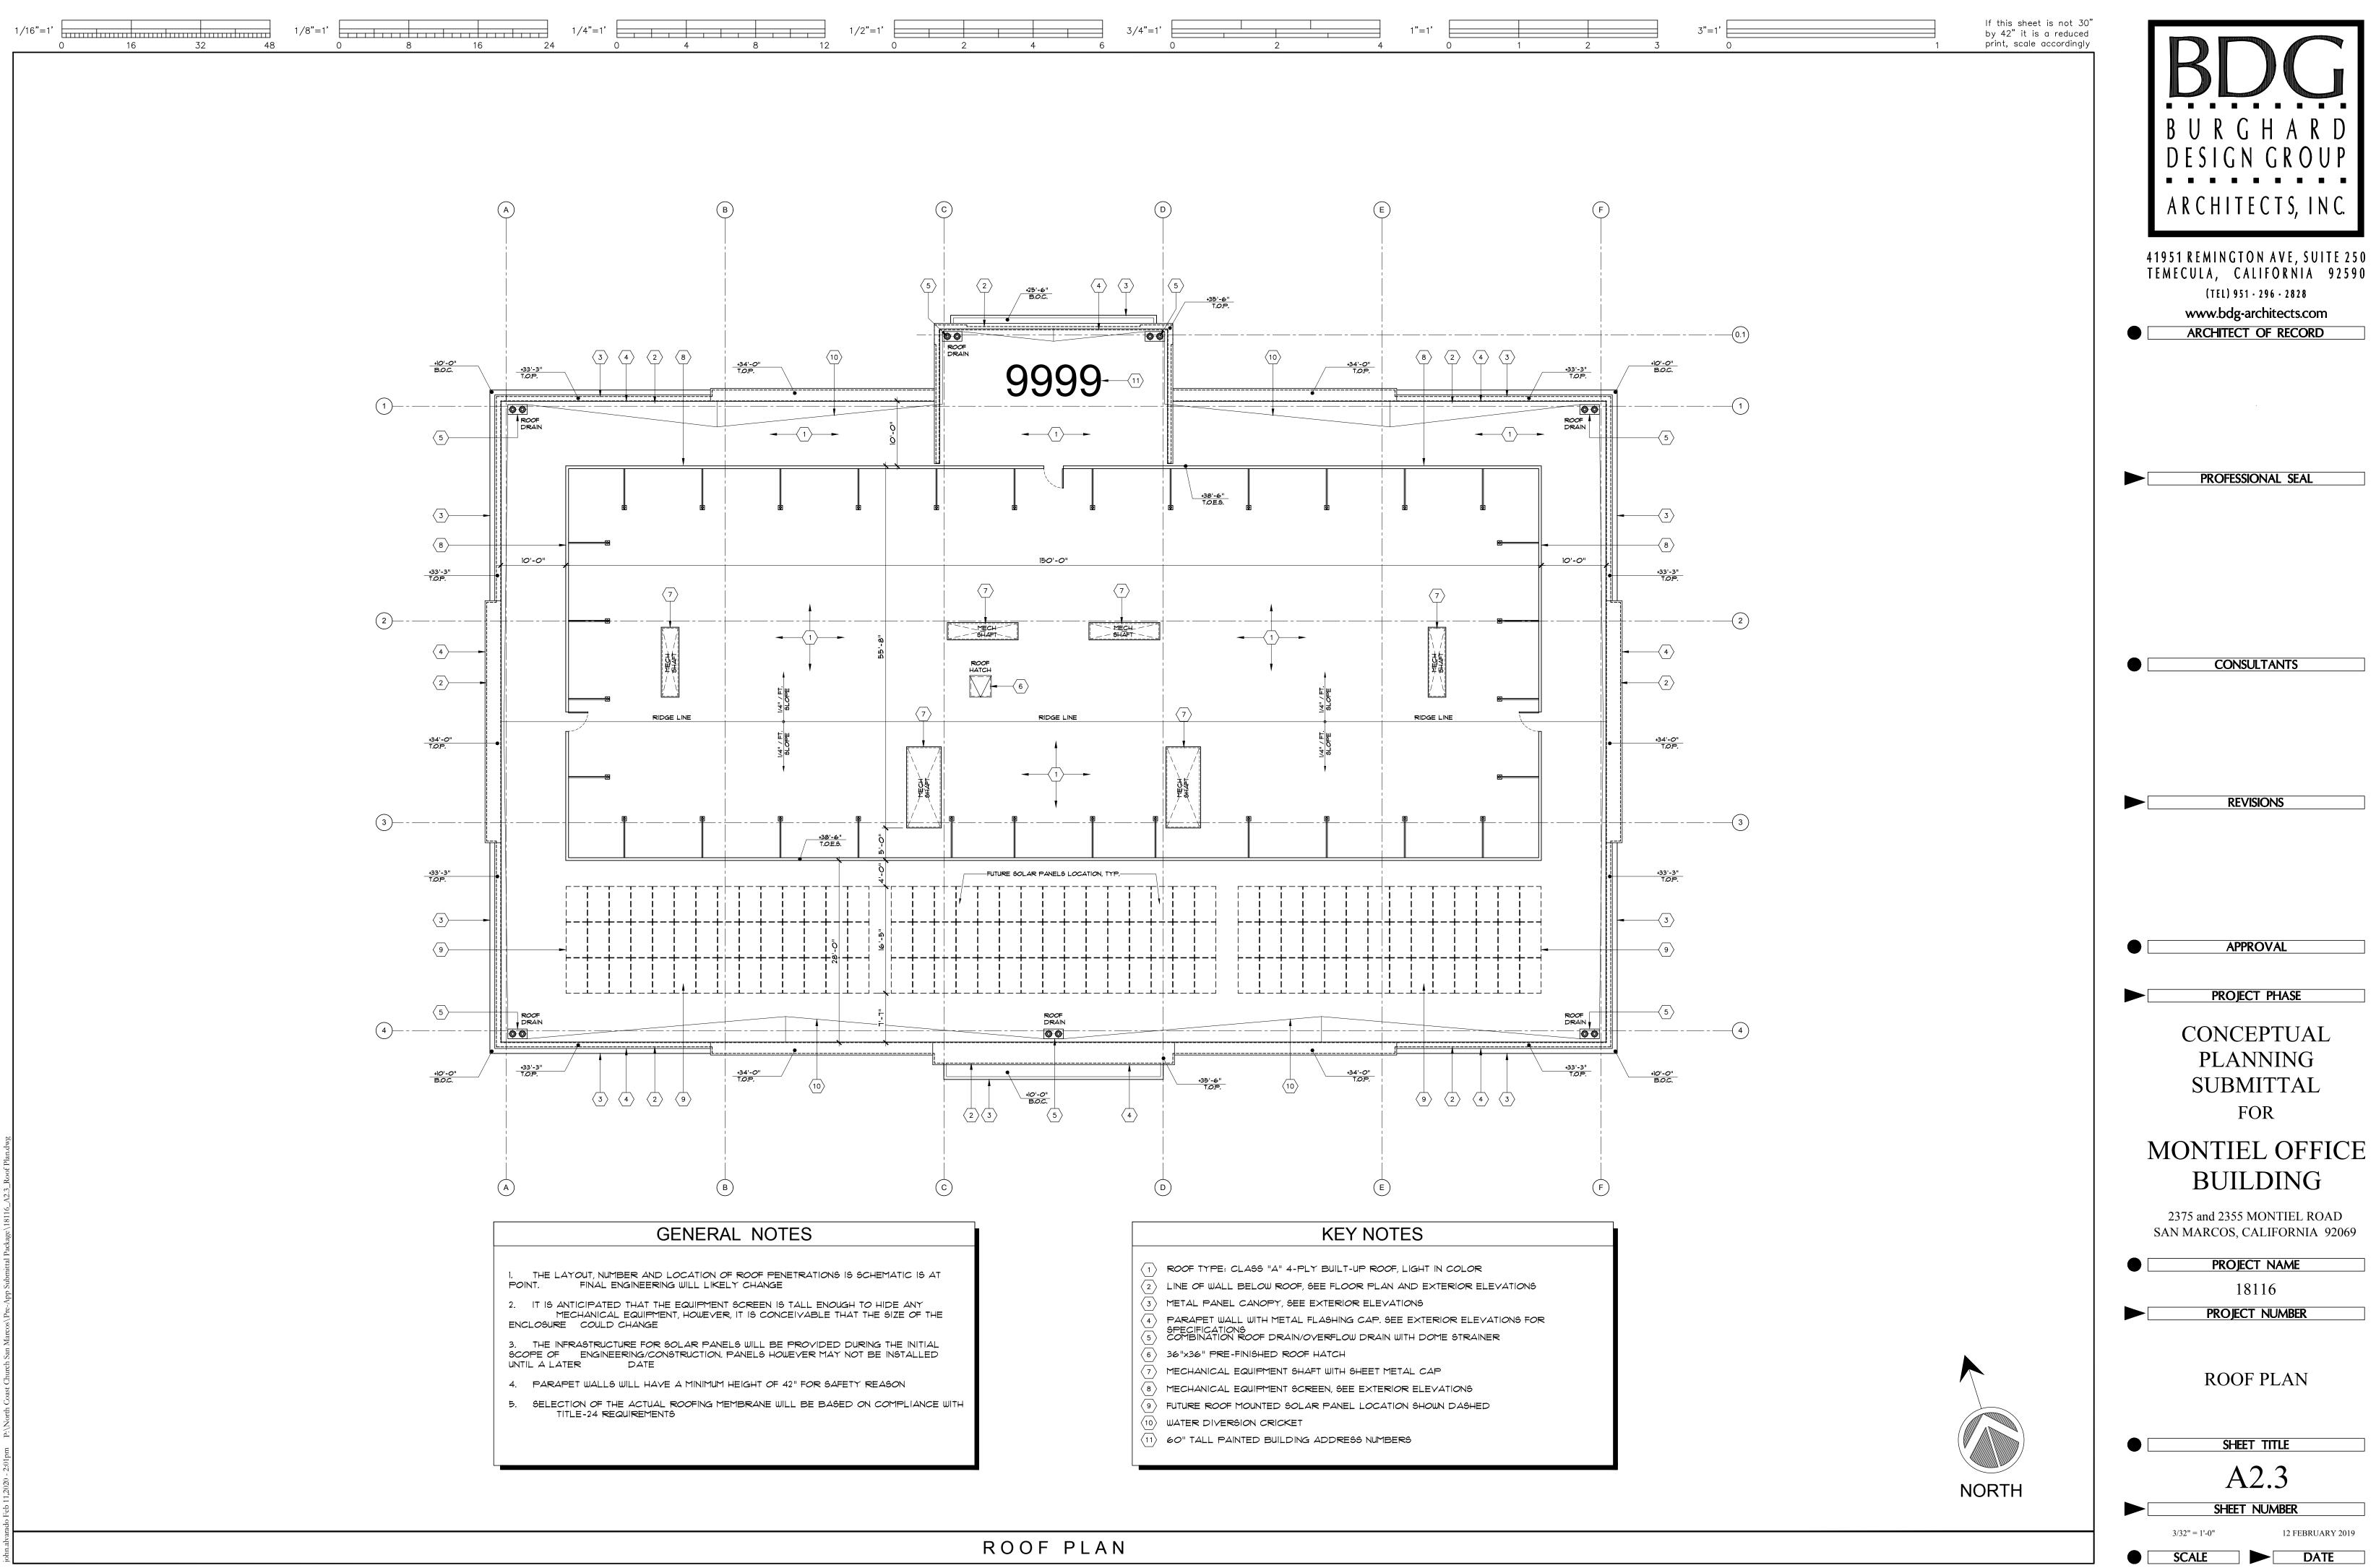




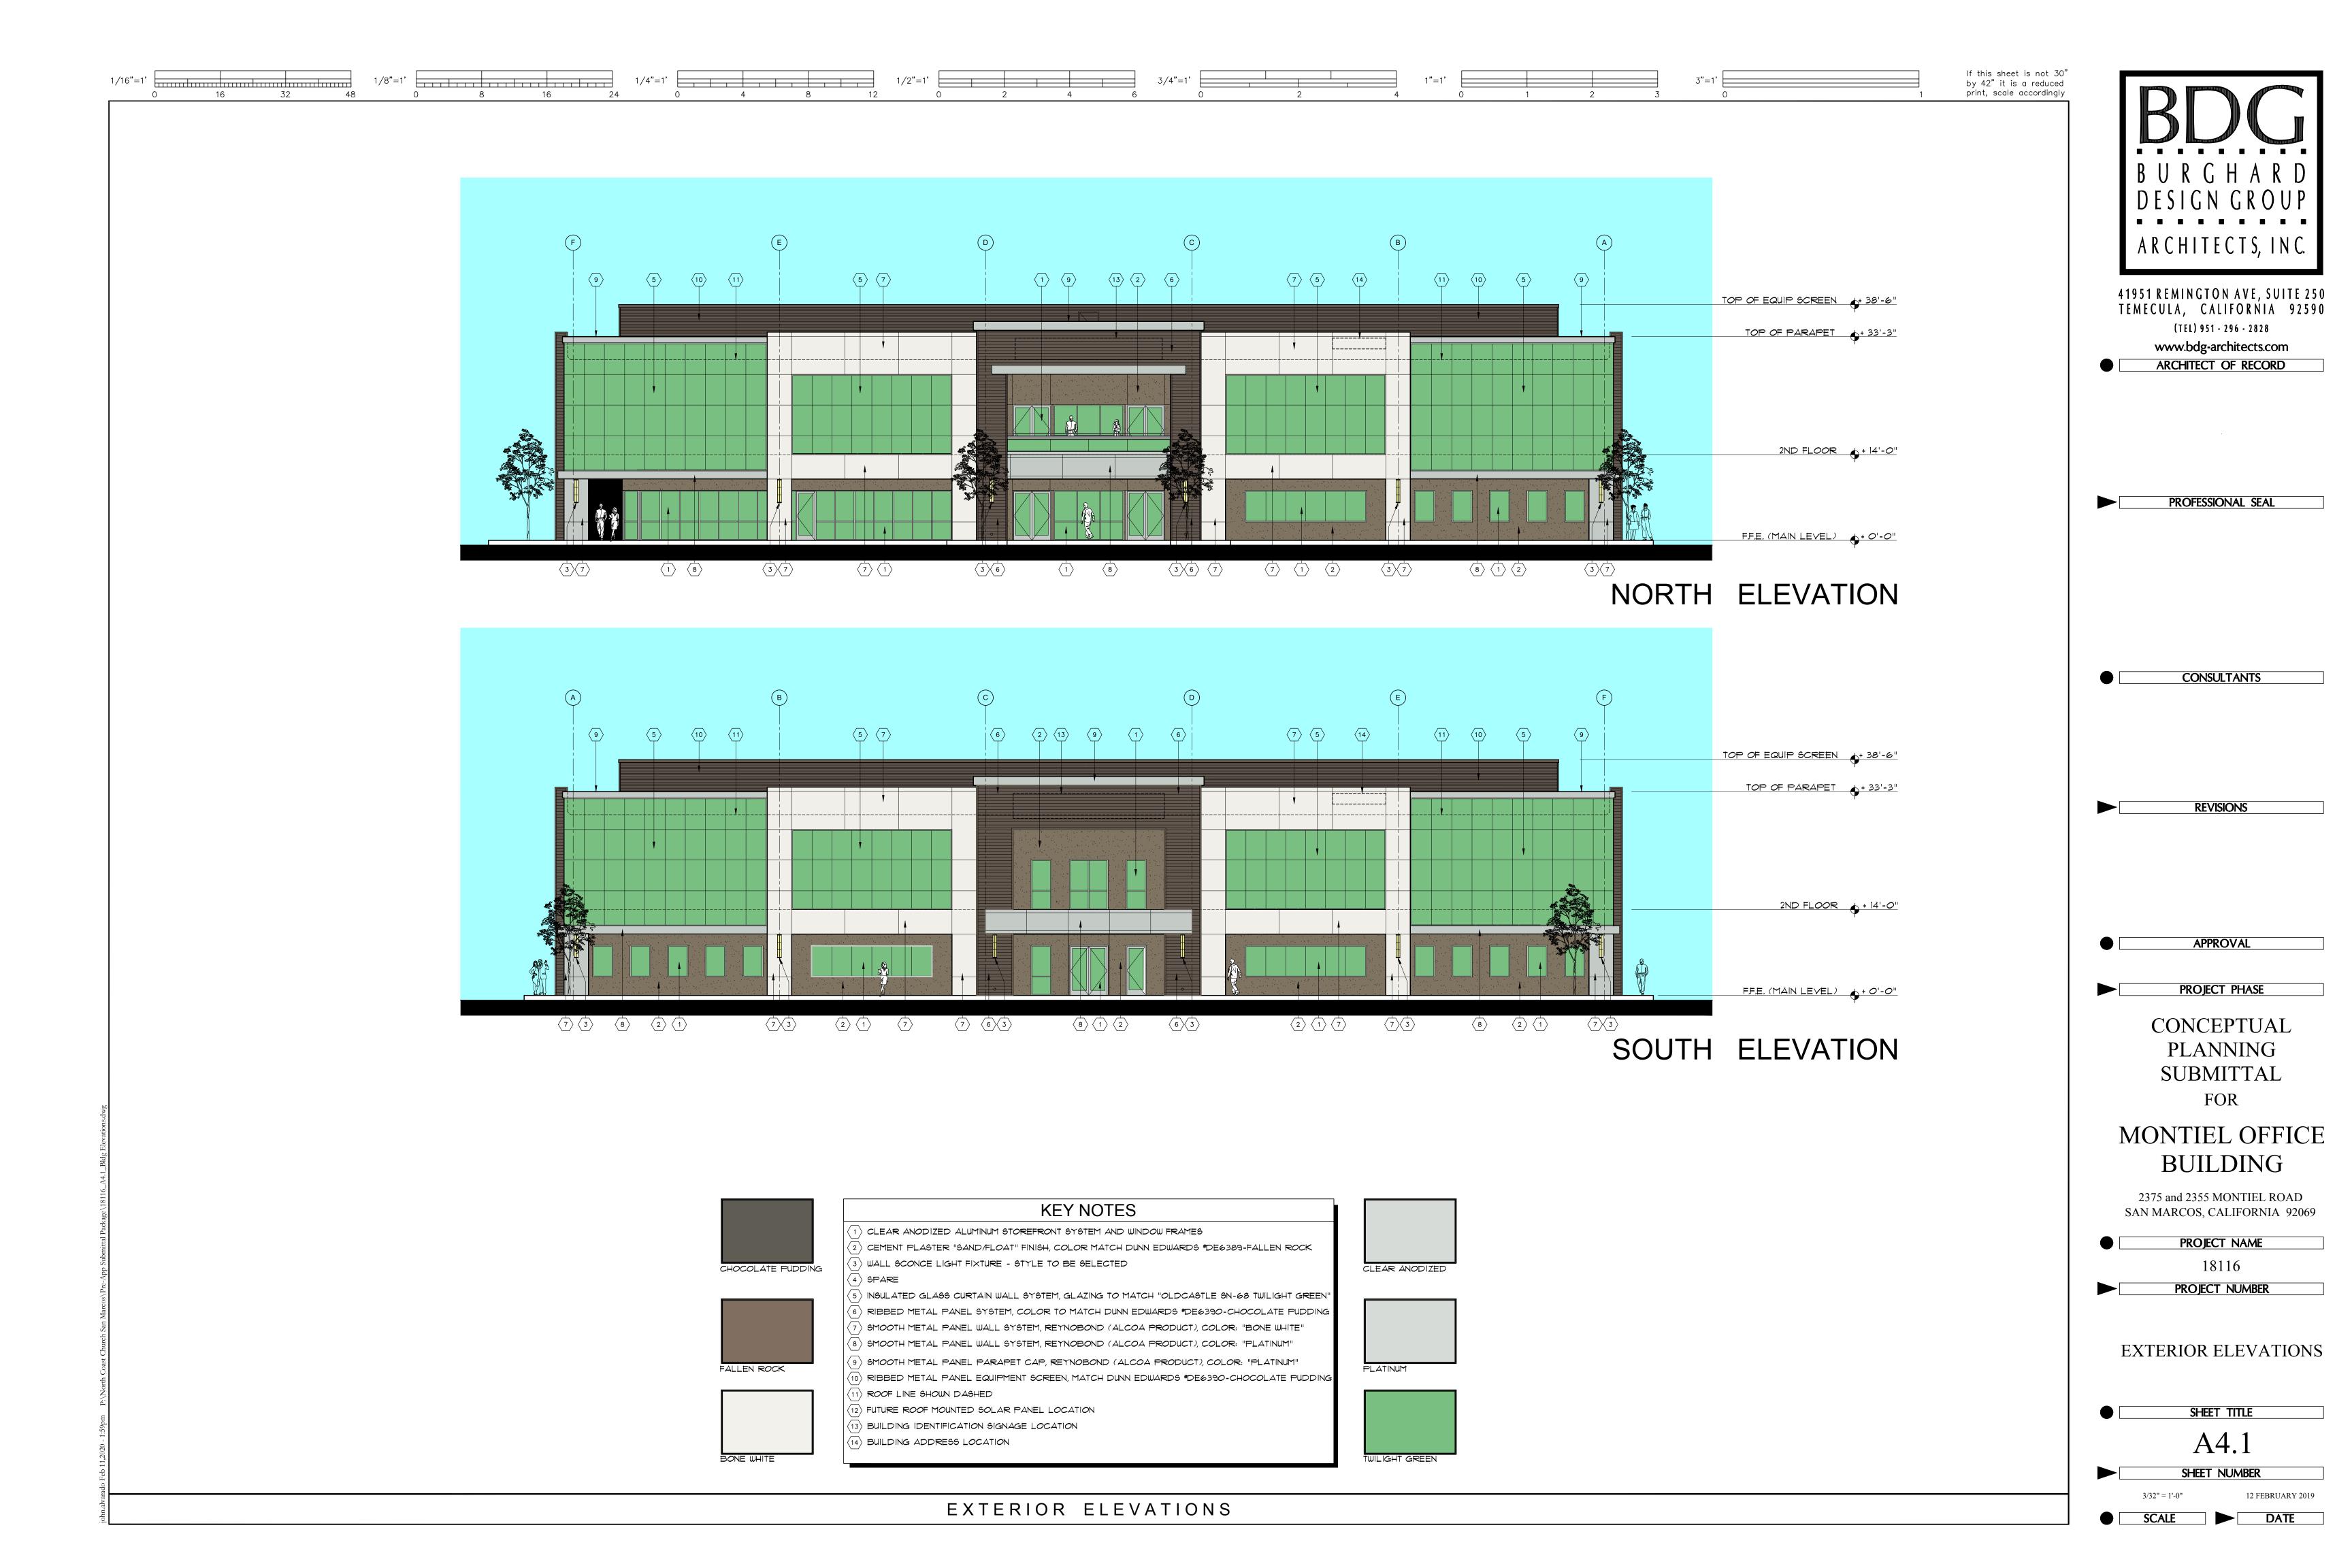


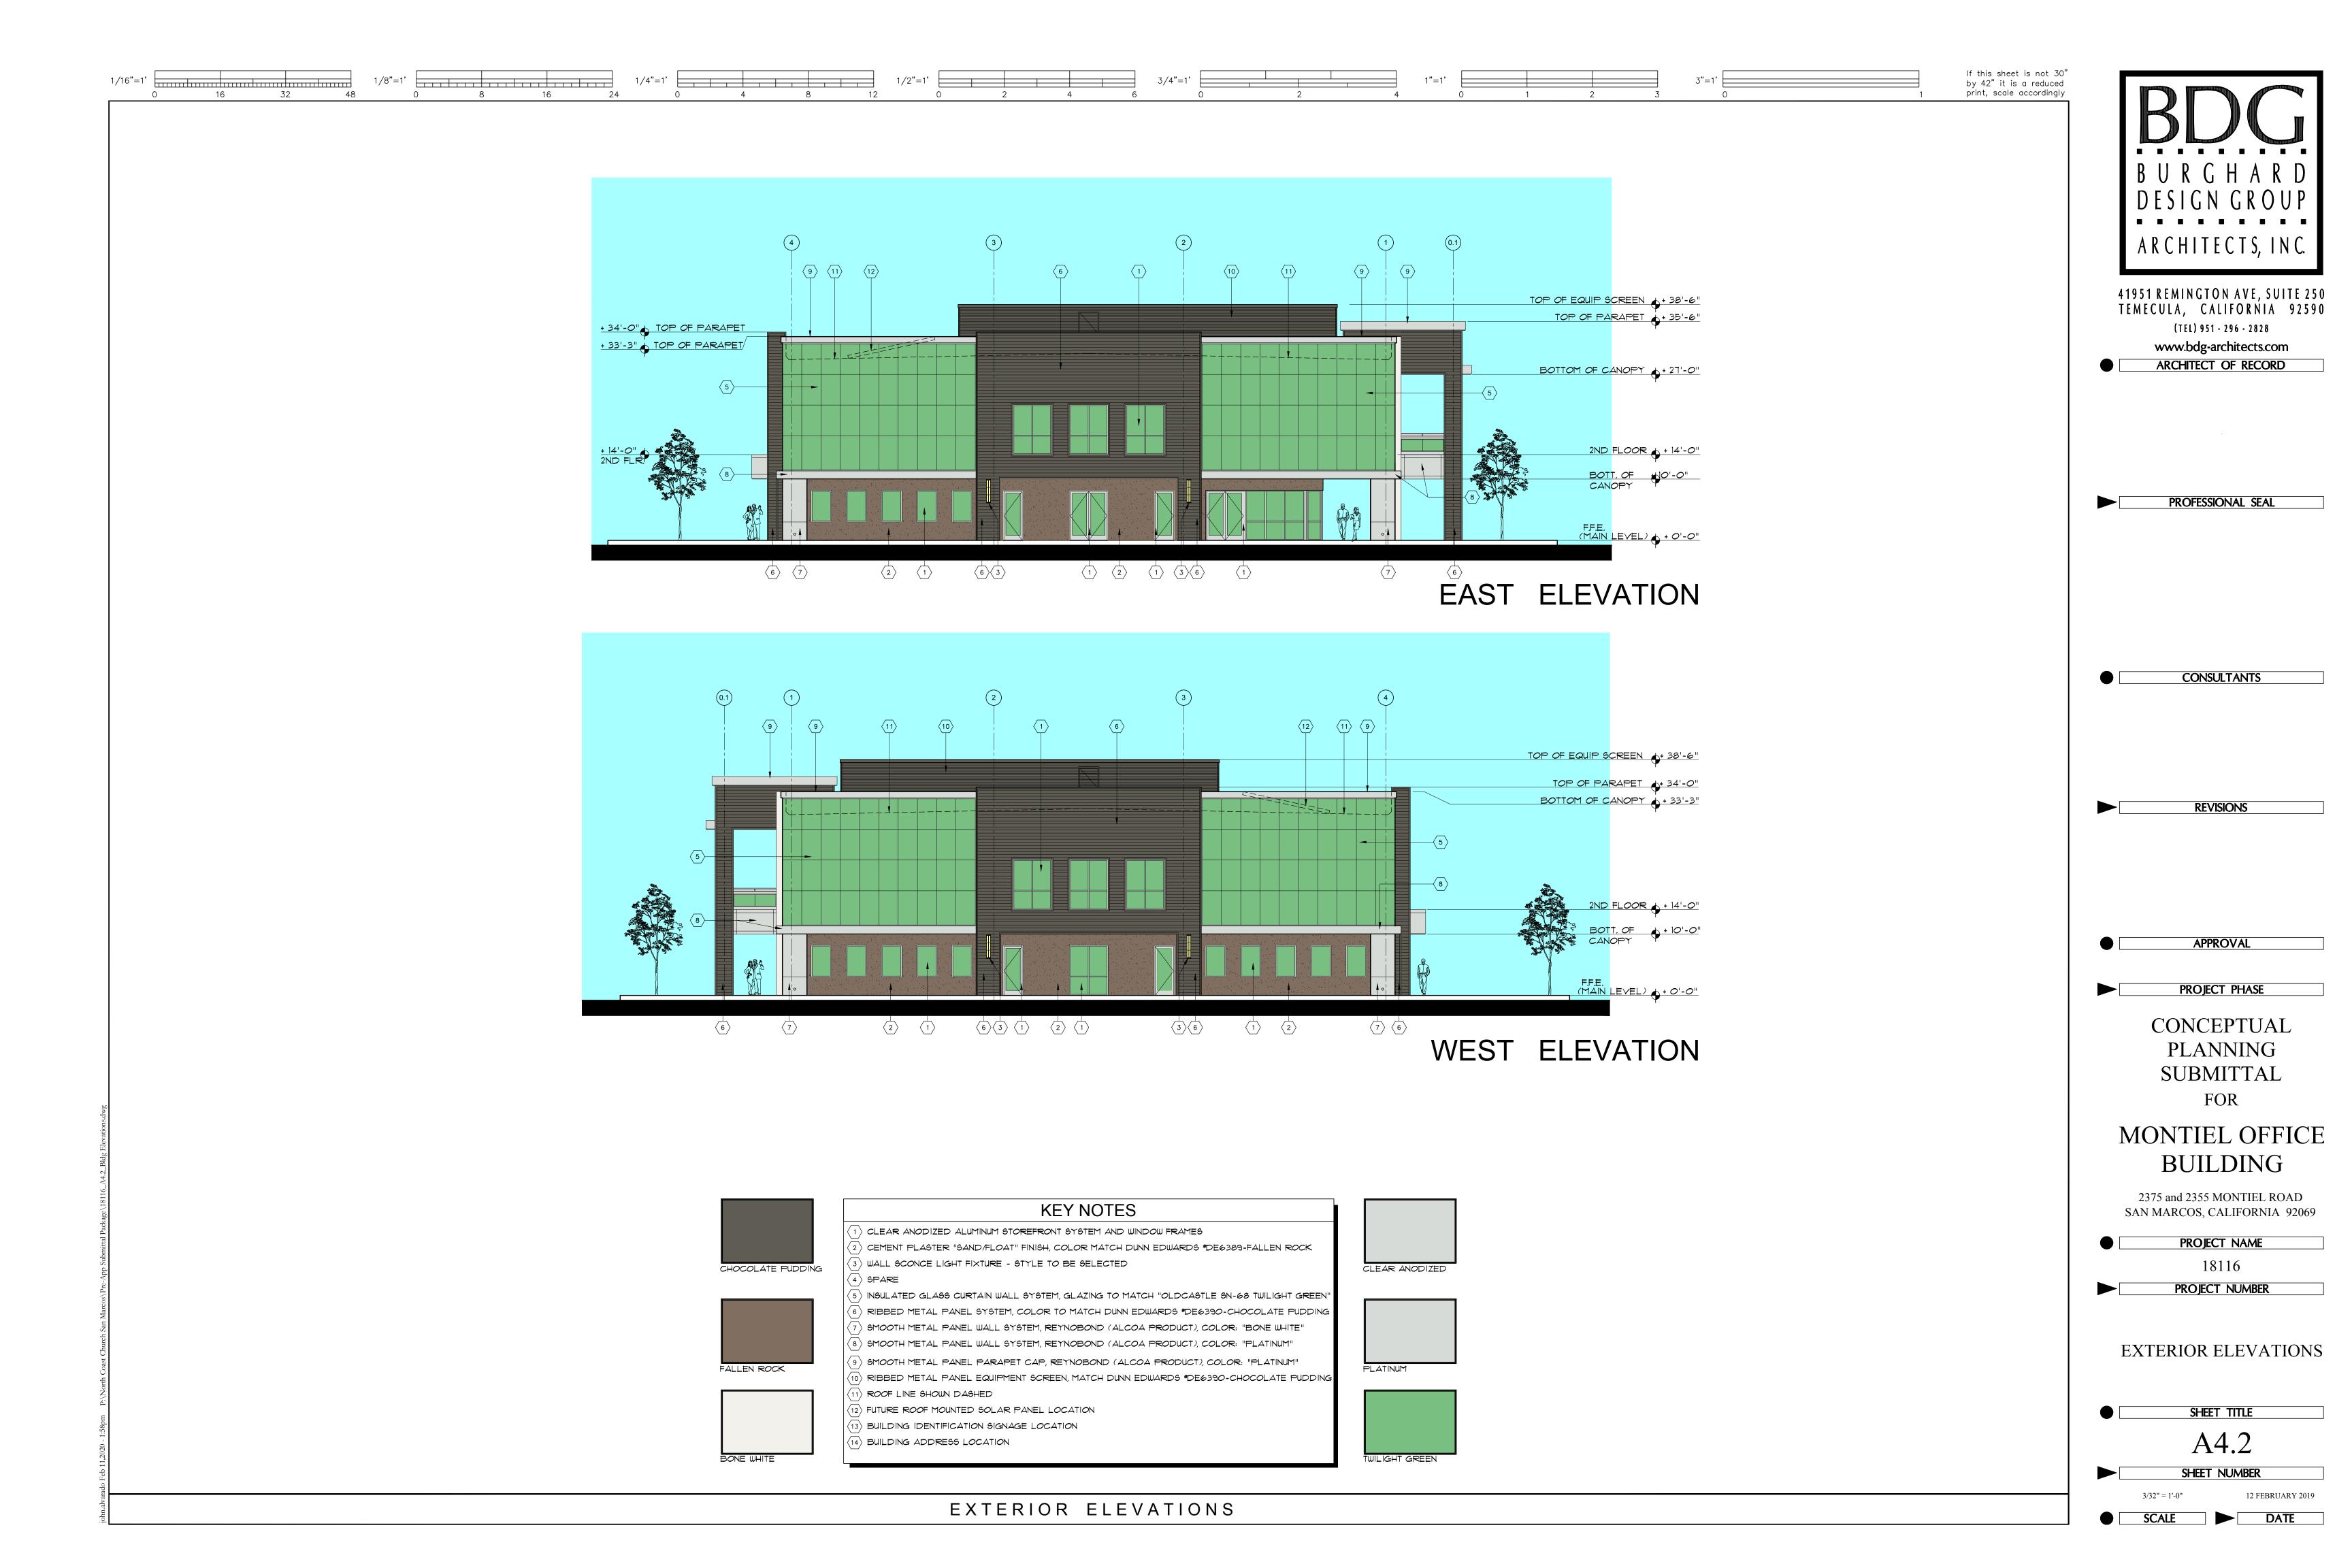


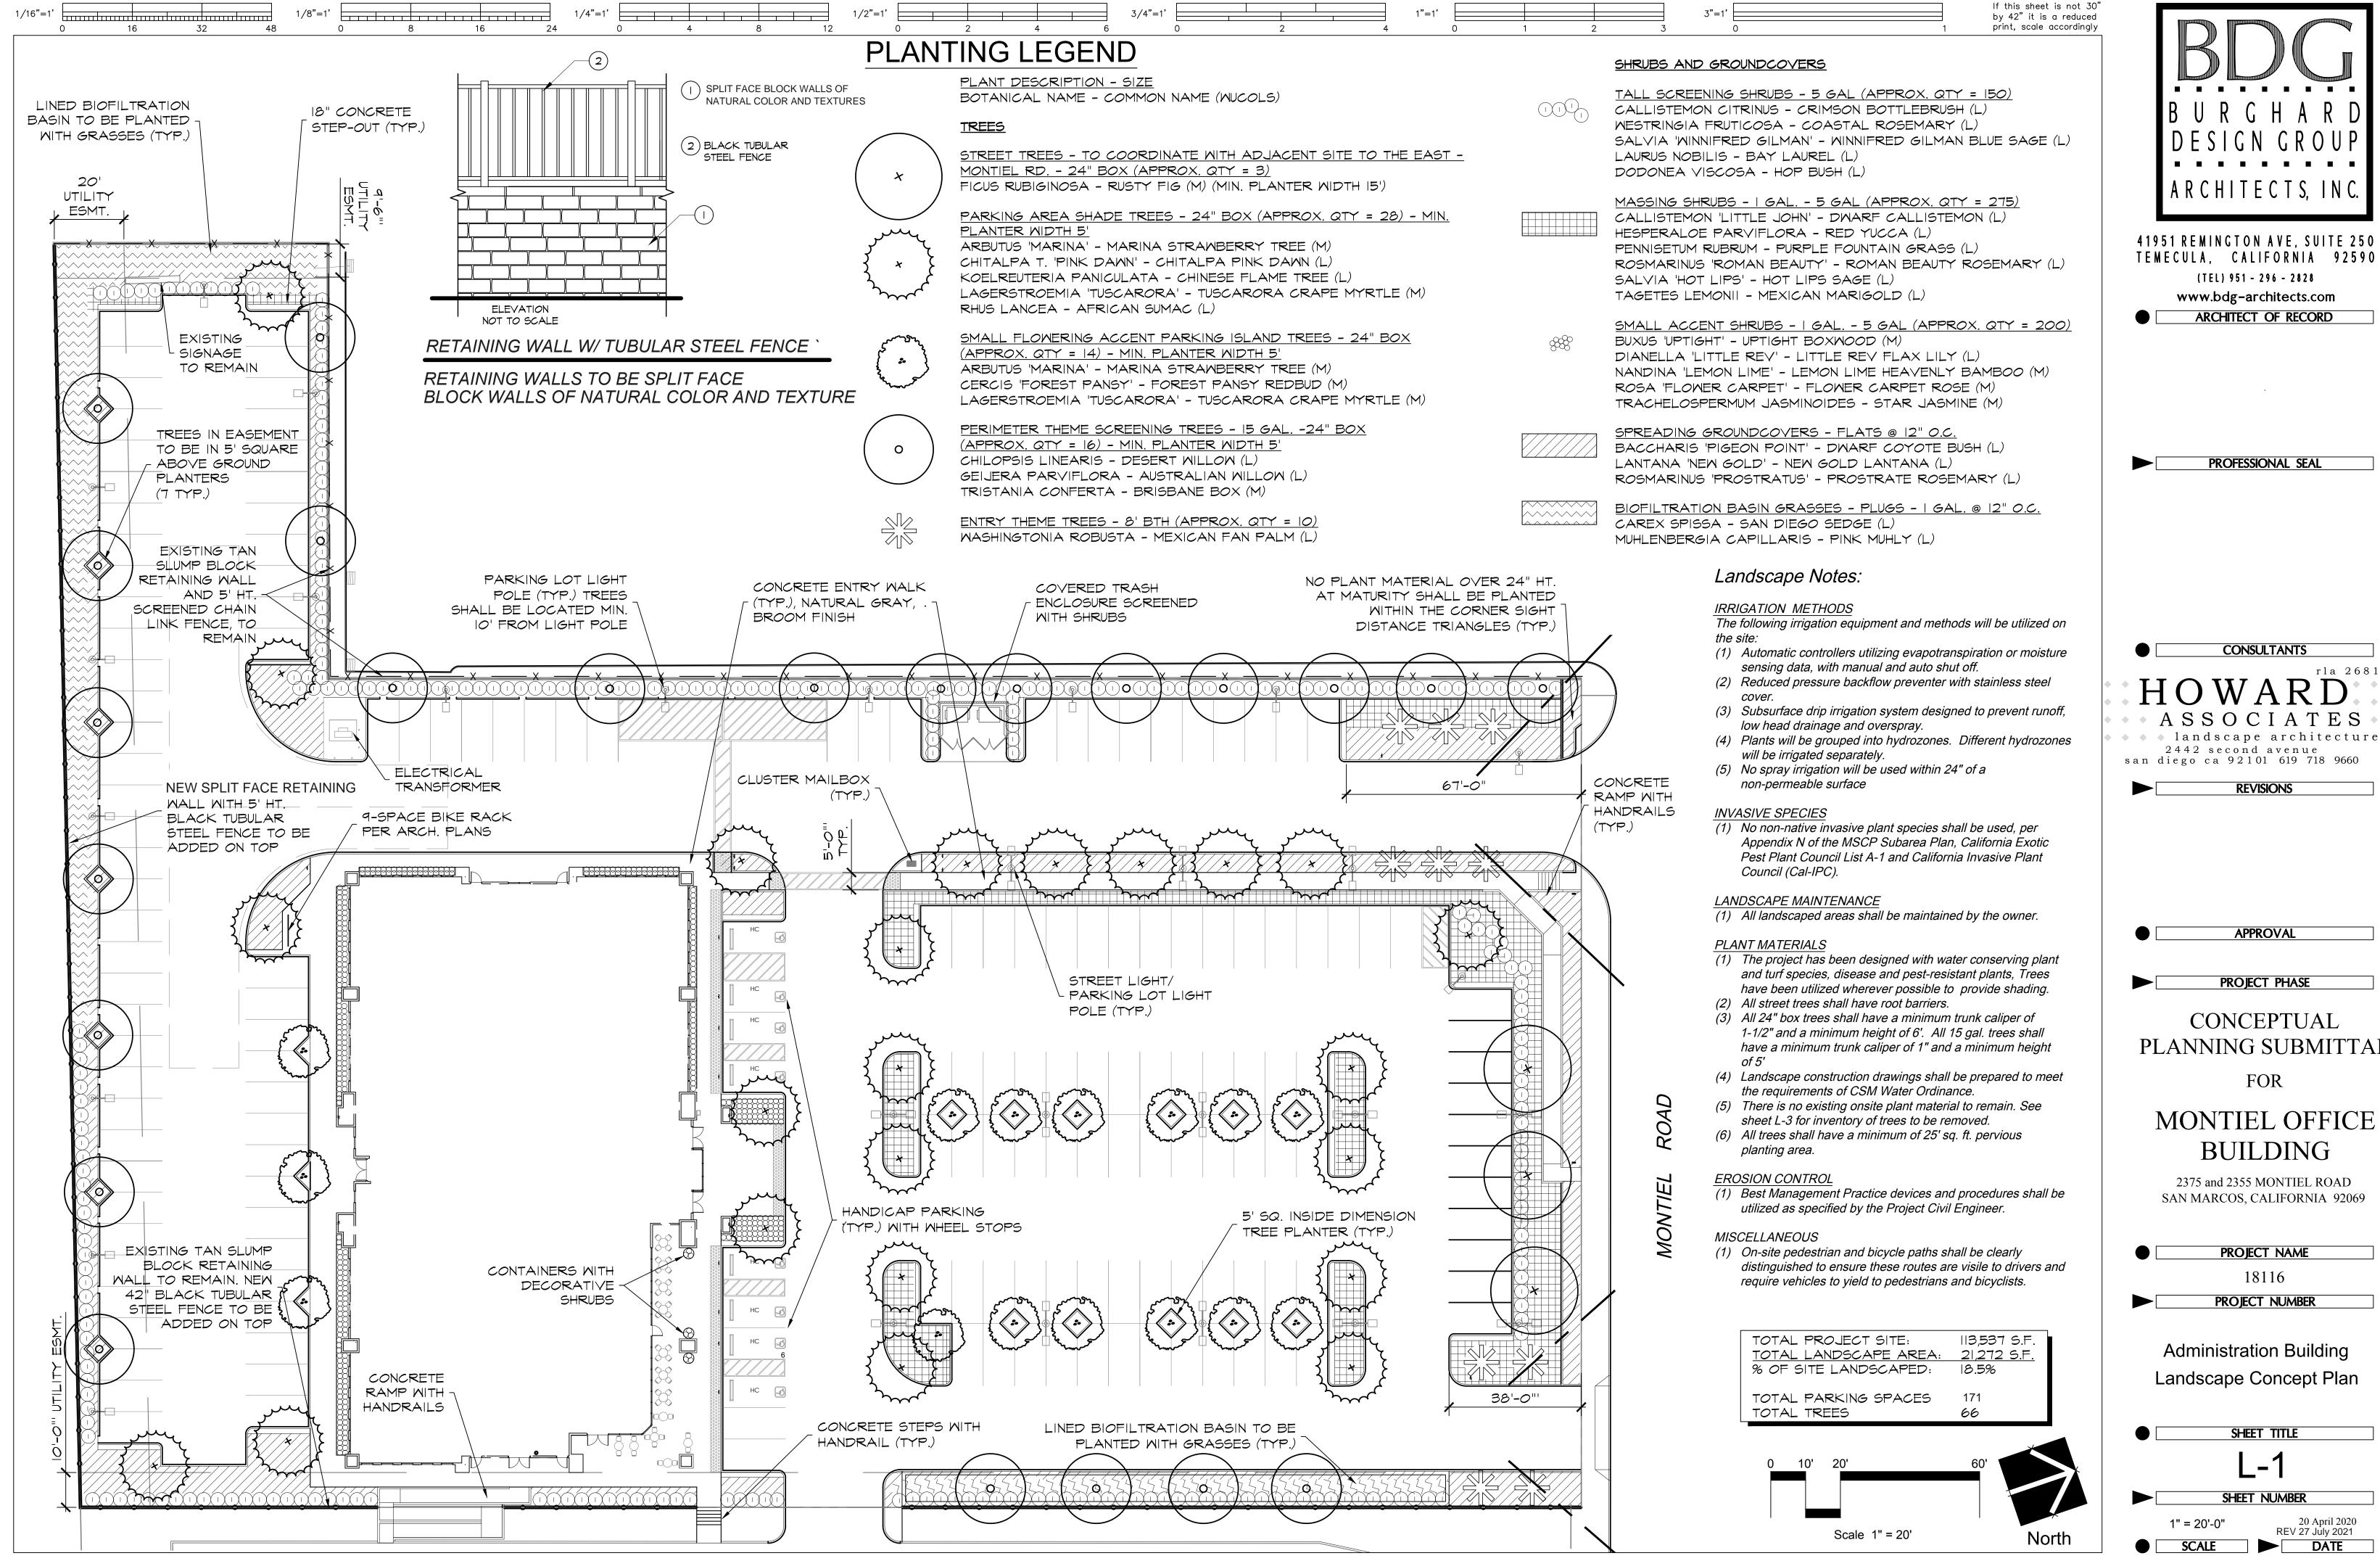




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