

## Appendix A

### Photometric Plan

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FOR  
REFERENCE  
ONLY


2/24/2021

## CONTRACTOR NOTE

1. THIS LIGHTING DESIGN IS BASED ON INFORMATION SUPPLIED BY OTHERS TO PAGE INTERWORKS, PA. SITE DETAILS PROVIDED HEREON ARE REPRODUCED ONLY AS A VISUALIZATION AID. FIELD DEVIATIONS MAY SIGNIFICANTLY AFFECT PREDICTED PERFORMANCE. PRIOR TO INSTALLATION, CRITICAL SITE INFORMATION (POLE LOCATIONS, ORIENTATION, MOUNTING HEIGHT, ETC.) SHOULD BE COORDINATED WITH THE CONTRACTOR AND/OR SPECIFIER RESPONSIBLE FOR THE PROJECT.
2. LUMINAIRE DATA IS TESTED TO INDUSTRY STANDARDS UNDER LABORATORY CONDITIONS. OPERATING VOLTAGE AND NORMAL MANUFACTURING TOLERANCES OF LAMP, BALLAST, AND LUMINAIRE MAY AFFECT FIELD RESULTS.

## WIFI POWER POLE NOTES

- 1) CONTRACTOR IS TO SUPPLY 4"x4"x20' ALUMINUM POLE TO MOUNT WIRELESS ACCESS POINT EQUIPMENT TO IF SITE LIGHTING POLE IS NOT AVAILABLE.
- 2) CONTRACTOR SHALL PROVIDE A 12"x12"x6" NEMA 3R JUNCTION BOX. JUNCTION BOX SHALL HOUSE THE OWNER SUPPLIED CISCO POWER INJECTOR. PROVIDE A CONTINUOUSLY POWERED 110V GFCI RECEPTACLE MOUNTED INSIDE THE JUNCTION BOX TO POWER THE CISCO POWER INJECTOR. JUNCTION SHALL BE NO MORE THAN 1' AWAY FROM THE WIRELESS ACCESS POINT (CISCO MR66).
- 3) CONTRACTOR TO INSTALL OWNER SUPPLIED WIRELESS ACCESS POINT (ROUTER, CISCO MR66) ABOVE THE NEMA 3R JUNCTION BOX. ROUTE CAT 5E CABLES FOR CISCO POWER INJECTOR OUTPUT INTO WIRELESS ACCESS POINT.
- 4) CONTRACTOR IS TO INSTALL OWNER SUPPLIED ANTENNA AT LEAST 20' ABOVE GRADE. ANTENNA HAS FOUR (4) CABLES THAT WILL CONNECT TO THE FOUR (4) INPUT PORTS ON THE WIRELESS ACCESS POINT.
- 5) CONTRACTOR SHALL VERIFY POLE BASE REQUIREMENTS WITH STRUCTURAL ENGINEER BASED ON SITE SOIL CONDITIONS.

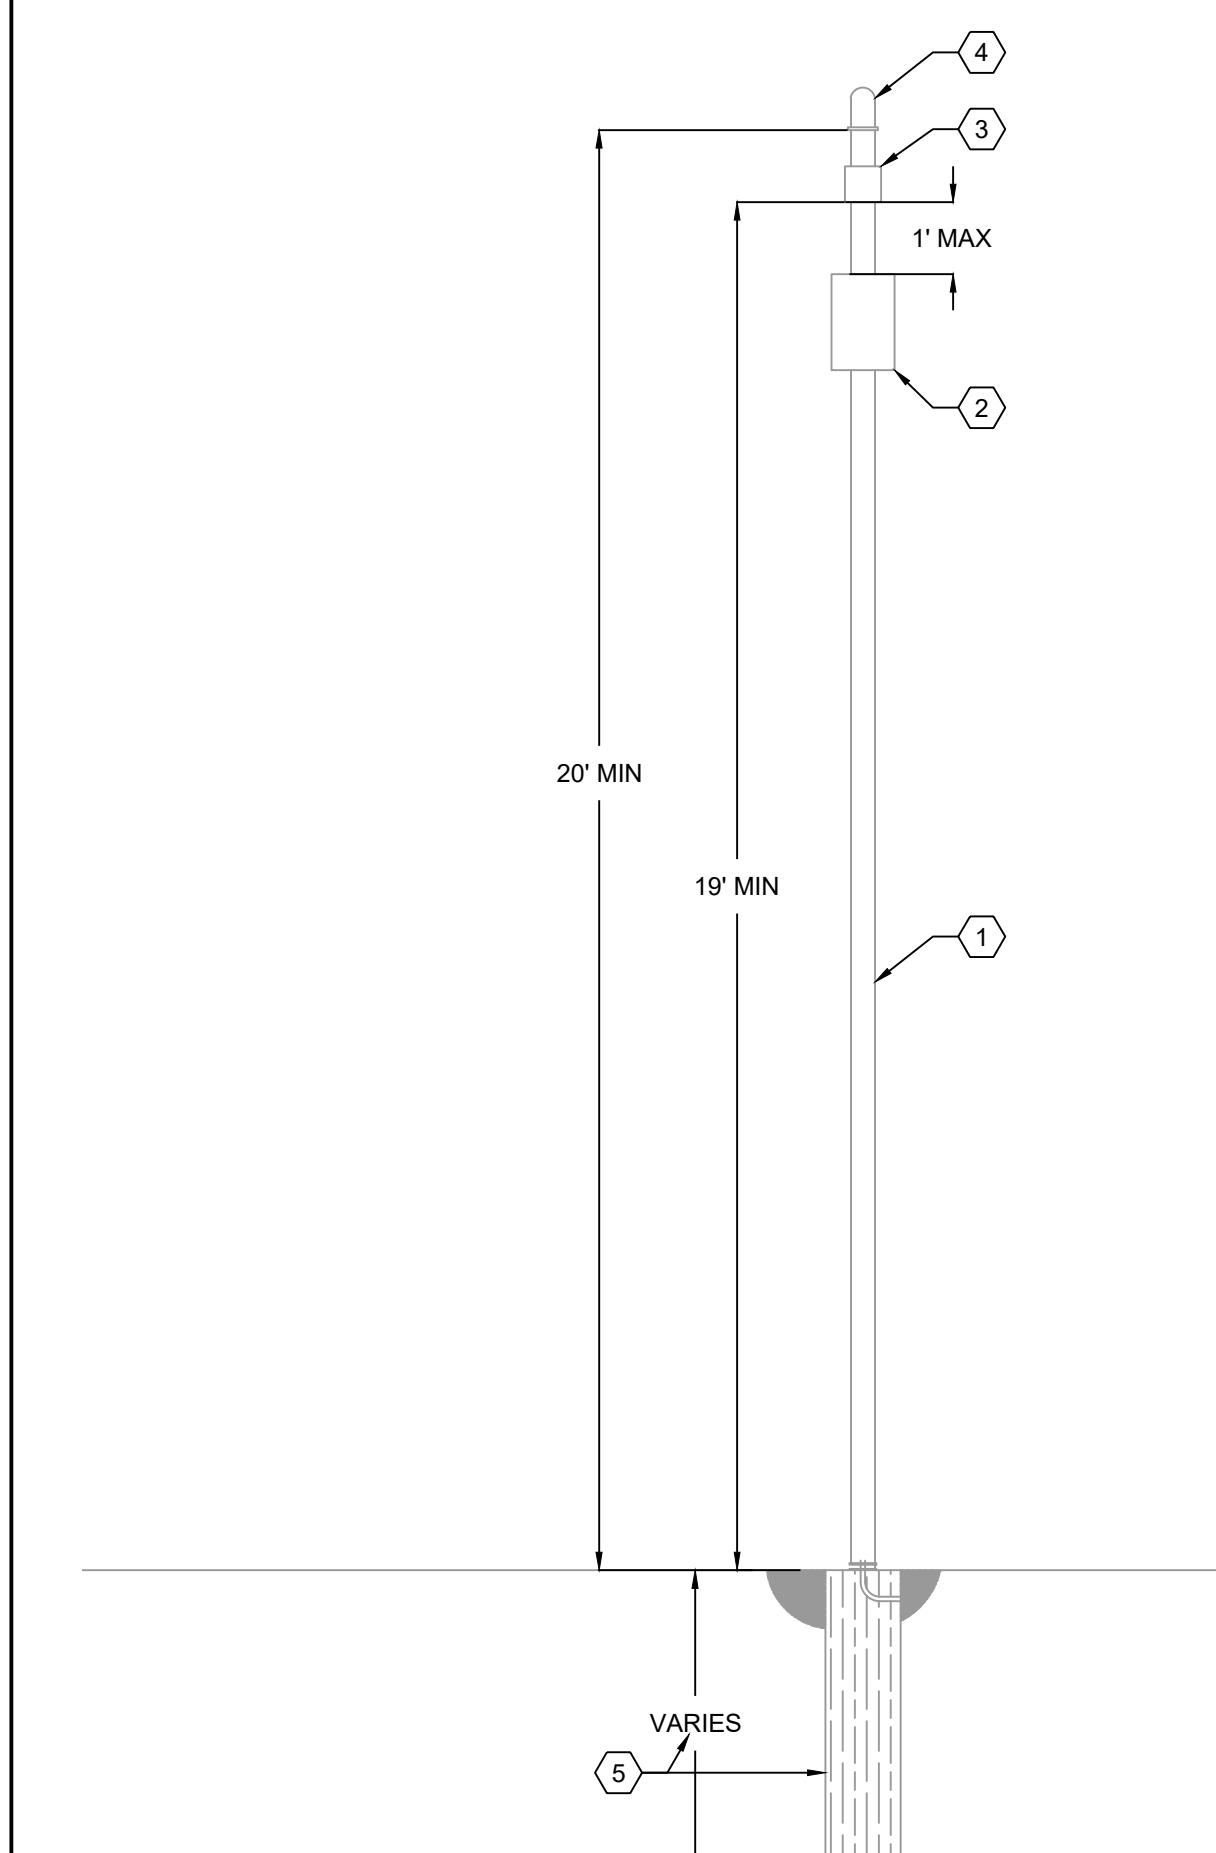

2  
ES1.2  
WIFI POWER POLE  
SCALE: 3/8" = 1'-0"

**PILOT FLYING J**  
DESIGN DEPARTMENT  
5508 LONAS ROAD  
KNOXVILLE, TENNESSEE 37909  
(865) 588-7488



**SITE PLAN  
PHOTOMETRIC**  
**PILOT TRAVEL CENTER**  
ADDRESS  
PALMDALE, CA

DATE: 07/03/20	DRAWN BY: KEC [PROJECT: 1267-01]	DESIGNED BY: MP	PAGE: 20/22
DATE: REV:	REVISION DESCRIPTION:	INT:	

**PAGE**  
INTERWORKS, P.A.  
ENGINEERS & CONSULTANTS  
923 MAIN STREET, NORTH WILKESBORO, NC 28659  
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**ES1.2**

Luminaire Schedule						
Symbol	Qty	Label	Arrangement	Total Lamp Lumens	LLF	Description
▪	52	UC	SINGLE	N.A.	0.810	CPY250-B-xx-F-B-UL-xx-57K CANOPY RECESSED
▪	13	GS	SINGLE	N.A.	0.810	CPY250-B-xx-F-A-UL-xx-30K 10'-6"
▪	9	FL	SINGLE	N.A.	0.810	XSPW-B-xx-2ME-4L-40K-UL CONFIGURED FROM XSPW-B-xx-2ME-8L-40K-UL 11'-6"
▪	6	SBC	SINGLE	N.A.	0.810	XSPW-B-xx-4ME-4L-40K-UL CONFIGURED FROM XSPW-B-xx-4ME-8L-40K-UL 20'-0"
▪	6	SB	SINGLE	N.A.	0.810	OSQ-A-xx-4ME-B-57K-UL CONFIGURED FROM OSQ-A-xx-4ME-B-30K-UL 15'-0"
▪	4	SD	SINGLE	N.A.	0.810	OSQ-A-xx-2ME-T-57K-UL CONFIGURED FROM OSQ-A-xx-2ME-U-40K-UL 25'-0"
▪	9	SBS	SINGLE	N.A.	0.810	OSQ-A-xx-4ME-B-57K-UL w. OSO-BLMF CONFIGURED FROM OSQ-A-xx-4ME-B-57K-UL 15'-0"
▪	5	SB2	BACK-BACK	N.A.	0.810	OSQ-A-xx-4ME-T-57K-UL CONFIGURED FROM OSQ-A-xx-4ME-U-40K-UL 25'-0"
▪	10	SB1	SINGLE	N.A.	0.810	OSQ-A-xx-4ME-B-57K-UL CONFIGURED FROM OSQ-A-xx-4ME-B-30K-UL 25'-0"
▪	4	SB2a	BACK-BACK	N.A.	0.810	OSQ-A-xx-4ME-B-57K-UL CONFIGURED FROM OSQ-A-xx-4ME-B-30K-UL 15'-0"
▪	2	SB4	4 @ 90 DEGREES		0.810	OSQ-A-xx-4ME-B-57K-UL CONFIGURED FROM OSQ-A-xx-4ME-B-30K-UL 15'-0"

Calculation Summary						
Label	CalcType	Units	Avg	Max	Min	Avg/Min
CalcPb_1	Illuminance	Fc	0.69	53.1	0.0	N.A.
WEST PROPERTY LINE (AUTO AREA)	Illuminance	Fc	0.97	2.8	0.0	N.A.
WEST PROPERTY LINE (TRUCK AREA)	Illuminance	Fc	0.00	0.0	0.0	N.A.
AUTO PARKING AREA	Illuminance	Fc	4.91	25.8	0.3	16.37
TRUCK PARKING AREA	Illuminance	Fc	3.54	42.2	0.2	21.00

