PROJECT ADDRESS: 3701 N. PACFIC PLACE, LONG BEACH CA PERMIT #:

WORK DESCRIPTION: CLEAR AND GRUB EXISTING SITE PRIOR TO CONSTRUCTION OF 3 STORY 51,000 SQUARE FOOT SELF STORAGE BUILDING AND PARKING LOT.

1. GRADING WORK SHALL BE DONE IN ACCORDANCE WITH THE CALIFORNIA BUILDING CODE 2013 AND LOCAL AMENDMENTS ADOPTED BY THE CITY OF LONG BEACH.

2. RECOMMENDATIONS INCLUDED IN THE CONSULTANT SOILS AND GEOLOGY REPORT BY NOVEMBER 14, 2019 CARL KIM GEOTECHNICAL, INC. (SOILS ENGINEER) (DATE)

945 BAILEYANA ROAD, HILLSBOROUGH, CA 94010

AND ALL ADDENDA SHALL BE COMPLIED WITH AND ARE A PART OF THE GRADING PLANS AND SPECIFICATIONS.

(949) 441-8143

(TELEPHONE)

YARDAGE QUANTITIES FOR PERMIT PURPOSES: \*\* CUT 45,900 CY, FILL 51,800 CY, IMPORT 5,900 CY REMOVAL / RECOMPACTION 8,000± CY

4. THE CONTRACTOR SHALL OBTAIN A PERMIT FROM CALIFORNIA DIVISION OF INDUSTRIAL SAFETY FOR THE CONSTRUCTION OF TRENCHES OR EXCAVATIONS WHICH ARE FIVE FEET OR DEEPER. SHEETING. SHORING. AND BRACING FOR THE TRENCH EXCAVATION SHALL CONFORM TO THE REQUIREMENTS OF "CONSTRUCTION SAFETY ORDERS," TITLE 8, DIVISION OF INDUSTRIAL SAFETY, STATE OF CALIFORNIA.

5. FOR PROJECTS GREATER THAN 1 ACRE IN SIZE. A COPY OF THE STORM WATER POLLUTION PREVENTION PLAN (SWPPP) WITH NOTICE OF INTENTION (NOI) MUST BE IN THE POSSESSION OF A RESPONSIBLE PERSON AND AVAILABLE AT THE SITE AT ALL TIMES.

6. ALL PROPERTY LINE AND CORNERS (LOT BOUNDARY) SHALL BE CLEARLY DELINEATED IN THE FIELD PRIOR TO COMMENCEMENT OF ANY CONSTRUCTION/GRADING.

7. DUST SHALL BE CONTROLLED BY WATERING OR OTHER APPROVED METHODS.

8. FILL PLACEMENT AREAS SHALL BE INSPECTED AND APPROVED BY THE CONSULTANT GEOLOGIST AND SOILS ENGINEER PRIOR TO PLACEMENT OF ANY FILL.

9. THE CONSTRUCTION DOCUMENTS AND RELATED WORKS ARE REQUIRED AS FOLLOWS: A. ALL GRADING SLOPES SHALL BE PLANTED AND SPRINKLERED. B. NO FILL TO BE PLACED UNTIL CITY INSPECTORS HAS INSPECTED AND APPROVED THE

BOTTOM EXCAVATION. C. ALL FILL SHALL BE COMPACTED TO A MIN. RELATIVE COMPACTION OF 90%.

D. TEMPORARY EROSION CONTROL TO BE INSTALLED DURING CONSTRUCTION.

10. THE FOLLOWING BMPS SHALL BE USED AS APPLICABLE: BIOFILTRATION AND DETENTION SYSTEM A REGISTERED CIVIL ENGINEER SHALL SUBMIT TO THE CITY OF LONG BEACH DEVELOPMENT DEPARTMENT SERVICES CENTER WRITTEN CERTIFICATION OF COMPLETION IN ACCORDANCE WITH THE APPROVED GRADING PLAN PRIOR TO ISSUANCE OF THE BUILDING PERMIT. CERTIFICATIONS SHALL BE TO LINE, GRADE, ELEVATION AND LOCATION OF CUT AND FILL SLOPES.

11. GRADING SHALL BE DONE UNDER THE SUPERVISION OF A SOILS ENGINEER WHO SHALL CERTIFY THAT ALL FILL HAS BEEN PROPERLY PLACED AND WHO SHALL SUBMIT A FINAL COMPACTION REPORT FOR ALL FILLS OVER 1 FOOT DEEP.

12. A CALIFORNIA REGISTERED CIVIL ENGINEER OR LICENSED LAND SURVEYOR SHALL SUBMIT CERTIFICATION OF BUILDING PAD ELEVATION WHERE SPECIFIC ELEVATIONS ARE REQUIRED. THE ELEVATION WITH RESPECT TO MEAN SEA LEVEL SHALL BE GIVEN. IF AN ELEVATION WITH RESPECT TO ADJACENT GROUND SURFACE IS REQUIRED THE ACTUAL DISTANCE ABOVE THE ADJACENT GROUND SHALL BE GIVEN.

13. A STANDBY CREW FOR EMERGENCY WORK SHALL BE AVAILABLE AT ALL TIMES DURING THE RAINY SEASON (OCTOBER 1 TO APRIL 15). THE CONTRACTOR SHALL PROVIDE PROTECTIVE MEASURES AND TEMPORARY DRAINAGE FACILITIES TO PROTECT ADJOINING PROPERTIES AND THE PUBLIC RIGHT-OF-WAY FROM MUD, SILT AND STORM WATERS ORIGINATING ON OR DIVERTED FROM THE CONSTRUCTION SITE. CONSTRUCT TEMPORARY DESILTING BASIN FOR TRAPPING MUD, DEBRIS. ETC.. AND TO CLEAR THE WATER PRIOR TO DEWATERING BY ANY ACCEPTABLE MEANS LIKE PUMPING. WHEN WATER HAS BEEN CLEARED, PUMPING CAN BE MADE DIRECTLY INTO THE EXISTING PUBLIC STORM DRAIN SYSTEM. THE CONTRACTOR SHALL BE RESPONSIBLE FOR CLEANING THE SAID STORM DRAIN AFTER COMPLETION OF DEWATERING. DEWATERING OR PUMPING DIRECTLY, OR SHEET FLOW OVER PUBLIC SIDEWALK AND ROAD SURFACE, WILL NOT BE PERMITTED. DEWATERING OR PUMPING INTO THE LOS ANGELES COUNTY OR CALTRANS STORM DRAIN SYSTEM MAY REQUIRE PERMITS FROM SAID AGENCIES. THEY SHALL BE CONSULTED BEFORE DOING THE WORK.

14. SANITARY FACILITIES SHALL BE MAINTAINED ON THE SITE FROM BEGINNING TO COMPLETION OF GRADING OPERATION

15. ANY MODIFICATIONS OF OR CHANGES IN APPROVED GRADING PLANS MUST BE APPROVED BY THE BUILDING OFFICIAL

16. FINAL GRADING MUST BE COMPLETED BEFORE OCCUPANCY OF BUILDING WILL BE ALLOWED. 17. FOR SITES SUSPECTED TO CONTAIN HAZARDOUS MATERIALS OR FOR THE PURPOSE OF DETERMINING APPLICABILITY OF THE HAZARDOUS WASTE CONTROL LAWS, THE CONTRACTOR/ DEVELOPER PRIOR TO STARTING OF GRADING OPERATIONS SHALL FILE APPLICATIONS FOR SITE CHARACTERIZATION PERMIT WITH THE DEPARTMENT OF HEALTH. ALL SITE REMEDIATION IF REQUIRED SHALL CONFORM WITH ALL APPLICABLE LOCAL AND STATE REGULATORY AGENCIES AND CONTRACTOR/ DEVELOPER SHALL OBTAIN THE NECESSARY PERMITS. FOR ADDITIONAL INFORMATION, PLEASE CONTACT THE FIRE PREVENTION BUREAU AT (562) 570-2560.

18. WHEN GRADING OCCURS DURING THE WET SEASON (OCTOBER 1 THROUGH APRIL 15), THE CONTRACTOR SHALL CONDUCT AND DOCUMENT SELF ON-SITE INSPECTIONS DURING RAIN EVENTS EXCEEDING 0.1 INCH OVER 24 HOUR PERIOD. IN ADDITION, SUSCEPTIBLE SLOPES SHALL BE

19. A LID OBSERVATION REPORT FORM IS REQUIRED TO BE SUBMITTED TO THE INSPECTOR AT SIGNIFICANT CONSTRUCTION STAGES AND AT COMPLETION OF THE PROJECT BY THE ENGINEER. <u>ADDITIONAL NOTES</u>

CONTRACTOR SHALL VERIFY ALL EXISTING FIELD CONDITIONS AND NOTIFY DESIGN ENGINEER OF ANY DISCREPANCIES PRIOR TO CONSTRUCTION.

CONTRACTOR TO VERIFY POINTS OF CONNECTION TO PIPES, INLETS, CURBS, GUTTERS, ETC. AND NOTIFY TRUXAW AND ASSOCIATES OF ANY DISCREPANCIES PRIOR TO CONSTRUCTION.

REFER TO INSITE PACIFIC SELF STORAGE ARCHITECTURAL PLANS PREPARED BY ARCHITECTS ORANGE FOR BUILDING DIMENSIONS, BUILDING SETBACKS, CONCRETE COLORS AND FINISHES, STRUCTURAL DETAILS, WALKWAYS, EXPANSION JOINT LOCATIONS, UTILITIES, ETC.

ALL WORK SHALL BE DONE IN STRICT CONFORMANCE WITH CURRENT CITY OF LONG BEACH AND SPPWC STANDARDS. WORK SHALL ALSO CONFORM TO APPLICABLE BUILDING CODES (CA BUILDING CODE, CA PLUMBING CODE, ETC.) AS INTERPRETED BY THE CITY OF LONG BEACH.

5. ALL CONTRACTORS PERFORMING WORK ON THIS PROJECT SHALL FAMILIARIZE THEMSELVES WITH THE SITE AND SHALL BE SOLELY RESPONSIBLE FOR ANY DAMAGE TO EXISTING FACILITIES RESULTING DIRECTLY OR INDIRECTLY FROM THEIR OPERATIONS, WHETHER OR NOT SHOWN ON THESE PLANS.

EXISTING UNDERGROUND UTILITY LINE LOCATIONS WERE TAKEN FROM AVAILABLE RECORDS. OTHER UTILITIES MAY EXIST THAT ARE NOT PLOTTED HEREON. EXISTING UNDERGROUND UTILITIES ARE TO BE RELOCATED AS REQUIRED TO AVOID CONFLICT WITH

PROPOSED STRUCTURES. EXISTING PUBLIC UTILITY EASEMENTS IN CONFLICT WITH PROPOSED STRUCTURES ARE TO BE

QUITCLAIMED WITH THE APPROVAL OF THE UTILITY COMPANY. NEW EASEMENTS ARE TO BE GRANTED

AT PROPOSED UTILITY LOCATIONS. CALL UNDERGROUND SERVICE ALERT AT 811 FOR UNDERGROUND LOCATIONS 48 HOURS BEFORE YOU

# CONCEPTUAL IMPROVEMENT PLANS INSITE PACIFIC SELF STORAGE 3701 N. PACIFIC PLACE, LONG BEACH, CA 90806

### ADDITIONAL NOTES CONTINUED

10. THE CONTRACTOR SHALL RENEW OR REPLACE ANY EXISTING TRAFFIC STRIPING AND/OR PAVEMENT MARKINGS, WHICH DURING HIS OPERATIONS HAVE BEEN EITHER REMOVED OR THE EFFECTIVENESS OF WHICH HAS BEEN REDUCED.

THE CONTRACTOR SHALL COMPLY WITH THE SOILS REPORT (AND ADDENDA) FOR THIS PROJECT AND ALL RECOMMENDATIONS FROM THE SOILS ENGINEER.

12. ALL TOPOGRAPHIC AND BOUNDARY INFORMATION SHOWN HEREON WAS OBTAINED FROM AN TOPOGRAPHIC AND BOUNDARY SURVEY DATED AUGUST 28, 2019 BY TRUXAW AND ASSOCIATES, INC.

13. THESE PLANS ARE BASED ON THE SITE PLAN PROVIDED TO TRUXAW & ASSOCIATES BY KSP STUDIO, DATED FEBRUARY 21, 2020.

14. ALL STORM DRAIN AND SEWER PIPE SHALL BE PLACED BEGINNING AT THE DOWNSTREAM POINT OF CONNECTION AND CONTINUING TO THE UPSTREAM TERMINUS. PIPE PLACEMENT SHALL BE CONTINUOUS. DEVIATIONS FROM THIS SEQUENCE WILL NOT BE PERMITTED. POTHOLING INFORMATION, WHERE REQUIRED, SHALL BE OBTAINED AND PROVIDED TO TRUXAW AND ASSOCIATES PRIOR TO CONSTRUCTION

15. ALL IMPROVEMENTS BEYOND THE LIMITS OF GRADING ARE TO BE PROTECTED IN PLACE UNLESS NOTED

### \*<u>TITLE\_REPORT</u>

THIS SURVEY AND FASEMENTS SHOWN HEREON ARE BASED ON INFORMATION CONTAINED IN THE PRELIMINARY TITLE REPORT PREPARED BY:

1500 QUAIL STREET, 3RD FLOOR NEWPORT BEACH, CA 92660 (714) 289-3300 ORDER/FILE NUMBER: 00527310-021-DN1 DATED: JULY 8, 2019 AMENDED JULY 24, 2019, AMENDMENT NO. 2 TITLE OFFICER: DAVID NOBLE

### \* LEGAL DESCRIPTION

THE LAND REFERRED TO HEREIN BELOW IS SITUATED IN THE COUNTY OF LOS ANGELES, STATE OF CALIFORNIA, AND IS DESCRIBED AS FOLLOWS:

THOSE PORTIONS OF LOTS 3 AND 4 OF TRACT NO. 1400, IN THE COUNTY OF LOS ANGELES, STATE OF CALIFORNIA, AS PER MAP RECORDED IN BOOK 18, PAGE 96 OF MAPS, IN THE OFFICE OF THE COUNTY RECORDER OF SAID COUNTY.

BEGINNING AT THE POINT OF INTERSECTION OF THE SOUTHERLY LINE OF SAID LOT 3 WITH THE WESTERLY LINE OF THE PACIFIC ELECTRIC RAILWAY COMPANY'S 70 FOOT RIGHT OF WAY, AS DESCRIBED IN DEED RECORDED IN BOOK 3991, PAGE 88, OF OFFICIAL RECORDS; THENCE WESTERLY ALONG THE SOUTHERLY LINE OF SAID LOT 3 TO ITS INTERSECTION WITH THE EASTERLY LINE OF THE LOS ANGELES COUNTY FLOOD CONTROL CHANNEL; THENCE NORTHERLY ALONG THE EASTERLY LINE OF FLOOD CONTROL CHANNEL TO ITS INTERSECTION WITH THE SOUTHWESTERLY LINE OF PACIFIC ELECTRIC RAILWAY COMPANY'S 120 FOOT RIGHT OF WAY, AS DESCRIBED IN DEED RECORDED IN BOOK 5596, PAGE 175 OF DEEDS; THENCE SOUTHEASTERLY ALONG AFORESAID SOUTHWESTERLY LINE OF RIGHT OF WAY TO ITS INTERSECTION WITH THE WESTERLY LINE OF PACIFIC ELECTRIC RAILWAY COMPANY'S 70 FOOT RIGHT OF WAY, AS DESCRIBED IN DEED RECORDED IN BOOK 3991, PAGE 88, OF OFFICIAL RECORDS: THENCE SOUTHERLY AND WESTERLY ALONG AFORESAID WESTERLY LINE OF SAID 70 FOOT RIGHT OF WAY TO THE POINT OF BEGINNING

EXCEPT THAT PORTION OF SAID LAND LYING SOUTHERLY OF THE NORTHERLY LINE OF THE LAND DESCRIBED IN PARCEL 1 OF THE DEED TO THE STATE OF CALIFORNIA. RECORDED MAY 12, 1958 AS INSTRUMENT NO. 1464, IN BOOK D96, PAGE 899, OF OFFICIAL RECORDS OF SAID COUNTY

APN: 7140-014-019 AND 7140-014-032

PARCEL B:

THAT PORTION OF LOT 4 OF TRACT NO. 1400. IN THE COUNTY OF LOS ANGELES. STATE OF CALIFORNIA, AS PER MAP RECORDED IN BOOK 18, PAGE 96 OF MAPS, IN THE OFFICE OF THE COUNTY RECORDER OF SAID COUNTY, DESCRIBED IN PARCEL 1 OF DEED (STATE PARCEL 7905) RECORDED JULY 12, 1960 AS INSTRUMENT NO. 1584, IN BOOK D907, PAGE 268 OF OFFICIAL RECORDS, IN SAID OFFICE, LYING NORTHERLY OF THE WESTERLY PROLONGATION OF THE NORTHERLY LINE OF PARCEL 1 OF HIGHWAY RIGHT OF WAY (REL-429) RELINQUISHED TO THE COUNTY OF LOS ANGELES BY RESOLUTION OF THE CALIFORNIA HIGHWAY COMMISSION, A CERTIFIED COPY OF WHICH RESOLUTION IS RECORDED NOVEMBER 30, 1965 AS INSTRUMENT NO. 4557, IN BOOK R2434, PAGE 453, OF SAID OFFICIAL RECORDS, AND AS SHOWN OF MAP FILED IN BOOK 1, PAGE 97 OF STATE HIGHWAY MAPS, IN SAID OFFICE.

EXCEPT THEREFROM, ALL OIL, MINERALS, NATURAL GAS, AND OTHER HYDROCARBONS BY WHATSOEVER NAME KNOWN THAT MAY BE WITHIN OR UNDER THE HEREIN CONVEYED PARCEL OF LAND, AND THE RIGHTS THERETO, TOGETHER WITH CERTAIN OTHER CONDITIONS, AS EXCEPTED AND RESERVED IN SAID DEED (STATE PARCEL 7905) RECORDED JULY 12, 1960 AS INSTRUMENT NO. 1584, IN BOOK D907, PAGE 268, OF SAID OFFICIAL RECORDS. APN: 7140-014-033

# \* EASEMENTS

WATER RIGHTS, CLAIMS OR TITLE TO WATER, WHETHER OR NOT DISCLOSED BY THE PUBLIC

AN OIL AND GAS LEASE FOR THE TERM THEREIN PROVIDED WITH CERTAIN COVENANTS, CONDITIONS AND PROVISIONS, TOGETHER WITH EASEMENTS, IF ANY, AS SET FORTH THEREIN DATED DECEMBER 1, 1936, OIL OPERATORS, INCORPORATED, A CALIFORNIA CORPORATION, AS LESSOR AND UNION OIL COMPANY OF CALIFORNIA, A CALIFORNIA CORPORATION, AS LESSEE, RECORDED FEBRUARY 27, 1936 AS INSTRUMENT NO. 46, IN BOOK 14010, PAGE 66 OF OFFICIAL RECORDS.

NO ASSURANCE IS MADE AS TO THE PRESENT OWNERSHIP OF THE LEASEHOLD CREATED BY SAID LEASE, NOR AS TO OTHER MATTERS AFFECTING THE RIGHTS OR INTERESTS OF THE LESSOR OR LESSEE IN SAID LEASE.

# NOT A SURVEY ITEM.

EASEMENT(S) FOR THE PURPOSE(S) SHOWN BELOW AND RIGHTS INCIDENTAL THERETO, AS GRANTED IN A DOCUMENT:

SEWER, SEWER PIPELINE AND INCIDENTAL PURPOSES PURPOSE: RECORDING DATE: JULY 6, 1946 RECORDING NO: BOOK 23355, PAGE 385 OF OFFICIAL RECORDS AFFECTS: A PORTION OF THE LAND

(10) EASEMENT(S) FOR THE PURPOSE(S) SHOWN BELOW AND RIGHTS INCIDENTAL THERETO, AS GRANTED IN A DOCUMENT:

PURPOSE: PUBLIC HIGHWAY SLOPES AND INCIDENTAL PURPOSES RECORDING DATE: MAY 12, 1958 RECORDING NO: 1464 BOOK D96, PAGE, 899 OF OFFICIAL

RECORDS AFFECTS: A PORTION OF THE LAND

(11) THE FACT THAT THE OWNERSHIP OF SAID LAND DOES NOT INCLUDE RIGHTS OF ACCESS TO OR FROM A PUBLIC STREET OR HIGHWAY ABUTTING SAID LAND, SUCH RIGHTS HAVING BEEN SEVERED FROM SAID LAND BY THE DOCUMENT RECORDED MAY 12, 1958 AS INSTRUMENT NO. 1464 IN BOOK D96, PAGE 899 OF OFFICIAL RECORDS.

 $\langle 12 \rangle$  any possible rights, title or interest that tidewater oil company, a delaware CORPORATION, MAY HAVE BY REASON OF AN 8" PIPELINE (DELINEATED ON A DRAWING ATTACHED TO LICENSE AGREEMENT RECORDED MARCH 22, 1967 AS INSTRUMENT NO. 2958, OFFICIAL RECORDS) PASSING THROUGH THE LAND.

### EASEMENT APPEARS TO HAVE EXPIRED. SEE DOCUMENT FOR FULL PARTICULARS.

13 THE FACT THAT SAID LAND IS INCLUDED WITHIN A PROJECT AREA OF THE NORTH LONG BEACH REDEVELOPMENT PROJECT, AND THAT PROCEEDINGS FOR THE REDEVELOPMENT OF SAID PROJECT HAVE BEEN INSTITUTED UNDER THE REDEVELOPMENT LAW (SUCH REDEVELOPMENT TO PROCEED ONLY AFTER THE ADOPTION OF THE REDEVELOPMENT PLAN) AS DISCLOSED BY A DOCUMENT RECORDED JULY 17, 1996 AS INSTRUMENT NO. 96-1152104 OF OFFICIAL RECORDS.

PARCELS A & B APPEAR TO BE WITHIN A PROJECT AREA OF THE NORTH LONG BEACH REDEVELOPMENT PROJECT.

14 ANY EASEMENTS NOT DISCLOSED BY THE PUBLIC RECORDS AS TO MATTERS AFFECTING TITLE TO REAL PROPERTY, WHETHER OR NOT SAID EASEMENTS ARE VISIBLE AND APPARENT.

### \* BENCHMARK

CITY OF LONG BEACH BENCHMARK NO. 1720 ELEVATION = 52.680 FEET (NGVD 29 MSL 1985)

WARDLOW RD @ PACIFIC PLACE BRASS DISC. FLUSH; STAMPED "CLB BM 1720 2000" 586' N/N CURB/WARDLOW RD.; 1' E/CURB

### \* BASIS OF BEARINGS

THE BEARING NORTH 00°02'45" EAST FOR THE CENTERLINE OF GOLDEN AVENUE AS SHOWN ON RECORD OF SURVEY, FILED IN BOOK 277, PAGE 53, IN THE CITY OF LONG BEACH, COUNTY OF LOS ANGELES, STATE OF CALIFORNIA, WAS USED AS THE BASIS OF BEARINGS FOR THIS

### **★**FLOOD ZONE

COMMUNITY NUMBER: 060136 1955F, EFFECTIVE DATE: 9/26/2008

ZONE X

PROPERTY NOT IN A SPECIAL FLOOD HAZARD AREA, AREA DETERMINED TO BE OUTSIDE THE 0.2% ANNUAL CHANCE FLOODPLAIN. FLOOD INSURANCE IS AVAILABLE, BUT NOT REQUIRED.

INFORMATION OBTAINED FROM CERTIFIED FLOOD SYSTEMS, INC. ON 8/16/2019

### \* LAND AREA

PARCEL A = 565.414 S.F. OR 12.980 AC PARCEL B = 41.774 OR 0.959 AC

# **★**RECORD DATA

(R) - TRACT NO. 1400, BOOK 18, PAGE 96 (R1) - RECORD OF SURVEY, BOOK 277, PAGE 53 (R2) - RECORD OF SURVEY, BOOK 152, PAGE 71

**UTILITY PROVIDERS:** 

.LONG BEACH WATER DEPARTMENT.

..LONG BEACH WATER DEPARTMENT.

..CITY OF LONG BEACH RESOURCES DEPARTMENT..

..FRONTIER COMMUNICATIONS.

.SOUTHERN CALIFORNIA EDISON.

.. CHARTER COMMUNICATIONS..

+STORM DRAIN.....LOS ANGELES COUNTY FLOOD CONTROL DISTRICT.

+INFORMATION NOT AVAILABLE AT TIME OF SURVEY

.(562) 570-2300

.(562) 570-2300

..(626) 458-5100

.(562) 570-2000

.(805) 458-4349

WATER..

+TELEPHONE..

+ELECTRIC.

2 - CONCEPTUAL GRADING PLAN 3 - CONCEPTUAL PUBLIC ACCESS ROAD 4 - CONCEPTUAL SECTIONS AND DETAILS

5 - CONCEPTUAL WALL PLAN 6 - CONCEPTUAL WALL SECTIONS 7 - CONCEPTUAL UTILITY PLAN

8 - CONCEPTUAL STORM DRAIN SECTIONS 9 - CONCEPTUAL LID PLAN 10 - CONCEPTUAL LID FORM & DETAILS

REFERENCE PLANS \* 1-TITLE SHEET

\* 2-BOUNDARY SURVEY \* 3-TOPOGRAPHIC SURVEY \* 4-TOPOGRAPHIC SURVEY

AB = AGGREGATE BASE

BLK = CONCRETE BLOCK

CB = CATCH BASIN

CF = CURB FACE

CL = CENTERLINE

CO = CLEANOUT

FD = FOUND

AC = ASPHALT CONCRETE

BS = BACK OF SIDEWALK

CLF = CHAIN LINK FENCE

DS = ROOF DOWNSPOUT

EG = EDGE OF GUTTER

FF = FINISHED FLOOR

FG = FINISHED GRADE

FS = FINISHED SURFACE

GB = GRADE BREAK

GR = TOP OF GRATE

ICV = IRRIGATION CONTROL VALVE

GM = GAS METER

GV = GAS VALVE

HP = HIGH POINT

IP = IRON PIPE

MH = MANHOLE

PB = PULL BOX

PCC = CONCRETE

LS = LIGHT STANDARD

NG = NATURAL GROUND

PIV = POST INDICATOR VALVE

L&T = LEAD & TAG

N&T = NAIL & TAG

OHW = OVERHEAD WIRE

PL = PROPERTY LINE

RWH = REDWOOD HEADER

SMH = SEWER MANHOLE

SCB = SIGNAL CONTROL BOX

RD = ROOF DRAIN

SPK = SPIKE

SW = SIDEWALK

TC = TOP OF CURB

TE = TRASH ENCLOSURE

TP = TELEPHONE POLE

TRAN = TRANSITION

TRANS= TRANSFORMER

HT = HEIGHT


FH = FIRE HYDRANT

FL = FLOW LINE

EP = EDGE OF PAVEMENT

FDC = FIRE DEPT. CONNECTION

DCV = DETECTOR CHECK VALVE

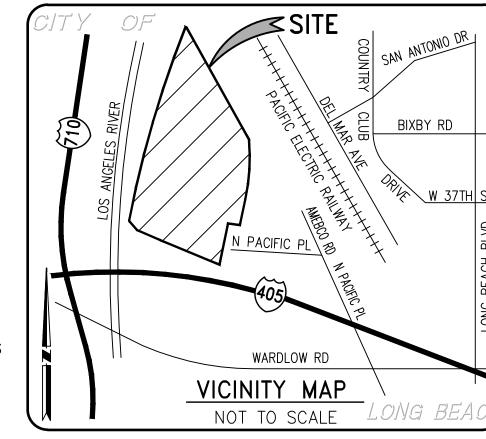

VAR = VARIABLE

WDF = WOOD FENCE

WM = WATER METER

WV = WATER VALVE

W = WASHER

N. = NORTH

S. = SOUTH

E. = EAST

 $W_{\cdot} = WEST$ 

N'LY = NORTHERLY

S'LY = SOUTHERLY

E'LY = EASTERLY

W'LY = WESTERLY

N/O = NORTH OF

S/O = SOUTH OF

E/O = EAST OF

W/O = WEST OF

 $\triangle$  = DELTA

= LENGTH

T = TANGENT

R = RADIUS

P = PROPERTY LINE

R/W = RIGHT OF WAY

M = MEASURED DATA

(RAD)= RADIAL BEARING

C = CALCULATED DATA

(210.00' R) = RECORD DATA

210.00' M. = MFASURFD DATA

210.00' PRO. = PRORATED DATA

210.00' C. = CALCULATED DATA

(427.00) TC = EXISTING ELEVATION

427.00 TC = DESIGN ELEVATION

——— G ——— = GAS LINE

---- R ---- = RIDGE LINE

———— S ———— = SEWER LINE

----- CATV ----- = CABLE TV LINE

— E — = ELECTRICAL LINE

—— GB—— GB— = GRADE BREAK LINE

T ---- = TELEPHONE LINE

— W — = WATER LINE

PRO = PROPORTIONATE MEASUREMENT

TRW = TOP OF RETAINING WALL FIRE HYDRANT TW = TOP OF WALLUG = UNDERGROUND ▼ TRAFFIC SIGNAL UP = UTILITY POLE

> → TRAFFIC SIGNAL ARM & POLE

— UTILITY POLE GUY WIRE & ANCHOR

SYMBOLS

WATER METER GAS METER

WATER VALVE GAS VALVE PULL BOX

GRATE INLET SIGN VENT

SEWER MANHOLE STORM DRAIN MANHOLE

TELEPHONE MANHOLE MANHOLE SEWER CLEANOUT

MONITORING WELL HANDICAP PARKING STALL LANDSCAPED AREA

PROTECT IN PLACE (R) REMOVE AND DISPOSE OFFSITE RELOCATE PLOTABLE EASEMENT ITEM

No. PER TITLE REPORT —— (427.0) —— EXIST. CONTOUR 427.0 DESIGN CONTOUR

> LOCATION OF "PROPOSED" ENVIRONMENTAL WELL/BORING SITE. PROPOSED LOCATION MARKERS SET BY ENVIRONMENTAL ENGINEER AT TIME OF FIELD SURVEY. NOT AN AS-BUILT LOCATION (TYP.)





# PLAN PREPARED FOR

INSITE PROPERTY GROUP 811 N. CATALINA AVENUE, SUITE 1306 REDONDO BEACH, CA 90277

# SOILS ENGINEER

THESE PLANS HAVE BEEN DESIGNED IN ACCORDANCE

# CARL KIM GEOTECHNICAL, INC.

945 BAILEYANA ROAD HILLSBOROUGH, CA 94010 (949) 441-8143PROJECT No. PWAS\_20190823b REPORT DATE: NOVEMBER 14, 2019 CONTRACTOR SHALL OBTAIN A COPY OF THIS REPORT AND FOLLOW THE RECOMMENDATIONS THEREIN. NOTIFY TRUXAW AND ASSOCIATES OF ANY DISCREPANCIES OR FIELD CHANGES PRIOR TO CONSTRUCTION.

# ARCHITECT

KSP STUDIO


23 ORCHARD ROAD, SUITE 200 LAKE FOREST, CA 92630


INFORMATION SHOWN ON THESE PLANS WERE TAKEN FROM THE PLAN REFERENCED BELOW. DATE OF SURVEY: AUGUST 28, 2019 ALTA SURVEY BY: TRUXAW AND ASSOCIATES. INC.

ORANGE, CA 92868 (714) 935-0265 JOB # IPG19058




NOTICE TO CONTRACTOR THE CONTRACTOR SHALL ASCERTAIN THE TRUE VERTICAL AND HORIZONTAL LOCATION AND SIZE OF ALL LITHITIES. PIPES. AND/OR STRUCTURES AND SHALL BI RESPONSIBLE FOR DAMAGE TO ANY PUBLIC OR PRIVATE

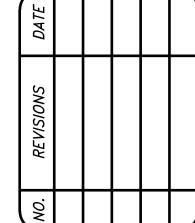

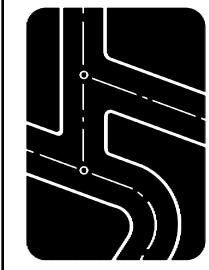

 $\Delta$ 

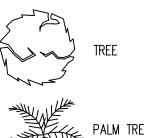

★ SOURCE OF TOPOGRAPHIC, BOUNDARY & EASEMENT INFORMATION.

1915 W. ORANGEWOOD AVENUE, SUITE 1



UTILITIES, SHOWN OR NOT SHOWN HEREON.


IMPORTANT NOTICE Section 4216 of the Government Code requires a Dig Alert Identification Number be issued before a "Permit to Excavate" will be valid. For your Dig Alert I.D. Number call Underground Service Alert Two working days before you

3-6-20 DRAWN BY **GEOFFREY AYTON** CHECKED BY CRAIG DI BIAS JOB NO. IPG19058 SHEET NO.

S

DATE

OF 160 SHEETS

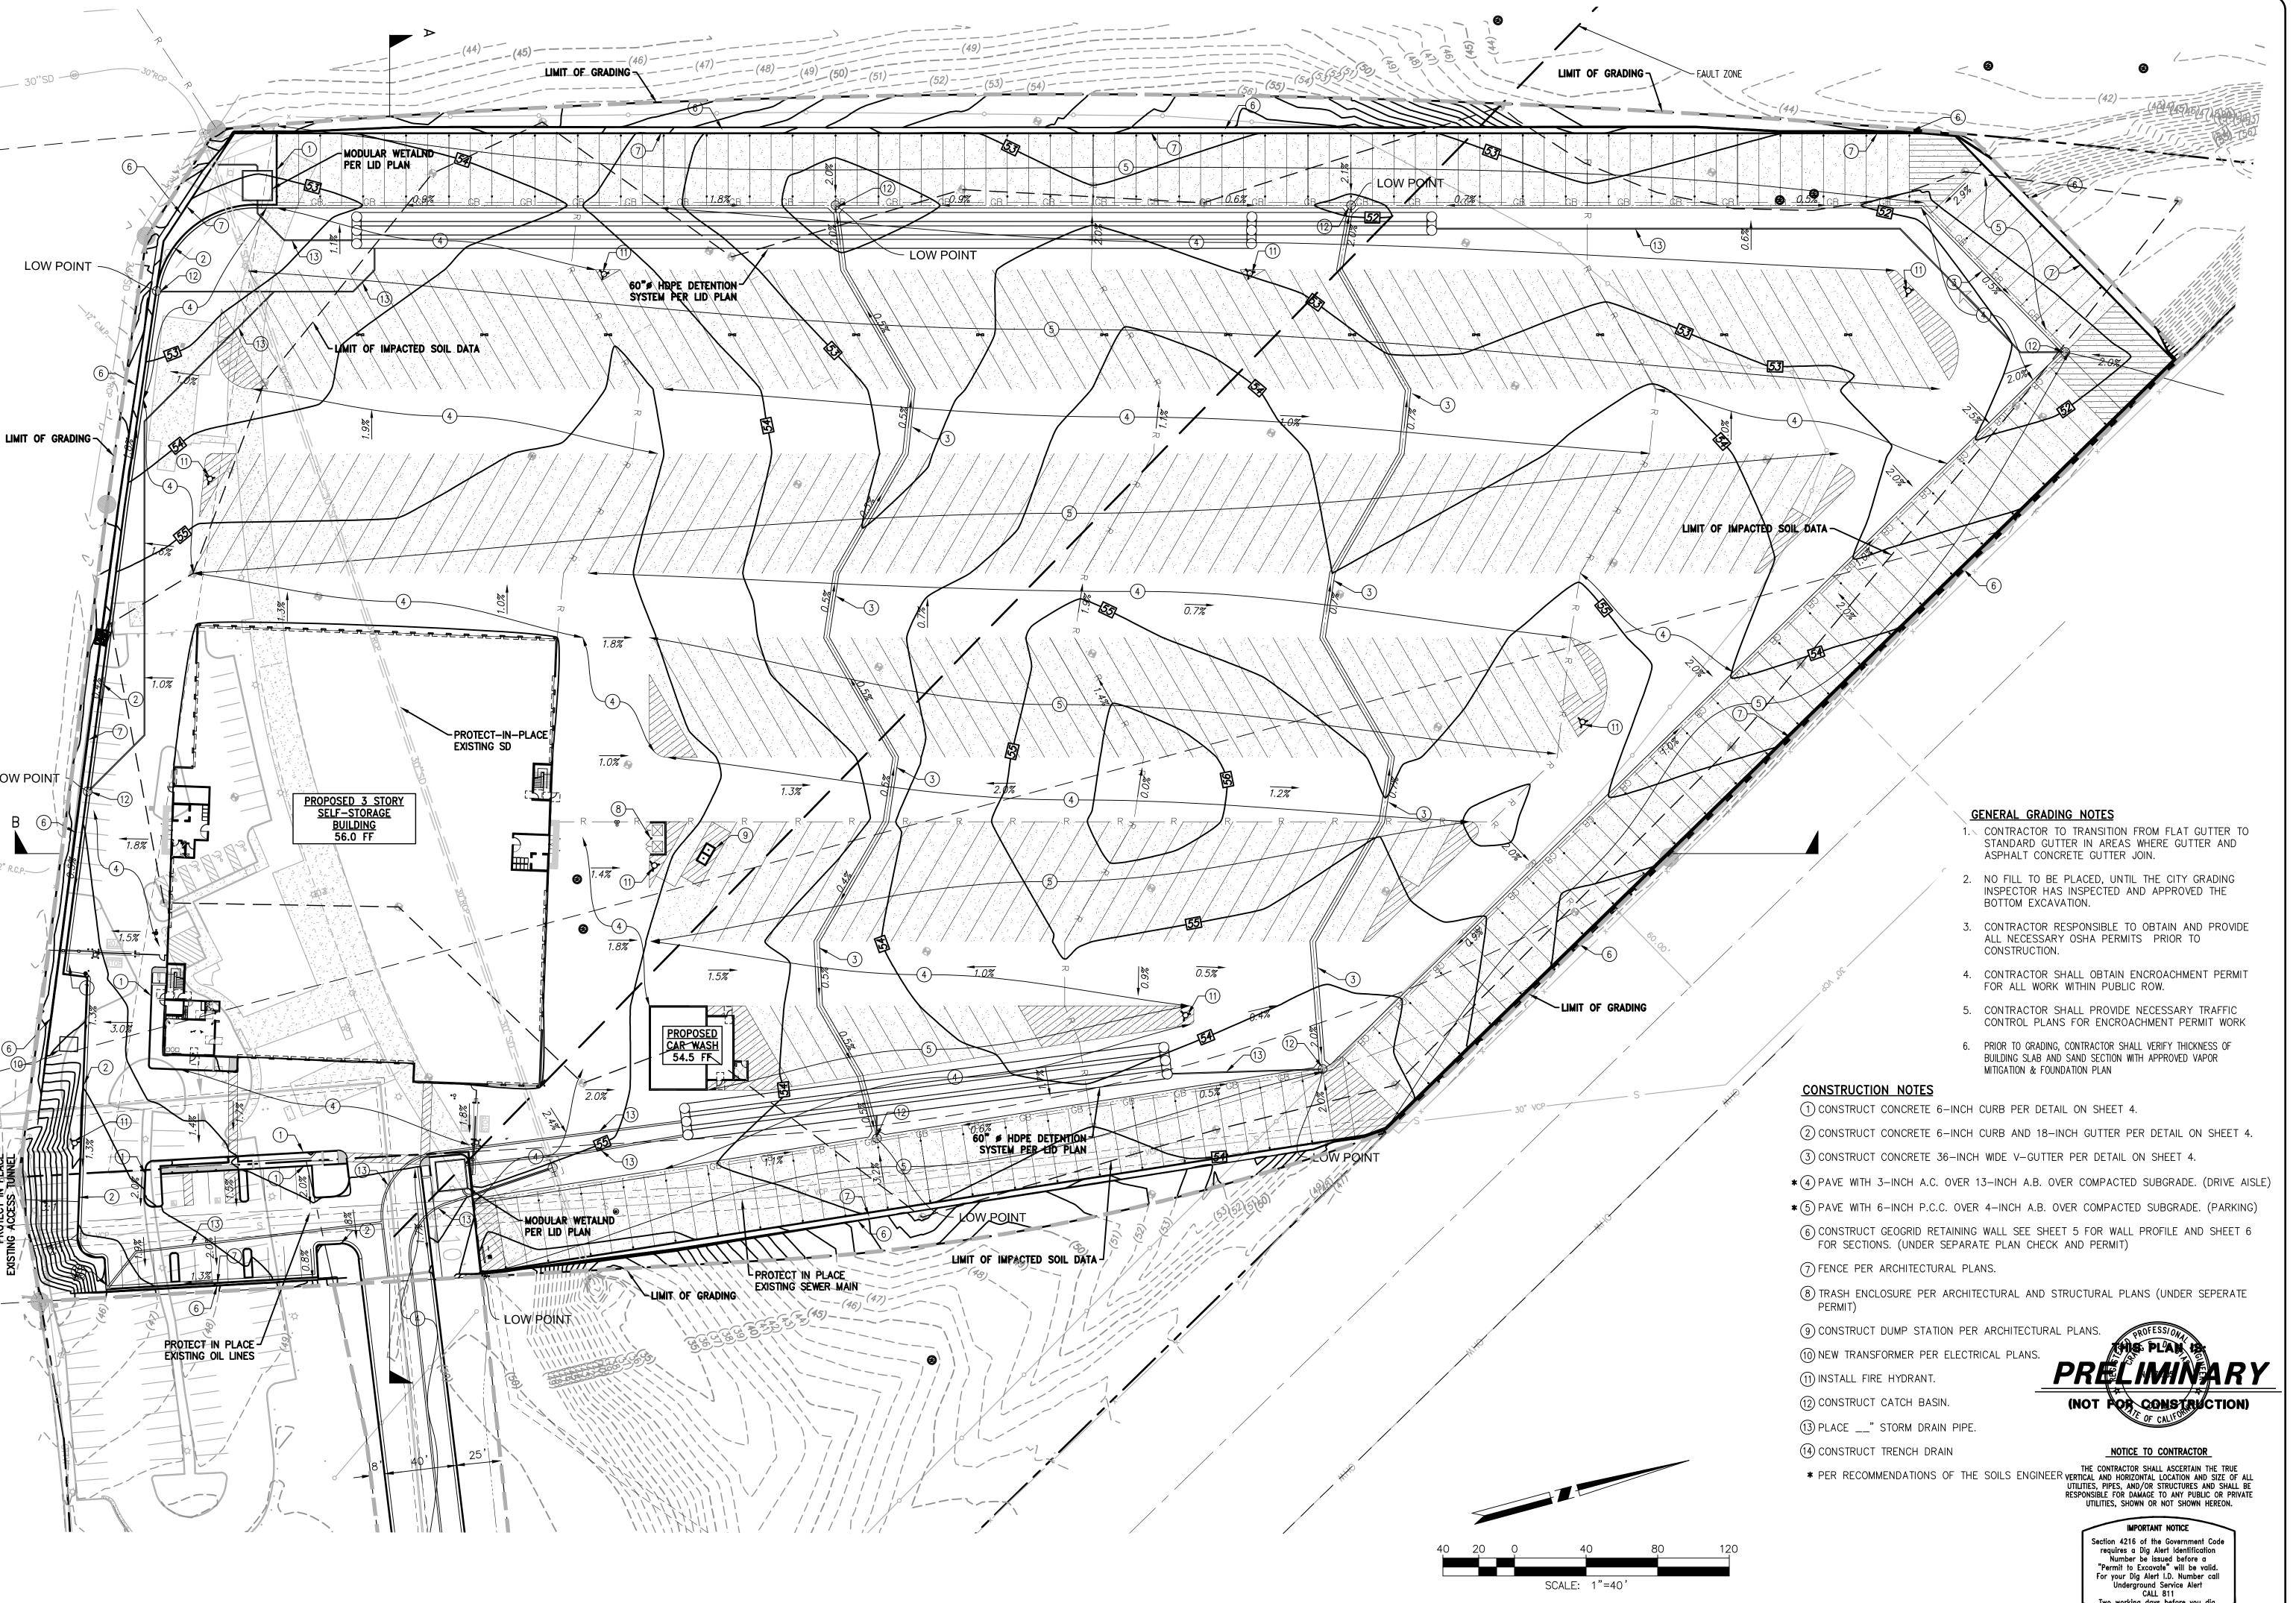

 $\Delta$ GRADING CONCEPTUAL


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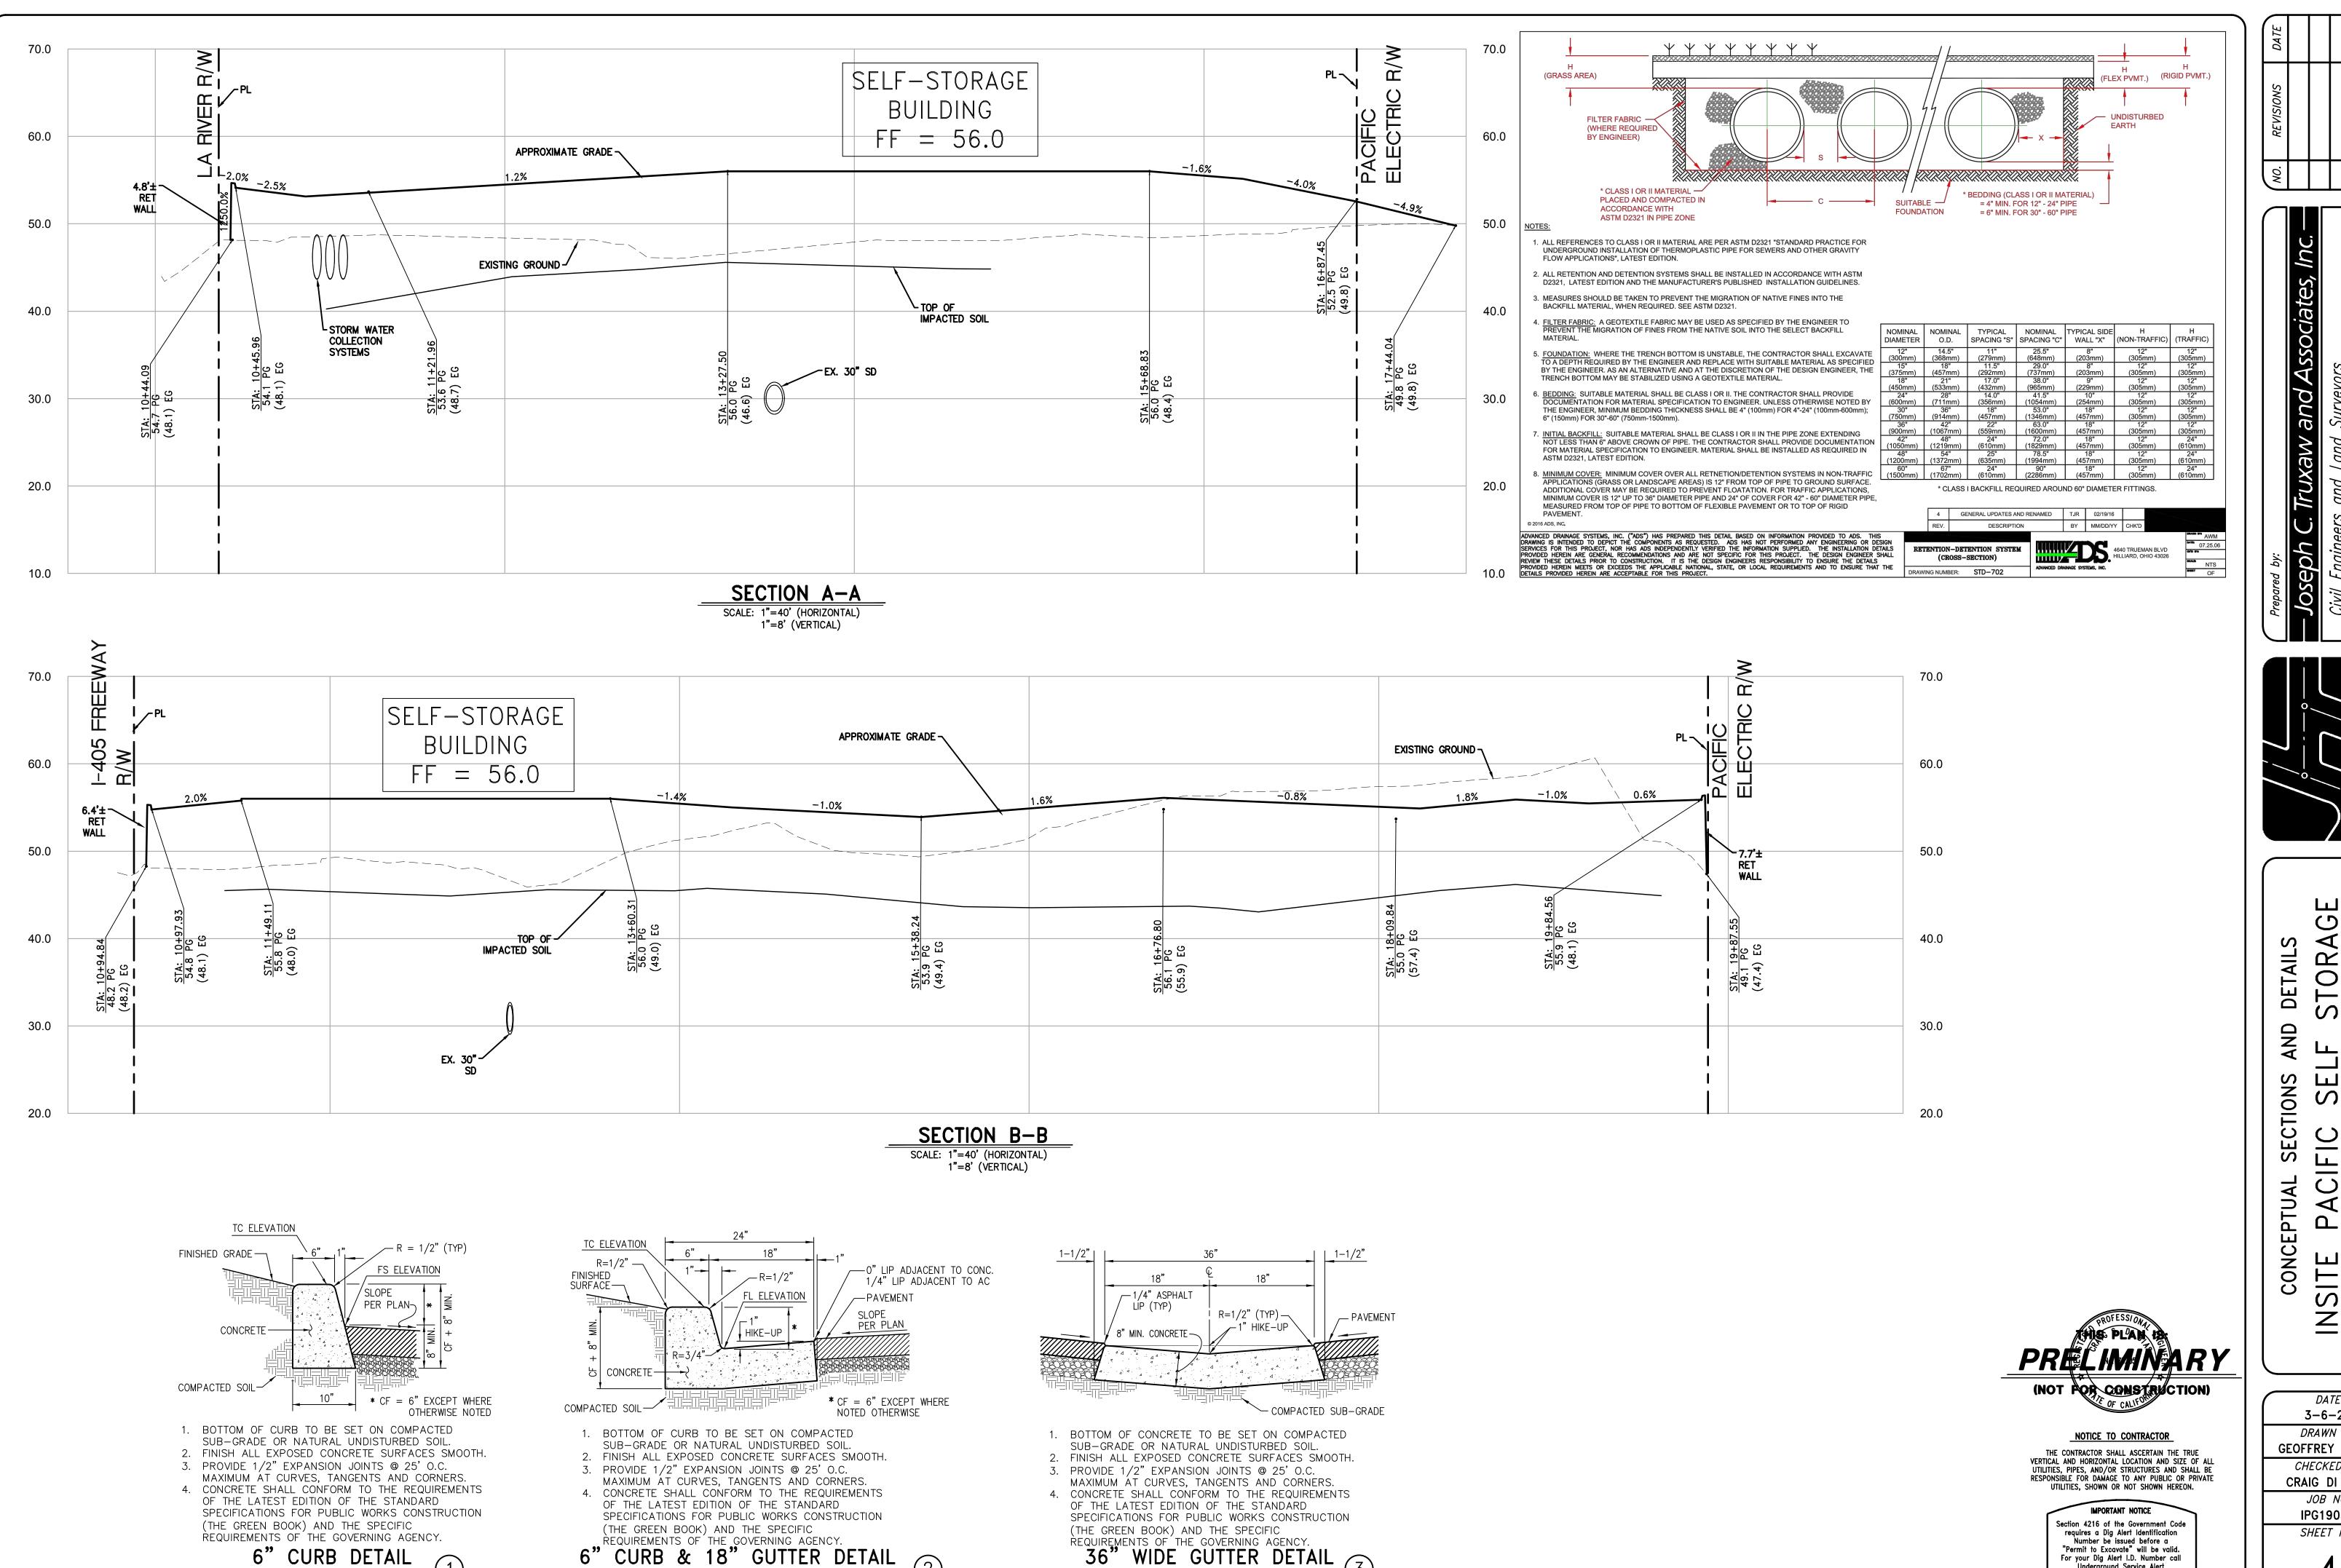
DRAWN BY GEOFFREY AYTON CHECKED BY

CRAIG DI BIAS JOB NO. IPG19058

SHEET NO.

OF 10 SHEETS



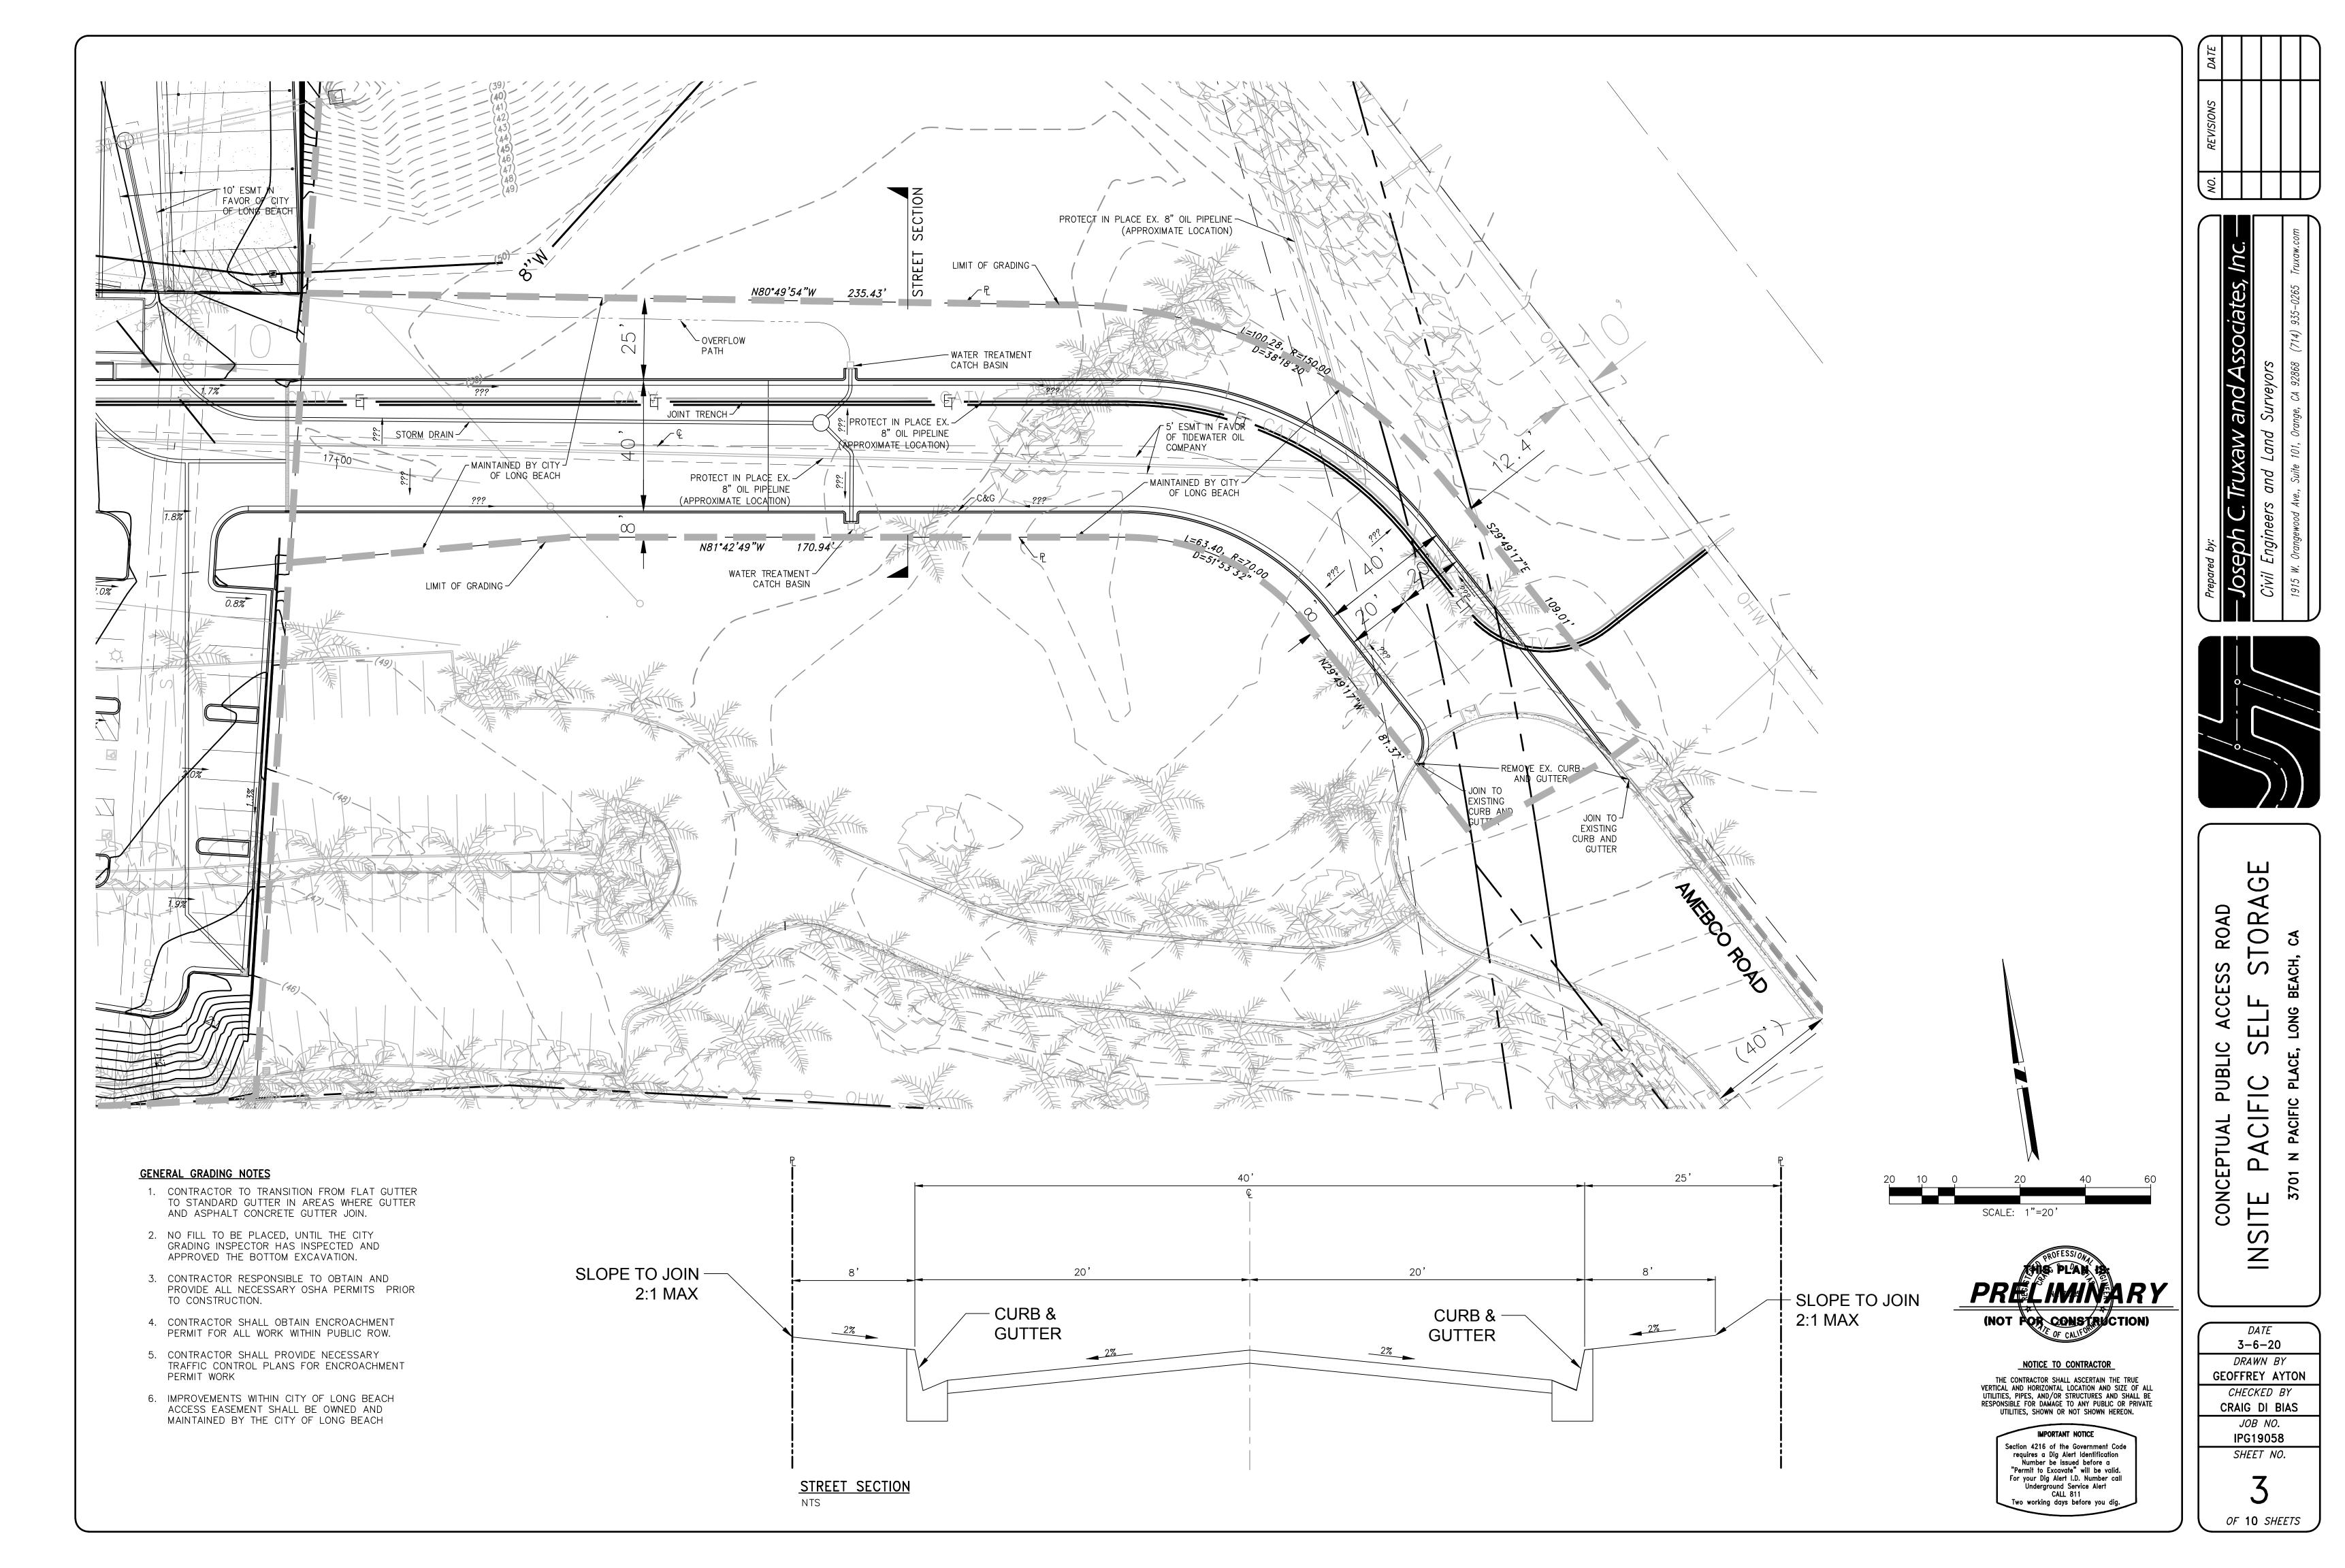

NOT TO SCALE

NOT TO SCALE

NOT TO SCALE


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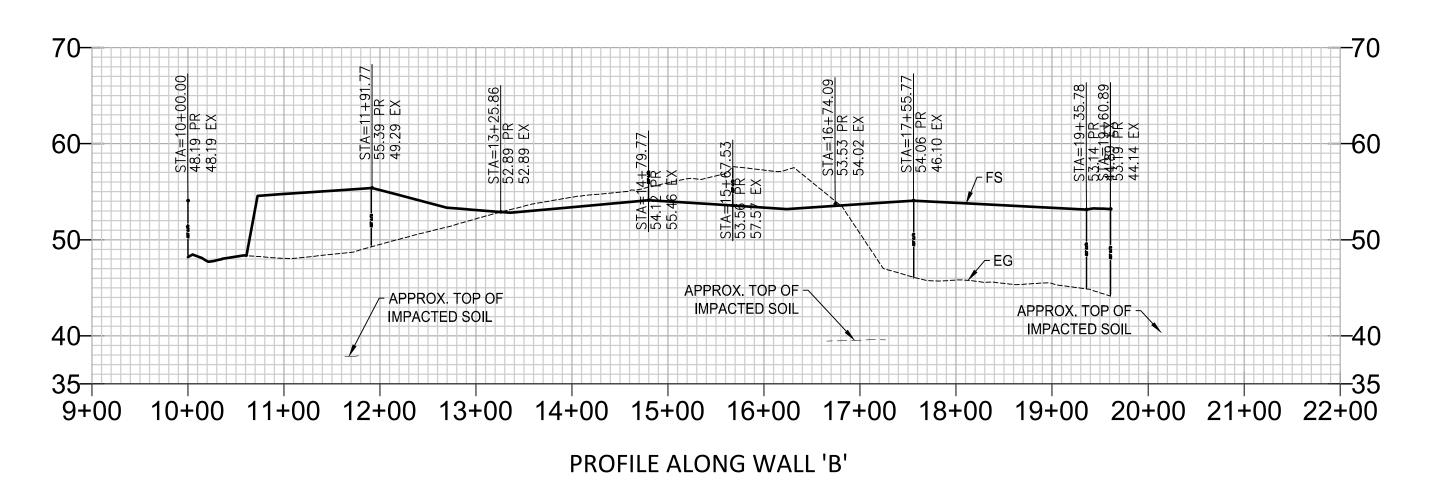
DATE 3-6-20 DRAWN BY **GEOFFREY AYTON** CHECKED BY CRAIG DI BIAS JOB NO.


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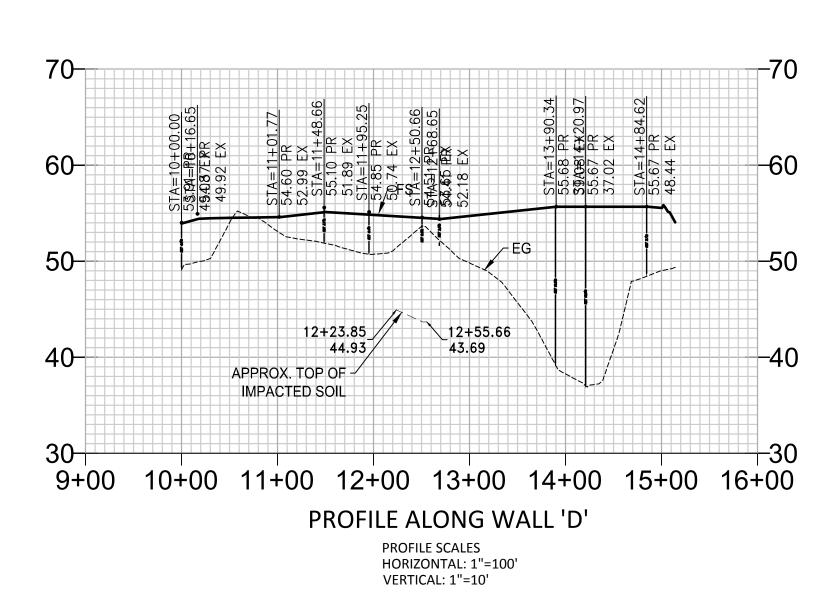
OF 10 SHEETS


Underground Service Alert CALL 811






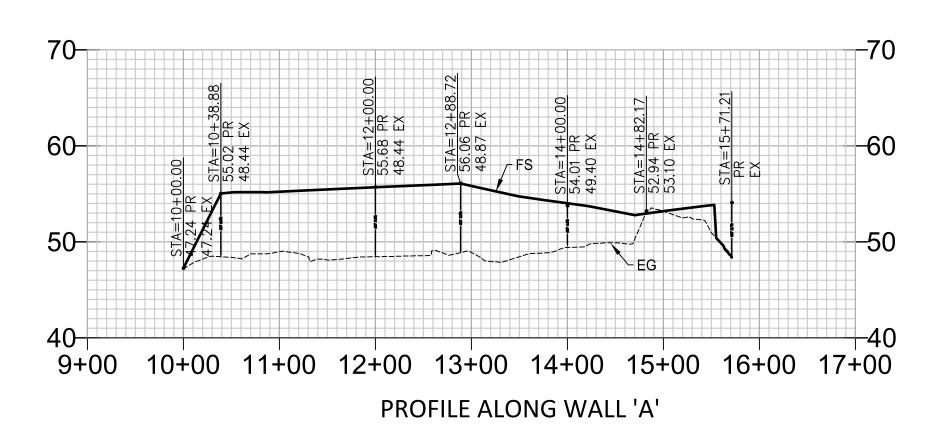

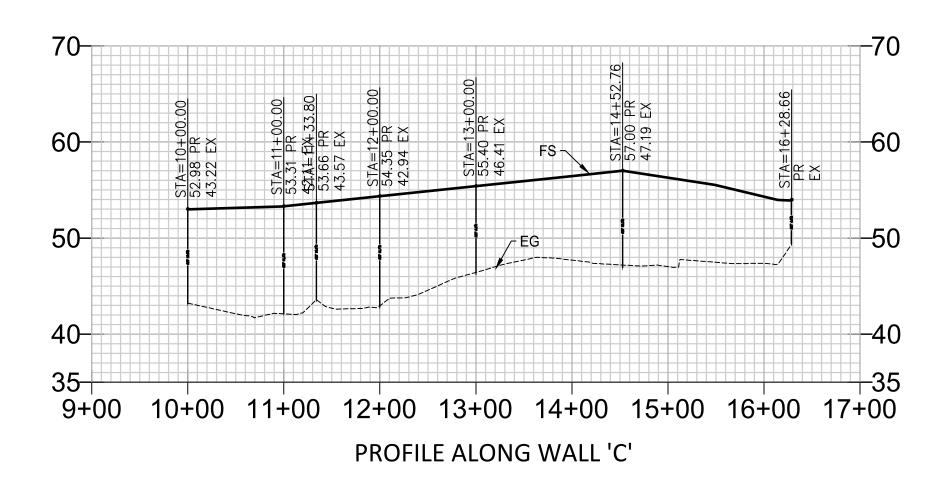

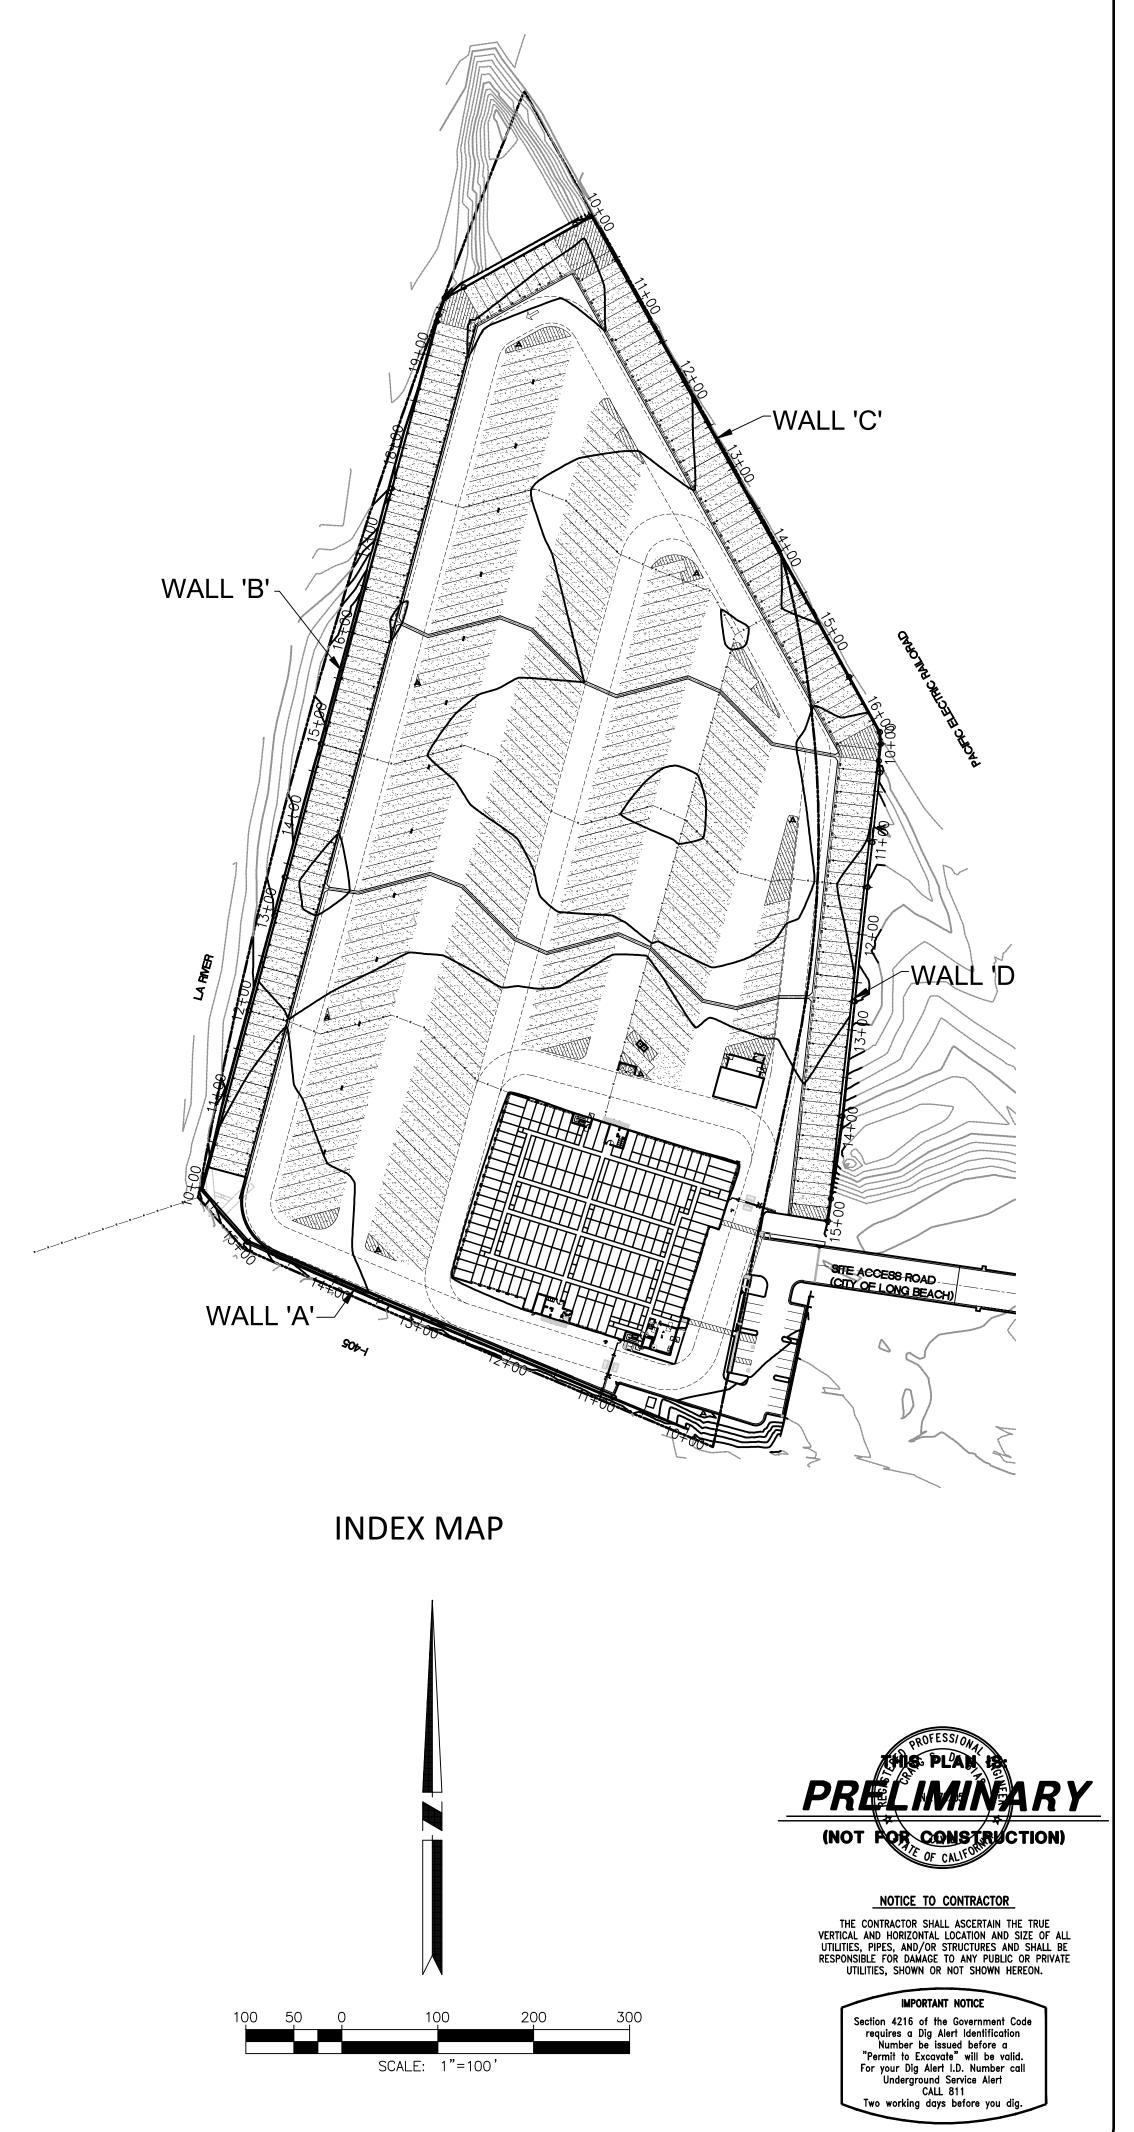

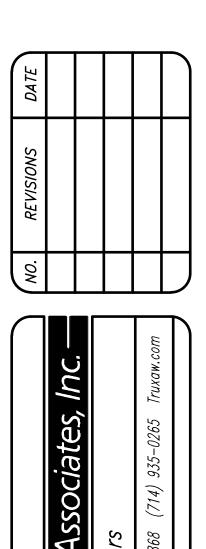

INSITE PACIFIC PLE STORAGE

DATE
3-6-20

DRAWN BY
GEOFFREY AYTON


CHECKED BY
CRAIG DI BIAS

JOB NO.
IPG19058


**5**OF 10 SHEETS

SHEET NO.


WALL A STA 10+00.00 TO 14+60.37

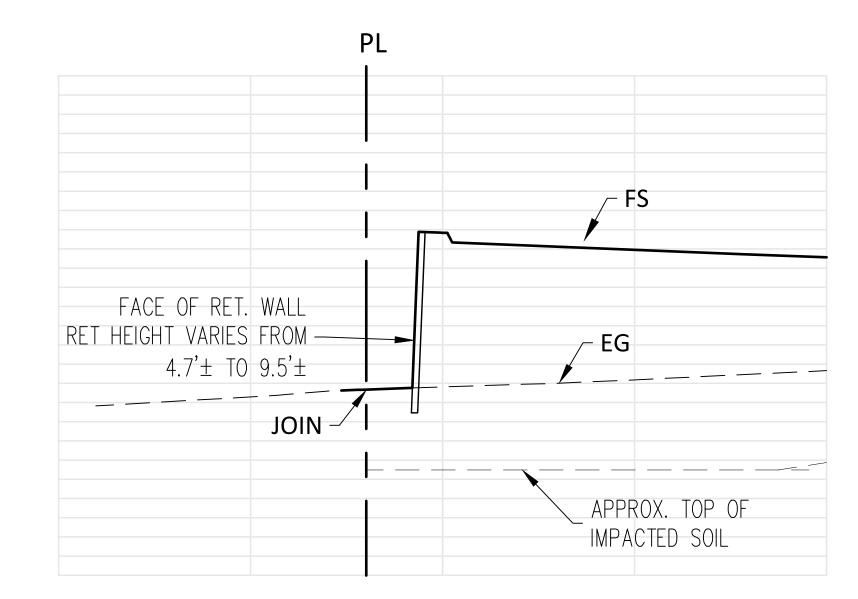


WALL B STA 10+00.00 TO 13+25.86 AND 16+74.09 TO 19+60.91

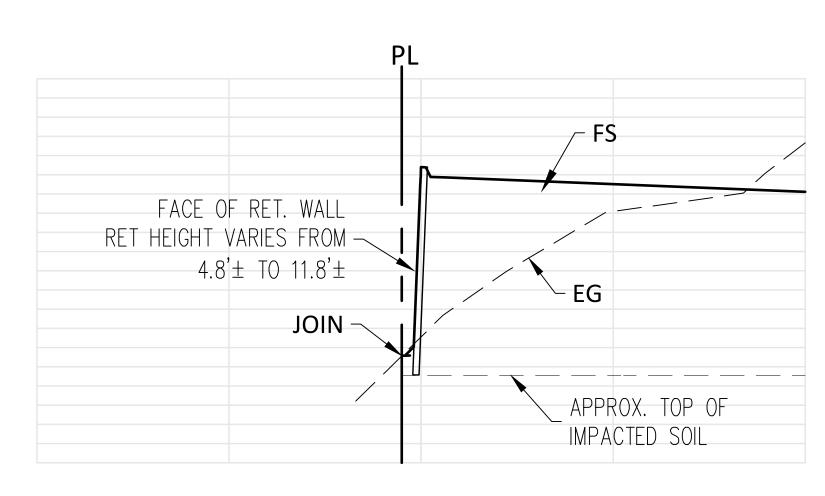


WALL C STA 10+00.00 TO 16+28.66

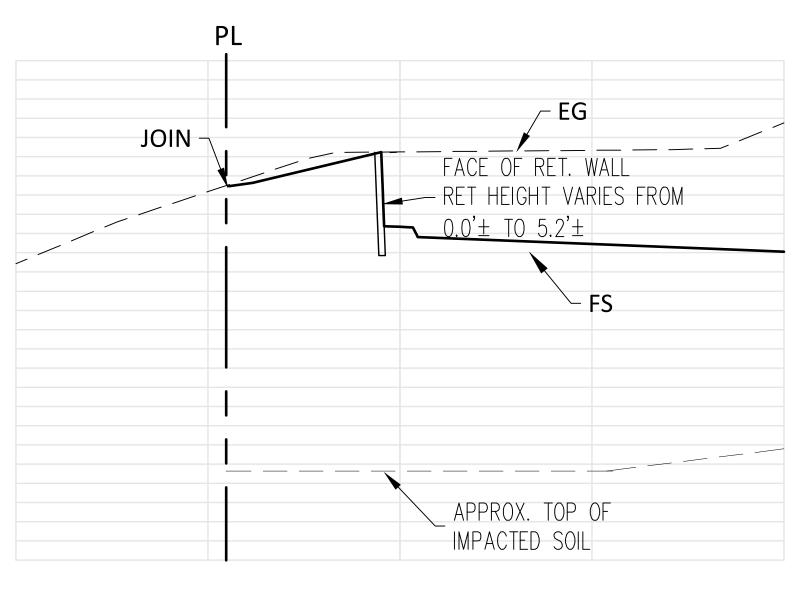


WALL B STA 13+25.86 TO 16+74.09

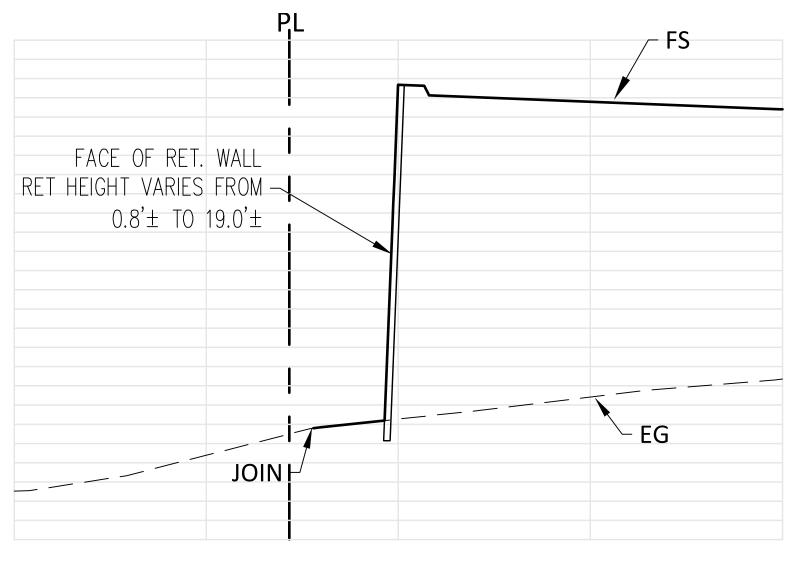


WALL D STA 10+00.00 TO 14+84.62

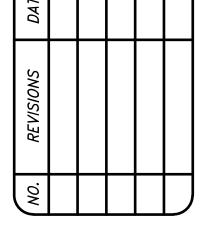

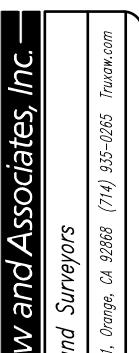

-Joseph C. Truxaw and As Civil Engineers and Land Surveyors 1915 W. Orangewood Ave., Suite 101, Orange, CA 92868

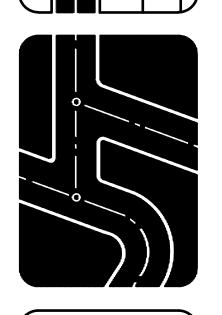

CONCEPTUAL WALL SECTIONS
SITE PACIFIC SELF STORAGE


DATE
3-6-20
DRAWN BY
GEOFFREY AYTON
CHECKED BY
CRAIG DI BIAS
JOB NO.
IPG19058
SHEET NO.

PRELIMINARY

THE CONTRACTOR SHALL ASCERTAIN THE TRUE VERTICAL AND HORIZONTAL LOCATION AND SIZE OF ALL UTILITIES, PIPES, AND/OR STRUCTURES AND SHALL BE RESPONSIBLE FOR DAMAGE TO ANY PUBLIC OR PRIVATE UTILITIES, SHOWN OR NOT SHOWN HEREON.

Section 4216 of the Government Code requires a Dig Alert Identification Number be issued before a "Permit to Excavate" will be valid. For your Dig Alert I.D. Number call Underground Service Alert CALL 811
Two working days before you dig.

6 OF 10 SHEETS

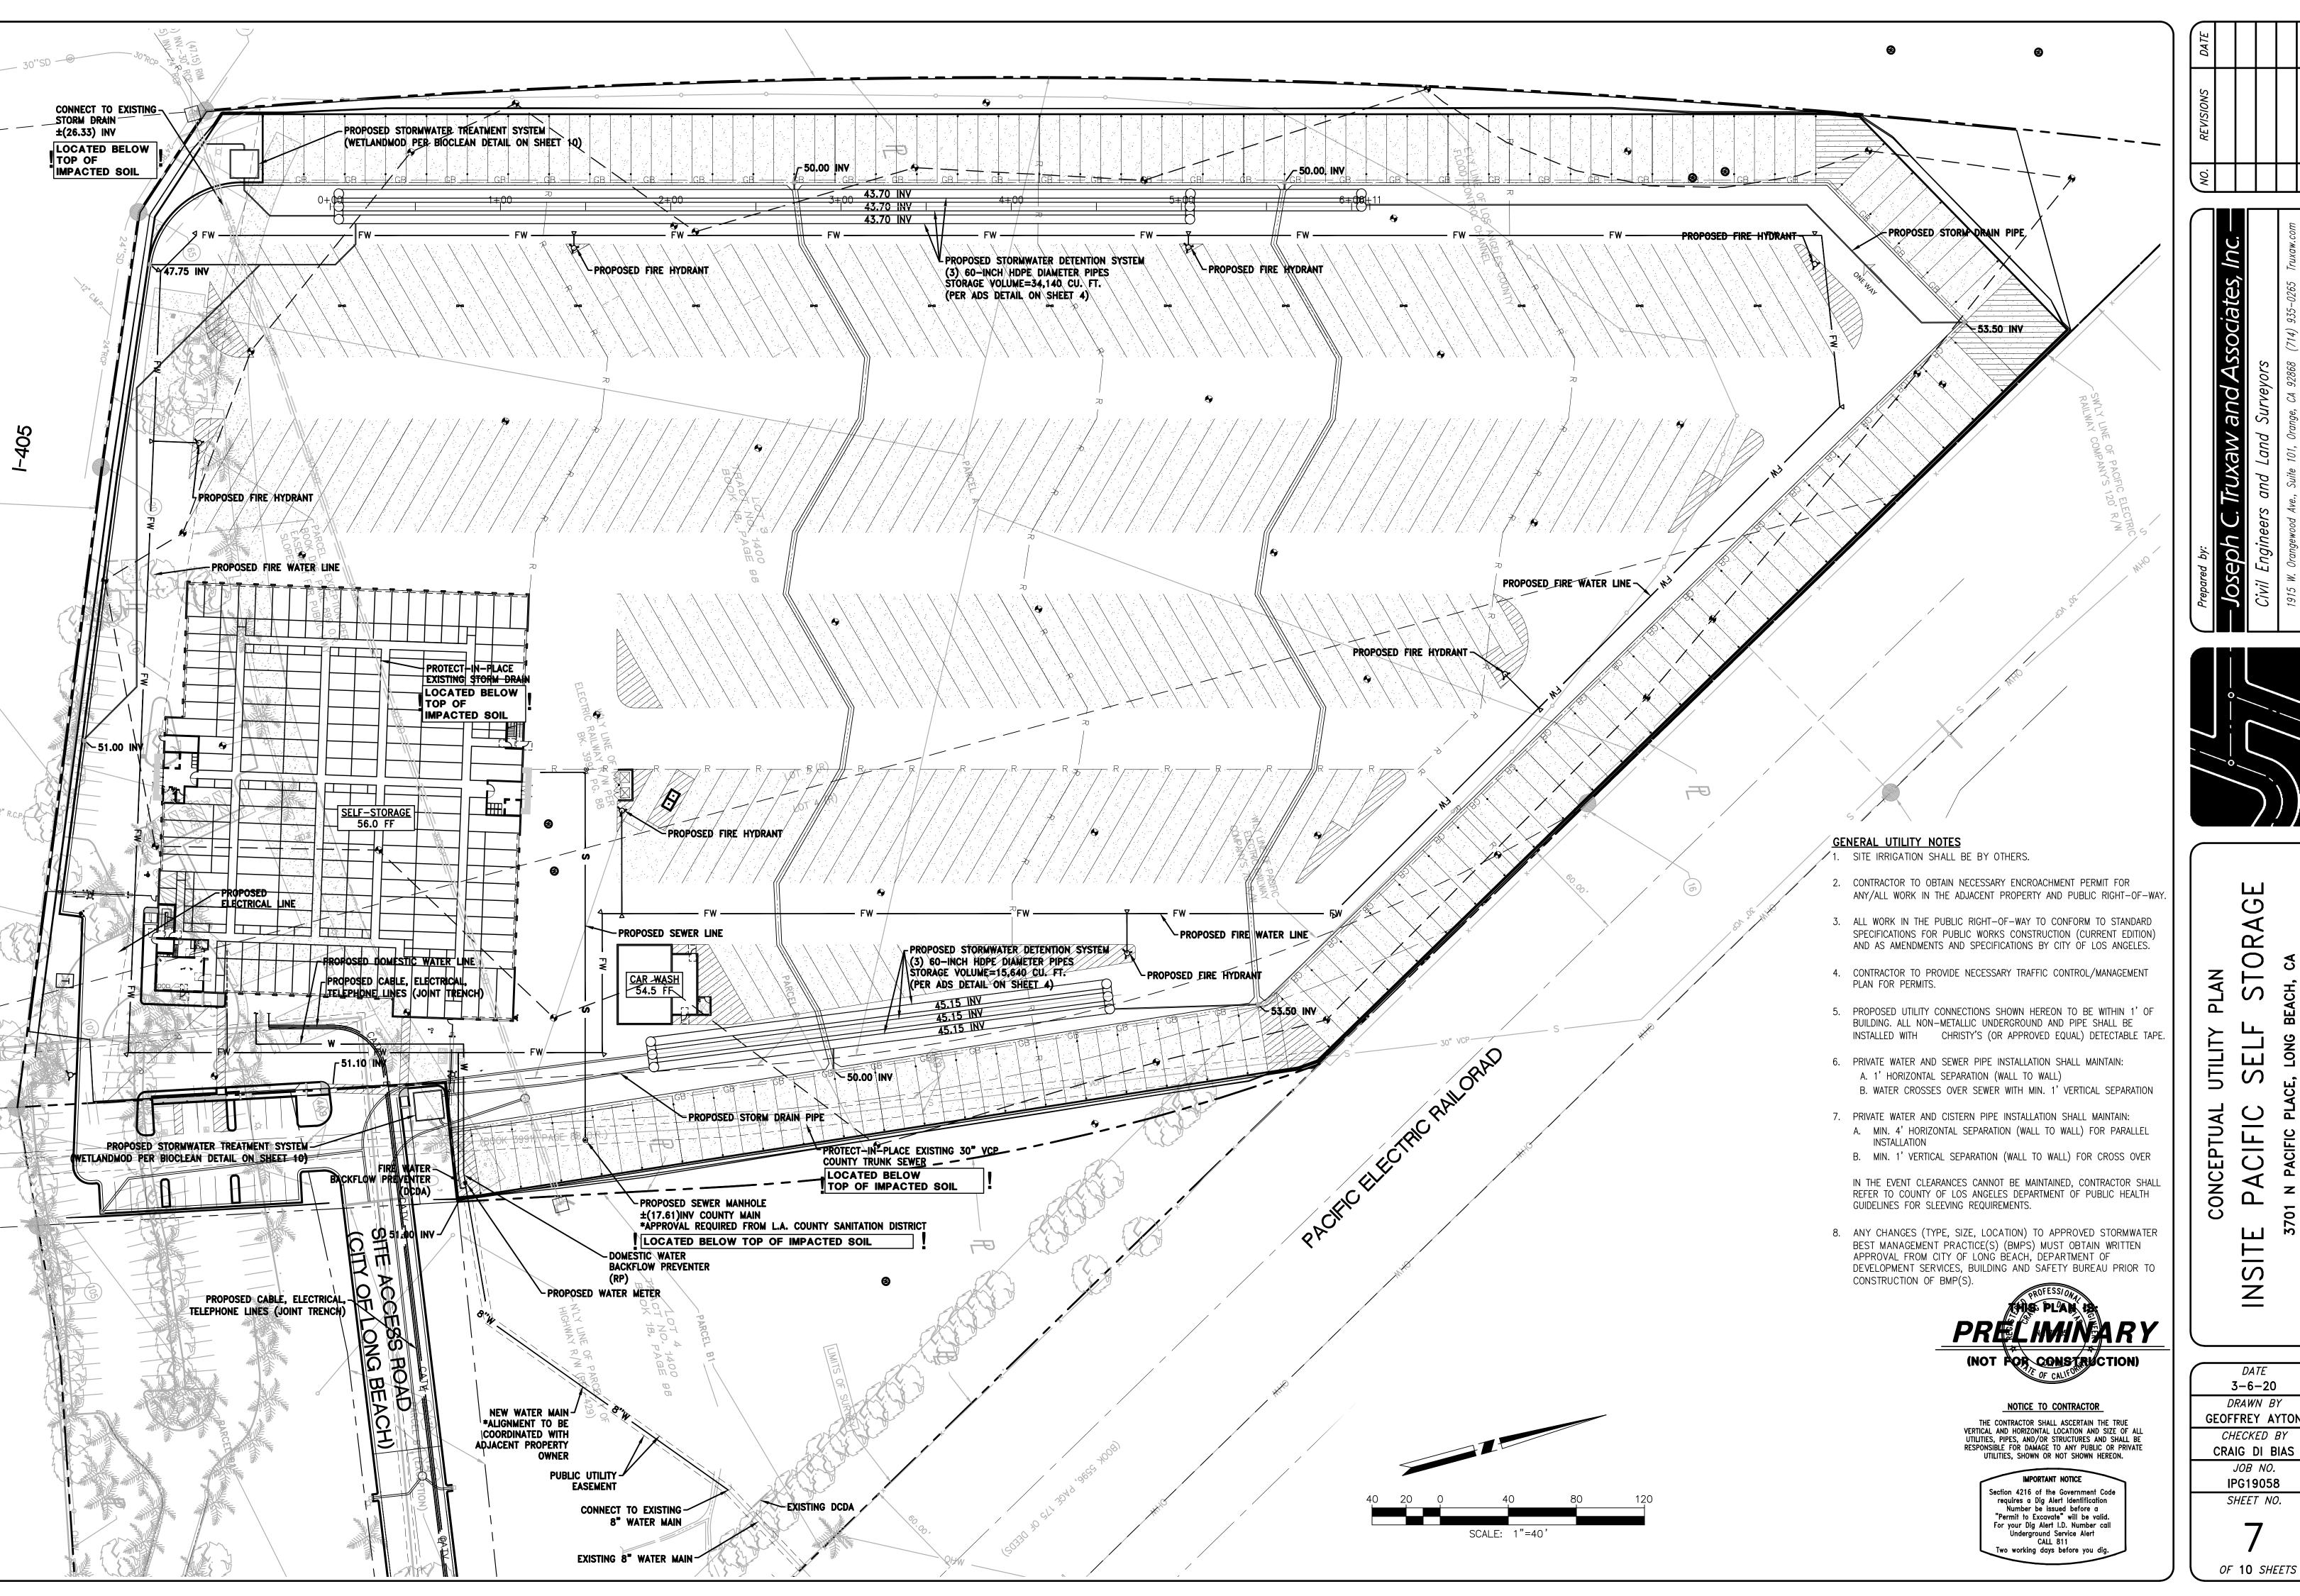

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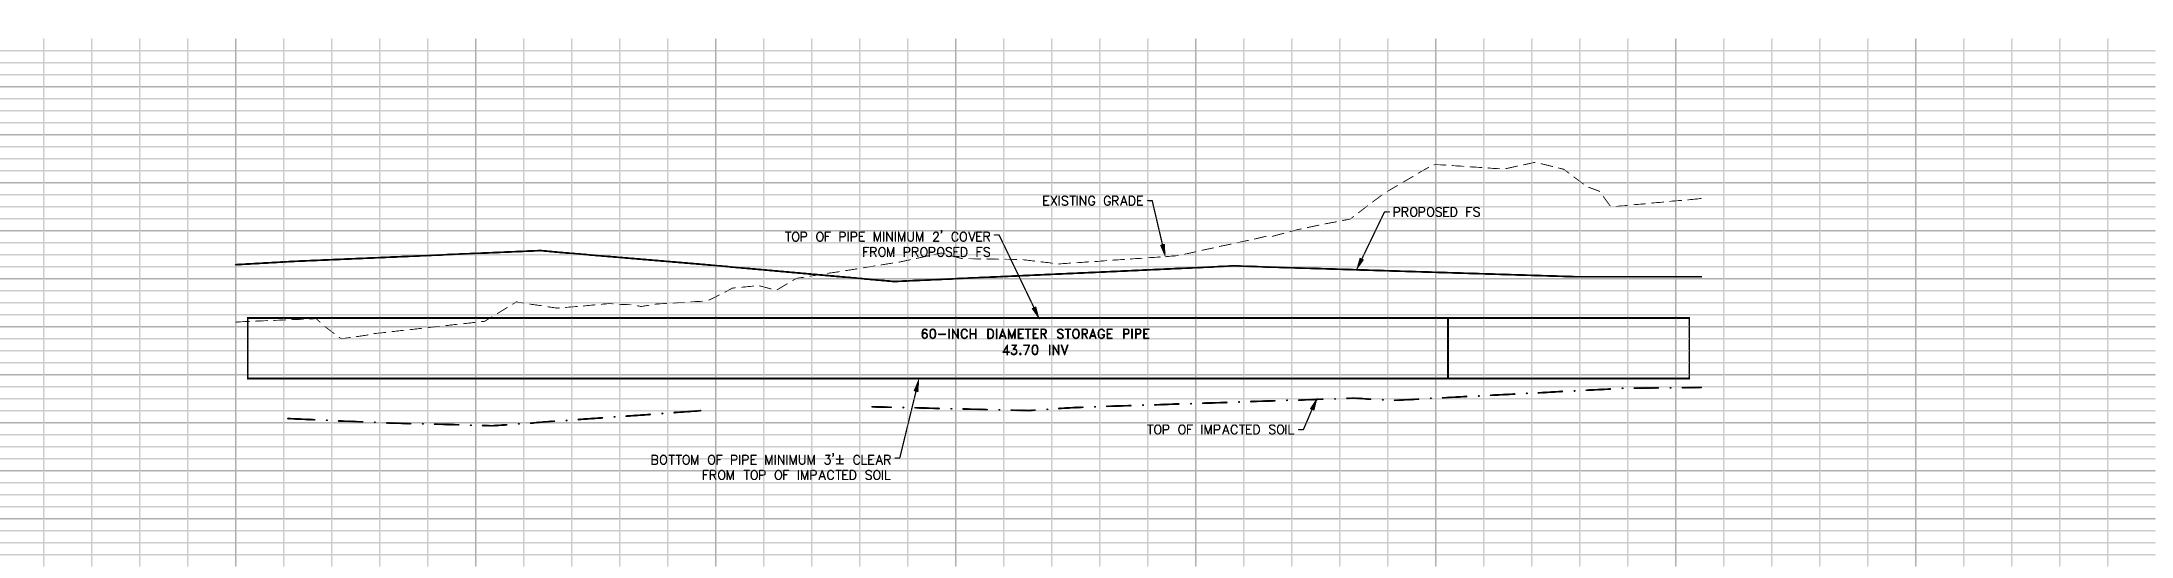
DATE 3-6-20

S

DRAWN BY **GEOFFREY AYTON** CHECKED BY


CRAIG DI BIAS JOB NO. IPG19058

SHEET NO.



SECTION CISTERN A

SCALE: 1"=40' (HORIZONTAL)
1"=8' (VERTICAL)

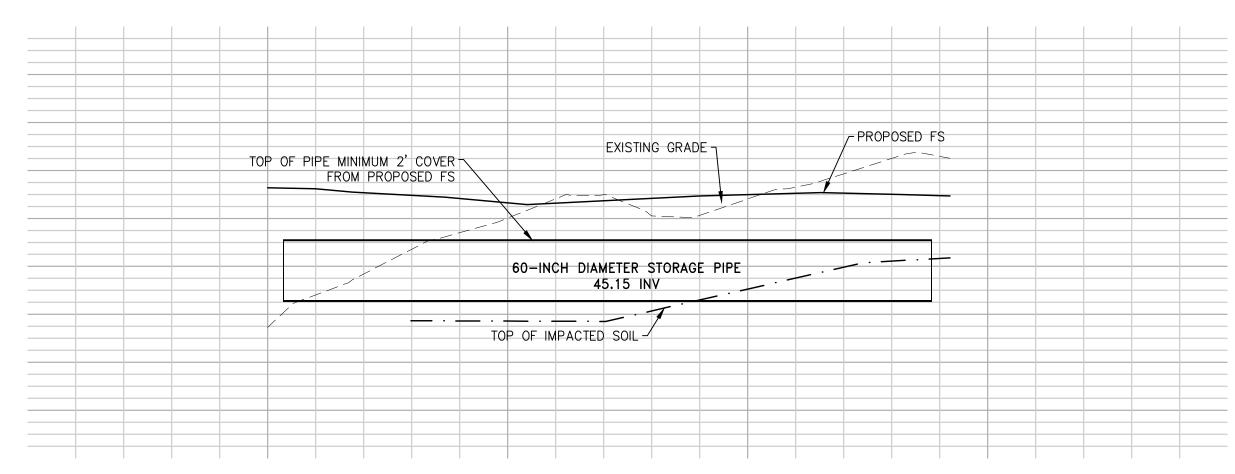

SCALE: 1"=40' (HORIZONTAL)
1"=8' (VERTICAL)



NOTICE TO CONTRACTOR

THE CONTRACTOR SHALL ASCERTAIN THE TRUE VERTICAL AND HORIZONTAL LOCATION AND SIZE OF ALL UTILITIES, PIPES, AND/OR STRUCTURES AND SHALL BE RESPONSIBLE FOR DAMAGE TO ANY PUBLIC OR PRIVATE UTILITIES, SHOWN OR NOT SHOWN HEREON.

IMPORTANT NOTICE

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Two working days before you dig.

ASSITE PACIFIC STORM

SECTIONS

DRAIN

OR

DATE
3-6-20


DRAWN BY
GEOFFREY AYTON

CHECKED BY
CRAIG DI BIAS

JOB NO.
IPG19058

8
OF 10 SHEETS

SHEET NO.

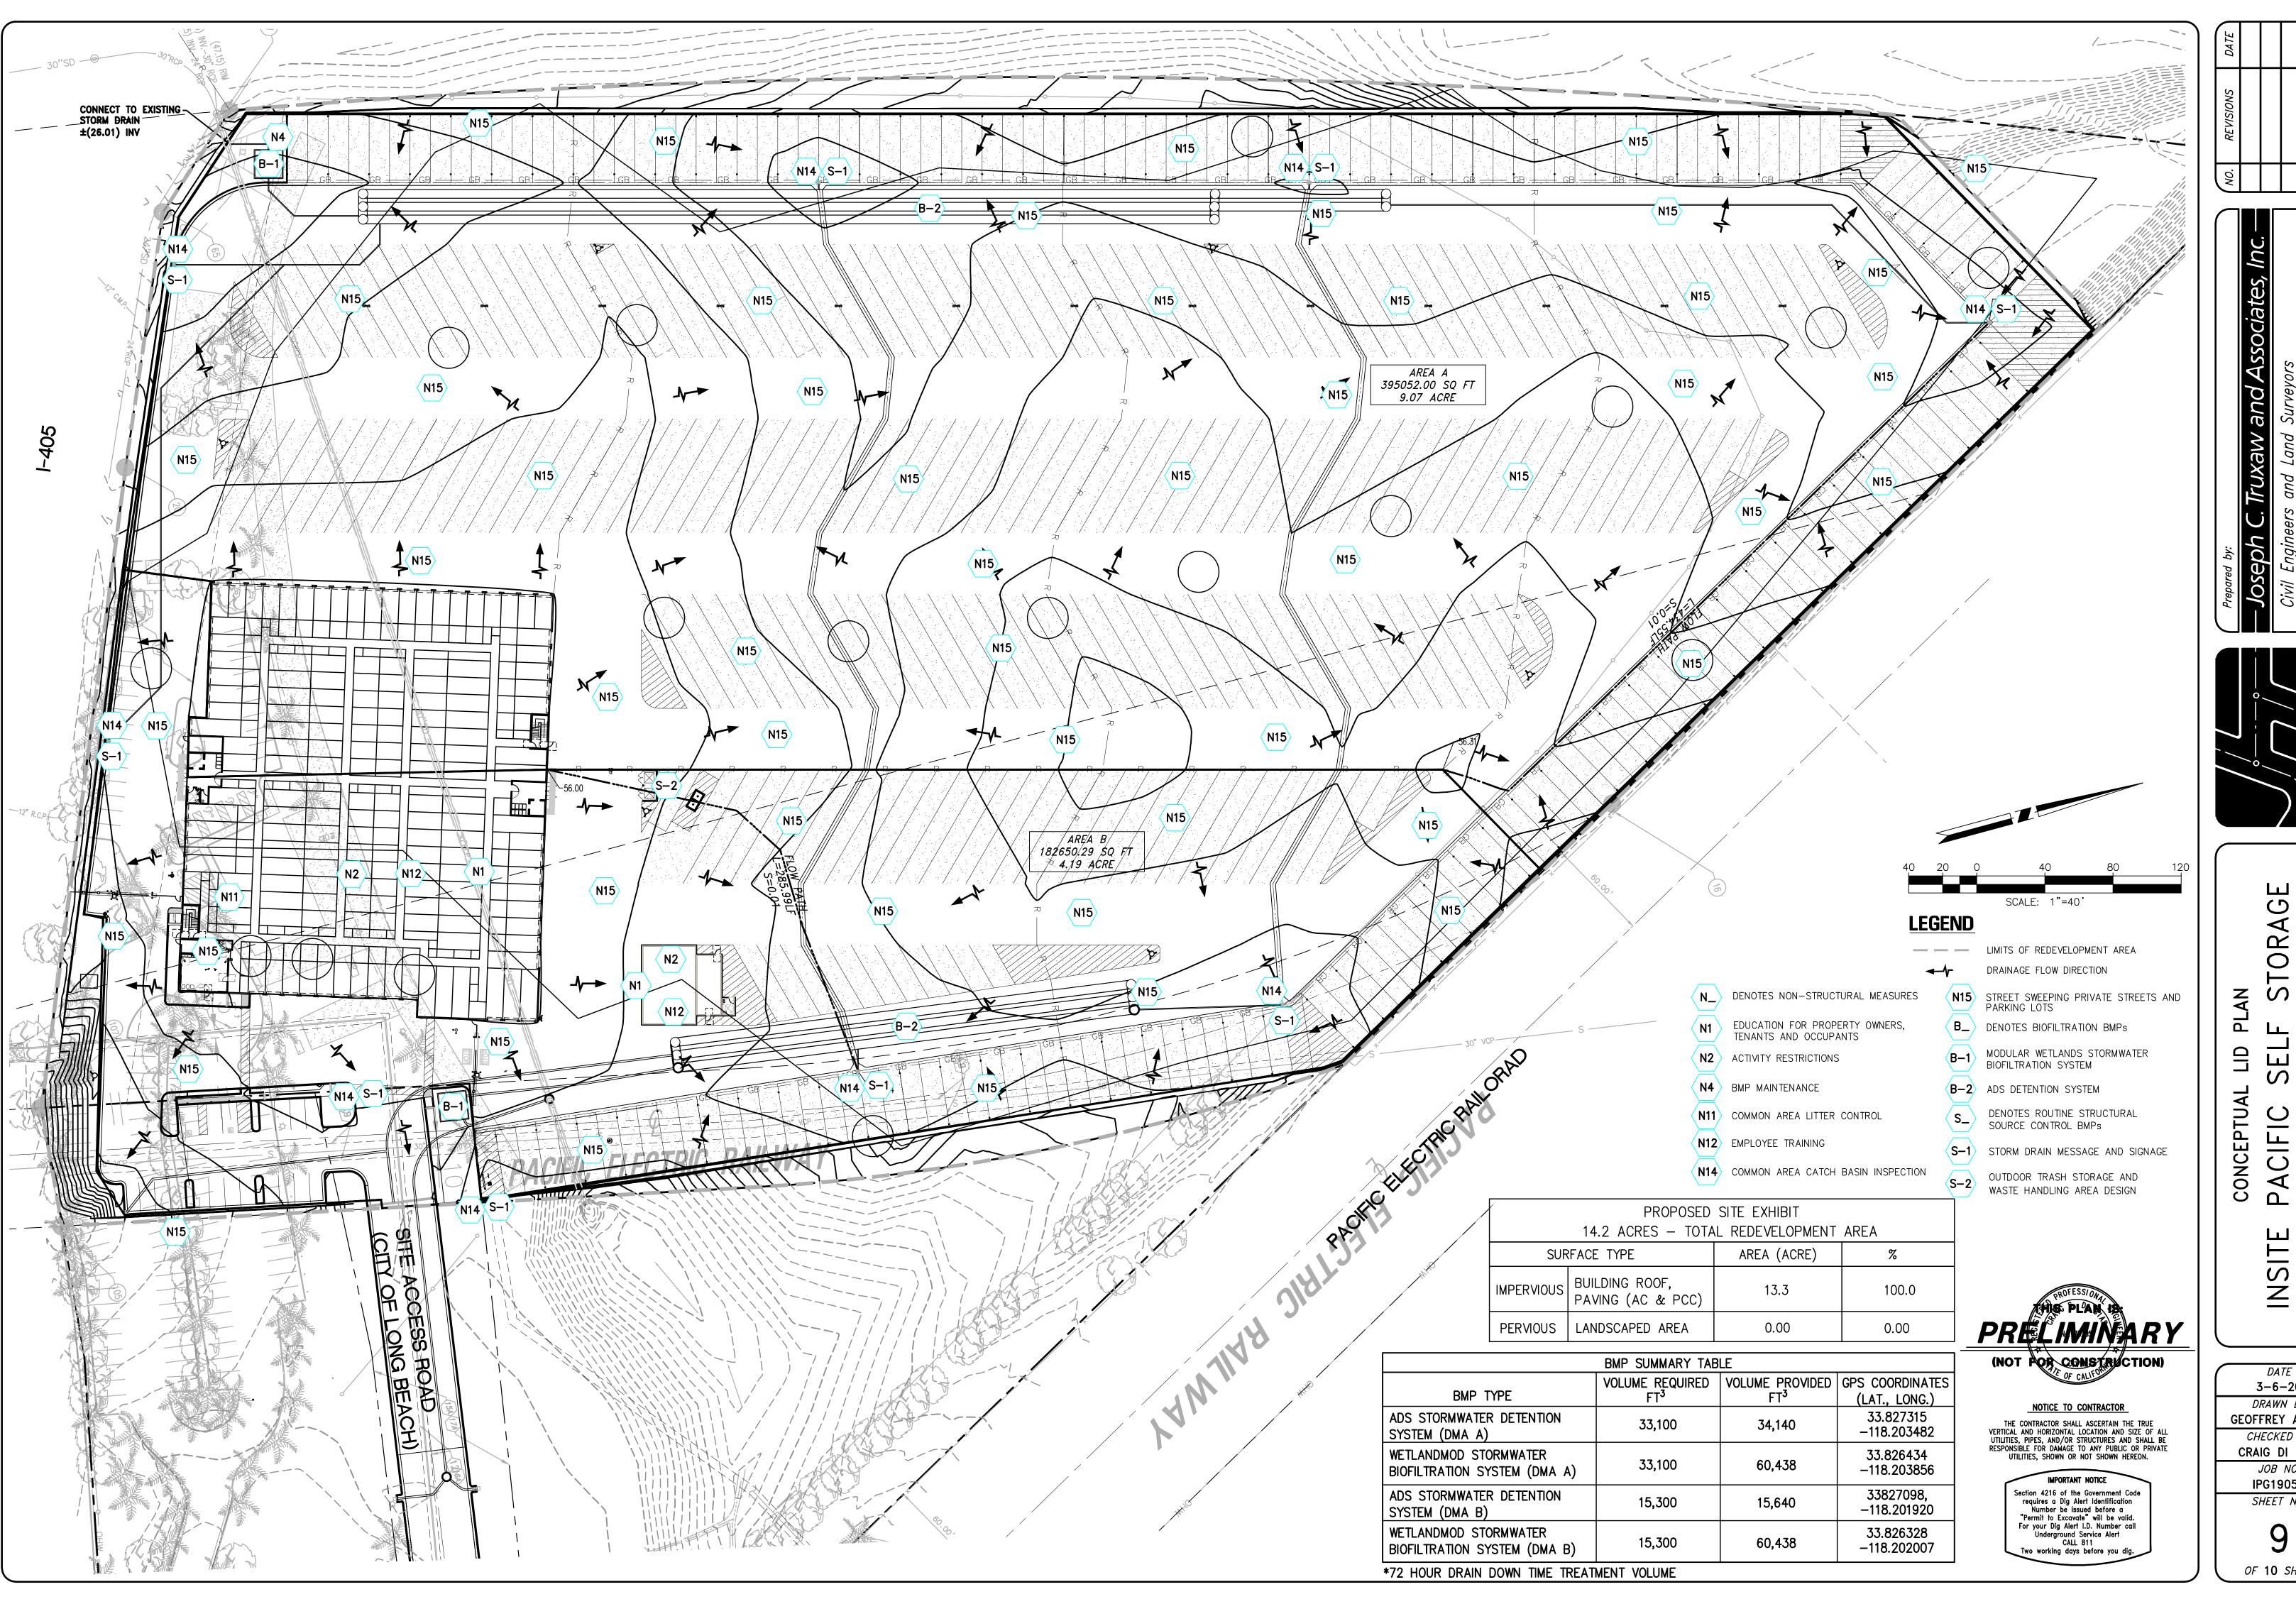

2 0

DATE 3-6-20 DRAWN BY **GEOFFREY AYTON** CHECKED BY CRAIG DI BIAS JOB NO. IPG19058 SHEET NO.

OF 10 SHEETS

Rain Barrels Rain Gardens Planter Boxes

\$3.00 per sq ft of non-infiltrated or non-treated water (first 34").

Land Use (Check the appropriate category):

Off-Site Mitigation Fee \$\_\_\_\_

Impact Development (LID) Plans.

**Total Drainage** 

Area managed by

Project

(acres)

PROJECT NUMBER

PROJECT LOCATION

VOLUME BASED (CF)

N/A

INLET PIPE 2 PER PLAN

OUTLET PIPE PER PLAN

SURFACE LOAD PEDESTRIAN

NOTES: CONCEPTUAL DESIGN

PEAK BYPASS REQUIRED (CFS) — IF APPLICABLE

PER PLAN

PROJECT NAME

STRUCTURE ID

PIPE DATA

INLET PIPE 1

RIM ELEVATION

Owner's Signature

\$3.00 per sq ft of non-infiltrated or non-treated water (first 3/4").

multiple LID BMPs are proposed, the data must be summed.

Registered Design Professional's Signature

SITE SPECIFIC DATA

TREATMENT REQUIRED

PRETREATMENT | BIOFILTRATION

FRAME & COVER | 2EA Ø30" | OPEN PLANTER | Ø24"

Choose at least two LID Measures and provide the required information in each column:

**Development Type** (Check the appropriate category): New Development

Development (LID) Plan and comply with the requirements established by the California

Regional Water Quality Control Board and the State Water Resources Control Board for Low

I hereby certify that the above information is true, accurate, and complete, to the best of my knowledge.

Paul Brown Project Address:

3701 N Pacific Place

う|Off-Site Mitigation Fee \$\_

Section 4: BMP Selection |24

	Category 1 Screening (Feasible)	Category 2 Screening (Potentially Feasible)	Category 3 Screening (Infeasible)
Description	□ Underlying Groundwater □ Depth of bottom of infiltration facility to seasonal high groundwater is > 10 ft □ Site Soils □ Infiltration rate (K <sub>sat</sub> ) is > 0.5 in/hr □ Geotechnical hazards Site Surroundings ☑ Buildings or structures are at least 25 ft away from the potential infiltration BMP ☑ Site is not located within the designated hillside grading area. ☑ No continuous presence of dry weather flows	<ol> <li>Underlying Groundwater</li> <li>□ Depth from bottom of infiltration facility to seasonal high groundwater is ≤ 10 ft</li> <li>□ Unconfined aquifer is present with beneficial uses that may be impaired by infiltration. Full treatment required if this is the case</li> <li>□ Groundwater is known to be polluted.</li> <li>Site Soils</li> <li>□ Infiltration rate is ≤ 0.5 in/hr but potential connectivity to higher K<sub>sat</sub> soils is feasible</li> <li>□ Geotechnical hazards such as liquefaction are a potential near the site</li> <li>Site Surroundings</li> <li>□ Buildings or structures are within 10 to 25 ft of the potential infiltration BMP</li> <li>□ High-risk areas such as service/gas stations, truck stops, and heavy industrial sites. Full treatment is required if this is the case, or high-risk areas must be separate from stormwater runoff mingling</li> </ol>	<ol> <li>Underlying Groundwater         <ul> <li>□ Depth from bottom of infiltration facility seasonal high groundwater is ≤ 5 ft</li> <li>☑ Sites with soil and/or groundwa contamination** Infiltration is not feasible</li> </ul> </li> <li>Site Soils         <ul> <li>□ Infiltration rate is ≤ 0.3 in/hr a connectivity to higher K<sub>sat</sub> soils is infeasible</li> <li>☑ Geotechnical hazards such as liquefactic collapsible soils, or expansive soils exist</li> </ul> </li> <li>Site Surroundings         <ul> <li>□ Site is located on a fill site</li> <li>□ Site is located on or within 50 for upgradient of a steep slope (20% or great and has not been approved by a profession geotechnical engineer or geologist</li> </ul> </li> </ol>
Instructions	If all of the above boxes are checked, they shall be confirmed by a site-specific geotechnical investigation report and/or hydrologic analysis conducted and certified by a State of California registered professional geotechnical engineer or geologist, verifying that infiltration BMPs are feasible at the site*. Otherwise, proceed to Category 2 screening.	If all of the above boxes are checked, or if corresponding boxes in Category 1 are checked in combination with the above boxes, a site-specific geotechnical investigation report and/or hydrologic analysis conducted and certified by a State of California registered professional geotechnical engineer or geologist shall be carried out to approve infiltration measures*. Otherwise, proceed to Category 3 screening.	If any of the above boxes are checked, a site-species geotechnical investigation report and/or hydrologanalysis conducted and certified by a State of Califor registered professional geotechnical engineer geologist shall be submitted to prove infiltrat practices are not feasible. *
	herein.  ** The presence of soil and/or groundwate	eening by Building and Safety Bureau and Public Works Department or contamination and/or the presence of existing or remove mental reports, approved geotechnical reports, permits or	ved underground storage tanks shall be

	Category 1 Screening (Feasible)	Category 2 Screening (Potentially Feasible)	Category 3 Screening (Infeasible)
Description	<ol> <li>Landscaped Area</li> <li>Landscaped area categorization of         <ol> <li>exists in accordance with Table                 <ol> <li>captured volume equal to or less                       than the Estimated Total Water                       Usage (ETWU) from October 1 -</li></ol></li></ol></li></ol>	Landscaped Area     Landscaped area categorization of 2     exists in accordance with Table 4.3     Captured volume greater than the     Estimated Total Water Usage (ETWU)     from October 1 - April 30.  2. Site Soils     Geotechnical hazards such as liquefaction are a potential near the site     Soil hydraulic conductivities are sufficient for the designed water application rate; if not, soil amendments will be implemented	<ol> <li>Landscaped Area         <ul> <li>Landscaped area categorization of 3 exists in accordance with Table 4.3</li> </ul> </li> <li>Site Soils         <ul> <li>Geotechnical hazards such as landsliding, collapsible soils, or expansive soils exist</li> </ul> </li> <li>Site Surroundings         <ul> <li>Site is located on or within 50 feet of a steep slope (20% or greater) as determined by the Department of Building and Safety; irrigation within 3 days of a rain event could cause geotechnical instability</li> </ul> </li> </ol>
Instructions	If all of the above boxes are checked, they shall be confirmed by a site-specific geotechnical investigation report and/or hydrologic analysis conducted and certified by a State of California registered professional civil engineer, geotechnical engineer, geologist, or landscape architect, verifying that capture and use BMPs are feasible at the site.* Otherwise, proceed to	If all of the above boxes are checked, or if corresponding boxes in Category 1 are checked in combination with the above boxes, a site-specific geotechnical investigation report and/or hydrologic analysis conducted and certified by a State of California registered professional civil engineer, geotechnical engineer, geologist, or landscape architect, shall be carried out to approve capture and use	If any of the above boxes are checked, a site-specific geotechnical investigation report and/or hydrologic analysis conducted and certified by a State of California registered professional geotechnical engineer, geologist, or landscape architect shall be submitted to prove capture & use practices are not feasible.*

Section 4: BMP Selection | 28

Table 4.2: Capture and Use Feasibility Screening

Category 2 screening.

\* Geotechnical Reports shall be reviewed by the Building and Safety Bureau and Public Works Department. See Geotechnical Report Requirements contained in the Infiltration Feasibility section.

measures.\* Otherwise, proceed to Category 3

Rev: 09.27.18 1 of 1 LID Project Information.docx

IPG19058

INSITE PACIFIC STORAGE

LONG BEACH, CA

DMA A & DMA B

FLOW BASED (CFS)

MATERIAL

HDPE

HDPE

HDPE

PER PLAN

LID Project Information

# of Trees

Biofiltration

-PRE-FILTER

CARTRIDGE

Wet Ink Stamp Here:

12/20/19

w/o Fill 1 ft subbase 2 ft subbase

Residential / 5-Units or More Non-Residential Industrial Institutional Transportation

48,400

\*Please provide the information requested in each column. The table is intended to represent the cumulative data of the project. If

I certify that the volume capacities provided herein correspond with the approved Low Impact | Affix Registered Design Profession

**Project Design** 

(cubic feet)

SEE NOTES


Open Space Mixed Use Other

Permit Number

Redevelopment 🗹

**Total Volume** 

Capacity of BMPs

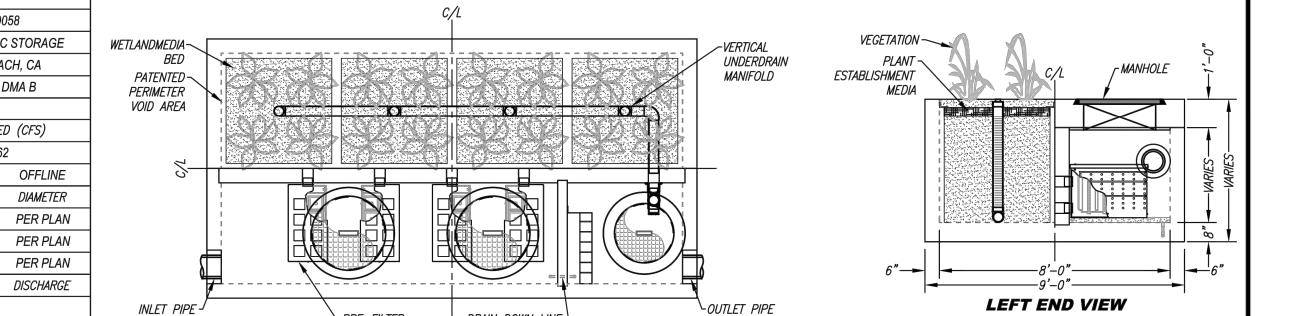

SEE NOTES

\* PRELIMINARY NOT FOR CONSTRUCTION


# **INSTALLATION NOTES**

- CONTRACTOR TO PROVIDE ALL LABOR, EQUIPMENT, MATERIALS AND INCIDENTALS REQUIRED TO OFFLOAD AND INSTALL THE SYSTEM AND APPURTENANCES IN ACCORDANCE WITH THIS DRAWING AND THE MANUFACTURERS SPECIFICATIONS, UNLESS OTHERWISE STATED IN MANUFACTURERS CONTRACT.
- UNIT MUST BE INSTALLED ON LEVEL BASE. MANUFACTURER RECOMMENDS A MINIMUM 6" LEVEL ROCK BASE UNLESS SPECIFIED BY THE PROJECT ENGINEER. CONTRACTOR IS RESPONSIBLE TO VERIFY PROJECT ENGINEERS RECOMMENDED BASE SPECIFICATIONS. CONTRACTOR TO SUPPLY AND INSTALL ALL EXTERNAL CONNECTING PIPES. ALL PIPES MUST BE FLUSH WITH INSIDE SURFACE OF
- CONCRETE. (PIPES CANNOT INTRUDE BEYOND FLUSH). INVERT OF OUTFLOW PIPE MUST BE FLUSH WITH DISCHARGE CHAMBER FLOOR. ALL PIPES SHALL BE SEALED WATER TIGHT PER MANUFACTURERS STANDARD CONNECTION DETAIL.
- CONTRACTOR RESPONSIBLE FOR INSTALLATION OF ALL RISERS, MANHOLES, AND HATCHES. CONTRACTOR TO GROUT ALL MANHOLES AND HATCHES TO MATCH FINISHED SURFACE UNLESS SPECIFIED OTHERWISE. VEGETATION SUPPLIED AND INSTALLED BY OTHERS. ALL UNITS WITH
- VEGETATION MUST HAVE DRIP OR SPRAY IRRIGATION SUPPLIED AND INSTALLED BY OTHERS. CONTRACTOR RESPONSIBLE FOR CONTACTING BIO CLEAN FOR ACTIVATION OF UNIT. MANUFACTURERS WARRANTY IS VOID WITH OUT

PROPER ACTIVATION BY A BIO CLEAN REPRESENTATIVE.

# **GENERAL NOTES**

MANUFACTURER TO PROVIDE ALL MATERIALS UNLESS OTHERWISE NOTED. ALL DIMENSIONS, ELEVATIONS, SPECIFICATIONS AND CAPACITIES ARE SUBJECT TO CHANGE. FOR PROJECT SPECIFIC DRAWINGS DETAILING EXACT DIMENSIONS, WEIGHTS AND ACCESSORIES PLEASE CONTACT BIO CLEAN.

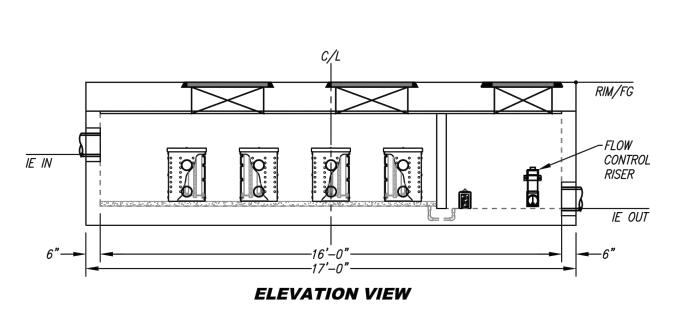

OPRIETARY AND CONFIDENTIAL:

THE PRODUCT MAY BE PROTECTED BY ONE OR MORE OF MORE OF

**PLAN VIEW** 

1	
+	
-VARIES-	
-   XA  -   XA R	
<u> </u>	6" MIN. BASE
\$10505	
	RIGHT END VIEW

TREATMENT FLOW (CFS)	0.462
OPERATING HEAD (FT)	3.4
PRETREATMENT LOADING RATE (GPM/SF)	2.0
WETLAND MEDIA LOADING RATE (GPM/SF)	1.0
MWS-1-8-16-V	

1V1 VV 3-L-0-10-V STORMWATER BIOFILTRATION SYSTEM STANDARD DETAIL



City of Long Beach **Department of Development Services Building and Safety Bureau** 333 West Ocean Blvd., 4<sup>th</sup> Floor Long Beach, CA 90802 tel: 562-570-LBDS fax: 562-570-6753 Website: http://www.lbds.info

# LID OBSERVATION REPORT FORM

LID OBSERVATION means the visual observation of the Low Impact Development ("LID") and storm water related Best Management Practices (BMPs) for conformance with the approved LID Plan at significant construction stages and at completion of the project. LID observation does not include or waive the responsibility for the inspections required by Section 18.07.050 or other sections of the City of Long Beach Building Code.

LID OBSERVATION must be performed by the Registered Design Professional ("RDP") responsible for the approved LID Plan or designated staff in their employment.

LID OBSERVATION REPORT must be signed and stamped below by the RDP responsible for the approved LID Plan and submitted to the city prior to the Building Final or issuance of the certificate of occupancy.

e Number: 935-0265
333-0203
e Number:

Updated: 11-27-12

- ☐ Installation is approved and without deficiencies.
- ☐ Final lid observation for the project is 100% complete without any deficiencies.
- ☐ Observed deficiencies and comments:

I declare that the following statements are true to the best of my 1. I am the Registered Design Professional retained by the

- Owner to be in responsible charge for the approved LID plan,
- 2. I, or a designated staff under my responsible charge, has performed the required site visits at each significant construction stage and at completion to verify that the best management practices as shown on the approved LID plan have been constructed and installed in accordance with the approved LID plan.

STAMP OF LID OBSERVER OF RECORD SIGNATURE OF LID OBSERVER OF RECORD

1 of 1



NOTICE TO CONTRACTOR THE CONTRACTOR SHALL ASCERTAIN THE TRUE VERTICAL AND HORIZONTAL LOCATION AND SIZE OF ALL UTILITIES, PIPES, AND/OR STRUCTURES AND SHALL BE RESPONSIBLE FOR DAMAGE TO ANY PUBLIC OR PRIVATE

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> Number be issued before a
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UTILITIES, SHOWN OR NOT SHOWN HEREON.

SHEET NO.

OF 10 SHEETS



DET OR .UAL EP  $\overline{\mathbf{O}}$ NO Ō

DATE 3-6-20 DRAWN BY **GEOFFREY AYTON** CHECKED BY CRAIG DI BIAS JOB NO.

IPG19058