## **APPENDICES**

- Appendix A Plan Sheets for the San Bernardino Bike Trail Project
- **Appendix B Visual Resources Technical Memorandum**
- Appendix C Invasive Plant Risk Assessment (IPRA)
- **Appendix D Natural Environment Study (NES)**
- **Appendix E Sierra Nevada Yellow-Legged Frog Site Assessment**
- **Appendix F Aquatic Resources Delineation Report**
- **Appendix G –Historic Property Survey Report (HPSR)**
- **Appendix H Feasibility Report**
- **Appendix I Preferred Alternative Memorandum**
- Appendix J Geotechnical Report

## **APPENDIX A**

## PLAN SHEETS FOR THE SAN BERNARDINO BIKE TRAIL PROJECT

#### INDEX OF SHEETS

SHEET NO.	SHEET NAME	TITLE
1	i	TITLE SHEET
2	ii	GENERAL NOTES, ABBREVIATIONS, AND LE
Χ	L-1	LAYOUT STA 10+ 00 - 14+00
Χ	L-2	LAYOUT STA 14+00 - 18+00
Χ	L-3	LAYOUT STA 18+00 - XX+XX
Χ	C-1	CONSTRUCTION DETAILS
Χ	EC-1	TEMPORARY EROSION CONTROL PLAN
Χ	EC-2	TEMPORARY EROSION CONTROL DETAILS
Χ	PD-1	SIGNING AND PAVEMENT DELINEATION
Χ	PD-2	SIGNING AND PAVEMENT DELINEATION
Χ	PD-3	SIGNING AND PAVEMENT DELINEATION


## COUNTY OF EL DORADO, CA DEPARTMENT OF TRANSPORTATION

PROJECT PLANS FOR THE CONSTRUCTION OF THE 2021

# SAN BERNARDINO CLASS 1 BIKE TRAIL PROJECT

IN THE COUNTY OF EL DORADO, DISTRICT 5, PORTION OF SEC 29, PORTION OF EAST 1/4 SEC 30, PORTION OF SOUTH 1/4 SEC 20, T12N, R18E, MDM

LOCATION MAP

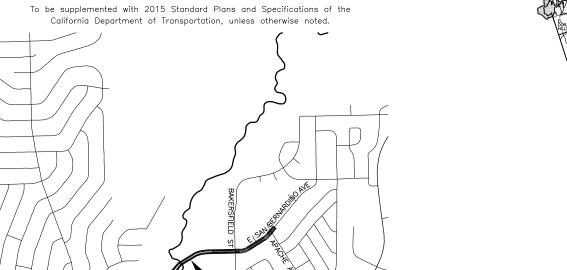

SITE LOCATION . VICINITY MAP

FUNDING AGENCY

CONGESTION MITIGATION AND AIR QUALITY PROGRAM TAHOE REGIONAL PLANNING AGENCY

SAN BERNARDINO CLASS 1

BIKE TRAIL PROJECT

CONTRACTOR'S LICENSE CLASSIFICATION: Bidders shall be properly licensed to perform the Work pursuant to the State Contractor's License Law (Business and Professions Code section 7000 et seq.) and shall possess a CLASS A LICENSE or equivalent combination of Classes required by the categories and type of Work included in the Contract Documents and Plans, at the time the Contract is awarded, and shall maintain a valid license through completion and acceptance of the Work including guarantee and warranty period. If the Contractor possesses a Class A license instead of the equivalent combination of Classes required by the categories and type of work included in the Contract Documents and Plans, then the Contractor or a subcontractor must also possess a CLASS C27 "Landscaping Contractor" license. Failure of the successful Bidder to obtain proper and adequate licensing for an award of the Contract shall constitute a failure to execute the Contract, and shall result in forfeiture of the Bidders security.

			REVISIONS
			Dueliesies
			Preliminary
			For information purposes only.
			Not for Construction.
MARK	DATE	BY	



SUBMITTED BY: DONALDO S. PALAROAN P.E. SENIOR CIVIL ENGINEER STATE OF CALIFORNIA NO. C66083

COUNTY OF EL DORADO DEPARTMENT OF TRANSPORTATION

STUMF

WILLOW CLUSTER LANDSCAPE LIGHTING

TREE, DIAMETER AND TYPE

- ALL IMPROVEMENTS WILL BE ACCOMPLISHED UNDER THE APPROVAL, INSPECTION, AND TO THE SATISFACTION OF THE COUNTY OF EL DORADO DEPARTMENT OF TRANSPORTATION (DOT). IMPROVEMENT CONSTRUCTION MUST COMPLY WITH THESE PLANS AND THE 2015 CALTRANS STANDARD PLANS, UNLESS NOTED OTHERWISE. ALL REFERENCES TO THE "STANDARD SPECIFICATIONS" MEAN THE STATE OF CALIFORNIA, DEPARTMENT OF TRANSPORTATION (CALTRANS) 2015 STANDARD SPECIFICATIONS. CONSTRUCTION NOT SPECIFIED ON THESE PLANS OR IN SPECIFIC COUNTY OF EL DORADO (COUNTY) ORDINANCES MUST CONFORM TO THE REQUIREMENTS OF THE STANDARD SPECIFICATIONS. YOU ARE OBLIGATED TO BE FAMILIAR WITH APPLICABLE SECTIONS OF THE STANDARD SPECIFICATIONS NOT DISCUSSED IN THE GENERAL NOTES. THE CONTRACT SPECIAL PROVISIONS SUPERSEDE THE STANDARD SPECIFICATIONS WHERE DISCREPANCIES OCCUR.
- CONSTRUCTION HOURS WILL BE WEEKDAYS BETWEEN 8:00 A.M. AND 6:30 P.M. UNLESS PRIOR APPROVAL IS RECEIVED FROM DOT.
- THE LOCATIONS AND EXTENT OF UNDERGROUND UTILITIES IN THE WORK AREA AS SHOWN ARE APPROXIMATE AND ARE NOT NECESSARILY COMPLETE. A REASONABLE EFFORT HAS BEEN MADE TO LOCATE AND DELINEATE UTILITIES BASED UPON AVAILABLE RECORDS. YOU MUST DETERMINE THE TYPE, LOCATION, SIZE, AND/OR DEPTH OF THE UTILITIES WITHIN THE WORK AREA BEFORE STARTING WORK. YOU OR ANY SUBCONTRACTOR FOR THIS CONTRACT ARE RESPONSIBLE FOR DAMAGES DUE TO THE FAILURE TO EXACTLY LOCATE AND PRESERVE UNDERGROUND UTILITIES. YOU MUST CONTACT UNDERGROUND SERVICE ALERT AT (800) 642-2444 AT LEAST 48 HOURS BEFORE ANY CONSTRUCTION. YOU ASSUME COMPLETE RESPONSIBILITY FOR DAMAGED UTILITIES.
- UNLESS SHOWN OTHERWISE. YOU ARE RESPONSIBLE FOR THE PROTECTION OF ALL EXISTING SURVEY MONUMENTS AND OTHER SURVEY MARKERS, INCLUDING CONSTRUCTION STAKES DURING CONSTRUCTION AND YOU ARE RESPONSIBLE FOR THE COST TO REPLACE ANY SUCH SURVEY MONUMENTS, MARKERS, OR STAKES,
- YOU WILL PROVIDE ALL LIGHTS, SIGNS, BARRICADES, FLAGGERS, PILOT CAR, OR OTHER DEVICES NECESSARY TO CONTROL TRAFFIC THROUGH THE JOB SITE AND FOR PUBLIC SAFETY UNDER THESE PLANS, THE STANDARD SPECIFICATIONS, AND CALIFORNIA MANUAL ON UNIFORM TRAFFIC CONTROL DEVICES (MUTCD).
- YOU AGREE TO ASSUME SOLE RESPONSIBILITY FOR JOB SITE CONDITIONS DURING THE COURSE OF THE WORK, INCLUDING SAFETY OF ALL PERSONS AND PROPERTY, AND FURTHER AGREE THAT THIS REQUIREMENT APPLIES CONTINUOUSLY AND IS NOT LIMITED TO NORMAL WORKING HOURS UNDER THE CONTRACT AND STANDARD SPECIFICATIONS.
- THERE WILL BE NO GRADING OR LAND DISTURBANCE BETWEEN OCTOBER 15 AND MAY 1 UNLESS APPROVALS ARE OBTAINED FROM THE TAHOE REGIONAL PLANNING AGENCY (TRPA), AS PROVIDED IN THE LIMITED EXEMPTION DESCRIBED IN CHAPTER 64, SUBSECTION 64.2.B. OF THE TRPA CODE OF ORDINANCES. APPROVALS FOR GRADING BETWEEN OCTOBER 15 AND MAY 1 MUST ALSO BE OBTAINED FROM THE LAHONTAN REGIONAL WATER QUALITY CONTROL BOARD. IF REQUIRED, DOT WILL OBTAIN THESE APPROVALS.
- YOU WILL MAINTAIN A SET OF PLANS ON THE JOB SITE SHOWING "AS-CONSTRUCTED" CHANGES MADE TO DATE. UPON COMPLETION OF THE WORK, YOU WILL GIVE TO THE COUNTY A SET OF PLANS, MARKED UP TO THE SATISFACTION OF DOT, REFLECTING THE AS-CONSTRUCTED
- ALL CONTROL STATIONING AND DATA DIMENSIONING REFERENCE THE CENTERLINE OF THE FACILITY SHOWN, UNLESS NOTED OTHERWISE.
- 10. YOU WILL NOT CLOSE OFF ANY UTILITY LINES OR OPEN VALVES OR TAKE ANY OTHER ACTION WHICH WOULD AFFECT THE OPERATION OF WATER OR SEWER SYSTEMS WITHOUT APPROVAL FROM THE SOUTH TAHOE PUBLIC UTILITY DISTRICT (STPUD). APPROVAL MUST BE REQUESTED AT LEAST 48 HOURS BEFORE INTERPUTPION TO ACTIVE WATER OR SEWER SERVICES, INCLUDING FIRE HYDRAMS, WHETHER INTENTIONAL OR NOT, MUST BE KEPT TO A MINIMUM TIME PERIOD. IF SERVICE TO BUILDINGS IS TO BE OFF FOR MORE THAN FOUR HOURS, YOU MUST ADVISE STPUD.
- 11. YOU ARE REQUIRED TO IMPLEMENT DUST CONTROL MEASURES TO ENSURE THAT DUST RESULTING FROM YOUR ACTIVITIES IS CONTROLLED AND COMPLIES WITH THE PROVISIONS OF SECTION 7, "LEGAL RELATIONS AND RESPONSIBILITY TO THE PUBLIC," AND SECTION 14, "ENVIRONMENTAL STEWARDSHIP," OF THE STANDARD SPECIFICATIONS, COUNTY, AND LOCAL ORDINANCES.
- YOU ARE RESPONSIBLE FOR IMPLEMENTING ALL TEMPORARY EROSION CONTROL MEASURES. THE TEMPORARY EROSION CONTROL MEASURES MUST COMPLY WITH THE TRPA "HANDBOOK OF BEST MANAGEMENT PRACTICES" AND THE STORM WATER POLLUTION PREVENTION PLAN (SWPPP).

  DOT WILL CONTACT TRPA BEFORE THE START OF THE WORK FOR A PRE-GRADE INSPECTION OF THE INSTALLED TEMPORARY EROSION CONTROL FACILITIES. YOU ARE RESPONSIBLE FOR THE MAINTENANCE AND PERFORMANCE OF THE TEMPORARY EROSION CONTROL MEASURES THROUGHOUT
- 13. CONSTRUCTION LIMITS SHOWN DELINEATE THE BOUNDARIES FOR YOUR ACTIVITIES BEYOND THE COUNTY ROAD RIGHT-OF-WAY. TEMPORARY FENCE (TYPE ESA) MUST BE ERECTED ALONG THESE BOUNDARIES BEFORE WORK STARTS. VEGETATION WITHIN THESE LIMITS MUST BE PROTECTED TO THE EXTENT FEASIBLE. ALL TREES MUST BE PROTECTED UNLESS SHOWN TO BE REMOVED.
- 14. UNLESS NOTED OTHERWISE, ALL REVEGETATION IS TO BE COMPLETED BY OTHERS.
- 15. YOU WILL ONLY USE THE DESIGNATED SITES SHOWN FOR STORAGE OF EQUIPMENT AND MATERIALS. YOU ARE RESPONSIBLE FOR THE SECURITY
- 16. IT IS YOUR AND YOUR SUBCONTRACTOR(S) RESPONSIBILITY TO EXAMINE THE JOB SITE BEFORE THE OPENING OF BID PROPOSALS. YOU MUST BECOME FAMILIAR WITH THE NATURE AND LOCATION OF THE WORK AND THE GENERAL AND LOCAL CONDITIONS, PARTICULARLY THOSE AFFECTING THE AVAILABILITY OF TRANSPORTATION, THE DISPOSAL, HANDLING, AND STORAGE OF MATERIALS, AVAILABILITY OF LABOR, WATER, ELECTRICITY, ROADS, THE UNCERTAINTIES OF WEATHER, THE CONDITIONS OF THE GROUND, SURFACE AND SUBSURFACE MATERIALS, THE EQUIPMENT AND FACILITIES NEEDED FOR AND DURING THE PERFORMANCE OF THE WORK. FAILURE BY YOU OR YOUR SUBCONTRACTOR(S) TO ACQUAINT YOURSELVES WITH THE INFORMATION AVAILABLE WILL NOT RELIEVE YOU OR YOUR SUBCONTRACTOR(S) FROM RESPONSIBILITY FOR PROPERLY ESTIMATING THE DIFFICULTY AND COST OF SUCCESSFULLY PERFORMING THE WORK.
- 17. ELEVATIONS FOR PIPE INVERTS, FLOWLINES, TOPS OF GRATES, RIMS, ETC., ARE BASED ON THE TOPOGRAPHIC INFORMATION SHOWN. YOU WILL VERIFY ALL NECESSARY SURFACE ELEVATIONS IN THE FIELD AND NOTIFY THE TD OF ANY DISCREPANCIES WHICH MIGHT AFFECT THE OPERATION OF THE NEW FACILITIES BEFORE BREAKING GROUND FOR THE INSTALLATION. DOT MUST BE CONTACTED IF ELEVATIONS ARE INCORRECT SO PROPER ADJUSTMENTS CAN BE MADE BEFORE THE INSTALLATION OF THE FACILITIES.
- 18. EXCEPT FOR THOSE OBTAINED BY DOT, YOU MUST OBTAIN, AT YOUR EXPENSE, ALL PERMITS, LICENSES, INSURANCE POLICIES, ETC., NECESSARY TO COMPLY WITH STATE AND LOCAL LAWS ASSOCIATED WITH THE PERFORMANCE OF THE WORK.
- 19. YOU ARE RESPONSIBLE TO REVIEW THE CONTRACT DOCUMENTS FOR SUBMITTALS REQUIRED FOR COUNTY REVIEW AND ACCEPTANCE.
- 20. THE COUNTY WILL PROVIDE CONSTRUCTION STAKING IN COMPLIANCE WITH SECTION 5-1.26 OF THE STANDARD SPECIFICATIONS.
- 21. THE PLANS SHOW SLOPE LENGTHS FOR PIPE ROUNDED TO THE NEAREST FOOT. ALL PIPE LENGTHS AND INVERT ELEVATIONS SHOWN ON THE PLANS ARE TO THE CENTERLINE OF THE STRUCTURES TO WHICH THE PIPES ARE ATTACHED. SEE THE STANDARD SPECIFICATIONS FOR THE MAXIMUM ALLOWABLE DEFLECTION ANGLE AT EACH PIPE JOINT.
- 22. YOU ARE RESPONSIBLE TO MAINTAIN THE GRADING LIMITS AS SHOWN ON THE PLANS, DETAILS, CROSS SECTIONS, AND AS DIRECTED BY THE

	NOTE: LOWER CASE TEXT	WITHIN PLAN SET II	NDICATES EXISTING
Δ	DELTA = DEFLECTION ANGLE	MAT'L	MATERIAL
Α	ARCH OR ASPEN	MISC	MISCELLANEOUS
AB	AGGREGATE BASE	мос	MID POINT ON CURVE
ABAND	ABANDONED	MOD	MODIFIED
ABC AC	ARTICULATED BLOCK CHANNEL ASPHALT CONCRETE	N NIC	NORTH NOT IN CONTRACT
AP	ANGLE POINT	NGVD	NATIONAL GEODETIC VERTICAL DATUM
APN	ASSESSOR'S PARCEL NUMBER	NTS	NOT TO SCALE
BC	BEGIN CURVE	OAE	OR APPROVED EQUAL
BCR	BEGIN CURB RETURN	0C	ON CENTER
BGN BLC	BEGIN BLANKET—LINED CHANNEL	OD OG	OUTSIDE DIAMETER ORIGINAL GROUND
BV	BAY VIEW	OH	OVERHEAD
BVCE	BEGIN VERTICAL CURVE ELEVATION		D/X OVEREXCAVATION
BVCS	BEGIN VERTICAL CURVE STATION	P	PINE
С	CEDAR	PC	POINT OF BEGINNING OF CURVE
CALCS	CALCULATIONS	PCC	PORTLAND CEMENT CONCRETE OR POINT OF COMPOUND CURVE
CATV CC	CABLE TELEVISION CENTER TO CENTER	PERF	PERFORATED
CF	CUBIC FEET OR CURB FACE	PL	PROPERTY LINE
CHD	CHORD DIRECTION	PCVCE	POINT OF COMPOUND VERTICAL CURVE ELEVATION
CIR	CIRCLE	PCVCS	POINT OF COMPOUND VERTICAL CURVE STATION
ę	CENTERLINE	POR	PORTION
CL	CLASS OR CENTERLINE	PRVCE	POINT OF REVERSE VERTICAL CURVE ELEVATION
CLR CO	CLEAR CURB OPENING OR CLEANOUT	PRVCS PP	POINT OF REVERSE VERTICAL CURVE STATION POWER/UTILITY POLE
CO.	COUNTY	PRC	POINT OF REVERSE CURVE
CONC	CONCRETE	PROP	PROPOSED
CONST	CONSTRUCT	PT	POINT OR POINT OF TANGENCY
CMP	CORRUGATED METAL PIPE	PUE	PUBLIC UTILITY EASEMENT
CR	CEDAR RIDGE	PVC	POLYVINYL CHLORIDE
CSP CT	CORRUGATED STEEL PIPE CALTRANS OR COURT	PVIE PVIS	POINT OF VERTICAL INTERSECTION ELEVATION POINT OF VERTICAL INTERSECTION STATION
CTC	CALIFORNIA TAHOE CONSERVANCY	PVIS PVMT	POINT OF VERTICAL INTERSECTION STATION  PAVEMENT
CY	CUBIC YARD	R	RADIUS
C&G	CURB AND GUTTER	R&R	REMOVE & REPLACE
D	DEPTH	RC	RELATIVE COMPACTION
DBL	DOUBLE	RCP	REINFORCED CONCRETE PIPE
DET	DETAIL DRAINAGE INLET OR DUCTILE IRON	RD BEE	ROAD
DI DIA OR Ø	DIAMETER	REF REQ'D	REFERENCE REQUIRED
DISS	DISSIPATOR	RLC	ROCK-LINED CHANNEL
DR	DRIVE	ROW	RIGHT-OF-WAY
D/W	DRIVEWAY	RSP	ROCK SLOPE PROTECTION
E	EAST	RT	RIGHT
EA EC	EACH END OF CURVE	RW S	RETAINING WALL SOUTH OR SANITARY SEWER
ECR	END OF CURB RETURN	sco	SEWER CLEAN OUT
ELEV	ELEVATION	SD	STORM DRAIN
ELEC	ELECTRIC	SDMH	STORM DRAIN MANHOLE
ENGR	ENGINEER	SED FB	SEDIMENT FOREBAY
EP	EDGE OF PAVEMENT	SEZ SF	STREAM ENVIRONMENT ZONE SOUARE FEET
ESA ESMT	ENVIRONMENTALLY SENSITIVE AREA EASEMENT	SHT	SQUARE FEET SHEET
EVCE	END VERTICAL CURVE ELEVATION	SL	SLOPE LENGTH
EVCS	END VERTICAL CURVE STATION	SMH	SEWER MANHOLE
EX OR EXIST	EXISTING	ST	SEDIMENT TRAP OR STREET
F	FIR	STA	STATION
FES FG	FLARED END SECTION	STD	STANDARD
FH	FINISHED GRADE FIRE HYDRANT	STL STPUD	STEEL SOUTH TAHOE PUBLIC UTILITY DISTRICT
FL	FLOWLINE	SWPPP	STORM WATER POLLUTION PREVENTION PLAN
FS	FINISH SURFACE	T	TELEPHONE
G	GAS	TBC	TOP BACK OF CURB
GA	GAUGE	TBD	TOP BACK OF DIKE
GB	GRADE BREAK	TD	TOP OF DIKE
GLS GW	GRASS—LINED SWALE GROUND WATER	TBR TG	TO BE REMOVED TOP OF GRATE
Н	HORIZONTAL	TTL	TOTAL
HDPE	HIGH DENSITY POLYETHYLENE	TRANS	TRANSITION
HP	HIGH POINT	TRM	TURF REINFORCEMENT MAT
HWL	HIGH WATER LINE	TRPA	TAHOE REGIONAL PLANNING AGENCY
ID IE	INSIDE DIAMETER	TYP	TYPICAL
IE INCR	INVERT ELEVATION INCREASE	UG UKN	UNDERGROUND UNKNOWN
INST	INSTALL	USFS	UNITED STATES FOREST SERVICE
INTRXN	INTERSECTION	V	VERTICAL
L	LENGTH	W	WEST OR WATER
LC	LENGTH OF CHORD	W/	WITH
LF LD	LINEAR FEET	W/O	WITHOUT
LP LT	LOW POINT LEFT	WC WV	WILLOW CLUSTER WATER VALVE
LTD	LAKE TAHOE DATUM	** *	THE PERSON AND THE PE

**ABBREVIATIONS** 

EX	ISTING	PRO	DPOSED
(SCREENED AND/OR DASHED)	EXISTING (AS NOTED)		CENTERLINE
	RIGHT-OF-WAY OR PROPERTY LINE		SAWCUT (AS NOTED)
	DRAINAGE OR SLOPE EASEMENT		AC PAVEMENT
	UTILITY (PUE) EASEMENT		AC REMOVAL
	LAND CAPABILITY BOUNDARY	xxxx.xx	ELEVATION
	10' SEZ SETBACK	XXXXXX XXXXXXX	ELEVATION, EG CL, PROPOSED (PROFILE ONLY)
OR 🔾	ROCK		CSP INLET/RISER OR STORM DRAIN
•	FOUND MONUMENT	ОП	MANHOLE, DRAINAGE INLET
Δ	SURVEY CONTROL POINT	VV	CUT OR FILL SLOPE
XXXX.X	ELEVATION	XX	DETAIL REF NUMBER SHEET NUMBER
	SEWER MANHOLE		ROCK
sco	SEWER CLEAN OUT		SD PIPE (MATERIAL AS NOTED)
	DRAINAGE INLET	−RSF −−− ESA−	REINFORCED SILT FENCE AND TYPE ESA FENCE
gm ■	GAS METER		
ŵv	WATER VALVE	D "."	FLARED END SECTION
wm	WATER METER	#:#	SLOPE RATIO, H: V
8	MONITORING WELL		ARTICULATED BLOCK CHANNEL
$ {\bf w} {\bf w} {\bf w} -$	WATER LINE		BLANKET-LINED CHANNEL
sss-	SEWER LINE	#	TREE REMOVAL
ggg-	GAS LINE	. —	FLOWLINE
	STORM DRAIN	— c — c — c —	CUT
	OVERHEAD UTILITIES	— f — f — f —	FILL
0	POWER/UTILITY POLE		
<i>β</i>	UTILITY POLE & GUY ANCHOR		
7	FIRE HYDRANT		
—— х ——	FENCE		
	FLOWLINE		

#### UTILITIES

GENERAL NOTES, ABBREVIATIONS, AND LEGEND

CABLE TELEVISION NATURAL GAS ELECTRIC SEWER & WATER TELEPHONE STORM DRAIN

CHARTER COMMUNICATIONS, (775) 233-8706 SOUTHWEST GAS, (530) 543-3225 LIBERTY UTILITIES, (530) 541-6400 SOUTH TAHOE PUD, (530) 544-6474 AT&T, (530) 888-2031 CO. OF EL DORADO DOT, (530) 573-3180

SAN BERNARDINO CLASS 1 BIKE TRAIL PROJECT

#### ii 2 or ? NTRACT NO. ???? 95117

#### **PRELIMINARY**







NOTE: THIS PROJECT IS LOCATED IN AN ENVIRONMENTALLY SENSITIVE AREA. YOU MUST EXERCISE UTMOST CARE TO PROTECT AND MAINTAIN EXISTING VEGETATION AND MINIMIZE SOIL COMPACTION WITHIN CONSTRUCTION AREAS. !! WARNING !! THE LOCATION AND/OR ELEVATION OF EXISTING THE LOCATION AND/OR ELEVATION OF EXISTING
UNDERGROUND UTILITIES SHOWN ON THESE
PLANS ARE ONLY APPROXIMATE. CONTRACTOR
TO VERIFY LOCATION AND ELEVATION OF ALL
EXISTING UNDERGROUND UTILITIES. BC = 10+79.45, FS 6312.70 −EC = 11+27.90, FS 6310.28 FS 6302.46 MATCH L -BC = 11+65.20, FS 6308.41 BC = 12+62.79, FS 6304.03 -EC = 11+93.20, FS 6307.01  $\frac{1}{D-1}$ PLAN & PROFILE HORIZ 1"= 20' VERT 1"= 5' 10+00 TO 14+00 6325 6325 6320 6320 6315 6315 -0.53% 6310 6310 6305 6305 MA 6300 6300 6295 6295 6290 12+50 10+50 11+00 11+50 12+00 13+00 13+50 14+00 **PRELIMINARY** PREPARED UNDER THE SUPERVISION OF : KIS KIS L-1 × of ? SAN BERNARDINO CLASS 1 BIKE TRAIL PROJECT COUNTY OF EL DORADO HECKED: LAYOUT STA 10+ 00 - 14+00 DSP 04/19 DEPARTMENT OF TRANSPORTATION CONTRACT NO.


REGISTERED CIVIL ENGINEER


OAD NUMBER:

<sup>No.</sup> 95117


APRIL 23, 2019

NOTE: THIS PROJECT IS LOCATED IN AN ENVIRONMENTALLY SENSITIVE AREA. YOU MUST EXERCISE UTMOST CARE TO PROTECT AND MAINTAIN EXISTING VEGETATION AND MINIMIZE SOIL COMPACTION WITHIN CONSTRUCTION AREAS. !! WARNING !! THE LOCATION AND/OR ELEVATION OF EXISTING UNDERGROUND UTILITIES SHOWN ON THESE
PLANS ARE ONLY APPROXIMATE. CONTRACTOR TO VERIFY LOCATION AND ELEVATION OF ALL EXISTING UNDERGROUND UTILITIES. BC = 14+89.46, FS 6299.67 FS 6299.62 MATCH LINES EC = 16+41.94,-FS 6298.15 ~18+00 EC = 17+44.62,-FS 6298.07 BC = 16+30.24,-FS 6298.26 BC = 17+41.00,-FS 6298.07 MATCH LINES SEE P-14+00  $\frac{1}{D-1}$ 16+50.00, END PATH, BGN BOARDWALK, FS 6298.07 PLAN & PROFILE SCALE: HORIZ 1"= 20' VERT 1"= 5' 14+00 TO 18+00 6315 6315 6310 6310 LINE~18+10 EE P-2 00 6305 6305 6300 6300 0.00% MATCH L MATCH 6295 6295 6290 6290 6285 6285 14+00 14+50 15+00 15+50 16+00 16+50 17+00 17+50 18+00 **PRELIMINARY** PREPARED UNDER THE SUPERVISION OF L-2 X OF ? KIS KIS SAN BERNARDINO CLASS 1 BIKE TRAIL PROJECT COUNTY OF EL DORADO HECKED: LAYOUT STA 14+00 - 18+00 DSP 04/19 CONTRACT NO. DEPARTMENT OF TRANSPORTATION APRIL 23, 2019 <sup>No.</sup> 95117

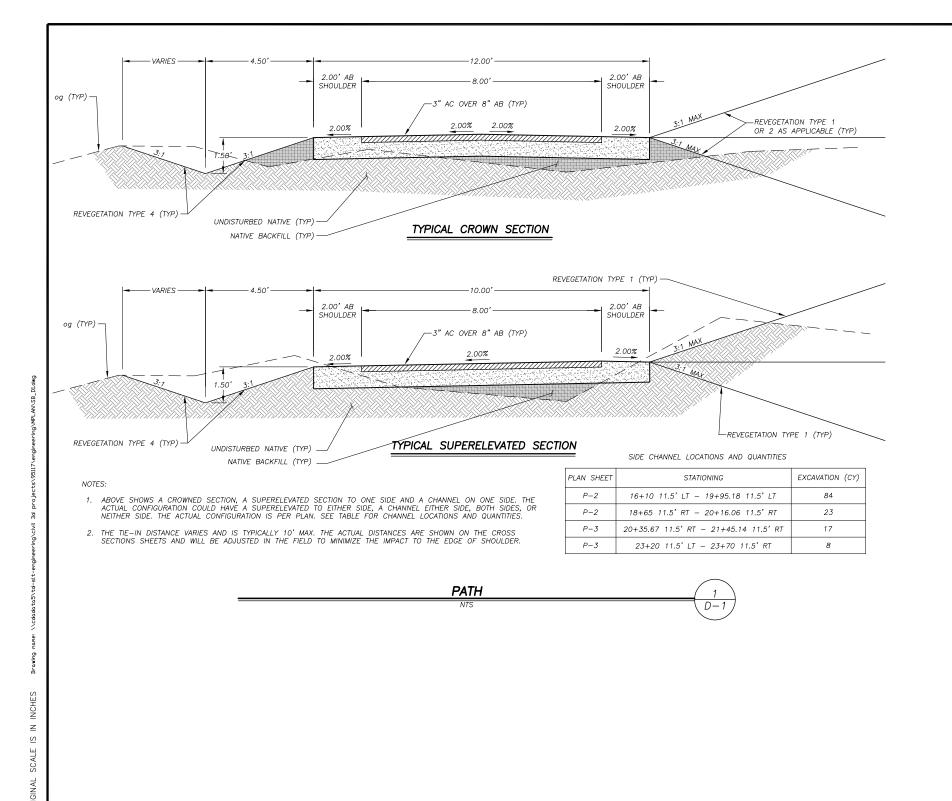

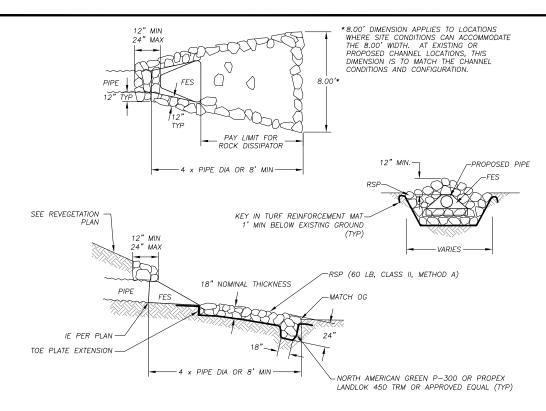

PLAN SHEET	STREET AND STATIONING	ROCK (CY)	EXCAVATION (CY)	AVERAGE LENGTH, L	AVERAGE WIDTH, W
P-2, P-12	19+95.18 11.5' LT	6	8	12'	8.5'
P-3, P-12	21+45.14 11.5' RT	4	5	12'	7.0'
P-3, P-12	23+70 11.5° LT	7	11	13'	9,

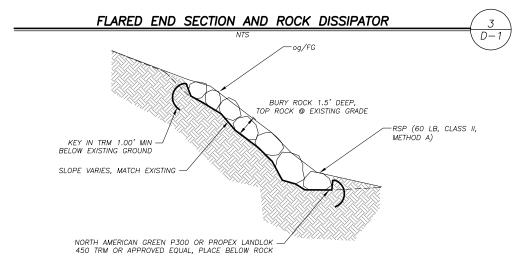

PLAN SHEET	STATIONING	ROCK/EXCAVATION (CY)
P-6	NEAR 35+25 LT	61
P-12	NEAR 21+73 LT	2

ROCK SLOPE PROTECTION

 $\frac{4}{D-1}$ 


SE VISION




**PRELIMINARY** 


COUNTY OF EL DORADO DEPARTMENT OF TRANSPORTATION SAN BERNARDINO CLASS 1 BIKE TRAIL PROJECT CONSTRUCTION DETAILS

C-1 X of ? CONTRACT NO. ???? CIP No. 95117

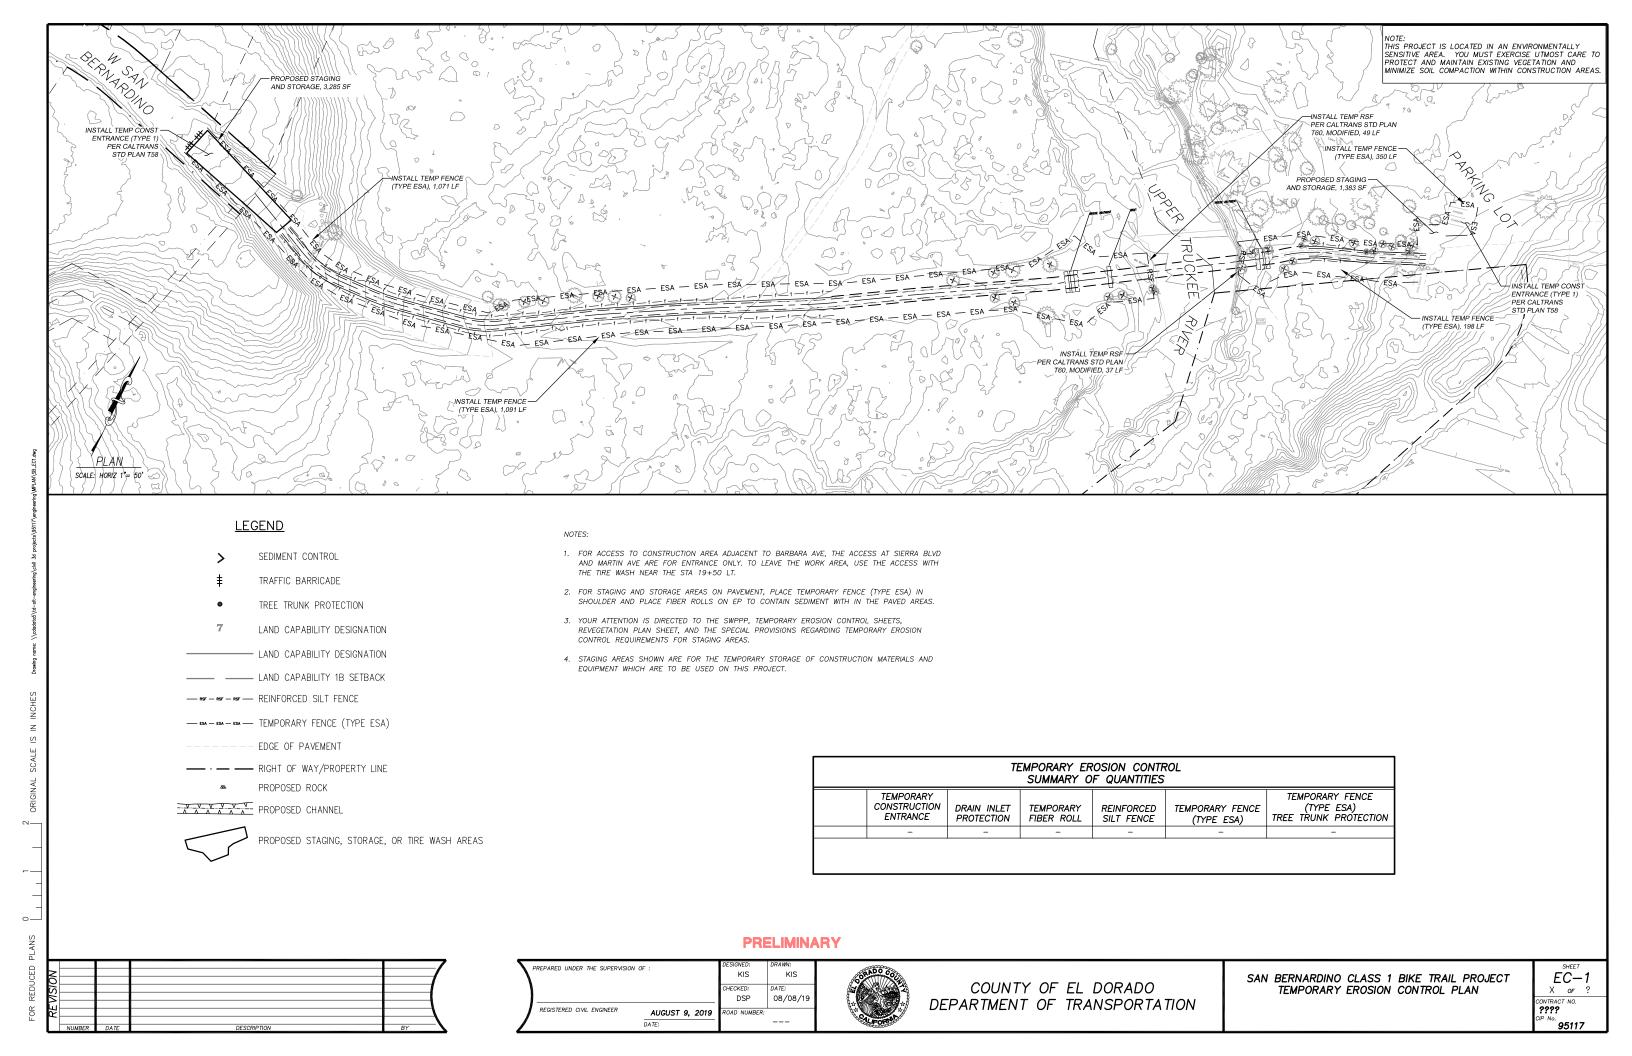

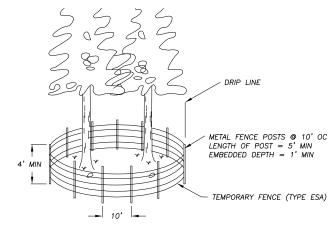

TEMPORARY FENCE (TYPE ESA) AT DRIPLINES

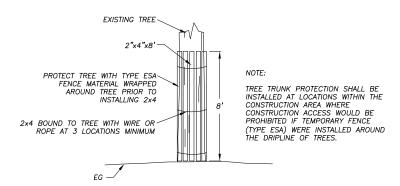


WOODEN TREE TRUNK PROTECTION

PIPE OUTLET (WHERE APPLICABLE) - PLACE PLASTIC SHEETING UNDER PIPE OUTLET OR AT TOE PLATE OF FES TO DIRECT FLOW ONTO PLASTIC AT SEAMS, OVERLAP UPSTREAM PLASTIC SHEETING A MINIMUM 3' OVER DOWNSTREAM PLASTIC SHEETING. PLACE GRAVEL BAGS OR GRAVEL-FILLED ROLLS THE 6 MIL PLASTIC SHEETING ENTIRE LENGTH OF OVERLAP - PLACE GRAVEL BAGS OR GRAVEL—FILLED ROLLS THE ENTIRE WIDTH OF PLASTIC SHEETING AT 30' INTERVALS

> PLASTIC SHEETING WITH GRAVEL BAGS OR GRAVEL-FILLED ROLLS

## VARIES APPLICABLE WEIGHTED FIBER ROLL OR GRAVEL-FILLED ROLL EXISTING AC, WHERE APPLICABLE EXCAVATION SECTION, WHERE APPLICABLE APPLICABLE WEIGHTED FIBER ROLL OR GRAVEL-FILLED ROLL EXISTING AC, WHERE APPLICABLE EXCAVATION SECTION, WHERE APPLICABLE

SPACING INTERVALS FOR WEIGHTED FIBER ROLL OR GRAVEL-FILLED ROLL TEMPORARY SEDIMENT CONTROL ON GRADE SHALL BE AT 50' OC FOR SLOPES GREATER THAN 5% AND AT 100' OC FOR SLOPES LESS THAN OR EQUAL TO 5%.

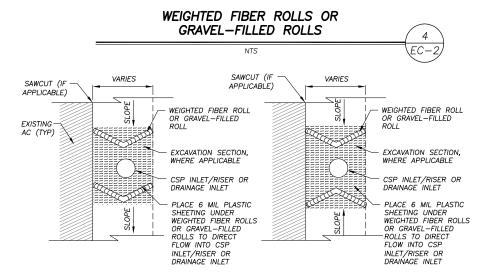

NOTE:

SEE ALSO TYPE 2 OR TYPE 3A, CALTRANS STD PLANS T61 AND T62.

DRAIN INLET PROTECTION NTS

#### GENERAL NOTES:

- 1. LOCATIONS AND LF OF TEMPORARY REINFORCED SILT FENCE REQUIRED FOR THE STAGING AREAS ARE NOT SHOWN. YOU ARE TO INCLUDE THESE AREAS IN YOUR TEMPORARY EROSION CONTROL PLAN
- 2. LENGTHS OF TEMPORARY REINFORCED SILT FENCE AND TEMPORARY FENCE (TYPE ESA) DOES NOT INCLUDE MINIMUM LIMITS FOR TREE PROTECTION. TREE PROTECTION FENCING IS TO BE AS SHOWN AND/OR AS DETERMINED IN THE FIELD.

NOT USED


#### **PRELIMINARY**

	REGISTERED CIVIL ENGINEER	AUCUST 0, 2010	KIS  CHECKED:  DSP  ROAD NUMBER:	KIS DATE: 08/08/19	
/		AUGUST 9, 2019  DATE:	NOAD NOWBEN.		ı



COUNTY OF EL DORADO DEPARTMENT OF TRANSPORTATION SAN BERNARDINO CLASS 1 BIKE TRAIL PROJECT TEMPORARY EROSION CONTROL DETAILS

X of ? NTRACT NO. ???? 95117

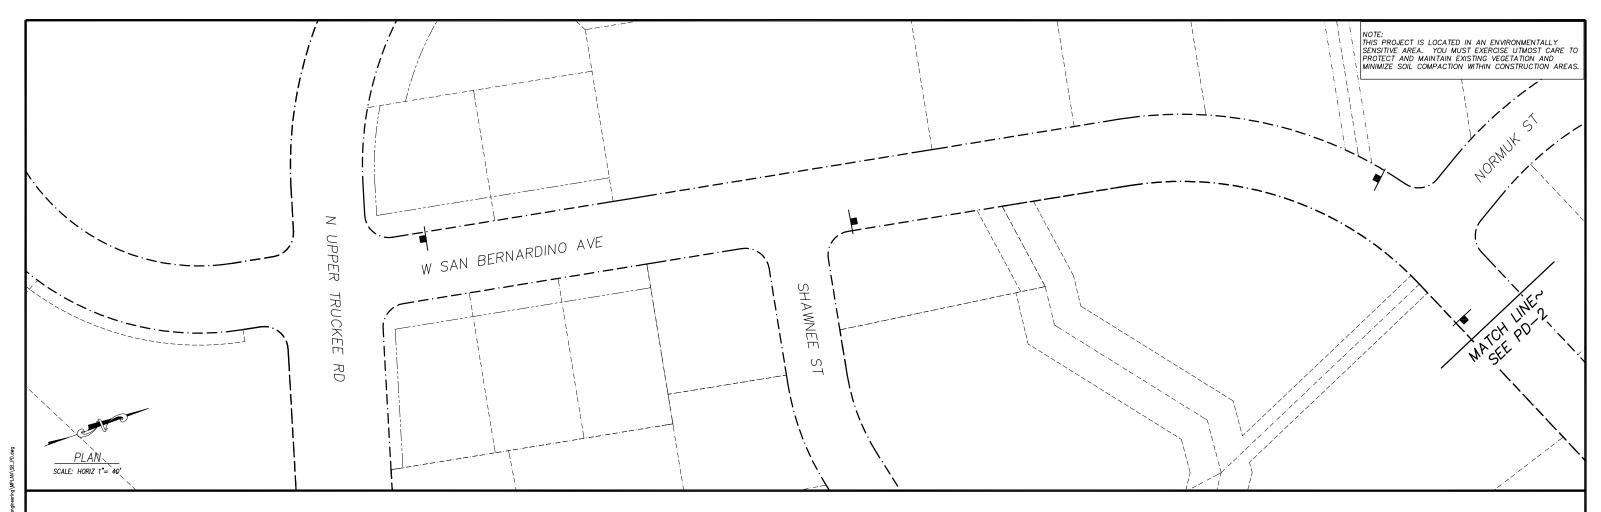

#### SIGNING LEGEND

- SIGN NUMBER, SEE TABLE DETAILS

- EXIST SIGN - INSTALL SIGN

- INSTALL DOUBLE SIDED SIGN

- REMOVE AND REPLACE

#### CONSTRUCTION NOTES:

— 4" SOLID YELLOW STRIPE PAINTED PER DIMENSIONS SHOWN

— 1' WIDE X 5' WHITE PAINTED LIMIT LINE PER CALTRANS RSP A24E

- "STOP" PAVEMENT MARKING (H=48", W=38") PER CALTRANS RSP A24D (12 SIZE) PLACE 5' & FROM LIMIT LINE

DASHED CENTERLINE STRIPING PER CAMUTCD FIG 9C-2

1) FINISH ON BACK OF SIGN: MIDNIGHT GREEN ENDURA SHIELD IV, TNEMEC SEMIGLOSS HIGH BUILD ACRYLIC POLYURETHANE ENAMEL NO. 75—J7751

2) ALL TRAFFIC CONTROL DEVICES SHALL BE IN ACCORDANCE WITH THE LATEST APPROVED CALIFORNIA MANUAL ON UNIFORM TRAFFIC CONTROL DEVICES (CA MUTCD).

3) ASTM DESIGNATION APPLIES TO ALL COLORS ON SIGN OR RAIL. BLACK SHALL BE NON-REFLECTIVE.

ROADWAY AND BIKE PATH SIGNS						
SIGN DESIGNATION	SIGN MESSAGE AND DESCRIPTION	SIGN SIZE	QTY	SIGN COLORS	RETROREFLECTIVE ASTM TYPE	
D11-1	"BIKE ROUTE" SIGN	24"x18"	_	WHITE ON GREEN	III	
M4-11	"BEGIN" SIGN	12"x4"	_	WHITE ON GREEN	III	
M4-12	"END" SIGN	12"x4"	_	WHITE ON GREEN	III	
R1-1	"STOP" SIGN	18"x18"	_	WHITE ON RED	III	
R1-5	"YIELD TO PEDESTRIAN" SIGN	36"x36"	-	RED/BLACK ON WHITE	III	
R44A (CA)	"NO MOTOR VEHICLES" SIGN	12"x24"	_	BLACK ON WHITE	III	
W7-5	"HILL" (BICYCLE) SIGN	18"×18"	_	BLACK ON YELLOW	111	
W3-1	"STOP AHEAD" SYMBOL	18"x18"	_	RED/BLACK ON YELLOW	111	
W11-15	BICYCLE/PEDESTRIAN WARNING	36"x36"	_	BLACK ON YELLOW	III	
W16-7P	DIAGONAL DOWNWARD RIGHT ARROW	24"x12"	_	BLACK ON YELLOW	III	
W16-7P	DIAGONAL DOWNWARD LEFT ARROW	24"x12"	_	BLACK ON YELLOW	III	
W16-9P	"AHEAD" SIGN	24"x12"	_	BLACK ON YELLOW	III	

PAVEMENT STRIPING					
TYPE SHEET		SPRAYABLE PAINT			
		YELLOW			
		FT			
SOLID YELLOW STRIPING	PD-1	-			
	PD-2	-			
	PD-3	-			
BROKEN YELLOW	PD-1	_			
CENTERLINE STRIPING	PD-2	_			
	PD-3	_			
	TOTAL	-			

PAVEMENT MARKINGS						
SYMBOL DESCRIPTION	QUANTITY (EA)	AREA (SF)	TOTAL AREA (SF)			
CROSSWALK	_	-	-			
LIMIT LINE	_	-	-			
YIELD LINE	-	-	-			
STOP	-	-	-			
TOTAL			_			

### **PRELIMINARY**

APPROVED FOR PAVEMENT DELINEATION AND SIGN WORK ONLY

_					
г					7
⋈					
O					/
S					1
ĸ				1	i
					4
6					1
Г					_\
	NUMBER	DATE	DESCRIPTION	BY	

	PREPARED UNDER THE SUPERVISION OF	F:	DESIGNED: KIS	DRAWN: KIS
			CHECKED: DSP	DATE: 08/08/19
_	REGISTERED CIVIL ENGINEER	AUGUST 9, 2019  DATE:	ROAD NUMBER:	



COUNTY OF EL DORADO DEPARTMENT OF TRANSPORTATION SAN BERNARDINO CLASS 1 BIKE TRAIL PROJECT SIGNING AND PAVEMENT DELINEATION

X of ? CONTRACT NO.

