

ABBREVIATIONS

| | | | |
|-----------|-----------------------------|---------|---------------------------|
| AB | ANCHOR BOLT | INFO | INFORMATION |
| AC | AIR CONDITIONER | INSUL | INSULATION |
| ADJ | ADJACENT | INT | INTERIOR |
| AFF | ABOVE FINISH FLOOR | INV | INVERT |
| AL | ALUMINUM | JAN | JANITOR |
| APPROX. | APPROXIMATELY | KIT | KITCHEN |
| ASPH | ASPHALT | LAM | LAMINATED |
| AVG | AVERAGE | LAV | LAVATORY |
| BD | BOARD | LB/# | POUND |
| BLDG | BUILDING | L.F./LF | LINEAR FLOOT |
| BLK/BLKG | BLOCK/BLOCKING | LS | LAG SCREW |
| BM | BEAM | MAX | MAXIMUM |
| BN | BULLNOSE | MB | MACHINE BOLT |
| BOT | BOTTOM | MECH | MECHANICAL |
| C.F. | CUBIC FOOT | MFR | MANUFACTURER |
| C.I. | CUBIC INCH | MIN | MINIMUM |
| CI | CAST IRON | MISC | MISCELLANEOUS |
| CJ | CEILING JOIST/CONTROL JOINT | MTL | METAL |
| CL | CENTER LINE | (N) | NEW |
| CLR | CLEAR/CLEARANCE | N.G./NG | NATURAL GRADE |
| CLG | CEILING | NO. / # | NUMBER |
| CLKG | CAULKING | NTS | NOT TO SCALE |
| CMU | CONCRETE MASONRY UNIT | O/ | OVER |
| CO | CLEANOUT | OBS | OBSCURE |
| COL | COLUMN | O.C./OC | ON CENTER |
| CONC | CONCRETE | OPCI | OWNER PROVIDED, |
| CONN | CONNECTION | | CONTRACTOR INSTALLED |
| CONST | CONSTRUCTION | OPQI | OWNER PROVIDED, |
| CONT | CONTINUOUS | | OWNER INSTALLED |
| CTR | CENTER | OS | OCCUPANCY SENSOR |
| CW | COLD WATER | OZ | OUNCE |
| C.Y. | CUBIC YARD | PERF | PERFORATED |
| DBL | DOUBLE | PERP | PERPENDICULAR |
| DEG | DEGREE | PH | PHONE |
| DEPT | DEPARTMENT | PL | PLATE/ PROPERTY LINE |
| DET | DETAIL | PLYWD | PLYWOOD |
| DF | DOUGLAS FIR | PR | PAIR |
| DIA | DIAMETER | PREFAB | PRE-FABRICATED |
| DIM | DIMENSION | P.S.F. | POUNDS PER SQUARE FOOT |
| DN | DOWN | P.S.I. | POUNDS PER SQUARE INCH |
| DS | DOWNSPOUT | PTDF | PRESSURE TREATED DOUG FIR |
| DW | DISHWASHER | PVMT | PAVEMENT |
| EA | EACH | R | RISER |
| EJ | EXPANSION JOINT | RD | ROOF DRAIN |
| ELEC | ELECTRICAL | REF | REFRIGERATOR |
| ELEV | ELEVATION/ELEVATOR | REQ | REQUIRED |
| ENCL | ENCLOSURE | RM | ROOM |
| EOS | EDGE OF SLAB | RO | ROUGH OPENING |
| EQ | EQUAL | RØW | RIGHT OF WAY |
| EQUIP | EQUIPMENT | RTS | REFER TO STRUCTURAL |
| EST | ESTIMATE | RWD | REDWOOD |
| EXIST/(E) | EXISTING | S4S | SURFACED 4 SIDES |
| EXT | EXTERIOR | SC | SOLID CORE |
| FAU | FORCED AIR UNIT | SD | SMOKE DETECTOR |
| FH | FIRE HYDRANT | S.F./SF | SQUARE FOOT |
| F.O.C. | FACE OF CURB | SHT | SHEET |
| F.O.F. | FACE OF FINISH | SHTG | SHEATHING |
| F.O.S. | FACE OF STUD | SIM | SIMILAR |
| FD | FLOOR DRAIN | SPEC | SPECIFICATION |
| FDN | FOUNDATION | SST | STAINLESS STEEL |
| FE | FIRE EXTINGUISHER | STD | STANDARD |
| FF | FINISH FLOOR | SYM | SYMBOL |
| F.G./FG | FINISH GRADE | STL | STEEL |
| FIN | FINISH | T&G | TONGUE AND GROOVE |
| FIX | FIXTURE | T | REA |
| FLR | FLOOR | THK | THICK(NESS) |
| FOS | FACE OF STUD | TEL | TELEPHONE |
| FP | FIREPLACE / FLOOR PLAN | TEMP | TEMPERATURE |
| F.S./FS | FINISH SURFACE | T.O.C. | TOP OF CURB |
| FT | FOOT | T.O.F. | TOP OF FOOTING |
| FTG | FOOTING | T.O.W. | TOP OF WALL |
| G | GAS | T.O.S. | TOP OF SLAB |
| GA | GAUGE | TV | TELEVISION |
| GALV | GALVANIZED | TYP. | TYPICAL |
| GD | GARBAGE DISPOSAL | UNO | UNLESS NOTED OTHERWISE |
| GL | GLASS | VCT | VINYL COMPOSITION TILE |
| GYP | GYPSPUM | VERT | VERTICAL |
| HB | HOSE BIBB | V.I.F. | VERIFY IN FIELD |
| HC | HOLLOW CORE | W/ | WITH |
| HDR | HEADER | W/O | WITHOUT |
| HORIZ | HORIZONTAL | WC | WATER CLOSET |
| HRDW | HARDWARE | WD | WOOD |
| HT | HEIGHT | WH | WATER HEATER |
| HW | HOT WATER | W.I.C. | WALK IN CLOSET |
| IN | INCH | WT | WEIGHT |
| INCL | INCLUDE | YD | YARD |

CALIFORNIA CODE REFERENCES

THIS PROJECT SHALL COMPLY WITH CURRENT APPLICABLE CODES & ORDINANCES

- 2016 CALIFORNIA BUILDING STANDARDS ADMINISTRATIVE CODE
- 2016 CALIFORNIA BUILDING CODE
- 2016 CALIFORNIA RESIDENTIAL BUILDING CODE
- 2016 CALIFORNIA ELECTRICAL CODE
- 2016 CALIFORNIA MECHANICAL CODE
- 2016 CALIFORNIA PLUMBING CODE
- 2016 CALIFORNIA ENERGY CODE
- 2016 CALIFORNIA HISTORICAL BUILDING CODE
- 2016 CALIFORNIA FIRE CODE
- 2016 CALIFORNIA EXISTING BUILDING CODE
- 2016 CALIFORNIA GREEN BUILDING STANDARDS CODE
- 2016 CALIFORNIA REFERENCE STANDARDS CODE

SAN LUIS OBISPO COUNTY CODE: TITLE 19 BUILDING AND CONSTRUCTION ORDINANCE
SAN LUIS OBISPO COUNTY CODE: TITLE 22 LAND USE ORDINANCE
SAN LUIS OBISPO COUNTY CODE: TITLE 23 COASTAL ZONE LAND USE ORDINANCE

MT. LOWE CANNABIS CULTIVATION

3033 MT. LOWE RD, SAN LUIS OBISPO, CA, 93401

PROJECT DESCRIPTION

Levi Seligman is the founder of Green Gold Organic Farms and has been organically farming in SLO county for the last 4 years. Green Gold specializes in growing sweet mini-peppers and strawberries on a small organic farm in Arroyo Grande. Also in their crop plan is avocados, artichokes, asparagus and misc. other seasonal row crops. Almost all of the crops are sold to local restaurants and local markets including Whole Foods and Slo Natural Foods Co-op. Green Gold Organic Collective also grew cannabis on the small organic property. The collective was working to provide high CBD strains for medicinal use, as most other cannabis growers geared more towards high THC strains. After receiving the SLO county registration under the ordinance No. 3334, Green Gold Organic Collective is no longer able to grow cannabis as part of their crop plan on the organic farm in Arroyo Grande. The new regulations forced Green Gold to find a suitable property with proper zoning and set back restrictions. The new property and project description is below:

Project description:
-Relocate Green Gold Organic Collective Registration ordinance No. 3334 from Arroyo Grande to Mt-Lowe Rd in SLO.
-Project size: approximately 0.5 acres of grow area

-All products to be sourced for there medicinal value and will be grown under the same standards required by CCOF (California Certified Organic Farmers) and with the same care and quality Levi brought to his organic farm in AG. The farm will specialize in high CBD strain cannabis plants.

-The farm will have a combination of hoop houses and out door crops.

Odor Control:
The location is very remote. The odor will not be a factor as the smell will not permeate past the property lines. Other than picking and trimming, no processing will occur on site that will generate additional odors.

Security Plan:
The property is located off highway 101. There is a locked gate at the entrance of Mt. Lowe Rd and an additional locked gate at main entrance to the property. This locked gate will be fitted with security cameras. Additional cameras will be located throughout the site and throughout the fenced grow areas. 24-7 security personnel will be provided. Each grow site will have a 6' wooden fence with locked gate and security cameras. See C1.0 for secure gate and camera locations.

Neighborhood Compatibility Statement: The project is situated very remotely through 2 access controlled gates in an agriculture zone. The proposed use of the site is consistent with it's zoning designation, is not visible from the shared driveway, generates minimal vehicle trips, does not require increased lighting, and does not generate excess noise. Therefore, the proposed use of this site will have negligible effect on it's surrounding context.

Water storage:
Four(4) 5,000 gallon polyurethane storage tanks

Product drying:
-Easy up canopies will be used to cure and dry the crop and will then be stored away till the next season.

Trimming:
-The Easy Up canopies used for drying will also be used for the Trimmers

Waste:
-Four wood composting bins will be created. Each bin will be 10'w x 12'L x 6'h. There will be 6 to 8 hundred pounds of compost generated per year. The compost will be spread back on the crops. All other waste (garbage) will continue to be hauled off site. No significant increase in other waste is expected.

Goal: To provide high CBD cannabis in an organic fashion without disturbing the existing ecosystem.

PROJECT DATA

PROJECT INFORMATION

THE SUBJECT CONSISTS OF TWO PARCELS, WITH SIX ACCESSOR PARCEL NUMBER WITH MINIMAL IMPROVEMENTS. PARCEL 1 HAS 94.87 ACRES AND INCLUDES APNVS 070-241-014/035/037. PARCEL 2 HAS APPROXIMATELY 86.86 ACRES AND INCLUDES APNVS 070-241-036/038/039.

| | |
|-----------------|--|
| PROJECT ADDRESS | 3033 MT. LOWE ROAD, SAN LUIS OBISPO, CA, 93401 |
| APN | 070-241-014/035/037 070-241-036/038/039 AGRICULTURAL |
| ZONING | PARCEL 1: 54.87 ACRES PARCEL 2: 86.86 ACRES |
| CURRENT USE | |
| LOT SIZE | |

AGENCIES & UTILITIES

| | | | |
|---|--|-----|----------------|
| COUNTY OF SAN LUIS OBISPO - PLANNING & BUILDING DIVISION 976 OSOS STREET, ROOM 200 SAN LUIS OBISPO, CA 93401 | | PH: | 805.781.5600 |
| COUNTY OF SAN LUIS OBISPO - CDF / COUNTY FIRE 635 N. SANTA ROSA STREET SAN LUIS OBISPO, CA 93405 | | PH: | 805.543.4244 |
| COUNTY OF SAN LUIS OBISPO - PUBLIC WORKS 976 OSOS STREET SAN LUIS OBISPO, CA 93401 | | PH: | 805.781.5011 |
| PG & E 406 HIGUERA STREET SAN LUIS OBISPO, CA 93401 | | PH: | 1.800.743.5000 |
| SOUTHERN CALIFORNIA GAS COMPANY 1314 BROAD STREET SAN LUIS OBISPO, CA 93401 | | PH: | 1.800.427.2200 |

SHEET INDEX


| TITLE / CODE | TITLE SHEET |
|----------------------|-----------------------------|
| T1.0 | |
| ARCHITECTURAL | |
| C1.0 | OVERALL SITE PLAN |
| C2.0 | PRELIMINARY GRADING CONCEPT |
| C3.0 | DETAILS |

PROJECT DIRECTORY

| | | |
|---|--|--------------------------|
| OWNER: MARK WOOLPERT TRUST ET AL | CONTACT: PH: 905.701.5217 EMAIL: mitchcw@gmail.com | MITCHELL WOOLPERT |
| APPLICANT: LEVI SELIGMAN 1405 GARDEN STREET SAN LUIS OBISPO, CA 93401 | CONTACT: PH: 760.402.0555 EMAIL: levi@acquireslo.com | LEVI SELIGMAN |
| AGENT: TEN OVER STUDIO, INC. 539 MARSH STREET SAN LUIS OBISPO, CA 93401 | CONTACT: PH: 805.541.1010 EMAIL: joels@tenoverstudio.com | JOEL SNYDER |
| CIVIL ENGINEERING: WALLACE GROUP 612 CLARION CT SAN LUIS OBISPO, CA 93401 | CONTACT: PH: 805.544.4011 EMAIL: shannonj@wallacegroup.us | SHANNON JESSICA |
| SURVEY: MBS LAND SURVEYS 3559 SOUTH HIGUERA ST SAN LUIS OBISPO, CA 93401 | CONTACT: PH: 805.594.1960 EMAIL: mike@mbslandsurveys.com | MICHAEL B STANTON |
| BIOLOGIST: ECOLOGICAL ASSETS MANAGEMENT LLC PO BOX 6840 LOS OSOS, CA 93412 | CONTACT: PH: 805.440.6137 EMAIL: dwayne@ecologicalmgmt.com | DWAYNE OBERHOFF |
| ARCHEOLOGIST: CENTRAL COAST ARCHEOLOGICAL RESOURCE CONSULTANTS 491 LAWRENCE DRIVE SAN LUIS OBISPO, CA 93401 | CONTACT: PH: 805.545.9428 EMAIL: tjoslin@ccarcheology.com | TERRY L. JOSLIN PhD, RPA |
| TRAFFIC ENGINEER: CENTRAL COAST TRANSPORTATION CONSULTING 895 NAPA AVE, SUITE A-6 MORRO BAY, CA 93442 | CONTACT: PH: 805.316.0101 EMAIL: joe@cctransconsulting.com | JOE FERNANDEZ |

TREE REMOVAL

NO TREES ARE PROPOSED TO BE REMOVED

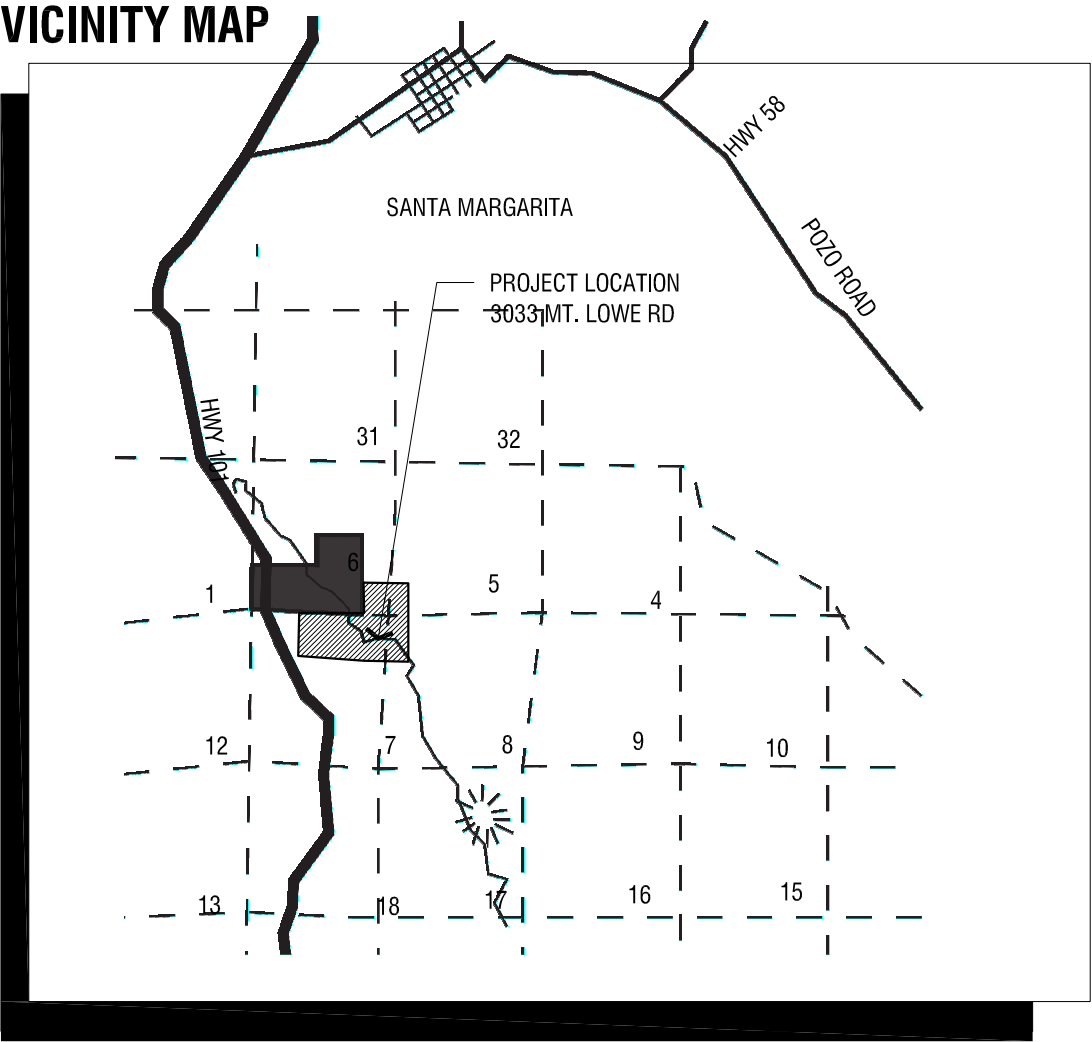


DRAWING SYMBOLS

| | | | |
|---------------------------|---------------------------|--------------------------------|---|
| | KEYNOTE | | |
| | DOOR NUMBER | | |
| | WINDOW NUMBER | | |
| | EQUIPMENT NUMBER | | |
| MASTER BEDROOM | ROOM TAG | | |
| | DETAIL REFERENCE: | | DETAIL NUMBER SHEET NUMBER |
| | DETAIL TARGET | | |
| | INTERIOR ELEVATION MARKER | ELEV NUMBER SHEET NUMBER | & DIRECTION OF VIEW |
| | ELEVATION MARKER | ELEV NUMBER SHEET NUMBER | & DIRECTION OF VIEW |
| | SECTION MARKER | SECTION NUMBER SHEET NUMBER | & DIRECTION OF VIEW |
| | ROOF / GROUND SLOPE: | | INDICATES SLOPE AND DIRECTION OF SLOPE |
| | HEIGHT / ELEVATION MARKER | | |
| | NORTH ARROW | | |
| | REVISION MARKER | | |

TEN OVER STUDIO, INC

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San Luis Obispo, CA
805.541.1010
info@tenoverstudio.com
www.tenoverstudio.com

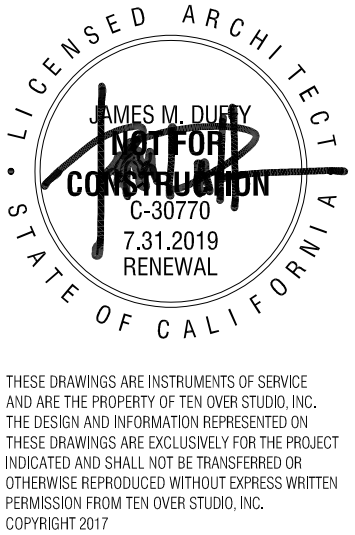

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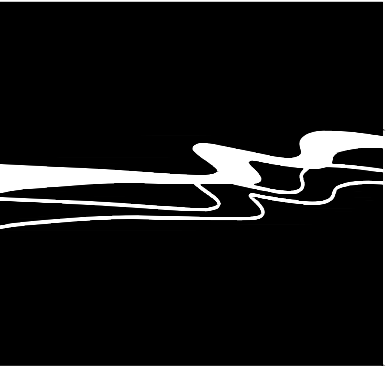
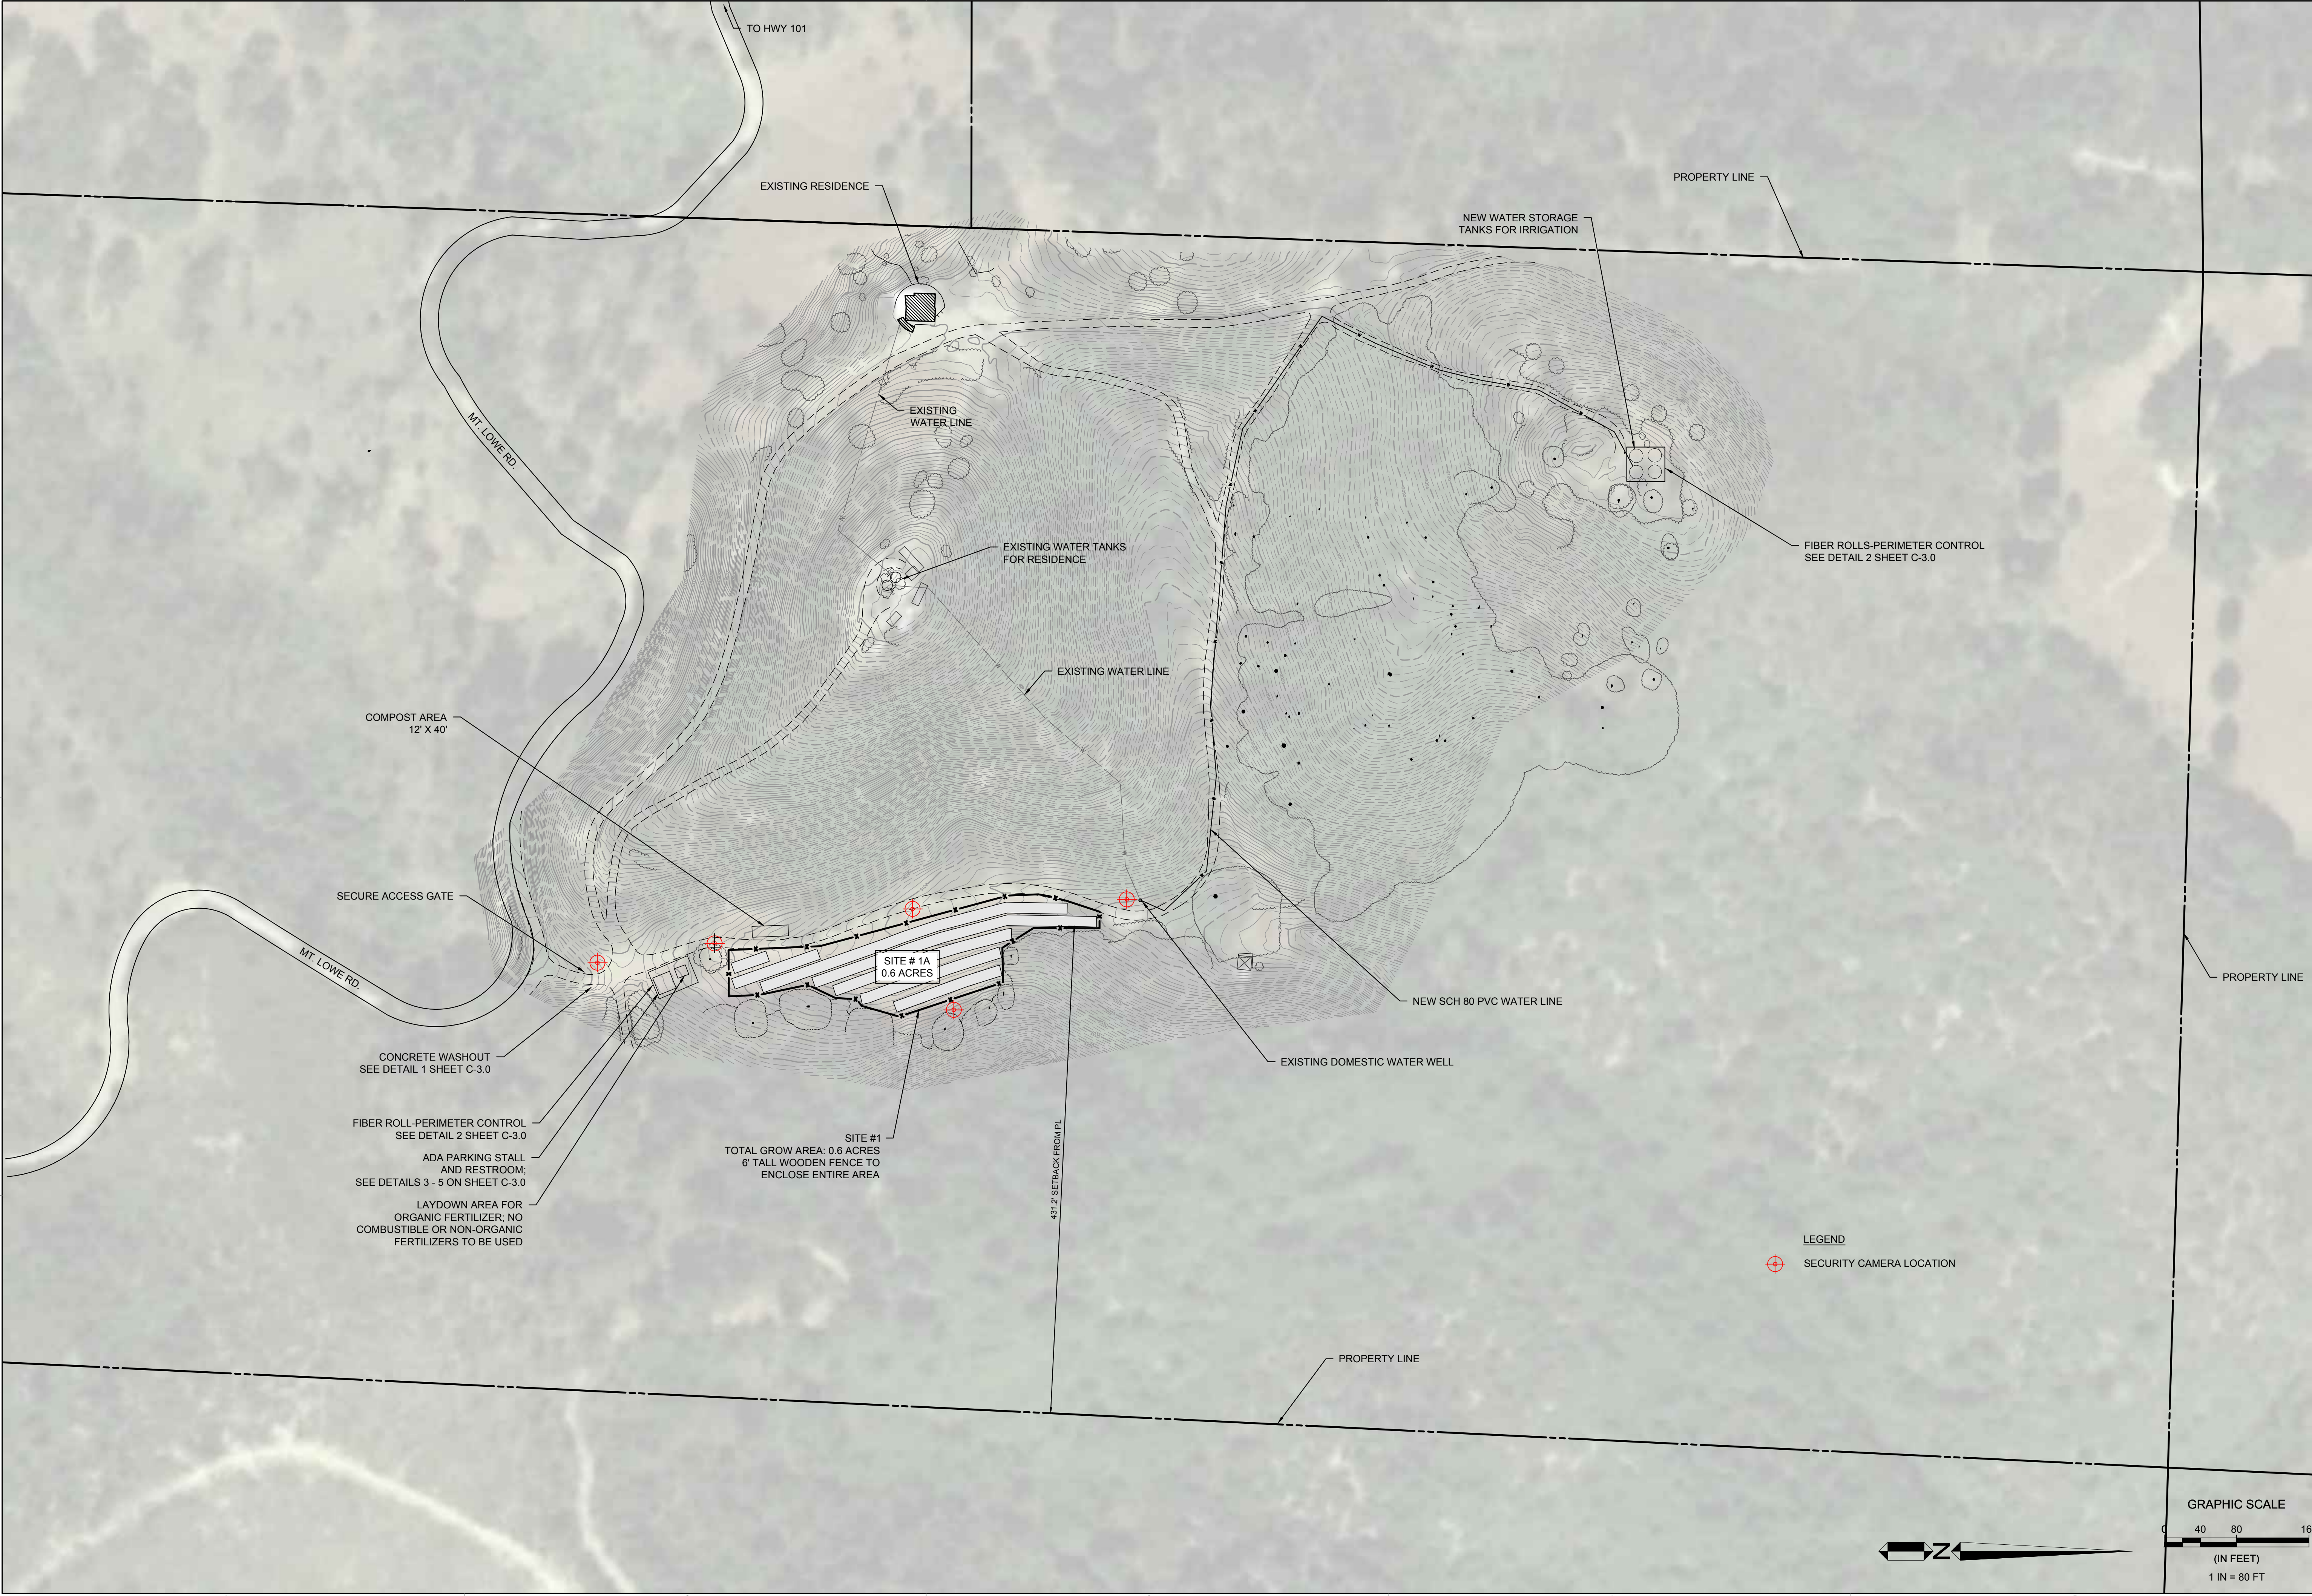
MT. LOWE ROAD
CANNABIS CULTIVATION
3033 MT. LOWE ROAD

| | |
|-----------|--------------------|
| DRWN BY: | XXX |
| CHK'D BY: | XXX |
| DATE | SUBMITTAL |
| 03/22/18 | LAND USE SUBMITTAL |
| 11/02/18 | RESUBMITTAL |
| 03/08/19 | RESUBMITTAL |
| | |
| | |
| | |
| | |

TITLE SHEET

T1.0

NOT FOR CONSTRUCTION



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WATER RESOURCES

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SIGNATURE

DATE SIGNED

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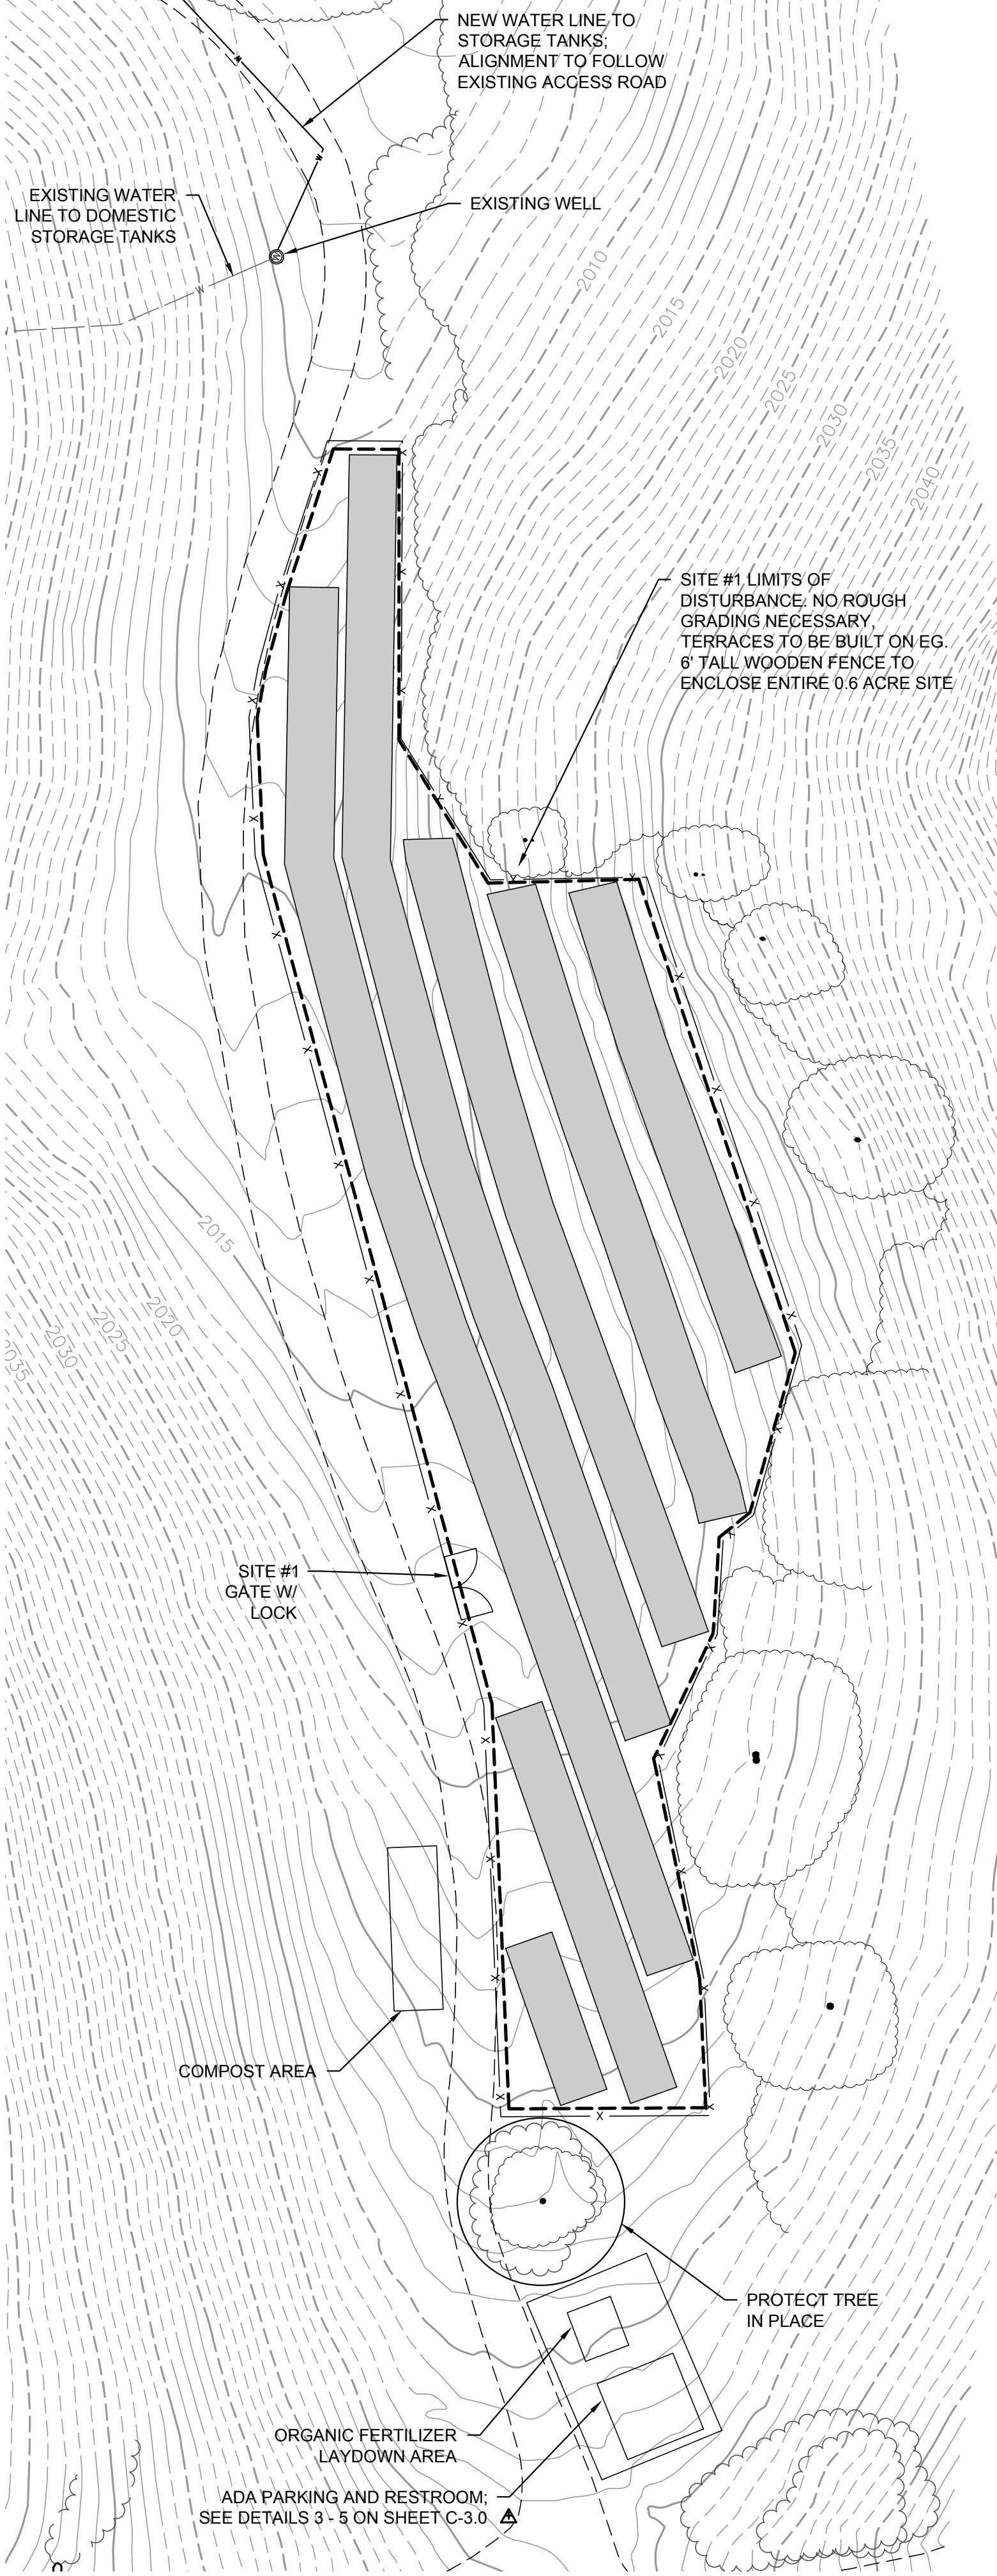
**GREEN GOLD ORGANIC COLLECTIVE
MT. LOWE CANNABIS CULTIVATION
OVERALL SITE PLAN**

JOB #: 1441
DESIGNERS: SJ
DRAWN BY: SJ
DATE: 3-2-19

DRAWING NO.

C-1.0

1 OF 3 SHEETS





GRADING QUANTITIES:

CUT (CY): <25 CY
FILL (CY): <25 CY
BALANCED

TOTAL GROW AREA
SITE # 1: 0.6 ACRES


AREA OF DISTURBANCE*: 0.02 ACRES

*AREA OF DISTURBANCE FOR CONSTRUCTION IS LIMITED TO THE NEW WATERLINE ALONG EXISTING ACCESS ROAD, PAD PREPARATION FOR THE FOUR 5,000 GALLON WATER STORAGE TANKS, AND MINOR GRADING FOR ADA PARKING STALL.

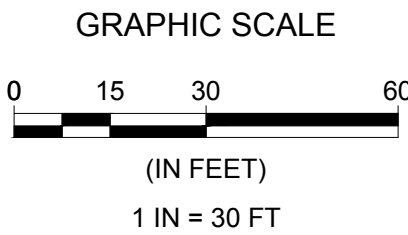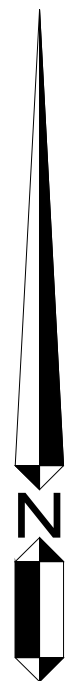

SITE #1

1:30

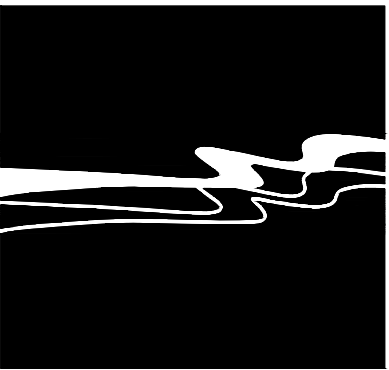

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DATE SIGNED

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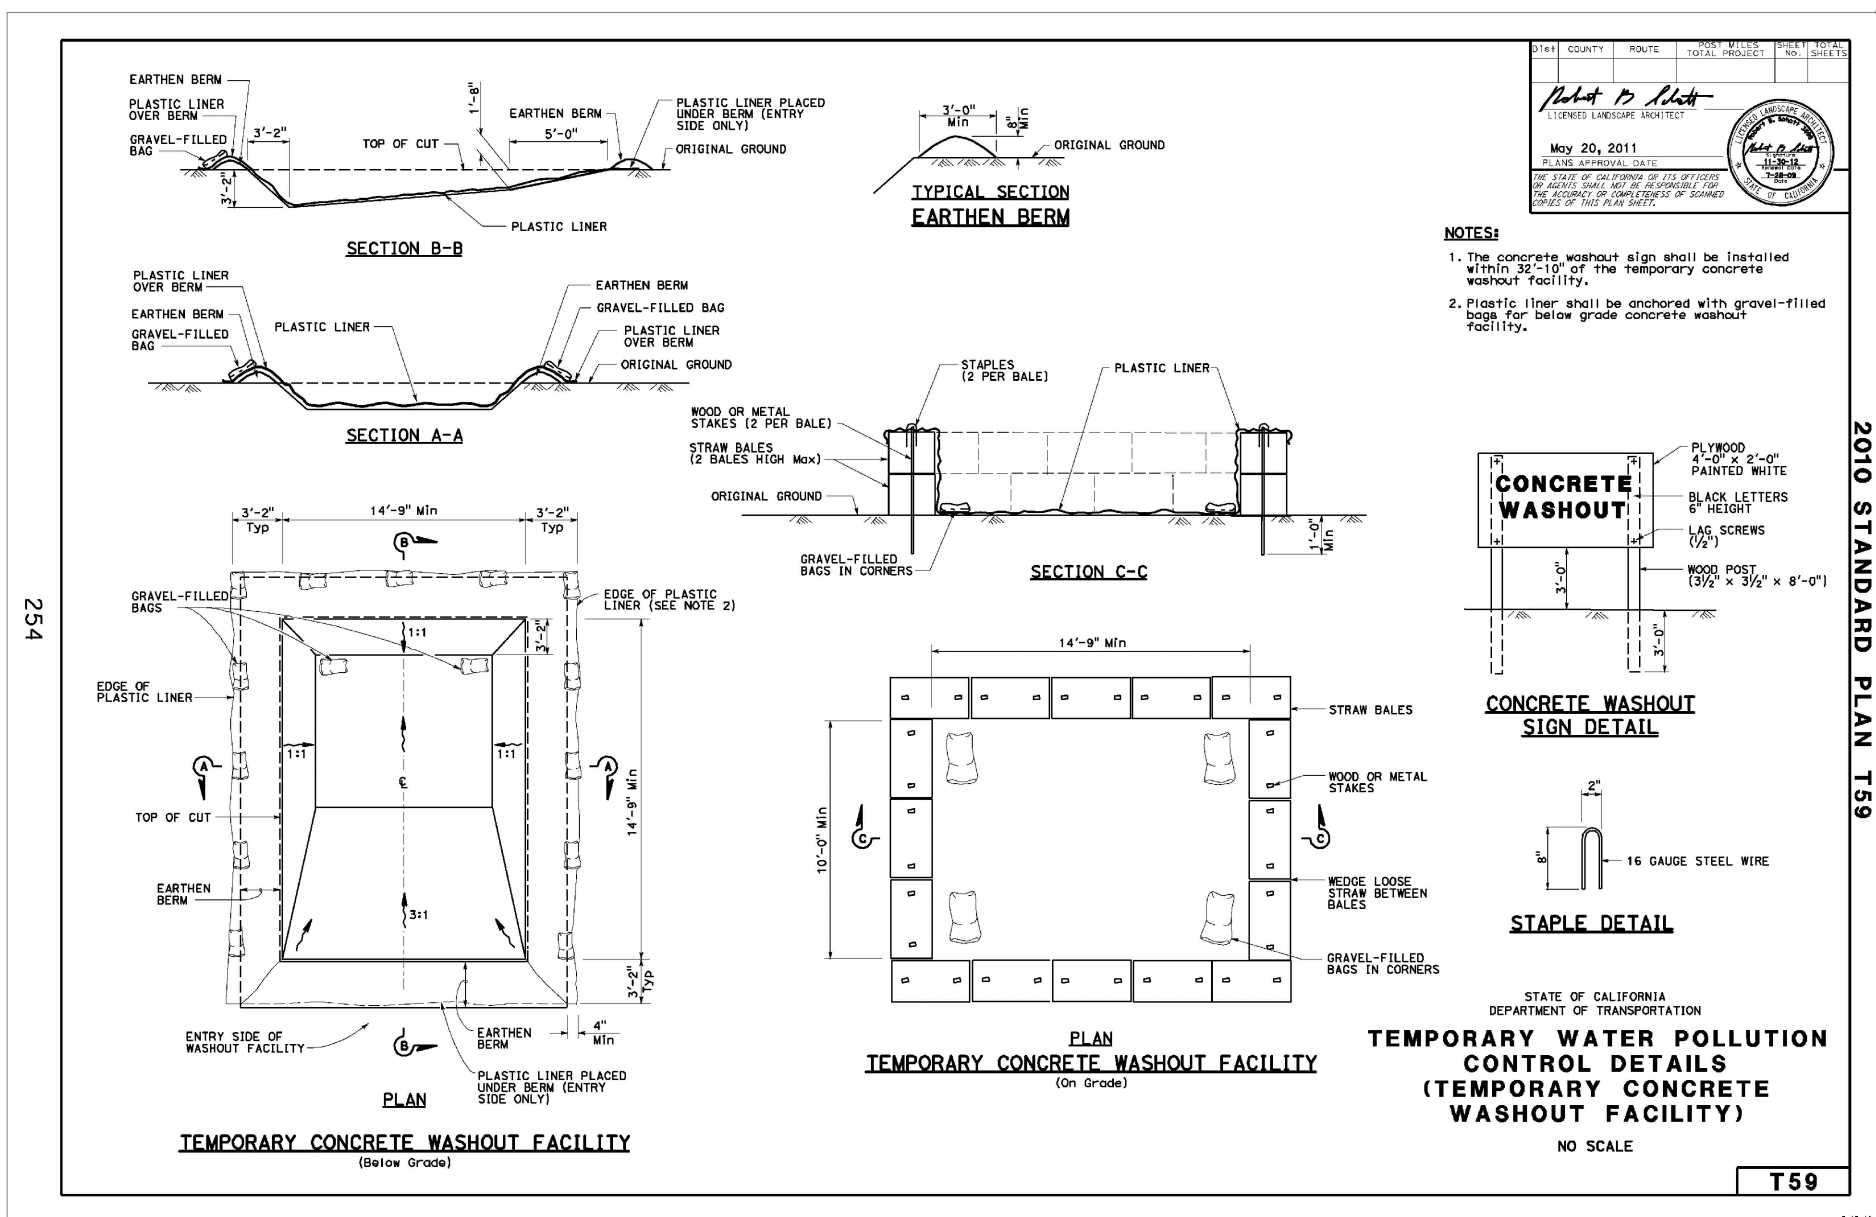
GREEN GOLD ORGANIC COLLECTIVE
MT. LOWE CANNABIS CULTIVATION
PRELIMINARY GRADING PLAN

JOB #: 1441-0001
DESIGNERS: SJ
DRAWN BY: CD
DATE: 10-31-2018


DRAWING NO.

C-2.0

2 OF 3 SHEETS



1 CONCRETE WASHOUT FACILITY DETAIL

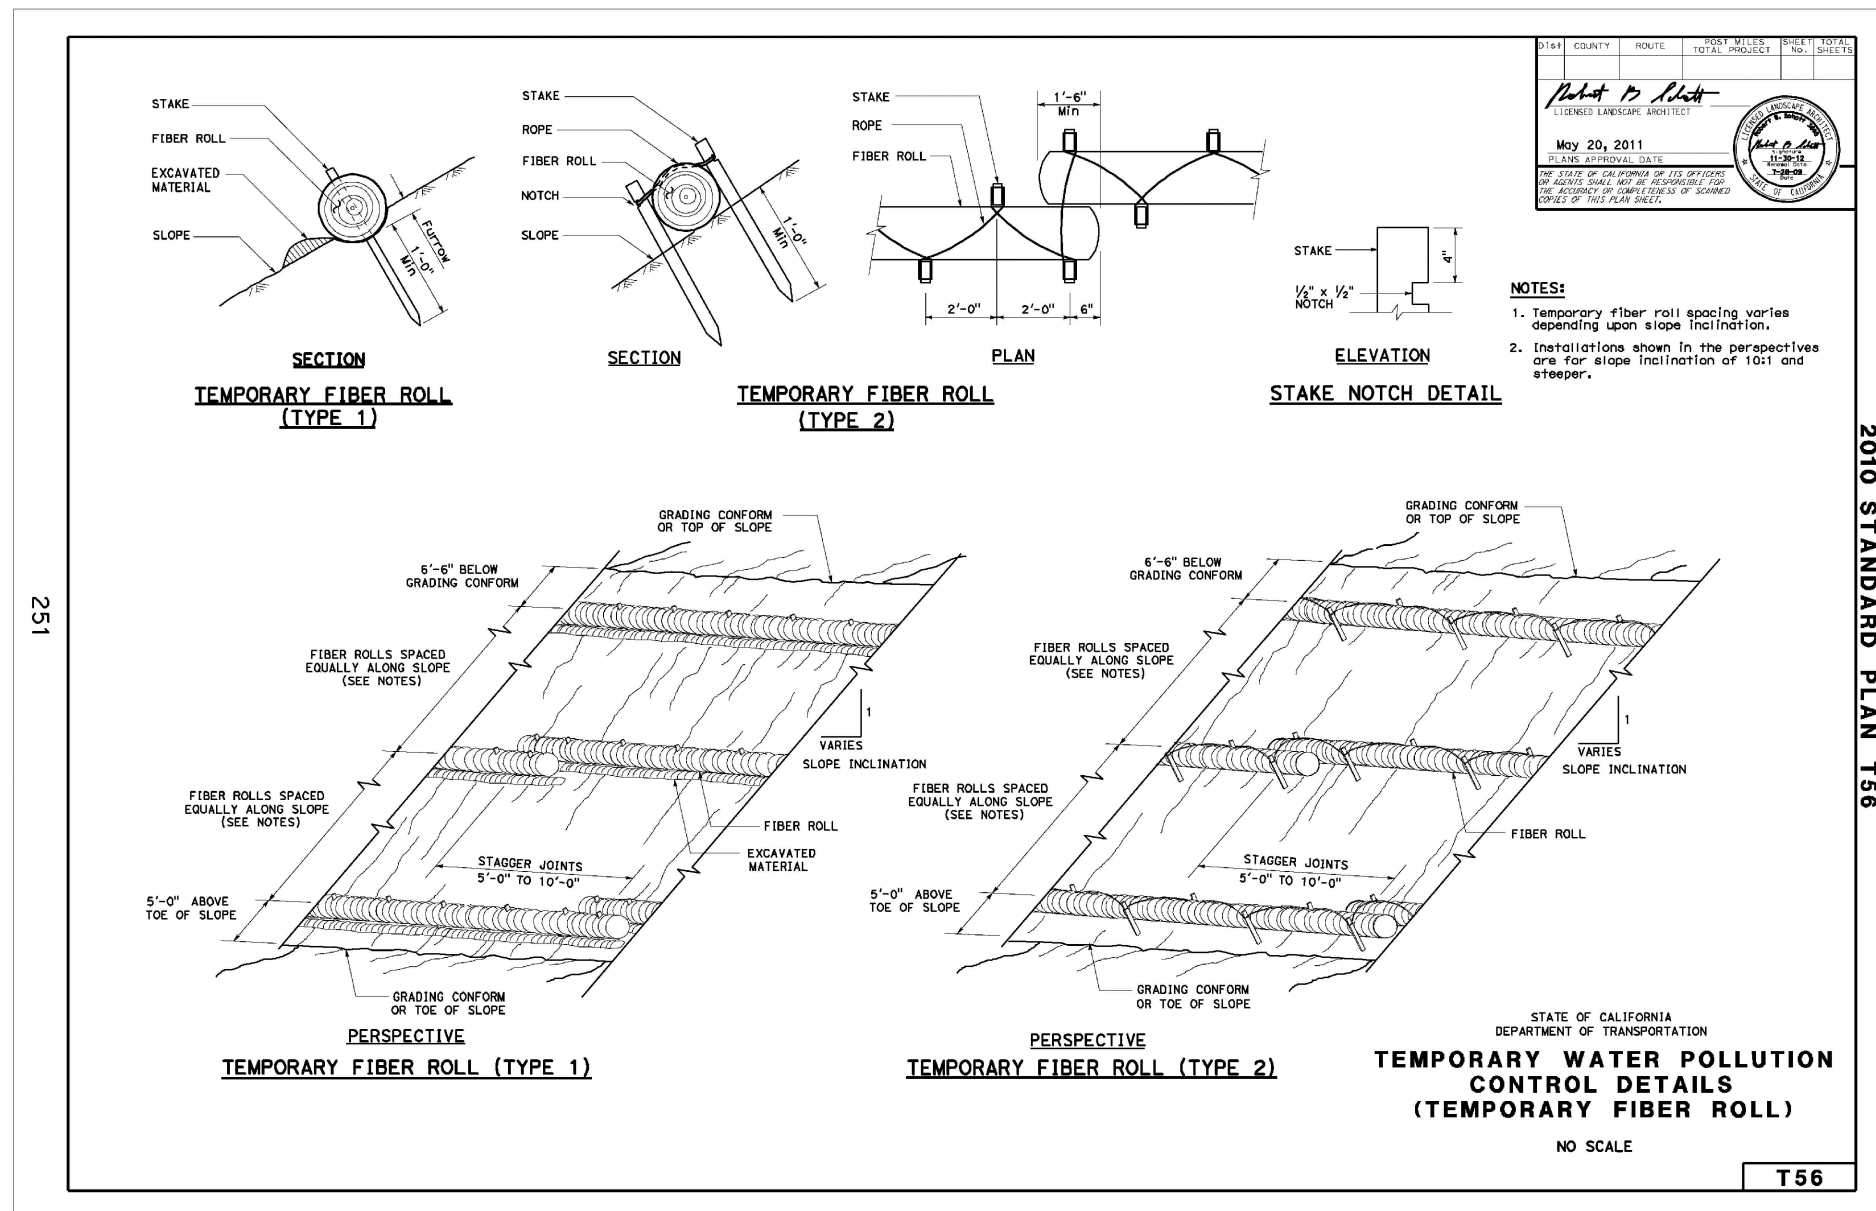

Locate fiber rolls on contours spaced as follows:

- Slope inclination of 4:1 (H:V) or flatter: Fiber rolls should be placed at a maximum interval of 20 ft.
- Slope inclination between 4:1 and 2:1 (H:V): Fiber Rolls should be placed at a maximum interval of 15 ft. (a closer spacing is more effective).
- Slope inclination 2:1 (H:V) or greater: Fiber Rolls should be placed at a maximum interval of 10 ft. (a closer spacing is more effective).

2 FIBER ROLL INSTALLATION DETAIL


EROSION AND SEDIMENT CONTROL AND PREVENTION NOTES

ALL DISCHARGES OF STORM WATER MUST COMPLY WITH THE LAWFUL REQUIREMENTS OF THE COUNTY OF SAN LUIS OBISPO, THE STATE OF CALIFORNIA, AND OTHER LOCAL AGENCIES REGARDING OFFSITE DISCHARGES OF STORM WATER.

3. THE DISTURBED AREA FOR THIS DEVELOPMENT IS LESS THAN AN ACRE, AND THEREFORE EXEMPT FROM THE REQUIREMENTS OF THE CALIFORNIA CONSTRUCTION GENERAL PERMIT.
2. RETAIN EXISTING VEGETATIVE COVER WHEN POSSIBLE, AND REDUCE THE AMOUNT OF DISTURBED/EXPOSED AREA WHERE POSSIBLE. DISTURB AREAS ONLY AS INDICATED ON THESE GRADING PLANS.
3. EROSION CONTROL MEASURES FOR WIND, WATER, AND TRACKING SHALL BE IMPLEMENTED ON THE PROJECT AT ALL TIMES AND SHALL INCLUDE SOURCE CONTROL, PROTECTION OF STOCKPILES (PER CALTRANS BMP WM-3), PROTECTION OF SLOPES, PROTECTION OF ALL DISTURBED AREAS, PROTECTION OF ACCESSES, AND PERIMETER CONTAINMENT MEASURES.
4. TEMPORARY EROSION CONTROL SHALL BE PLACED PRIOR TO THE COMMENCEMENT OF GRADING AND SITE DISTURBANCE ACTIVITIES. THE INTENT OF EROSION CONTROL MEASURES SHALL BE TO KEEP ALL GENERATED SEDIMENTS FROM ENTERING A SWALE, DRAINAGE WAY, WATERCOURSE, ATMOSPHERE, OR MIGRATE ONTO ADJACENT PROPERTIES OR ONTO THE PUBLIC RIGHT-OF-WAY.
5. PERMANENT EROSION CONTROL MEASURES SUCH AS HYDROSEEDING ON DISTURBED & GRADED SLOPES SHALL BE IMPLEMENTED AS SOON AS POSSIBLE FOLLOWING COMPLETION OF SOIL DISTURBING ACTIVITIES.
6. CONTRACTOR SHALL PERFORM SITE INSPECTIONS AND APPROPRIATE MAINTENANCE OF ALL EROSION CONTROL MEASURES/DEVICES DURING THE COURSE OF CONSTRUCTION AND ESPECIALLY PRIOR TO, DURING, AND AFTER RAIN EVENTS.
7. THE CONTRACTOR/DEVELOPER SHALL BE RESPONSIBLE FOR THE PLACEMENT AND MAINTENANCE OF ALL EROSION CONTROL MEASURES/DEVICES AS SPECIFIED BY THE APPROVED PLAN UNTIL PROJECT IS ACCEPTED AS COMPLETE BY COUNTY.
8. EROSION CONTROL MEASURES MAY BE RELOCATED, OR ADDITIONAL MEASURES MAY BE REQUIRED DEPENDING ON THE ACTUAL CONDITIONS ENCOUNTERED DURING CONSTRUCTION. ADDITIONAL EROSION CONTROL MEASURES/DEVICES SHALL BE PLACED AS REQUIRED BY THE ENGINEER, COUNTY, OR HCD INSPECTOR.
9. WIND EROSION SHALL BE IMPLEMENTED PER CALTRANS BMP WE-1 AND STOCKPILE MANAGEMENT SHALL BE IMPLEMENTED PER CALTRANS BMP WM-03.
10. THE CONTRACTOR, AND DEVELOPER SHALL BE RESPONSIBLE TO REVIEW THE PROJECT SITE PRIOR TO OCTOBER 15 (RAINY SEASON) AND TO COORDINATE AND ENSURE EROSION CONTROL DEVICES ARE INSTALLED PROPERLY. A LOCALLY BASED STANDBY CREW FOR EMERGENCY WORK SHALL BE AVAILABLE AT ALL TIMES DURING THE RAINY SEASON (OCTOBER 15 THROUGH APRIL 15). NECESSARY MATERIALS SHALL BE AVAILABLE AND STOCK PILED AT CONVENIENT LOCATIONS TO FACILITATE RAPID CONSTRUCTION OR MAINTENANCE OF TEMPORARY DEVICES WHEN RAIN IS IMMINENT.
11. IN THE EVENT OF A FAILURE, THE DEVELOPER AND/OR HIS REPRESENTATIVE SHALL BE RESPONSIBLE FOR CLEANUP AND ALL ASSOCIATED COSTS OR DAMAGE. IN THE EVENT THAT DAMAGE OCCURS WITHIN THE RIGHT-OF-WAY AND THE COUNTY IS REQUIRED TO PERFORM CLEANUP, THE OWNER SHALL BE RESPONSIBLE FOR COUNTY REIMBURSEMENT OF ALL ASSOCIATED COSTS OR DAMAGE.
10. ENSURE THAT THE EROSION AND SEDIMENTATION CONTROL MEASURES ARE INSTALLED IN ACCORDANCE WITH THE DETAIL S SHOWN IN THESE PLANS PRIOR TO EACH STORM EVENT. INSPECT AND MAINTAIN E&SC MEASURES ON ALL DISTURBED AREAS BEFORE, DURING, AND AFTER STORM EVENTS. AFTER EACH RAIN STORM, REMOVE ALL SILT AND DEBRIS FROM E&SC MEASURES.
11. THE USE OF PLASTIC MATERIALS SHALL BE LIMITED WHEN ALTERNATIVES EXIST.
12. ALL EQUIPMENT/ VEHICLES WILL BE FUELED, MAINTAINED AND STORED IN THE DESIGNATED STAGING AREA FITTED WITH APPROPRIATE BMPs.
13. STORAGE AREAS FOR MATERIALS, WASTE, WATER STORAGE, WATER TRANSFER FOR DUST CONTROL AND COMPACTION PRACTICES, AND CONCRETE WASHOUTS SHALL BE LOCATED WITHIN THE DESIGNATED STAGING AREAS.
14. TRACKING ONTO THE PUBLIC STREET SHALL BE MINIMIZED. THE ADJOINING STREET SHALL BE CLEANED BY SWEEPING TO REMOVE DIRT, DUST, MUD AND CONSTRUCTION DEBRIS AT THE END OF EACH DAY, AS A MINIMUM.
15. TEMPORARY EROSION CONTROL MEASURES SHALL BE REMOVED WHEN PERMANENT IMPROVEMENTS, PLANTINGS, AND STABILIZATION OF DISTURBED AREAS, BIODEGRADABLE FIBER ROLLS MAY BE LEFT IN PLACE WHEN CONSTRUCTION IS COMPLETE. TEMPORARY MEASURES SHALL BE REMOVED PRIOR TO FINAL INSPECTION.
16. DISTURBED AREA FOR THE NEW WATER PIPELINE WILL NOT CHANGE THE LINE OR GRADE OF THE EXISTING ROAD. AT THE END OF EACH WORKING DAY, ALL TRENCHES SHALL BE CLOSED AND SOIL SHALL BE COMPACTED IN PLACE, ESPECIALLY IF RAIN IS IN THE FORECAST.


DUST CONTROL NOTES

1. THE CONTRACTOR SHALL COMPLY WITH DUST CONTROL MEASURES REQUIRED BY SLO APCD.
2. IMPLEMENT PERMANENT DUST CONTROL MEASURES AS SOON AS POSSIBLE FOLLOWING COMPLETION OF ANY SOIL DISTURBING ACTIVITIES
3. STABILIZE ALL DISTURBED/EXPOSED SOIL AREAS PER THE EROSION CONTROL NOTES.
4. DURING CONSTRUCTION, WATER TRUCKS OR SPRINKLER SYSTEMS SHALL BE USED IN SUFFICIENT QUANTITIES TO PREVENT AIRBORNE DUST FROM LEAVING THE SITE. INCREASED FREQUENCY WILL BE REQUIRED WHENEVER WIND SPEEDS EXCEED 15 MPH. RECLAIMED (NON-POTABLE) WATER SHALL BE USED WHENEVER POSSIBLE.
5. ALL DIRT STOCKPILE AREAS SHALL BE SPRAYED DAILY AS NEEDED.
6. ALL TRUCKS HAULING SOIL MATERIALS TO AND FROM THE SITE SHALL BE COVERED WITH A TARP TO PREVENT DUST FROM BLOWING OFF THE TRUCK.
7. ALL CONSTRUCTION VEHICLES SHALL NOT EXCEED 15 MPH ON ANY UNPAVED SURFACE AT THE CONSTRUCTION SITE.
8. THE CONTRACTOR SHALL DESIGNATE A PERSON OR PERSONS TO MONITOR THE DUST CONTROL PROGRAM AND TO ORDER INCREASED WATERING, AS NECESSARY, TO REDUCE THE TRANSPORT OF DUST OFF-SITE. THE DESIGNATED PERSON'S DUTY SHALL INCLUDE HOLIDAY AND WEEKEND PERIODS WHEN WORK MAY NOT BE IN PROGRESS.
9. CONSTRUCTION EQUIPMENT SHALL CONFORM TO THE MOST CURRENT AIR QUALITY REGULATIONS FOR THE OPERATION OF MOTOR VEHICLES.

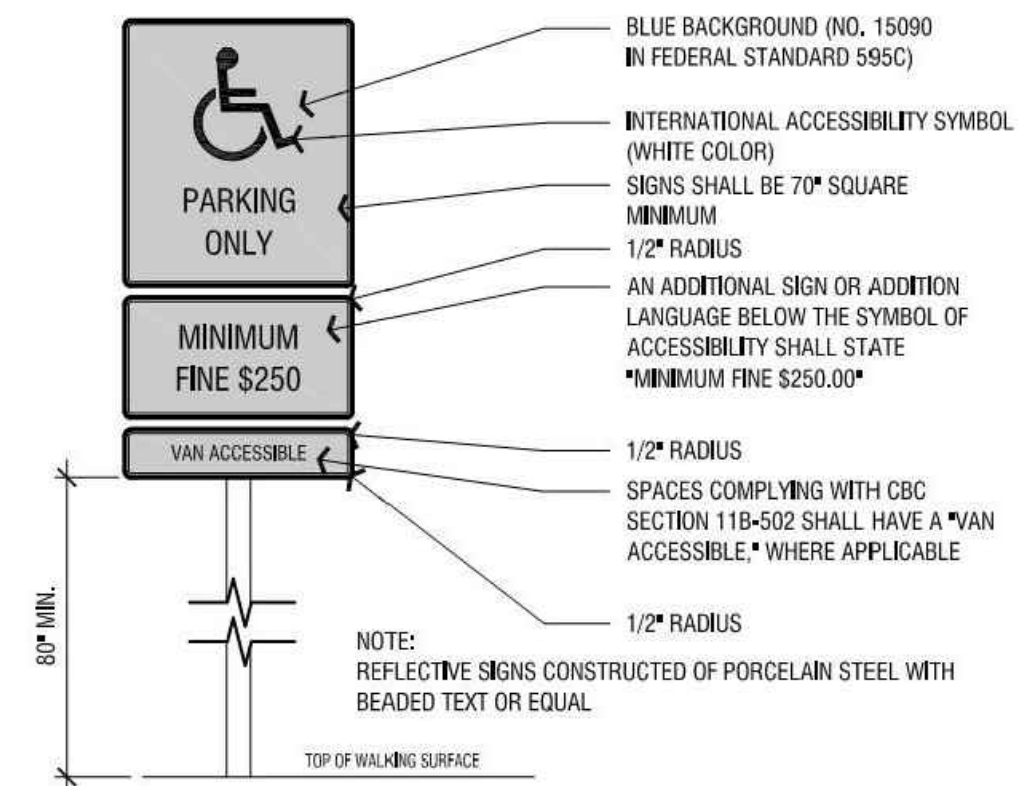

3 ACCESSIBLE PARKING SIGNAGE

SCALE: $3/4" = 1'-0"$

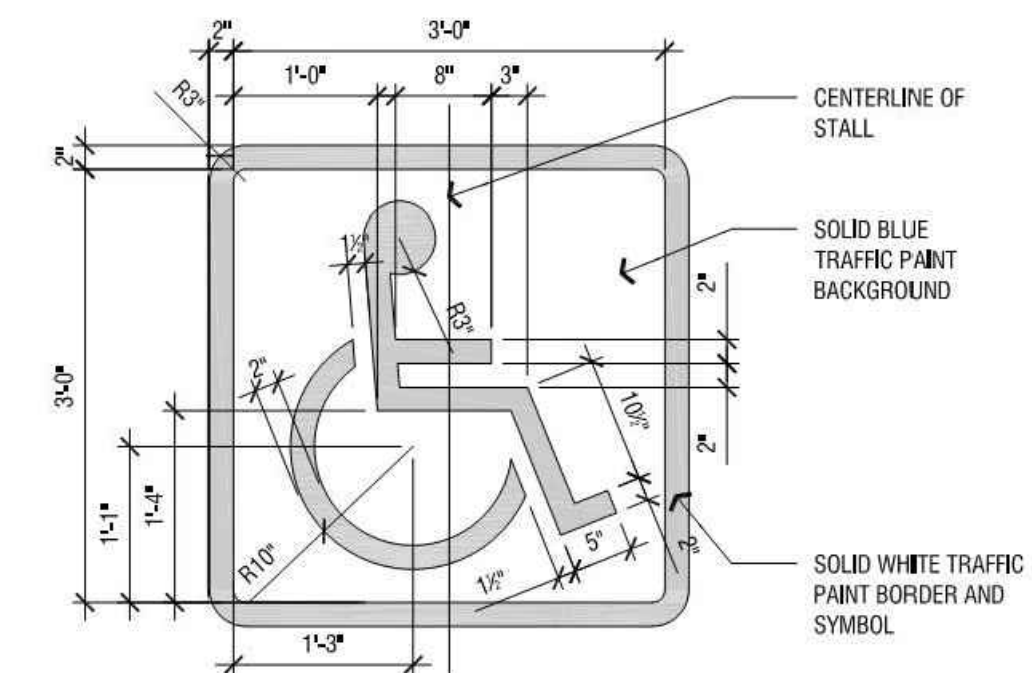


NOTE:
PER 2013 CBC 11B-502.6.4, THE CENTERLINE OF THE INTERNATIONAL SYMBOL OF ACCESSIBILITY SHALL BE A MAXIMUM OF 6 INCHES FROM THE CENTERLINE OF THE PARKING SPACE, ITS SIDES PARALLEL TO THE LENGTH OF THE PARKING SPACE AND ITS LOWER CORNER AT, OR LOWER SIDE ALIGNED WITH, THE END OF THE PARKING SPACE.


**INTERNATIONAL SYMBOL
OF ACCESSIBILITY**

PARKING

SCALE: 3/4" = 1'-0"

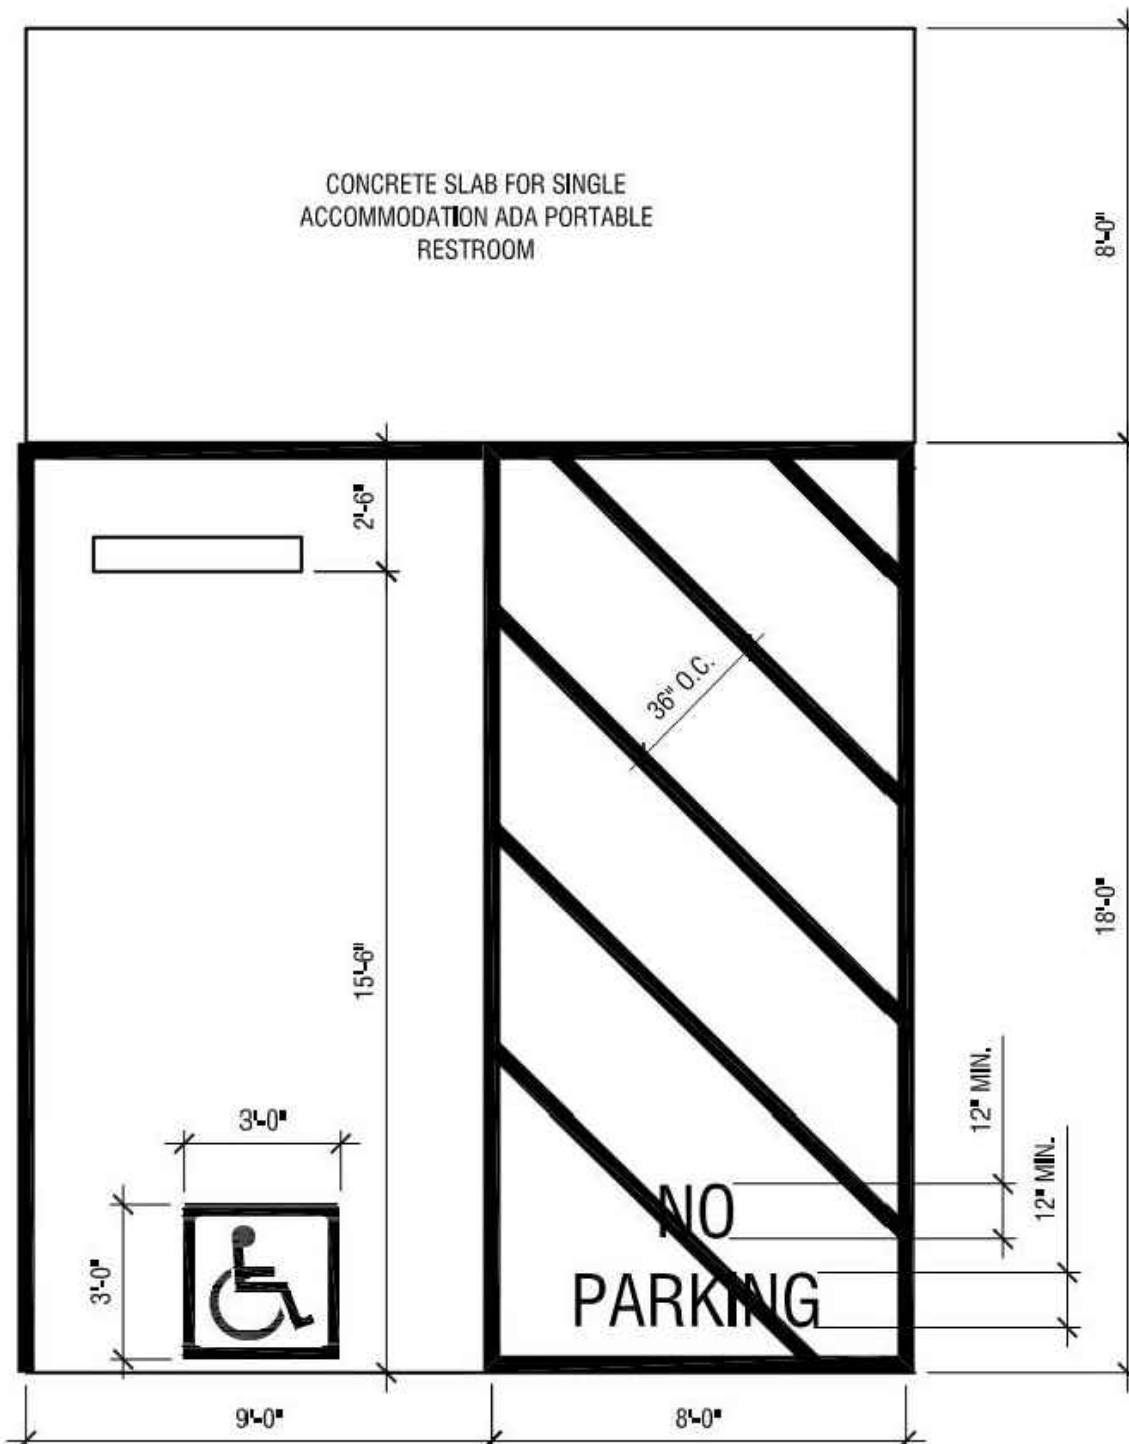

5 ADA STALL
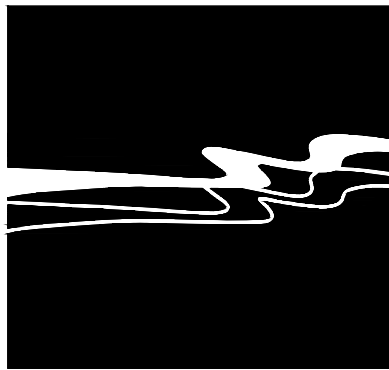
$$1/4'' = 1'$$


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SIGNATURE

DATE SIGNED _____

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GREEN GOLD ORGANIC COLLECTIVE
MT. LOWE CANNABIS CULTIVATION
DETAILS

DETAILS

JOB #: 1441-0001
DESIGNERS: SJ
DRAWN BY: SJ
DATE: 10-31-2018
DRAWING NO.

C-3.0

3 OF 3 SHEETS