

APPENDIX V -

SEWER CAPACITY STUDY

Sewer Capacity Study

Tentative Tract 6016 *Camarillo, CA*

November 13, 2019

Prepared by:



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SEWER CAPACITY STUDY

TENTATIVE TRACT 6016

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November 11, 2019

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1. Project Overview

1.1. Introduction

This sewer capacity study is being prepared to support Tentative Tract 6016, in the City of Camarillo, CA. The project is located at the base of the Conejo Mountains within the existing Camarillo Springs Golf Course. The area proposed is located south of Ridge View Street and west of the existing golf course driving range. See Figure A (right) for vicinity map.

1.2. Land Use

Tentative Tract 6016 consists of a total of 32 acres of development, designated as Public/Quasi Public, and zoned RE (Rural Residential). The project applicant is requesting to amend the General Plan land use designation to Low-Medium Density Residential (30 dwelling units per acre.) The development is proposing 248 age restricted (55+) single family detached dwelling units, private recreation center, pocket parks, walking trails and natural open space. The project would reconfigure and update the existing golf course, resulting in the number of holes being reduced from 18 to 12. Other improvements proposed to the existing golf course include a new clubhouse facility, a 6.3 acre neighborhood park, trails, a 1.3 acre dog park, and event spaces (See Appendix A for Conceptual Site Plan).

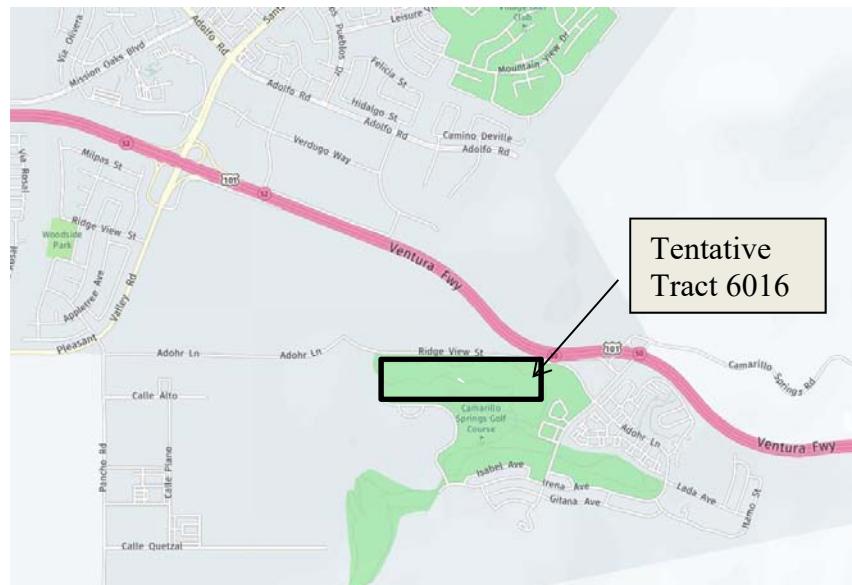


Figure A – Vicinity Map

2. Existing and Proposed Sewer System Layout

2.1. Existing Sewer Layout

The existing site is serviced by the Camarillo Sanitary District via an existing 15" VCP line, which ties into a 10" and 8" VCP siphon east of the Conejo Creek and traverses underneath the existing channel connecting to a siphon pump structure and a 24" ACP sewer line. The pipe then connects via a 5' manhole to a 12" VCP line, which then continues to the treatment plant.

2.2. Existing Sewer Flows

A flow study was done along the 12" VCP line at an existing manhole located about 600' south of the siphon crossing of Conejo Creek. The manhole is located on the western edge of a dirt road, east of an agriculture field, west of Conejo Creek and south of Adohr Lane. The manhole was monitored from June 21st until July 9th, 2018, by Dexter Wilson Engineering. See appendix B for

readings from the flow study, including the existing minimum, average, and peak dry weather flows, as well as a pipe flow report for the Ex. 12" VCP pipe.

2.3. Proposed Sewer Flow Rates

The sewer flow rates were calculated using two different methods:

- First, by applying an 85% factor to the expected water demand 66,376 gpd, as shown below in Table 1:

Table 1 - Domestic Water Demand - TT 6016

Land Use Description	Lot Area (Ac)	Units	Water Use (AF/Year) ⁽³⁾	Total Usage (AF/Year)	Total Usage (gpd)	Max Daily Demand (gpm) ⁽¹⁾	Peak Hour Demand (gpm) ⁽²⁾
TT 6016	32	248	0.30	74.4	66,376.0	92.19	273.5

(1) Maximum Day Demand based upon peaking factor equal to 2.0 times Average Annual Demand

(2) Peak Hour Demand based upon peaking factor equal to 6.0 times Average Annual Demand

(3) Per Water Demand Credit Program, Resolution no. 2016-89, Single Family Small Yard Water use is 0.30 AF/Year

This results in a peak demand of 56,420gpd (66,376x0.85=56,420)

- Second, average dry weather flow (Qadw) rates were calculated using Table 2.1 in the 2015 City of Camarillo Sanitary District Manual of Standard Specifications, as shown in Table 2 below:

Table 2 - Sewer Demand - TT 6016

High Density Land-Use	Area (ac)	Ultimate Unit Flow Factor (1)		Average Dry Weather flow (Qadw)		Higher Average Dry Weather Flow Qadw		Peak Dry Weather Flows, Qpdw (2)		Peak Wet Weather Flows, Qpww (3)	
		gpd/ac		(gpd)	(cfs)	(cfs)	(gpm)	(cfs)	(gpm)	(cfs)	(gpm)
TT 6016	32 Ac	1700	/Ac	54400 gpd	56,420 (4)	0.087	0.222	99.64	0.311	139.50	

(1) Ultimate Unit Flow Factors calculated using Table 2.1 in the 2015 City of Camarillo Sanitary District Manual of Standard Specifications

(2) Qpdw = 2.1 (Qadw)^{0.92}, per Section 2.1.1.2 of the 2015 City of Camarillo Sanitary District Manual of Standard Specifications

(3) Qpww = 1.4 (Qpdw), per Section 2.1.1.3 of the 2015 City of Camarillo Sanitary District Manual of Standard Specifications

(4) Using higher of the two demand values, based on 85% of building water demand (From Table 1 - 85% of 66,376=56,420)

The higher of the two factors was used to calculate Peak Dry and Wet Weather Flows, as summarized in Table 2.

2.4. Sewer System Evaluation Criteria and Assumptions

Evaluation and sizing for the required sewer collection system facilities were conducted using Camarillo Sanitary District Standard Specification (CSDSS) criteria and information from the Sewer System Master Plan Update 2015. Manning's "n" was assumed to be 0.013 for the VCP pipe, and 0.012 for PVC pipe. As stated, the peak dry weather flow rate in pipes 15 inches and smaller should not exceed a depth to pipe diameter ratio of $d/D=0.5$. For pipes 18 inches and larger, the maximum d/D may be 0.62. Sewer mains should also be constructed to provide a mean velocity of not less than two (2) feet per second. See Appendix C for the allowable flow in a 12" pipe per the district standards.

2.5. Sewer Collection and Hydraulic Analysis

The existing pipe has a very flat slope of $S=0.04\%$ (See Appendix E for Sewer Plans of Existing 12" VCP). Based on the flow report, the existing pipe is flowing at an average measured level of 6.5" (See Appendix C for Existing flow based on Flow Report), which is approximately 0.43 cfs. The total projected Peak Dry Weather Flow (PDWF) from Tentative Tract 6016 could add approximately 0.222 cfs (99.64gpm), as shown on Table 2.

The existing pipe is already flowing at a 0.5" higher than District Standards, but at less than the mean velocity of 2 fps. A pipe calculation was done to determine the d/D ratio in the existing 12" VCP pipe with the addition of the 0.222 cfs flows from the proposed development. See Appendix D. The depth in the pipe with the project is approximately 8.8". The expected velocity increases from 0.98 ft/s, to 1.06 ft/s. A pipe calculation was done for a 15" PVC pipe, which meets the depth requirement, and have an even higher velocity of 1.14 ft/sec, see Appendix D.

3. Conclusion

The current infrastructure in place for the sewer does not meet Camarillo Sanitary District Standards. With the addition of 248 single family dwelling units, the existing Conejo Creek 12" VCP Sewer Line would need to be upsized to a 15" PVC, SDR 35 sewer line.

APPENDIX A



CLUBHOUSE, DRIVING RANGE & PARK KEY

- ① NEW CLUBHOUSE
 - GOLF SHOP
 - RESTAURANT & BAR
 - OUTDOOR LOUNGE
 - PRACTICE GREENS
 - EVENT AREA
- ② IMPROVED DRIVING RANGE
- ③ EXISTING POND
- ④ DOG PARK
- ⑤ NEW PARK
 - SHADeD SEATING
 - OPEN TURF
 - PATHWAYS
- ⑥ EXISTING PARKING LOT
- ⑦ CART PATH
- ⑧ REDESIGNED GOLF COURSE

PROPOSED COMMUNITY

- ⑨ GATED COMMUNITY ENTRY
- ⑩ NEW 55+ CLUBHOUSE
 - POOL & SPA
 - PICKLEBALL COURTS
 - RAISED GARDENS
 - OUTDOOR COOKING/DINING
- ⑪ POCKET PARK
- ⑫ EXPANDED LAKE
- ⑬ LAKE TRAIL

New Urban West

APPENDIX B

Dexter Wilson Engineering

~4986 Adohr Ln, Camarillo, CA 93012

2018.06 Adohr MH L15-100

Manhole No. L15-100

Access:


MH is on the western edge of a dirt road, east of a field, west of Conejo Creek, and south of Adohr Lane.

System Type:

 Sanitary Storm

Install Date: 6/21/2018

Map

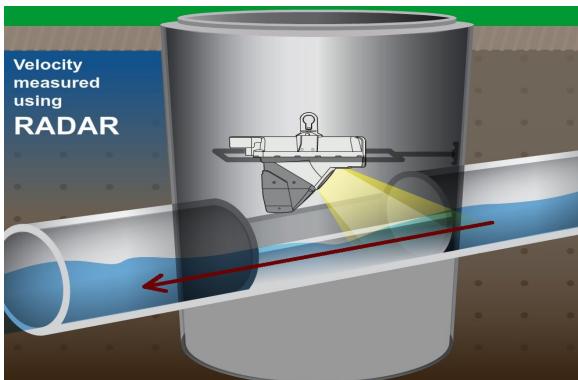Technology

Sewer Plan

Flow Meter

Meter Depth: 204"

MH Coordinates: 34.204056, -119.001528

Laminar to moderate open channel hydraulics; slight bend in trough within MH.

Avg Velocity	Avg Measured Level	Multiplier
0.75 fps	6.5"	1

Gas

O2	H2S	CO	LEL
20.9	0	0	0

Notes

No laterals; monitored upstream line as it provided best hydraulics. Liner has issues.

Traffic Safety

MH in open space, no traffic control required.

Land Use

Residential	Commercial	Industrial	Trunk
X			

Manhole Depth 223"

Monitored Pipe Size 12"

Inner Pipe Size (In/Out) 12"/12"

Pipe Shape Round

Pipe Condition Good

Manhole Material Lined Concrete

Silt 0

Velocity Profile Data *

Velocity Profile Taken 0.4 2-D

Sensor Offset 18.69"

Sensor Dist. to Crown 6.69"

Sensor Direction Upstream

Flow Heading West



Meter Site Document

Dexter Wilson Engineering

2018.06 Adohr MH L15-100

~4986 Adohr Ln, Camarillo, CA 93012

Site



Manhole During Install



Installation Process



Installed



Upstream



Monitored Pipe Size



Data for 2018.06 Adohr MH L15-100:
 6/21/2018 thru 7/09/2018

TimeStamp	Level (in)	Flow (gpm)	Velocity (fps)
2018/06/21 10:45	6.75	167.01	0.82
2018/06/21 11:00	6.79	176.78	0.86
2018/06/21 11:15	6.84	186.67	0.90
2018/06/21 11:30	7.04	190.74	0.89
2018/06/21 11:45	7.14	196.87	0.90
2018/06/21 12:00	7.14	196.87	0.90
2018/06/21 12:15	7.21	200.53	0.91
2018/06/21 12:30	7.14	198.49	0.91
2018/06/21 12:45	7.11	191.82	0.88
2018/06/21 13:00	6.98	187.35	0.88
2018/06/21 13:15	6.91	176.67	0.84
2018/06/21 13:30	6.86	175.07	0.84
2018/06/21 13:45	6.79	172.90	0.84
2018/06/21 14:00	6.79	174.85	0.85
2018/06/21 14:15	6.79	178.83	0.87
2018/06/21 14:30	6.71	176.26	0.87
2018/06/21 14:45	6.69	175.56	0.87
2018/06/21 15:00	6.53	159.90	0.82
2018/06/21 15:15	6.53	159.90	0.82
2018/06/21 15:30	6.51	159.20	0.82
2018/06/21 15:45	6.50	158.90	0.82
2018/06/21 16:00	6.50	158.90	0.82
2018/06/21 16:15	6.50	158.90	0.82
2018/06/21 16:30	6.33	147.69	0.78
2018/06/21 16:45	6.28	144.26	0.77
2018/06/21 17:00	6.22	142.53	0.77
2018/06/21 17:15	6.22	142.53	0.77
2018/06/21 17:30	6.22	143.96	0.78
2018/06/21 17:45	6.22	146.12	0.79
2018/06/21 18:00	6.41	152.11	0.79
2018/06/21 18:15	6.55	160.50	0.82
2018/06/21 18:30	6.55	160.50	0.82
2018/06/21 18:45	6.55	160.50	0.82
2018/06/21 19:00	6.54	160.20	0.82
2018/06/21 19:15	6.54	160.20	0.82
2018/06/21 19:30	6.54	172.04	0.88
2018/06/21 19:45	6.57	173.16	0.88
2018/06/21 20:00	6.60	176.06	0.89
2018/06/21 20:15	6.81	183.00	0.89

TimeStamp	Level (in)	Flow (gpm)	Velocity (fps)
2018/06/21 20:30	6.81	183.80	0.89
2018/06/21 20:45	6.87	185.72	0.89
2018/06/21 21:00	6.93	189.99	0.90
2018/06/21 21:15	6.95	186.48	0.88
2018/06/21 21:30	6.95	186.48	0.88
2018/06/21 21:45	6.95	186.48	0.88
2018/06/21 22:00	6.84	182.85	0.88
2018/06/21 22:15	6.74	179.60	0.88
2018/06/21 22:30	6.71	178.06	0.88
2018/06/21 22:45	6.71	180.37	0.89
2018/06/21 23:00	6.70	175.39	0.87
2018/06/21 23:15	6.62	172.83	0.87
2018/06/21 23:30	6.48	166.04	0.85
2018/06/21 23:45	6.42	157.98	0.82
2018/06/22 00:00	6.31	151.11	0.80
2018/06/22 00:15	6.11	140.76	0.78
2018/06/22 00:30	6.03	131.48	0.74
2018/06/22 00:45	5.88	126.96	0.74
2018/06/22 01:00	5.72	121.91	0.73
2018/06/22 01:15	5.61	114.19	0.71
2018/06/22 01:30	5.48	108.90	0.69
2018/06/22 01:45	5.47	105.72	0.68
2018/06/22 02:00	5.39	101.90	0.66
2018/06/22 02:15	5.32	95.61	0.63
2018/06/22 02:30	5.11	81.96	0.57
2018/06/22 02:45	5.07	79.71	0.56
2018/06/22 03:00	5.03	78.84	0.56
2018/06/22 03:15	5.00	78.19	0.56
2018/06/22 03:30	4.99	72.44	0.52
2018/06/22 03:45	4.93	71.29	0.52
2018/06/22 04:00	4.89	67.96	0.50
2018/06/22 04:15	4.87	70.18	0.52
2018/06/22 04:30	4.85	67.13	0.50
2018/06/22 04:45	4.87	74.13	0.55
2018/06/22 05:00	4.89	74.54	0.55
2018/06/22 05:15	4.91	76.35	0.56
2018/06/22 05:30	4.98	77.62	0.56
2018/06/22 05:45	5.16	81.76	0.56
2018/06/22 06:00	5.17	82.00	0.56
2018/06/22 06:15	5.20	88.22	0.60
2018/06/22 06:30	5.20	88.22	0.60
2018/06/22 06:45	5.37	101.52	0.66
2018/06/22 07:00	5.70	120.06	0.73
2018/06/22 07:15	5.74	126.10	0.76
2018/06/22 07:30	6.11	148.09	0.82

TimeStamp	Level (in)	Flow (gpm)	Velocity (fps)
2018/06/22 07:45	6.38	166.77	0.88
2018/06/22 08:00	6.51	170.99	0.88
2018/06/22 08:15	6.75	180.45	0.88
2018/06/22 08:30	6.89	183.24	0.88
2018/06/22 08:45	7.09	187.66	0.87
2018/06/22 09:00	7.09	186.57	0.86
2018/06/22 09:15	7.11	188.35	0.87
2018/06/22 09:30	7.13	189.20	0.87
2018/06/22 09:45	7.13	193.37	0.89
2018/06/22 10:00	7.26	199.18	0.89
2018/06/22 10:15	7.47	206.26	0.89
2018/06/22 10:30	7.47	206.26	0.89
2018/06/22 10:45	7.47	204.44	0.89
2018/06/22 11:00	7.29	194.67	0.87
2018/06/22 11:15	7.27	193.40	0.87
2018/06/22 11:30	7.14	189.29	0.87
2018/06/22 11:45	7.11	188.30	0.87
2018/06/22 12:00	7.05	183.82	0.85
2018/06/22 12:15	7.03	187.29	0.87
2018/06/22 12:30	7.03	195.94	0.91
2018/06/22 12:45	7.05	187.93	0.87
2018/06/22 13:00	7.08	186.81	0.86
2018/06/22 13:15	7.08	186.81	0.86
2018/06/22 13:30	7.08	182.33	0.84
2018/06/22 13:45	6.87	175.78	0.84
2018/06/22 14:00	6.72	170.17	0.84
2018/06/22 14:15	6.72	170.17	0.84
2018/06/22 14:30	6.71	170.15	0.84
2018/06/22 14:45	6.69	171.08	0.85
2018/06/22 15:00	6.67	168.86	0.84
2018/06/22 15:15	6.64	167.93	0.84
2018/06/22 15:30	6.64	165.15	0.83
2018/06/22 15:45	6.63	161.11	0.81
2018/06/22 16:00	6.64	161.36	0.81
2018/06/22 16:15	6.64	161.36	0.81
2018/06/22 16:30	6.60	160.17	0.81
2018/06/22 16:45	6.60	160.49	0.81
2018/06/22 17:00	6.64	167.22	0.84
2018/06/22 17:15	6.60	165.98	0.84
2018/06/22 17:30	6.60	162.07	0.82
2018/06/22 17:45	6.60	160.49	0.81
2018/06/22 18:00	6.56	160.86	0.82
2018/06/22 18:15	6.56	160.86	0.82
2018/06/22 18:30	6.56	164.63	0.84
2018/06/22 18:45	6.51	163.19	0.84

TimeStamp	Level (in)	Flow (gpm)	Velocity (fps)
2018/06/22 19:00	6.56	166.56	0.84
2018/06/22 19:15	6.65	171.86	0.86
2018/06/22 19:30	6.66	172.18	0.86
2018/06/22 19:45	6.66	172.18	0.86
2018/06/22 20:00	6.66	172.18	0.86
2018/06/22 20:15	6.62	166.80	0.84
2018/06/22 20:30	6.49	162.43	0.83
2018/06/22 20:45	6.49	162.43	0.83
2018/06/22 21:00	6.49	162.43	0.83
2018/06/22 21:15	6.62	174.89	0.88
2018/06/22 21:30	6.62	174.89	0.88
2018/06/22 21:45	6.87	187.15	0.90
2018/06/22 22:00	6.87	191.79	0.92
2018/06/22 22:15	6.87	191.79	0.92
2018/06/22 22:30	6.78	176.55	0.86
2018/06/22 22:45	6.74	183.15	0.90
2018/06/22 23:00	6.71	182.16	0.90
2018/06/22 23:15	6.69	177.06	0.88
2018/06/22 23:30	6.63	175.11	0.88
2018/06/22 23:45	6.60	174.14	0.88
2018/06/23 00:00	6.38	162.64	0.85
2018/06/23 00:15	6.22	140.62	0.76
2018/06/23 00:30	6.13	137.90	0.76
2018/06/23 00:45	6.03	127.54	0.72
2018/06/23 01:00	5.89	122.09	0.71
2018/06/23 01:15	5.72	113.82	0.69
2018/06/23 01:30	5.68	112.74	0.69
2018/06/23 01:45	5.53	107.13	0.68
2018/06/23 02:00	5.53	102.44	0.65
2018/06/23 02:15	5.50	100.23	0.64
2018/06/23 02:30	5.42	96.60	0.62
2018/06/23 02:45	5.29	91.99	0.61
2018/06/23 03:00	5.14	88.29	0.61
2018/06/23 03:15	5.06	86.53	0.61
2018/06/23 03:30	5.05	83.59	0.59
2018/06/23 03:45	5.06	83.85	0.59
2018/06/23 04:00	5.09	80.23	0.56
2018/06/23 04:15	5.06	78.13	0.55
2018/06/23 04:30	5.01	75.72	0.54
2018/06/23 04:45	5.01	74.45	0.53
2018/06/23 05:00	4.93	71.18	0.52
2018/06/23 05:15	4.92	70.99	0.52
2018/06/23 05:30	4.90	69.30	0.51
2018/06/23 05:45	4.90	70.60	0.52
2018/06/23 06:00	4.92	72.35	0.53

TimeStamp	Level (in)	Flow (gpm)	Velocity (fps)
2018/06/23 06:15	5.01	78.44	0.56
2018/06/23 06:30	5.09	82.82	0.58
2018/06/23 06:45	5.18	87.82	0.60
2018/06/23 07:00	5.32	91.11	0.60
2018/06/23 07:15	5.40	92.99	0.60
2018/06/23 07:30	5.53	103.95	0.66
2018/06/23 07:45	5.76	121.53	0.73
2018/06/23 08:00	6.03	136.68	0.77
2018/06/23 08:15	6.03	140.23	0.79
2018/06/23 08:30	6.16	149.77	0.82
2018/06/23 08:45	6.61	175.02	0.88
2018/06/23 09:00	6.76	183.92	0.90
2018/06/23 09:15	6.80	185.25	0.90
2018/06/23 09:30	7.06	193.79	0.90
2018/06/23 09:45	7.09	206.65	0.95
2018/06/23 10:00	7.45	219.14	0.95
2018/06/23 10:15	7.60	212.20	0.90
2018/06/23 10:30	7.62	217.86	0.92
2018/06/23 10:45	7.68	219.84	0.92
2018/06/23 11:00	7.75	222.20	0.92
2018/06/23 11:15	7.68	219.84	0.92
2018/06/23 11:30	7.68	219.84	0.92
2018/06/23 11:45	7.62	227.25	0.96
2018/06/23 12:00	7.57	220.19	0.94
2018/06/23 12:15	7.56	193.12	0.83
2018/06/23 12:30	7.48	217.09	0.94
2018/06/23 12:45	7.48	222.35	0.96
2018/06/23 13:00	7.35	212.67	0.94
2018/06/23 13:15	7.35	202.93	0.90
2018/06/23 13:30	7.35	204.35	0.90
2018/06/23 13:45	7.11	195.08	0.90
2018/06/23 14:00	7.08	192.36	0.89
2018/06/23 14:15	6.92	187.13	0.89
2018/06/23 14:30	6.85	184.79	0.89
2018/06/23 14:45	6.77	177.92	0.87
2018/06/23 15:00	6.73	176.63	0.87
2018/06/23 15:15	6.73	174.58	0.86
2018/06/23 15:30	6.68	172.99	0.86
2018/06/23 15:45	6.57	166.97	0.85
2018/06/23 16:00	6.57	169.44	0.86
2018/06/23 16:15	6.57	169.05	0.86
2018/06/23 16:30	6.54	168.10	0.86
2018/06/23 16:45	6.54	168.10	0.86
2018/06/23 17:00	6.57	170.76	0.86
2018/06/23 17:15	6.61	174.53	0.88

TimeStamp	Level (in)	Flow (gpm)	Velocity (fps)
2018/06/23 17:30	6.63	177.09	0.89
2018/06/23 17:45	6.67	178.46	0.89
2018/06/23 18:00	6.70	179.39	0.89
2018/06/23 18:15	6.79	182.29	0.89
2018/06/23 18:30	6.79	180.34	0.88
2018/06/23 18:45	6.79	178.79	0.87
2018/06/23 19:00	6.66	173.51	0.86
2018/06/23 19:15	6.57	168.94	0.86
2018/06/23 19:30	6.57	170.58	0.86
2018/06/23 19:45	6.57	170.58	0.86
2018/06/23 20:00	6.70	175.53	0.87
2018/06/23 20:15	6.73	177.10	0.87
2018/06/23 20:30	6.74	177.42	0.87
2018/06/23 20:45	6.74	177.42	0.87
2018/06/23 21:00	6.74	177.42	0.87
2018/06/23 21:15	6.62	171.02	0.86
2018/06/23 21:30	6.62	171.02	0.86
2018/06/23 21:45	6.62	168.77	0.85
2018/06/23 22:00	6.63	169.08	0.85
2018/06/23 22:15	6.65	176.87	0.88
2018/06/23 22:30	6.73	179.48	0.88
2018/06/23 22:45	6.73	176.30	0.87
2018/06/23 23:00	6.73	176.30	0.87
2018/06/23 23:15	6.64	171.17	0.86
2018/06/23 23:30	6.56	167.08	0.85
2018/06/23 23:45	6.55	162.13	0.82
2018/06/24 00:00	6.44	157.08	0.82
2018/06/24 00:15	6.36	152.33	0.80
2018/06/24 00:30	6.16	136.88	0.75
2018/06/24 00:45	5.89	127.13	0.74
2018/06/24 01:00	5.88	121.73	0.71
2018/06/24 01:15	5.85	115.77	0.68
2018/06/24 01:30	5.63	108.16	0.67
2018/06/24 01:45	5.58	105.38	0.66
2018/06/24 02:00	5.54	99.72	0.63
2018/06/24 02:15	5.39	95.93	0.62
2018/06/24 02:30	5.30	87.79	0.58
2018/06/24 02:45	5.30	87.79	0.58
2018/06/24 03:00	5.30	87.79	0.58
2018/06/24 03:15	5.27	87.15	0.58
2018/06/24 03:30	5.27	87.15	0.58
2018/06/24 03:45	5.25	86.69	0.58
2018/06/24 04:00	5.19	80.64	0.55
2018/06/24 04:15	5.14	79.56	0.55
2018/06/24 04:30	5.06	75.32	0.53

TimeStamp	Level (in)	Flow (gpm)	Velocity (fps)
2018/06/24 04:45	5.01	74.33	0.53
2018/06/24 05:00	4.98	70.75	0.51
2018/06/24 05:15	4.87	68.69	0.51
2018/06/24 05:30	4.87	68.69	0.51
2018/06/24 05:45	4.87	68.69	0.51
2018/06/24 06:00	4.87	66.05	0.49
2018/06/24 06:15	4.90	69.41	0.51
2018/06/24 06:30	4.90	69.41	0.51
2018/06/24 06:45	4.97	70.76	0.51
2018/06/24 07:00	5.03	71.85	0.51
2018/06/24 07:15	5.05	80.95	0.57
2018/06/24 07:30	5.11	86.04	0.60
2018/06/24 07:45	5.35	94.47	0.62
2018/06/24 08:00	5.73	115.74	0.70
2018/06/24 08:15	5.90	125.58	0.73
2018/06/24 08:30	6.08	132.56	0.74
2018/06/24 08:45	6.19	154.47	0.84
2018/06/24 09:00	6.75	177.67	0.87
2018/06/24 09:15	6.84	182.80	0.88
2018/06/24 09:30	6.89	188.27	0.90
2018/06/24 09:45	6.97	191.54	0.90
2018/06/24 10:00	7.16	207.68	0.95
2018/06/24 10:15	7.27	212.34	0.95
2018/06/24 10:30	7.53	226.05	0.97
2018/06/24 10:45	7.53	226.05	0.97
2018/06/24 11:00	7.92	260.17	1.05
2018/06/24 11:15	7.99	262.72	1.05
2018/06/24 11:30	7.99	262.72	1.05
2018/06/24 11:45	7.99	235.25	0.94
2018/06/24 12:00	7.77	224.99	0.93
2018/06/24 12:15	7.66	218.39	0.92
2018/06/24 12:30	7.60	219.32	0.93
2018/06/24 12:45	7.53	214.05	0.92
2018/06/24 13:00	7.53	214.05	0.92
2018/06/24 13:15	7.49	217.73	0.94
2018/06/24 13:30	7.49	219.76	0.95
2018/06/24 13:45	7.43	217.70	0.95
2018/06/24 14:00	7.43	217.70	0.95
2018/06/24 14:15	7.43	208.28	0.91
2018/06/24 14:30	7.43	207.84	0.91
2018/06/24 14:45	7.30	193.47	0.86
2018/06/24 15:00	7.00	183.75	0.86
2018/06/24 15:15	6.93	185.50	0.88
2018/06/24 15:30	6.89	180.26	0.86
2018/06/24 15:45	6.84	178.48	0.86

TimeStamp	Level (in)	Flow (gpm)	Velocity (fps)
2018/06/24 16:00	6.68	172.49	0.86
2018/06/24 16:15	6.68	172.49	0.86
2018/06/24 16:30	6.68	172.49	0.86
2018/06/24 16:45	6.79	178.76	0.87
2018/06/24 17:00	6.84	180.77	0.87
2018/06/24 17:15	6.84	180.77	0.87
2018/06/24 17:30	6.84	180.63	0.87
2018/06/24 17:45	6.73	177.10	0.87
2018/06/24 18:00	6.73	176.97	0.87
2018/06/24 18:15	6.73	176.97	0.87
2018/06/24 18:30	6.79	180.98	0.88
2018/06/24 18:45	6.79	180.98	0.88
2018/06/24 19:00	6.79	178.90	0.87
2018/06/24 19:15	6.92	185.19	0.88
2018/06/24 19:30	6.96	188.36	0.89
2018/06/24 19:45	6.96	182.15	0.86
2018/06/24 20:00	6.96	182.15	0.86
2018/06/24 20:15	6.91	187.08	0.89
2018/06/24 20:30	6.91	183.00	0.87
2018/06/24 20:45	6.91	183.00	0.87
2018/06/24 21:00	6.97	184.92	0.87
2018/06/24 21:15	7.11	189.40	0.87
2018/06/24 21:30	7.11	189.40	0.87
2018/06/24 21:45	7.11	189.54	0.87
2018/06/24 22:00	7.05	185.99	0.86
2018/06/24 22:15	7.02	185.04	0.86
2018/06/24 22:30	6.80	179.55	0.87
2018/06/24 22:45	6.64	173.41	0.87
2018/06/24 23:00	6.64	167.74	0.84
2018/06/24 23:15	6.64	169.47	0.85
2018/06/24 23:30	6.64	169.47	0.85
2018/06/24 23:45	6.64	167.60	0.84
2018/06/25 00:00	6.34	145.67	0.77
2018/06/25 00:15	6.32	143.50	0.76
2018/06/25 00:30	6.17	137.44	0.75
2018/06/25 00:45	5.80	128.71	0.76
2018/06/25 01:00	5.64	111.97	0.69
2018/06/25 01:15	5.58	105.46	0.66
2018/06/25 01:30	5.46	92.99	0.60
2018/06/25 01:45	5.41	90.30	0.59
2018/06/25 02:00	5.41	90.30	0.59
2018/06/25 02:15	5.41	90.30	0.59
2018/06/25 02:30	5.41	90.30	0.59
2018/06/25 02:45	5.41	90.30	0.59
2018/06/25 03:00	5.21	88.91	0.61

TimeStamp	Level (in)	Flow (gpm)	Velocity (fps)
2018/06/25 03:15	5.14	79.68	0.55
2018/06/25 03:30	5.12	77.88	0.54
2018/06/25 03:45	5.11	77.68	0.54
2018/06/25 04:00	5.10	77.47	0.54
2018/06/25 04:15	5.10	74.59	0.52
2018/06/25 04:30	5.07	74.03	0.52
2018/06/25 04:45	5.06	73.83	0.52
2018/06/25 05:00	5.05	73.68	0.52
2018/06/25 05:15	5.05	73.68	0.52
2018/06/25 05:30	5.05	79.40	0.56
2018/06/25 05:45	5.20	86.87	0.59
2018/06/25 06:00	5.21	93.11	0.63
2018/06/25 06:15	5.39	97.34	0.63
2018/06/25 06:30	5.45	103.52	0.67
2018/06/25 06:45	5.49	114.33	0.73
2018/06/25 07:00	5.81	123.04	0.73
2018/06/25 07:15	5.97	127.64	0.73
2018/06/25 07:30	6.30	154.12	0.82
2018/06/25 07:45	6.65	168.10	0.84
2018/06/25 08:00	6.71	180.05	0.89
2018/06/25 08:15	7.14	194.04	0.89
2018/06/25 08:30	7.15	191.76	0.88
2018/06/25 08:45	7.19	202.06	0.92
2018/06/25 09:00	7.28	205.06	0.92
2018/06/25 09:15	7.29	196.24	0.88
2018/06/25 09:30	7.33	206.68	0.92
2018/06/25 09:45	7.49	229.38	0.99
2018/06/25 10:00	7.53	230.76	0.99
2018/06/25 10:15	7.53	228.55	0.98
2018/06/25 10:30	7.53	228.55	0.98
2018/06/25 10:45	7.56	215.32	0.92
2018/06/25 11:00	7.56	215.32	0.92
2018/06/25 11:15	7.44	211.28	0.92
2018/06/25 11:30	7.41	206.90	0.91
2018/06/25 11:45	7.41	206.90	0.91
2018/06/25 12:00	7.29	202.95	0.91
2018/06/25 12:15	7.23	200.97	0.91
2018/06/25 12:30	7.03	191.31	0.89
2018/06/25 12:45	6.92	187.38	0.89
2018/06/25 13:00	6.92	187.70	0.89
2018/06/25 13:15	6.92	187.38	0.89
2018/06/25 13:30	6.92	185.25	0.88
2018/06/25 13:45	6.92	184.84	0.88
2018/06/25 14:00	6.84	182.52	0.88
2018/06/25 14:15	6.84	180.80	0.87

TimeStamp	Level (in)	Flow (gpm)	Velocity (fps)
2018/06/25 14:30	6.76	178.22	0.87
2018/06/25 14:45	6.76	178.22	0.87
2018/06/25 15:00	6.73	176.56	0.87
2018/06/25 15:15	6.71	175.60	0.87
2018/06/25 15:30	6.71	175.60	0.87
2018/06/25 15:45	6.64	173.35	0.87
2018/06/25 16:00	6.59	167.63	0.85
2018/06/25 16:15	6.59	167.63	0.85
2018/06/25 16:30	6.49	160.08	0.82
2018/06/25 16:45	6.37	154.76	0.81
2018/06/25 17:00	6.37	154.76	0.81
2018/06/25 17:15	6.37	156.41	0.82
2018/06/25 17:30	6.40	159.66	0.84
2018/06/25 17:45	6.56	166.25	0.84
2018/06/25 18:00	6.70	173.39	0.86
2018/06/25 18:15	6.70	173.39	0.86
2018/06/25 18:30	6.58	165.25	0.84
2018/06/25 18:45	6.58	167.18	0.85
2018/06/25 19:00	6.58	167.18	0.85
2018/06/25 19:15	6.58	167.18	0.85
2018/06/25 19:30	6.84	184.84	0.89
2018/06/25 19:45	6.88	185.87	0.89
2018/06/25 20:00	6.94	188.18	0.89
2018/06/25 20:15	6.94	188.18	0.89
2018/06/25 20:30	6.94	189.92	0.90
2018/06/25 20:45	6.94	189.92	0.90
2018/06/25 21:00	6.96	190.90	0.90
2018/06/25 21:15	7.03	193.63	0.90
2018/06/25 21:30	7.05	194.29	0.90
2018/06/25 21:45	7.05	194.29	0.90
2018/06/25 22:00	7.05	196.32	0.91
2018/06/25 22:15	7.03	196.49	0.92
2018/06/25 22:30	6.96	193.31	0.91
2018/06/25 22:45	6.84	189.27	0.91
2018/06/25 23:00	6.84	182.44	0.88
2018/06/25 23:15	6.59	173.15	0.87
2018/06/25 23:30	6.48	168.14	0.87
2018/06/25 23:45	6.41	157.93	0.82
2018/06/26 00:00	6.37	156.55	0.82
2018/06/26 00:15	6.18	144.76	0.79
2018/06/26 00:30	6.02	136.26	0.77
2018/06/26 00:45	5.87	131.64	0.77
2018/06/26 01:00	5.75	117.89	0.71
2018/06/26 01:15	5.65	110.57	0.68
2018/06/26 01:30	5.53	107.25	0.68

TimeStamp	Level (in)	Flow (gpm)	Velocity (fps)
2018/06/26 01:45	5.53	107.25	0.68
2018/06/26 02:00	5.48	104.43	0.67
2018/06/26 02:15	5.30	101.20	0.67
2018/06/26 02:30	5.28	97.99	0.66
2018/06/26 02:45	5.21	87.24	0.59
2018/06/26 03:00	5.20	86.80	0.59
2018/06/26 03:15	5.10	96.02	0.67
2018/06/26 03:30	5.10	81.80	0.57
2018/06/26 03:45	5.06	79.47	0.56
2018/06/26 04:00	5.06	94.65	0.67
2018/06/26 04:15	5.06	82.24	0.58
2018/06/26 04:30	5.09	80.09	0.56
2018/06/26 04:45	5.09	81.61	0.57
2018/06/26 05:00	5.09	81.65	0.57
2018/06/26 05:15	5.12	80.75	0.56
2018/06/26 05:30	5.14	81.20	0.56
2018/06/26 05:45	5.21	84.19	0.57
2018/06/26 06:00	5.24	86.39	0.58
2018/06/26 06:15	5.27	94.38	0.63
2018/06/26 06:30	5.51	101.96	0.65
2018/06/26 06:45	5.53	108.72	0.69
2018/06/26 07:00	5.76	118.28	0.71
2018/06/26 07:15	5.97	131.14	0.75
2018/06/26 07:30	6.23	153.68	0.83
2018/06/26 07:45	6.59	175.60	0.89
2018/06/26 08:00	6.64	178.13	0.89
2018/06/26 08:15	6.80	189.70	0.92
2018/06/26 08:30	6.84	191.06	0.92
2018/06/26 08:45	7.33	204.51	0.91
2018/06/26 09:00	7.33	204.51	0.91
2018/06/26 09:15	7.33	201.92	0.90
2018/06/26 09:30	7.33	201.92	0.90
2018/06/26 09:45	7.33	204.51	0.91
2018/06/26 10:00	7.37	208.28	0.92
2018/06/26 10:15	7.37	208.28	0.92
2018/06/26 10:30	7.37	208.28	0.92
2018/06/26 10:45	7.36	202.27	0.89
2018/06/26 11:00	7.30	198.94	0.89
2018/06/26 11:15	7.23	196.23	0.88
2018/06/26 11:30	7.23	194.22	0.88
2018/06/26 11:45	7.22	189.24	0.85
2018/06/26 12:00	7.22	189.24	0.85
2018/06/26 12:15	7.00	182.35	0.85
2018/06/26 12:30	6.93	183.25	0.87
2018/06/26 12:45	6.87	181.28	0.87

TimeStamp	Level (in)	Flow (gpm)	Velocity (fps)
2018/06/26 13:00	6.86	180.96	0.87
2018/06/26 13:15	6.85	174.41	0.84
2018/06/26 13:30	6.85	174.41	0.84
2018/06/26 13:45	6.77	169.83	0.83
2018/06/26 14:00	6.77	168.94	0.82
2018/06/26 14:15	6.51	153.77	0.79
2018/06/26 14:30	6.49	154.38	0.79
2018/06/26 14:45	6.49	154.38	0.79
2018/06/26 15:00	6.48	154.09	0.79
2018/06/26 15:15	6.45	153.15	0.79
2018/06/26 15:30	6.42	152.50	0.80
2018/06/26 15:45	6.34	150.13	0.80
2018/06/26 16:00	6.28	146.31	0.78
2018/06/26 16:15	6.28	142.35	0.76
2018/06/26 16:30	6.34	144.05	0.76
2018/06/26 16:45	6.34	142.22	0.75
2018/06/26 17:00	6.30	140.92	0.75
2018/06/26 17:15	6.34	142.45	0.75
2018/06/26 17:30	6.30	143.09	0.76
2018/06/26 17:45	6.30	143.09	0.76
2018/06/26 18:00	6.36	144.56	0.76
2018/06/26 18:15	6.36	144.80	0.76
2018/06/26 18:30	6.38	145.13	0.76
2018/06/26 18:45	6.47	151.96	0.78
2018/06/26 19:00	6.47	154.37	0.80
2018/06/26 19:15	6.55	158.10	0.80
2018/06/26 19:30	6.60	161.99	0.82
2018/06/26 19:45	6.61	162.29	0.82
2018/06/26 20:00	6.86	181.33	0.87
2018/06/26 20:15	6.86	181.33	0.87
2018/06/26 20:30	7.07	192.74	0.89
2018/06/26 20:45	7.08	193.06	0.89
2018/06/26 21:00	7.07	192.74	0.89
2018/06/26 21:15	6.85	181.32	0.87
2018/06/26 21:30	6.92	187.38	0.89
2018/06/26 21:45	6.85	184.78	0.89
2018/06/26 22:00	6.85	185.08	0.89
2018/06/26 22:15	6.81	183.47	0.89
2018/06/26 22:30	6.81	183.47	0.89
2018/06/26 22:45	6.80	183.14	0.89
2018/06/26 23:00	6.70	175.36	0.87
2018/06/26 23:15	6.67	174.44	0.87
2018/06/26 23:30	6.59	171.82	0.87
2018/06/26 23:45	6.57	168.99	0.86
2018/06/27 00:00	6.43	162.55	0.85

TimeStamp	Level (in)	Flow (gpm)	Velocity (fps)
2018/06/27 00:15	6.41	150.07	0.78
2018/06/27 00:30	6.17	136.88	0.75
2018/06/27 00:45	6.06	128.68	0.72
2018/06/27 01:00	5.94	119.87	0.69
2018/06/27 01:15	5.80	114.38	0.68
2018/06/27 01:30	5.78	111.87	0.67
2018/06/27 01:45	5.57	106.67	0.67
2018/06/27 02:00	5.55	107.73	0.68
2018/06/27 02:15	5.53	105.68	0.67
2018/06/27 02:30	5.40	102.41	0.67
2018/06/27 02:45	5.33	92.97	0.61
2018/06/27 03:00	5.22	88.88	0.60
2018/06/27 03:15	5.10	86.06	0.60
2018/06/27 03:30	5.09	78.78	0.55
2018/06/27 03:45	5.10	77.43	0.54
2018/06/27 04:00	5.10	76.21	0.53
2018/06/27 04:15	5.10	76.05	0.53
2018/06/27 04:30	5.03	74.67	0.53
2018/06/27 04:45	5.04	76.23	0.54
2018/06/27 05:00	5.04	81.70	0.58
2018/06/27 05:15	5.04	90.25	0.64
2018/06/27 05:30	5.10	91.67	0.64
2018/06/27 05:45	5.23	96.27	0.65
2018/06/27 06:00	5.24	95.04	0.64
2018/06/27 06:15	5.24	93.94	0.64
2018/06/27 06:30	5.51	100.30	0.64
2018/06/27 06:45	5.53	103.53	0.65
2018/06/27 07:00	5.84	129.19	0.76
2018/06/27 07:15	6.22	144.32	0.78
2018/06/27 07:30	6.26	145.56	0.78
2018/06/27 07:45	6.58	159.53	0.81
2018/06/27 08:00	6.83	175.97	0.85
2018/06/27 08:15	7.23	188.39	0.85
2018/06/27 08:30	7.23	188.39	0.85
2018/06/27 08:45	7.23	198.83	0.90
2018/06/27 09:00	7.31	200.13	0.89
2018/06/27 09:15	7.31	199.23	0.89
2018/06/27 09:30	7.31	199.23	0.89
2018/06/27 09:45	7.35	201.43	0.89
2018/06/27 10:00	7.62	209.16	0.89
2018/06/27 10:15	7.45	202.02	0.88
2018/06/27 10:30	7.54	204.87	0.88
2018/06/27 10:45	7.54	204.87	0.88
2018/06/27 11:00	7.45	187.93	0.82
2018/06/27 11:15	7.45	191.51	0.83

TimeStamp	Level (in)	Flow (gpm)	Velocity (fps)
2018/06/27 11:30	7.29	186.67	0.83
2018/06/27 11:45	7.10	177.22	0.82
2018/06/27 12:00	6.98	176.93	0.83
2018/06/27 12:15	6.67	167.40	0.83
2018/06/27 12:30	6.66	163.65	0.82
2018/06/27 12:45	6.55	154.65	0.79
2018/06/27 13:00	6.53	159.67	0.82
2018/06/27 13:15	6.53	159.67	0.82
2018/06/27 13:30	6.53	159.67	0.82
2018/06/27 13:45	6.58	163.38	0.83
2018/06/27 14:00	6.58	163.38	0.83
2018/06/27 14:15	6.58	159.37	0.81
2018/06/27 14:30	6.40	147.79	0.77
2018/06/27 14:45	6.40	147.79	0.77
2018/06/27 15:00	6.40	147.79	0.77
2018/06/27 15:15	6.39	147.74	0.77
2018/06/27 15:30	6.39	149.25	0.78
2018/06/27 15:45	6.35	148.09	0.78
2018/06/27 16:00	6.25	143.63	0.77
2018/06/27 16:15	6.25	143.63	0.77
2018/06/27 16:30	6.25	143.73	0.77
2018/06/27 16:45	6.32	145.45	0.77
2018/06/27 17:00	6.40	147.75	0.77
2018/06/27 17:15	6.43	148.92	0.77
2018/06/27 17:30	6.43	148.98	0.77
2018/06/27 17:45	6.37	147.25	0.77
2018/06/27 18:00	6.43	152.72	0.79
2018/06/27 18:15	6.43	154.59	0.80
2018/06/27 18:30	6.72	172.95	0.85
2018/06/27 18:45	6.78	174.84	0.85
2018/06/27 19:00	6.79	175.20	0.85
2018/06/27 19:15	6.83	176.41	0.85
2018/06/27 19:30	6.79	174.74	0.85
2018/06/27 19:45	6.78	174.34	0.85
2018/06/27 20:00	6.67	161.86	0.80
2018/06/27 20:15	6.59	159.47	0.80
2018/06/27 20:30	6.59	159.47	0.80
2018/06/27 20:45	6.56	164.63	0.84
2018/06/27 21:00	6.56	164.82	0.84
2018/06/27 21:15	6.64	175.17	0.88
2018/06/27 21:30	6.73	179.51	0.88
2018/06/27 21:45	6.78	182.70	0.89
2018/06/27 22:00	6.78	182.70	0.89
2018/06/27 22:15	6.77	183.01	0.89
2018/06/27 22:30	6.85	183.42	0.88

TimeStamp	Level (in)	Flow (gpm)	Velocity (fps)
2018/06/27 22:45	6.77	180.49	0.88
2018/06/27 23:00	6.76	179.63	0.88
2018/06/27 23:15	6.57	170.93	0.87
2018/06/27 23:30	6.50	164.32	0.84
2018/06/27 23:45	6.40	155.39	0.81
2018/06/28 00:00	6.38	154.78	0.81
2018/06/28 00:15	6.36	154.18	0.81
2018/06/28 00:30	6.32	149.27	0.79
2018/06/28 00:45	6.10	134.99	0.75
2018/06/28 01:00	5.87	119.63	0.70
2018/06/28 01:15	5.75	113.05	0.68
2018/06/28 01:30	5.59	105.59	0.66
2018/06/28 01:45	5.41	96.38	0.62
2018/06/28 02:00	5.34	93.17	0.61
2018/06/28 02:15	5.27	90.02	0.60
2018/06/28 02:30	5.16	81.72	0.56
2018/06/28 02:45	5.14	79.90	0.55
2018/06/28 03:00	5.14	79.90	0.55
2018/06/28 03:15	5.05	78.06	0.55
2018/06/28 03:30	5.05	70.99	0.50
2018/06/28 03:45	4.95	68.85	0.50
2018/06/28 04:00	4.92	66.99	0.49
2018/06/28 04:15	4.92	66.99	0.49
2018/06/28 04:30	4.92	67.01	0.49
2018/06/28 04:45	4.97	67.91	0.49
2018/06/28 05:00	4.97	70.68	0.51
2018/06/28 05:15	4.97	70.68	0.51
2018/06/28 05:30	4.97	70.68	0.51
2018/06/28 05:45	4.99	72.41	0.52
2018/06/28 06:00	5.10	77.47	0.54
2018/06/28 06:15	5.26	88.20	0.59
2018/06/28 06:30	5.44	104.79	0.68
2018/06/28 06:45	5.51	108.66	0.69
2018/06/28 07:00	5.81	119.05	0.70
2018/06/28 07:15	5.87	121.20	0.71
2018/06/28 07:30	6.08	128.98	0.72
2018/06/28 07:45	6.73	170.58	0.84
2018/06/28 08:00	6.77	172.46	0.84
2018/06/28 08:15	6.83	175.87	0.85
2018/06/28 08:30	6.98	185.02	0.87
2018/06/28 08:45	7.37	197.36	0.87
2018/06/28 09:00	7.41	205.08	0.90
2018/06/28 09:15	7.45	206.38	0.90
2018/06/28 09:30	7.45	209.44	0.91
2018/06/28 09:45	7.57	213.28	0.91

TimeStamp	Level (in)	Flow (gpm)	Velocity (fps)
2018/06/28 10:00	7.57	213.28	0.91
2018/06/28 10:15	7.57	203.23	0.87
2018/06/28 10:30	7.57	203.23	0.87
2018/06/28 10:45	7.57	201.15	0.86
2018/06/28 11:00	7.48	198.63	0.86
2018/06/28 11:15	7.48	190.63	0.83
2018/06/28 11:30	7.41	188.79	0.83
2018/06/28 11:45	7.36	189.77	0.84
2018/06/28 12:00	7.23	193.55	0.87
2018/06/28 12:15	7.23	191.45	0.86
2018/06/28 12:30	7.05	187.81	0.87
2018/06/28 12:45	7.00	186.21	0.87
2018/06/28 13:00	6.94	182.28	0.86
2018/06/28 13:15	6.93	181.96	0.86
2018/06/28 13:30	6.80	176.85	0.86
2018/06/28 13:45	6.72	172.51	0.85
2018/06/28 14:00	6.71	172.20	0.85
2018/06/28 14:15	6.71	172.20	0.85
2018/06/28 14:30	6.68	166.96	0.83
2018/06/28 14:45	6.68	166.96	0.83
2018/06/28 15:00	6.66	166.34	0.83
2018/06/28 15:15	6.63	163.17	0.82
2018/06/28 15:30	6.61	162.13	0.81
2018/06/28 15:45	6.51	159.49	0.82
2018/06/28 16:00	6.51	159.49	0.82
2018/06/28 16:15	6.51	165.46	0.85
2018/06/28 16:30	6.61	168.61	0.85
2018/06/28 16:45	6.61	168.61	0.85
2018/06/28 17:00	6.61	164.52	0.83
2018/06/28 17:15	6.58	161.54	0.82
2018/06/28 17:30	6.58	161.54	0.82
2018/06/28 17:45	6.58	161.54	0.82
2018/06/28 18:00	6.58	161.54	0.82
2018/06/28 18:15	6.54	160.33	0.82
2018/06/28 18:30	6.51	157.27	0.80
2018/06/28 18:45	6.51	157.27	0.80
2018/06/28 19:00	6.50	155.08	0.79
2018/06/28 19:15	6.51	157.27	0.80
2018/06/28 19:30	6.59	165.91	0.84
2018/06/28 19:45	6.59	165.91	0.84
2018/06/28 20:00	6.59	160.12	0.81
2018/06/28 20:15	6.68	168.70	0.84
2018/06/28 20:30	6.80	173.14	0.84
2018/06/28 20:45	6.88	175.62	0.84
2018/06/28 21:00	6.95	182.26	0.86

TimeStamp	Level (in)	Flow (gpm)	Velocity (fps)
2018/06/28 21:15	6.95	182.26	0.86
2018/06/28 21:30	6.95	182.26	0.86
2018/06/28 21:45	6.91	181.00	0.86
2018/06/28 22:00	6.91	181.00	0.86
2018/06/28 22:15	6.89	180.25	0.86
2018/06/28 22:30	6.89	182.32	0.87
2018/06/28 22:45	6.80	183.04	0.89
2018/06/28 23:00	6.76	181.78	0.89
2018/06/28 23:15	6.70	167.69	0.83
2018/06/28 23:30	6.56	160.89	0.82
2018/06/28 23:45	6.29	146.21	0.78
2018/06/29 00:00	6.16	138.85	0.76
2018/06/29 00:15	6.15	136.70	0.75
2018/06/29 00:30	6.07	136.02	0.76
2018/06/29 00:45	6.03	127.55	0.72
2018/06/29 01:00	5.88	123.52	0.72
2018/06/29 01:15	5.84	121.92	0.72
2018/06/29 01:30	5.82	124.83	0.74
2018/06/29 01:45	5.71	118.49	0.72
2018/06/29 02:00	5.66	117.16	0.72
2018/06/29 02:15	5.43	88.90	0.57
2018/06/29 02:30	5.21	82.83	0.56
2018/06/29 02:45	5.21	82.83	0.56
2018/06/29 03:00	5.21	84.27	0.57
2018/06/29 03:15	5.28	85.89	0.57
2018/06/29 03:30	5.28	94.79	0.63
2018/06/29 03:45	5.28	94.79	0.63
2018/06/29 04:00	5.22	84.44	0.57
2018/06/29 04:15	5.12	80.73	0.56
2018/06/29 04:30	5.12	80.73	0.56
2018/06/29 04:45	5.12	79.31	0.55
2018/06/29 05:00	5.12	79.31	0.55
2018/06/29 05:15	5.19	85.18	0.58
2018/06/29 05:30	5.20	85.37	0.58
2018/06/29 05:45	5.30	92.19	0.61
2018/06/29 06:00	5.34	93.10	0.61
2018/06/29 06:15	5.35	93.34	0.61
2018/06/29 06:30	5.35	94.78	0.62
2018/06/29 06:45	5.47	102.43	0.66
2018/06/29 07:00	5.87	119.62	0.70
2018/06/29 07:15	5.89	123.59	0.72
2018/06/29 07:30	6.18	140.99	0.77
2018/06/29 07:45	6.65	171.95	0.86
2018/06/29 08:00	6.94	182.40	0.86
2018/06/29 08:15	7.12	188.11	0.86

TimeStamp	Level (in)	Flow (gpm)	Velocity (fps)
2018/06/29 08:30	7.14	188.74	0.86
2018/06/29 08:45	7.20	189.39	0.86
2018/06/29 09:00	7.22	189.97	0.86
2018/06/29 09:15	7.29	192.11	0.86
2018/06/29 09:30	7.45	201.07	0.87
2018/06/29 09:45	7.45	201.07	0.87
2018/06/29 10:00	7.48	201.92	0.87
2018/06/29 10:15	7.57	207.37	0.89
2018/06/29 10:30	7.57	205.70	0.88
2018/06/29 10:45	7.50	199.09	0.86
2018/06/29 11:00	7.48	195.70	0.85
2018/06/29 11:15	7.36	199.30	0.88
2018/06/29 11:30	7.36	199.30	0.88
2018/06/29 11:45	7.32	192.34	0.85
2018/06/29 12:00	7.29	191.41	0.85
2018/06/29 12:15	7.32	200.18	0.89
2018/06/29 12:30	7.38	194.15	0.85
2018/06/29 12:45	7.21	185.67	0.84
2018/06/29 13:00	7.21	185.18	0.84
2018/06/29 13:15	6.91	176.68	0.84
2018/06/29 13:30	6.85	174.36	0.84
2018/06/29 13:45	6.85	174.82	0.84
2018/06/29 14:00	6.83	173.69	0.84
2018/06/29 14:15	6.83	167.37	0.81
2018/06/29 14:30	6.71	163.83	0.81
2018/06/29 14:45	6.53	156.01	0.80
2018/06/29 15:00	6.53	156.01	0.80
2018/06/29 15:15	6.53	159.74	0.81
2018/06/29 15:30	6.50	158.83	0.81
2018/06/29 15:45	6.50	155.06	0.79
2018/06/29 16:00	6.35	166.33	0.88
2018/06/29 16:15	6.35	150.32	0.79
2018/06/29 16:30	6.33	147.78	0.78
2018/06/29 16:45	6.33	149.68	0.79
2018/06/29 17:00	6.33	144.05	0.76
2018/06/29 17:15	6.38	145.47	0.76
2018/06/29 17:30	6.41	156.01	0.81
2018/06/29 17:45	6.41	156.01	0.81
2018/06/29 18:00	6.38	145.47	0.76
2018/06/29 18:15	6.49	158.79	0.82
2018/06/29 18:30	6.49	158.79	0.82
2018/06/29 18:45	6.45	151.49	0.78
2018/06/29 19:00	6.52	159.70	0.82
2018/06/29 19:15	6.56	162.87	0.83
2018/06/29 19:30	6.54	162.26	0.83

TimeStamp	Level (in)	Flow (gpm)	Velocity (fps)
2018/06/29 19:45	6.56	162.87	0.83
2018/06/29 20:00	6.61	164.61	0.83
2018/06/29 20:15	6.65	171.81	0.86
2018/06/29 20:30	6.70	173.45	0.86
2018/06/29 20:45	6.73	174.40	0.86
2018/06/29 21:00	6.73	172.98	0.85
2018/06/29 21:15	6.70	171.58	0.85
2018/06/29 21:30	6.68	170.67	0.85
2018/06/29 21:45	6.68	170.67	0.85
2018/06/29 22:00	6.68	170.67	0.85
2018/06/29 22:15	6.62	165.01	0.83
2018/06/29 22:30	6.62	168.52	0.85
2018/06/29 22:45	6.62	172.65	0.87
2018/06/29 23:00	6.61	172.60	0.87
2018/06/29 23:15	6.58	171.64	0.87
2018/06/29 23:30	6.56	170.99	0.87
2018/06/29 23:45	6.41	154.14	0.80
2018/06/30 00:00	6.38	147.44	0.77
2018/06/30 00:15	6.22	142.52	0.77
2018/06/30 00:30	6.05	133.46	0.75
2018/06/30 00:45	5.83	120.17	0.71
2018/06/30 01:00	5.83	120.03	0.71
2018/06/30 01:15	5.80	119.29	0.71
2018/06/30 01:30	5.74	117.80	0.71
2018/06/30 01:45	5.69	116.53	0.71
2018/06/30 02:00	5.67	115.91	0.71
2018/06/30 02:15	5.61	111.04	0.69
2018/06/30 02:30	5.50	107.97	0.69
2018/06/30 02:45	5.37	96.96	0.63
2018/06/30 03:00	5.25	91.06	0.61
2018/06/30 03:15	5.11	84.88	0.59
2018/06/30 03:30	5.10	79.03	0.55
2018/06/30 03:45	5.00	76.82	0.55
2018/06/30 04:00	5.00	73.96	0.53
2018/06/30 04:15	5.00	73.96	0.53
2018/06/30 04:30	5.00	72.59	0.52
2018/06/30 04:45	5.00	76.66	0.55
2018/06/30 05:00	4.97	72.05	0.52
2018/06/30 05:15	4.97	72.05	0.52
2018/06/30 05:30	4.97	72.04	0.52
2018/06/30 05:45	4.97	72.04	0.52
2018/06/30 06:00	4.99	72.43	0.52
2018/06/30 06:15	5.09	78.71	0.55
2018/06/30 06:30	5.13	82.32	0.57
2018/06/30 06:45	5.14	82.68	0.57

TimeStamp	Level (in)	Flow (gpm)	Velocity (fps)
2018/06/30 07:00	5.19	85.13	0.58
2018/06/30 07:15	5.30	89.17	0.59
2018/06/30 07:30	5.37	102.90	0.67
2018/06/30 07:45	5.71	120.13	0.73
2018/06/30 08:00	5.88	125.00	0.73
2018/06/30 08:15	5.91	131.04	0.76
2018/06/30 08:30	6.31	167.86	0.89
2018/06/30 08:45	6.79	187.25	0.91
2018/06/30 09:00	6.85	191.20	0.92
2018/06/30 09:15	6.99	200.79	0.94
2018/06/30 09:30	7.42	231.06	1.01
2018/06/30 09:45	7.51	234.29	1.01
2018/06/30 10:00	7.58	236.84	1.01
2018/06/30 10:15	7.59	225.87	0.96
2018/06/30 10:30	7.59	225.87	0.96
2018/06/30 10:45	7.90	233.07	0.95
2018/06/30 11:00	8.24	248.23	0.96
2018/06/30 11:15	8.24	244.33	0.95
2018/06/30 11:30	8.24	238.75	0.92
2018/06/30 11:45	7.93	195.87	0.79
2018/06/30 12:00	7.89	194.71	0.79
2018/06/30 12:15	7.89	194.71	0.79
2018/06/30 12:30	7.89	229.78	0.93
2018/06/30 12:45	7.85	228.62	0.94
2018/06/30 13:00	7.85	228.62	0.94
2018/06/30 13:15	7.85	228.62	0.94
2018/06/30 13:30	7.80	219.28	0.90
2018/06/30 13:45	7.42	203.76	0.89
2018/06/30 14:00	7.15	194.47	0.89
2018/06/30 14:15	7.15	194.47	0.89
2018/06/30 14:30	7.08	192.08	0.89
2018/06/30 14:45	6.87	185.85	0.89
2018/06/30 15:00	6.80	182.88	0.89
2018/06/30 15:15	6.80	185.52	0.90
2018/06/30 15:30	6.80	185.52	0.90
2018/06/30 15:45	6.80	185.52	0.90
2018/06/30 16:00	6.78	172.19	0.84
2018/06/30 16:15	6.78	173.91	0.85
2018/06/30 16:30	6.66	168.02	0.84
2018/06/30 16:45	6.66	168.02	0.84
2018/06/30 17:00	6.66	170.09	0.85
2018/06/30 17:15	6.66	170.09	0.85
2018/06/30 17:30	6.66	169.66	0.84
2018/06/30 17:45	6.54	166.44	0.85
2018/06/30 18:00	6.54	166.44	0.85

TimeStamp	Level (in)	Flow (gpm)	Velocity (fps)
2018/06/30 18:15	6.54	168.09	0.86
2018/06/30 18:30	6.77	175.44	0.86
2018/06/30 18:45	6.77	175.44	0.86
2018/06/30 19:00	6.77	173.38	0.85
2018/06/30 19:15	6.77	173.38	0.85
2018/06/30 19:30	6.77	173.38	0.85
2018/06/30 19:45	6.76	175.68	0.86
2018/06/30 20:00	6.76	175.68	0.86
2018/06/30 20:15	6.76	175.68	0.86
2018/06/30 20:30	6.76	175.68	0.86
2018/06/30 20:45	6.76	175.68	0.86
2018/06/30 21:00	6.75	175.39	0.86
2018/06/30 21:15	6.75	175.39	0.86
2018/06/30 21:30	6.53	168.41	0.86
2018/06/30 21:45	6.53	168.41	0.86
2018/06/30 22:00	6.53	169.84	0.87
2018/06/30 22:15	6.95	192.99	0.91
2018/06/30 22:30	6.95	192.99	0.91
2018/06/30 22:45	6.95	192.99	0.91
2018/06/30 23:00	6.76	173.61	0.85
2018/06/30 23:15	6.45	163.14	0.84
2018/06/30 23:30	6.45	163.14	0.84
2018/06/30 23:45	6.45	163.14	0.84
2018/07/01 00:00	6.45	163.14	0.84
2018/07/01 00:15	6.45	163.14	0.84
2018/07/01 00:30	6.25	145.25	0.78
2018/07/01 00:45	5.96	136.79	0.78
2018/07/01 01:00	5.89	127.09	0.74
2018/07/01 01:15	5.86	124.59	0.73
2018/07/01 01:30	5.81	121.43	0.72
2018/07/01 01:45	5.60	112.17	0.70
2018/07/01 02:00	5.57	109.76	0.69
2018/07/01 02:15	5.44	98.45	0.63
2018/07/01 02:30	5.35	94.98	0.63
2018/07/01 02:45	5.22	88.68	0.60
2018/07/01 03:00	5.12	86.50	0.60
2018/07/01 03:15	5.12	86.50	0.60
2018/07/01 03:30	5.03	84.50	0.60
2018/07/01 03:45	5.02	84.28	0.60
2018/07/01 04:00	4.98	76.41	0.55
2018/07/01 04:15	4.97	76.21	0.55
2018/07/01 04:30	4.95	74.44	0.54
2018/07/01 04:45	4.97	74.87	0.54
2018/07/01 05:00	4.98	75.04	0.54
2018/07/01 05:15	4.97	73.49	0.53

TimeStamp	Level (in)	Flow (gpm)	Velocity (fps)
2018/07/01 05:30	4.99	73.88	0.53
2018/07/01 05:45	5.04	77.77	0.55
2018/07/01 06:00	4.99	73.88	0.53
2018/07/01 06:15	4.99	76.76	0.55
2018/07/01 06:30	5.03	87.15	0.62
2018/07/01 06:45	5.08	88.48	0.62
2018/07/01 07:00	5.15	89.95	0.62
2018/07/01 07:15	5.19	91.03	0.62
2018/07/01 07:30	5.31	94.03	0.62
2018/07/01 07:45	5.49	109.31	0.69
2018/07/01 08:00	5.97	131.44	0.75
2018/07/01 08:15	6.09	140.35	0.78
2018/07/01 08:30	6.15	145.34	0.80
2018/07/01 08:45	6.18	146.58	0.80
2018/07/01 09:00	6.43	158.48	0.82
2018/07/01 09:15	6.73	184.79	0.91
2018/07/01 09:30	7.11	203.25	0.94
2018/07/01 09:45	7.19	205.98	0.94
2018/07/01 10:00	7.20	206.33	0.94
2018/07/01 10:15	7.21	206.96	0.94
2018/07/01 10:30	7.38	212.74	0.94
2018/07/01 10:45	7.76	231.57	0.96
2018/07/01 11:00	8.01	240.01	0.96
2018/07/01 11:15	8.08	247.68	0.98
2018/07/01 11:30	8.10	243.09	0.96
2018/07/01 11:45	8.21	246.39	0.96
2018/07/01 12:00	8.30	245.57	0.94
2018/07/01 12:15	8.30	239.99	0.92
2018/07/01 12:30	8.21	233.54	0.91
2018/07/01 12:45	8.10	230.06	0.91
2018/07/01 13:00	7.96	225.60	0.91
2018/07/01 13:15	7.83	217.82	0.89
2018/07/01 13:30	7.38	191.57	0.84
2018/07/01 13:45	7.26	188.38	0.84
2018/07/01 14:00	7.16	185.34	0.84
2018/07/01 14:15	7.11	187.73	0.86
2018/07/01 14:30	7.08	182.82	0.84
2018/07/01 14:45	6.99	182.96	0.86
2018/07/01 15:00	6.84	178.36	0.86
2018/07/01 15:15	6.84	178.15	0.86
2018/07/01 15:30	6.84	178.15	0.86
2018/07/01 15:45	6.87	179.32	0.86
2018/07/01 16:00	6.87	179.32	0.86
2018/07/01 16:15	6.87	179.11	0.86
2018/07/01 16:30	6.88	182.05	0.87

TimeStamp	Level (in)	Flow (gpm)	Velocity (fps)
2018/07/01 16:45	6.81	179.80	0.87
2018/07/01 17:00	6.79	176.59	0.86
2018/07/01 17:15	6.79	176.59	0.86
2018/07/01 17:30	6.81	177.54	0.86
2018/07/01 17:45	6.81	177.54	0.86
2018/07/01 18:00	6.91	180.72	0.86
2018/07/01 18:15	7.03	191.86	0.89
2018/07/01 18:30	7.13	195.14	0.89
2018/07/01 18:45	7.13	195.14	0.89
2018/07/01 19:00	7.13	192.53	0.88
2018/07/01 19:15	7.11	186.02	0.86
2018/07/01 19:30	7.10	185.71	0.86
2018/07/01 19:45	7.10	191.61	0.88
2018/07/01 20:00	7.09	194.10	0.90
2018/07/01 20:15	7.09	194.10	0.90
2018/07/01 20:30	7.09	194.10	0.90
2018/07/01 20:45	7.09	189.15	0.87
2018/07/01 21:00	7.09	189.15	0.87
2018/07/01 21:15	7.10	189.42	0.87
2018/07/01 21:30	7.11	187.70	0.86
2018/07/01 21:45	7.15	189.41	0.86
2018/07/01 22:00	7.25	194.41	0.87
2018/07/01 22:15	7.25	192.57	0.86
2018/07/01 22:30	7.25	190.56	0.86
2018/07/01 22:45	7.25	190.56	0.86
2018/07/01 23:00	7.10	182.98	0.84
2018/07/01 23:15	6.65	165.51	0.83
2018/07/01 23:30	6.56	153.14	0.78
2018/07/01 23:45	6.56	153.01	0.78
2018/07/02 00:00	6.54	152.30	0.78
2018/07/02 00:15	6.54	151.93	0.77
2018/07/02 00:30	6.53	151.64	0.77
2018/07/02 00:45	6.35	146.46	0.77
2018/07/02 01:00	6.03	126.01	0.71
2018/07/02 01:15	6.02	120.42	0.68
2018/07/02 01:30	5.80	114.84	0.68
2018/07/02 01:45	5.72	110.84	0.67
2018/07/02 02:00	5.62	106.36	0.66
2018/07/02 02:15	5.61	104.62	0.65
2018/07/02 02:30	5.54	104.17	0.66
2018/07/02 02:45	5.50	101.73	0.65
2018/07/02 03:00	5.44	97.06	0.63
2018/07/02 03:15	5.37	90.73	0.59
2018/07/02 03:30	5.32	88.12	0.58
2018/07/02 03:45	5.32	88.12	0.58

TimeStamp	Level (in)	Flow (gpm)	Velocity (fps)
2018/07/02 04:00	5.32	88.12	0.58
2018/07/02 04:15	5.36	88.96	0.58
2018/07/02 04:30	5.36	87.53	0.57
2018/07/02 04:45	5.36	86.02	0.56
2018/07/02 05:00	5.31	84.97	0.56
2018/07/02 05:15	5.31	86.46	0.57
2018/07/02 05:30	5.31	86.51	0.58
2018/07/02 05:45	5.40	90.02	0.59
2018/07/02 06:00	5.43	96.89	0.63
2018/07/02 06:15	5.48	98.05	0.63
2018/07/02 06:30	5.68	106.30	0.65
2018/07/02 06:45	5.73	109.09	0.66
2018/07/02 07:00	5.89	123.61	0.72
2018/07/02 07:15	6.12	135.59	0.75
2018/07/02 07:30	6.23	142.57	0.77
2018/07/02 07:45	6.80	171.11	0.83
2018/07/02 08:00	6.86	176.96	0.85
2018/07/02 08:15	6.88	177.74	0.85
2018/07/02 08:30	7.14	185.86	0.85
2018/07/02 08:45	7.34	192.06	0.85
2018/07/02 09:00	7.41	201.31	0.88
2018/07/02 09:15	7.55	200.65	0.86
2018/07/02 09:30	7.55	197.80	0.85
2018/07/02 09:45	7.55	190.43	0.82
2018/07/02 10:00	7.55	200.65	0.86
2018/07/02 10:15	7.53	196.83	0.85
2018/07/02 10:30	7.47	195.00	0.85
2018/07/02 10:45	7.43	199.16	0.87
2018/07/02 11:00	7.43	201.40	0.88
2018/07/02 11:15	7.43	203.57	0.89
2018/07/02 11:30	7.43	203.57	0.89
2018/07/02 11:45	7.43	203.57	0.89
2018/07/02 12:00	7.43	203.50	0.89
2018/07/02 12:15	7.23	197.11	0.89
2018/07/02 12:30	7.22	196.66	0.89
2018/07/02 12:45	6.99	187.79	0.88
2018/07/02 13:00	6.97	184.58	0.87
2018/07/02 13:15	6.90	182.33	0.87
2018/07/02 13:30	6.82	171.18	0.83
2018/07/02 13:45	6.82	171.18	0.83
2018/07/02 14:00	6.82	175.66	0.85
2018/07/02 14:15	6.77	169.70	0.83
2018/07/02 14:30	6.77	169.70	0.83
2018/07/02 14:45	6.77	174.04	0.85
2018/07/02 15:00	6.70	169.40	0.84

TimeStamp	Level (in)	Flow (gpm)	Velocity (fps)
2018/07/02 15:15	6.70	167.55	0.83
2018/07/02 15:30	6.70	163.16	0.81
2018/07/02 15:45	6.70	161.37	0.80
2018/07/02 16:00	6.69	161.08	0.80
2018/07/02 16:15	6.73	162.26	0.80
2018/07/02 16:30	6.63	161.27	0.81
2018/07/02 16:45	6.62	160.97	0.81
2018/07/02 17:00	6.63	162.76	0.81
2018/07/02 17:15	6.55	158.87	0.81
2018/07/02 17:30	6.50	156.97	0.81
2018/07/02 17:45	6.38	146.92	0.77
2018/07/02 18:00	6.33	141.90	0.75
2018/07/02 18:15	6.33	141.90	0.75
2018/07/02 18:30	6.32	141.62	0.75
2018/07/02 18:45	6.33	141.90	0.75
2018/07/02 19:00	6.41	146.23	0.76
2018/07/02 19:15	6.41	148.15	0.77
2018/07/02 19:30	6.70	165.55	0.82
2018/07/02 19:45	6.81	172.83	0.84
2018/07/02 20:00	6.95	177.15	0.84
2018/07/02 20:15	6.95	177.81	0.84
2018/07/02 20:30	6.95	177.81	0.84
2018/07/02 20:45	6.95	177.91	0.84
2018/07/02 21:00	6.95	180.01	0.85
2018/07/02 21:15	7.04	190.42	0.89
2018/07/02 21:30	7.04	190.42	0.89
2018/07/02 21:45	7.04	190.42	0.89
2018/07/02 22:00	6.87	170.95	0.82
2018/07/02 22:15	6.80	167.99	0.82
2018/07/02 22:30	6.72	163.99	0.81
2018/07/02 22:45	6.59	159.81	0.81
2018/07/02 23:00	6.52	157.71	0.81
2018/07/02 23:15	6.52	151.65	0.77
2018/07/02 23:30	6.41	148.48	0.77
2018/07/02 23:45	6.30	145.30	0.77
2018/07/03 00:00	6.24	143.14	0.77
2018/07/03 00:15	6.15	125.69	0.69
2018/07/03 00:30	5.95	120.08	0.69
2018/07/03 00:45	5.88	114.99	0.67
2018/07/03 01:00	5.86	109.27	0.64
2018/07/03 01:15	5.78	105.55	0.63
2018/07/03 01:30	5.68	101.44	0.62
2018/07/03 01:45	5.62	98.37	0.61
2018/07/03 02:00	5.47	94.58	0.61
2018/07/03 02:15	5.44	92.40	0.60

TimeStamp	Level (in)	Flow (gpm)	Velocity (fps)
2018/07/03 02:30	5.43	87.43	0.56
2018/07/03 02:45	5.35	85.76	0.56
2018/07/03 03:00	5.13	72.34	0.50
2018/07/03 03:15	5.06	71.04	0.50
2018/07/03 03:30	5.06	66.92	0.47
2018/07/03 03:45	5.04	66.53	0.47
2018/07/03 04:00	5.04	65.08	0.46
2018/07/03 04:15	5.02	66.12	0.47
2018/07/03 04:30	5.01	64.60	0.46
2018/07/03 04:45	5.02	66.12	0.47
2018/07/03 05:00	5.02	66.12	0.47
2018/07/03 05:15	5.05	66.71	0.47
2018/07/03 05:30	5.11	72.05	0.50
2018/07/03 05:45	5.32	77.82	0.52
2018/07/03 06:00	5.40	80.75	0.53
2018/07/03 06:15	5.44	83.16	0.54
2018/07/03 06:30	5.51	89.49	0.57
2018/07/03 06:45	5.52	95.87	0.61
2018/07/03 07:00	5.61	98.19	0.61
2018/07/03 07:15	5.71	100.45	0.61
2018/07/03 07:30	5.98	122.71	0.70
2018/07/03 07:45	6.42	148.41	0.77
2018/07/03 08:00	6.47	149.85	0.77
2018/07/03 08:15	6.53	161.01	0.82
2018/07/03 08:30	6.79	169.23	0.82
2018/07/03 08:45	7.04	176.76	0.82
2018/07/03 09:00	7.06	175.19	0.81
2018/07/03 09:15	7.07	177.66	0.82
2018/07/03 09:30	7.07	184.12	0.85
2018/07/03 09:45	7.27	191.90	0.86
2018/07/03 10:00	7.27	191.90	0.86
2018/07/03 10:15	7.27	191.90	0.86
2018/07/03 10:30	7.46	197.73	0.86
2018/07/03 10:45	7.35	194.30	0.86
2018/07/03 11:00	7.35	200.96	0.89
2018/07/03 11:15	7.46	204.50	0.89
2018/07/03 11:30	7.46	204.50	0.89
2018/07/03 11:45	7.44	196.77	0.86
2018/07/03 12:00	7.44	196.22	0.85
2018/07/03 12:15	7.27	190.94	0.85
2018/07/03 12:30	7.26	190.62	0.85
2018/07/03 12:45	7.24	187.65	0.84
2018/07/03 13:00	7.22	184.03	0.83
2018/07/03 13:15	6.98	176.72	0.83
2018/07/03 13:30	6.65	165.66	0.83

TimeStamp	Level (in)	Flow (gpm)	Velocity (fps)
2018/07/03 13:45	6.63	163.10	0.82
2018/07/03 14:00	6.63	163.10	0.82
2018/07/03 14:15	6.62	164.74	0.83
2018/07/03 14:30	6.63	165.07	0.83
2018/07/03 14:45	6.63	165.07	0.83
2018/07/03 15:00	6.73	168.13	0.83
2018/07/03 15:15	6.73	164.77	0.81
2018/07/03 15:30	6.73	164.27	0.81
2018/07/03 15:45	6.53	158.22	0.81
2018/07/03 16:00	6.53	153.94	0.79
2018/07/03 16:15	6.49	150.62	0.77
2018/07/03 16:30	6.53	151.98	0.78
2018/07/03 16:45	6.58	155.40	0.79
2018/07/03 17:00	6.58	153.43	0.78
2018/07/03 17:15	6.51	149.27	0.76
2018/07/03 17:30	6.59	153.71	0.78
2018/07/03 17:45	6.70	159.16	0.79
2018/07/03 18:00	6.71	165.64	0.82
2018/07/03 18:15	6.72	165.94	0.82
2018/07/03 18:30	6.72	165.94	0.82
2018/07/03 18:45	6.71	163.66	0.81
2018/07/03 19:00	6.64	159.35	0.80
2018/07/03 19:15	6.57	155.08	0.79
2018/07/03 19:30	6.56	154.78	0.79
2018/07/03 19:45	6.56	154.78	0.79
2018/07/03 20:00	6.56	154.78	0.79
2018/07/03 20:15	6.66	160.03	0.80
2018/07/03 20:30	6.66	166.35	0.83
2018/07/03 20:45	6.66	166.35	0.83
2018/07/03 21:00	6.65	161.46	0.81
2018/07/03 21:15	6.56	157.08	0.80
2018/07/03 21:30	6.53	155.97	0.80
2018/07/03 21:45	6.51	155.33	0.80
2018/07/03 22:00	6.51	154.97	0.79
2018/07/03 22:15	6.56	156.86	0.80
2018/07/03 22:30	6.58	161.27	0.82
2018/07/03 22:45	6.58	161.27	0.82
2018/07/03 23:00	6.58	159.28	0.80
2018/07/03 23:15	6.56	158.68	0.80
2018/07/03 23:30	6.51	155.33	0.80
2018/07/03 23:45	6.47	154.14	0.80
2018/07/04 00:00	6.34	151.37	0.80
2018/07/04 00:15	6.32	147.62	0.78
2018/07/04 00:30	6.16	140.47	0.77
2018/07/04 00:45	6.15	140.23	0.77

TimeStamp	Level (in)	Flow (gpm)	Velocity (fps)
2018/07/04 01:00	6.13	139.60	0.77
2018/07/04 01:15	5.88	123.35	0.72
2018/07/04 01:30	5.81	116.93	0.69
2018/07/04 01:45	5.72	112.55	0.68
2018/07/04 02:00	5.72	112.28	0.68
2018/07/04 02:15	5.69	111.52	0.68
2018/07/04 02:30	5.51	102.11	0.65
2018/07/04 02:45	5.31	85.09	0.57
2018/07/04 03:00	5.20	82.83	0.57
2018/07/04 03:15	5.08	78.63	0.55
2018/07/04 03:30	5.08	78.60	0.55
2018/07/04 03:45	5.04	68.01	0.48
2018/07/04 04:00	5.03	66.38	0.47
2018/07/04 04:15	5.00	65.86	0.47
2018/07/04 04:30	5.00	65.86	0.47
2018/07/04 04:45	5.00	64.53	0.46
2018/07/04 05:00	5.00	64.53	0.46
2018/07/04 05:15	5.00	64.53	0.46
2018/07/04 05:30	5.03	66.29	0.47
2018/07/04 05:45	5.03	64.94	0.46
2018/07/04 06:00	4.98	65.42	0.47
2018/07/04 06:15	4.98	65.42	0.47
2018/07/04 06:30	4.98	64.02	0.46
2018/07/04 06:45	4.98	64.02	0.46
2018/07/04 07:00	4.98	66.88	0.48
2018/07/04 07:15	5.13	69.55	0.48
2018/07/04 07:30	5.37	90.94	0.59
2018/07/04 07:45	5.78	113.94	0.68
2018/07/04 08:00	6.02	129.28	0.73
2018/07/04 08:15	6.24	141.28	0.76
2018/07/04 08:30	6.27	145.81	0.78
2018/07/04 08:45	6.47	159.85	0.82
2018/07/04 09:00	6.58	165.64	0.84
2018/07/04 09:15	6.68	177.17	0.88
2018/07/04 09:30	7.47	233.37	1.01
2018/07/04 09:45	7.60	228.95	0.97
2018/07/04 10:00	7.72	223.81	0.93
2018/07/04 10:15	7.70	226.07	0.95
2018/07/04 10:30	7.73	224.14	0.93
2018/07/04 10:45	7.88	225.52	0.92
2018/07/04 11:00	8.09	232.31	0.92
2018/07/04 11:15	8.21	236.15	0.92
2018/07/04 11:30	8.26	234.05	0.90
2018/07/04 11:45	8.33	235.66	0.90
2018/07/04 12:00	8.26	233.16	0.90

TimeStamp	Level (in)	Flow (gpm)	Velocity (fps)
2018/07/04 12:15	8.26	217.64	0.84
2018/07/04 12:30	8.09	212.63	0.84
2018/07/04 12:45	7.76	202.82	0.84
2018/07/04 13:00	7.76	203.62	0.84
2018/07/04 13:15	7.76	203.62	0.84
2018/07/04 13:30	7.75	203.22	0.84
2018/07/04 13:45	7.84	205.47	0.84
2018/07/04 14:00	7.96	207.43	0.84
2018/07/04 14:15	7.84	195.13	0.80
2018/07/04 14:30	7.75	190.08	0.79
2018/07/04 14:45	7.48	182.66	0.79
2018/07/04 15:00	7.08	170.85	0.79
2018/07/04 15:15	7.03	180.10	0.84
2018/07/04 15:30	7.03	184.94	0.86
2018/07/04 15:45	7.08	186.53	0.86
2018/07/04 16:00	7.08	186.53	0.86
2018/07/04 16:15	7.03	180.59	0.84
2018/07/04 16:30	6.93	176.67	0.84
2018/07/04 16:45	6.86	174.50	0.84
2018/07/04 17:00	6.84	161.69	0.78
2018/07/04 17:15	6.81	162.63	0.79
2018/07/04 17:30	6.81	162.63	0.79
2018/07/04 17:45	6.81	160.61	0.78
2018/07/04 18:00	6.66	155.64	0.78
2018/07/04 18:15	6.55	150.73	0.77
2018/07/04 18:30	6.52	149.45	0.76
2018/07/04 18:45	6.52	149.45	0.76
2018/07/04 19:00	6.48	148.31	0.76
2018/07/04 19:15	6.46	147.74	0.76
2018/07/04 19:30	6.42	146.60	0.76
2018/07/04 19:45	6.42	148.41	0.77
2018/07/04 20:00	6.42	148.41	0.77
2018/07/04 20:15	6.42	152.86	0.80
2018/07/04 20:30	6.70	167.40	0.83
2018/07/04 20:45	6.70	167.40	0.83
2018/07/04 21:00	6.75	168.98	0.83
2018/07/04 21:15	6.75	168.98	0.83
2018/07/04 21:30	6.75	168.98	0.83
2018/07/04 21:45	6.67	162.85	0.81
2018/07/04 22:00	6.60	154.07	0.78
2018/07/04 22:15	6.39	143.75	0.75
2018/07/04 22:30	6.38	141.54	0.74
2018/07/04 22:45	6.19	135.93	0.74
2018/07/04 23:00	6.19	135.93	0.74
2018/07/04 23:15	6.19	135.93	0.74

TimeStamp	Level (in)	Flow (gpm)	Velocity (fps)
2018/07/04 23:30	6.41	146.28	0.76
2018/07/04 23:45	6.41	146.28	0.76
2018/07/05 00:00	6.41	146.28	0.76
2018/07/05 00:15	6.20	144.19	0.78
2018/07/05 00:30	6.14	139.78	0.77
2018/07/05 00:45	6.07	129.04	0.72
2018/07/05 01:00	5.97	118.86	0.68
2018/07/05 01:15	5.87	116.29	0.68
2018/07/05 01:30	5.65	108.83	0.67
2018/07/05 01:45	5.58	94.22	0.59
2018/07/05 02:00	5.47	88.59	0.57
2018/07/05 02:15	5.27	84.35	0.57
2018/07/05 02:30	5.27	84.10	0.56
2018/07/05 02:45	5.24	79.14	0.53
2018/07/05 03:00	5.24	79.14	0.53
2018/07/05 03:15	5.22	78.75	0.53
2018/07/05 03:30	5.19	76.66	0.52
2018/07/05 03:45	5.19	76.66	0.52
2018/07/05 04:00	5.13	75.41	0.52
2018/07/05 04:15	5.10	74.83	0.52
2018/07/05 04:30	5.10	74.71	0.52
2018/07/05 04:45	5.10	71.99	0.50
2018/07/05 05:00	5.11	72.02	0.50
2018/07/05 05:15	5.12	72.21	0.50
2018/07/05 05:30	5.17	74.63	0.51
2018/07/05 05:45	5.18	76.27	0.52
2018/07/05 06:00	5.19	78.10	0.54
2018/07/05 06:15	5.34	81.07	0.54
2018/07/05 06:30	5.44	87.78	0.57
2018/07/05 06:45	5.47	96.21	0.62
2018/07/05 07:00	5.66	107.31	0.66
2018/07/05 07:15	5.73	110.77	0.67
2018/07/05 07:30	5.92	117.50	0.68
2018/07/05 07:45	6.34	151.90	0.80
2018/07/05 08:00	6.73	164.45	0.81
2018/07/05 08:15	6.74	169.94	0.83
2018/07/05 08:30	7.00	177.93	0.83
2018/07/05 08:45	7.11	183.01	0.84
2018/07/05 09:00	7.16	184.60	0.84
2018/07/05 09:15	7.36	197.91	0.87
2018/07/05 09:30	7.40	202.61	0.89
2018/07/05 09:45	7.40	202.61	0.89
2018/07/05 10:00	7.47	204.92	0.89
2018/07/05 10:15	7.40	202.07	0.89
2018/07/05 10:30	7.38	201.43	0.89

TimeStamp	Level (in)	Flow (gpm)	Velocity (fps)
2018/07/05 10:45	7.34	191.16	0.85
2018/07/05 11:00	7.34	200.14	0.89
2018/07/05 11:15	7.33	200.23	0.89
2018/07/05 11:30	7.34	200.55	0.89
2018/07/05 11:45	7.33	192.97	0.86
2018/07/05 12:00	7.24	191.25	0.86
2018/07/05 12:15	7.10	185.78	0.86
2018/07/05 12:30	6.95	171.78	0.81
2018/07/05 12:45	6.90	167.64	0.80
2018/07/05 13:00	6.90	167.64	0.80
2018/07/05 13:15	6.90	167.64	0.80
2018/07/05 13:30	6.87	170.83	0.82
2018/07/05 13:45	6.87	170.85	0.82
2018/07/05 14:00	6.87	170.85	0.82
2018/07/05 14:15	6.87	173.06	0.83
2018/07/05 14:30	6.86	172.83	0.83
2018/07/05 14:45	6.78	170.33	0.83
2018/07/05 15:00	6.74	164.85	0.81
2018/07/05 15:15	6.42	152.32	0.79
2018/07/05 15:30	6.35	146.28	0.77
2018/07/05 15:45	6.35	146.28	0.77
2018/07/05 16:00	6.35	146.28	0.77
2018/07/05 16:15	6.55	154.46	0.79
2018/07/05 16:30	6.59	159.70	0.81
2018/07/05 16:45	6.59	159.70	0.81
2018/07/05 17:00	6.59	157.86	0.80
2018/07/05 17:15	6.59	157.86	0.80
2018/07/05 17:30	6.59	157.86	0.80
2018/07/05 17:45	6.59	151.67	0.77
2018/07/05 18:00	6.58	151.38	0.77
2018/07/05 18:15	6.58	153.66	0.78
2018/07/05 18:30	6.58	153.66	0.78
2018/07/05 18:45	6.72	163.51	0.81
2018/07/05 19:00	6.77	169.84	0.83
2018/07/05 19:15	6.77	169.84	0.83
2018/07/05 19:30	6.77	171.49	0.84
2018/07/05 19:45	6.77	171.49	0.84
2018/07/05 20:00	6.77	169.06	0.83
2018/07/05 20:15	6.75	168.45	0.83
2018/07/05 20:30	6.75	167.57	0.82
2018/07/05 20:45	6.92	173.03	0.82
2018/07/05 21:00	6.92	185.07	0.88
2018/07/05 21:15	6.94	185.72	0.88
2018/07/05 21:30	7.09	191.13	0.88
2018/07/05 21:45	7.13	192.42	0.88

TimeStamp	Level (in)	Flow (gpm)	Velocity (fps)
2018/07/05 22:00	7.13	188.64	0.86
2018/07/05 22:15	7.09	169.55	0.78
2018/07/05 22:30	7.01	166.30	0.78
2018/07/05 22:45	6.81	158.15	0.77
2018/07/05 23:00	6.57	151.06	0.77
2018/07/05 23:15	6.55	152.68	0.78
2018/07/05 23:30	6.54	150.20	0.77
2018/07/05 23:45	6.51	149.04	0.76
2018/07/06 00:00	6.41	146.43	0.76
2018/07/06 00:15	6.11	131.83	0.73
2018/07/06 00:30	6.06	124.92	0.70
2018/07/06 00:45	5.96	118.81	0.68
2018/07/06 01:00	5.75	114.22	0.69
2018/07/06 01:15	5.58	105.50	0.66
2018/07/06 01:30	5.49	89.02	0.57
2018/07/06 01:45	5.39	85.18	0.56
2018/07/06 02:00	5.34	84.18	0.56
2018/07/06 02:15	5.29	83.15	0.56
2018/07/06 02:30	5.26	88.13	0.59
2018/07/06 02:45	5.21	87.07	0.59
2018/07/06 03:00	5.16	85.97	0.59
2018/07/06 03:15	5.13	85.30	0.59
2018/07/06 03:30	5.11	73.53	0.51
2018/07/06 03:45	5.05	69.47	0.49
2018/07/06 04:00	4.95	67.69	0.49
2018/07/06 04:15	4.94	66.22	0.48
2018/07/06 04:30	4.89	66.46	0.49
2018/07/06 04:45	4.89	65.05	0.48
2018/07/06 05:00	4.86	64.52	0.48
2018/07/06 05:15	4.89	61.04	0.45
2018/07/06 05:30	4.91	61.37	0.45
2018/07/06 05:45	5.01	63.07	0.45
2018/07/06 06:00	5.05	68.10	0.48
2018/07/06 06:15	5.08	81.31	0.57
2018/07/06 06:30	5.34	87.16	0.57
2018/07/06 06:45	5.40	88.50	0.58
2018/07/06 07:00	5.42	91.98	0.60
2018/07/06 07:15	5.63	110.16	0.68
2018/07/06 07:30	5.85	117.09	0.69
2018/07/06 07:45	6.23	153.74	0.83
2018/07/06 08:00	6.76	170.11	0.83
2018/07/06 08:15	6.89	174.11	0.83
2018/07/06 08:30	6.95	177.85	0.84
2018/07/06 08:45	7.23	180.78	0.81
2018/07/06 09:00	7.26	181.62	0.81

TimeStamp	Level (in)	Flow (gpm)	Velocity (fps)
2018/07/06 09:15	7.26	181.62	0.81
2018/07/06 09:30	7.30	194.25	0.87
2018/07/06 09:45	7.30	182.71	0.81
2018/07/06 10:00	7.30	182.82	0.81
2018/07/06 10:15	7.30	182.77	0.81
2018/07/06 10:30	7.30	187.07	0.83
2018/07/06 10:45	7.24	180.99	0.81
2018/07/06 11:00	7.21	184.33	0.83
2018/07/06 11:15	7.12	189.73	0.87
2018/07/06 11:30	7.12	189.73	0.87
2018/07/06 11:45	7.11	189.41	0.87
2018/07/06 12:00	7.11	189.41	0.87
2018/07/06 12:15	7.13	190.70	0.87
2018/07/06 12:30	7.13	190.70	0.87
2018/07/06 12:45	7.12	178.84	0.82
2018/07/06 13:00	7.12	174.29	0.80
2018/07/06 13:15	6.97	169.88	0.80
2018/07/06 13:30	6.91	168.11	0.80
2018/07/06 13:45	6.85	166.29	0.80
2018/07/06 14:00	6.81	170.77	0.83
2018/07/06 14:15	6.73	168.32	0.83
2018/07/06 14:30	6.73	168.32	0.83
2018/07/06 14:45	6.62	162.62	0.82
2018/07/06 15:00	6.45	157.51	0.82
2018/07/06 15:15	6.45	153.20	0.79
2018/07/06 15:30	6.45	153.15	0.79
2018/07/06 15:45	6.45	153.13	0.79
2018/07/06 16:00	6.45	151.70	0.79
2018/07/06 16:15	6.45	149.56	0.78
2018/07/06 16:30	6.41	148.06	0.77
2018/07/06 16:45	6.41	148.06	0.77
2018/07/06 17:00	6.39	147.48	0.77
2018/07/06 17:15	6.39	147.48	0.77
2018/07/06 17:30	6.39	148.98	0.78
2018/07/06 17:45	6.32	146.94	0.78
2018/07/06 18:00	6.39	149.66	0.78
2018/07/06 18:15	6.44	152.96	0.79
2018/07/06 18:30	6.40	153.63	0.80
2018/07/06 18:45	6.44	156.68	0.81
2018/07/06 19:00	6.50	162.64	0.83
2018/07/06 19:15	6.59	170.60	0.86
2018/07/06 19:30	6.90	181.89	0.87
2018/07/06 19:45	6.90	181.89	0.87
2018/07/06 20:00	6.90	182.41	0.87
2018/07/06 20:15	6.79	177.25	0.86

TimeStamp	Level (in)	Flow (gpm)	Velocity (fps)
2018/07/06 20:30	6.78	173.95	0.85
2018/07/06 20:45	6.74	171.06	0.84
2018/07/06 21:00	6.74	171.06	0.84
2018/07/06 21:15	6.74	171.06	0.84
2018/07/06 21:30	6.74	173.30	0.85
2018/07/06 21:45	6.80	176.88	0.86
2018/07/06 22:00	6.86	178.79	0.86
2018/07/06 22:15	6.86	177.07	0.85
2018/07/06 22:30	6.80	171.04	0.83
2018/07/06 22:45	6.75	164.31	0.80
2018/07/06 23:00	6.50	155.06	0.79
2018/07/06 23:15	6.42	152.70	0.79
2018/07/06 23:30	6.36	150.92	0.79
2018/07/06 23:45	6.36	152.43	0.80
2018/07/07 00:00	6.36	150.63	0.79
2018/07/07 00:15	6.31	150.94	0.80
2018/07/07 00:30	6.29	148.56	0.79
2018/07/07 00:45	6.25	147.38	0.79
2018/07/07 01:00	5.93	129.73	0.75
2018/07/07 01:15	5.93	128.30	0.74
2018/07/07 01:30	5.84	120.37	0.71
2018/07/07 01:45	5.80	119.32	0.71
2018/07/07 02:00	5.78	118.68	0.71
2018/07/07 02:15	5.73	117.36	0.71
2018/07/07 02:30	5.65	103.83	0.64
2018/07/07 02:45	5.49	93.59	0.60
2018/07/07 03:00	5.31	86.42	0.57
2018/07/07 03:15	5.12	79.24	0.55
2018/07/07 03:30	5.10	74.69	0.52
2018/07/07 03:45	5.09	73.08	0.51
2018/07/07 04:00	5.03	69.15	0.49
2018/07/07 04:15	5.03	69.15	0.49
2018/07/07 04:30	5.03	69.15	0.49
2018/07/07 04:45	5.03	70.54	0.50
2018/07/07 05:00	5.08	71.51	0.50
2018/07/07 05:15	5.08	75.71	0.53
2018/07/07 05:30	5.07	79.74	0.56
2018/07/07 05:45	5.10	80.36	0.56
2018/07/07 06:00	5.11	79.24	0.55
2018/07/07 06:15	5.11	77.83	0.54
2018/07/07 06:30	5.18	80.67	0.55
2018/07/07 06:45	5.18	80.67	0.55
2018/07/07 07:00	5.22	82.99	0.56
2018/07/07 07:15	5.25	83.65	0.56
2018/07/07 07:30	5.52	103.77	0.66

TimeStamp	Level (in)	Flow (gpm)	Velocity (fps)
2018/07/07 07:45	5.75	121.34	0.73
2018/07/07 08:00	6.04	133.25	0.75
2018/07/07 08:15	6.06	133.84	0.75
2018/07/07 08:30	6.36	160.45	0.85
2018/07/07 08:45	6.59	169.34	0.85
2018/07/07 09:00	7.11	187.72	0.86
2018/07/07 09:15	7.93	211.29	0.85
2018/07/07 09:30	7.93	211.29	0.85
2018/07/07 09:45	7.93	207.09	0.84
2018/07/07 10:00	7.78	202.64	0.84
2018/07/07 10:15	7.75	187.78	0.78
2018/07/07 10:30	7.73	187.23	0.78
2018/07/07 10:45	7.73	209.47	0.87
2018/07/07 11:00	7.63	210.70	0.89
2018/07/07 11:15	7.63	206.30	0.87
2018/07/07 11:30	7.71	208.80	0.87
2018/07/07 11:45	7.71	208.65	0.87
2018/07/07 12:00	7.63	205.68	0.87
2018/07/07 12:15	7.58	178.83	0.76
2018/07/07 12:30	7.38	180.72	0.79
2018/07/07 12:45	7.38	180.72	0.79
2018/07/07 13:00	7.31	178.69	0.79
2018/07/07 13:15	7.23	178.41	0.80
2018/07/07 13:30	7.23	181.56	0.82
2018/07/07 13:45	6.78	171.93	0.84
2018/07/07 14:00	6.74	170.74	0.84
2018/07/07 14:15	6.72	170.07	0.84
2018/07/07 14:30	6.72	176.57	0.87
2018/07/07 14:45	6.78	178.63	0.87
2018/07/07 15:00	6.80	179.14	0.87
2018/07/07 15:15	6.84	180.38	0.87
2018/07/07 15:30	6.85	180.88	0.87
2018/07/07 15:45	7.02	186.28	0.87
2018/07/07 16:00	7.03	191.63	0.89
2018/07/07 16:15	7.03	191.63	0.89
2018/07/07 16:30	7.02	181.63	0.85
2018/07/07 16:45	6.91	174.13	0.83
2018/07/07 17:00	6.78	170.15	0.83
2018/07/07 17:15	6.78	170.15	0.83
2018/07/07 17:30	6.78	174.17	0.85
2018/07/07 17:45	6.81	175.65	0.85
2018/07/07 18:00	6.81	175.65	0.85
2018/07/07 18:15	6.81	175.65	0.85
2018/07/07 18:30	6.68	166.84	0.83
2018/07/07 18:45	6.66	166.22	0.83


TimeStamp	Level (in)	Flow (gpm)	Velocity (fps)
2018/07/07 19:00	6.66	166.22	0.83
2018/07/07 19:15	6.66	165.87	0.83
2018/07/07 19:30	6.67	164.55	0.82
2018/07/07 19:45	6.70	167.72	0.83
2018/07/07 20:00	6.79	170.48	0.83
2018/07/07 20:15	6.79	170.48	0.83
2018/07/07 20:30	6.79	170.48	0.83
2018/07/07 20:45	6.79	174.19	0.85
2018/07/07 21:00	6.69	173.95	0.86
2018/07/07 21:15	6.64	169.48	0.85
2018/07/07 21:30	6.63	167.13	0.84
2018/07/07 21:45	6.63	167.13	0.84
2018/07/07 22:00	6.66	168.06	0.84
2018/07/07 22:15	6.66	168.06	0.84
2018/07/07 22:30	6.66	168.06	0.84
2018/07/07 22:45	6.67	166.80	0.83
2018/07/07 23:00	6.67	166.80	0.83
2018/07/07 23:15	6.66	162.15	0.81
2018/07/07 23:30	6.58	153.50	0.78
2018/07/07 23:45	6.55	150.71	0.77
2018/07/08 00:00	6.48	144.12	0.74
2018/07/08 00:15	6.23	137.21	0.74
2018/07/08 00:30	6.16	135.32	0.74
2018/07/08 00:45	6.16	135.27	0.74
2018/07/08 01:00	6.13	134.44	0.74
2018/07/08 01:15	5.93	123.19	0.71
2018/07/08 01:30	5.73	109.23	0.66
2018/07/08 01:45	5.67	106.21	0.65
2018/07/08 02:00	5.67	106.21	0.65
2018/07/08 02:15	5.56	100.15	0.63
2018/07/08 02:30	5.56	105.07	0.66
2018/07/08 02:45	5.56	100.15	0.63
2018/07/08 03:00	5.50	98.75	0.63
2018/07/08 03:15	5.47	96.39	0.62
2018/07/08 03:30	5.36	89.13	0.58
2018/07/08 03:45	5.35	87.48	0.57
2018/07/08 04:00	5.31	86.44	0.57
2018/07/08 04:15	5.25	85.17	0.57
2018/07/08 04:30	5.25	85.08	0.57
2018/07/08 04:45	5.25	84.57	0.57
2018/07/08 05:00	5.25	84.57	0.57
2018/07/08 05:15	5.25	84.57	0.57
2018/07/08 05:30	5.25	82.11	0.55
2018/07/08 05:45	5.25	82.11	0.55
2018/07/08 06:00	5.25	79.20	0.53

TimeStamp	Level (in)	Flow (gpm)	Velocity (fps)
2018/07/08 06:15	5.15	77.25	0.53
2018/07/08 06:30	5.24	80.36	0.54
2018/07/08 06:45	5.25	82.19	0.55
2018/07/08 07:00	5.25	83.61	0.56
2018/07/08 07:15	5.25	86.78	0.59
2018/07/08 07:30	5.46	102.36	0.66
2018/07/08 07:45	5.63	106.56	0.66
2018/07/08 08:00	5.92	122.72	0.71
2018/07/08 08:15	6.30	148.74	0.79
2018/07/08 08:30	6.50	157.03	0.80
2018/07/08 08:45	6.79	172.61	0.84
2018/07/08 09:00	6.90	176.02	0.84
2018/07/08 09:15	7.07	188.13	0.87
2018/07/08 09:30	7.08	189.17	0.87
2018/07/08 09:45	7.15	191.41	0.87
2018/07/08 10:00	7.62	206.27	0.87
2018/07/08 10:15	7.64	218.28	0.92
2018/07/08 10:30	7.71	220.65	0.92
2018/07/08 10:45	7.97	219.15	0.88
2018/07/08 11:00	7.97	219.15	0.88
2018/07/08 11:15	7.97	218.68	0.88
2018/07/08 11:30	7.58	201.72	0.86
2018/07/08 11:45	7.56	193.55	0.83
2018/07/08 12:00	7.50	191.76	0.83
2018/07/08 12:15	7.47	185.96	0.81
2018/07/08 12:30	7.47	185.96	0.81
2018/07/08 12:45	7.50	186.84	0.81
2018/07/08 13:00	7.50	189.29	0.82
2018/07/08 13:15	7.44	187.48	0.82
2018/07/08 13:30	7.44	188.81	0.82
2018/07/08 13:45	7.24	181.54	0.82
2018/07/08 14:00	7.24	181.54	0.82
2018/07/08 14:15	7.22	178.09	0.80
2018/07/08 14:30	7.16	177.23	0.81
2018/07/08 14:45	7.16	177.23	0.81
2018/07/08 15:00	6.81	170.77	0.83
2018/07/08 15:15	6.81	170.77	0.83
2018/07/08 15:30	6.81	173.18	0.84
2018/07/08 15:45	6.87	175.19	0.84
2018/07/08 16:00	6.87	175.19	0.84
2018/07/08 16:15	6.91	176.43	0.84
2018/07/08 16:30	6.92	176.74	0.84
2018/07/08 16:45	6.87	175.19	0.84
2018/07/08 17:00	6.87	174.81	0.84
2018/07/08 17:15	6.85	172.75	0.83


TimeStamp	Level (in)	Flow (gpm)	Velocity (fps)
2018/07/08 17:30	6.85	174.19	0.84
2018/07/08 17:45	6.85	180.80	0.87
2018/07/08 18:00	6.85	178.41	0.86
2018/07/08 18:15	6.85	180.43	0.87
2018/07/08 18:30	6.91	182.30	0.87
2018/07/08 18:45	6.73	174.55	0.86
2018/07/08 19:00	6.73	174.55	0.86
2018/07/08 19:15	6.77	172.27	0.84
2018/07/08 19:30	6.92	176.93	0.84
2018/07/08 19:45	6.91	176.67	0.84
2018/07/08 20:00	6.91	180.41	0.86
2018/07/08 20:15	6.91	176.67	0.84
2018/07/08 20:30	6.87	175.30	0.84
2018/07/08 20:45	6.78	172.50	0.84
2018/07/08 21:00	6.78	174.44	0.85
2018/07/08 21:15	6.86	176.91	0.85
2018/07/08 21:30	6.87	179.18	0.86
2018/07/08 21:45	7.03	187.05	0.87
2018/07/08 22:00	7.30	196.59	0.88
2018/07/08 22:15	7.30	196.59	0.88
2018/07/08 22:30	7.30	196.59	0.88
2018/07/08 22:45	6.96	178.17	0.84
2018/07/08 23:00	6.93	174.28	0.83
2018/07/08 23:15	6.64	165.36	0.83
2018/07/08 23:30	6.44	154.09	0.80
2018/07/08 23:45	6.43	148.80	0.77
2018/07/09 00:00	6.42	142.75	0.74
2018/07/09 00:15	6.32	137.88	0.73
2018/07/09 00:30	6.16	133.50	0.73
2018/07/09 00:45	5.93	119.63	0.69
2018/07/09 01:00	5.84	114.25	0.67
2018/07/09 01:15	5.73	107.57	0.65
2018/07/09 01:30	5.61	91.65	0.57
2018/07/09 01:45	5.44	88.06	0.57
2018/07/09 02:00	5.36	86.41	0.57
2018/07/09 02:15	5.30	80.49	0.54
2018/07/09 02:30	5.28	79.95	0.53
2018/07/09 02:45	5.25	79.36	0.53
2018/07/09 03:00	5.17	74.65	0.51
2018/07/09 03:15	5.17	73.33	0.50
2018/07/09 03:30	5.14	72.53	0.50
2018/07/09 03:45	5.08	70.29	0.49
2018/07/09 04:00	5.08	70.15	0.49
2018/07/09 04:15	5.08	70.15	0.49
2018/07/09 04:30	5.04	70.59	0.50

TimeStamp	Level (in)	Flow (gpm)	Velocity (fps)
2018/07/09 04:45	5.02	70.22	0.50
2018/07/09 05:00	5.00	71.23	0.51
2018/07/09 05:15	5.00	71.23	0.51
2018/07/09 05:30	5.00	72.83	0.52
2018/07/09 05:45	5.23	77.48	0.52
2018/07/09 06:00	5.24	79.24	0.54
2018/07/09 06:15	5.29	80.23	0.54
2018/07/09 06:30	5.34	81.22	0.54
2018/07/09 06:45	5.42	88.85	0.58
2018/07/09 07:00	5.82	113.12	0.67
2018/07/09 07:15	5.87	114.66	0.67
2018/07/09 07:30	6.17	142.81	0.78
2018/07/09 07:45	6.70	167.50	0.83
2018/07/09 08:00	6.87	177.36	0.85
2018/07/09 08:15	7.00	181.73	0.85
2018/07/09 08:30	7.52	199.55	0.86
2018/07/09 08:45	7.54	200.24	0.86
2018/07/09 09:00	7.54	200.24	0.86
2018/07/09 09:15	7.52	199.62	0.86
2018/07/09 09:30	7.28	192.07	0.86
2018/07/09 09:45	7.26	191.51	0.86
2018/07/09 10:00	7.26	183.52	0.82
2018/07/09 10:15	7.25	183.22	0.82
2018/07/09 10:30	7.16	172.18	0.78
2018/07/09 10:45	7.10	170.45	0.78
2018/07/09 11:00	7.18	170.18	0.77
2018/07/09 11:15	7.18	170.18	0.77
2018/07/09 11:30	7.18	182.65	0.83
2018/07/09 11:45	7.41	195.93	0.86
2018/07/09 12:00	7.41	195.93	0.86
2018/07/09 12:15	7.41	195.93	0.86
2018/07/09 12:30	7.14	183.40	0.84
2018/07/09 12:45	6.82	173.51	0.84
2018/07/09 13:00	6.82	173.51	0.84
2018/07/09 13:15	6.82	173.66	0.84
2018/07/09 13:30	6.77	172.06	0.84


2018.06 Adohr MH L15-100

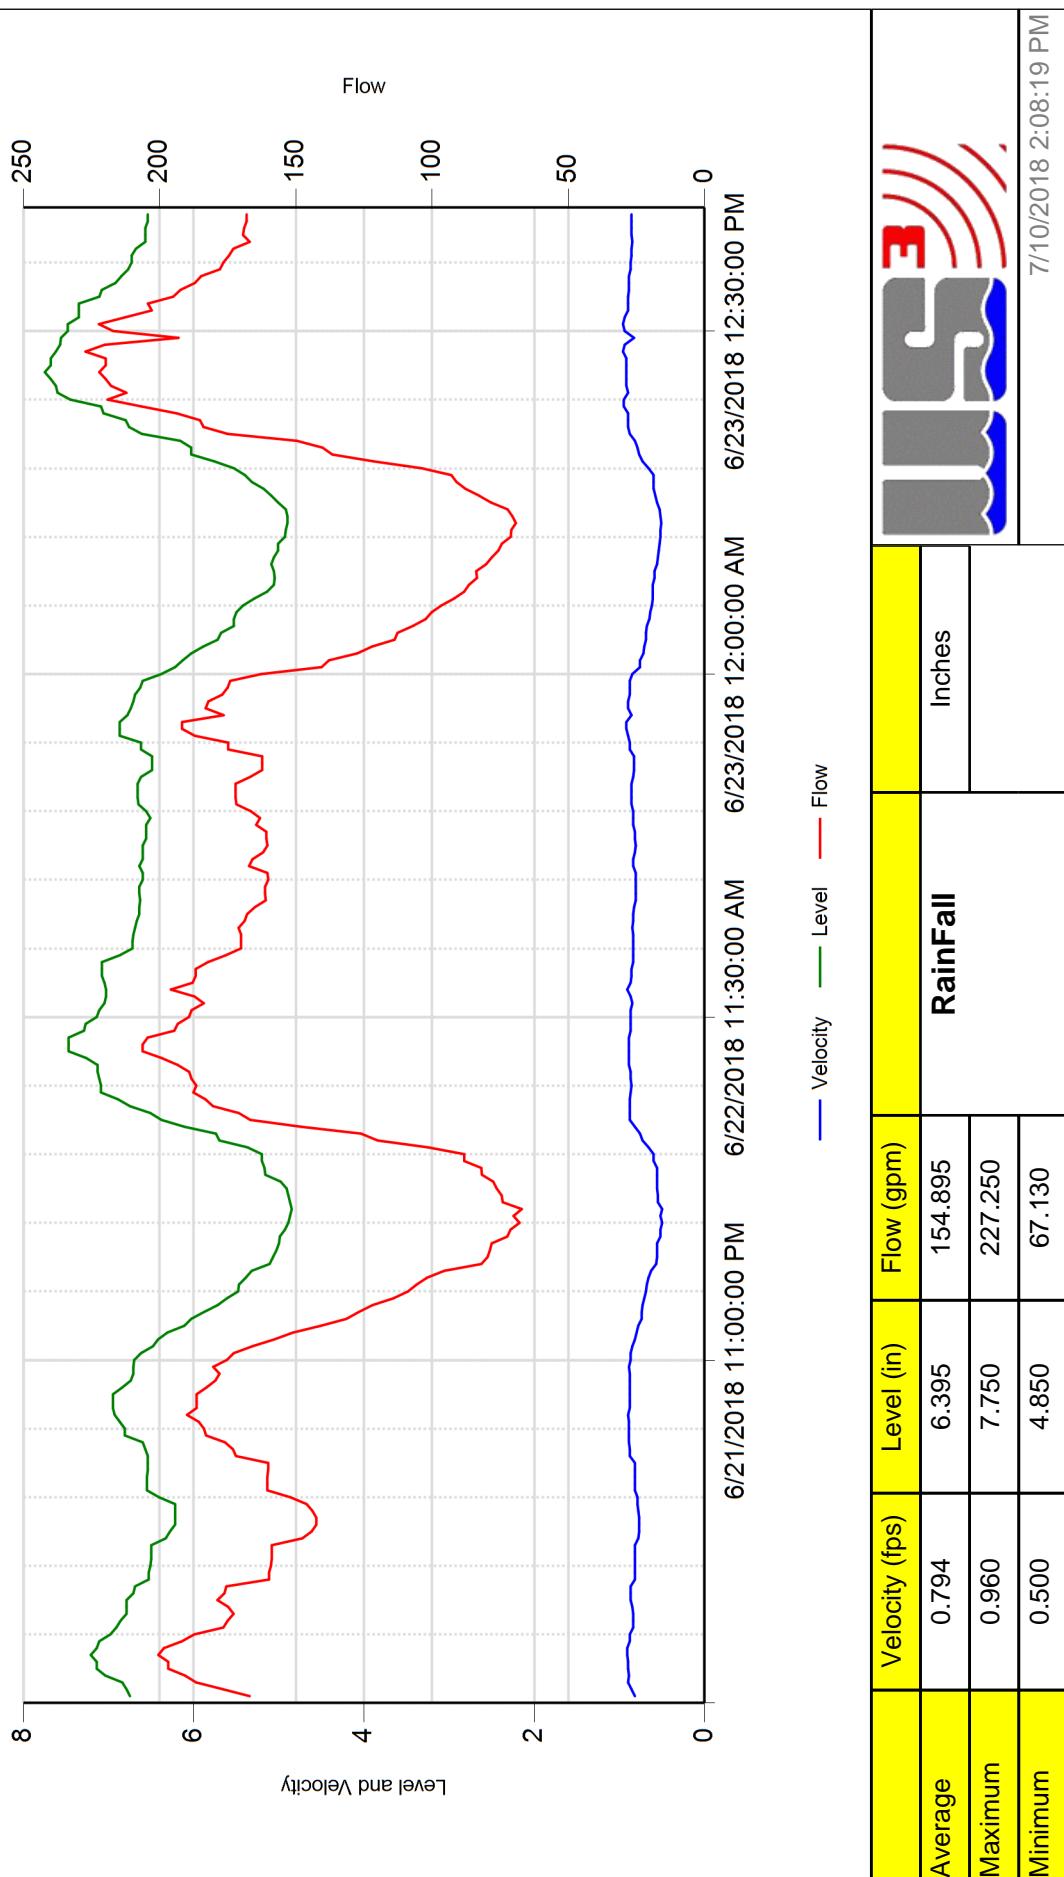


2018.06 Adohr MH L15-100

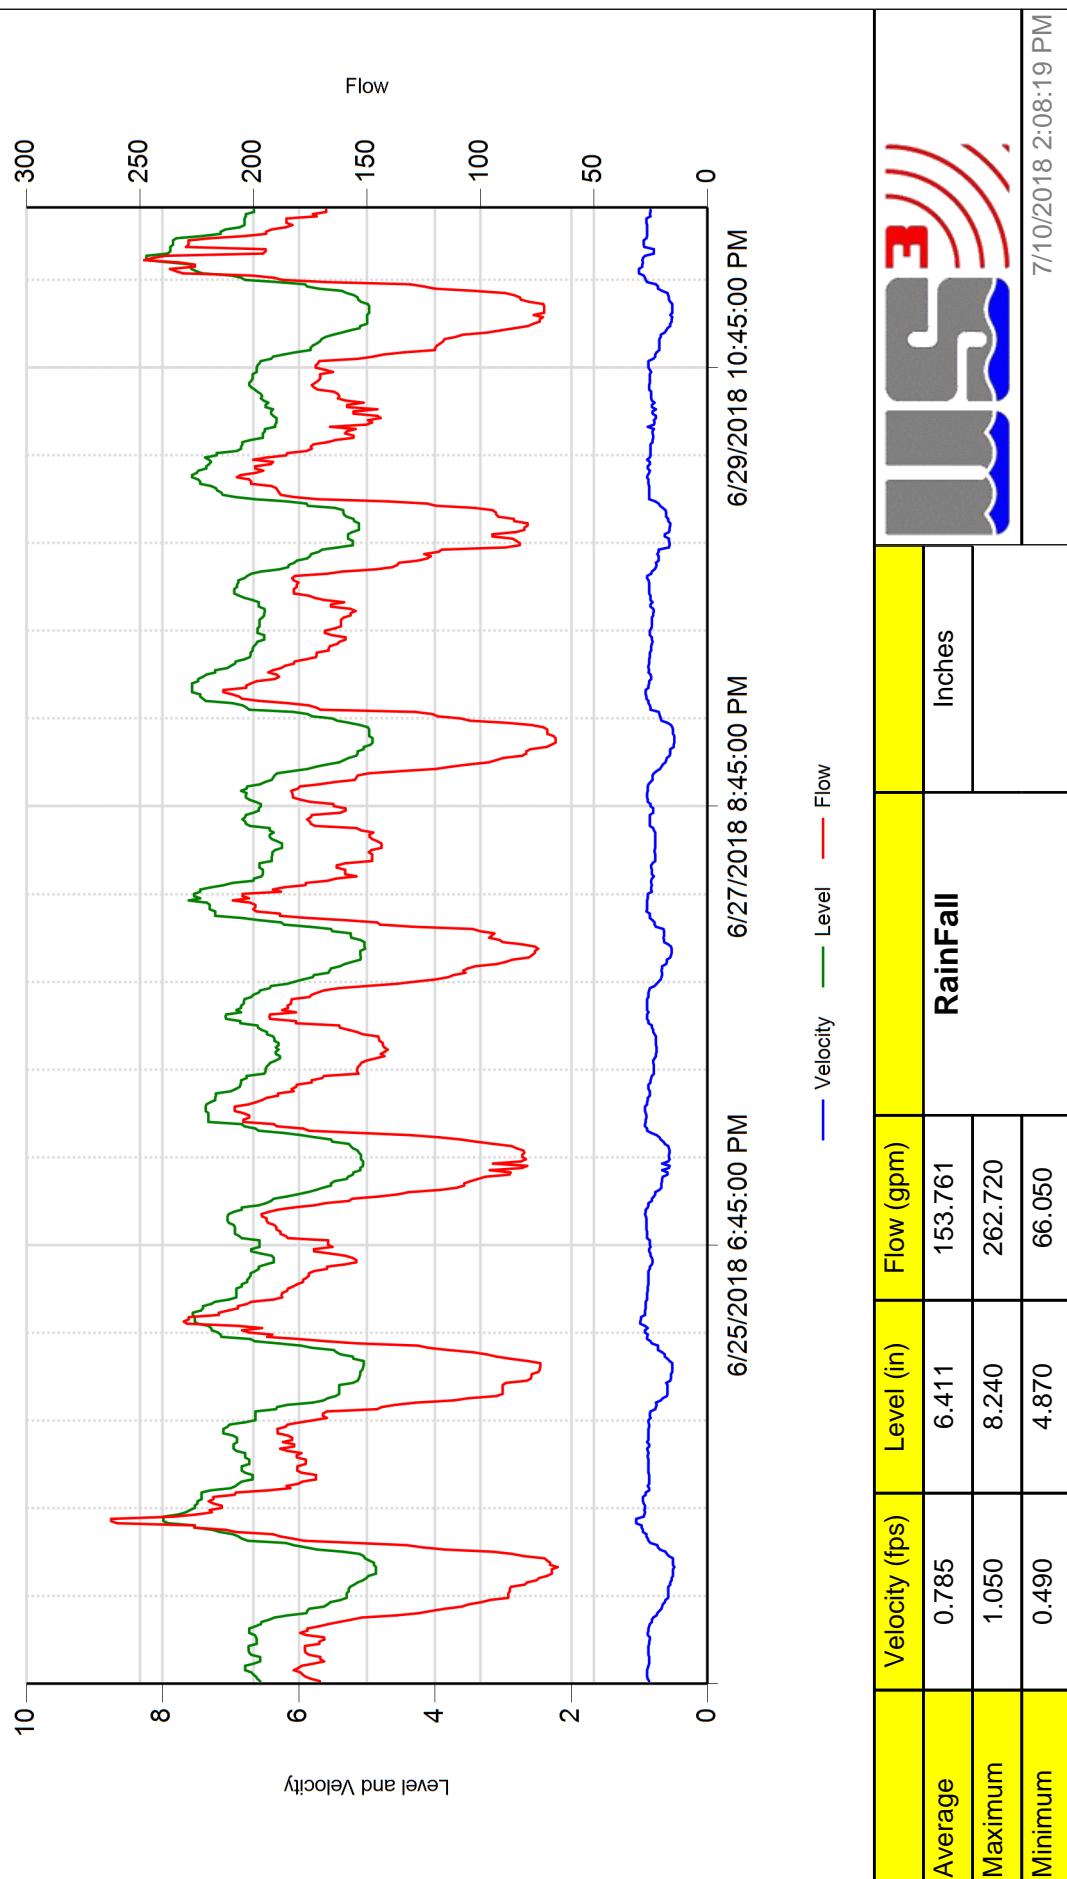


2018.06 Adohr MH L15-100

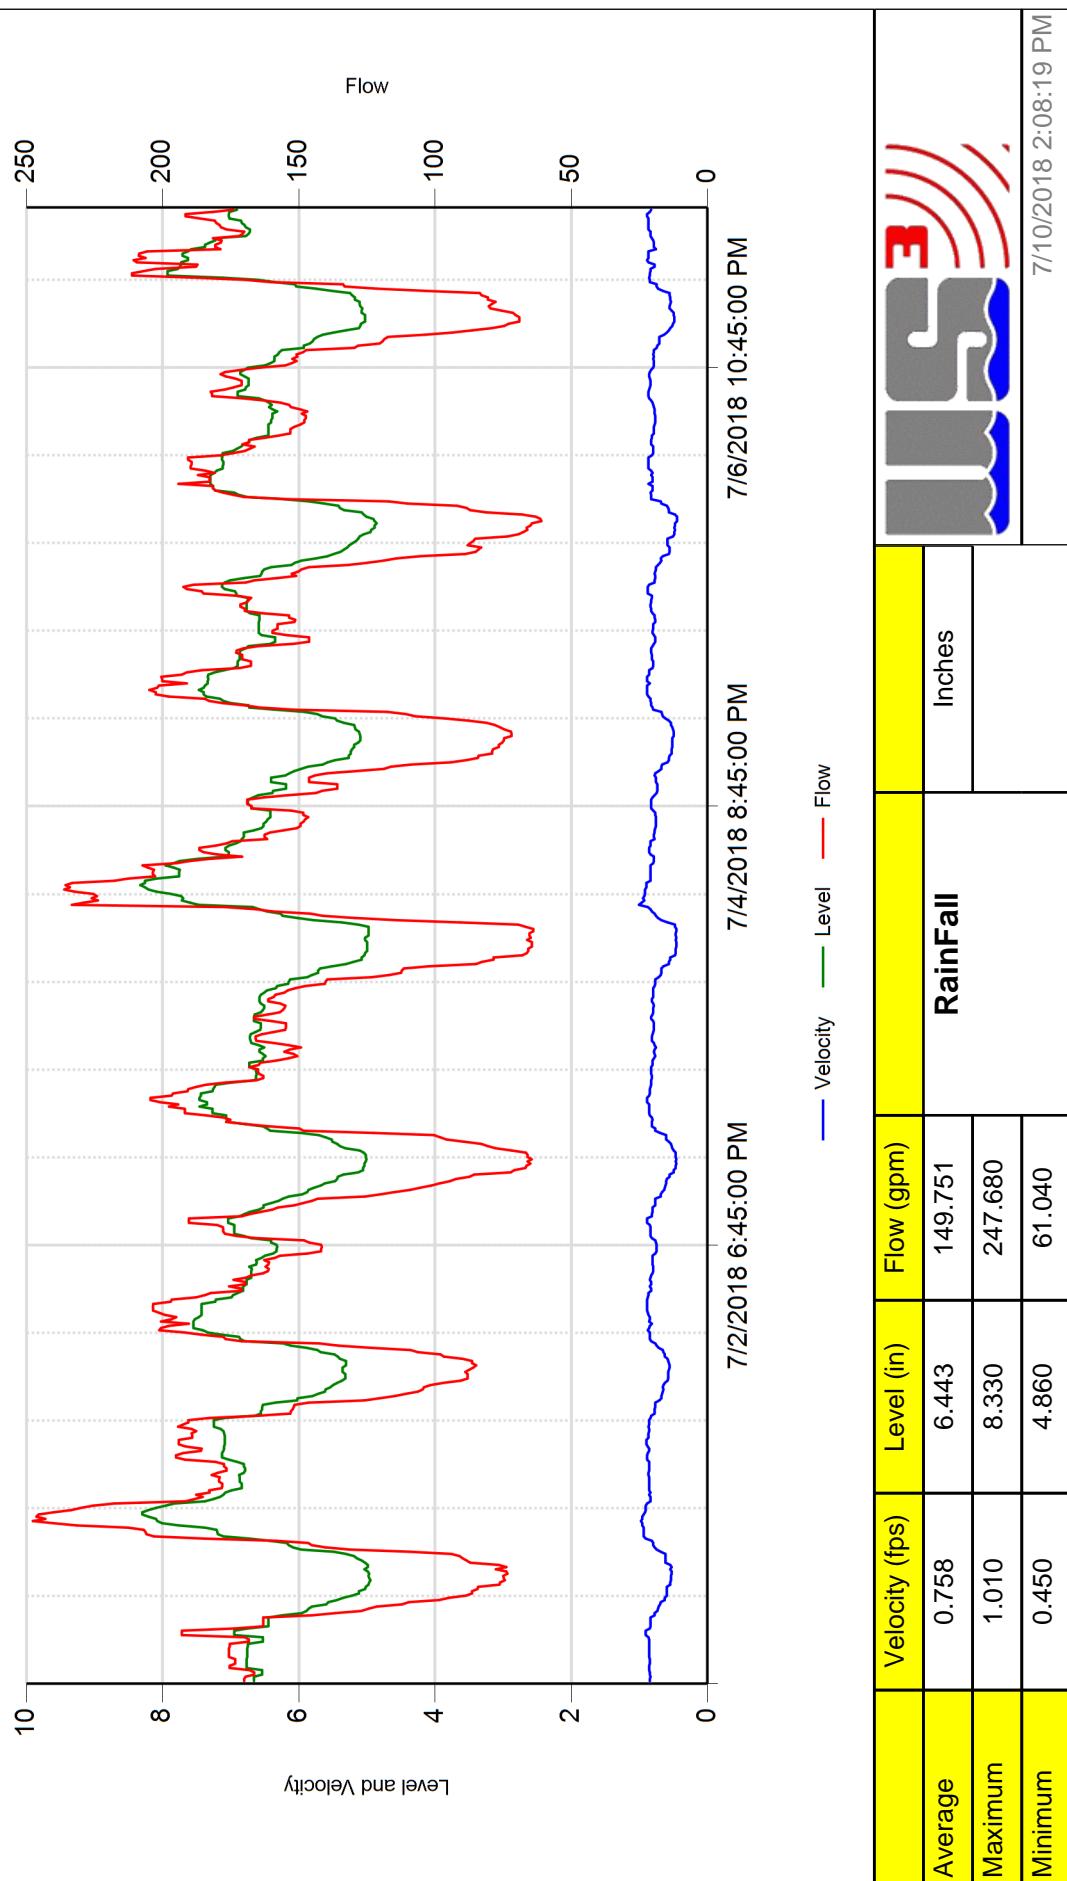

2018.06 Adohr MH L15-100

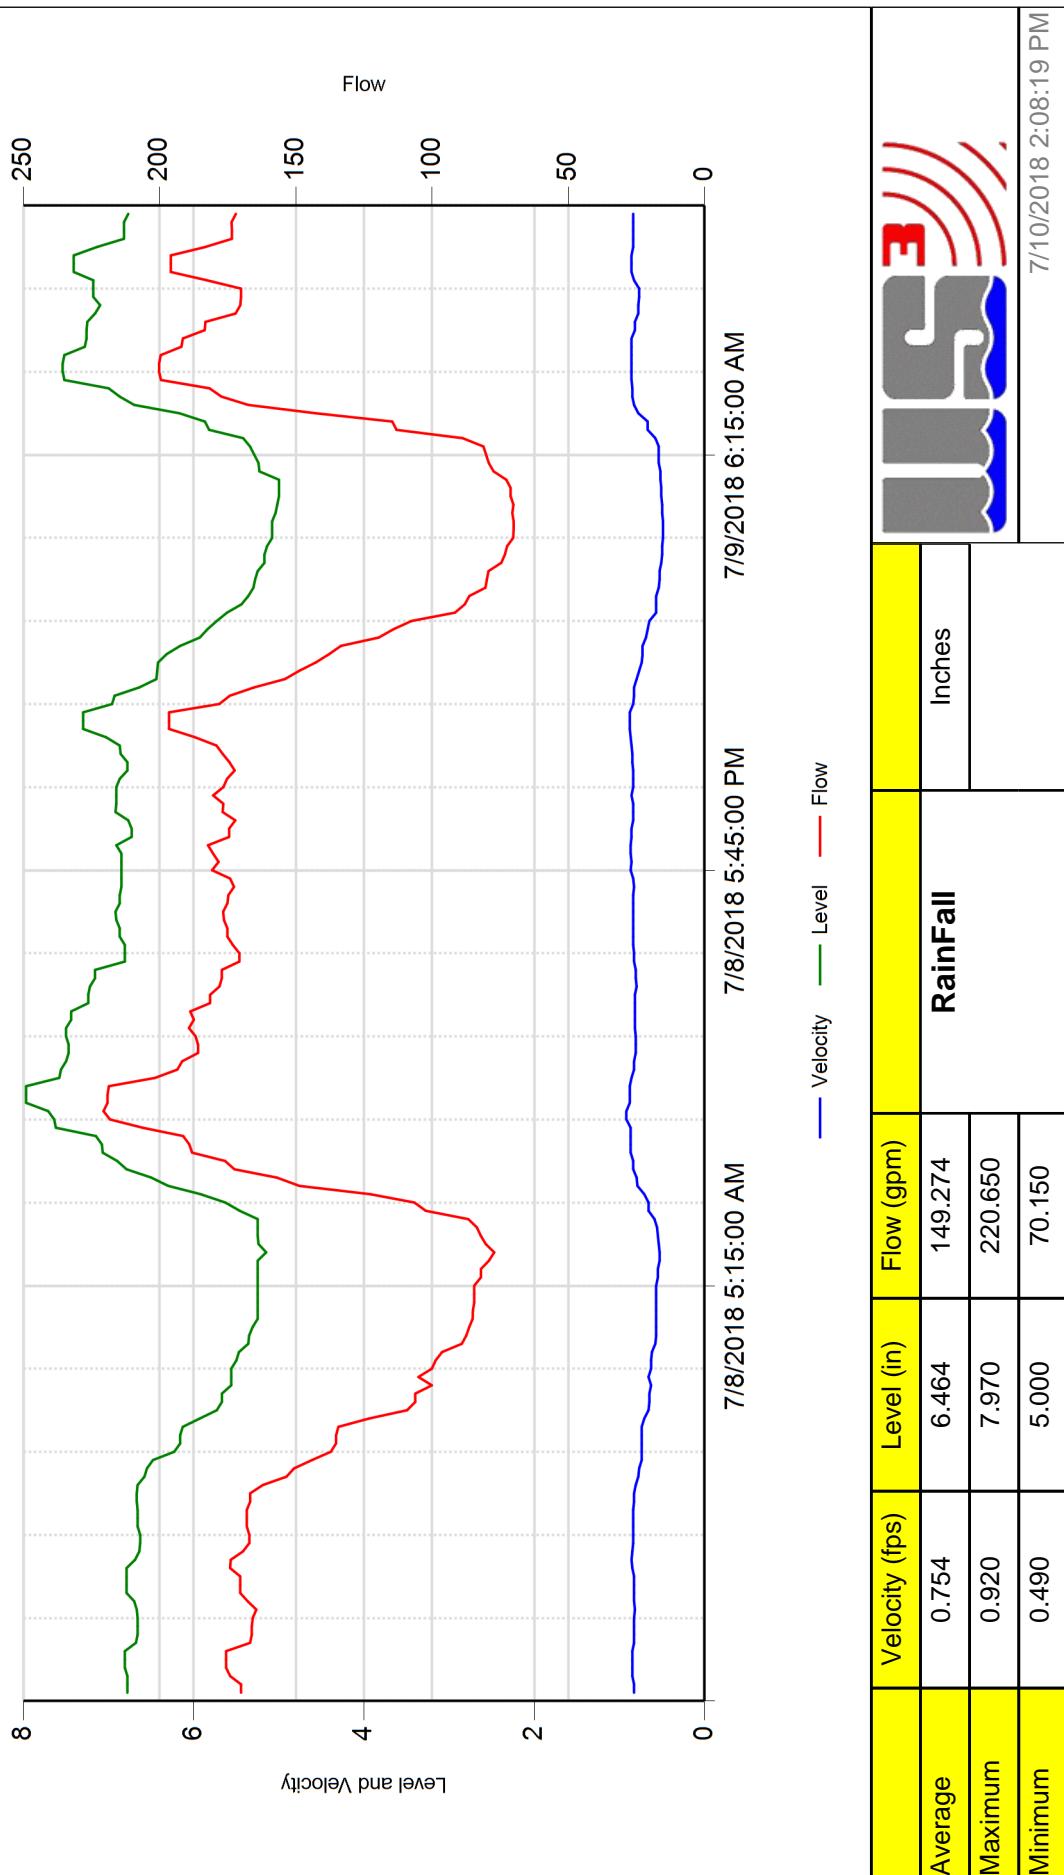

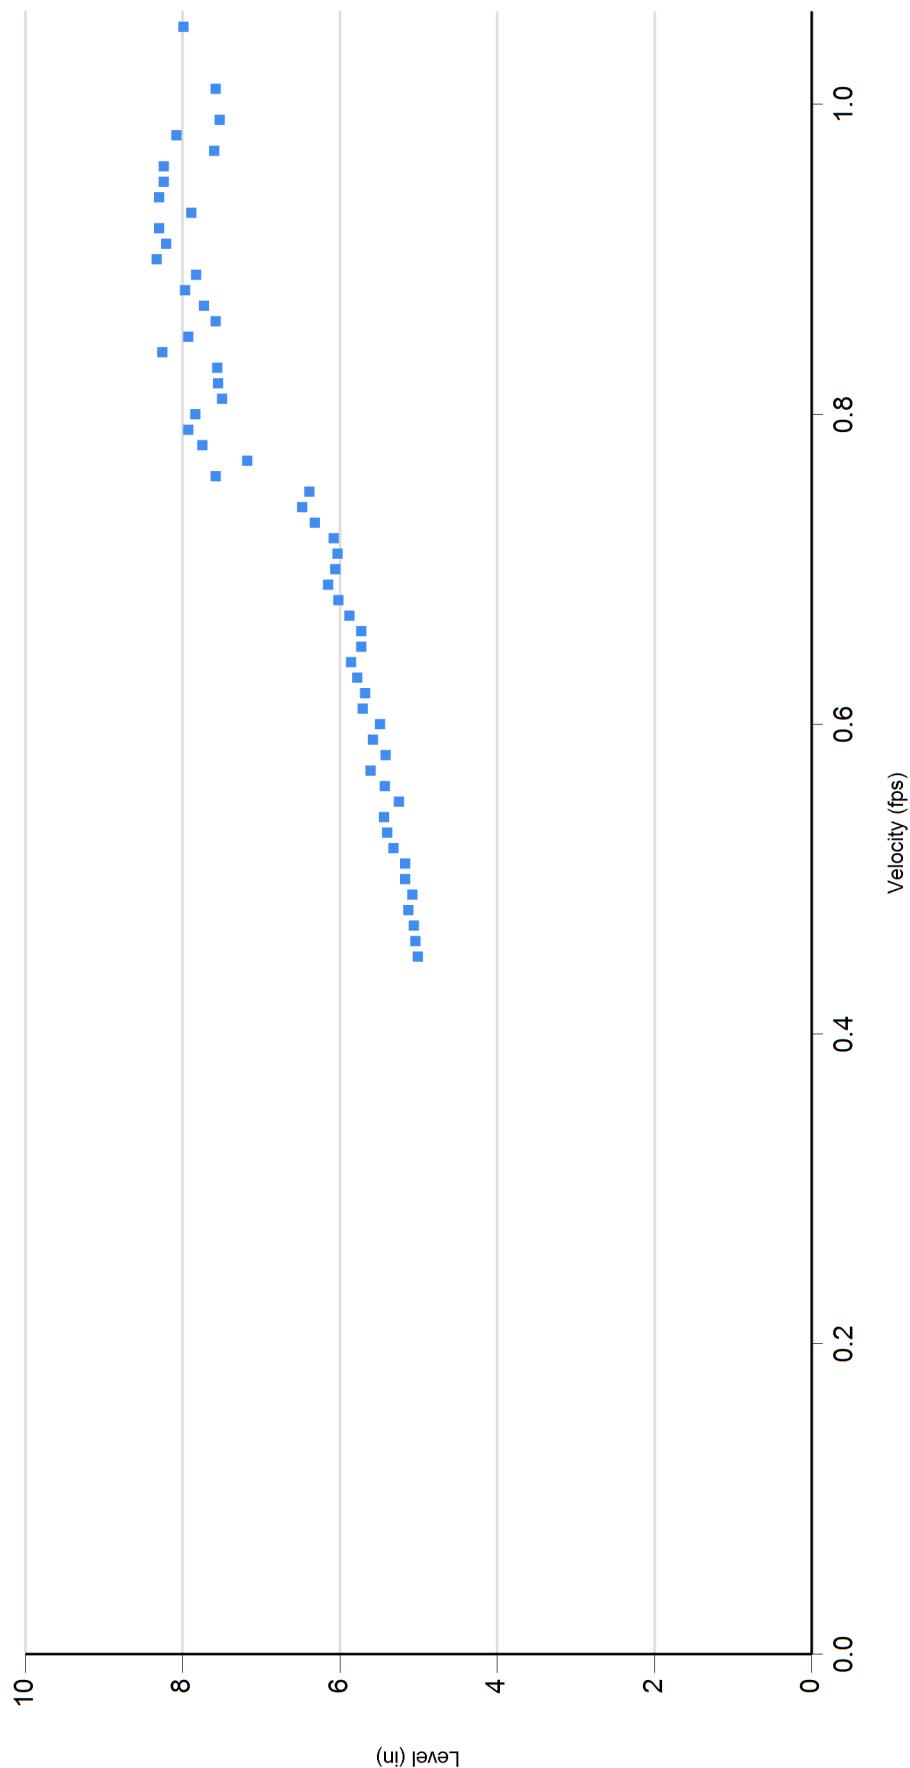

52



Utility Systems Science and Software

Report Date: 07/10/2018
 Customer: Dexter Wilson Engineering
 Group: Sewer flow monitoring
 SiteID: 3092

Statistics for 2018.06 Adohr MH L15-100: 06/21/2018 thru 07/09/2018

	Flow (GPM)				Flow (MGD)				Velocity (FPS)				Level (inches)				
	Date	Avg	Max	Min	Max	Avg	Min	Max	Min	Avg	Max	Min	Total Gal	Rain			
6/21/18	172.01	200.53	142.53	0.25	0.29	0.21	0.85	0.91	0.77	6.69	7.21	6.22	247,691				
6/22/18	151.16	206.26	67.13	0.22	0.30	0.10	0.78	0.92	0.50	6.33	7.47	4.85	217,665				
6/23/18	154.84	227.25	69.30	0.22	0.33	0.10	0.79	0.96	0.51	6.37	7.75	4.90	222,964				
6/24/18	157.87	262.72	66.05	0.23	0.38	0.10	0.79	1.05	0.49	6.46	7.99	4.87	227,336				
Week:	158.97	262.72	66.05	0.23	0.38	0.10	0.80	1.05	0.49	6.46	7.99	4.85	915,656				
6/25/18	158.24	230.76	73.68	0.23	0.33	0.11	0.80	0.99	0.52	6.45	7.56	5.05	227,872				
6/26/18	151.36	208.28	79.47	0.22	0.30	0.11	0.78	0.92	0.56	6.35	7.37	5.06	217,963				
6/27/18	149.06	209.16	74.67	0.21	0.30	0.11	0.77	0.90	0.53	6.36	7.62	5.03	214,651				
6/28/18	150.82	213.28	66.99	0.22	0.31	0.10	0.77	0.91	0.49	6.40	7.57	4.92	217,183				
6/29/18	150.70	207.37	79.31	0.22	0.30	0.11	0.78	0.89	0.55	6.40	7.57	5.12	217,009				
6/30/18	158.05	248.23	72.04	0.23	0.36	0.10	0.79	1.01	0.52	6.47	8.24	4.97	227,599				
7/1/18	160.56	247.68	73.49	0.23	0.36	0.11	0.79	0.98	0.53	6.54	8.30	4.95	231,201				
Week:	154.11	248.23	66.99	0.22	0.36	0.10	0.78	1.01	0.49	6.42	8.30	4.92	1,553,478				
7/2/18	153.20	203.57	84.97	0.22	0.29	0.12	0.77	0.89	0.56	6.51	7.55	5.31	220,614				
7/3/18	142.79	204.50	64.60	0.21	0.29	0.09	0.74	0.89	0.46	6.36	7.46	5.01	205,614				

	Flow (GPM)				Flow (MGD)				Velocity (FPS)				Level (inches)		
Date	Avg	Max	Min	Avg	Max	Min	Avg	Max	Min	Avg	Max	Min	Total Gal	Rain	
7/4/18	149.18	236.15	64.02	0.21	0.34	0.09	0.74	1.01	0.46	6.49	8.33	4.98	214,815		
7/5/18	146.90	204.92	71.99	0.21	0.30	0.10	0.75	0.89	0.50	6.42	7.47	5.10	211,540		
7/6/18	143.01	194.25	61.04	0.21	0.28	0.09	0.74	0.87	0.45	6.31	7.30	4.86	205,932		
7/7/18	151.02	211.29	69.15	0.22	0.30	0.10	0.76	0.89	0.49	6.47	7.93	5.03	217,470		
7/8/18	153.97	220.65	77.25	0.22	0.32	0.11	0.77	0.92	0.53	6.55	7.97	5.15	221,720		
Week:	148.58	236.15	61.04	0.21	0.34	0.09	0.75	1.01	0.45	6.44	8.33	4.86	1,497,705		
7/9/18	131.50	200.24	70.15	0.19	0.29	0.10	0.69	0.86	0.49	6.20	7.54	5.00	189,358		
Week:	131.50	200.24	70.15	0.19	0.29	0.10	0.69	0.86	0.49	6.20	7.54	5.00	189,358		
Totals:	151.91	262.72	61.04	0.22	0.38	0.09	0.77	1.05	0.45	6.43	8.33	4.85	4,156,198		

APPENDIX C

Channel Report

Project filename: 2019-11-12 Sewer Flows.stx

Studio Express by Hydrology Studio v 1.0.0.6

11-12-2019

Ex. 12" VCP Pipe

Channel 1

CIRCULAR PIPE

Diameter = 12.0 in
Invert Elevation = 95.71 ft
Pipe Slope = 0.044 %
Manning's n = 0.013

DISCHARGE

Method = Known Depth


known Depth = 0.50 ft

(Depth of flow for a 12" pipe per 2015 Camarillo Sanitary District standards)

CALCULATION SAMPLE

Flow	Depth	Area	Velocity	WP	n-value	Crit Depth	HGL	EGL	Max Shear	Top Width
(cfs)	(in)	(sqft)	(ft/s)	(ft)		(in)	(ft)	(ft)	(lb/sqft)	(ft)
0.37	6.0	0.39	0.95	1.57	0.013	3.1	96.2	96.22	0.01	1.00

166+/- gpm

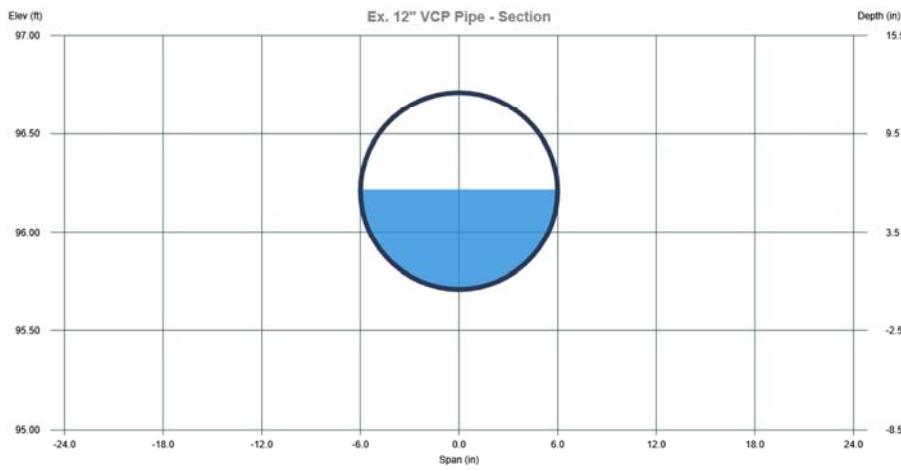

Channel Report

Project filename: 2019-11-12 Sewer Flows.stx

Studio Express by Hydrology Studio v 1.0.0.6

11-12-2019

Ex. 12" VCP Pipe

Channel 3

CIRCULAR PIPE

Diameter = 12.0 in
Invert Elevation = 95.71 ft
Pipe Slope = 0.044 %
Manning's n = 0.013


DISCHARGE

Method = Known Depth
known Depth = 0.54 ft
(Avg. Depth currently 6.5")

CALCULATION SAMPLE

Flow	Depth	Area	Velocity	WP	n-value	Crit Depth	HGL	EGL	Max Shear	Top Width
(cfs)	(in)	(sqft)	(ft/s)	(ft)		(in)	(ft)	(ft)	(lb/sqft)	(ft)
0.43	6.5	0.43	0.98	1.65	0.013	3.2	96.3	96.27	0.01	1.00

191+/- gpm

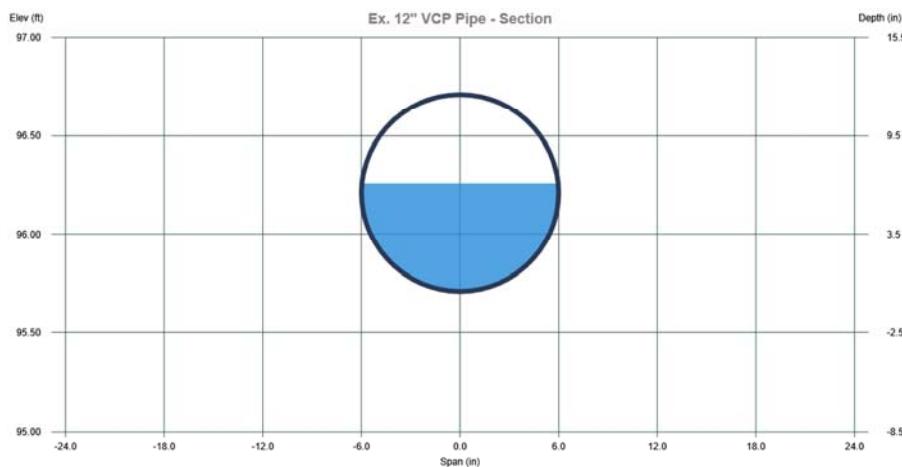

APPENDIX D

Channel Report

Project filename: 2019-11-12 Sewer Flows.stx

Studio Express by Hydrology Studio v 1.0.0.6

11-12-2019


Ex. 12" VCP Pipe with Additional Flow

Channel 5

CIRCULAR PIPE		DISCHARGE	
Diameter	= 12.0 in	Method	= Known Q
Invert Elevation	= 95.71 ft	Known Q	= 0.65 cfs
Pipe Slope	= 0.044 %		
Manning's n	= 0.013		

CALCULATION SAMPLE

Flow	Depth	Area	Velocity	WP	n-value	Crit Depth	HGL	EGL	Max Shear	Top Width
(cfs)	(in)	(sqft)	(ft/s)	(ft)		(in)	(ft)	(ft)	(lb/sqft)	(ft)
0.65	8.8	0.61	1.06	2.05	0.013	4.1	96.4	96.46	0.02	0.89

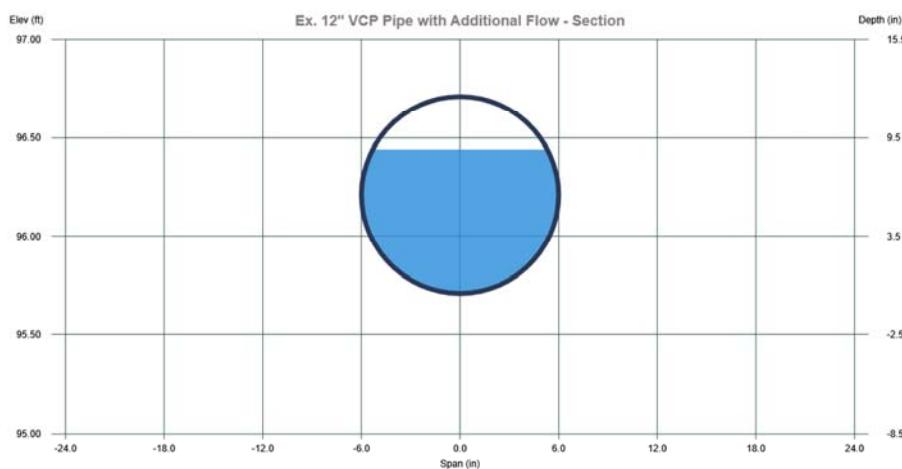

Channel Report

Project filename: 2019-11-12 Sewer Flows.stx

Studio Express by Hydrology Studio v 1.0.0.6

11-12-2019

New. 15" PVC Pipe with Additional Flow

Channel 5

CIRCULAR PIPE


Diameter = 15.0 in
Invert Elevation = 95.71 ft
Pipe Slope = 0.044 %
Manning's n = 0.012

DISCHARGE

Method = Known Q
Known Q = 0.65 cfs

CALCULATION SAMPLE


Flow	Depth	Area	Velocity	WP	n-value	Crit Depth	HGL	EGL	Max Shear	Top Width
(cfs)	(in)	(sqft)	(ft/s)	(ft)		(in)	(ft)	(ft)	(lb/sqft)	(ft)
0.65	7.1	0.57	1.14	1.89	0.012	3.8	96.3	96.32	0.02	1.25

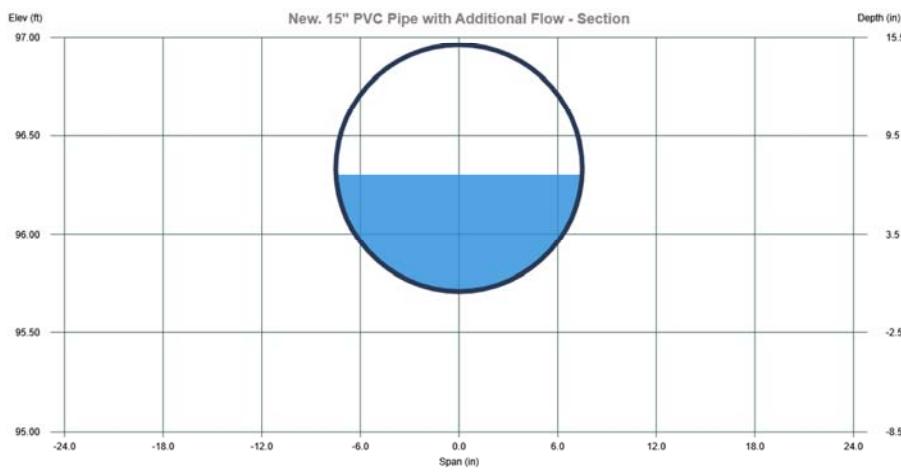

APPENDIX E

CITY OF CAMARILLO

CAMARILLO SANITARY DISTRICT

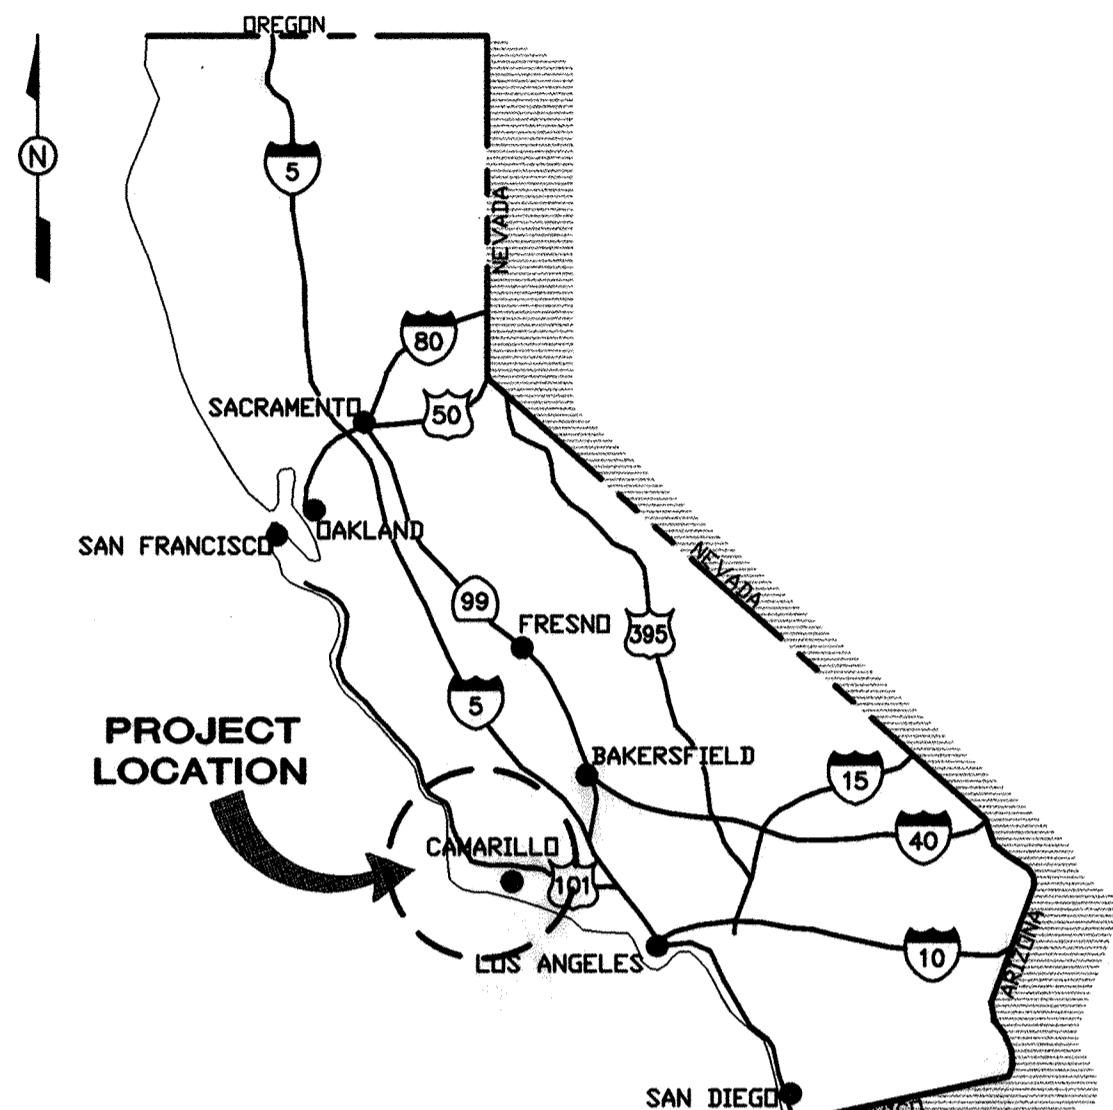

VICINITY MAP



CONEJO CREEK 12" VCP SEWER LINE JOB NUMBER SS-91-1

1999

INDEX OF DRAWINGS

CITY OF CAMARILLO DWG. NO.	SHEET NO.	DRAWING NO.	DESCRIPTION OF DRAWINGS
C-11254	1	G-1	COVER, SITE, AND LOCATION MAPS, INDEX
C-11255	2	G-2	SYMBOLS, ABBREV. & CONSTRUCTION NOTES
C-11256	3	G-3	AERIAL PHOTO
C-11257	4	P-1	PIPING PLAN AND PROFILE
C-11258	5	P-2	PIPING PLAN AND PROFILE
C-11259	6	P-3	PIPING PLAN AND PROFILE
C-11260	7	P-4	PIPING PLAN AND PROFILE
C-11261	8	S-1	STRUCTURAL NOTES
C-11262	9	S-2	SEWER DIVERSION BOX
C-11262A	9A	S-2A	SEWER DIVERSION BOX
C-11263	10	D-1	DETAILS
C-11264	11	D-2	DETAILS
C-11264A	12	D-3	DETAILS

DIRECTOR OF ENGINEERING SERVICES

RCE 22261 EX. DATE 9-30-01 DATE

REVIEWED: _____
DIRECTOR OF PUBLIC SERVICES

REVIEWED: _____
SANITARY DISTRICT SUPERINTENDANT

RECOMMENDED: _____
CITY CAPITAL PROJECTS ENGINEER

COORDINATES AND BEARINGS ARE BASED UPON CALIFORNIA COORDINATE SYSTEM, NORTH AMERICAN DATUM OF 1927 (U.S. SURVEY FEET), AS SHOWN ON VENTURA COUNTY FIELD BOOK 1937-A, PAGE 143, AND VENTURA COUNTY HORIZONTAL CONTROL DATA BOOK 236-1692, PAGE 5.

PT. NO. 1 ("CON 83-7"):
N 254176.460 E 198267.260 ELEV. 151.82'
CONCRETE NAIL, NO TAG, IN TOP OF BIG BOULDER.


PT. NO. 3:
N 253765.811 E 1894194.580 ELEV. 190.789'
2" BRASS DISC IN CONCRETE, FLUSH.

PT. NO. 998 ("CC-1"):
N 251812.100 E 1693931.730 ELEV. 99.03'
BRASS DISC STAMPED "CC-1 1971" SET IN CONCRETE, DOWN 0.5'.

BENCHMARK:
B.M. NO. CC-1 NAVD 1929 ELEVATION=99.03'
FOUND A VENTURA COUNTY STANDARD BRASS DISC STAMPED "CC-1 1971"
SET IN CONCRETE CORE DOWN 0.5'.
NORTH OF CONEJO CREEK AND 23'± WEST OF PANCHO ROAD.


A MINIMUM OF 48 HRS PRIOR TO
THE START OF THE CONSTRUCTION

Call
UNDERGROUND
SERVICE
ALERT
1-800-422-4133

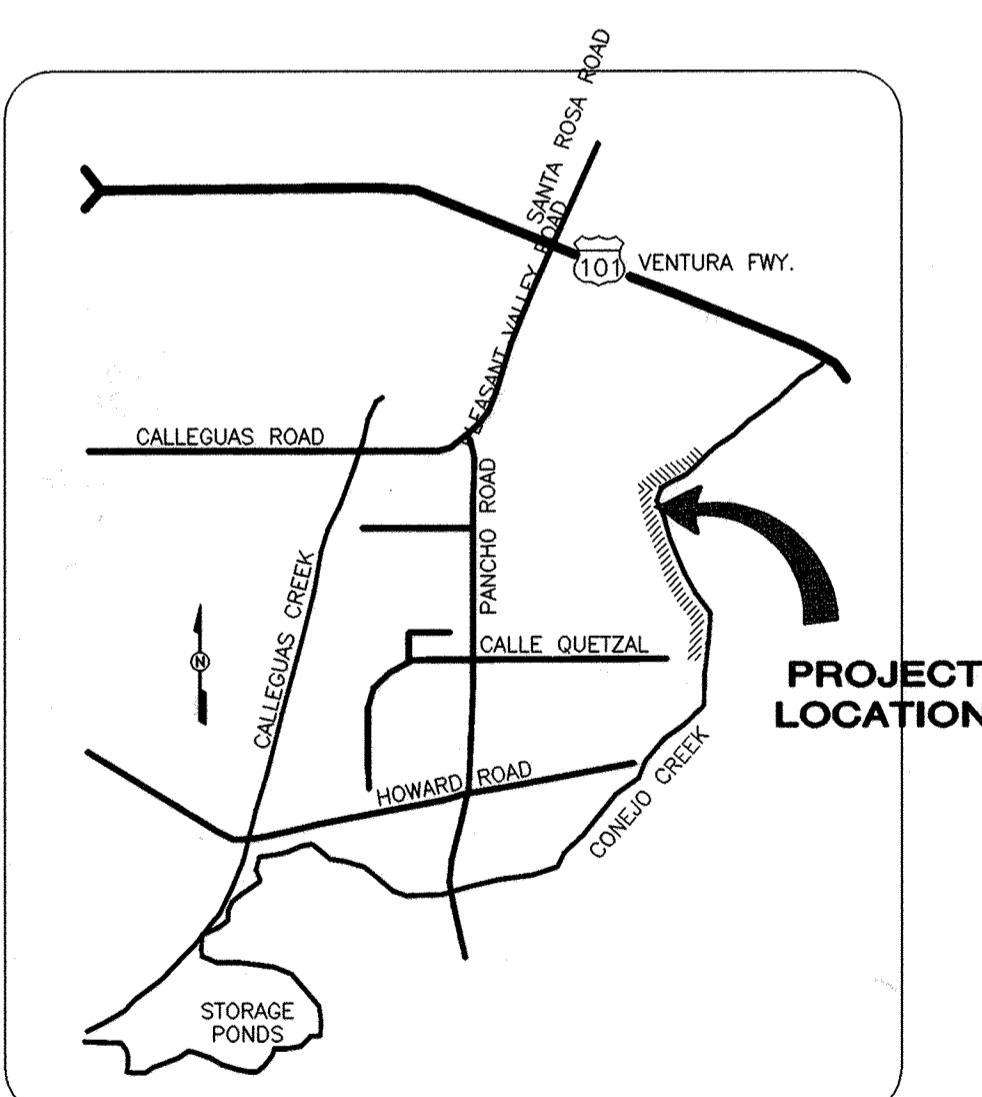

LOCATION MAP
NOT TO SCALE

RECORD DRAWING
THESE RECORD DRAWINGS HAVE BEEN
PREPARED BASED IN PART ON
INFORMATION PROVIDED BY OTHERS

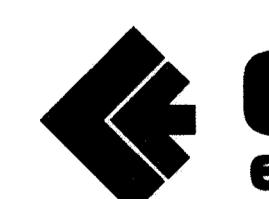 **CAROLLO**
e n g i n e e r s


ALLEN C. TODD, PRINCIPAL

3100 SOUTH HARBOR BLVD, SUITE 200
SANTA ANA, CALIFORNIA 92704
TEL. (714)-540-4300



CITY OF CAMARILLO DRAWING NUMBER C-11254

GENERAL NOTES

1. SECTION 4212/4217 OF THE GOVERNMENT CODE REQUIRES A DIG ALERT IDENTIFICATION NUMBER TO BE ISSUED BEFORE A PERMIT TO EXCAVATE WILL BE VALID. CALL FOR DIG ALERT ID NUMBER:


UNDERGROUND SERVICE ALERT
TOLL FREE 1-800-422-4133

A MINIMUM OF TWO WORKING DAYS BEFORE DIGGING PRIOR TO THE START OF CONSTRUCTION. FOR BEST RESPONSE, PROVIDE AS MUCH NOTICE AS POSSIBLE, UP TO TEN (10) WORKING DAYS.


2. CONTRACTOR SHALL POTHOLE ALL CROSSING AND CONNECTING UTILITIES BEFORE STARTING CONSTRUCTION AND PROVIDE ELEVATIONS OF TOP OF PIPE, SIZE OF PIPE, AND INVERT OF PIPE TO ENGINEER. POTHOLE SHALL BE IMMEDIATELY FILLED, INCLUDING PAVEMENT, AS SOON AS MEASUREMENTS ARE TAKEN.

A. CONTRACTOR SHALL PROTECT ALL EXISTING UTILITIES (WATER AND DRAINAGE SERVICES AND ACCESS ROADS, ETC.) DURING CONSTRUCTION AND ENSURE THEY REMAIN IN PLACE AND OPERATIONAL.

3. THE DISTRICT TO ACQUIRE ALL ENCROACHMENT PERMITS PRIOR TO CONSTRUCTION.
4. ALL WORK SHALL BE DONE IN ACCORDANCE WITH THE SPECIFICATIONS AND PLANS OF THE CITY OF CAMARILLO AND THE STANDARD SPECIFICATIONS FOR PUBLIC WORKS CONSTRUCTION, LATEST EDITION, WHERE NOT COVERED BY THE FORMER, AND SHALL BE COMPLETED TO THE SATISFACTION OF THE CITY ENGINEER.
5. WORK MUST BE PERFORMED TO THE SATISFACTION OF THE CITY ENGINEER.
6. THE CONTRACTOR SHALL NOTIFY THE DISTRICT AT LEAST ONE WORKING DAY PRIOR TO BEGINNING OF CONSTRUCTION AT 1-805-482-4677 AND CAMARILLO SANITARY DISTRICT AT (805) 388-5332.
7. THE CONTRACTOR SHALL PRACTICE SAFETY AT ALL TIMES AND SHALL FURNISH, ERECT, AND MAINTAIN SUCH FENCES, BARRICADES, LIGHTS, AND SIGNS NECESSARY TO GIVE ADEQUATE PROTECTION TO THE PUBLIC AT ALL TIMES. TEMPORARY TRAFFIC CONTROL SHALL BE APPROVED BY THE CITY OF CAMARILLO CITY ENGINEER.
8. ALL EXCAVATIONS OR TRENCHES IN PAVED AREAS SHALL REQUIRE SAWCUTTING IN A NEAT AND UNIFORM MANNER. ALL MATCH OR JOIN LINES TO EXISTING ASPHALTIC CONCRETE PAVING WITHOUT REDWOOD HEADERS SHALL BE SAW CUT.
9. ALL SEWER CROSSINGS OF PUBLIC WATER MAINS SHALL BE IN ACCORDANCE WITH STATE HEALTH SERVICE STANDARDS.
10. CONTRACTOR TO LOCATE, PROTECT, AND REPAIR AT HIS EXPENSE, ANY UTILITIES DAMAGED BY HIS FORCES.
11. THESE PLANS SHALL INCLUDE ALL AS-BUILT REVISIONS PRIOR TO THE ACCEPTANCE BY THE CAMARILLO SANITARY DISTRICT.

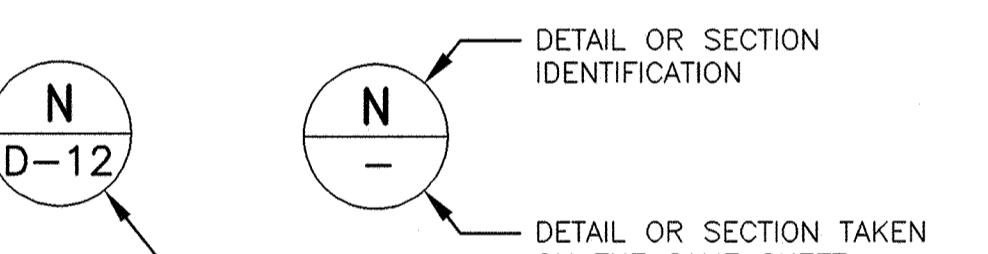

AT TITLE

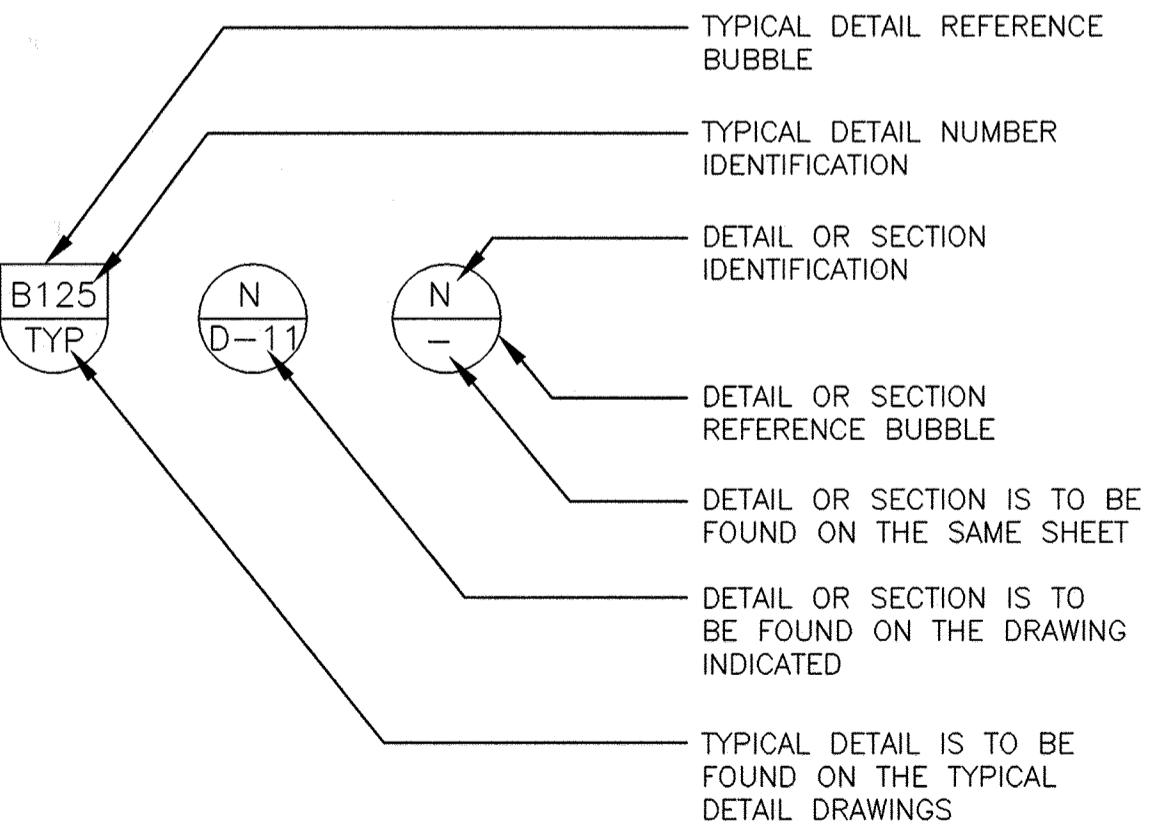


DRAWING INDEX MAP

A

1"

= 600'

AT CROSS REFERENCE

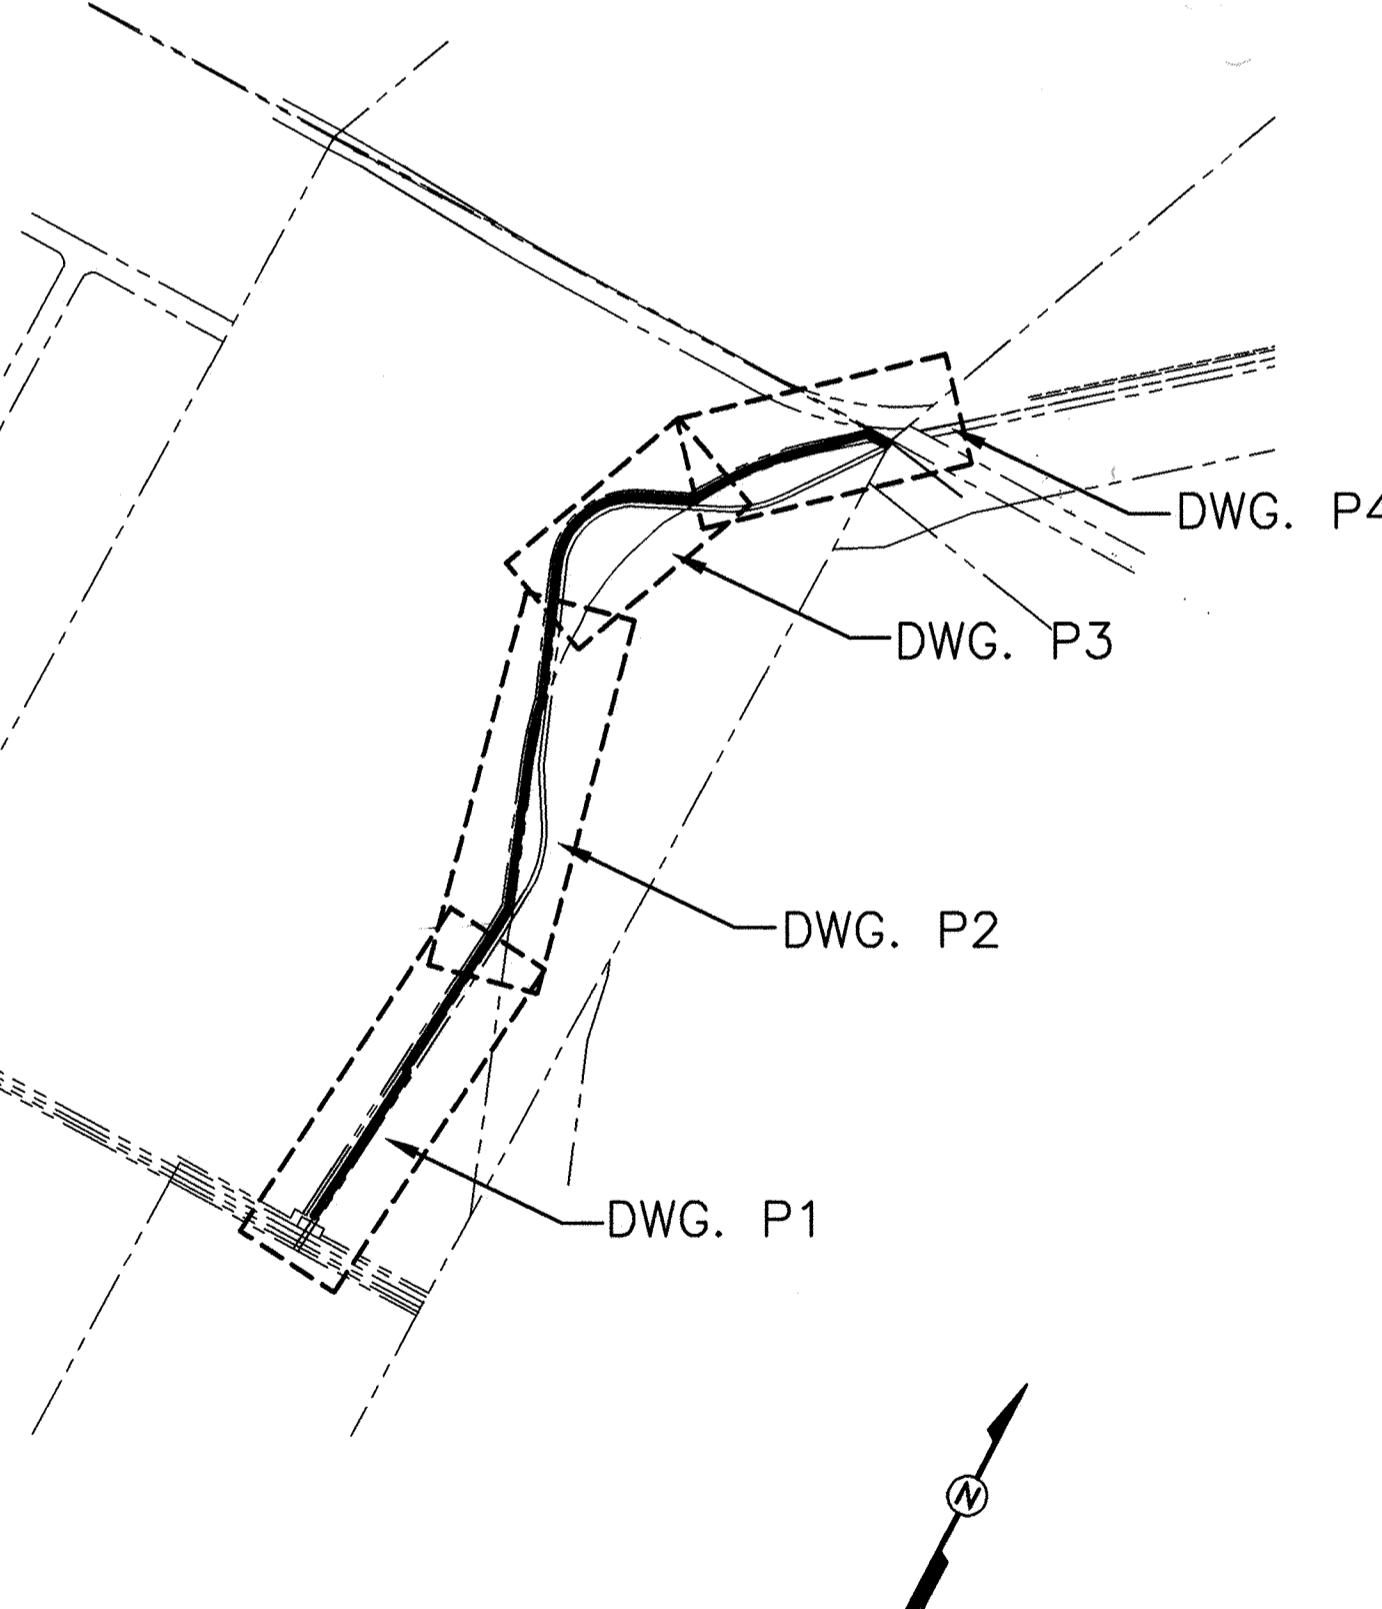

ABBREVIATIONS

AC	ASPHALT CONCRETE PAVEMENT	EXISTING SEWER
ACP	ASBESTOS CEMENT PIPE	NEW SEWER
BC	BEGINNING OF CURVATURE	ABANDONED SEWER
BF	BLIND FLANGE	EXISTING GAS
BFV	BUTTERFLY VALVE	
CI	CAST IRON	EXISTING UNDERGROUND GTE DUCT
CL OR CL	CENTER LINE	
CLF	CHAIN LINK FENCE	
CLR	CLEAR	EXISTING UNDERGROUND ELECTRICAL
CMLC	CEMENT MORTAR LINED & COATED	
CO	CLEANOUT	EXISTING OVERHEAD ELECTRICAL
CONC	CONCRETE	
CONST	CONSTRUCT	EXISTING WATER MAIN
D	DIAMETER OF PIPE	EXISTING WATER GATE VALVE
DIA	DIAMETER	
DIP	DUCTILE IRON PIPE	EXISTING STORM DRAIN
DP	DIVERSION PIPELINE	EASEMENT
DWG	DRAWING	
E	EAST	EXISTING CONTOURS
EA	EACH	
EC	END OF CURVATURE	EXISTING SPOT ELEVATIONS
EL	ELEVATION	
ESMT	EASEMENT	FENCE
EW	EACH WAY	LIGHT POLE
EXIST	EXISTING	
FC	FLEXIBLE COUPLING	EXISTING MANHOLE
FH	FIRE HYDRANT	
FT	FOOT	FIRE HYDRANT
HORIZ	HORIZONTAL	
HPP	HIGH PRESSURE PIPELINE	PROPERTY LINE
ID	INSIDE DIAMETER	
IE	INVERT ELEVATION	RIGHT OF WAY
IN OR "	INCH	
INV	INVERT	
LP	LIGHT POLE	
LT	LEFT	
MAX	MAXIMUM	
MIN	MINIMUM	
MH	MANHOLE	
N	NORTH	
N/A	NOT APPLICABLE	
NO OR #	NUMBER	
NT'D	NOTED	
NTS	NOT TO SCALE	
PERM	PERMANENT	
OD	OUTSIDE DIAMETER	
OH	OVERHEAD	
PL OR P L	PROPERTY LINE	
PT	POINT	
PVC	POLYVINYL CHLORIDE	
PVCWD	PLEASANT VALLEY COUNTY WATER DISTRICT	
RCP	REINFORCED CONCRETE PIPE	
REINF	REINFORCEMENT,	
REQD	REINFORCING	
REV	REQUIRED	
RT	REVISION	
R/W	RIGHT	
VCFCD	RIGHT OF WAY	
S	VENTURA COUNTY FLOOD CONTROL DISTRICT	
SF	SOUTH, SLOPE	
SL	SQUARE FEET	
STA	SURVEY LINE	
STD	STATION	
TEMP	STANDARD	
TBM	TEMPORARY	
TYP	TEMPORARY BENCH MARK	
UNO	TYPICAL	
UG	UNLESS NOTED OTHERWISE	
VERT	UNDERGROUND	
W	VERTICAL	
	WEST	

SYMBOL LEGEND

S	12" VCP SEWER
S	12" VCP SEWER
G	EXISTING GAS
T	EXISTING UNDERGROUND GTE DUCT
E(UG)	EXISTING UNDERGROUND ELECTRICAL
E(OH)	EXISTING OVERHEAD ELECTRICAL
W	EXISTING WATER MAIN
15" SD	EXISTING WATER GATE VALVE
308	EXISTING STORM DRAIN
308.2	EXISTING SPOT ELEVATIONS
X	FENCE
LP	LIGHT POLE
O	EXISTING MANHOLE
FH	FIRE HYDRANT
R	PROPERTY LINE
R/W	RIGHT OF WAY

DIRECTOR OF ENGINEERING SERVICES

RCE 22261 EX. DATE 9-30-01 DATE


REVIEWED: DIRECTOR OF PUBLIC SERVICES

REVIEWED: SANITARY DISTRICT SUPERINTENDANT

RECOMMENDED: CITY CAPITAL PROJECTS ENGINEER

RECORD DRAWING

THESE RECORD DRAWINGS HAVE BEEN PREPARED BASED IN PART ON INFORMATION PROVIDED BY OTHERS

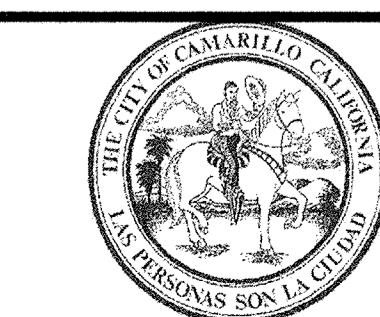

CITY OF CAMARILLO

CAMARILLO SANITARY DISTRICT

CONEJO CREEK 12" VCP SEWER LINE
SYMBOLS, ABBREV., CONSTRUCTION NOTES
AND DRAWING INDEX MAP

APPROVED

CITY OF CAMARILLO
DRAWING NUMBER


C-1125

DRAWING NUMBER

G-2

SHT. 2 OF 12

REVISIONS			
NO.	DATE	INITIAL	DESCRIPTION
			APP'D.
			SCALE AS NOTED
			DESIGNED RJE
			DRAWN MAC
			CHECKED DRJ
			DATE AUG. 1999

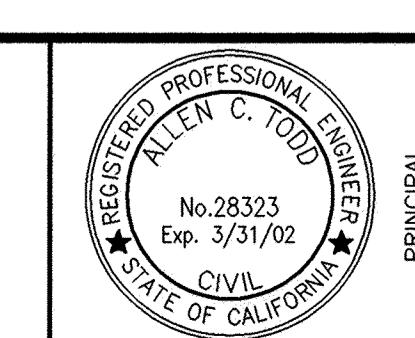

PRINCIPAL


VERIFY SCALES

BAR IS ONE INCH ON ORIGINAL DRAWING

0 _____ 1"

IF NOT ONE INCH ON THIS SHEET, ADJUST SCALES ACCORDINGLY



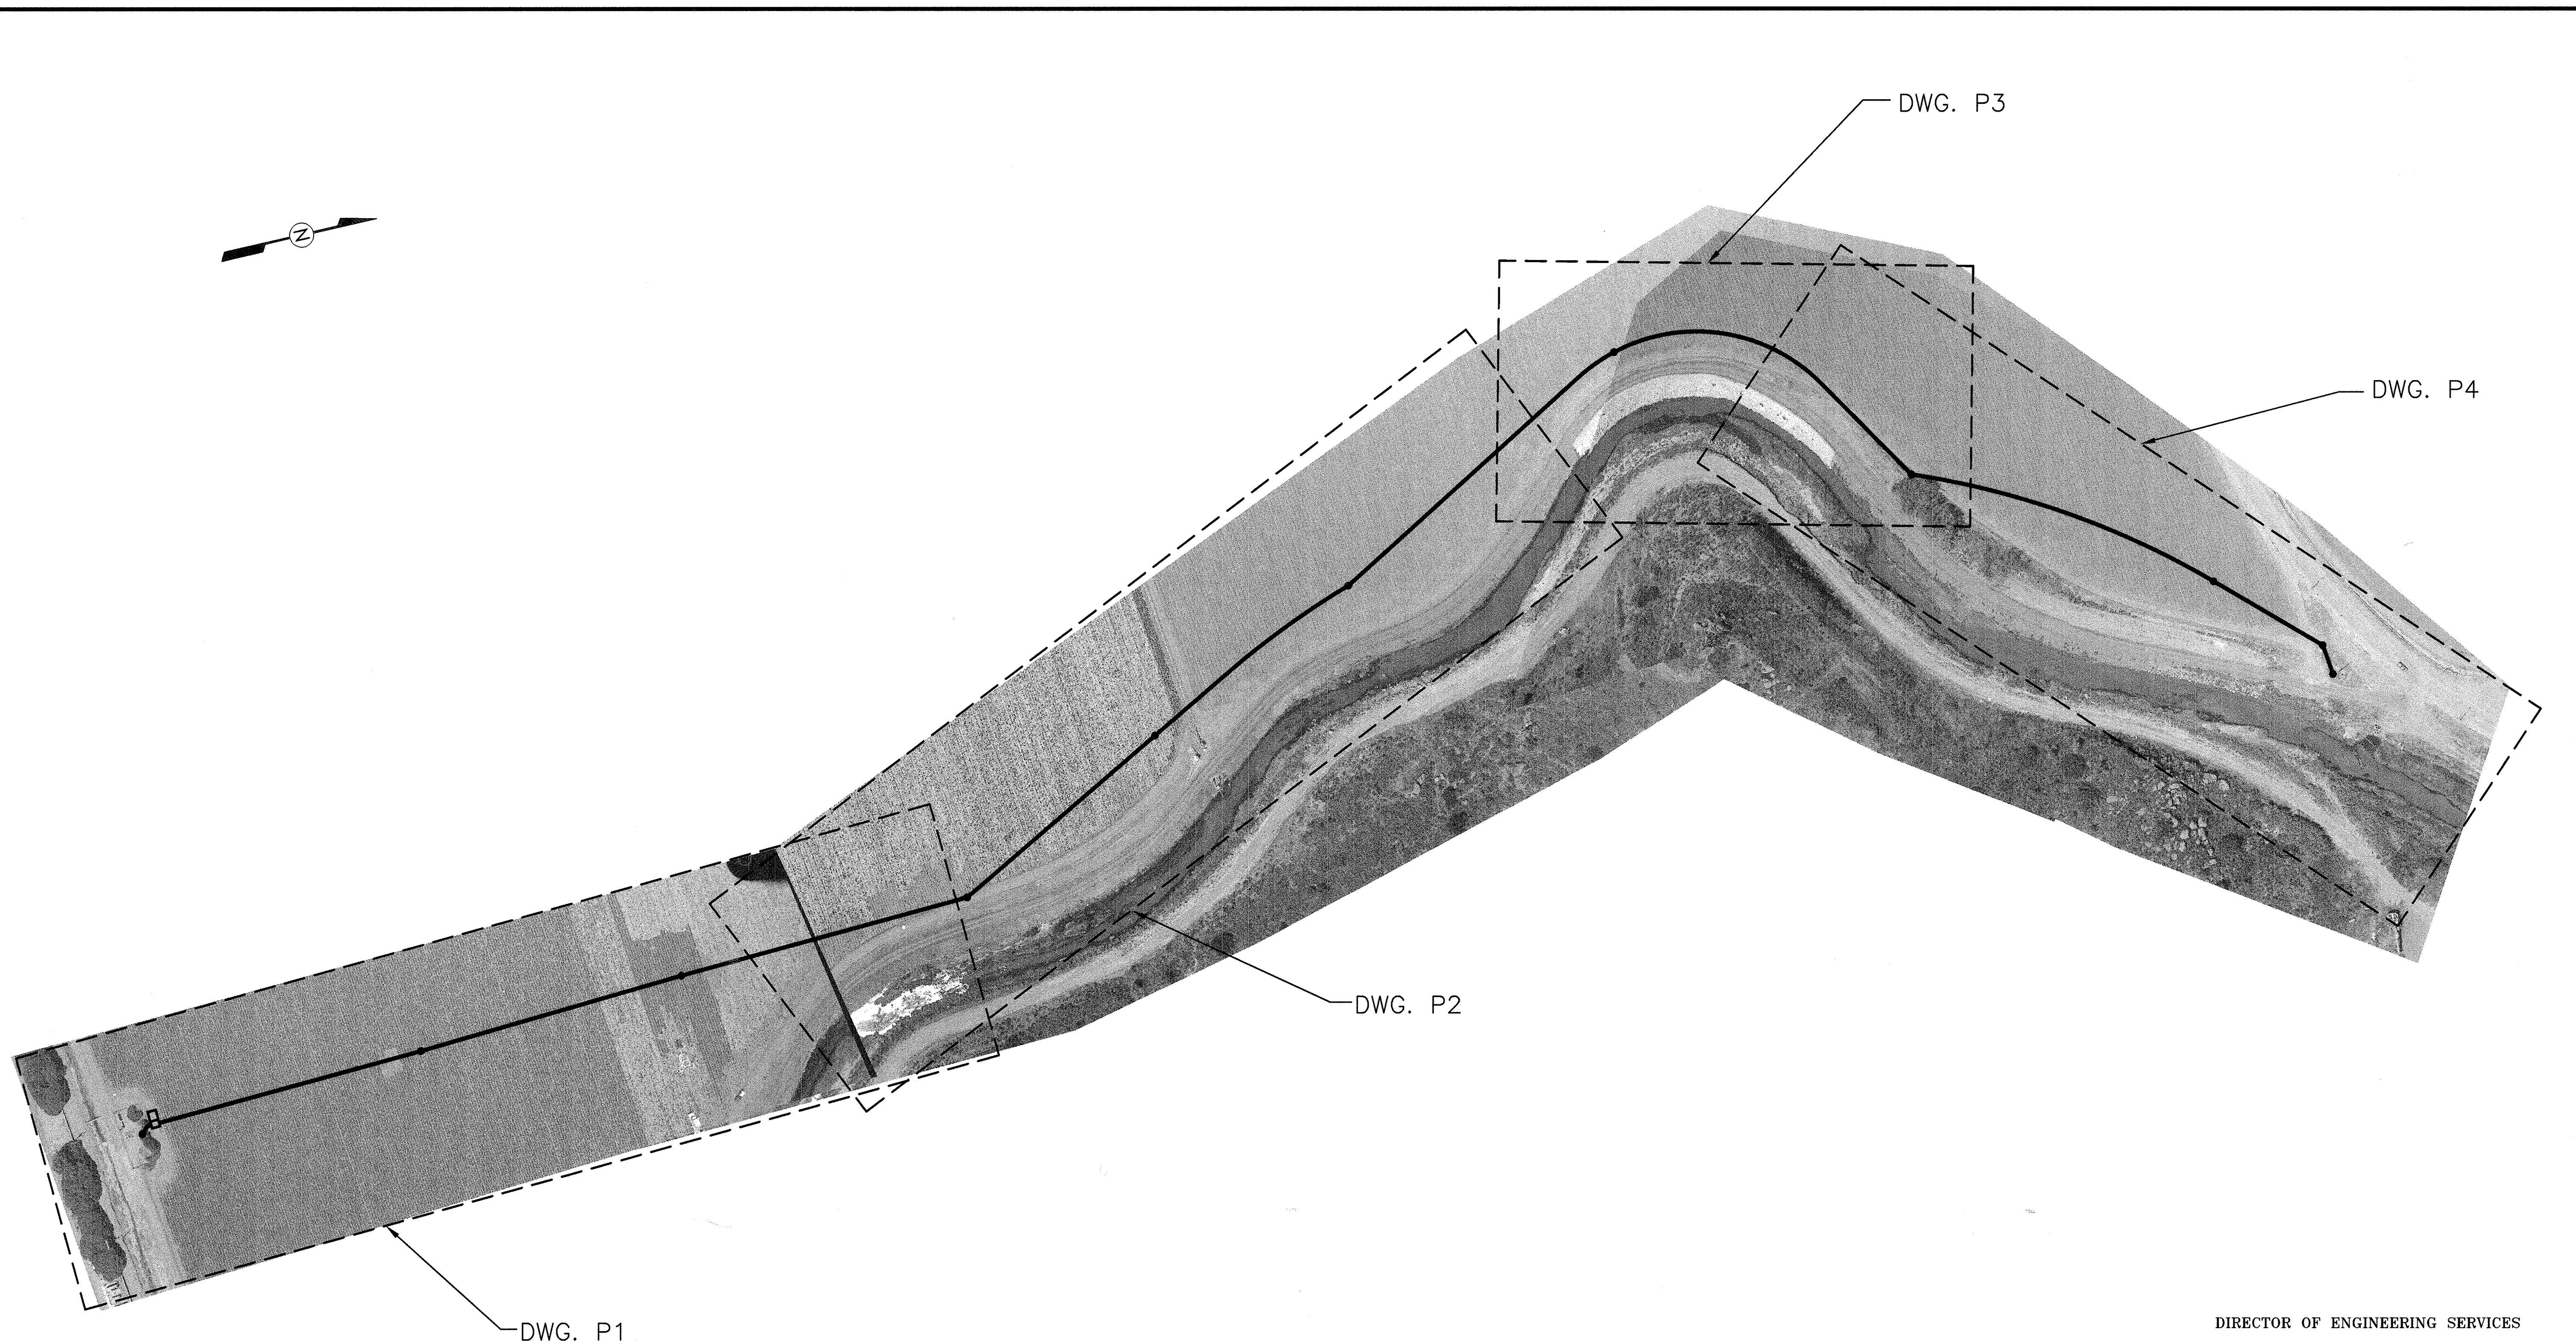

DIRECTOR OF ENGINEERING SERVICES

RCE 22261 EX. DATE 9-30-01 DATE

REVIEWED: DIRECTOR OF PUBLIC SERVICES

REVIEWED: SANITARY DISTRICT SUPERINTENDANT


RECOMMENDED: CITY CAPITAL PROJECTS ENGINEER

RECORD DRAWING
THESE RECORD DRAWINGS HAVE BEEN
PREPARED BASED IN PART ON
INFORMATION PROVIDED BY OTHERS

REVISIONS			
NO.	DATE	INITIAL	DESCRIPTION
			APPVD.


SCALE
DESIGNED RJE
DRAWN CAT
CHECKED DRJ
DATE AUG. 1999

PRINCIPAL

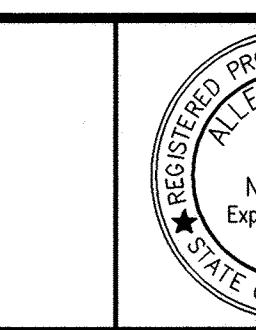

VERIFY SCALES
BAR IS ONE INCH ON
ORIGINAL DRAWING
0 1"

IF NOT ONE INCH ON
THIS SHEET, ADJUST
SCALES ACCORDINGLY

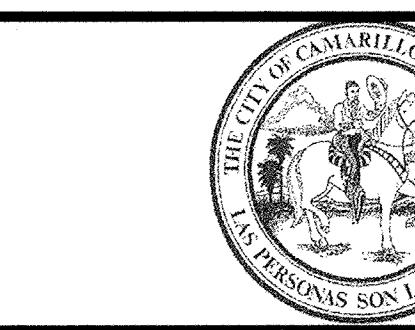

CITY OF CAMARILLO
Camarillo Sanitary District
CONEJO CREEK 12" VCP SEWER LINE
AERIAL PHOTO

CITY OF CAMARILLO
DRAWING NUMBER
C-11256

DRAWING NUMBER
G-3

SHT. **3 OF 12**

APPROVED

H:\Client\Camarillo_SA0\4843A10\Dwg\Record\RCP04003 11/14/00 10:58 pbocciarelli XREFS: CAMBRD, ALIGNMENT, RCPRF003, CAMROSA, X-UTIL, BRIDGE

RECORD DRAWING

THESE RECORD DRAWINGS HAVE
PREPARED BASED IN PART
INFORMATION PROVIDED BY OTHERS.

NOTE:

- 1 SUPPORT EXISTING PIPE IN PLACE
- 2 CONSTRUCT FENCING PER AMERICAN PUBLIC WORKS ASSOCIATION STANDARD PLANS FOR PUBLIC WORKS CONSTRUCTION, STANDARD PLAN 600 AND STANDARD SPECIFICATIONS FOR PUBLIC WORKS CONSTRUCTION, 1997 EDITION, FENCE HEIGHT SHALL MATCH EXISTING FENCING

- \diamondsuit N=255200.6± E=69757.42
 - \diamondsuit N=255563.95 E=697492.16
 - \diamondsuit N=255927.93 E=697518.93
 - \diamondsuit N=255187.65 E=697456.29
 - \diamondsuit N=255179.5± E=697445.54
 - \diamondsuit N=255175.02 E=697466.88

DIRECTOR OF ENGINEERING SERVICES



RCE 22261 EX. DATE 9-30-01 DATE

VIEWED: _____
DIRECTOR OF PUBLIC SERVICES

VIEWED: _____
SANITARY DISTRICT SUPERINTENDANT

RECOMMENDED: _____
CITY CAPITAL PROJECTS ENGINEER

ADAMSON PROPERTY

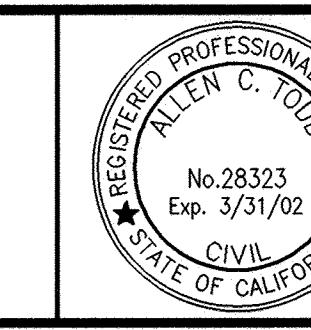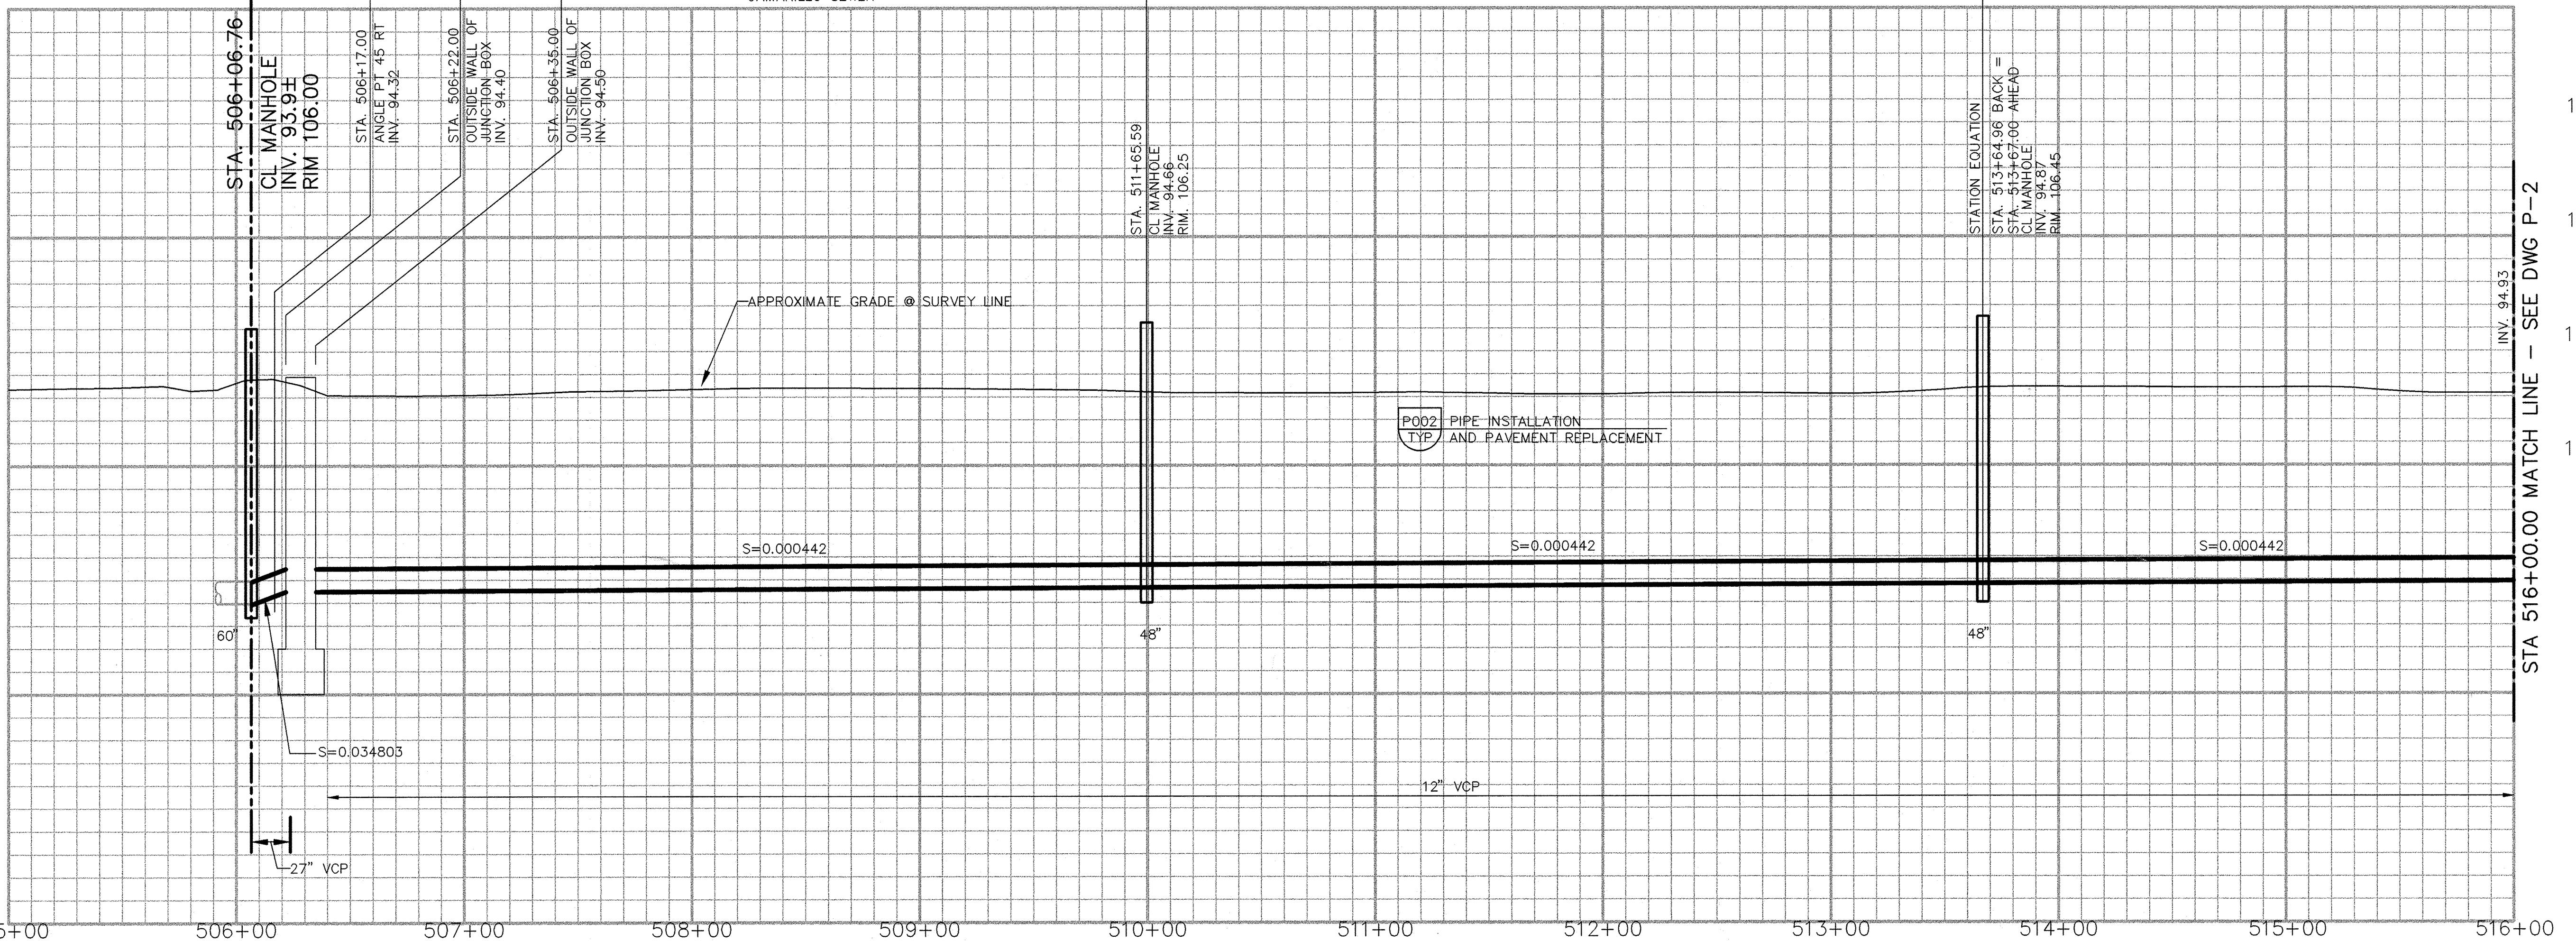


VERIFY SCALES ACCURATELY

BAR IS ONE INCH LONG

PRINCIPAL SCALE

0

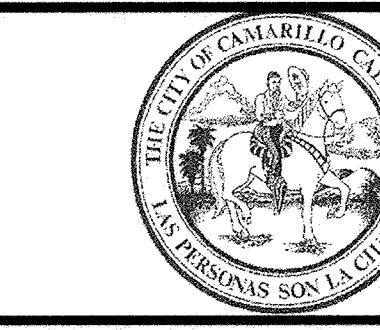

CITY OF CAMARILLO
CAMARILLO SANITARY DISTRICT
EJO CREEK 12" VCP SEWER LINE
PLAN & PROFILE

APPROVED _____

OF CAMARILLO
NG NUMBER
-11257
NG NUMBER
P-1
4 OF 12

SCALES:

- 1 N=256325.79 E=697553.6
- 2 N=256638.49 E=697437.3
- 3 N=256763.09 E=697391.01
- 4 N=256952.52 E=697338.5

 A  = $9^\circ 49'$ 3
 R = 1147.50'
 L = 196.82'

NOTE: ① SUPPORT EXISTING PIPE IN PLACE

RECORD DRAWING

THESE RECORD DRAWINGS HAVE BEEN
PREPARED BASED IN PART ON
INFORMATION PROVIDED BY OTHERS




DIRECTOR OF ENGINEERING SERVICES

RCE 22261 EX. DATE 9-30-01 DATE

VIEWED: _____


VIEWED: _____ **SANITARY DISTRICT SUPERINTENDANT**

RECOMMENDED: _____
CITY CAPITAL PROJECTS ENGINEER

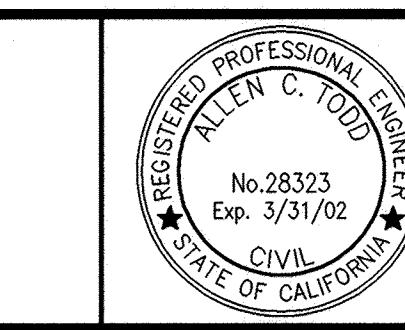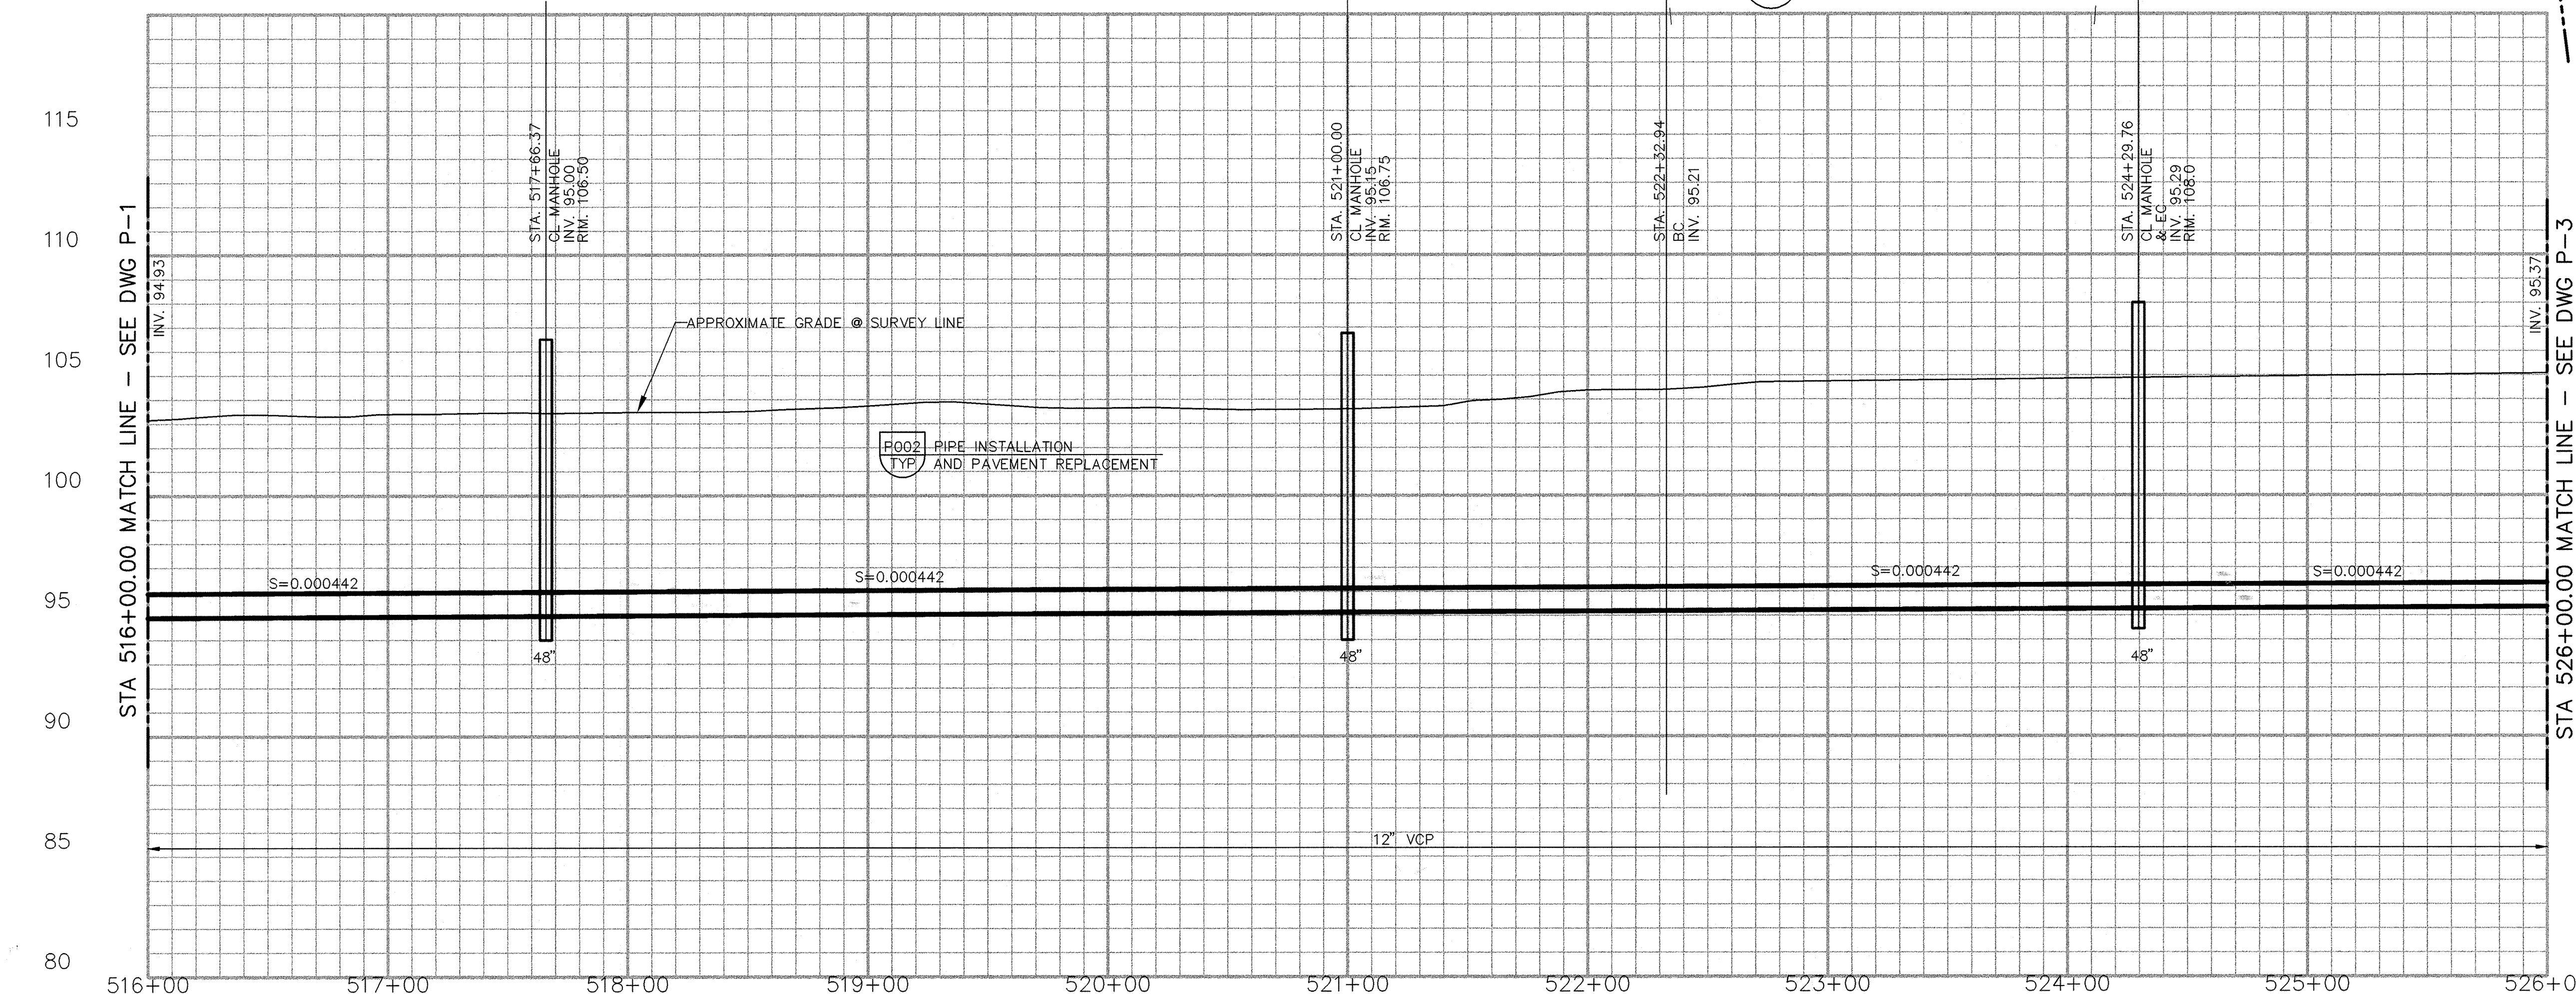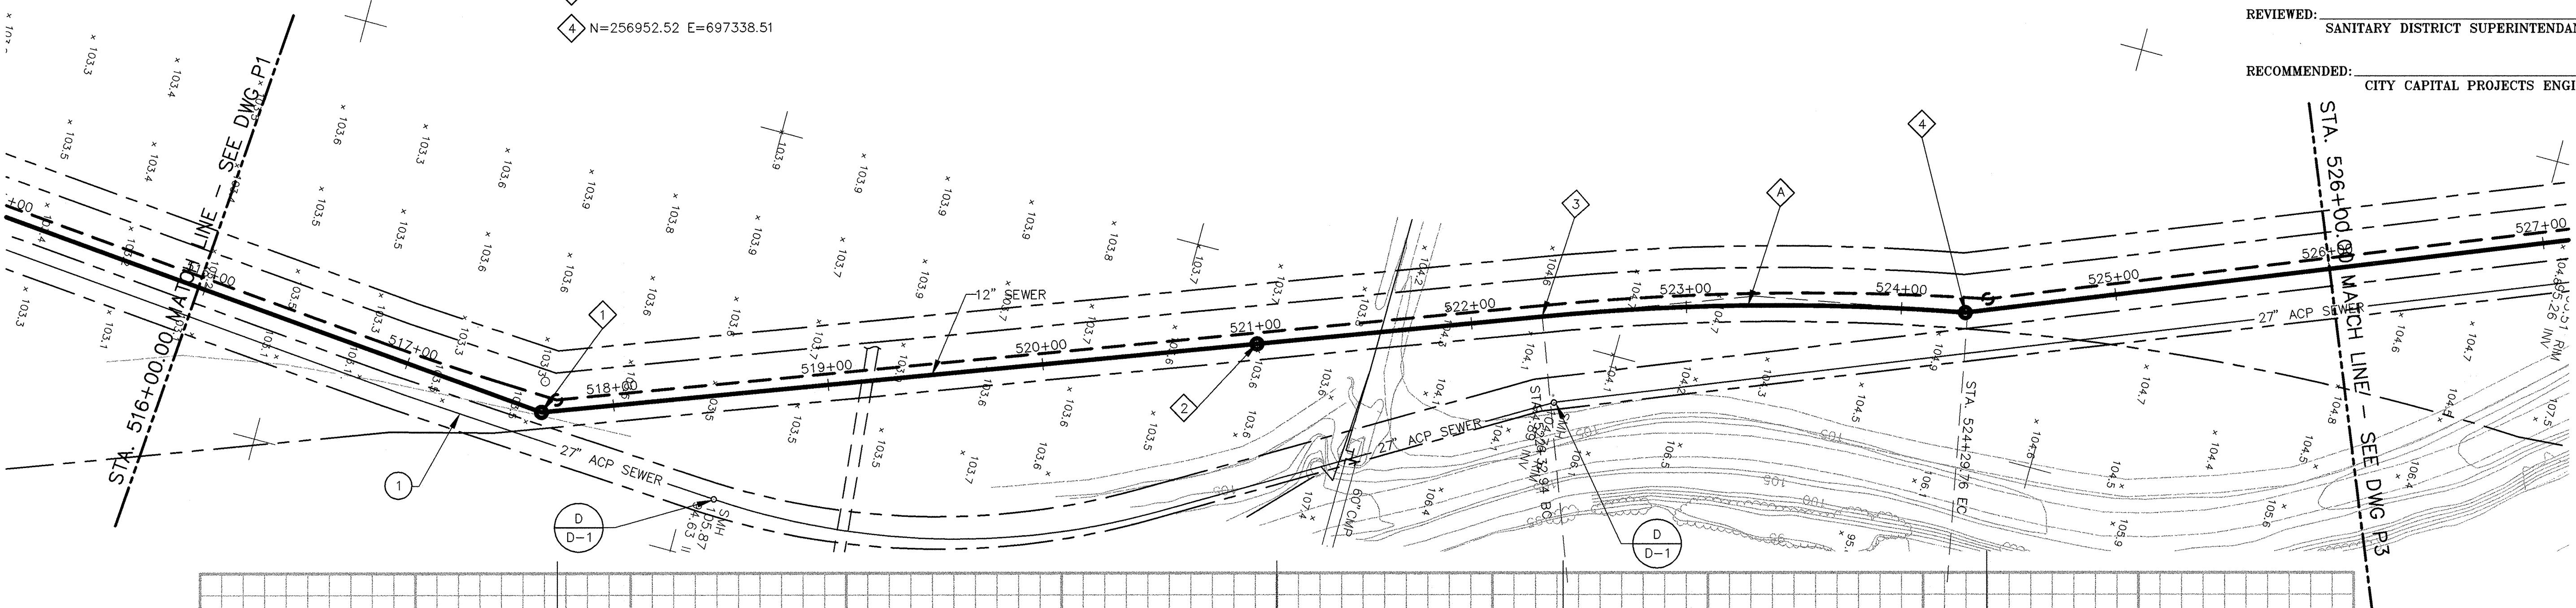

VERIFY SCAN

PRINCIPAL
BAR IS ONE INCH
ORIGINAL DRAWING
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IF NOT ONE INCH
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CITY OF CAMARILLO

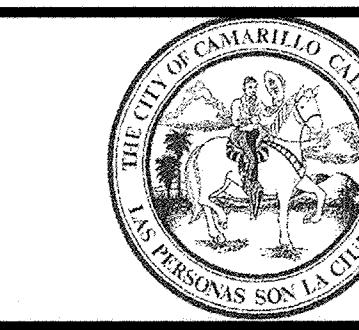
CAMARILLO SANITARY DISTRICT
EJO CREEK 12" VCP SEWER LINE
PLAN A PROFILE

— 1 —


CITY OF CAMARILLO
DRAWING NUMBER
C-11258

DRAWING NUMBER
P-2

SHT. 5 OF 12

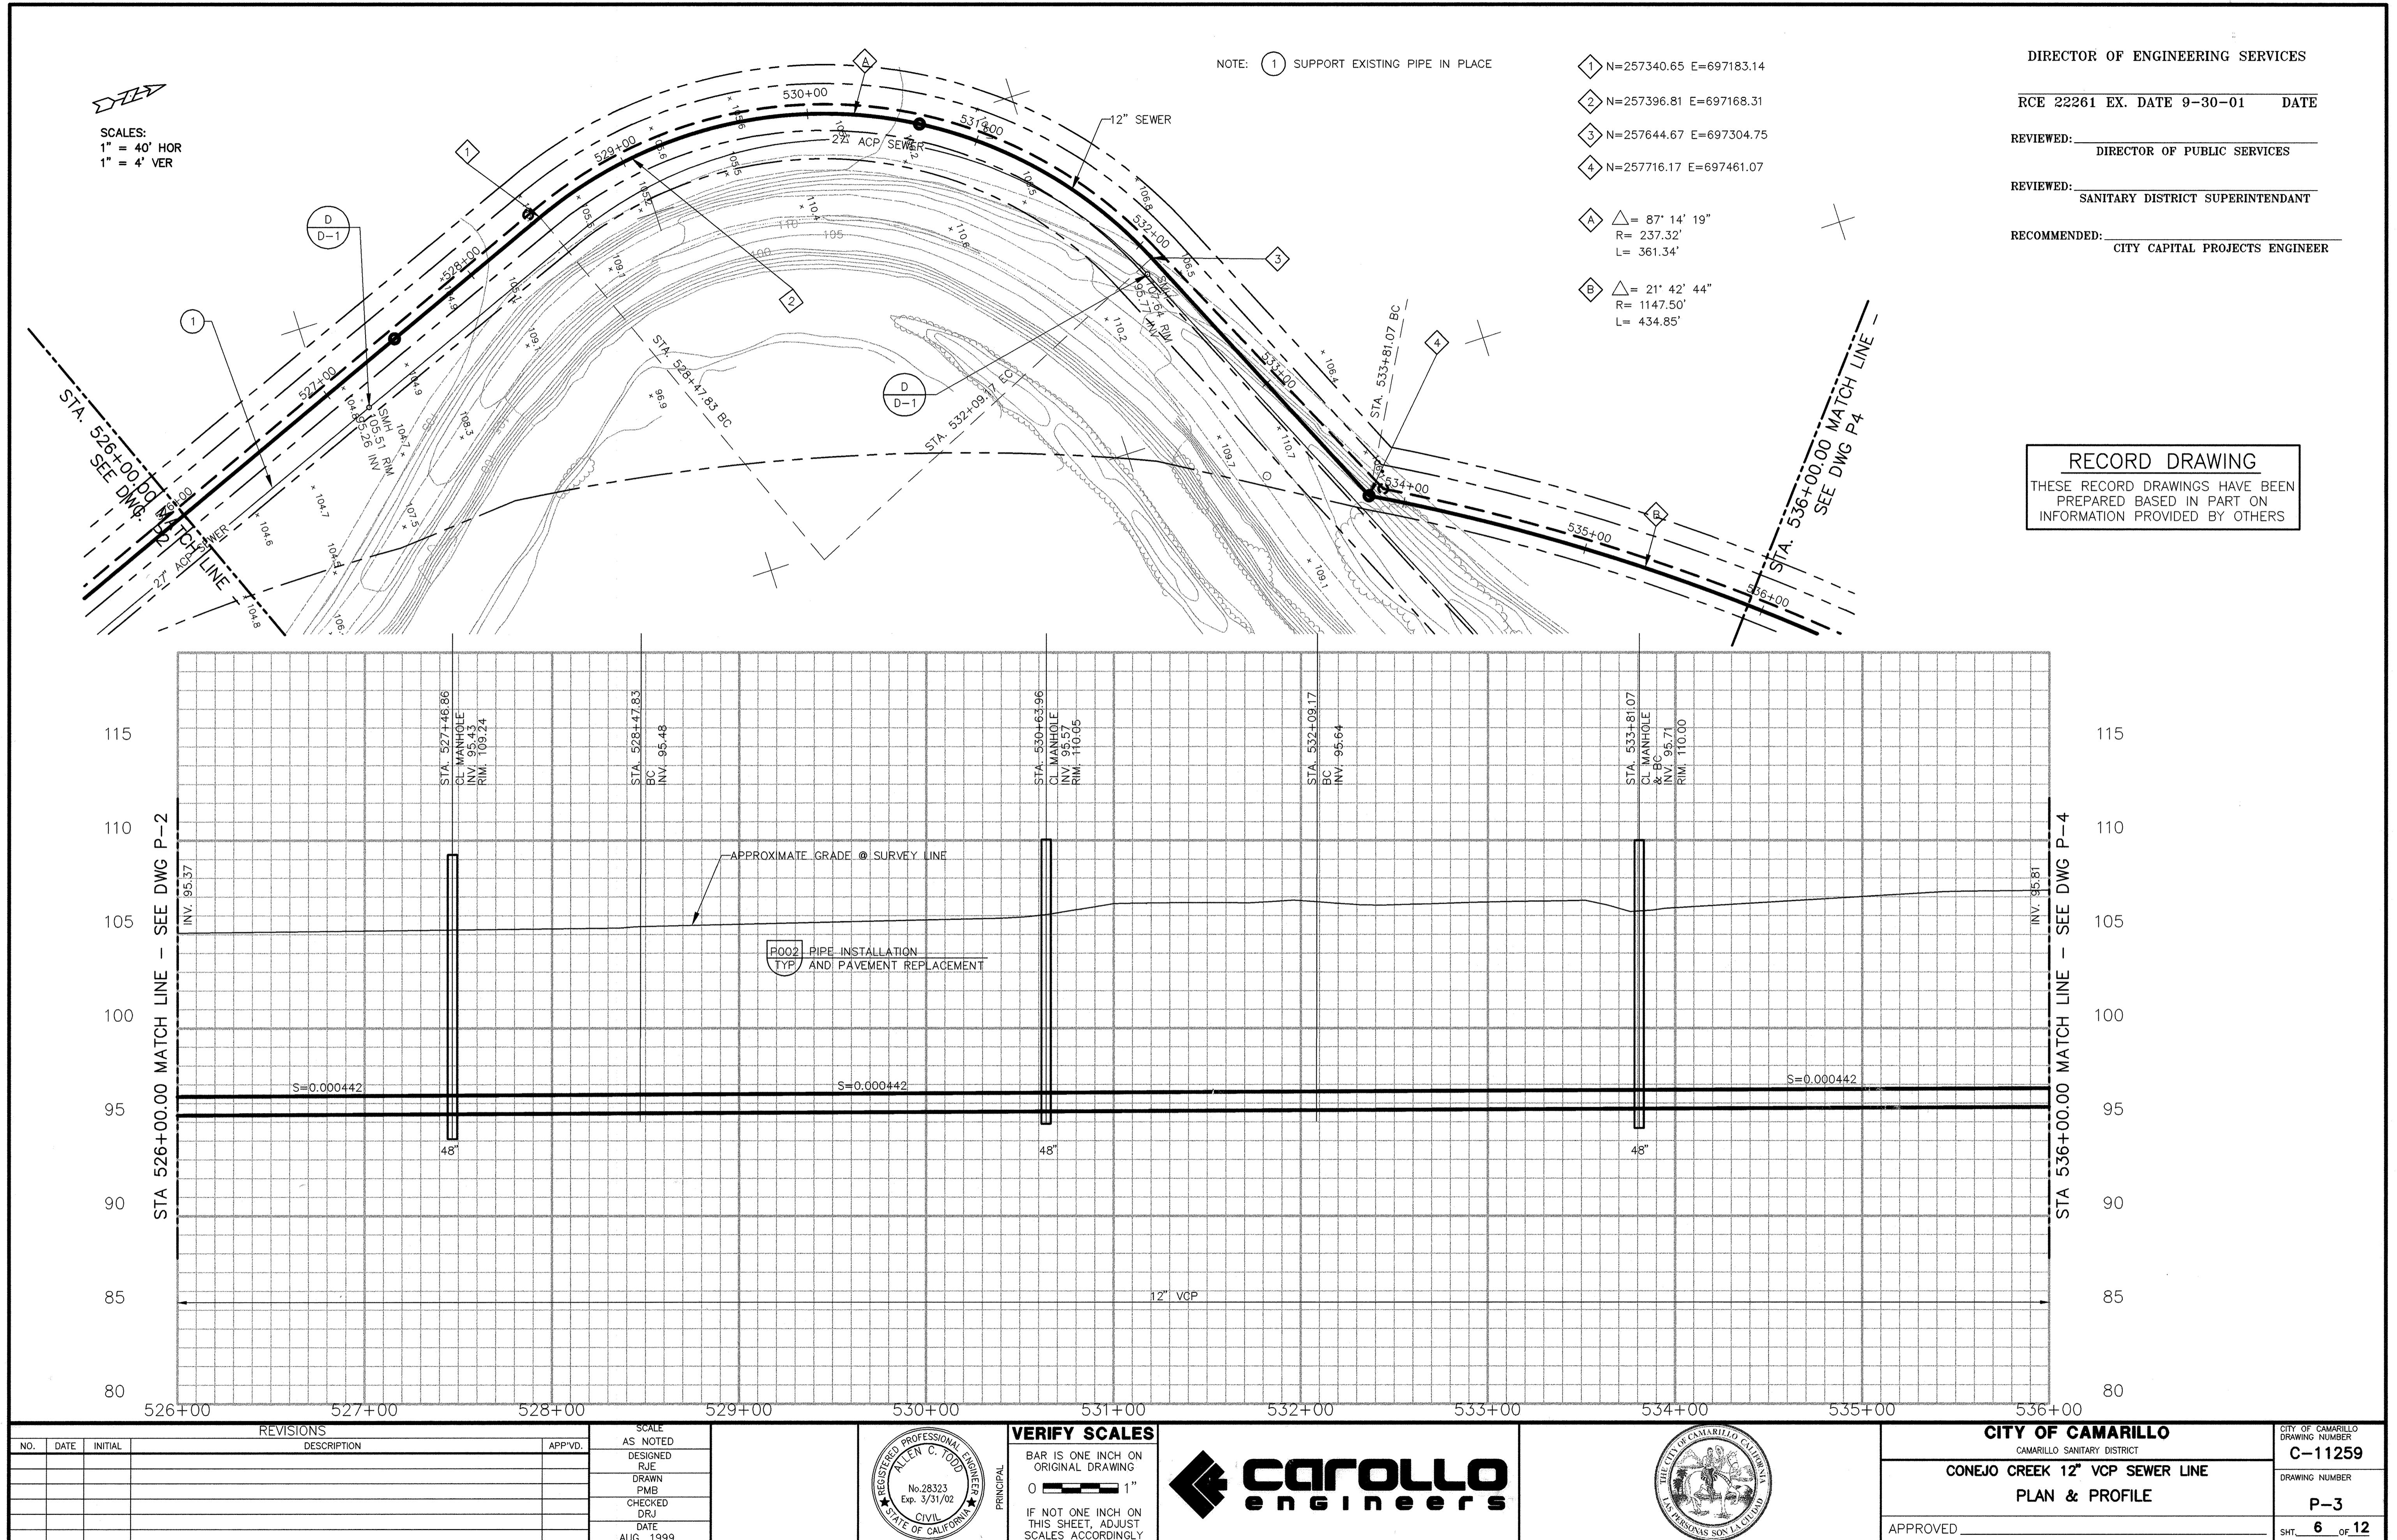

H:\Client\Camarillo_SA0\4843A10\Record\ RCp07003 11/14/00 10:51 pbocciarelli XREFS: CAMBRD, ALIGNMENT, RCPRF003, CAMROSA, X-UTIL, BRIDGE

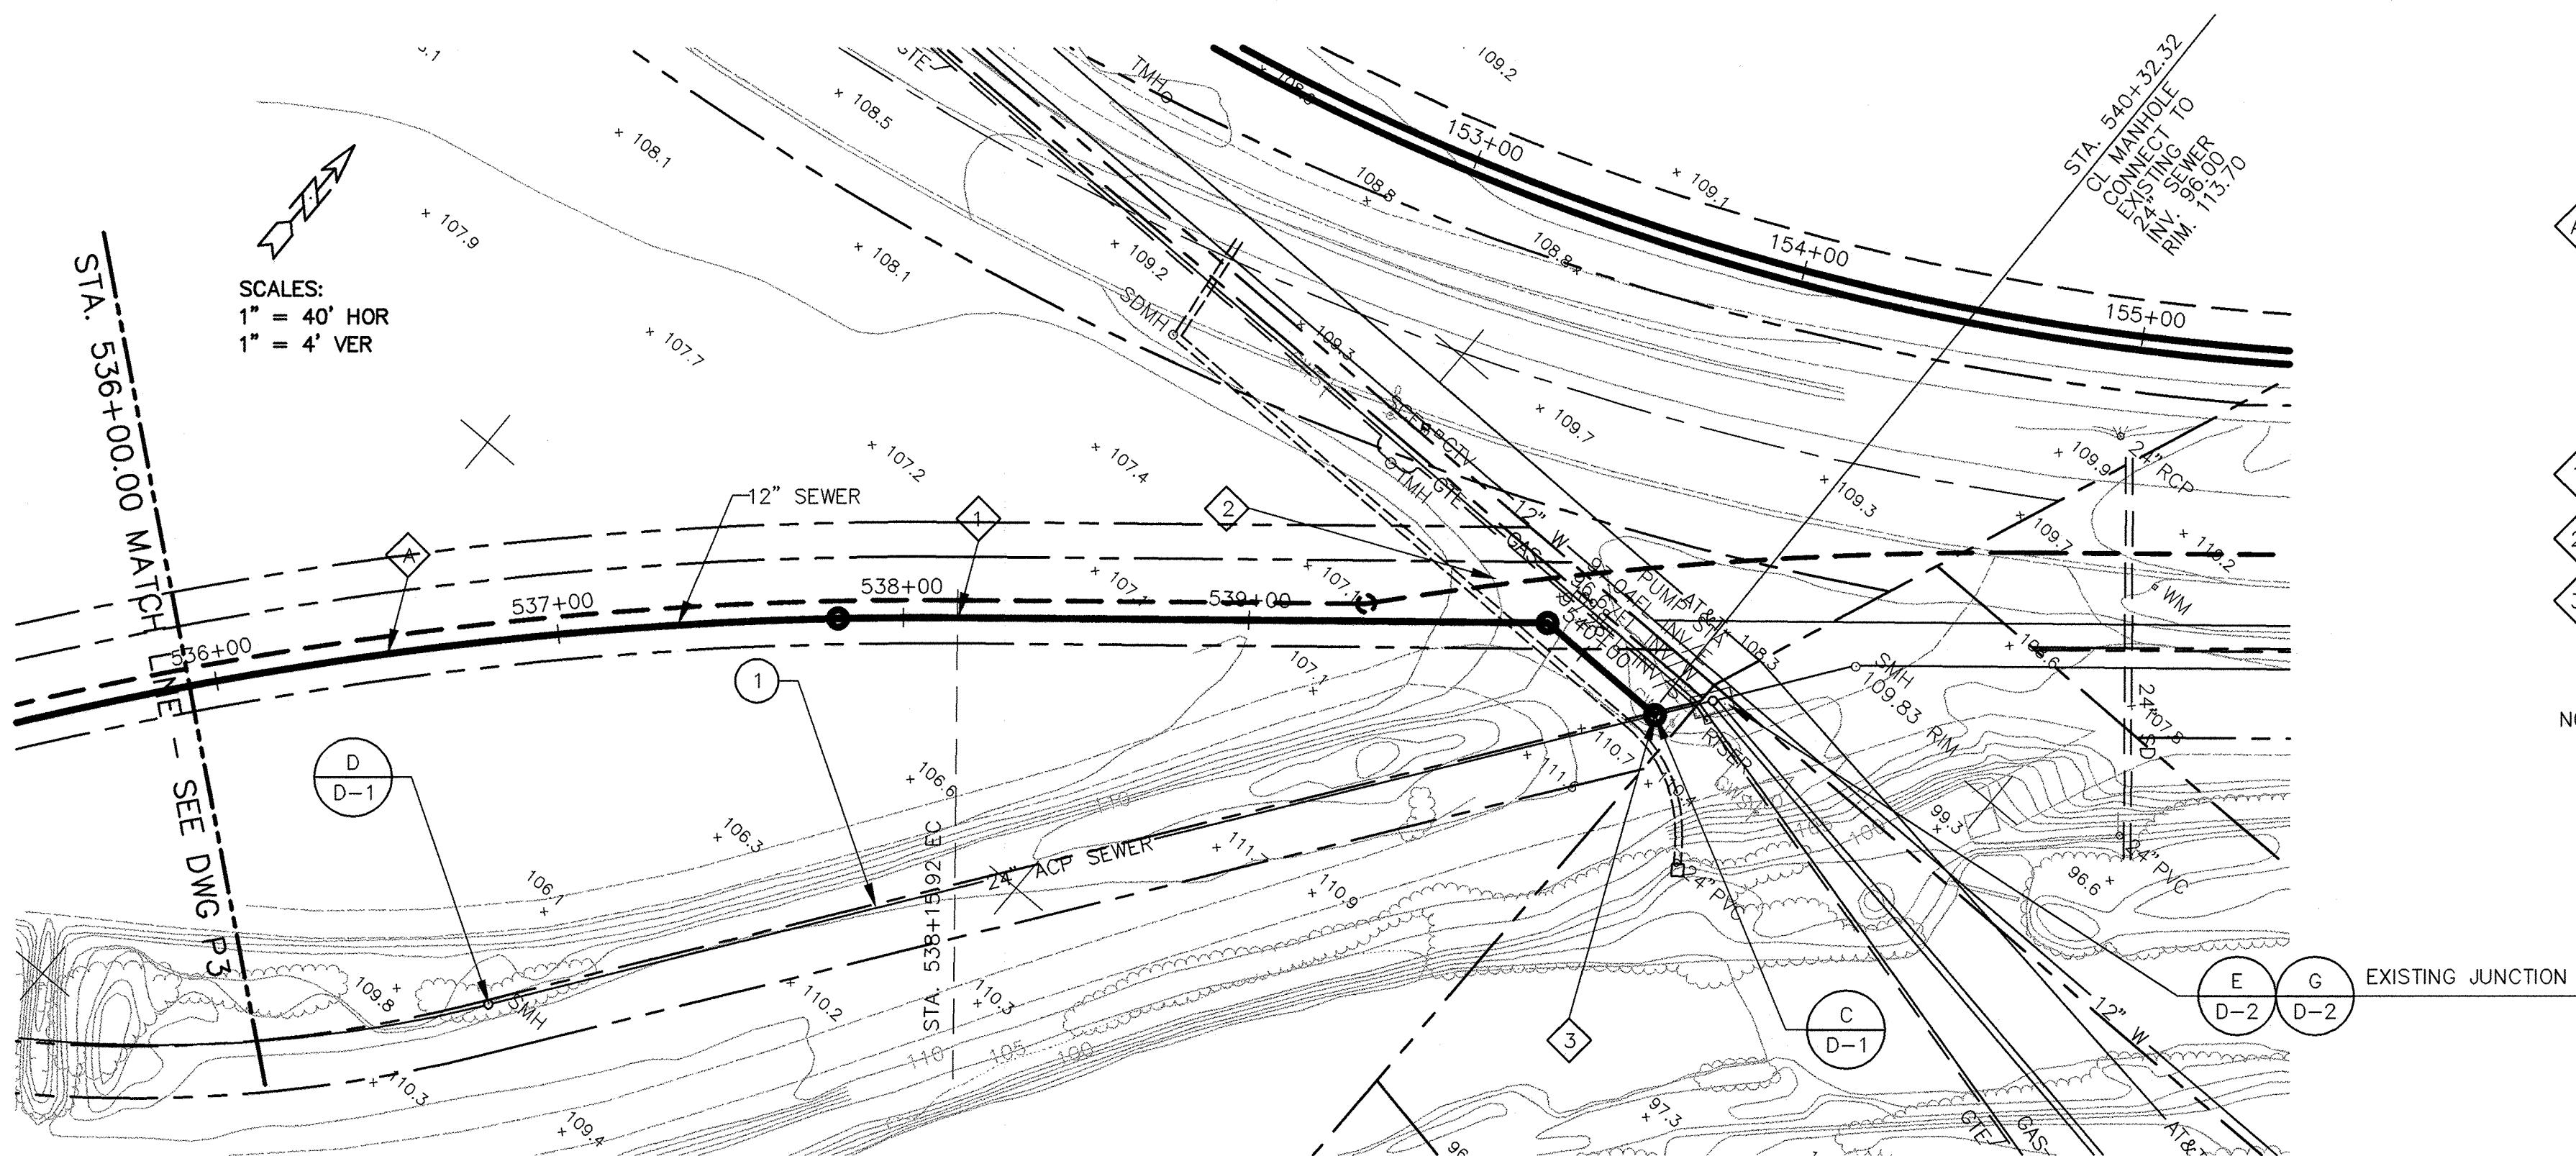

STA 536+00.00 MATCH LINE - SEE DWG P-3

INV. 95.81

STA. 537+81.07
CL MANHOLE
INV. 95.89
RIM. 111.94

APPROXIMATE GRADE @ SURVEY LINE

P002 PIPE INSTALLATION
TYP AND PAVEMENT REPLACEMENT

S=0.000442

48"

12" VCP

60"


STA. 539+86.32
CL MANHOLE
INV. 95.97
RIM. 112.00

STA. 540+27.24
CL MANHOLE
CONNECT TO
EXISTING
24" SEWER
INV. 96.00
RIM. 113.70

S=0.000442

120
115
110
105
100
95
90
85

536+00 537+00 538+00 539+00 540+00 541+00 542+00

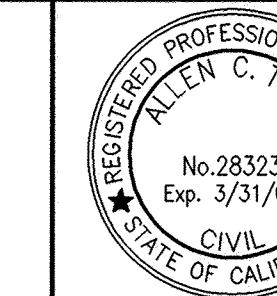

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HEET, ADJUST
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The logo consists of a large, bold, black 'K' icon on the left, followed by the word 'CAROLLO' in a bold, black, sans-serif font. Below 'CAROLLO', the letters 'e R G I B e e G S' are written in a smaller, black, sans-serif font.

CITY OF CAMARILLO
CAMARILLO SANITARY DISTRICT
NEJO CREEK 12" VCP SEWER L
PLAN & PROFILE

Y OF CAMARILLO
DRAWING NUMBER
C-11260
DRAWING NUMBER
P-4
7 OF 12

Y OF CAMARILLO
DRAWING NUMBER
C-11260
DRAWING NUMBER
P-4
7 OF 12

P-4

DIRECTOR OF ENGINEERING SERVICES

RCE 22261 EX. DATE 9-30-01 DATE

REVIEWED: _____
DIRECTOR OF PUBLIC SERVICES

REVIEWED: _____
SANITARY DISTRICT SUPERINTENDANT

RECOMMENDED: CITY CAPITAL PROJECTS ENGINEER

 A $\triangle = 21^\circ 42' 44''$
 $R = 1147.50'$
 $L = 434.85'$





- 1 N=258048.89 E=697736.99
- 2 N=258157.40 E=697848.95
- 3 N=258156.86 E=697909.43

NOTE: 1 SUPPORT EXISTING PIPE IN PLACE

RECORD DRAWING


THESE RECORD DRAWINGS HAVE BEEN
PREPARED BASED IN PART ON
INFORMATION PROVIDED BY OTHERS

- NOTES:**
1. FOR STRUCTURAL NOTES SEE DRAWING S-1.
 2. INSTALL PVC VENT STACK AS MANUFACTURED BY ARMOUR CAST COMPANY, MODEL NO. UPSRK-8.
 3. TOP SLAB AND CHECKERED PLATE DESIGN LIVE LOAD: 100 PSF
 4. REINFORCING BARS IN EACH DIRECTION AND EACH FACE OR MAT OF WALLS AND SLAB SHALL BE PLACED IN ENTIRE WALL AND SLAB AREAS. THESE BARS MAY BE SHOWN CUT OFF BY A "—" OR "—" MARK FOR CLARITY OF THE DRAWINGS AND DETAILS. REFERENCE IS MADE TO TYPICAL DETAILS FOR PLACEMENT OF ADDITIONAL BARS AT OPENINGS, ETC.
 5. LINE INTERIOR CONCRETE SURFACE OF THE DIVERSION BOX WITH PVC LINER PER SPECIFICATIONS & PER DET **S270**.
 6. REINFORCING SHOWN ON PLAN FOR THE TOP IS FOR IN-PLACE LOADING: CONTRACTOR TO DESIGN ADDITIONAL REINFORCING FOR LIFTING AND HANDLING LOADS.
 7. NUMBER OF LIFTING INSERTS SHALL NOT BE REDUCED, BUT CAN BE INCREASED **R322**.

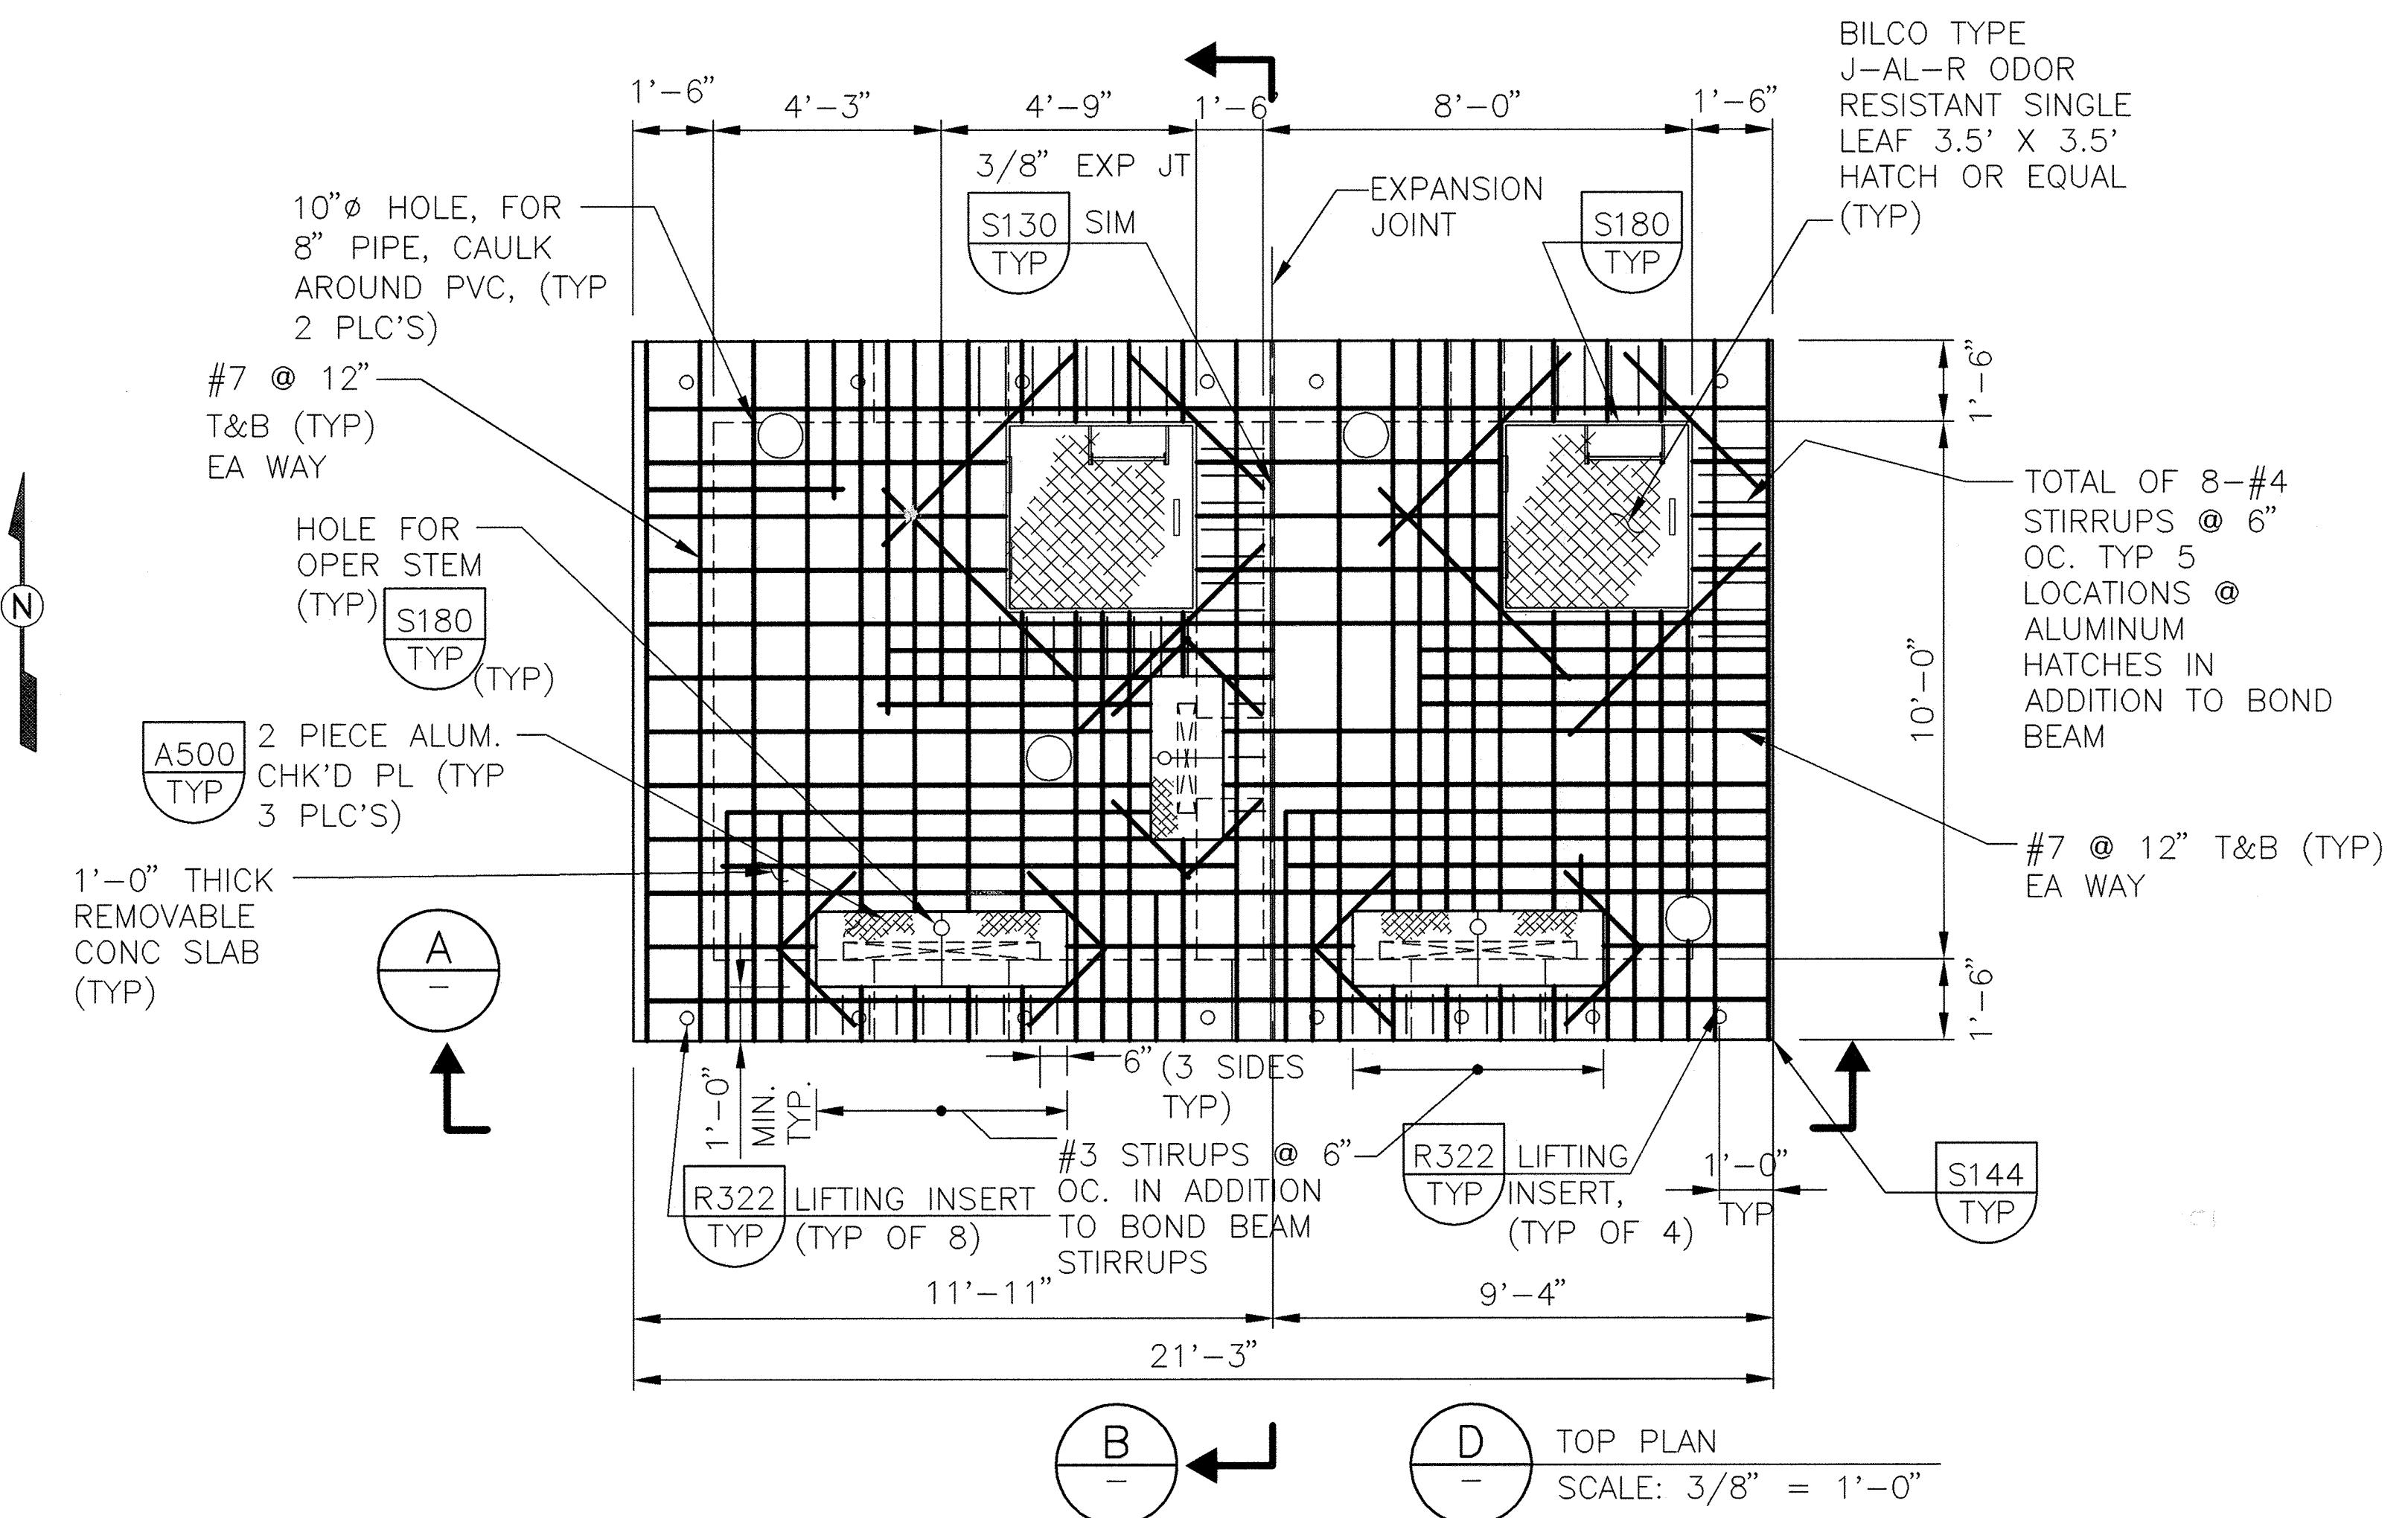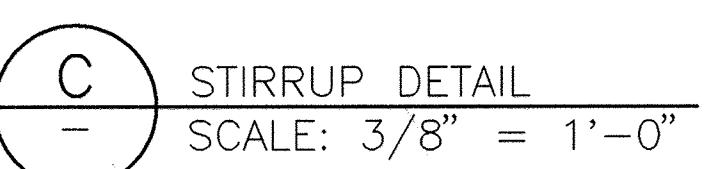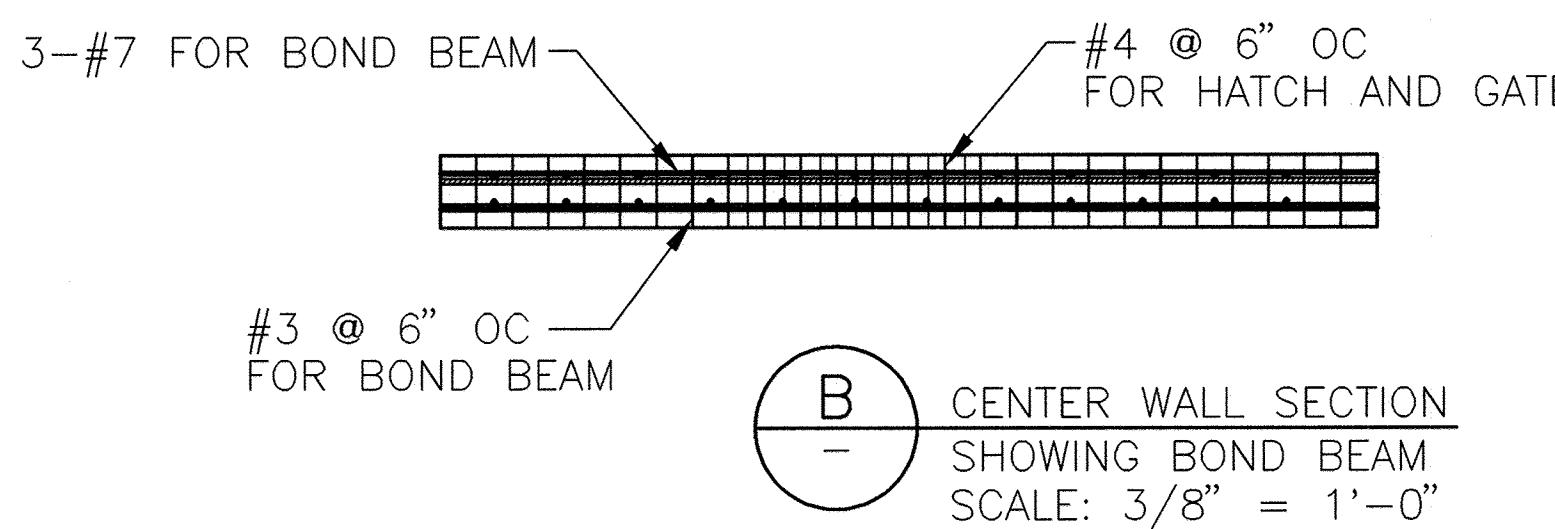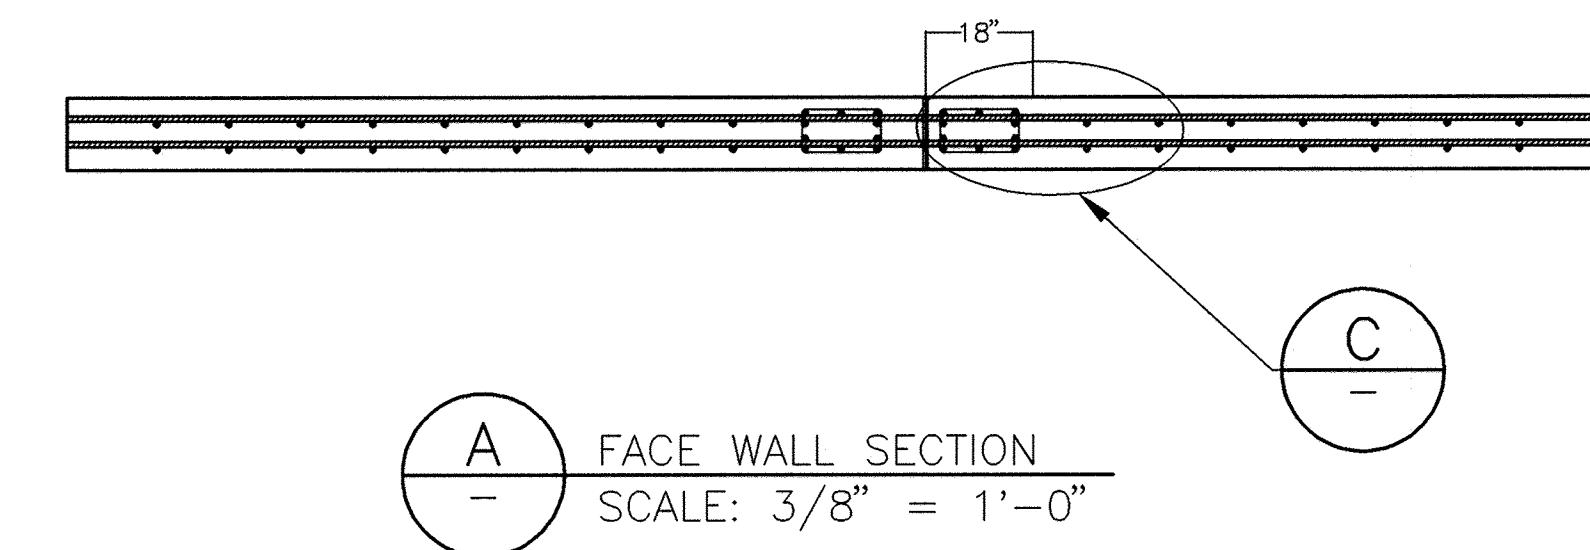

RECORD DRAWING
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INFORMATION PROVIDED BY OTHERS

REVISIONS			APP'D.
NO.	DATE	INITIAL	
			SCALE AS SHOWN
			DESIGNED
			DRAWN
			CHECKED HRR
			DATE
			NOV 2000

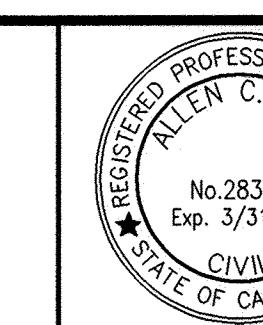

VERIFY SCALES
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ORIGINAL DRAWING
0 1"
IF NOT ONE INCH ON
THIS SHEET, ADJUST
SCALES ACCORDINGLY

carollo
engineers




CAMROSA
Water District


**CITY OF CAMARILLO /
CAMROSA WATER DISTRICT**
CONEJO CREEK 12" VCP SEWER LINE
SEWER DIVERSION BOX

APPROVED
GENERAL MANAGER, CAMROSA WATER DISTRICT

CITY OF CAMARILLO
DRAWING NUMBER
C-11262A
DRAWING NUMBER
S-2A
SHT. **9A** OF **13**

H:\Client\Camarillo_SA0\4843A10\Record\ D-1 11/13/00 14:20 pbocciarelli XREFS: M-PP02, M-PP03, M-PP04, M-PP06, CAMBRD2

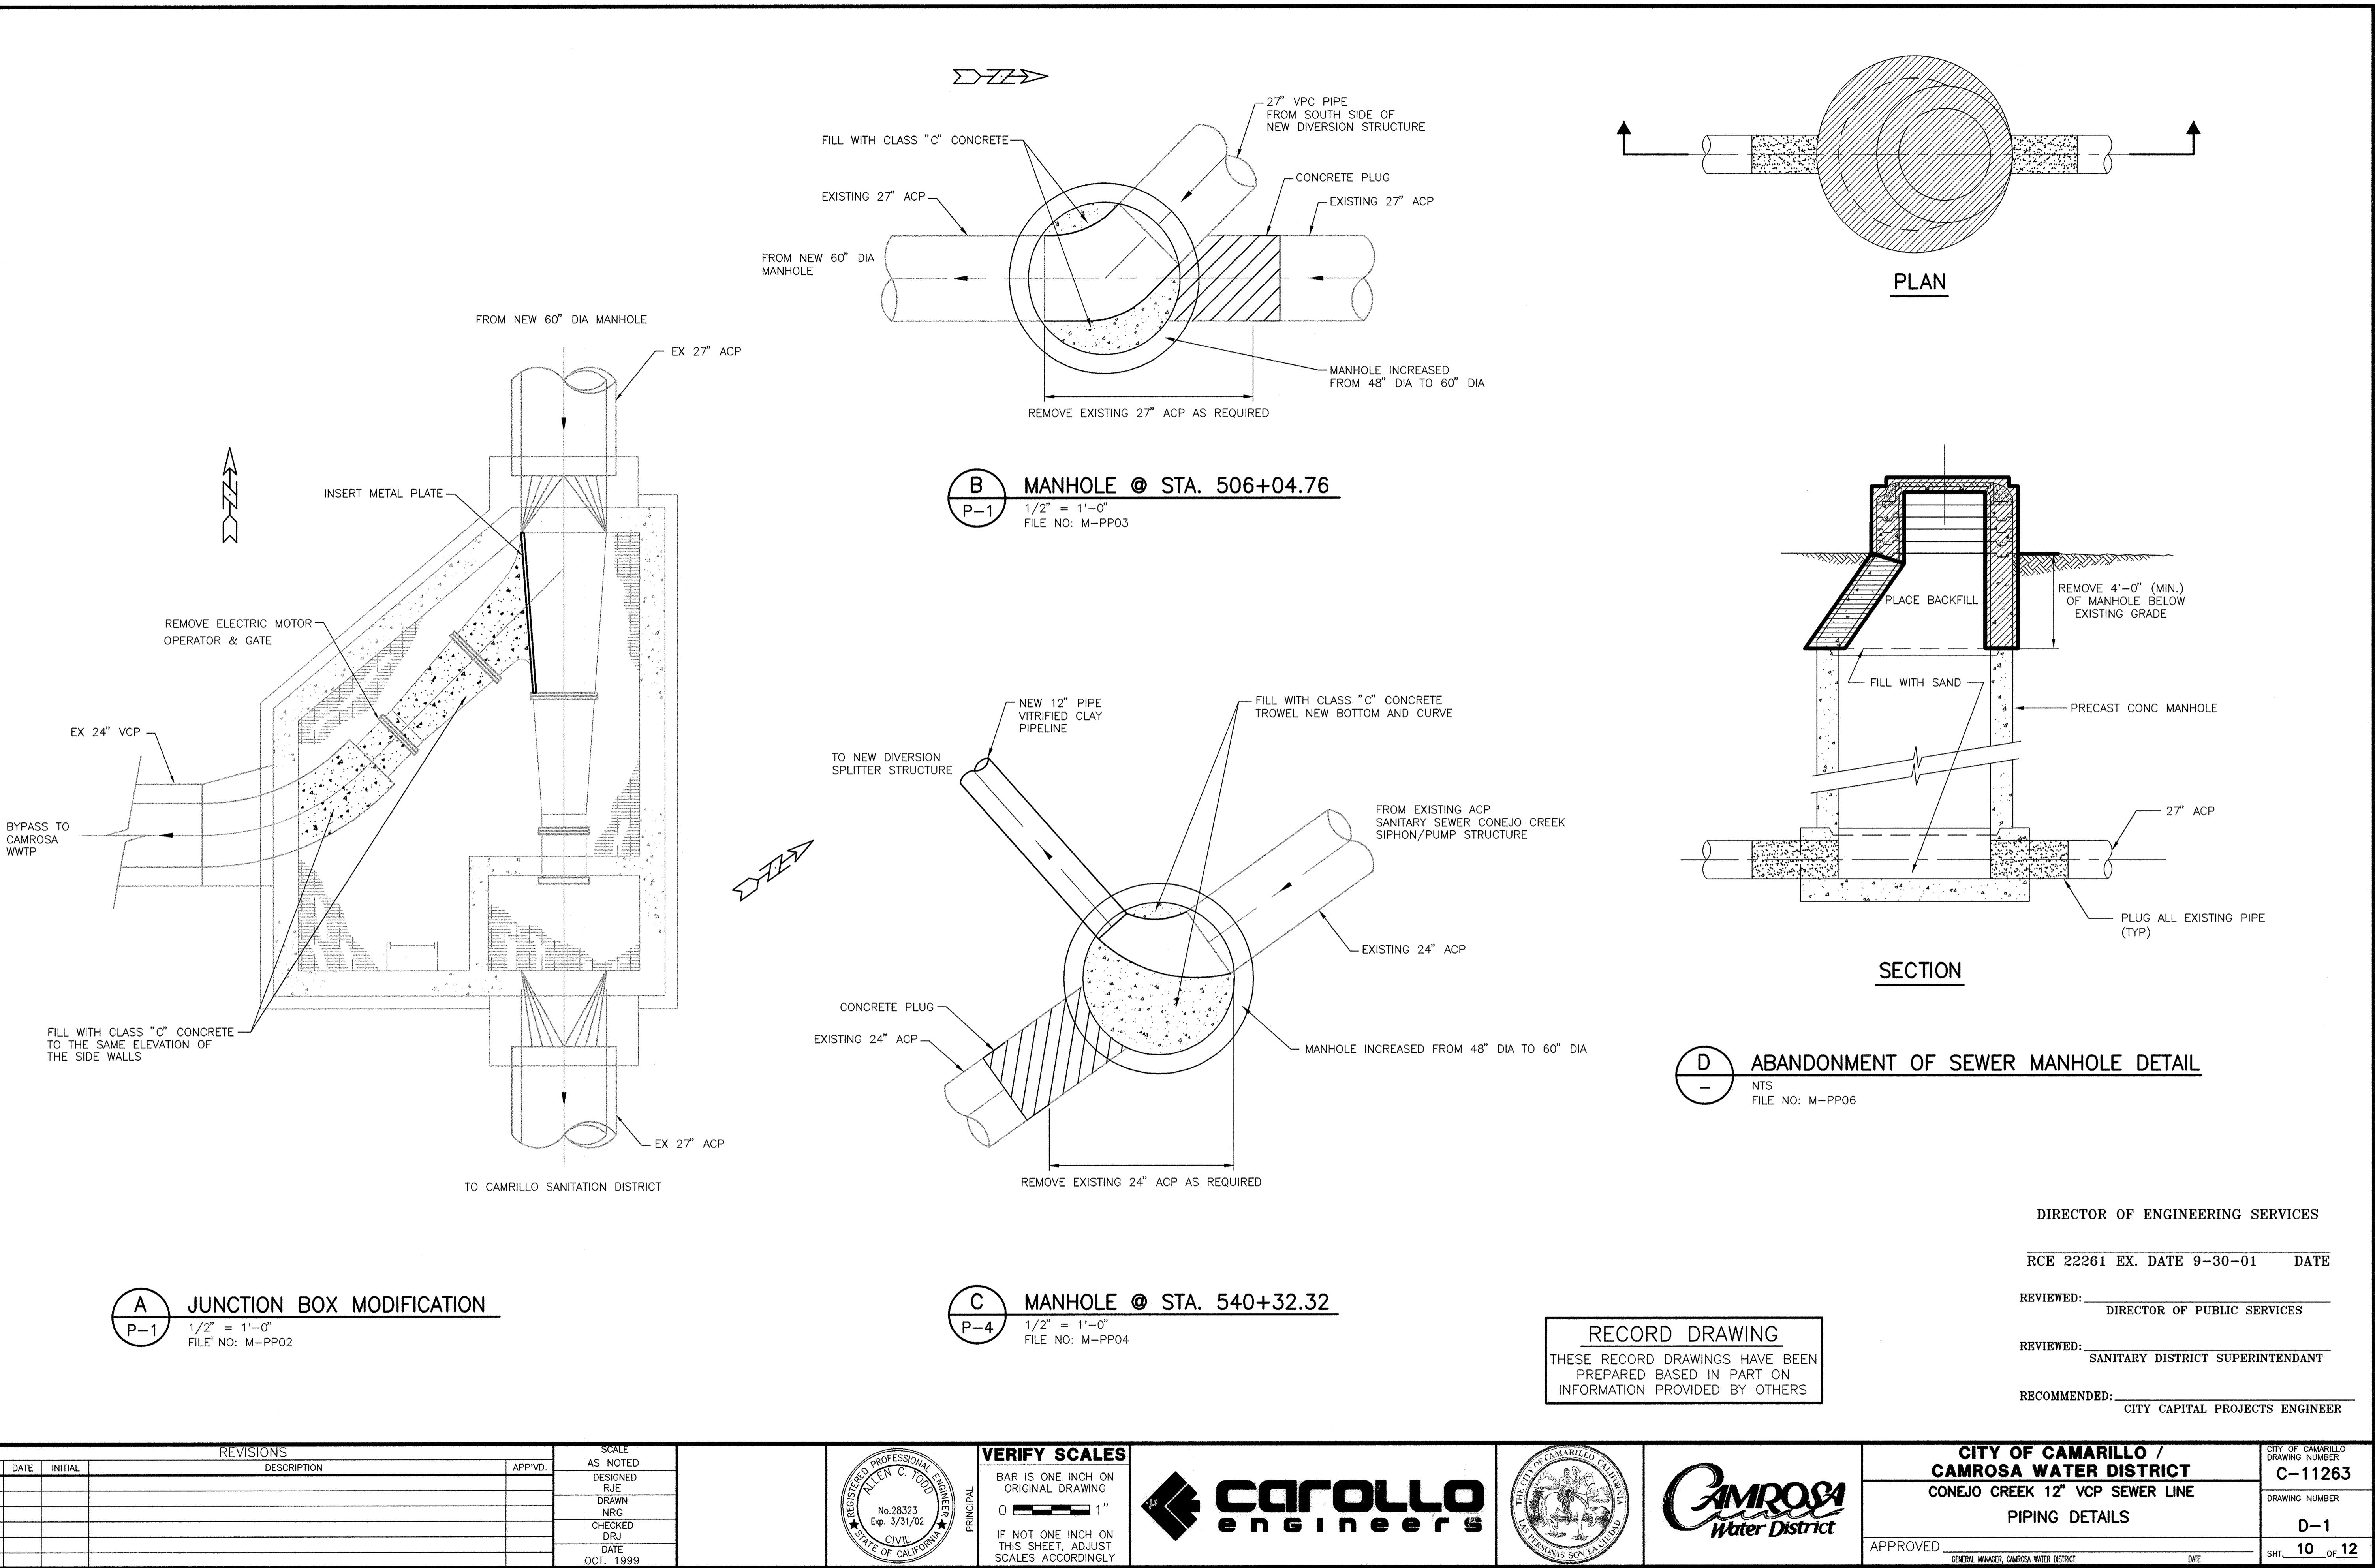


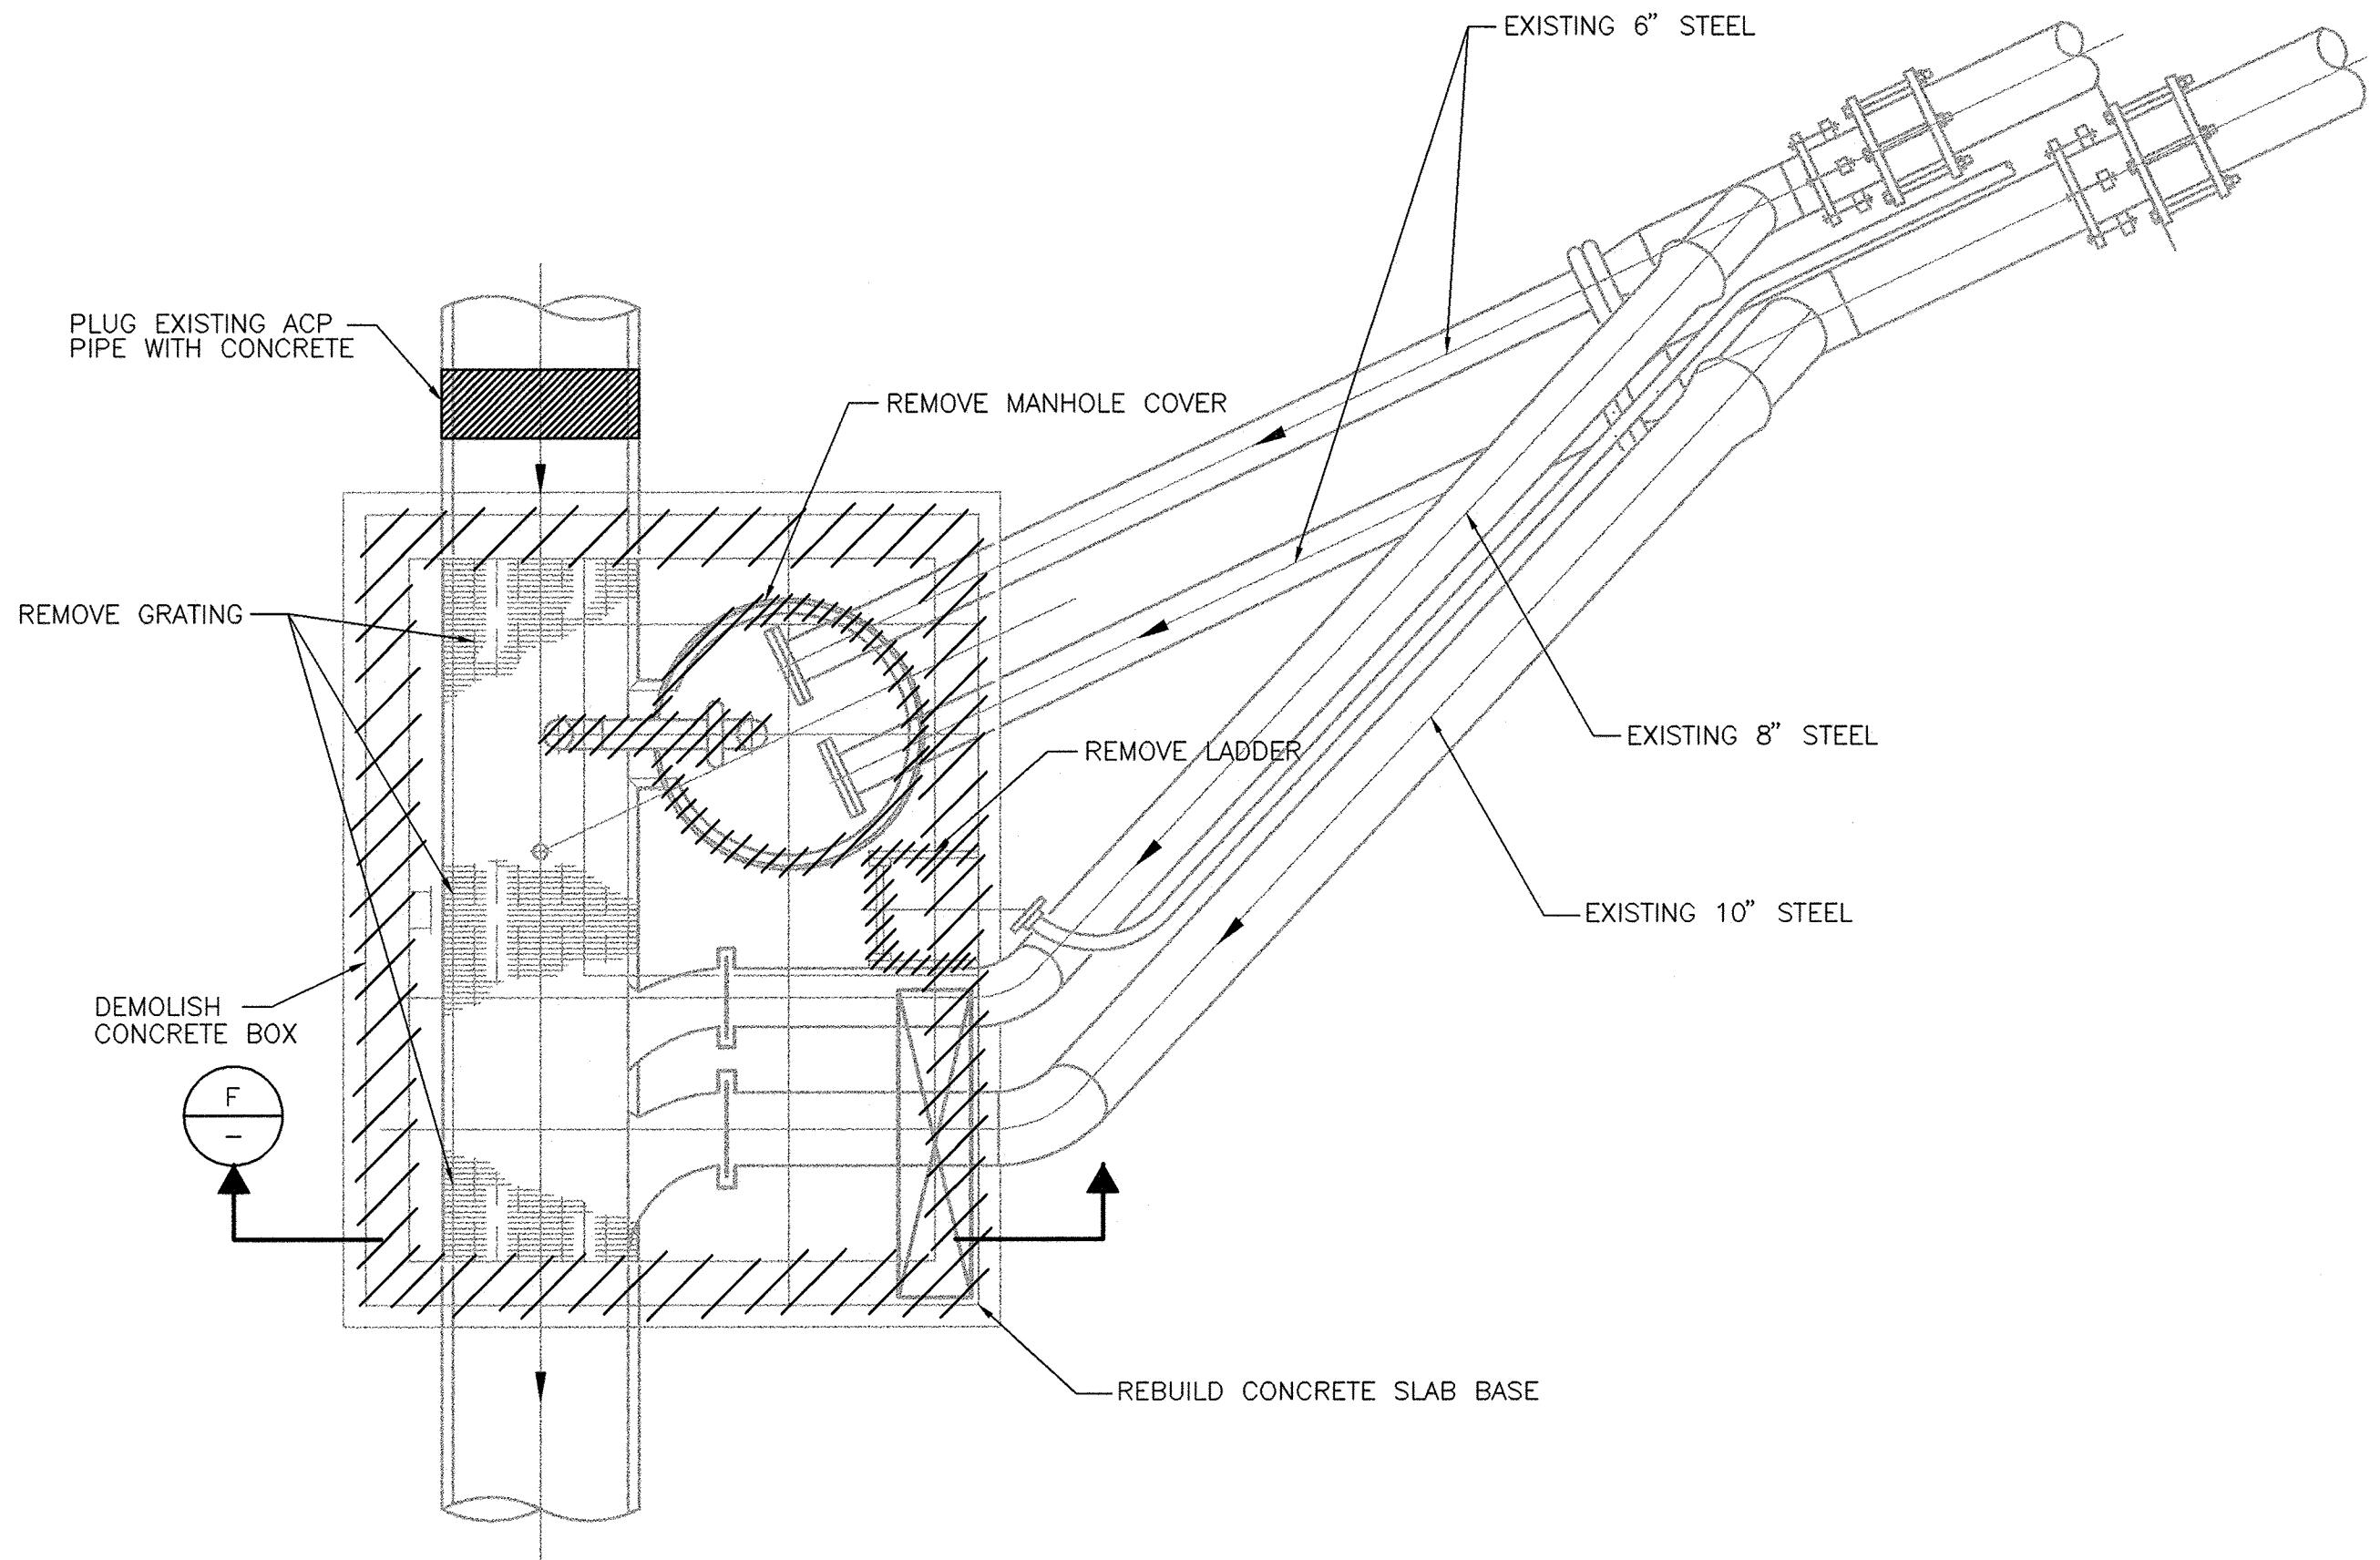


E DEMOLITION PLAN
— 1/2" = 1'-0"
FILE NO. M-PP10

RECORD DRAWING
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INFORMATION PROVIDED BY OTHERS

REVISIONS			
NO.	DATE	INITIAL	DESCRIPTION
APP'D.			
			SCALE AS NOTED
			DESIGNED RJE
			DRAWN NRG
			CHECKED DRJ
	OCT. 1999		DATE

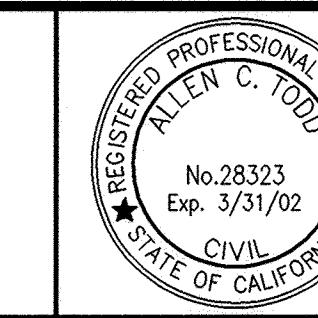

VERIFY SCALES
BAR IS ONE INCH ON
ORIGINAL DRAWING
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IF NOT ONE INCH ON
THIS SHEET, ADJUST
SCALES ACCORDINGLY

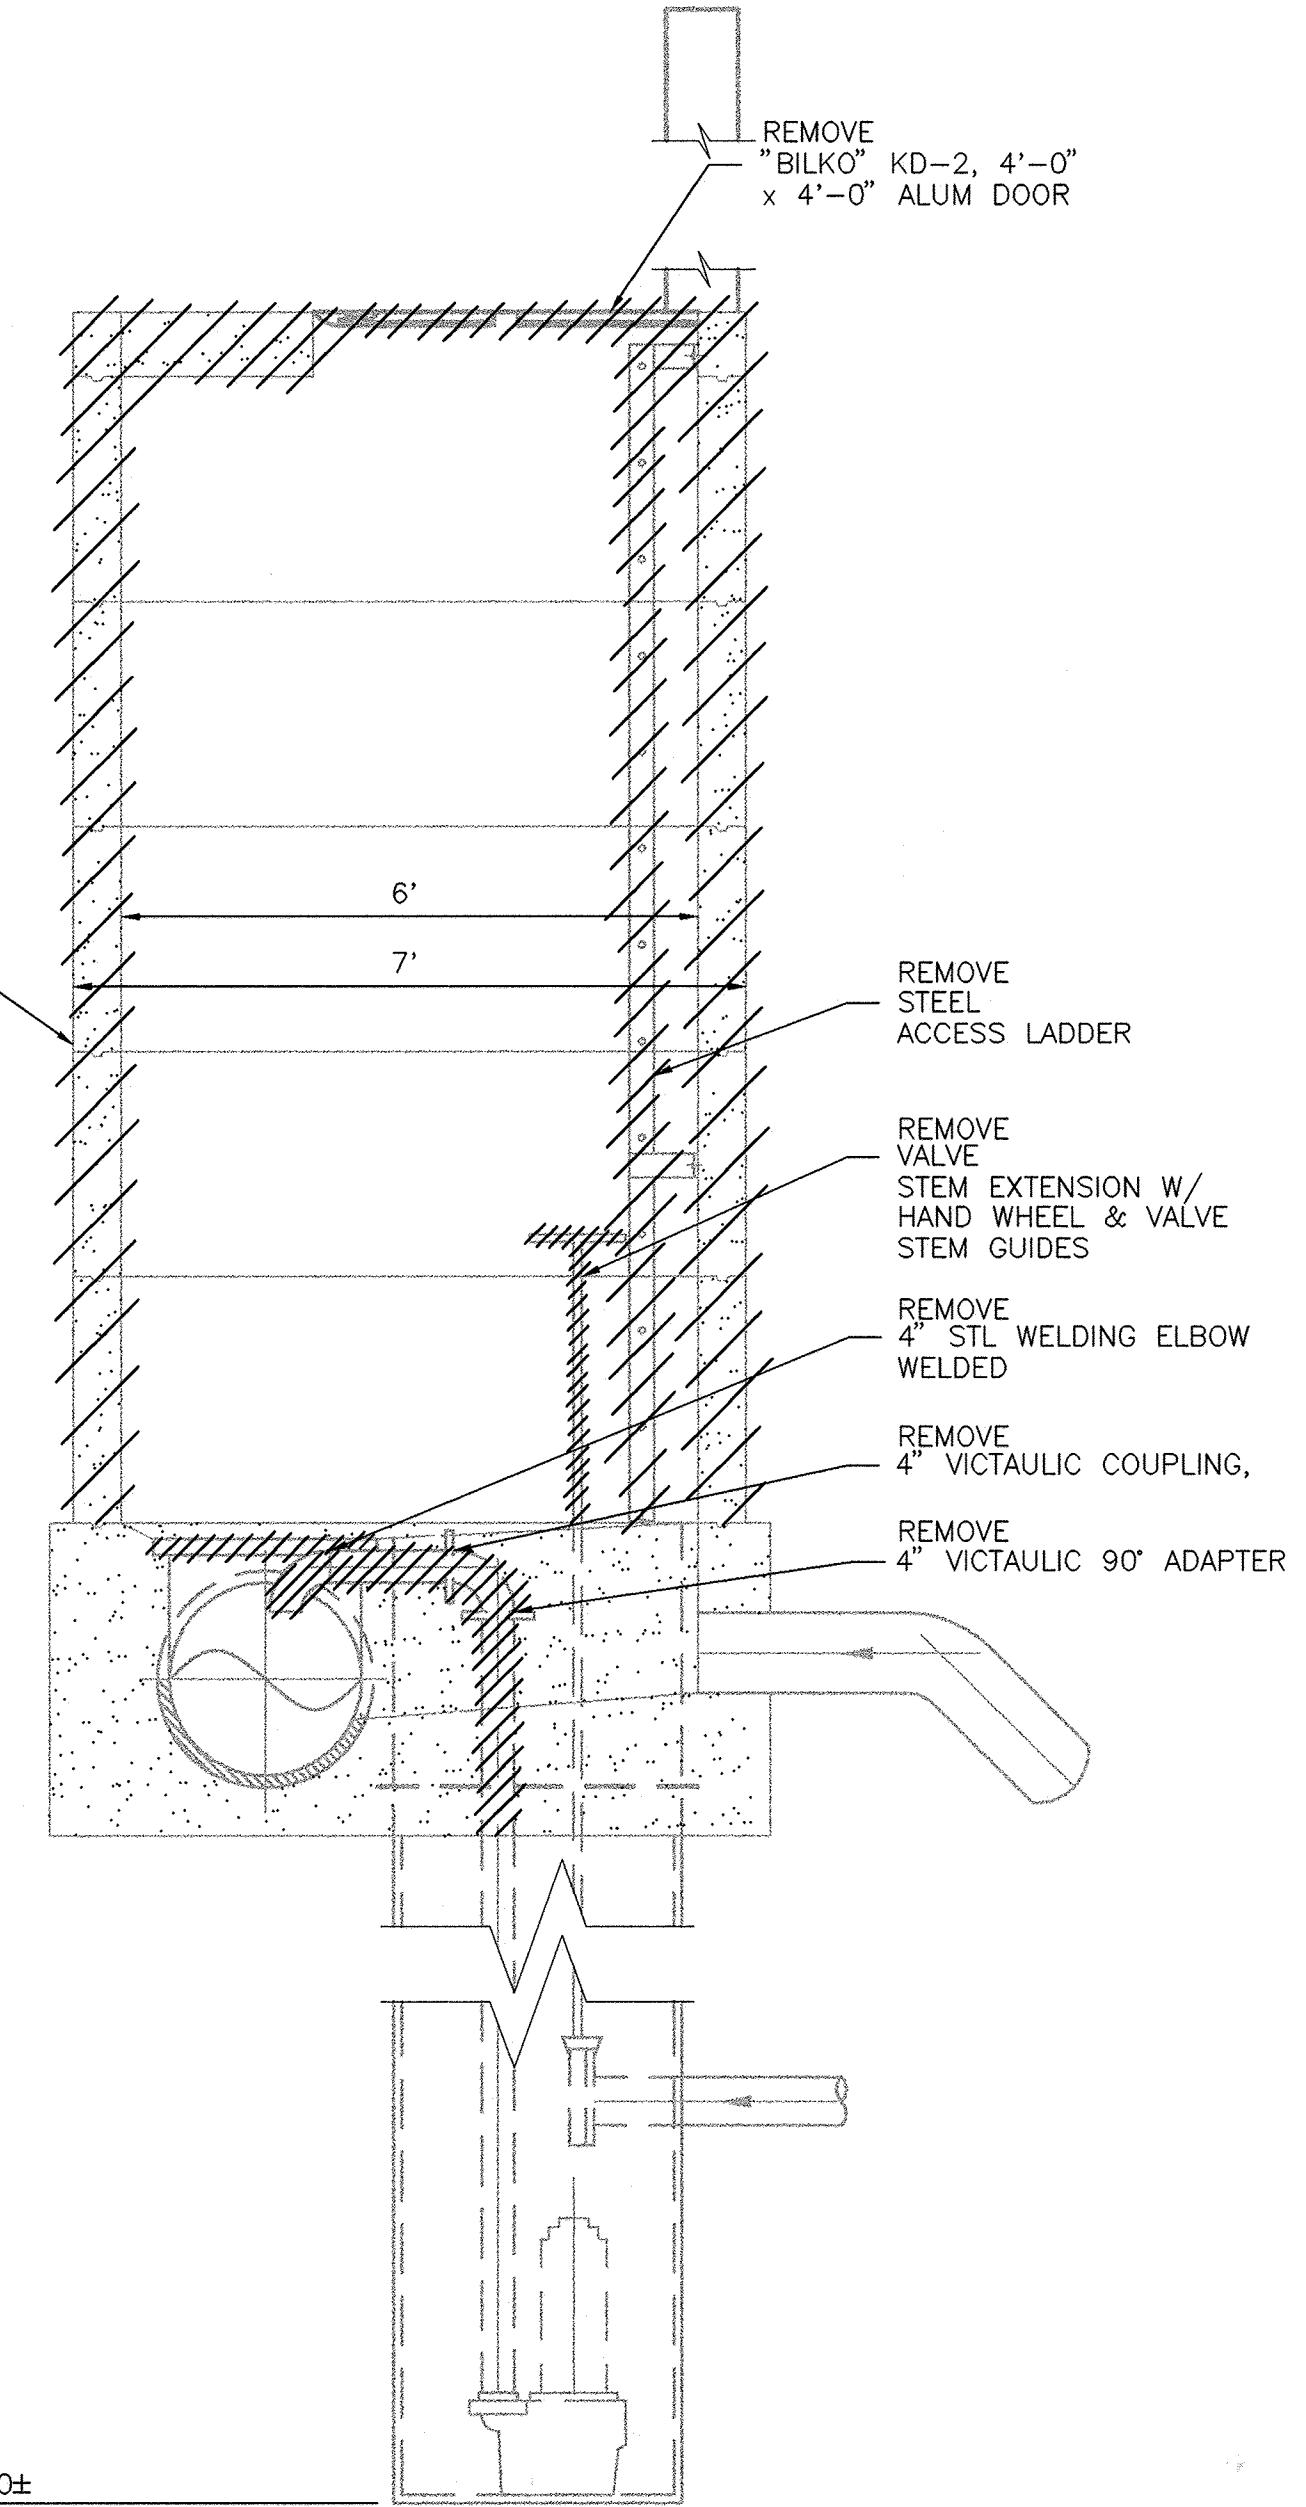

F DEMOLITION SECTION
— 1/2" = 1'-0"
FILE NO. M-PP09


DIRECTOR OF ENGINEERING SERVICES
RCE 22261 EX. DATE 9-30-01 DATE
REVIEWED: DIRECTOR OF PUBLIC SERVICES
REVIEWED: SANITARY DISTRICT SUPERINTENDANT
RECOMMENDED: CITY CAPITAL PROJECTS ENGINEER



CITY OF CAMARILLO
CAMARILLO SANITARY DISTRICT
CONEJO CREEK 12" VCP SEWER LINE
DEMOLITION OF EXISTING
SYPHON/PUMP STATION

CITY OF CAMARILLO
DRAWING NUMBER
C-11264
DRAWING NUMBER
D-2
SHT. **11** OF **12**

APPROVED:

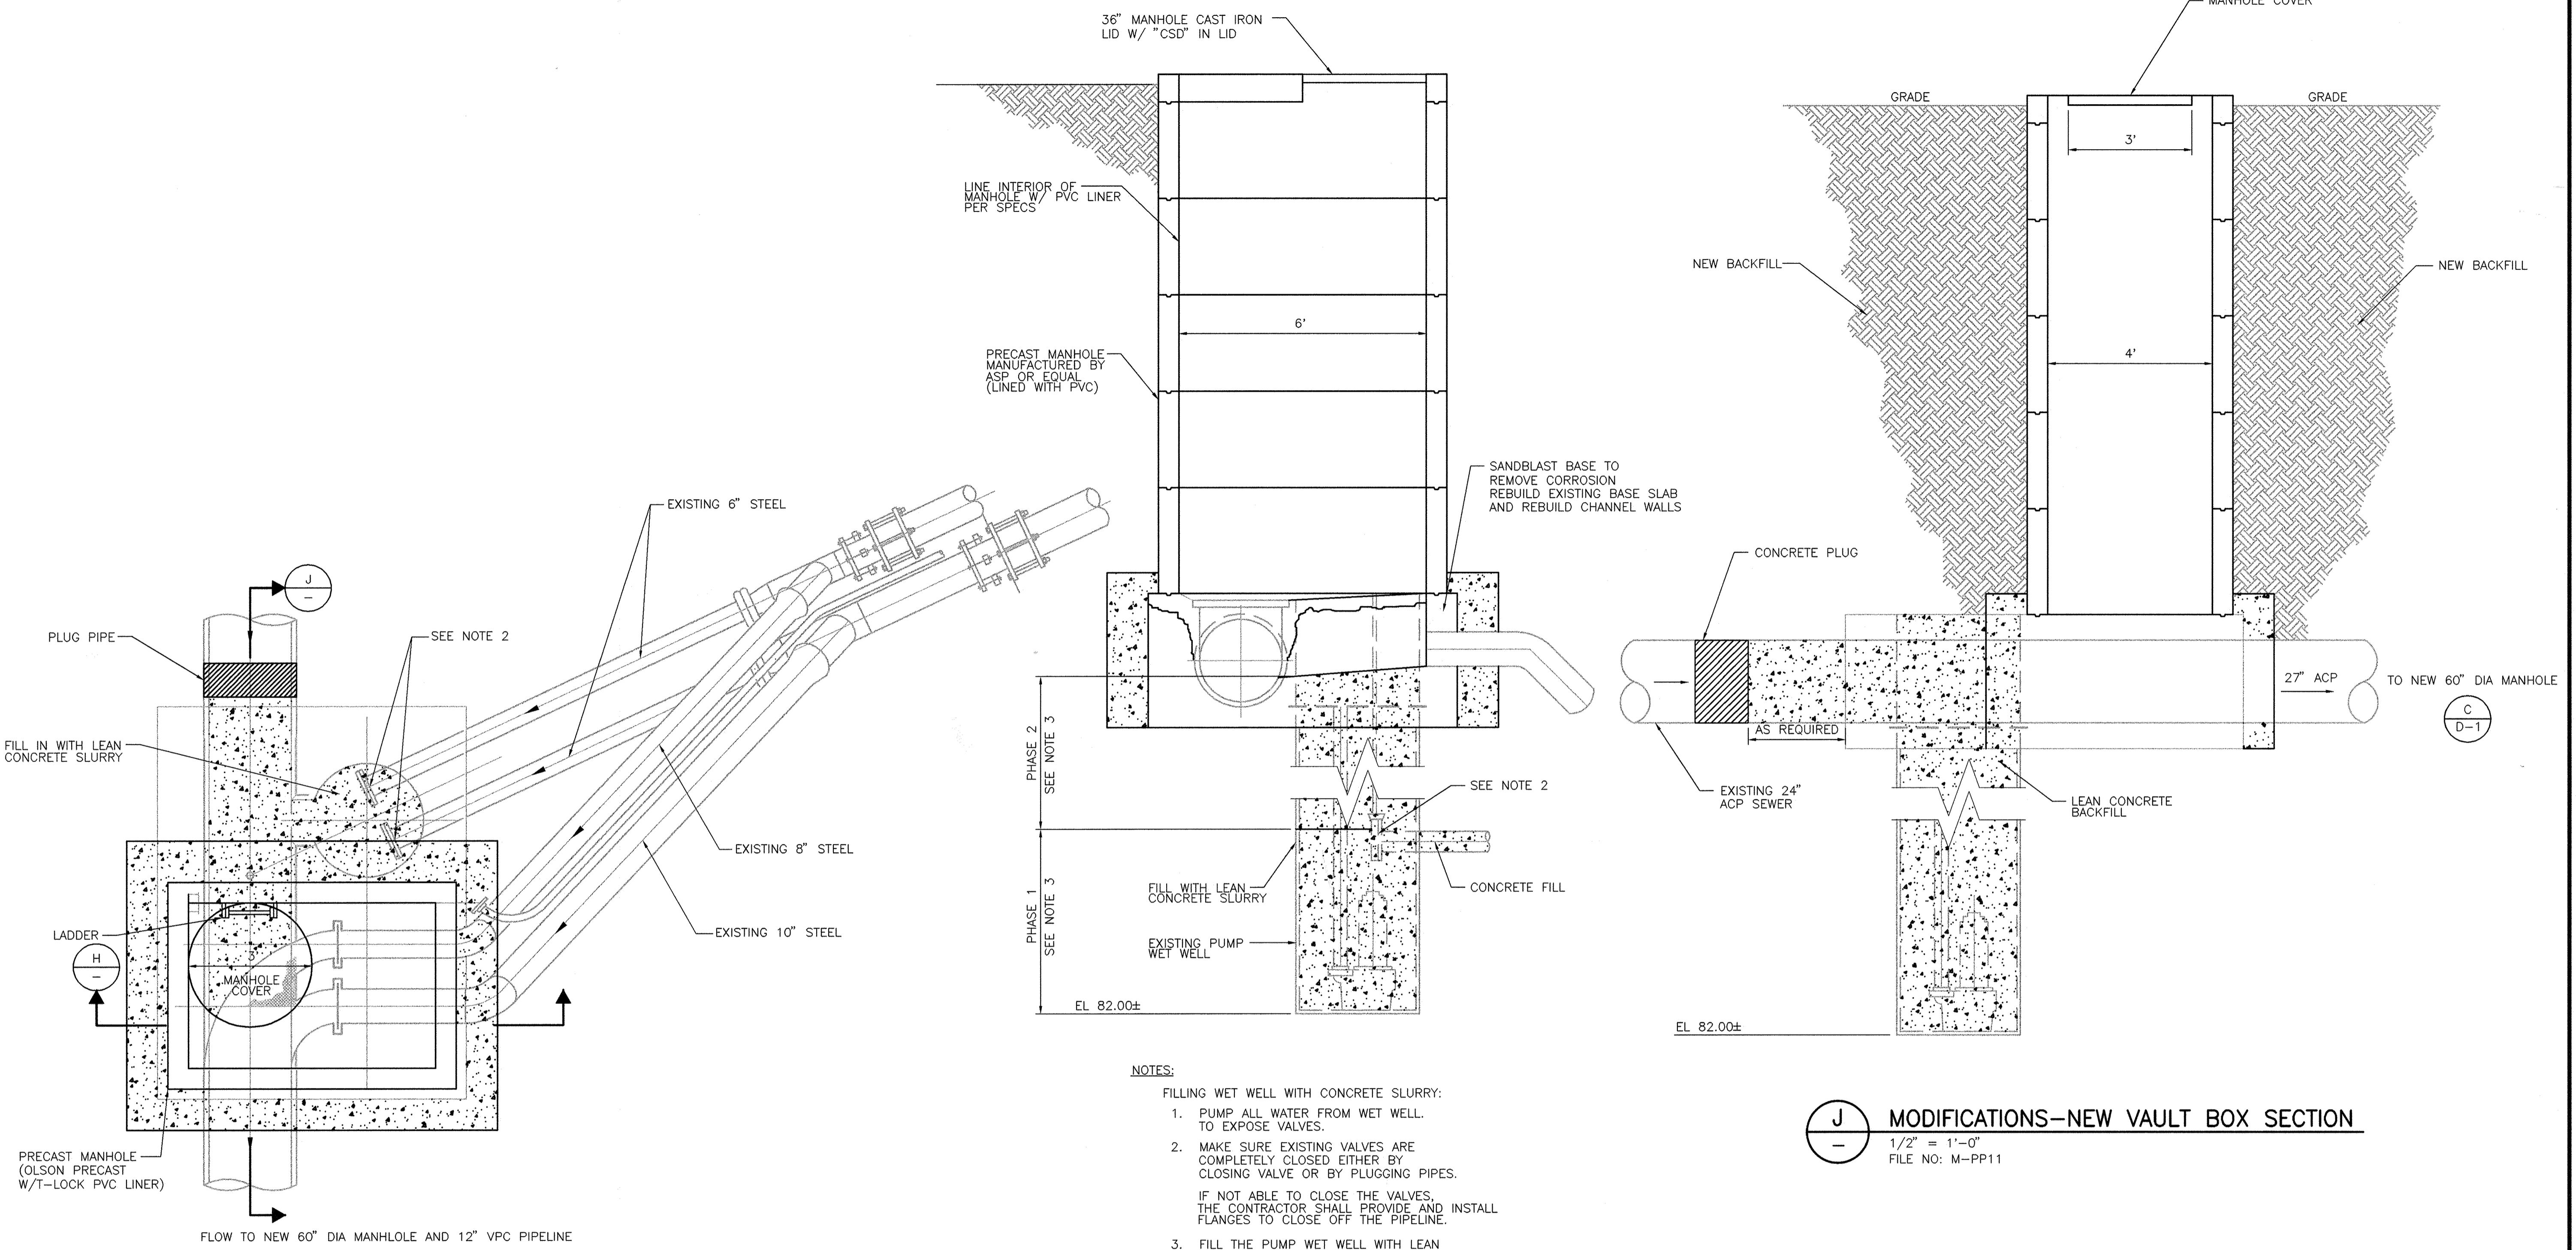

NOTES:

- FILLING WET WELL WITH CONCRETE SLURRY:
1. PUMP ALL WATER FROM WET WELL.
TO EXPOSE VALVES.
- MAKE SURE EXISTING VALVES ARE
COMPLETELY CLOSED EITHER BY
CLOSING VALVE OR BY PLUGGING PIPES.
IF NOT ABLE TO CLOSE THE VALVES,
THE CONTRACTOR SHALL PROVIDE AND INSTALL
FLANGES TO CLOSE OFF THE PIPELINE.
- FILL THE PUMP WET WELL WITH LEAN
CONCRETE FILL IN 2 POURS.

PHASE 1: FILL WET WELL WITH CONCRETE
SLURRY TO THE TOP OF THE
EXISTING PIPES IN WET WELL.
LET SLURRY SET FOR 24 HOURS.
LEAVE PUMP IN PLACE WITH
SLURRY.

PHASE 2: FILL THE REST OF WELL WITH
CONCRETE SLURRY.

- CONTRACTOR SHALL FIELD VERIFY ALL ELEVATIONS.

J
-

MODIFICATIONS—NEW VAULT BOX SECTION

1/2" = 1'-0"
FILE NO: M-PP11

DIRECTOR OF ENGINEERING SERVICES

RCE 22261 EX. DATE 9-30-01 DATE

REVIEWED: DIRECTOR OF PUBLIC SERVICES

REVIEWED: SANITARY DISTRICT SUPERINTENDANT

RECOMMENDED: CITY CAPITAL PROJECTS ENGINEER

G
-

MODIFICATIONS—PLAN

1/2" = 1'-0"
FILE NO: M-PP08


RECORD DRAWING
THESE RECORD DRAWINGS HAVE BEEN
PREPARED BASED IN PART ON
INFORMATION PROVIDED BY OTHERS

H
-

MODIFICATIONS—SIPHON/PUMP WET WELL


1/2" = 1'-0"
FILE NO: M-PP07

REVISIONS			
NO.	DATE	INITIAL	DESCRIPTION
			APP'D.
			SCALE AS NOTED
			DESIGNED RJE
			DRAWN NRG
			CHECKED DRJ
			DATE OCT. 1999

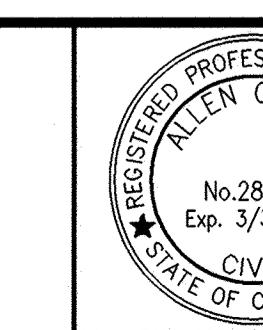

VERIFY SCALES
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IF NOT ONE INCH ON THIS SHEET, ADJUST SCALES ACCORDINGLY

CAROLLO
engineers

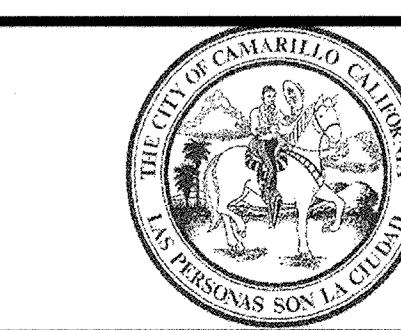

CITY OF CAMARILLO
CAMARILLO SANITARY DISTRICT
CONEJO CREEK 12" VCP SEWER LINE
NEW SIPHON/PUMP STATION SEWER BOX

CITY OF CAMARILLO
DRAWING NUMBER
C-11264A
DRAWING NUMBER
D-3
SHT. **12 OF 12**