

Palmdale to Burbank Project Section





This page intentionally left blank

ROADWAY/GRADE SEPARATION/ACCESS ROADS SHEETS

GENERAL

DRAWING NO.	DRAWING DESCRIPTION	
CV-B0001	ROADWAYS AND GRADE SEPARATIONS - INDEX OF DRAWINGS	
CV-B0002	ROADWAYS AND GRADE SEPARATIONS - ABBREVIATIONS	
CV-B0003	ROADWAYS AND GRADE SEPARATIONS - ABBREVIATIONS AND LEGEND	= "

SR14A

DRAWING NO.	DRAWING DESCRIPTION
H14/7/14/15 - 1/5 # 5	KEY MAP
CV-B0001-14A	ROADWAYS AND GRADE SEPARATIONS - KEY MAP (1/2)
	ROADWAYS AND GRADE SEPARATIONS - KEY MAP (2/2)
Service entre to the	ROADWAY PLANS, PROFILES AND TYPICAL SECTIONS
CV-R4001-14A	ROADWAY PLAN - EAST 10TH STREET & EAST AVENUE R11
CV-R4002-14A	ROADWAY PLAN - WATER TREATMENT PLANT ACCESS ROADS, DELAWARE RD & VALLEY FORGE RD
and the same the same of the same and the sa	ROADWAY PROFILE - EAST 10TH STREET
CV-R1002-14A	ROADWAY PROFILE - EAST AVENUE R11
CV-R1003-14A	ROADWAY PROFILE - SERVICE ROAD AVENUE S & VALLEY FORGE RD
CV-R1004-14A	ROADWAY PROFILE - WATER TREATMENT PLANT ACCESS ROADS & DELAWARE RD
CV-P3001-14A	ROADWAY TYPICAL SECTIONS ~ EAST 10TH STREET (1/2)
	ROADWAY TYPICAL SECTIONS - EAST 10TH STREET (2/2) & EAST AVE R11
CV-R3003-14A	ROADWAY TYPICAL SECTIONS - WATER TREATMENT PLANT ACCESS ROADS, DELAWARE RD & VALLEY FORGE RD
MI DOVOV LIB	
	GRADE SEPARATION PLANS, PROFILES AND TYPICAL SECTIONS
CV-T4001-14A	GRADE SEPARATION PLAN - AVENUE S (1/2)
CV-T4002-14A	GRADE SEPARATION PLAN - AVENUE 5 (2/2)
CV-T4003-14A	GRADE SEPARATION PLAN - SIERRA HIGHWAY (1/2)
CV-T4004-14A	GRADE SEPARATION PLAN - SIERRA HIGHWAY (2/2)
	GRADE SEPARATION PROFILE - AVENUE S (1/2)
	GRADE SEPARATION PROFILE - AVENUE S (2/2)
	GRADE SEPARATION PROFILE - SIERRA HIGHWAY (1/2)
CV-T1004-14A	GRADE SEPARATION PROFILE - SIERRA HIGHWAY (2/2)
CV=T3001=144	ROADWAY TYPICAL SECTIONS - SIERRA HIGHWAY
	ROADWAY TYPICAL SECTIONS - AVENUE S (1/2)
	ROADWAY TYPICAL SECTIONS - AVENUE S (2/2)
27 10000	127.07
	ACCESS ROAD PLANS, PROFILES AND TYPICAL SECTIONS
CV-Y4001-14A	ACCESS ROAD PLAN - PORTAL 1
	ACCESS ROAD PLAN - INTERMEDIATE WINDOW
	ACCESS ROAD PLAN - PORTAL 2 (1/3)
CV-Y4004-14A	ACCESS ROAD PLAN - PORTAL 2 (2/3)
	ACCESS ROAD PLAN - PORTAL 2 (3/3)
-1	ACCESS ROAD PLAN - PORTAL 3
CV-Y4006-14A	
	ACCESS ROAD PLAN - PORTAL 4 (2/3)
	ACCESS ROAD PLAN - PORTAL 4 (3/3) ACCESS ROAD PLAN - PORTAL 9
CV-Y4009-14A	ACCESS ROAD PLAN - PORTAL 9
CV-Y1001-14A	ACCESS ROAD PROFILE - PORTAL 1
	ACCESS ROAD PROFILE - INTERMEDIATE WINDOW
	ACCESS ROAD PROFILE - PORTAL 2 (1/3)
CV-Y1004-14A	
CV-Y1005-14A	
CV-Y1006-14A	
CV-Y1007-14A	ACCESS ROAD PROFILE - PORTAL 4 (1/3)
CV-Y1008-14A	ACCESS ROAD PROFILE - PORTAL 4 (2/3)
CV-Y1009-14A	ACCESS ROAD PROFILE - PORTAL 4 (3/3)
CV-Y1010-14A	ACCESS ROAD PROFILE - PORTAL 9
CV-Y3001-14A	ACCESS ROADS TYPICAL SECTIONS - PORTALS SR14A

E1A/E2A

WWW. LEVILLE TO SEE	Common de la companya del companya del la companya del companya de la companya del companya de la companya del la companya de la companya del la companya del la companya de la companya del la com
DRAWING NO.	DRAWING DESCRIPTION
	KEY MAP
V-B0001-EA	ROADWAYS AND GRADE SEPARATIONS - KEY MAP
	ROADWAY PLANS, PROFILES AND TYPICAL SECTIONS
V-R4001-EA	
V-R4001-EA	ROADWAY PLAN - EAST 10TH STREET & EAST AVENUE R11
V-H4002-EA	ROADWAY PLAN - WATER TREATMENT PLANT ACCESS ROADS, DELAWARE RD & VALLEY FORGE RD
CV-R1001-EA	ROADWAY PROFILE - EAST 10TH STREET
V-R1002-EA	ROADWAY PROFILE - EAST AVENUE R11
CV-R1003-EA	ROADWAY PROFILE - SERVICE ROAD AVENUE S & VALLEY FORGE RD
CV-R1004-EA	ROADWAY PROFILE - WATER TREATMENT PLANT ACCESS ROADS & DELAWARE RD
	ROADWAY TYPICAL SECTIONS - EAST 10TH STREET (1/2)
	ROADWAY TYPICAL SECTIONS - EAST 10TH STREET (2/2) & EAST AVE R11
CV-R3003-EA	ROADWAY TYPICAL SECTIONS - WATER TREATMENT PLANT ACCESS ROADS, DELAWARE RD & VALLEY FORGE RD
	GRADE SEPARATION PLANS, PROFILES AND TYPICAL SECTIONS
CV-T4001-EA	GRADE SEPARATION PLAN - AVENUE S (1/2)
CV-T4002-EA	GRADE SEPARATION PLAN - AVENUE S (2/2)
V-T4003-EA	GRADE SEPARATION PLAN - SIERRA HIGHWAY (1/2)
V-T4004-EA	GRADE SEPARATION PLAN - SIERRA HIGHWAY (2/2)
V-T4005-EA	GRADE SEPARATION PLAN - FORESTON DRIVE (1/2)
CV-T4006-FA	GRADE SEPARATION PLAN - FORESTON DRIVE (2/2)
37 14000 LA	STAND SET ATTACK TONESTON BUTTE (2) 2)
CV-T1001-EA	GRADE SEPARATION PROFILE - AVENUE 5 (1/2)
CV-T1002-EA	GRADE SEPARATION PROFILE - AVENUE S (2/2)
CV-T1003-EA	GRADE SEPARATION PROFILE - SIERRA HIGHWAY (1/2)
2V-T1004-EA	GRADE SEPARATION PROFILE - SIERRA HIGHWAY (2/2)
2V-T1005-EA	GRADE SEPARATION PROFILE - SIERRA HIGHWAY (2/2) GRADE SEPARATION PROFILE - FORESTON DRIVE (1/2)
SV-T1006-EA	GRADE SEPARATION PROFILE - FORESTON DRIVE (2/2)
50/ #765) F1	
	ROADWAY TYPICAL SECTIONS - SIERRA HIGHWAY
	ROADWAY TYPICAL SECTIONS - AVENUE S (1/2)
	ROADWAY TYPICAL SECTIONS - AVENUE S (2/2)
V-T3004-EA	ROADWAY TYPICAL SECTIONS - FORESTON DRIVE
	ACCESS ROAD PLANS, PROFILES AND TYPICAL SECTIONS
CV-Y4001-EA	ACCESS ROAD PLAN - PORTAL 1
CV-Y4002-EA	ACCESS ROAD PLAN - PORTAL 2
CV VIAAI DA	ACCECS DOAD BENETIE - BODTAL 1
CV-Y1001-EA	ACCESS ROAD PROFILE - PORTAL 1
CV-Y1002-EA	ACCESS ROAD PROFILE - PORTAL 2 (2/1)
CV-Y1003-EA	ACCESS ROAD PROFILE - PORTAL 2 (2/2)
CV-Y3001-EA	ACCESS ROADS TYPICAL SECTIONS - PORTALS E1A/E2A

						DESIGNED BY D.CORDOBA
						A.CAMACHO
		+	H			R. RODRIGUE
						N CHARGE A.RELANO
REV	DATE	В٧	5100	APR	CESCRIPTION	DATE 02/26/2021

PEPD RECORD SET ADDENDUM SR14A/E1A/E2A NOT FOR

CONSTRUCTION





CALIFORNIA HIGH-SPEED RAIL PROJECT PALMDALE TO BURBANK

ALIGNMENT "SR14A/E1A/E2A" ROADWAYS AND GRADE SEPARATIONS INDEX OF DRAWINGS

CONTRA	HSR	14-42
DRAWIN		B0001
SCALE	NO	SCALE

SHEET NO.

((A		(C CONTINUED)		(F CONTINUED)		(M CONTINUED)		(P CONTINUED)
	AGGREGATE BASE		CREEK	FTG	FOOTING	MP	METAL PLATE	PVMT	PAVEMENT
	ABANDON		CONTINUOUS REINFORCED	FWBT	FACING WESTBOUND TRAFFIC	MPGR	METAL PLATE GUARD RAILING	PVP	MAINTENANCE VEHICLE P
	ABUTMENT		CONCRETE PAVEMENT	FWY	FREEWAY	MPH	MILES PER HOUR	PVMT	PAVEMENT
	ASPHALT CONCRETE		CONCRETED ROCK SLOPE PROTECTION		G	MSE	MECHANICALLY STABILIZED EARTH	PVP	MAINTENANCE VEHICLE PI
	ASPHALT CONCRETE BASE		CURVE TO SPIRAL			MTL	MATERIAL		
	ADJUST		CEMENT TREATED BASE	GP	GRADING PLANE	MT	MAIN TRACK		(0)
	AHEAD		CEMENT TREATED PERMEABLE BASE	GR	GUARD RAILING			QTY	QUANTITY
	ALTERNATE		CEMENT TREATED PERMEABLE MATERIAL	GSP	GALVANIZED STEEL PIPE		The second secon	9.11	3001112111
	TIME FROM MIDNIGHT TO NOON		CENTERS	GTR	GUTTER	N	NORTH, NORTHING		R
	APPROXIMATE	Œ.	CENTERLINE		(H)	NB.	NORTHBOUND		
	ACCESS RESTRICTION			i.		NO.	NUMBER (MUST HAVE PERIOD)	R	RADIUS
	AGGREGATE SUBBASE ASPHALT TREATED PERMEABLE BASE	D	DEPTH	HDC	HEIGHT HIGH DESERT CORRIDOR	NOS. NS	NUMBERS (MUST HAVE PERIOD) NEAR SIDE	RD	ROAD
	ASPHALT TREATED PERMEABLE MATERIAL		DOUBLE	HR	HOUR	NTS	NOT TO SCALE	REINF	REINFORCED, REINFORCEM
	AVENUE		DEGREE	HMA	HOT MIXED ASPHALT	N/A	NOT APPLICABLE	pri	REINFORCING RELOCATE
	AVERAGE		DELINEATOR	HORIZ	HORIZONTAL	INC A	NOT AFFERDALE	REPL	REPLACEMENT
	AT		DETAIL, DETOUR	HP	HINGE POINT, HORSEPOWER			RET	RETAINING
	79		DRAINAGE INLET, DROP INLET	HST	HIGH SPEED TRAIN	OBLR	OBLITERATE	REV	REVISED
(В		DIAMETER	HSR	HIGH SPEED RAIL	OC	OVERCROSSING	RDWY	ROADWAY
BAGR	BRIDGE APPROACH GUARD RAILING		DIAPHRAGM	HWY	HIGHWAY	OD	OUTSIDE DIAMETER	RM	ROAD-MIXED
	BEGINNING OF BRIDGE		DISTANCE, DISTRICT		112 501111111	OF	OUTSIDE FACE	RP	RADIUS POINT, REFERENCI
	BEGIN HORIZONTAL CURVE		DOUBLE METAL BEAM BARRIER			OG	ORIGINAL GROUND	RR	RAILROAD
	BEGIN CURB RETURN		DRIVE	IB	IMPORTED BORROW	OGAC	OPEN GRADED ASPHALT CONCRETE	RSP	ROCK SLOPE PROTECTION
	BEGIN		DOUBLE THRIE BEAM BARRIER	ID.	INSIDE DIAMETER	ОН	OVERHEAD	RT	RIGHT
	BITUMINOUS COATED		DRIVEWAY	ĨF.	INSIDE FACE			RTE	ROUTE
BK	BACK			11/1	INCH, INCHES		(P)	RW	REDWOOD, RETAINING WAL
BKF	BACKFILL		(E)	INT	INTERIOR	P	PAGE	R/W	RIGHT OF WAY
BLDG	BUILDING	E	EAST, EASTING	INV	INVERT	PB	PULL BOX	RWY	RAILWAY
BLVD	BOULEVARD	EA	ACTUAL SUPERELEVATION	IRR	IRRIGATION	P-B	PALMDALE TO BURBANK		
ВМ	BENCH MARK	EU	UNBALANCED SUPERELEVATION			PC	POINT OF CURVATURE, PRECAST		(5
	ВОТТОМ		EASEMENT			PCC	POINT OF COMPOUND CURVE,	-	colleil supplications
B-P	BAKERSFIELD TO PALMDALE		END OF BRIDGE	JCT	JUNCTION		PORTLAND CEMENT CONCRETE	5	SOUTH, SUPPLEMENT
	BRIDGE		END HORIZONTAL CURVE	JPCP	JOINTED PLAIN CONCRETE PAVEMENT	PCP	PERFORATED CONCRETE PIPE,	SAE	STRUCTURE APPROACH EM
	BEARING		END CURB RETURN	JT	JOINT		PRESTRESSED CONCRETE PIPE	SALV	SALVAGE
	BEGIN VERTICAL CURVE		ELEVATION			PCVC	POINT OF COMPOUND VERTICAL CURVE	SB	SOUTHBOUND
BW	BARBED WIRE		EXTRALEGAL LEAD NETWORK			PED	PEDESTRIAN	SC	SPIRAL TO CURVE
7	C		EMBANKMENT	K.	DISTANCE TO ACHIEVE 1% GRADE CHANGE		PEDESTRIAN OVERCROSSING	SCRRA	SOUTHERN CALIFORNIA RE
	Service and African and American Artists		ENGINEER			PED UC	PEDESTRIAN UNDERCROSSING	SCHIA	RAIL AUTHORITY
	CABLE ANCHOR ASSEMBLY		EDGE OF DECK			PG	PROFILE GRADE	SD	STORM DRAIN
	CONSTRUCTION AREA SIGN		EDGE OF PAVEMENT	1	LENGTH	PI	POINT OF INTERSECTION	SEC	SECOND
	CONCRETE BARRIER		EQUATION, EQUAL	LAT	LATITUDE	PJP	PARTIAL JOINT PENETRATION	SECT	SECTION
	CONCRETE BLOCK WALL CENTER TO CENTER		EDGE OF SHOULDER	LCB	LEAN CONCRETE BASE	P,PL	PLATE PROPERTY LINE	SEP	SEPARATION
	CALIFORNIA HIGH SPEED RAIL		EDGE OF TRAVELED WAY END VERTICAL CURVE	LMF	LIGHT MAINTENANCE FACILITY	P/L PM	POST MILE, TIME FROM NOON TO MIDNIGH	T SG	SUBGRADE
	AUTHORITY		ENDWALL	LN.	LANE	PN	PAVING NOTCH	SHLD	SHOULDER
	CALIFORNIA HIGH SPEED TRAIN	100	EXCAVATION	LOC	LOCATION LAYOUT LINE	POB	POINT OF BEGINNING	SHT	SHEET
	CALIFORNIA HIGH SPEED RAIL	EXIST, EX.		LONG	LONGITUDE	POC	POINT OF HORIZONTAL CURVE	SIM	SIMILAR
	CENTER OF GRAVITY		EXPANSION	LONGIT	LONGITUDINAL	POE	POINT OF ENDING	S	STATION LINE
	CHANNEL		EXPANSION JOINT	LT	LEFT	POT	POINT OF TANGENT	SM	SELECTED MATERIAL
	CAST IRON		EXPRESSWAY	56	75.1	POVE	POINT OF VERTICAL CURVE	SPEC	SPECIAL, SPECIFICATIONS
	CAST-IN-DRILLED-HOLE		EXTERIOR		M	PP	PIPE PILE, PLASTIC PIPE, POWER POLE	55	SLOPE STAKE, SPIRAL TO
	CENTERLINE, CLASS			MAINT	MAINTENANCE	PPEF	PROPOSED PERMANENT	SR	STATE ROUTE
	CLASS 2		(F)	MAX	MAXIMUM		ENVIRONMENTAL FOOTPRINT	ST	STREET, SPIRAL TO TANG
	CHAIN LINK FENCE (6 FT)	FEBT	FACING EASTBOUND TRAFFIC	MB.	METAL BEAM	PRC	POINT OF REVERSE CURVE	STA	STATION
	GLEAR, CLEARANCE		FINISHED GRADE	MBB	METAL BEAM BARRIER	PROP	PROPOSED	STBB	SINGLE THRIE BEAM BARR
	COUNTY	FL	FLOW LINE	MBGR	METAL BEAM GUARD PAILING	PRF	POINT OF VERTICAL CURVE	STD	STANDARD
COL	COLUMN	FNBT	FACING NORTHBOUND TRAFFIC	MED	MEDIAN	PRVC	PAVEMENT REINFORCING FABRIC	STR	STRUCTURE
	CONCRETE		FACE OF CONCRETE	MIN	MINIMUM	PS&E	POINT OF REVERSE VERTICAL CURVE	SRS	STAND ALONE RADIO SITE
	CONNECTOR		FRONTAGE ROAD	MISC	MISCELLANEOUS	PS,P/S	PLANS, SPECIFICATIONS AND ESTIMATES	SURF	SURFACING
CONST	CONSTRUCT, CONSTRUCTION		FAR SIDE, FINISHED SURFACE	M/L	MAIN LINE (RAILWAY)	PSP	PRESTRESSED, PARALLEL STATION	SW	SIDEWALK, SOUND WALL
	CONTINUOUS		FACING SOUTHBOUND TRAFFIC	MOD	MODIFIED, MODIFY	PT	POINT OF TANGENCY	SWR SWS	SEWER SWITCHING STATION
COORD	COORDINATE	FT	FOOT, FEET	MON	MONUMENT	PVI	POINT OF VERTICAL INTERSECTION	CNC	
			D_CORDOBA PEPD RECORD SET				CALIFORNIA HIGH-S	PEED RA	IL PROJECT
	+		DRAWN BY	in l			PALMDALE		
	+-		CHECKED BY SR14A/E1A/E2A	SEN	VER PARENTE		ALIGNMENT "S ROADWAYS AND G		Transfer to the second
			The state of the s				ROADWAYS AND C	TABLE SEPAR	
			IN CHARGE NOT FOR A.RELANO CONSTRUCTION	0	CALIFO	DRNIA		ZNOITAL	NO



GENERAL NOTES


1. THE FOLLOWING ARE ROADWAY DESIGN STANDARD AND GUIDELINES: A. CALTRANS HIGHWAY DESIGN MANUAL (2016)

B. AASHTO ROADSIDE DESIGN GUIDE (2011)

C. APPLICABLE LOCAL DESIGN STANDARD AND GUIDELINES (I.E., CITY OF PALMDALE)
STA 296+82.67 (SPRUCE CT) IS THE NORTHERN LIMIT OF THE PALMDALE-BURBANK ENVIRONMENTAL DOCUMENT.
NORTH OF THIS POINT REFER TO BAKERSFIELD-PALMDALE ENVIRONMENTAL DOCUMENT.

DESIGN FEATURES BETWEEN STA 265+00.00 AND STA 296+82.67 (SPRUCE CT) SHOWN FOR REFERENCE ONLY.

LEGEND

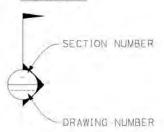

PROPOSED RIGHT OF WAY EXISTING RIGHT OF WAY

RETAINING WALL FILL

CUT

NOISE BARRIER (POTENTIAL)

OG / ORIGINAL GROUND



REMOVE BASE & SURFACING



POINT OF MINIMUM VERTICAL CLEARANCE




WATER SURFACE




ESTIMATED 100-YEAR FLOOD ELEVATION



EXISTING HIGH VOLTAGE TOWER

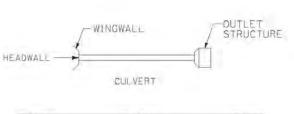

255+00 260+00 265+00 CONTROL LINE EXAMPLE "A" LINE

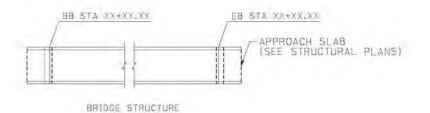

CALIFORNIA HIGH-SPEED RAIL PROJECT PALMDALE TO BURBANK ALIGNMENT "SR14A/E1A/EA2"

ROADWAYS AND GRADE SEPARATIONS ABBREVIATIONS AND LEGEND

CONTRAC	T NO. SR14-42
DRAWING C	No. V-B0003
SCALE	SCALE
SHEET N	0.

R. RODRIGUE A.RELANO BY DHN APP DESCRIPTION 02/26/2021


PEPD RECORD SET


NOT FOR


CONSTRUCTION







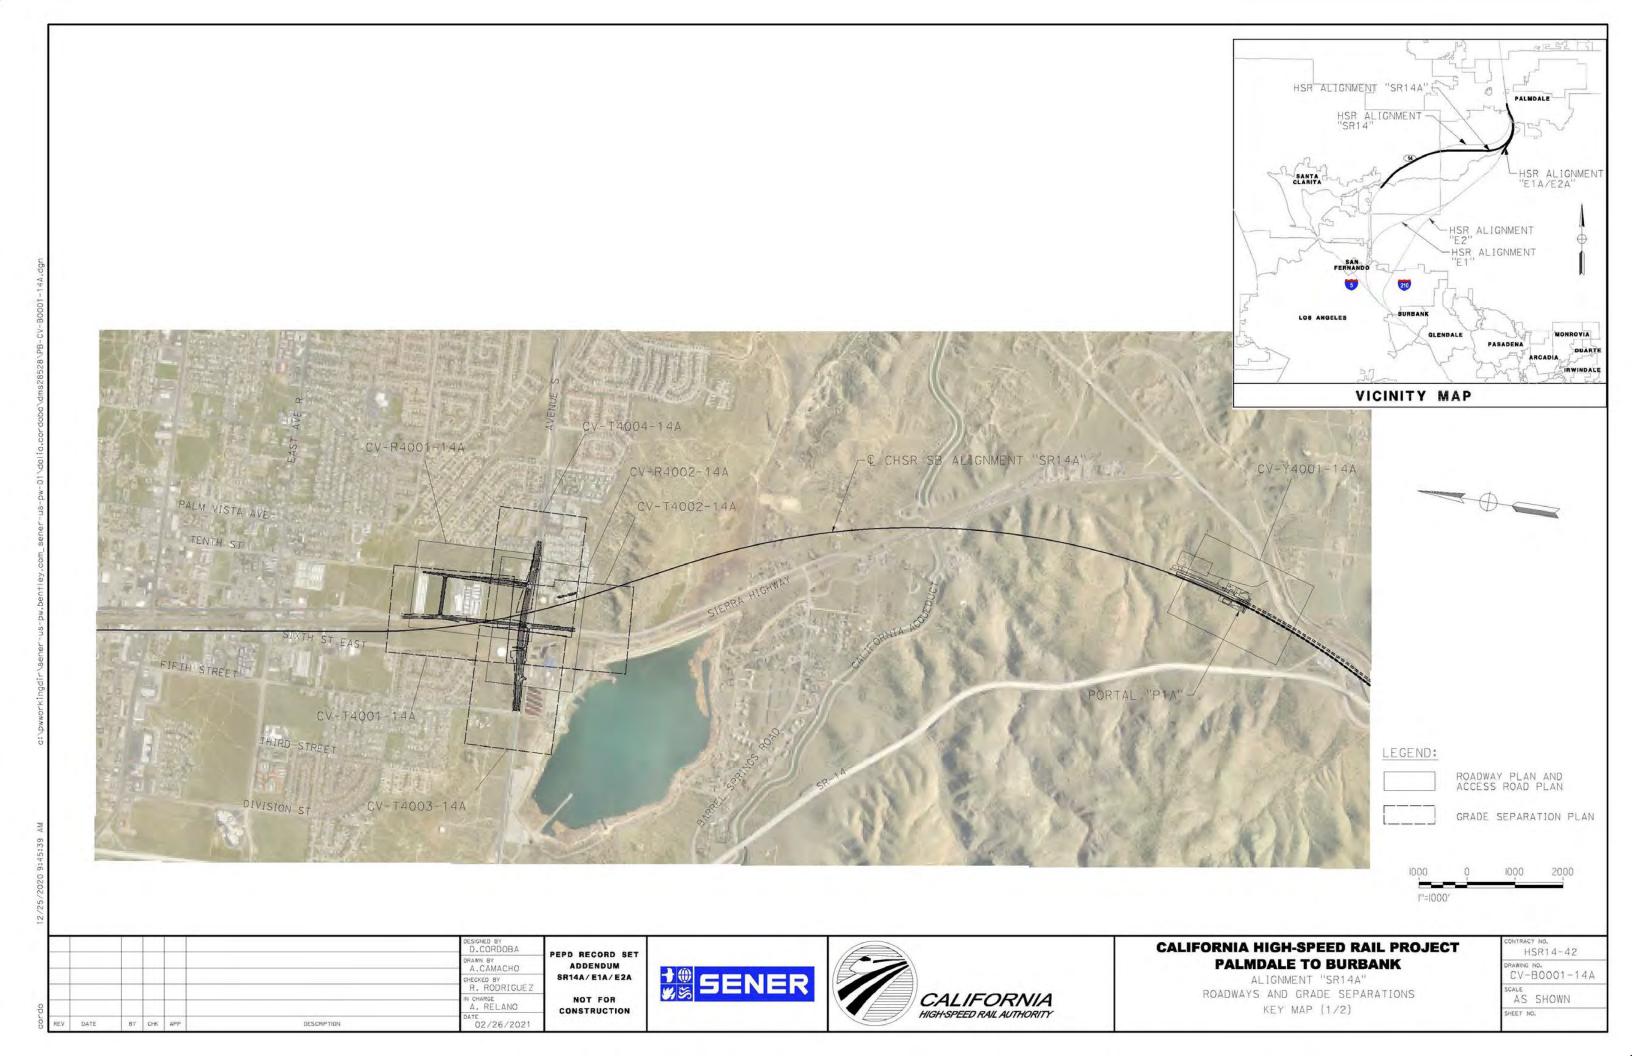


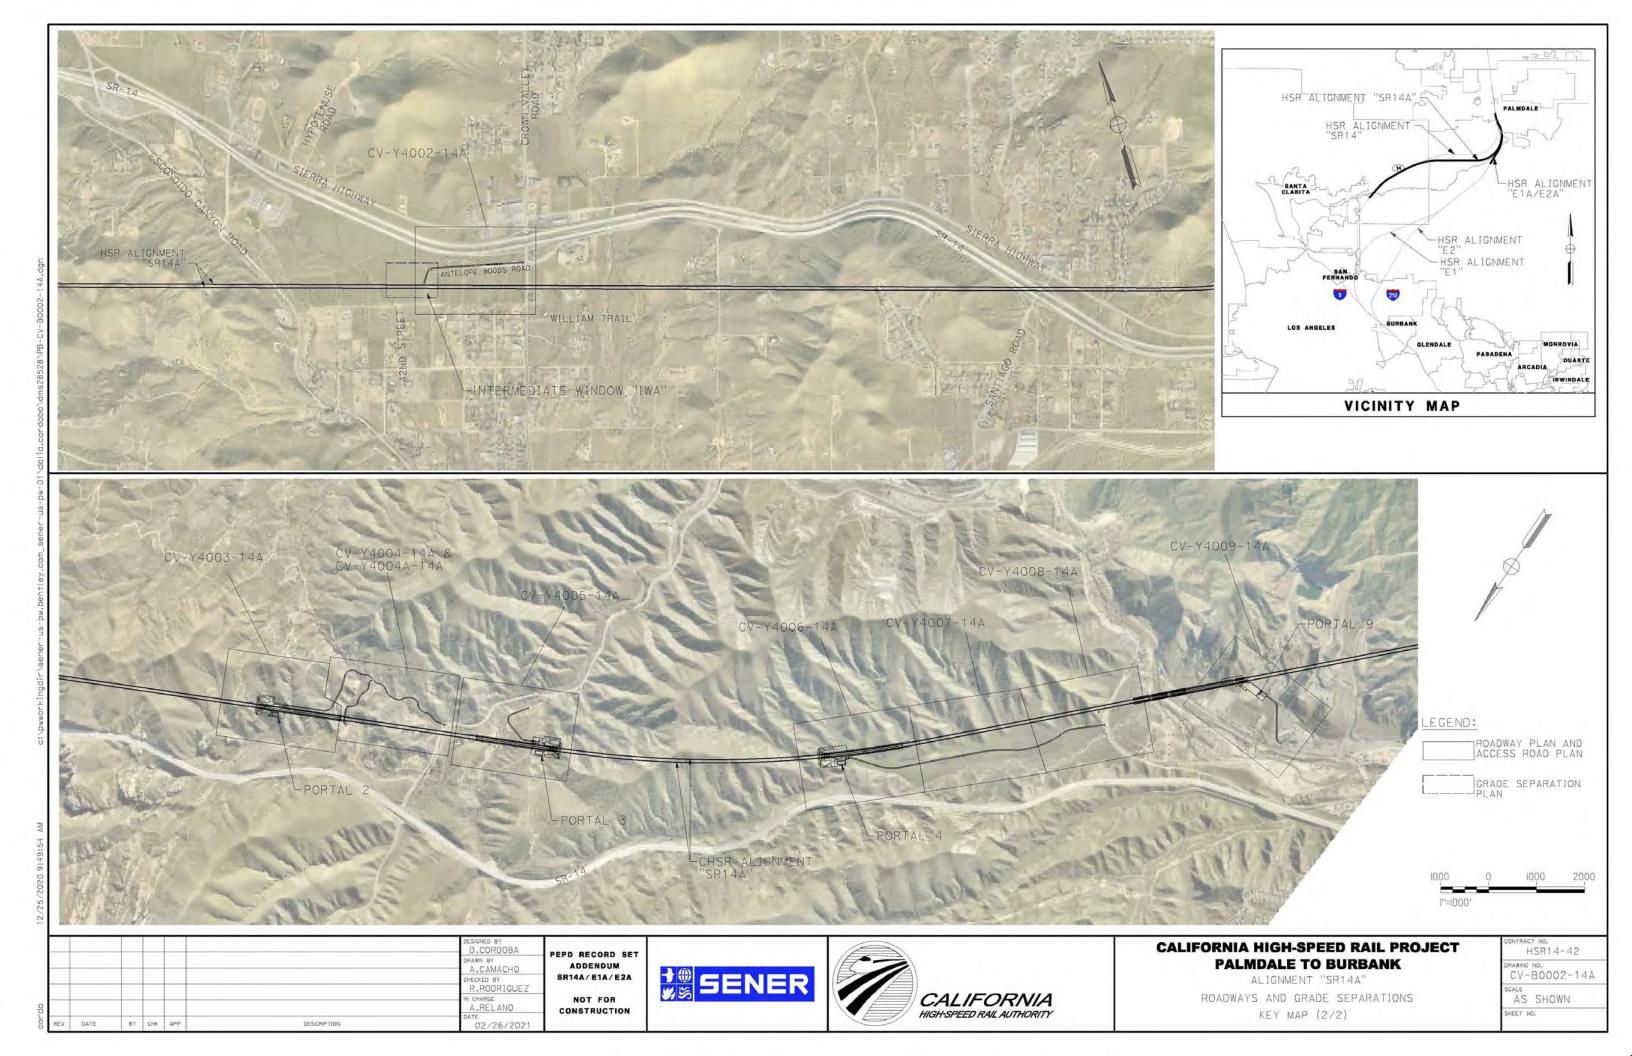


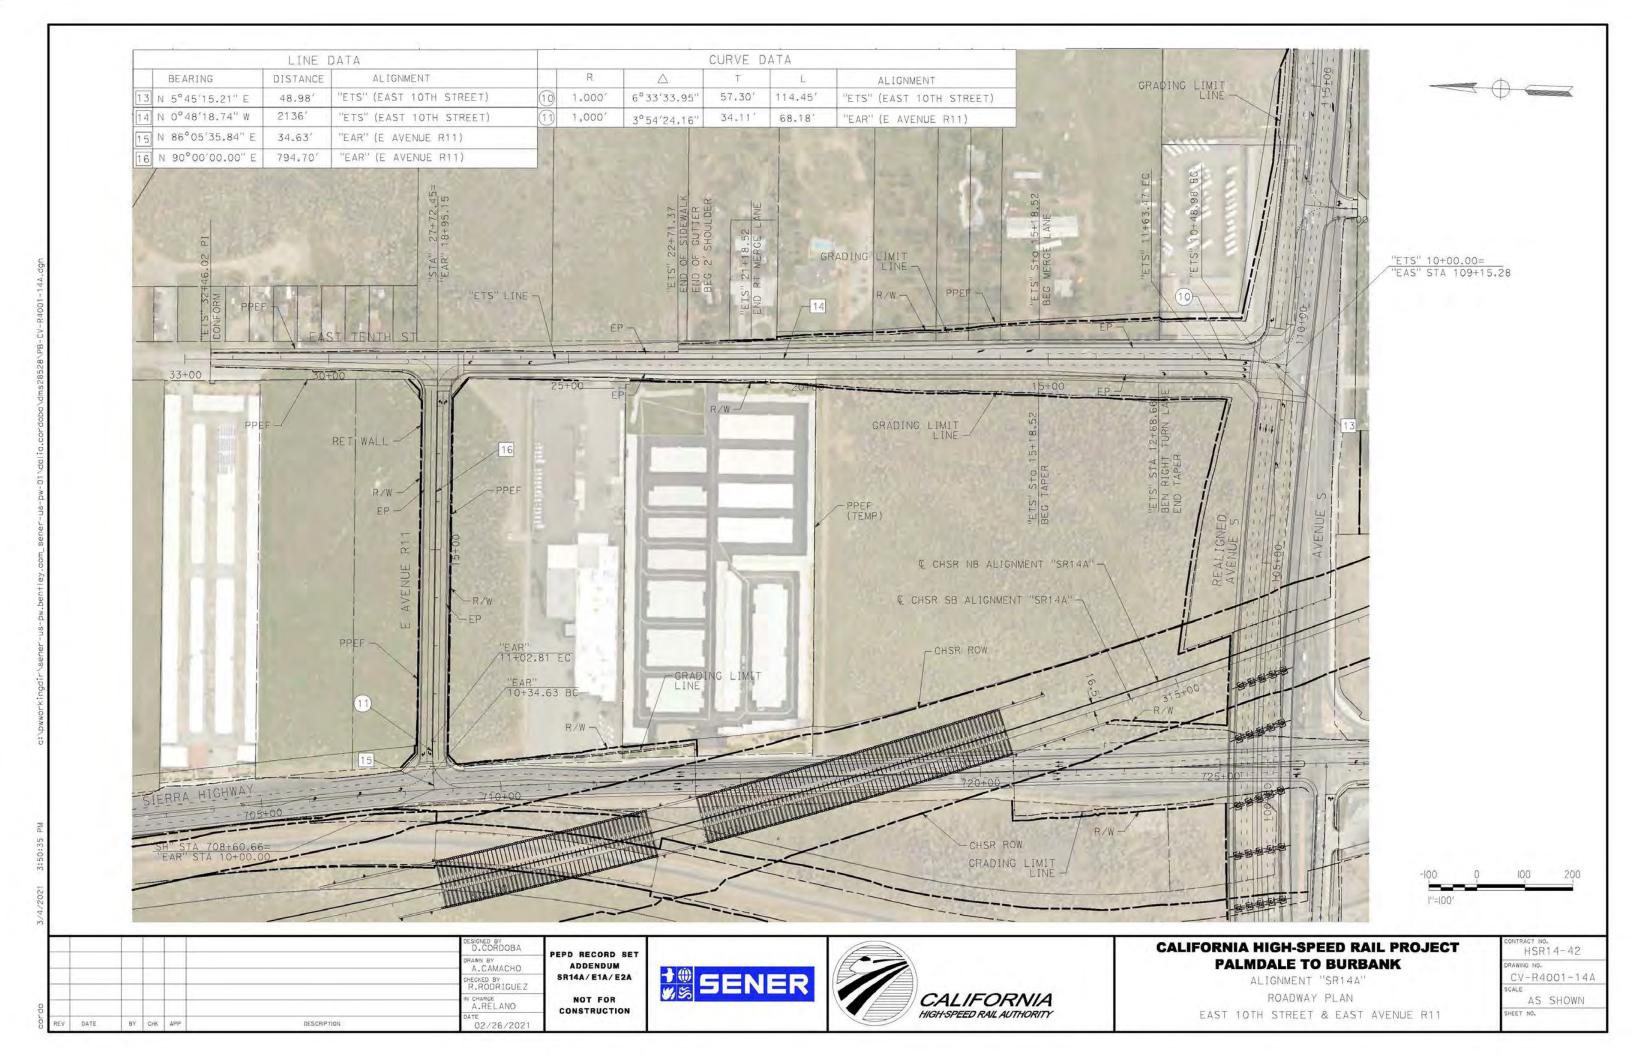


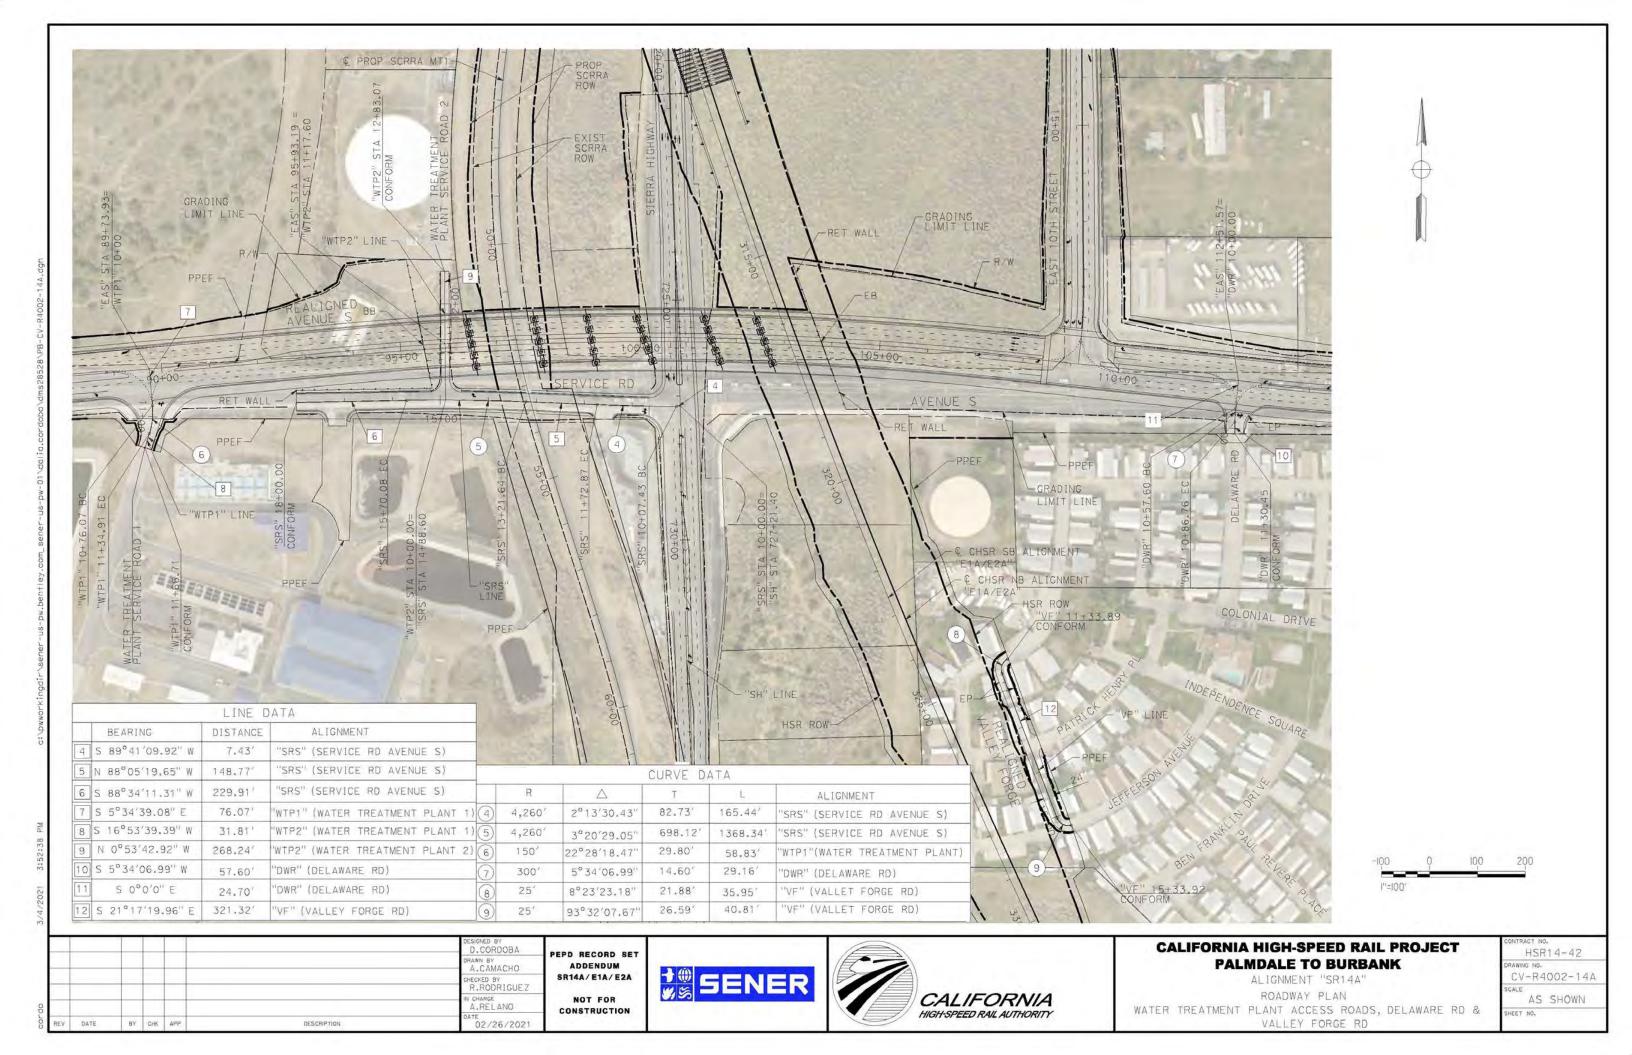

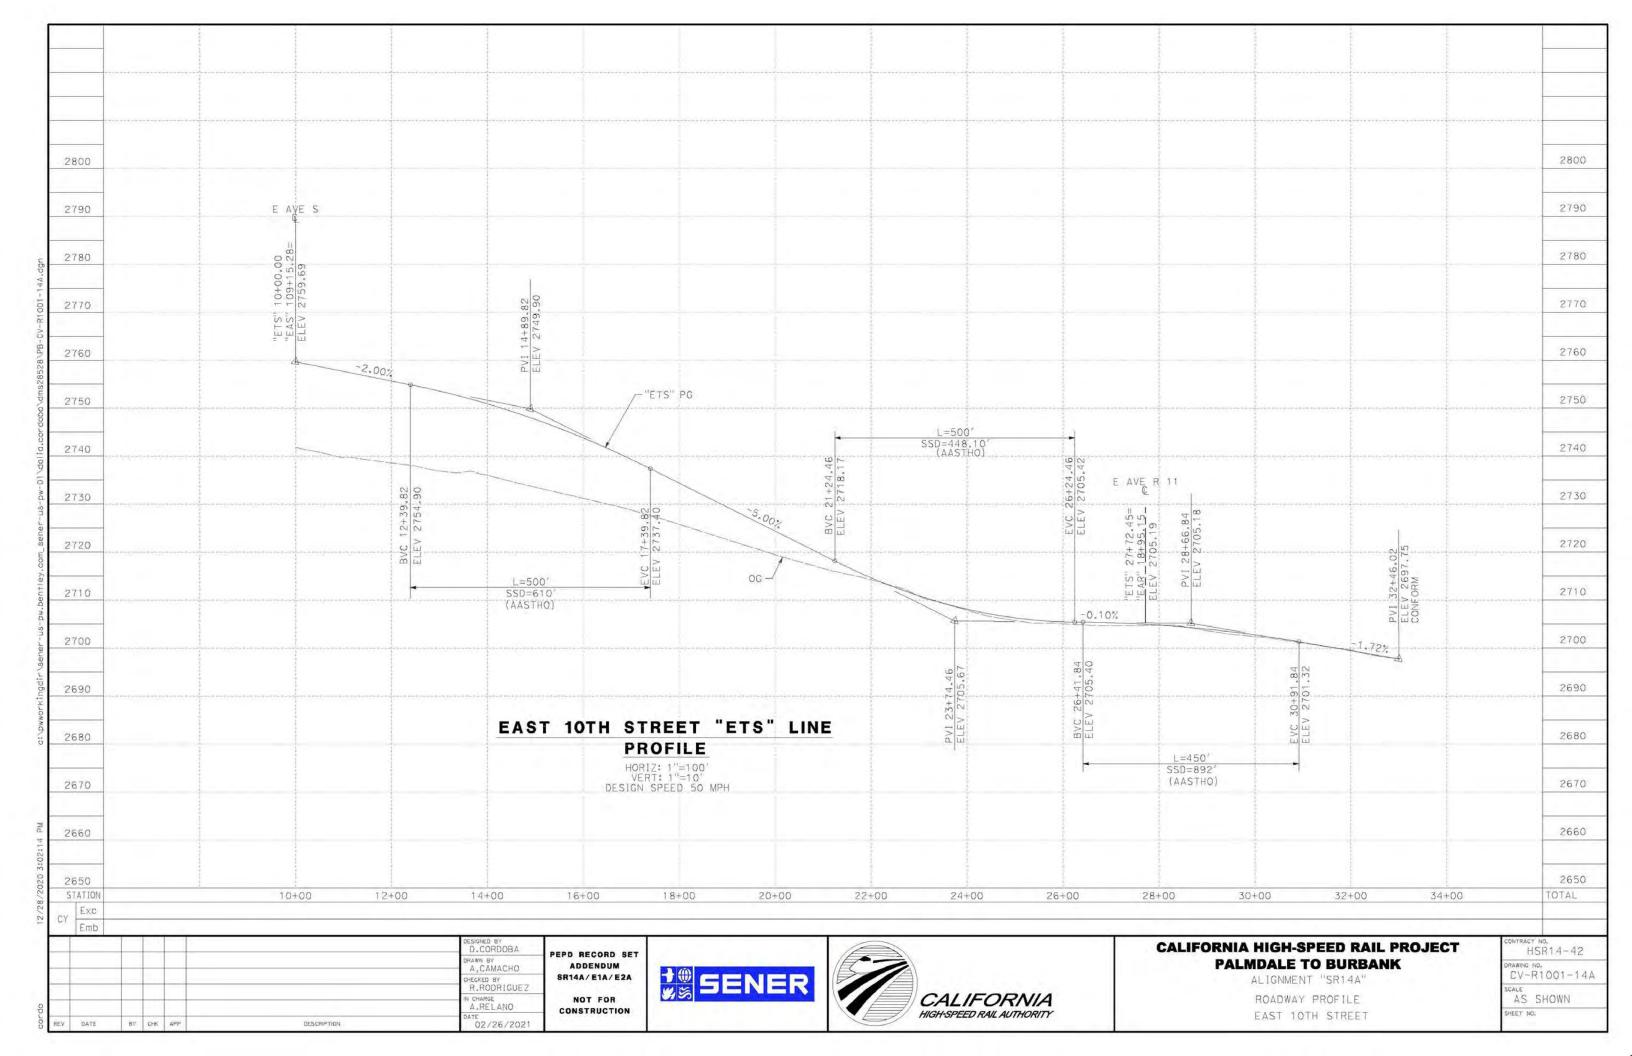

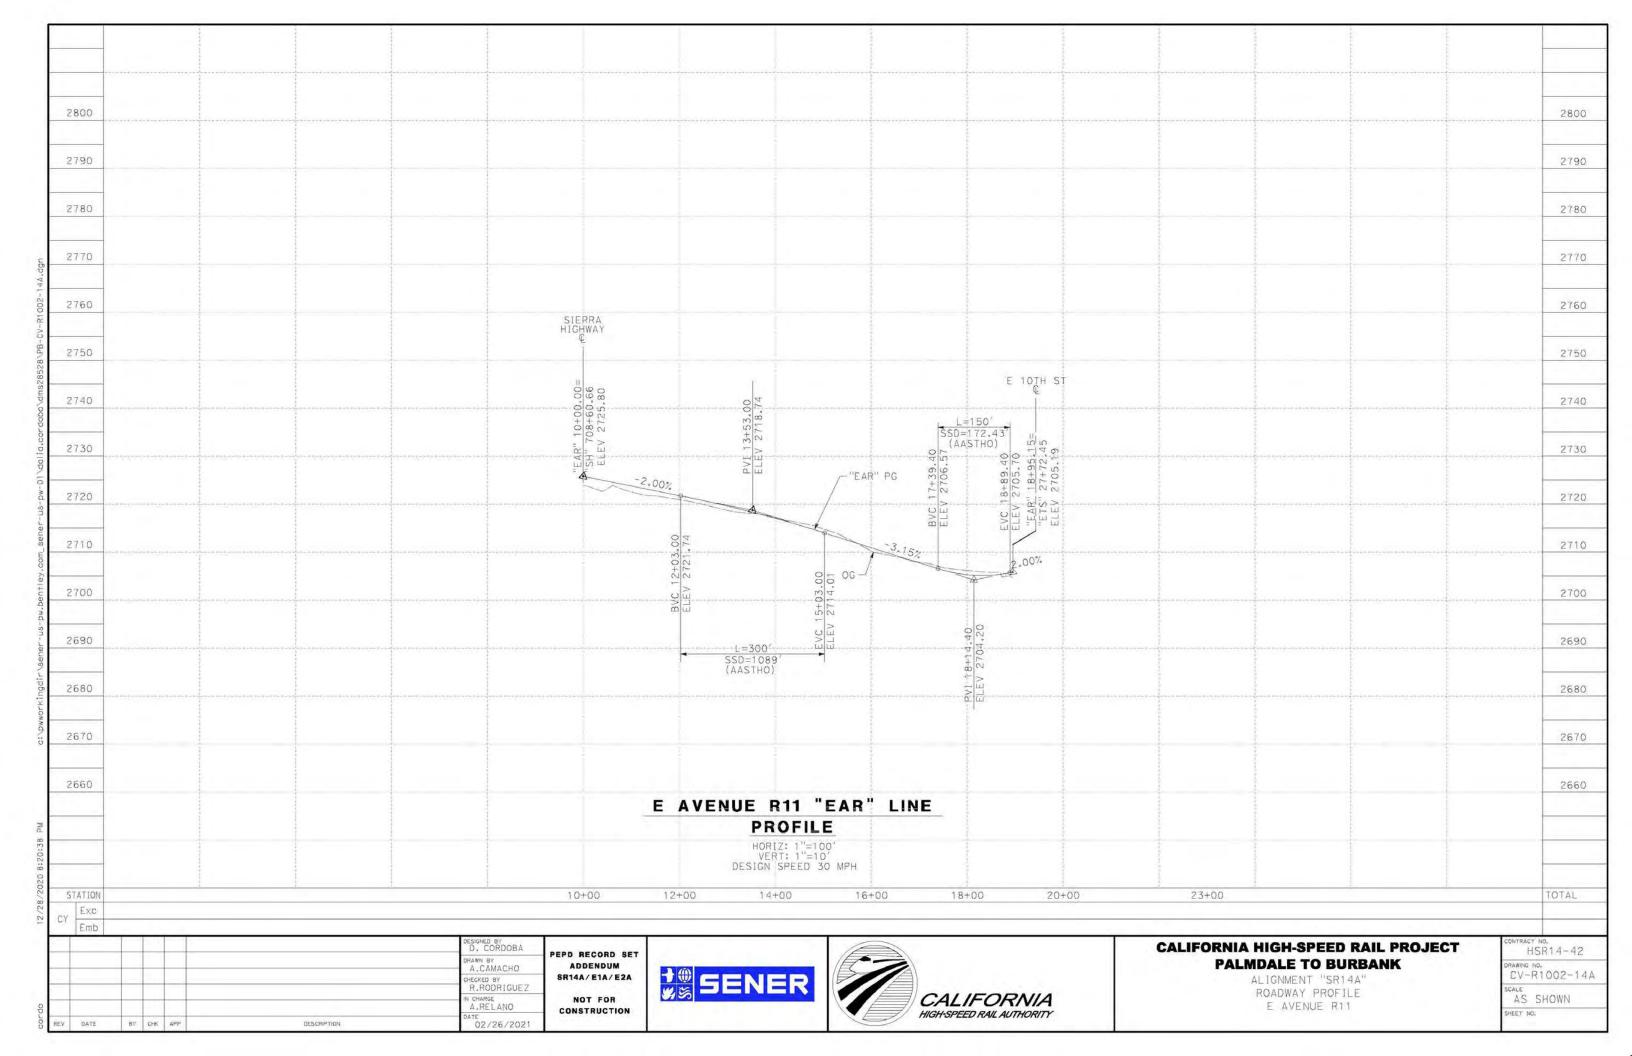


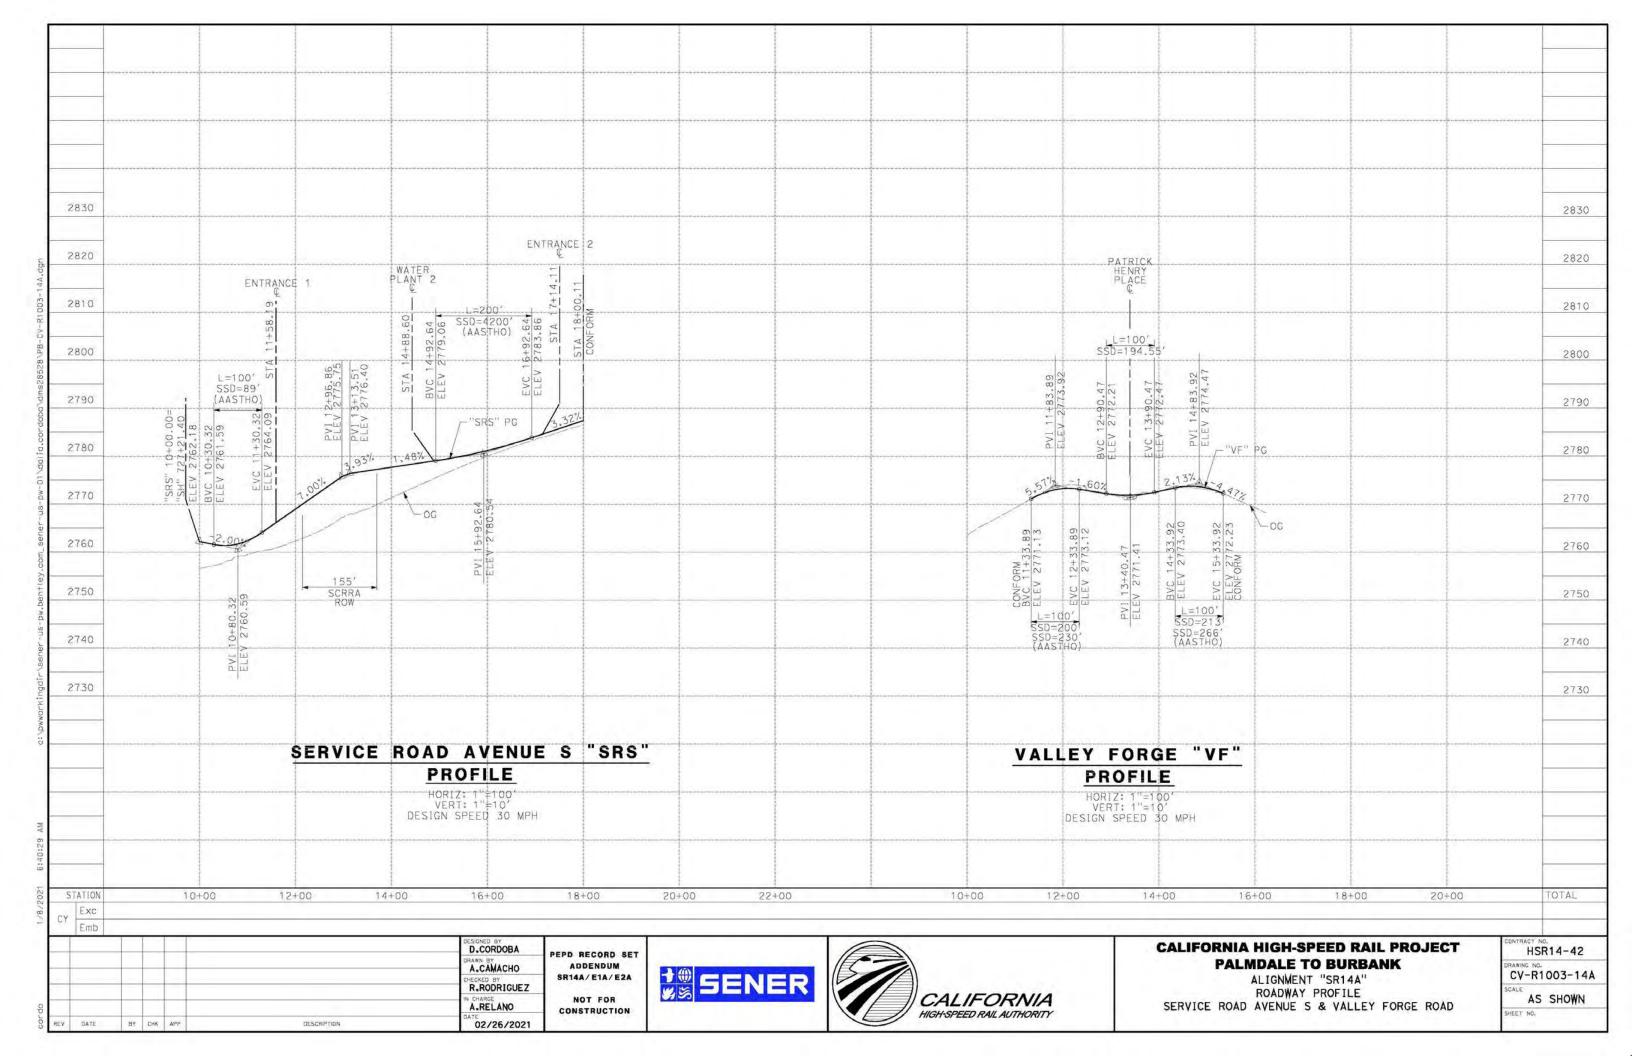

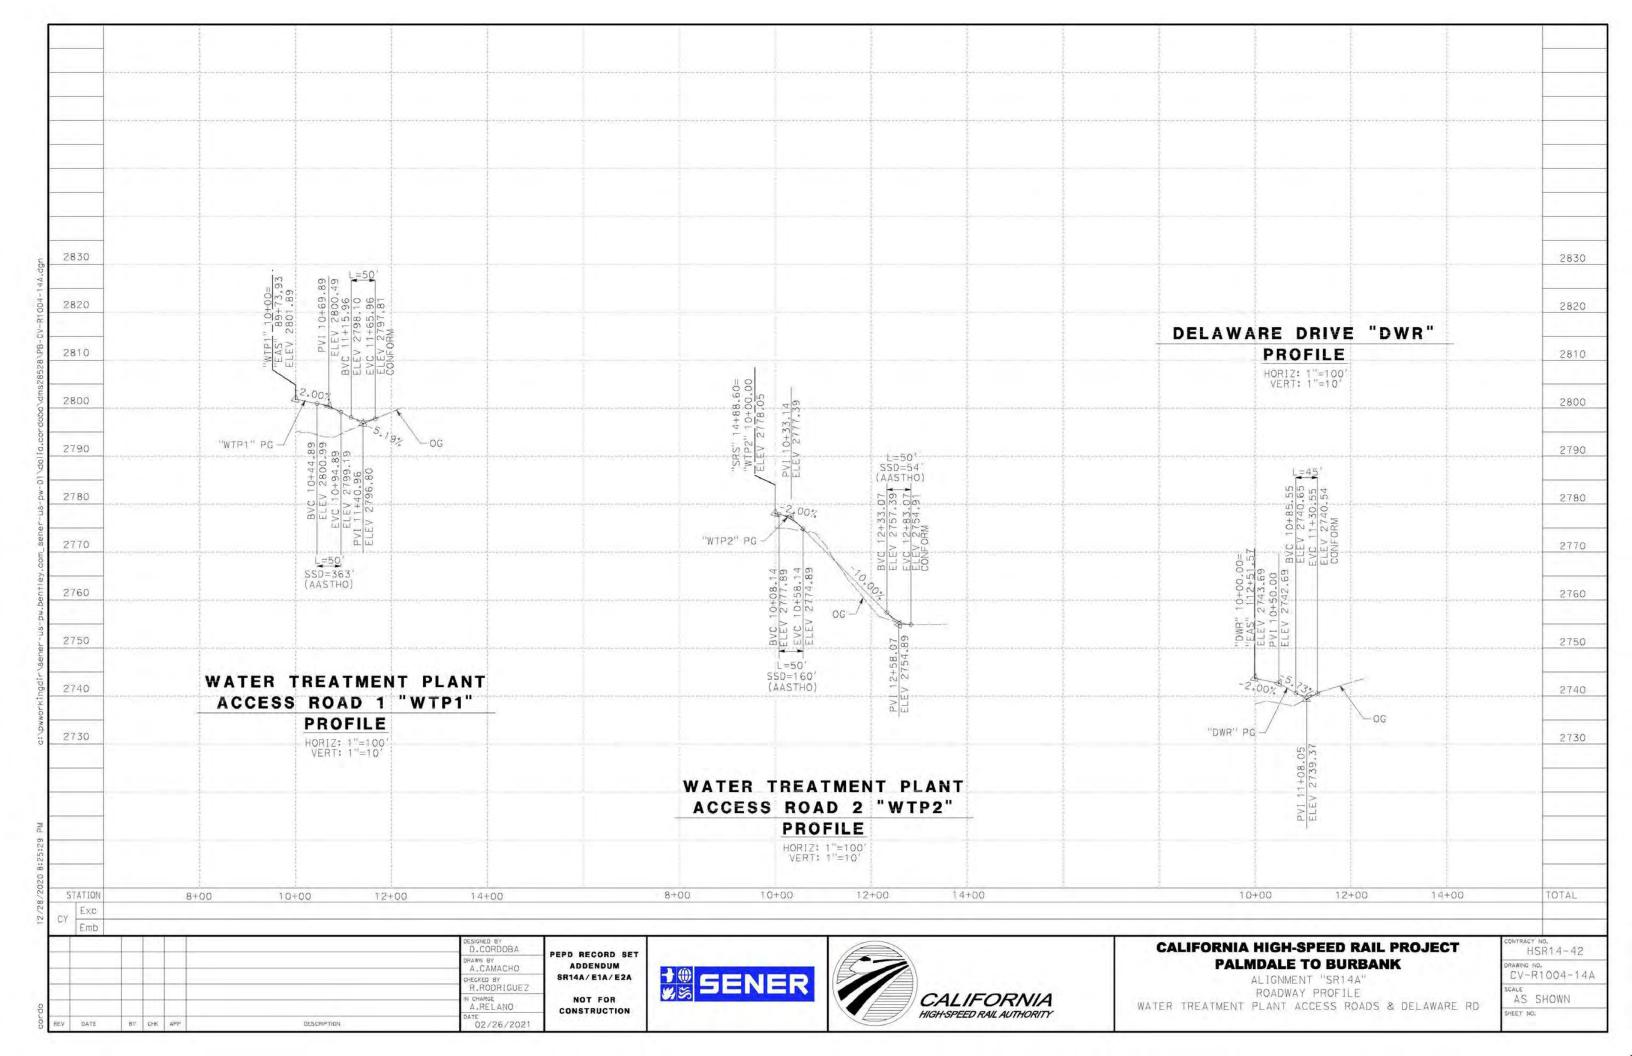

EAST 10TH ST

STA 12+68.66 TO STA 22+71.37 SECONDARY ARTERIAL PER CITY OF PALMDALE GENERAL PLAN

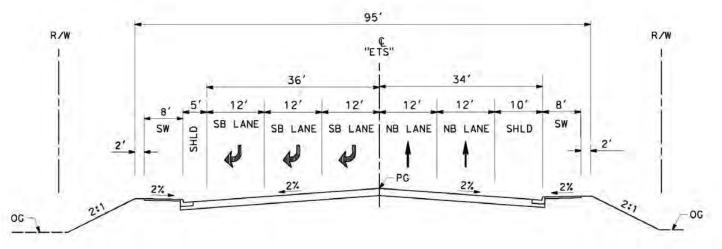

EAST 10TH ST

STA 10+76.75 TO STA 12+68.66 SECONDARY ARTERIAL PER CITY OF PALMOALE GENERAL PLAN

		1	100			DESIGNED BY D.CORDOBA	-
						DRAWN BY A.CAMACHO	PE
				-		CHECKED BY R.RODRIGUEZ	1 *
		+	\vdash			IN CHARGE A.RELANO	1.
REV	DATE	BY	СНК	APP	DESCRIPTION	DATE 02/26/2021	1

PEPD RECORD SET
ADDENDUM
SR14A/E1A/E2A
NOT FOR
CONSTRUCTION






CALIFORNIA HIGH-SPEED RAIL PROJECT PALMDALE TO BURBANK


ALIGNMENT "SR14A"
ROADWAY TYPICAL SECTIONS
EAST 10TH STREET (1/2)

HSR14-42
CV-R3001-14
SCALE AS SHOWN

AS SHOWN

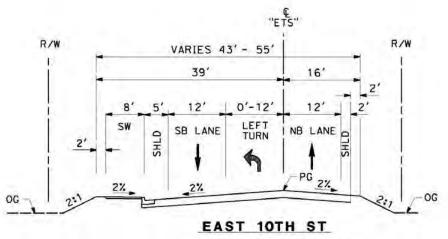


STA 24+22.42 TO STA 27+49.52 SECONDARY ARTERIAL PER CITY OF PALMDALE GENERAL PLAN

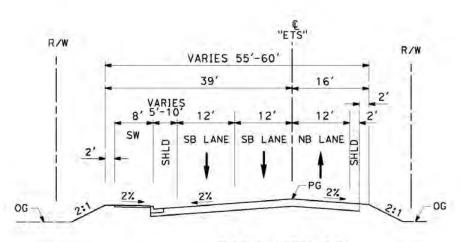


EAST 10TH ST

STA 22+71.37 TO STA 24+22.42 SECONDARY ARTERIAL PER CITY OF PALMDALE GENERAL PLAN

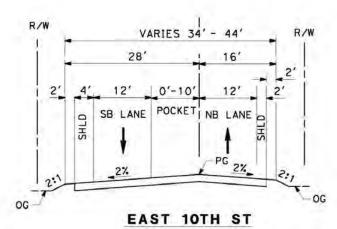

STA 27+49.52 TO STA STA 32+45.63 SECONDARY ARTERIAL RER CITY OF PALMDALE GENERAL PLAN

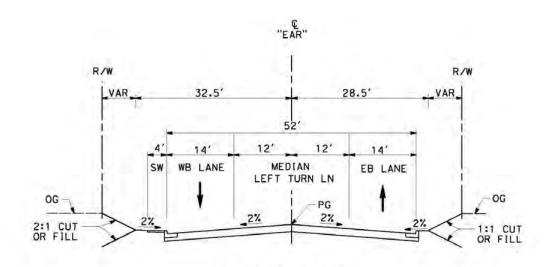

E AVENUE R11

STA 10+00 TO STA 18+95.15 LOCAL INTERIOR STREET PER CITY OF PALMDALE GENERAL PLAN

		1 =	M			DESIGNED BY D.CORDOBA	PE
		-				A.CAMACHO] -
\dashv		+				R.RODRIGUEZ	l *
		+				A.RELANO	١,
REV	DATE	BY	СНК	APP	DESCRIPTION	DATE 02/26/2021	1

PEPD RECORD SET
ADDENDUM
SR14A/E1A/E2A
NOT FOR
CONSTRUCTION






CALIFORNIA HIGH-SPEED RAIL PROJECT PALMDALE TO BURBANK

ALIGNMENT "SR14A"


ROADWAY TYPICAL SECTIONS
EAST 10TH STREET (2/2) & E AVENUE R11

CONTRA	HSF	114-42
CV	C NO.	002-14A
SCALE	ū.	SHOWN
SHEET	NO.	

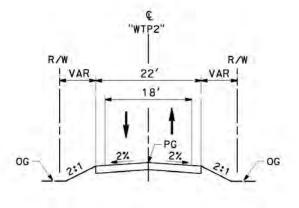


WATER TREATMENT PLANT ACCESS ROAD 2

STA 10+00 TO 5TA 12+68.24

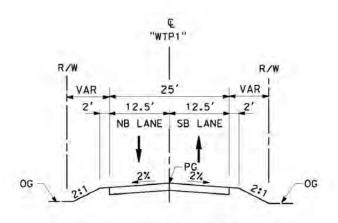


WATER TREATMENT PLANT ACCESS ROAD1

STA 10+00 TO STA 11+66.71

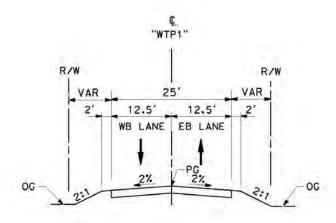

DELAWARE RD

STA 10+00 TO STA 11+66.71

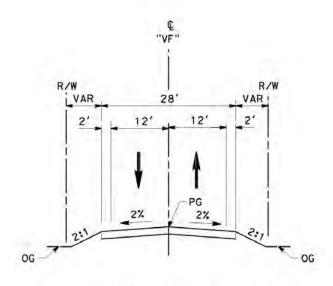

VALLEY FORGE RD

11+39.62 TO 15+33.61

		1 =	M			DESIGNED BY D.CORDOBA	PE
		-				A.CAMACHO	
\dashv		+				R.RODRIGUEZ	1
		1				IN CHARGE A.RELANO	
REV	DATE	BY	СНК	APP	DESCRIPTION	DATE 02/26/2021	

PEPD RECORD SET
ADDENDUM
SR14A/E1A/E2A
NOT FOR
CONSTRUCTION





CALIFORNIA HIGH-SPEED RAIL PROJECT PALMDALE TO BURBANK


ALIGNMENT "SR14A"


ROADWAY TYPICAL SECTIONS


WATER TREATMENT PLANT ACCESS ROADS, DELAWARE RD &


VALLEY FORGE RD

ĺ	CONTRACT NO. HSR14-42 ORAWING NO. CV-R3003-14A				
	NO SCALE				
	SHEET NO.				

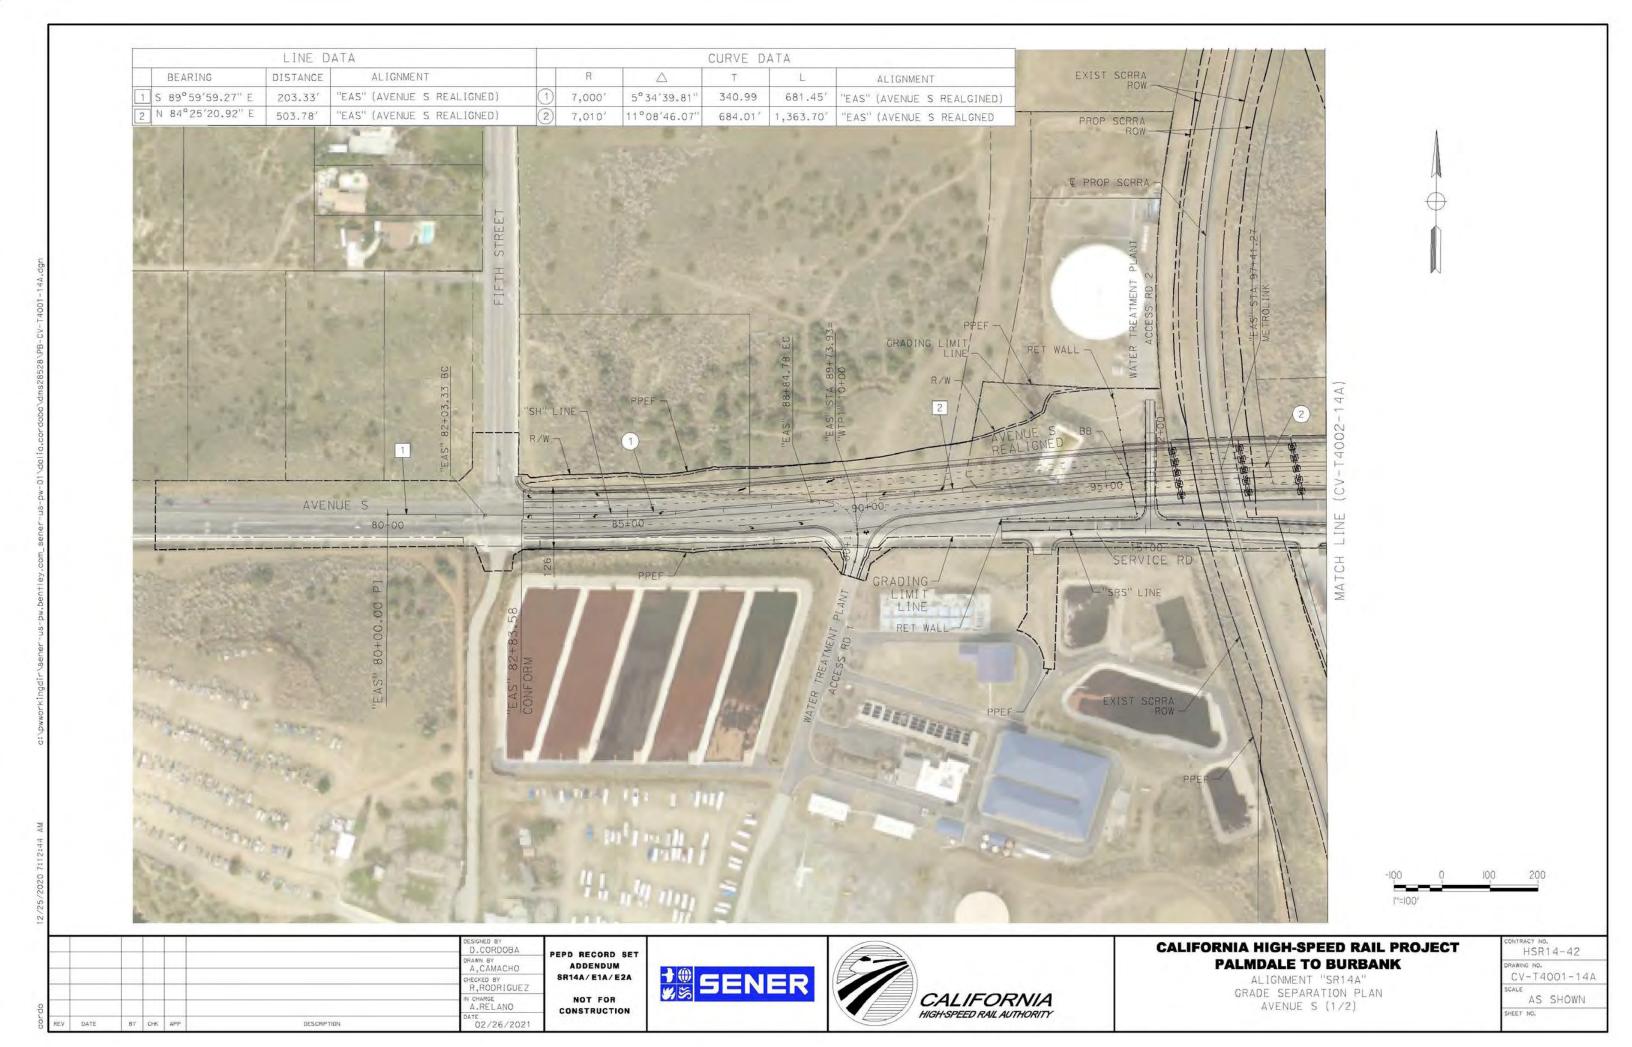

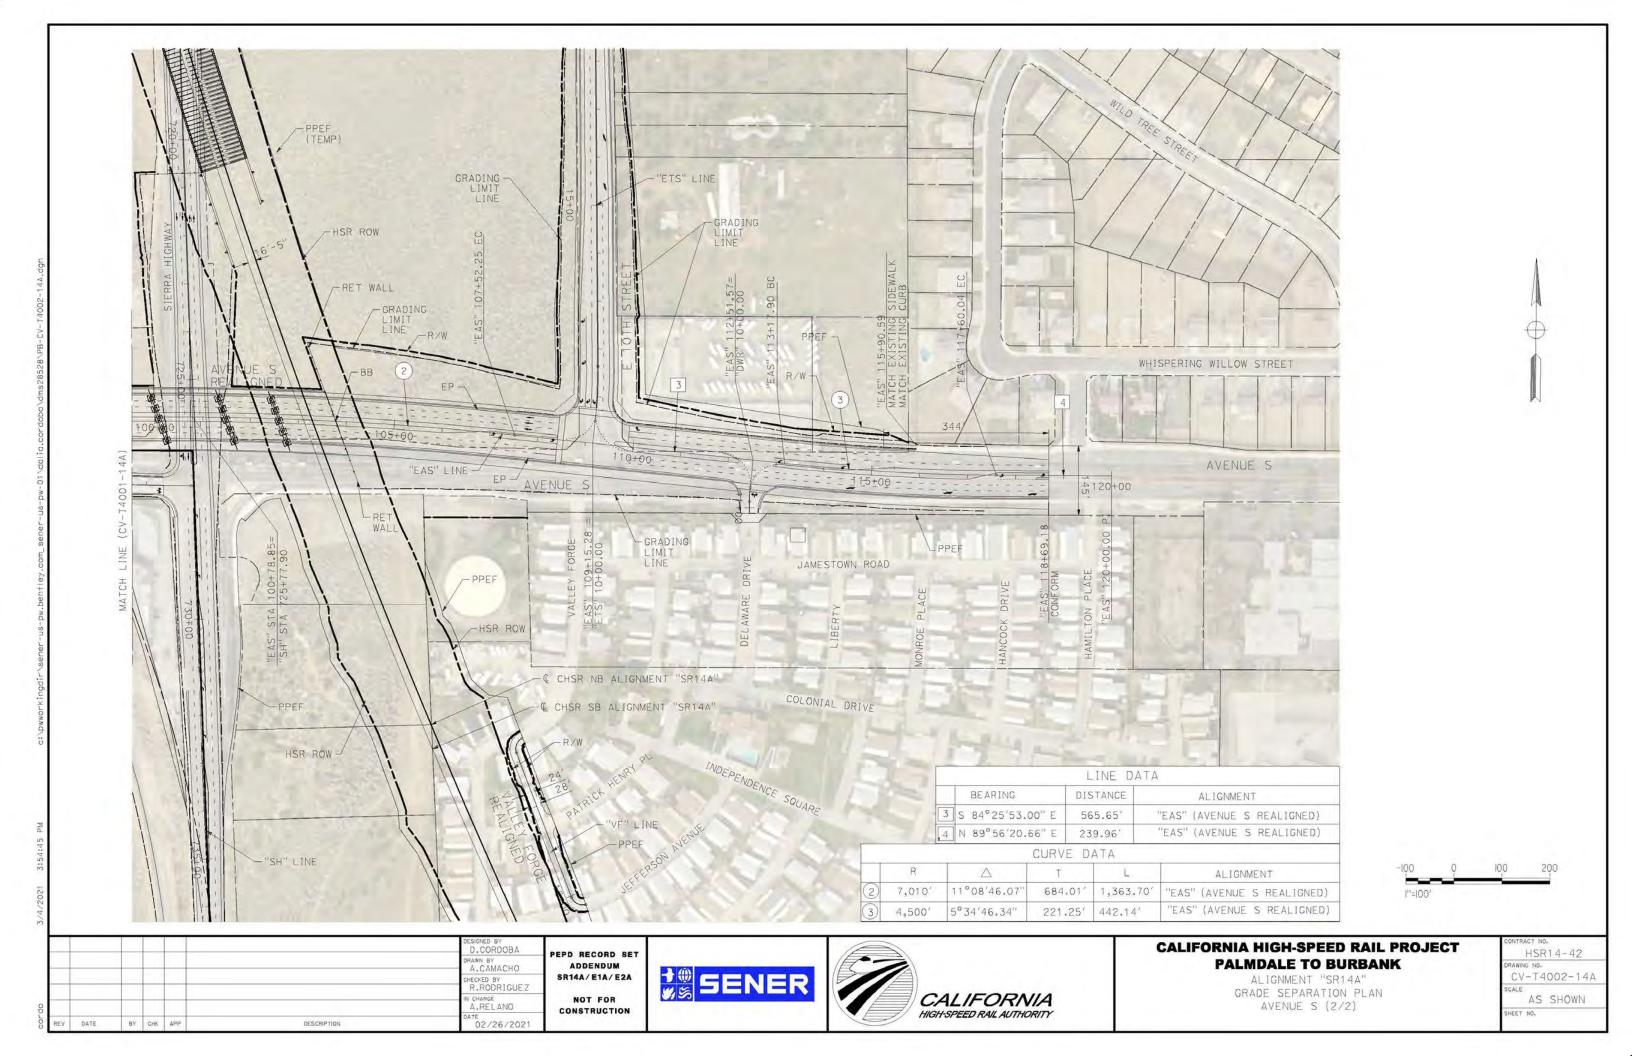

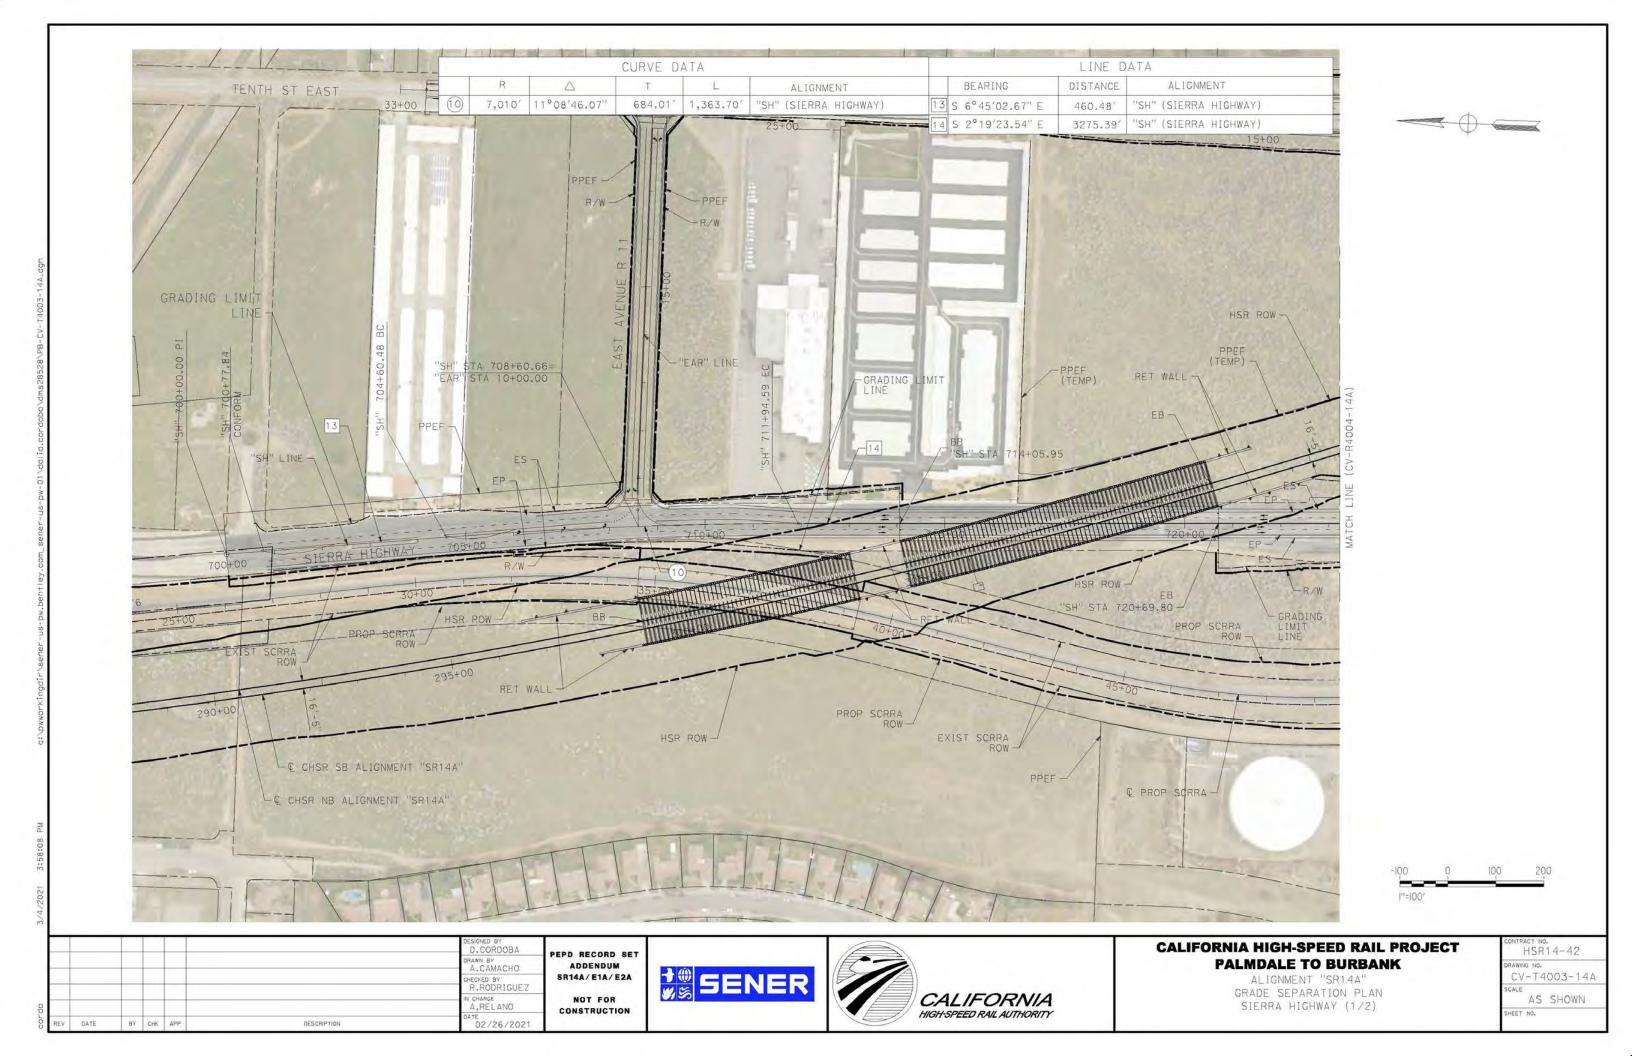

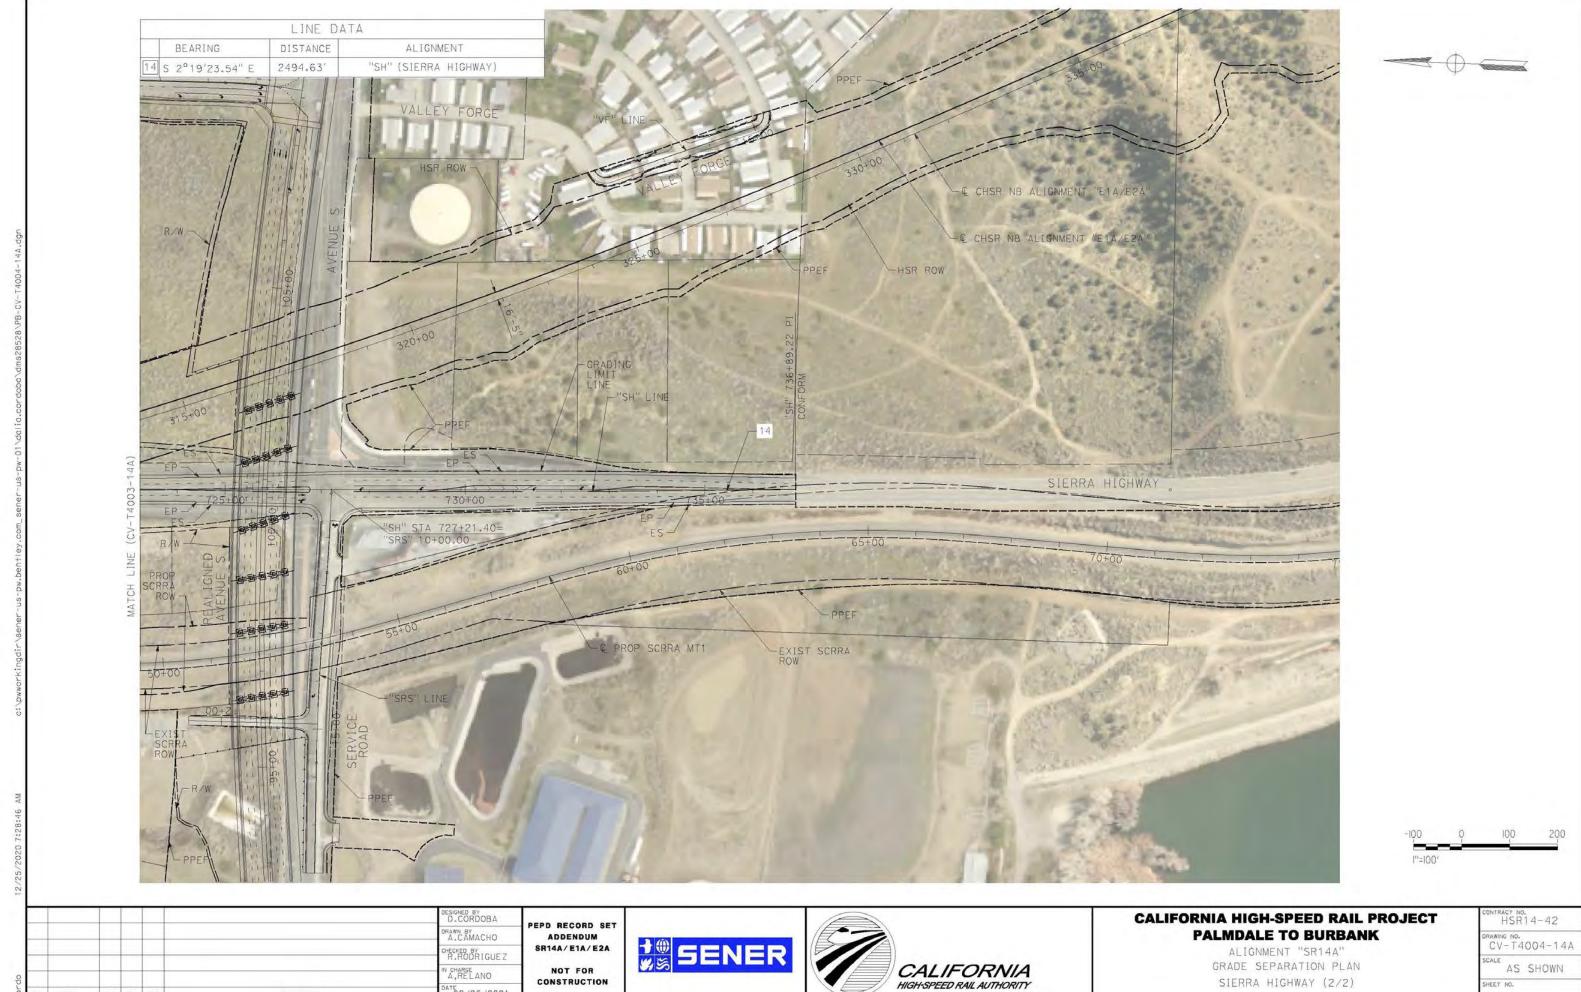

CONSTRUCTION


ATE 02/26/2021


BY CHK APP


DESCRIPTION


AS SHOWN

SIERRA HIGHWAY (2/2)

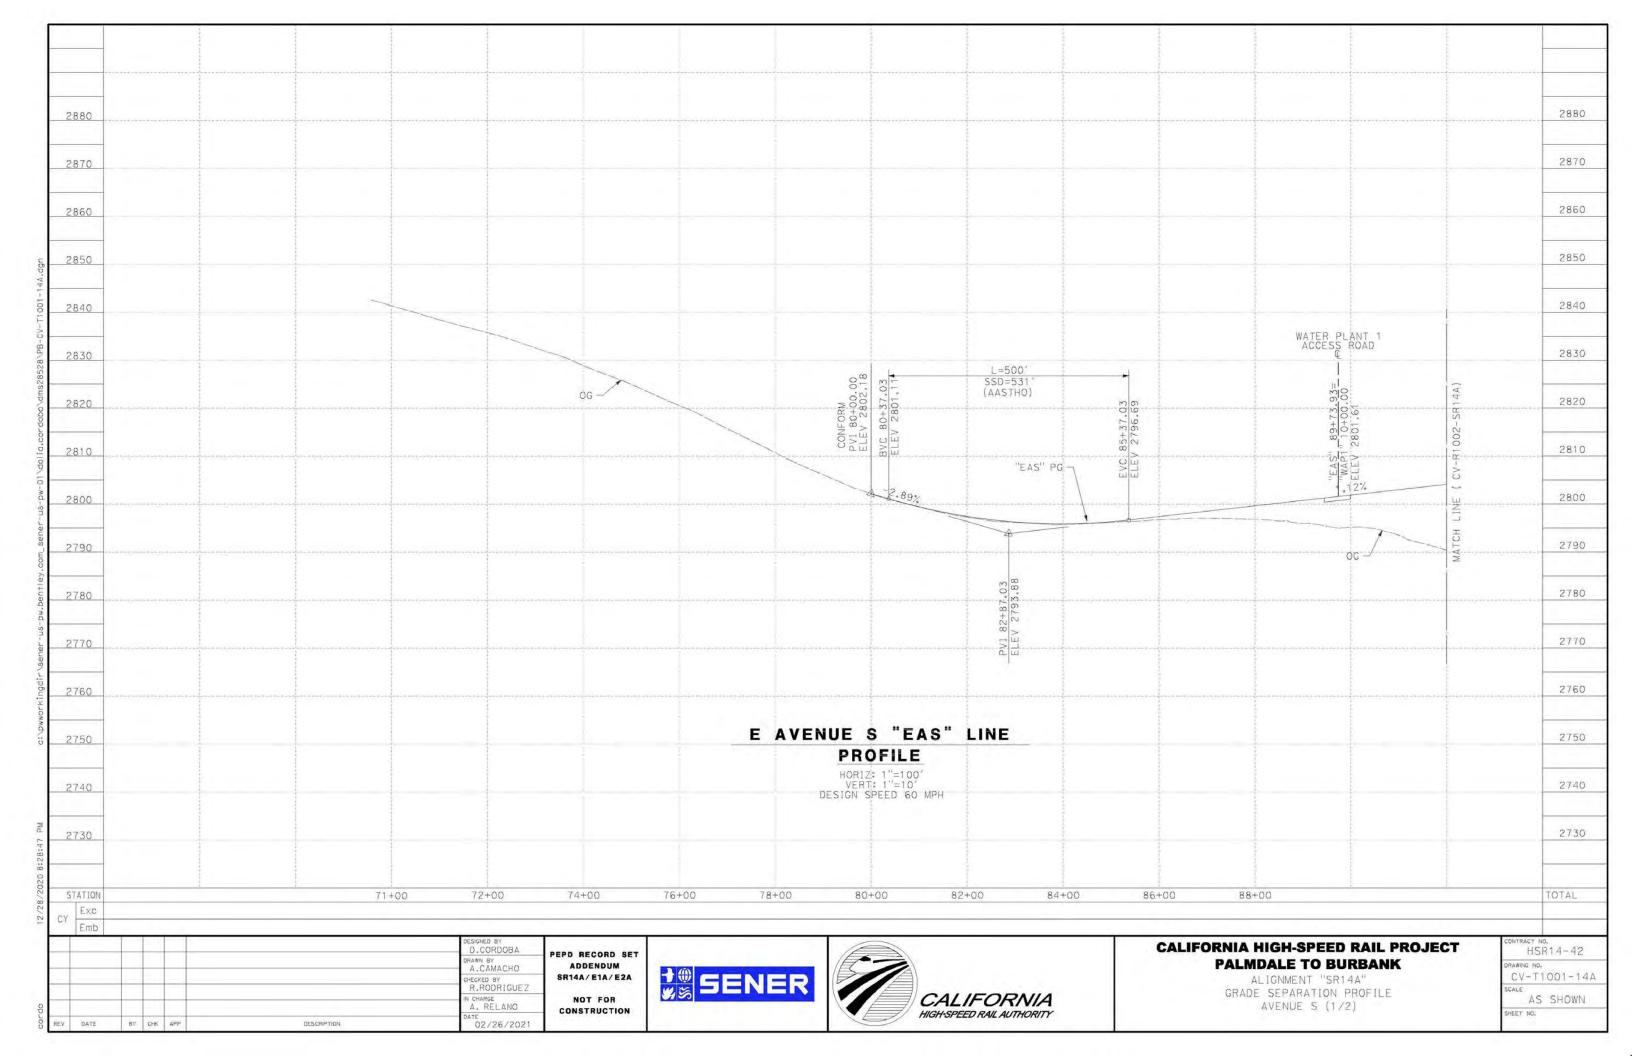


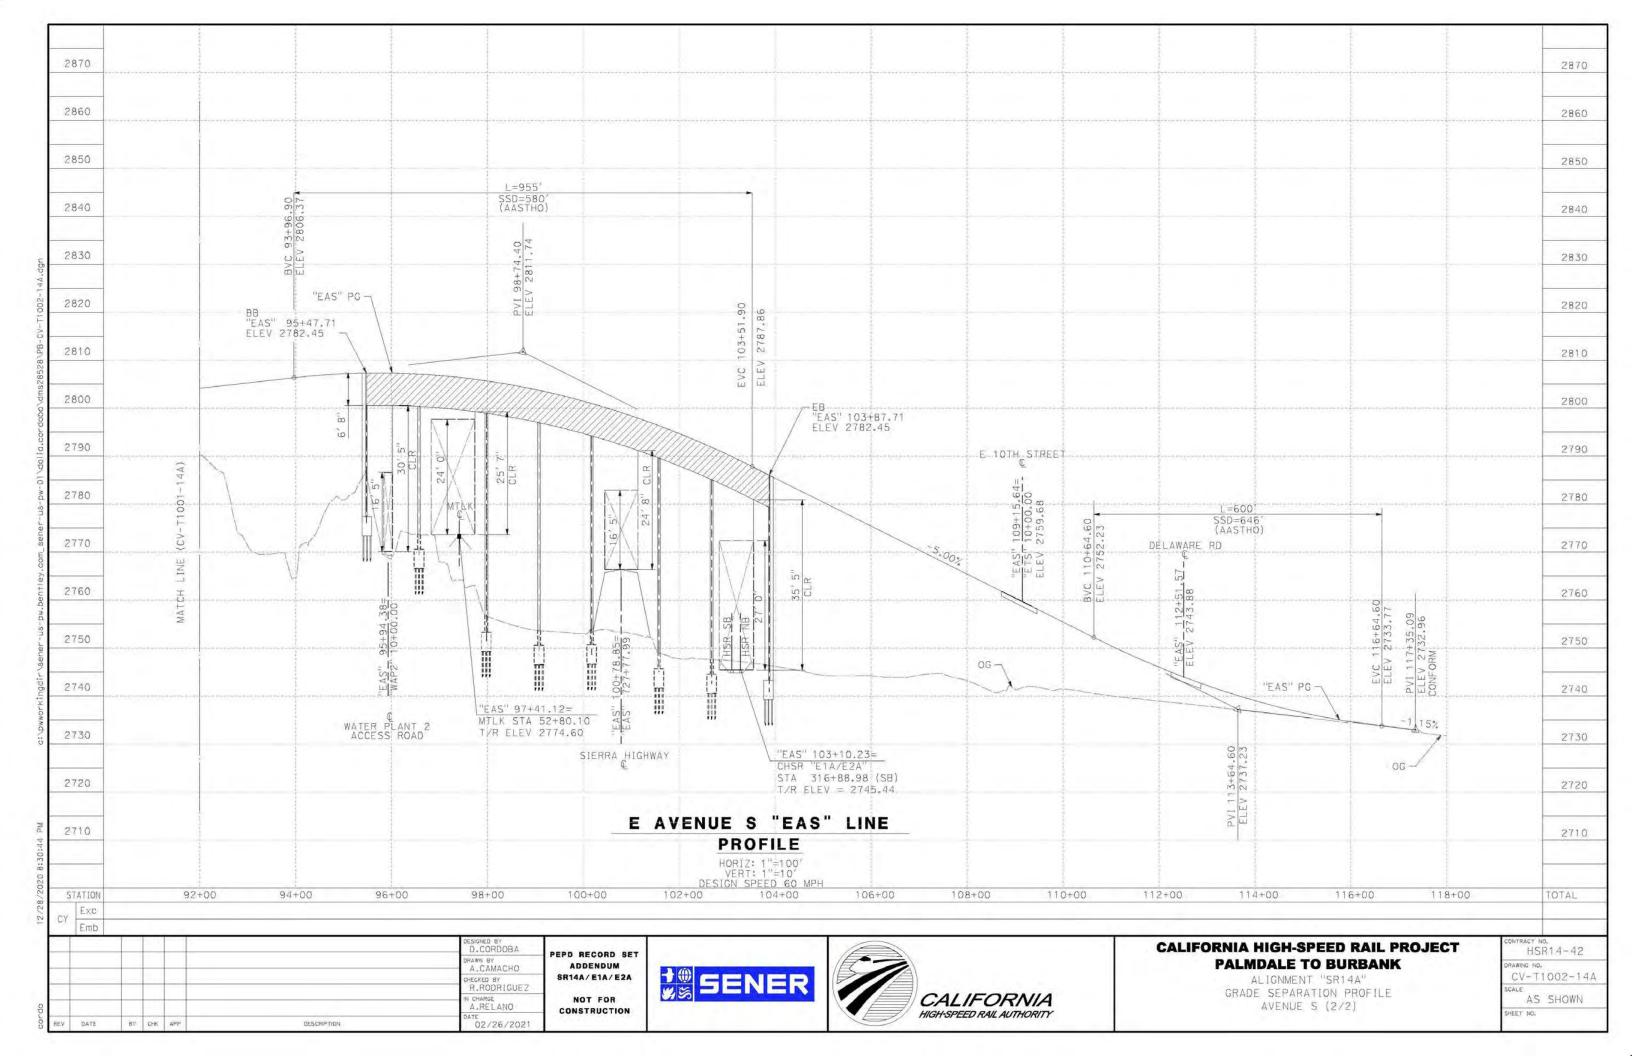

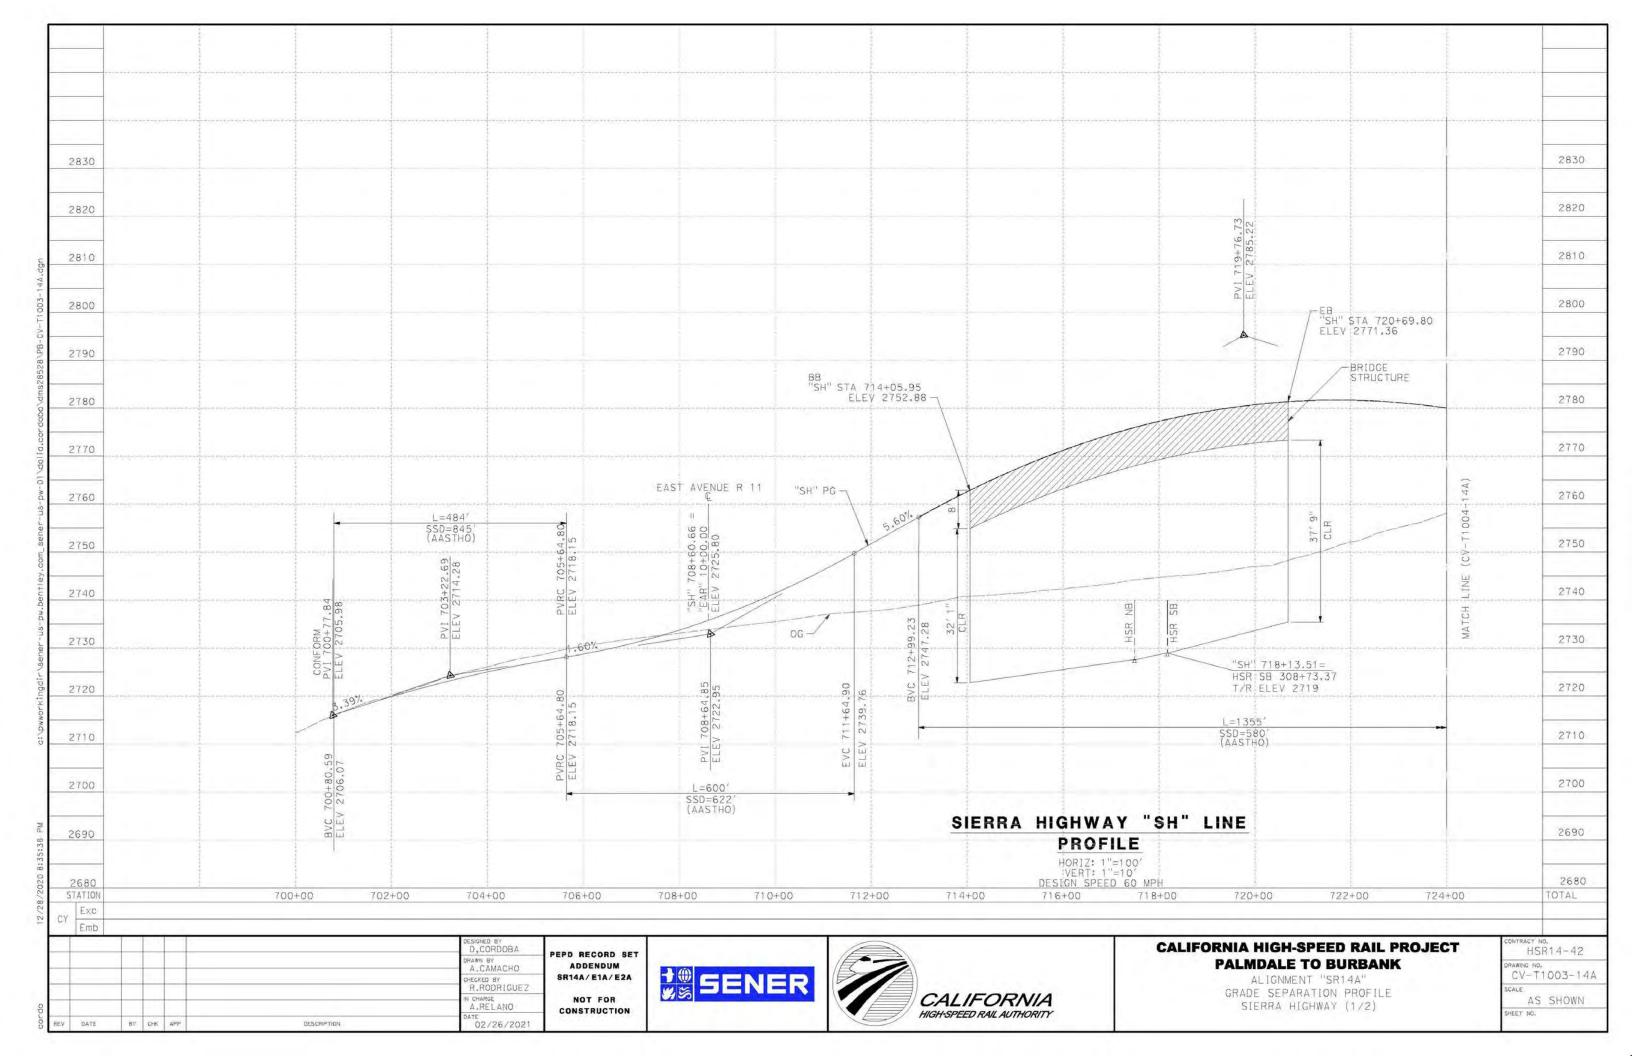

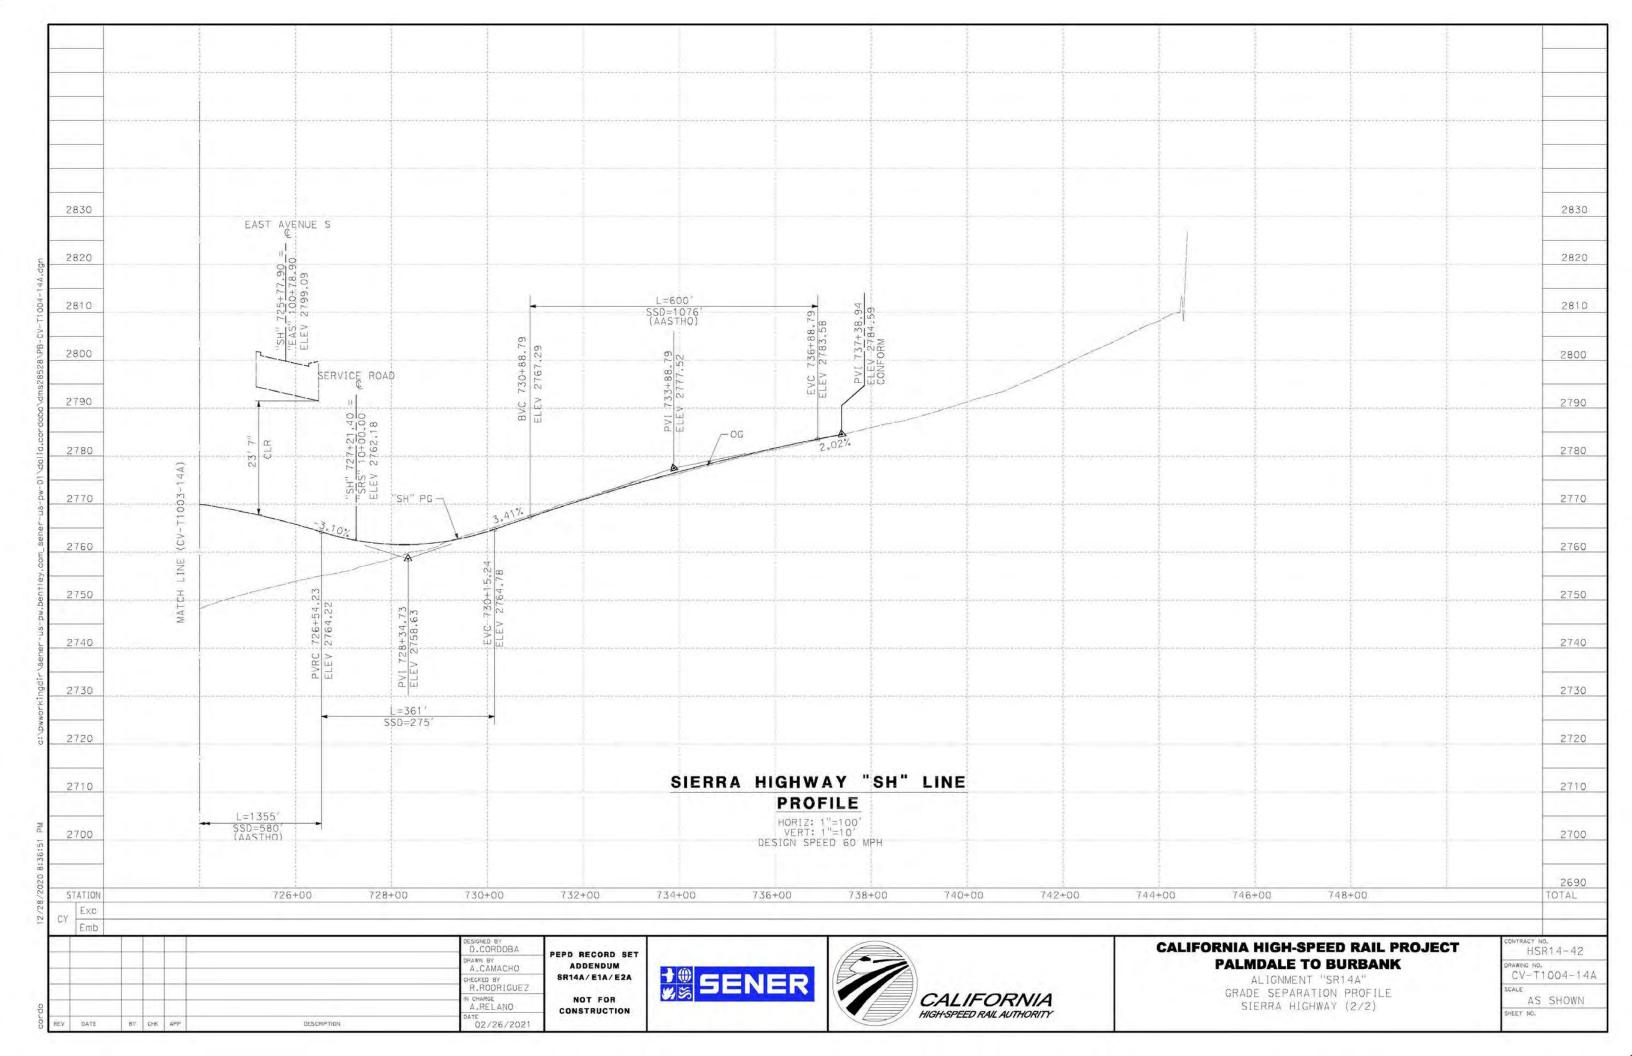


STA 705+22.61 to 707+98.97 PER CITY OF PALMDALE GENERAL PLAN

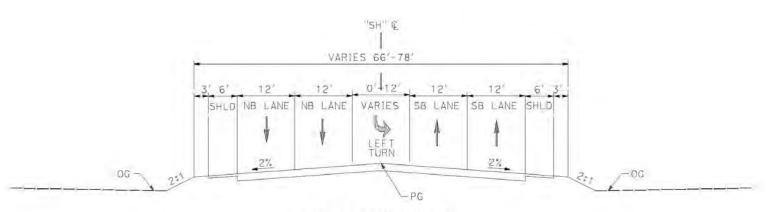

SIERRA HIGHWAY

STA 707+98.97 to 712+07.54 STA 723+76,85 to 736+89,22 PER CITY OF PALMDALE GENERAL PLAN

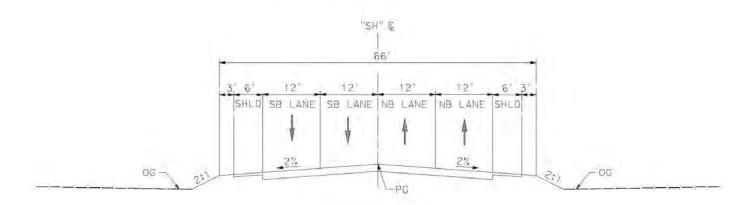

SIERRA HIGHWAY

STA 712+07.54 to 714+93.94 (BEG BRIDGE) STA 720+69.80 (END BRIDGE) TO 723+76.85 PER CITY OF PALMDALE GENERAL PLAN

			77			D_CORDOBA	, P
						A.CAMACHO	ľ
		+				CHECKED BY R.RODRIGUEZ	1
		1				IN CHARGE A. RELANO	1
REV	DATE	RY	50%	APP	DESCRIPTION	DATE 02/26/2021	

PEPD RECORD SET ADDENDUM SR14A/E1A/E2A NOT FOR CONSTRUCTION





CALIFORNIA HIGH-SPEED RAIL PROJECT PALMDALE TO BURBANK


ALIGNMENT "SR14A" ROADWAY TYPICAL SECTIONS SIERRA HIGHWAY

CONTRACT NO.
HSR14-42
DRAWING NO.
CV-T3001-14A
NO SCALE

SHEET NO.

AVENUE S

STA 90+27.08 to 92+75.30 STA 103+77.01 (END BRIDGE) to STA 118+68.90 PER CITY OF PALMDALE GENERAL PLAN

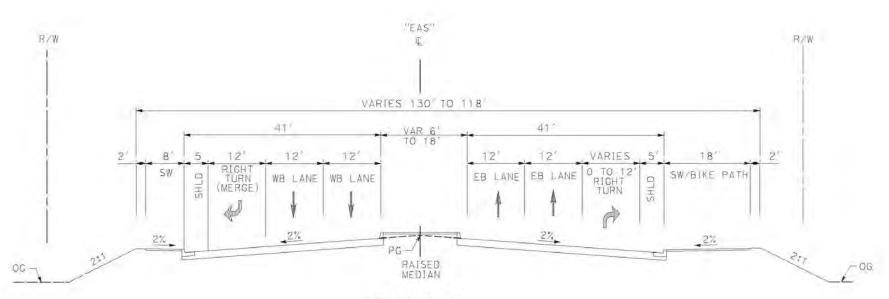

AVENUE S

STA 80+00,00 to 90+27.08 PER CITY OF PALMDALE GENERAL PLAN

			11			D_CORDOBA
						A.CAMACHO
-		+				CHECKED BY R.RODRIGUEZ
-						IN CHARUE A.RELANO
REV	DATE	87	DHR.	APP	DESCRIPTION	DATE 02/26/2021

PEPD RECORD SET ADDENDUM SR14A/E1A/E2A NOT FOR CONSTRUCTION







CALIFORNIA HIGH-SPEED RAIL PROJECT PALMDALE TO BURBANK


ALIGNMENT "SR14A" ROADWAY TYPICAL SECTIONS AVENUE S REALIGNED (1/2) DRAWING NO.


CV-T3002-14A


NO SCALE

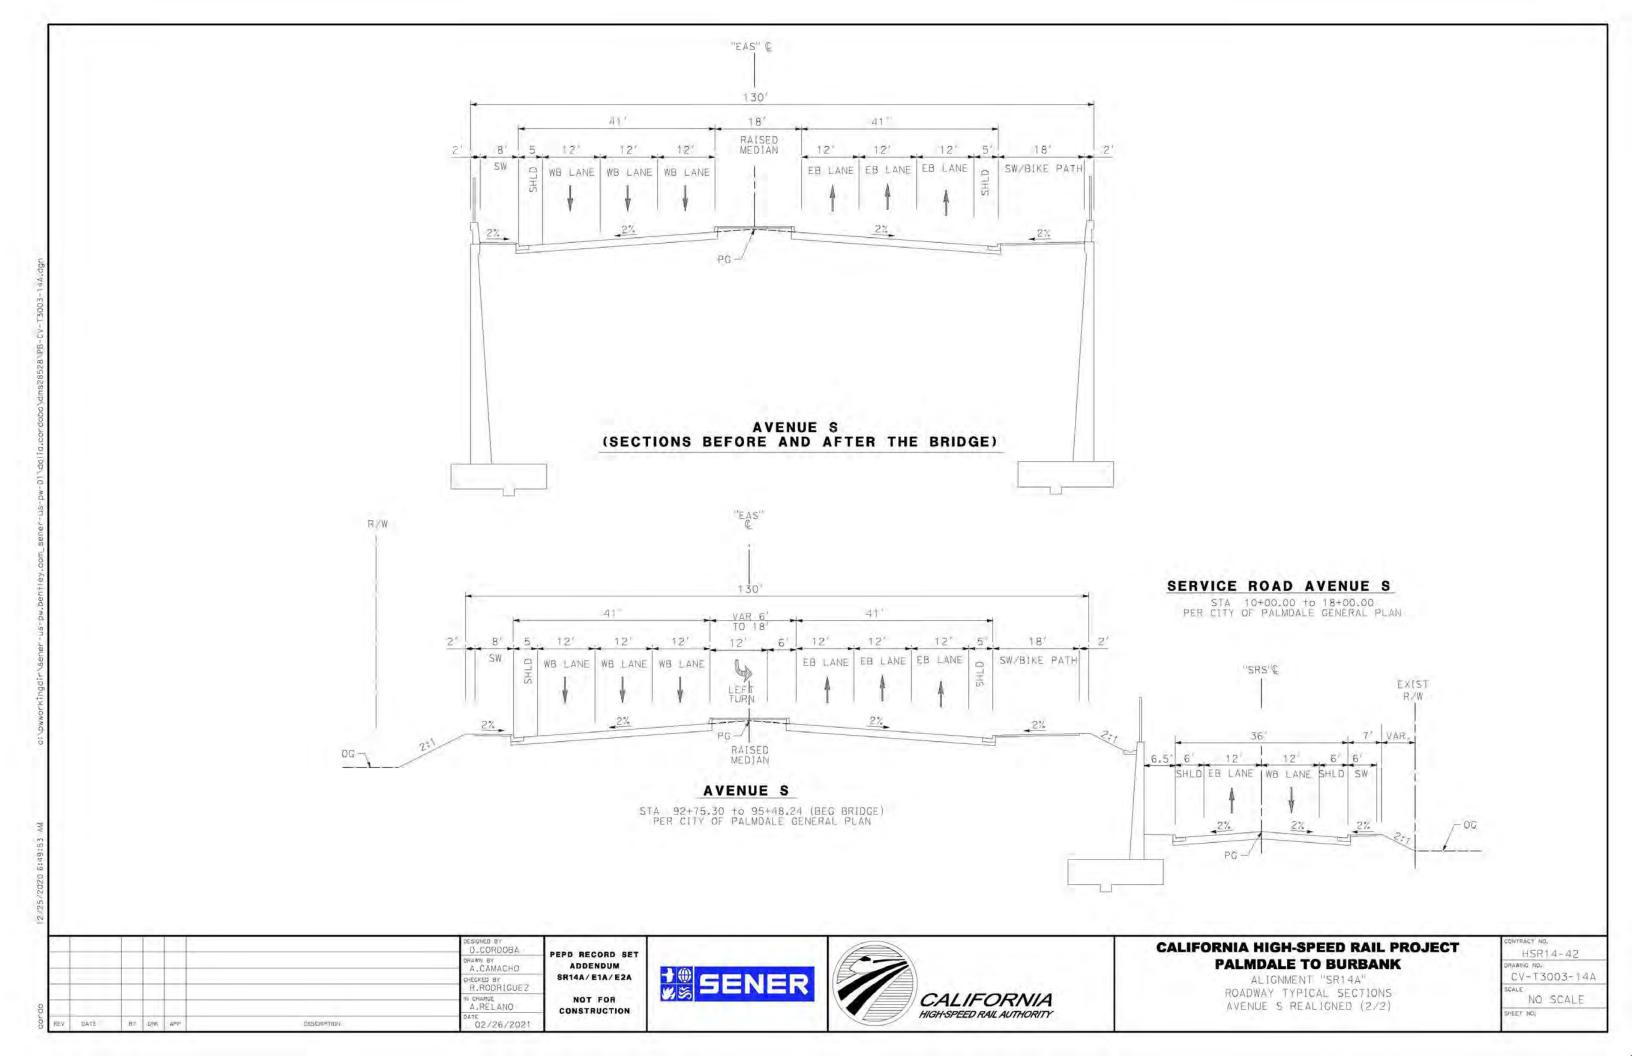


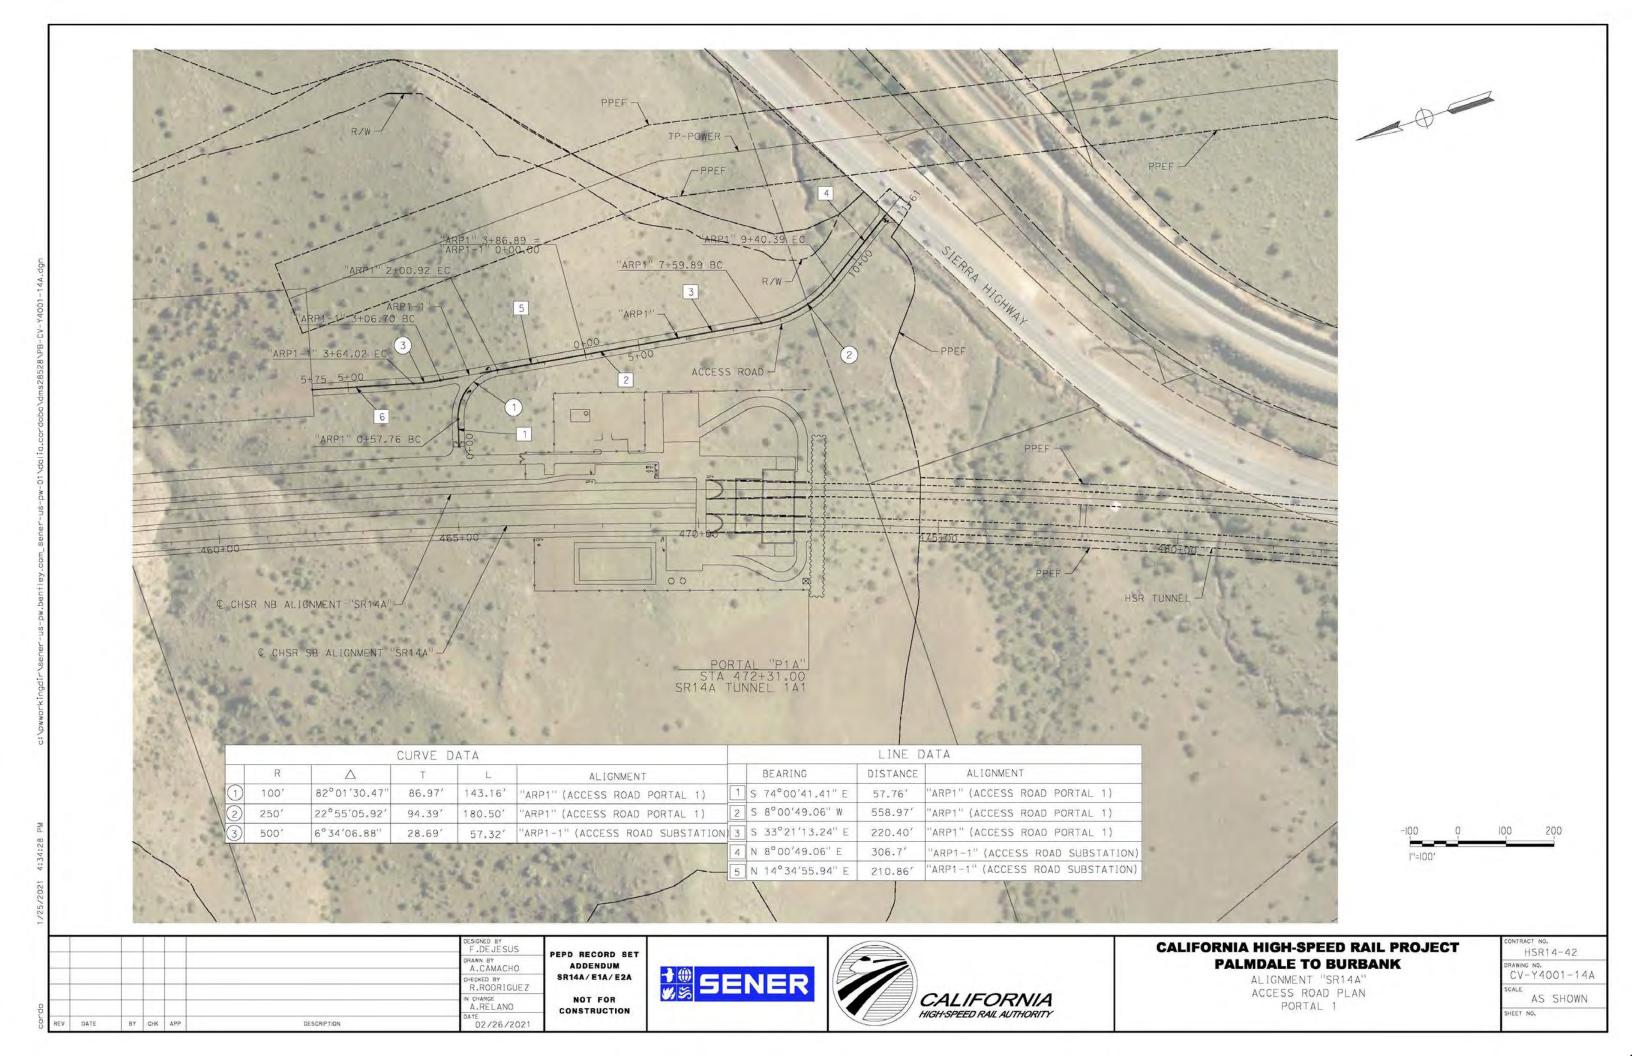


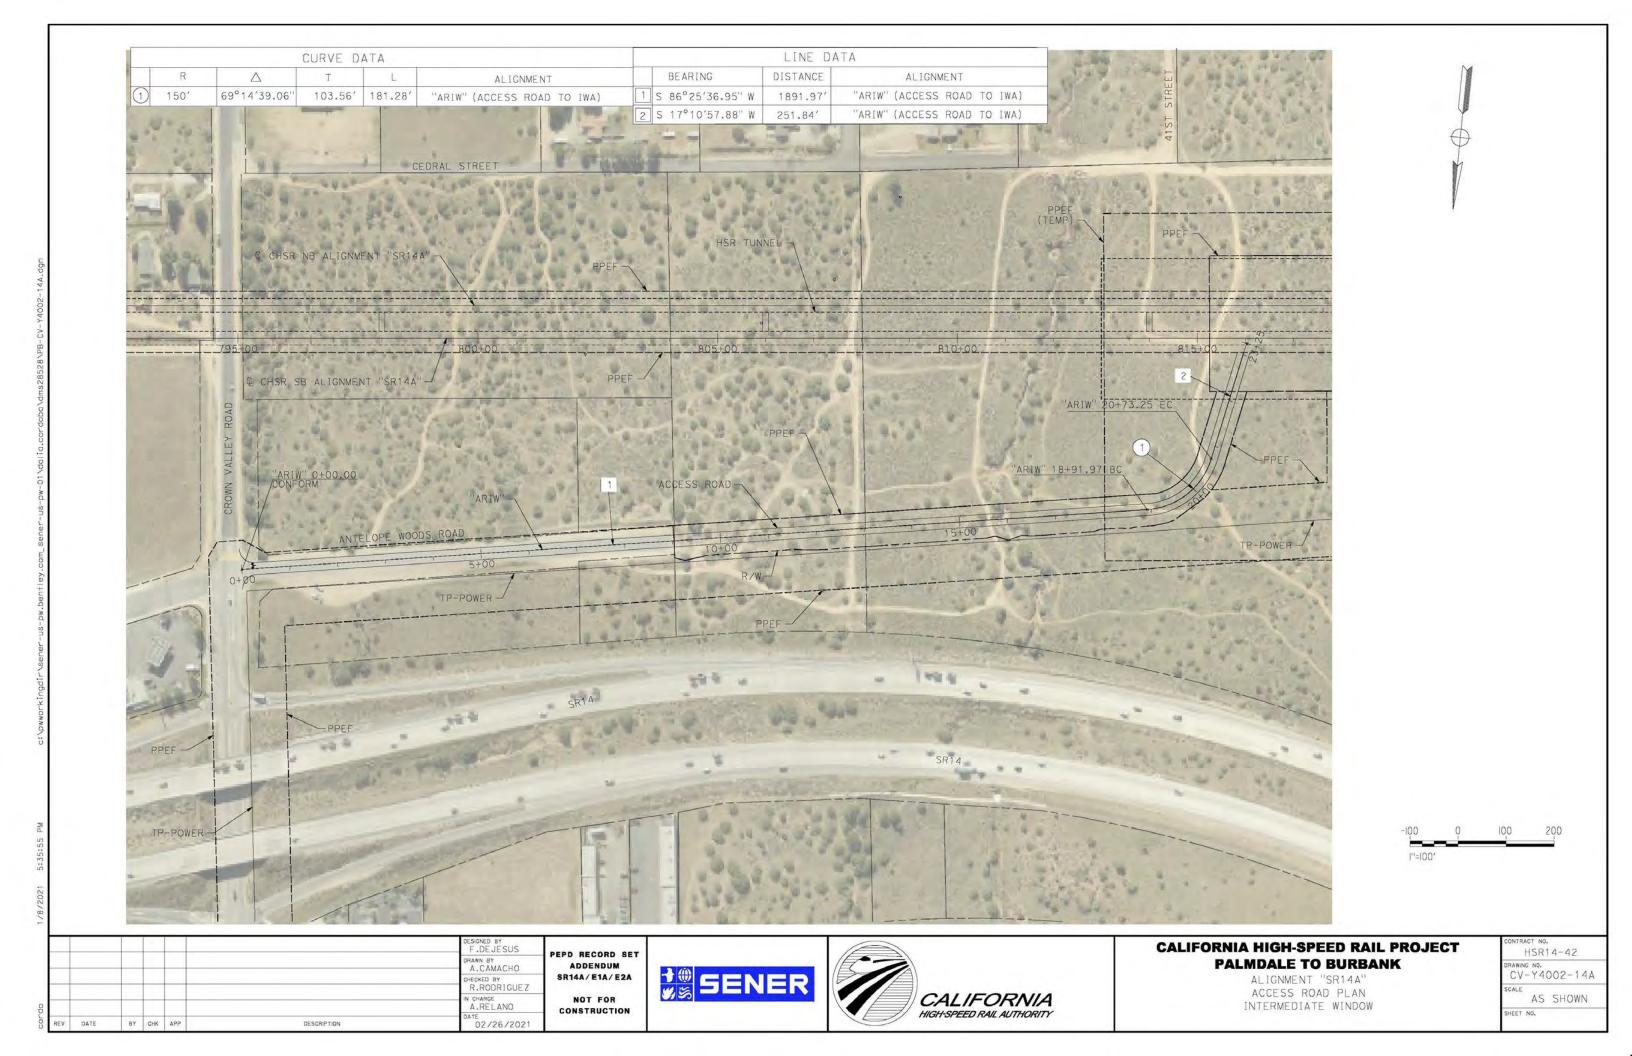


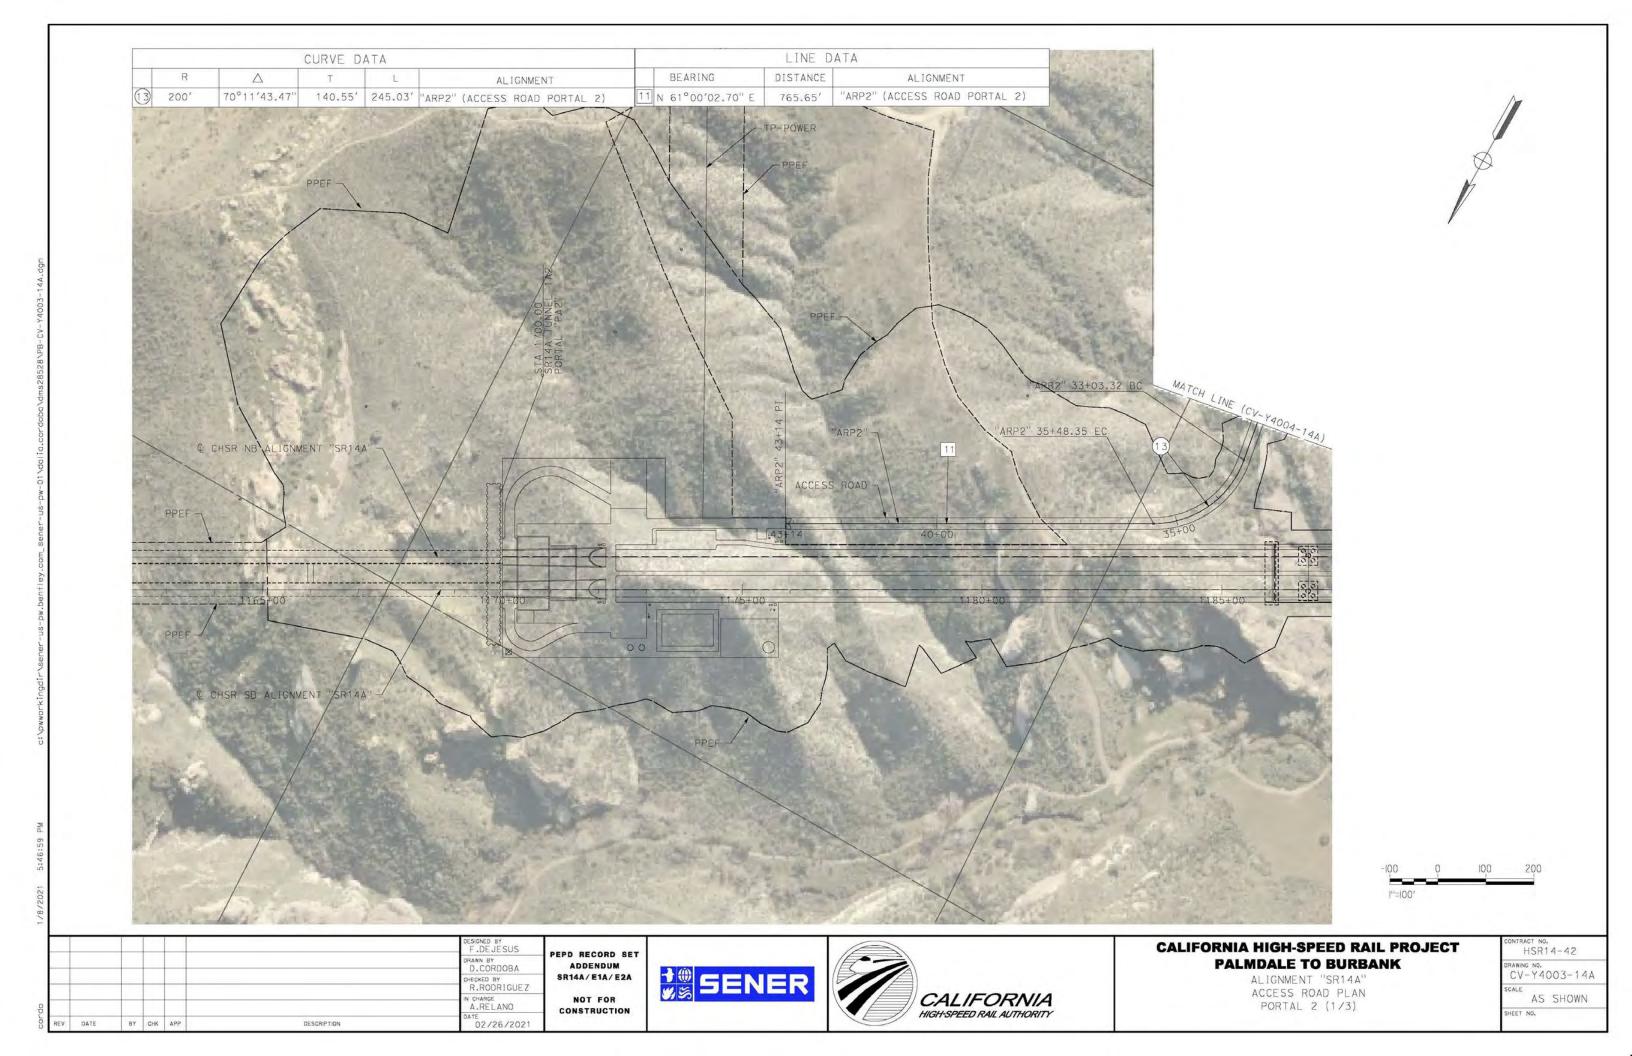


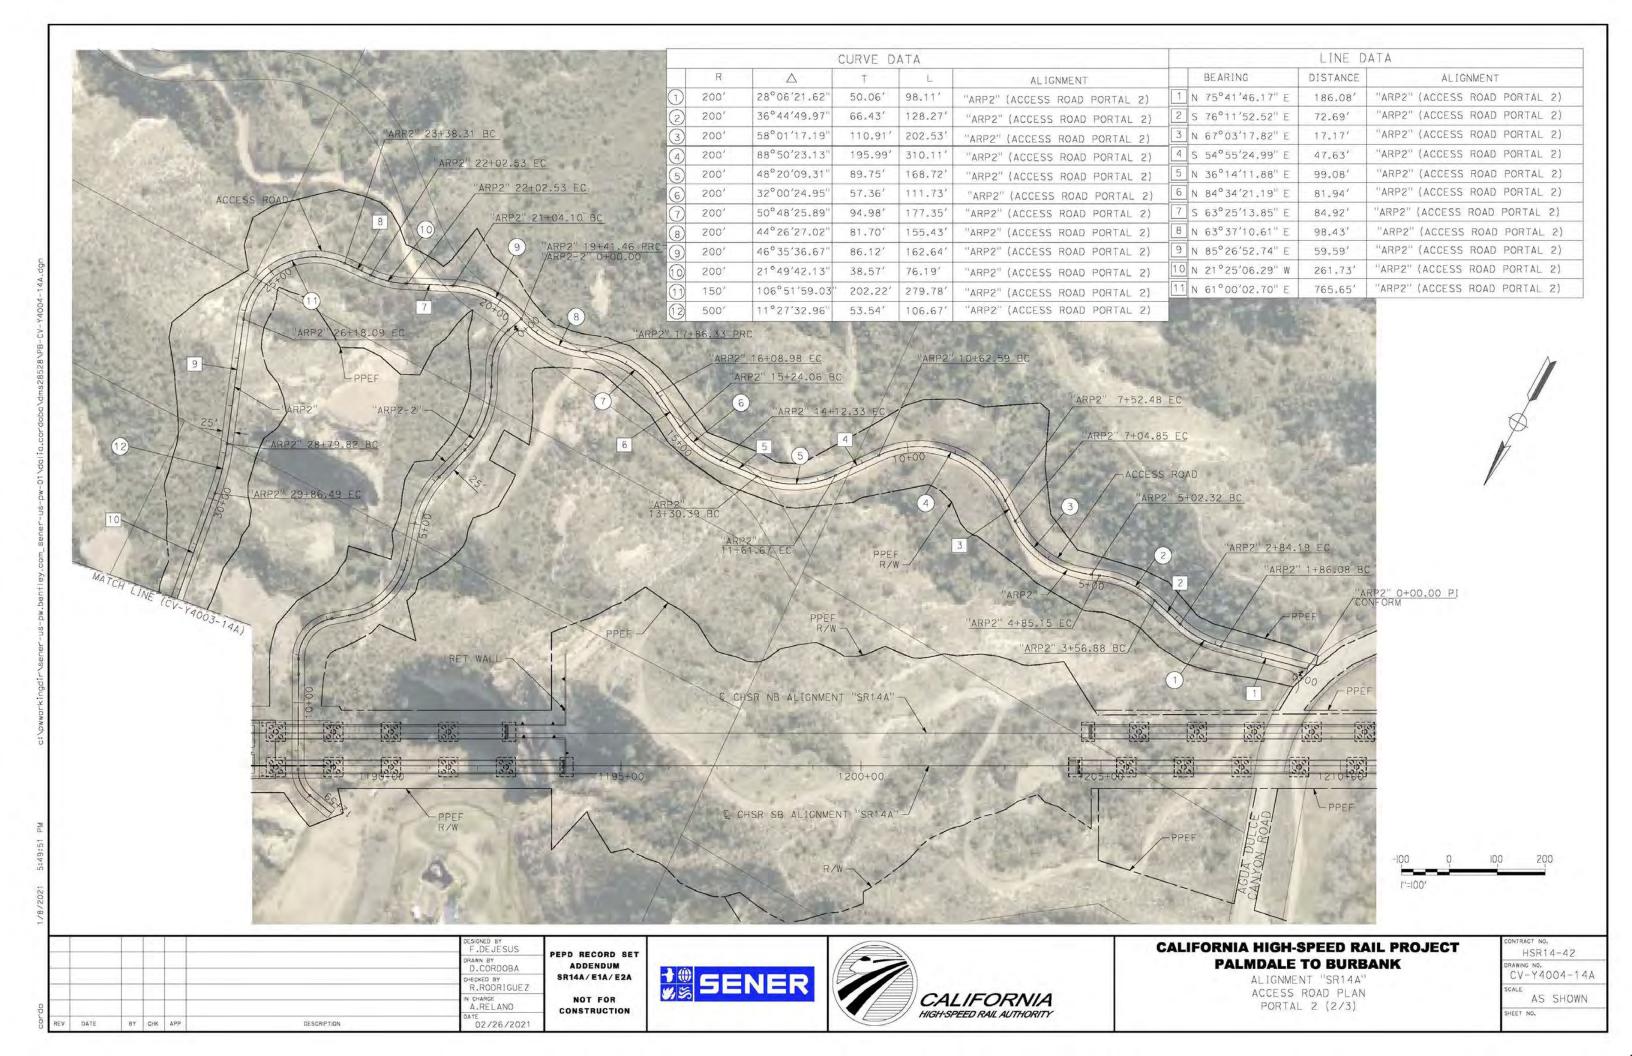


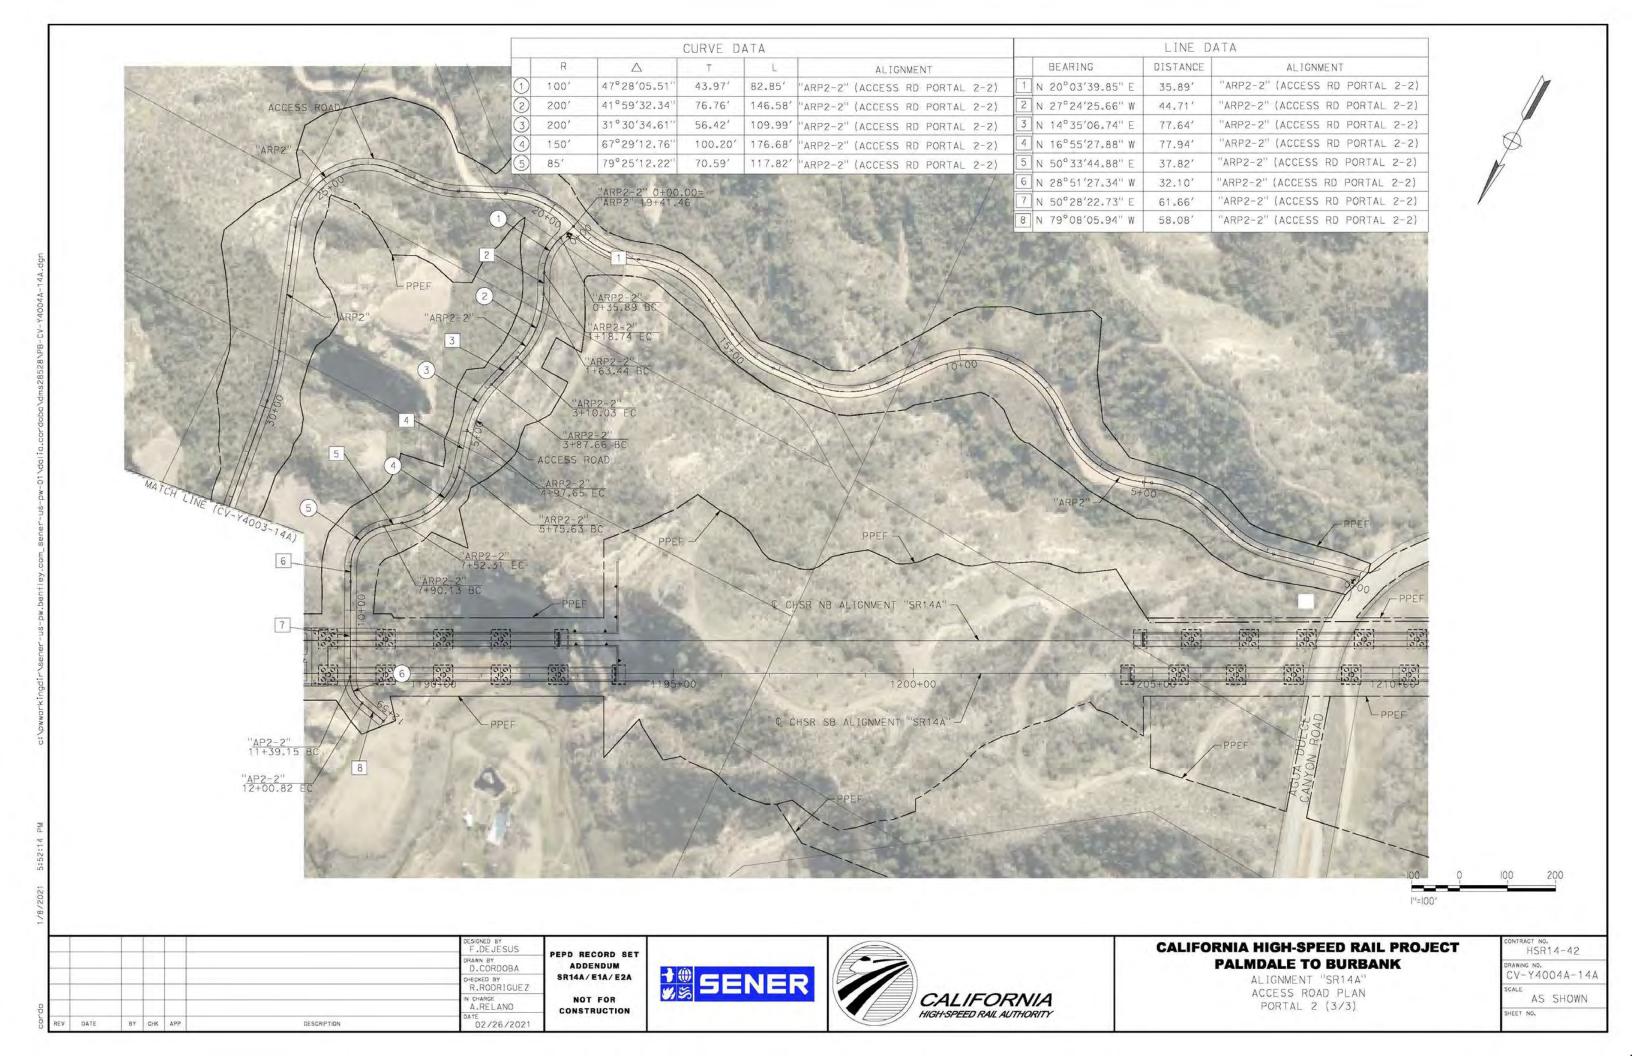


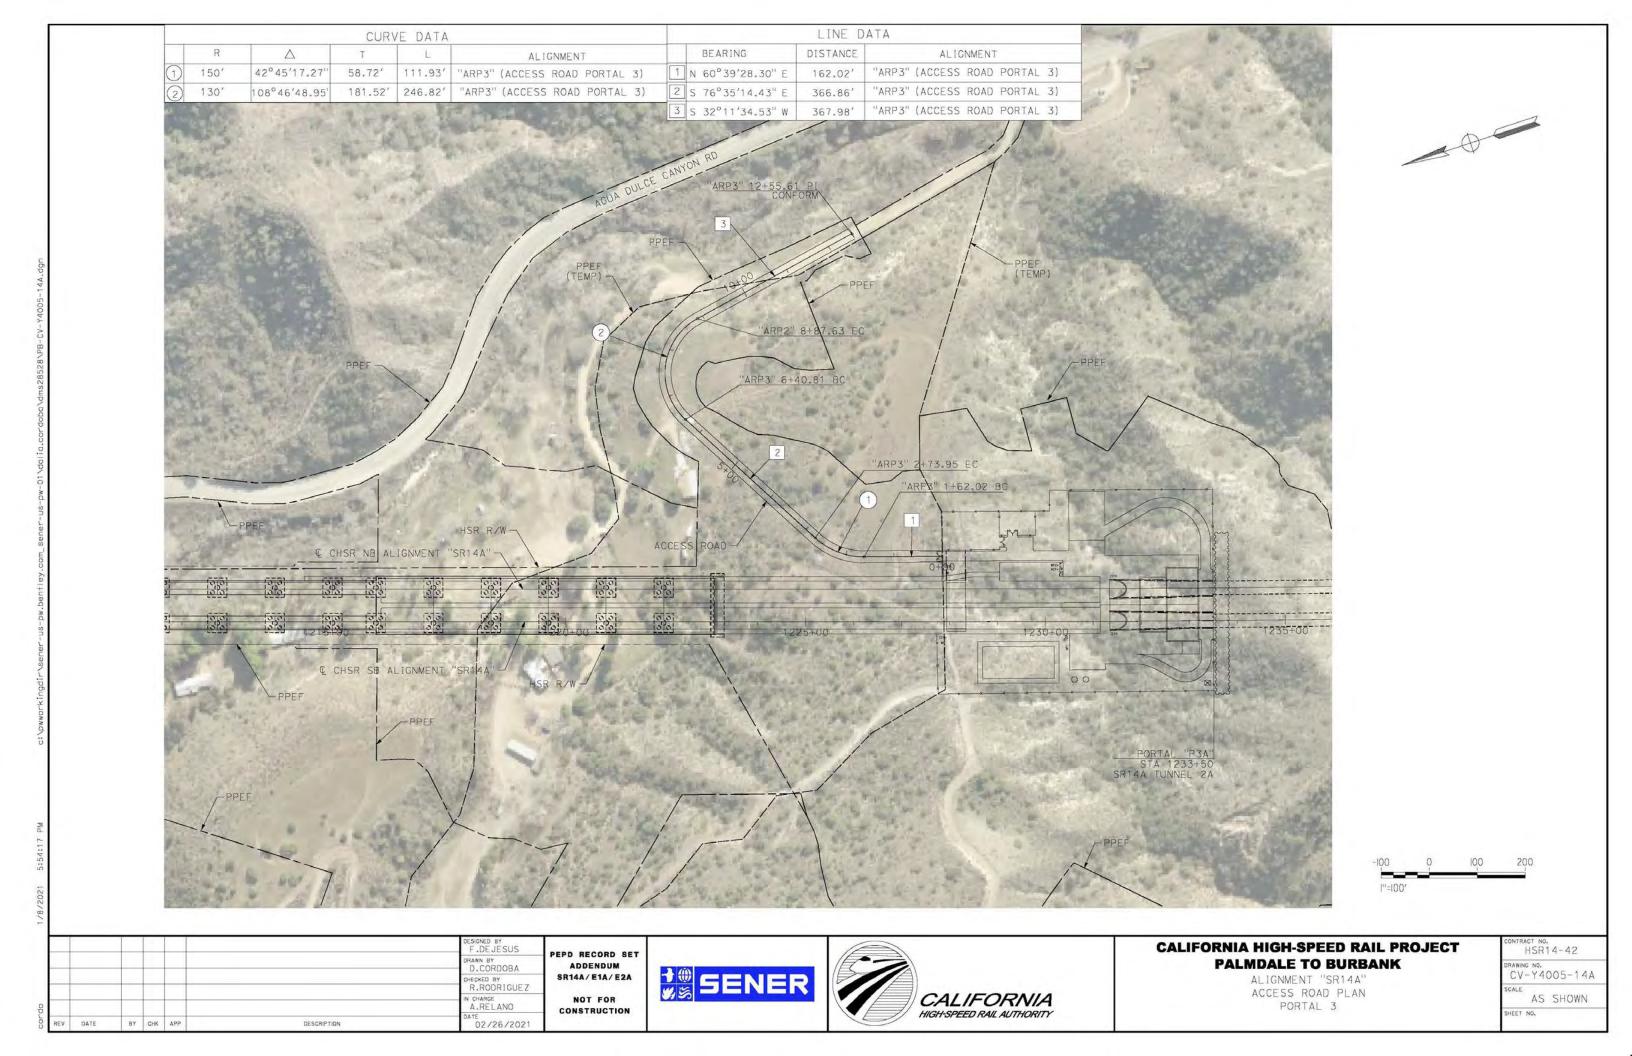


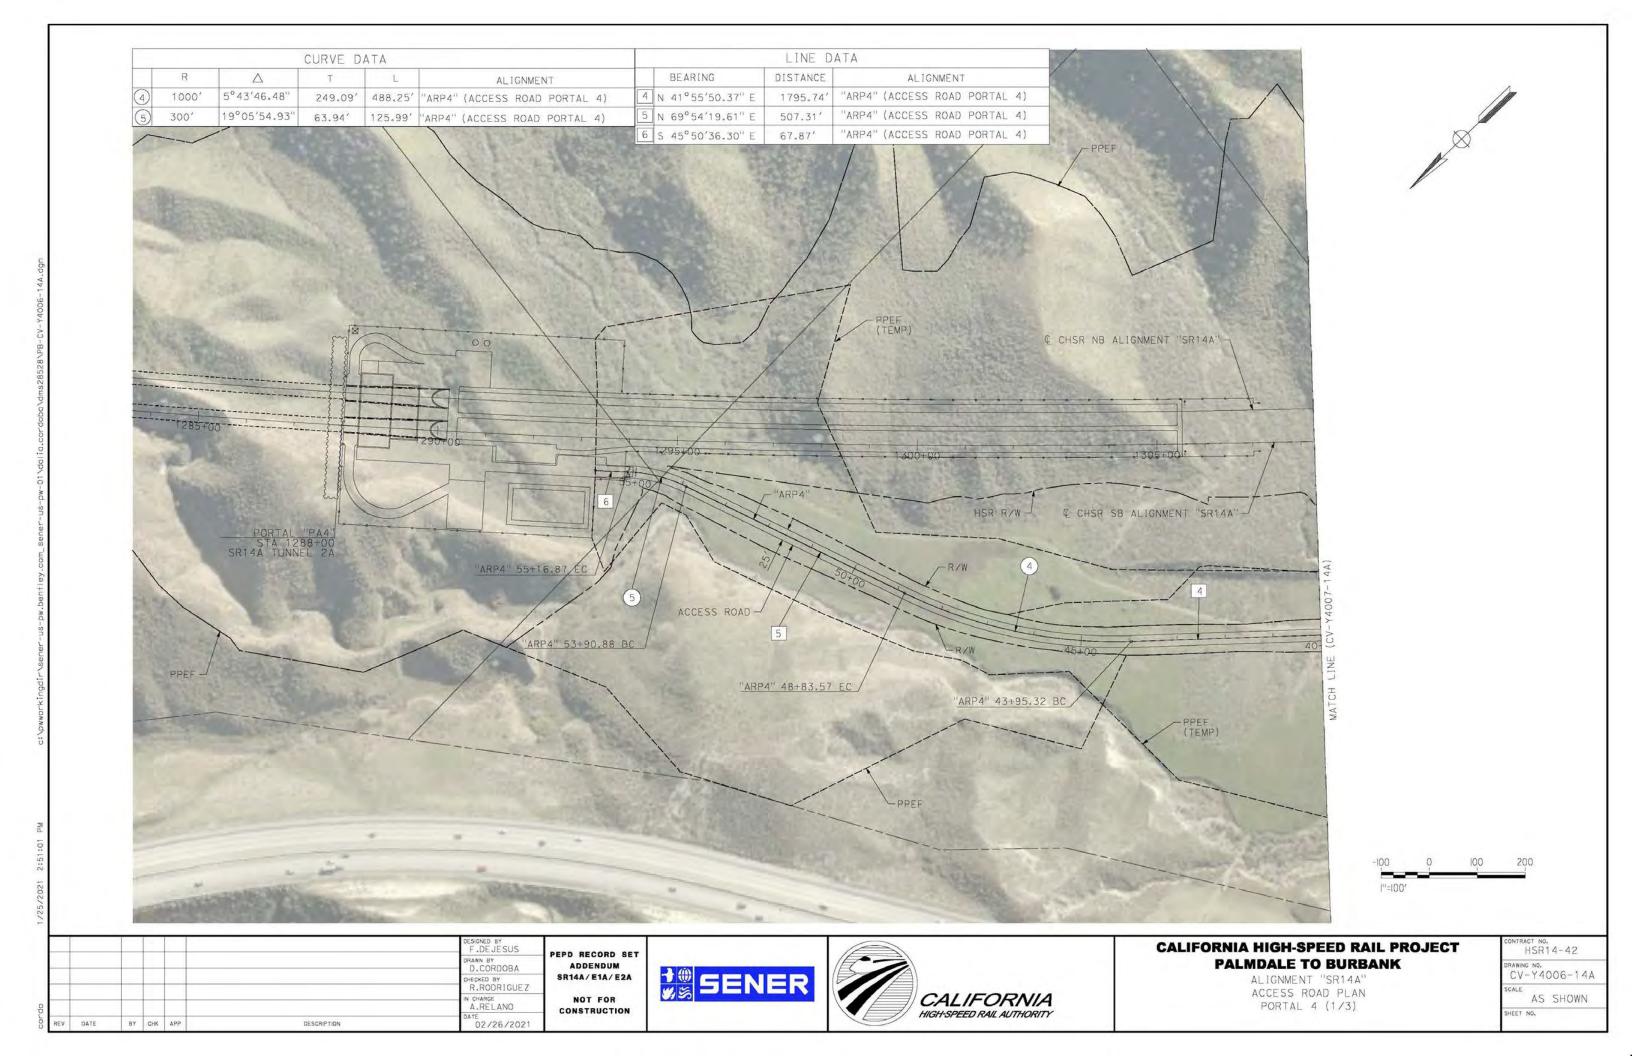


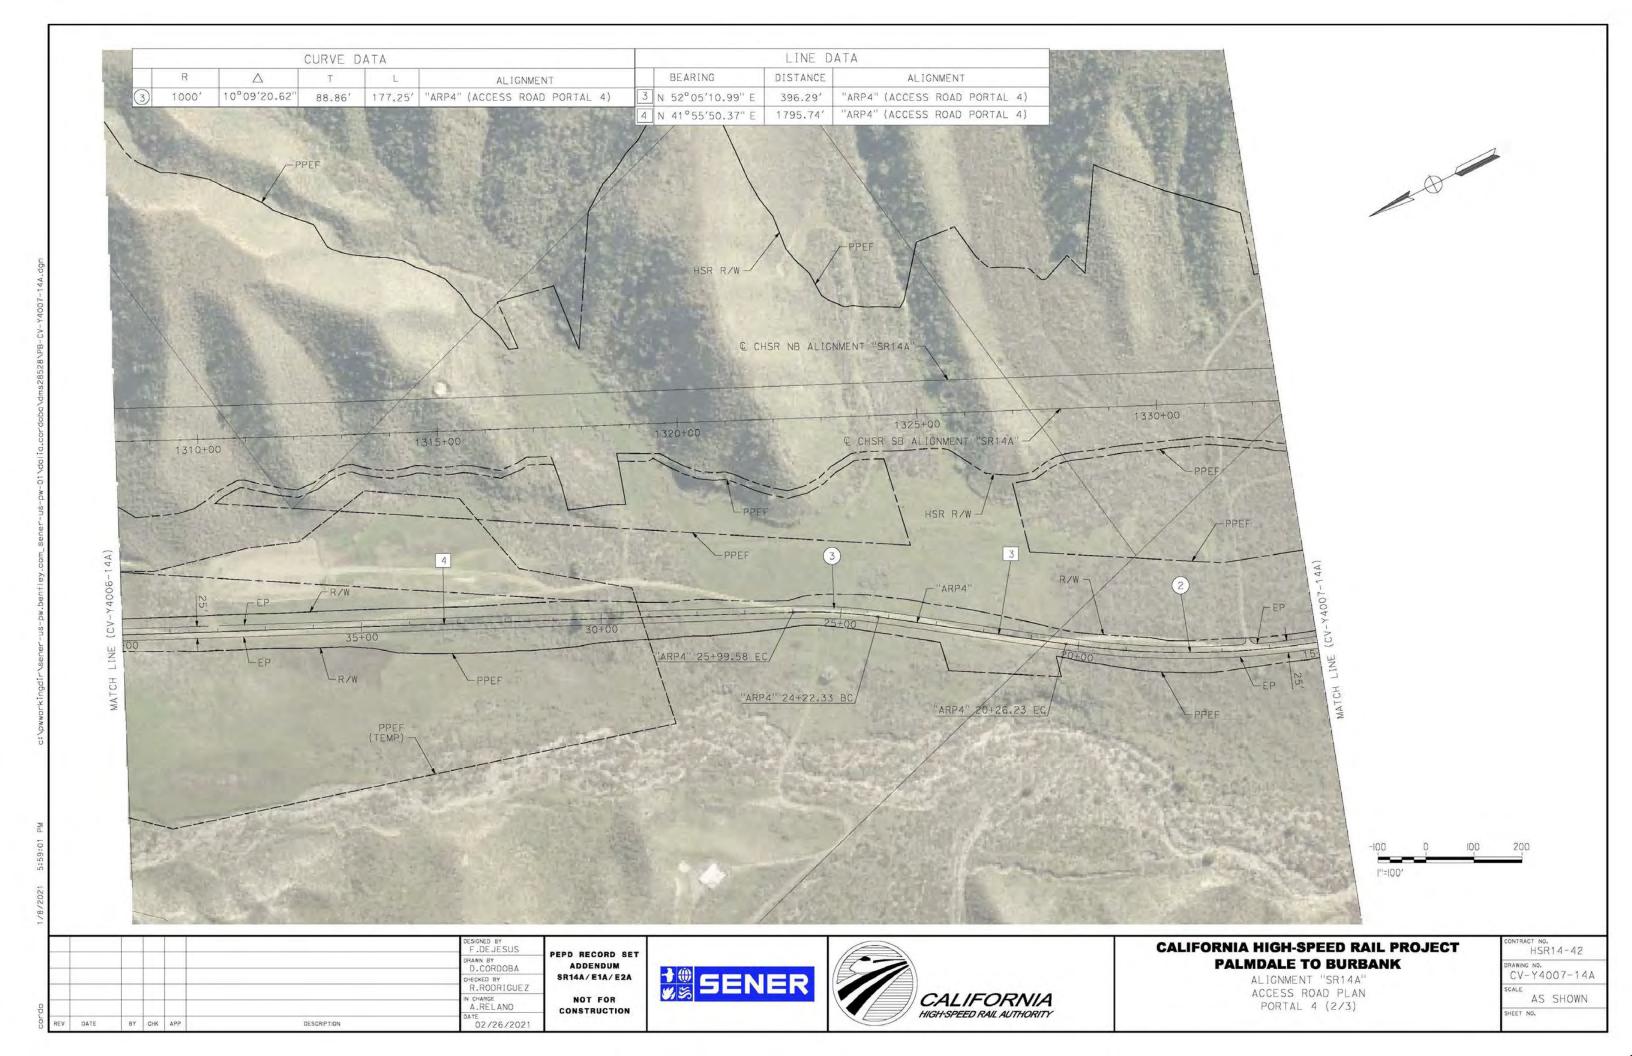


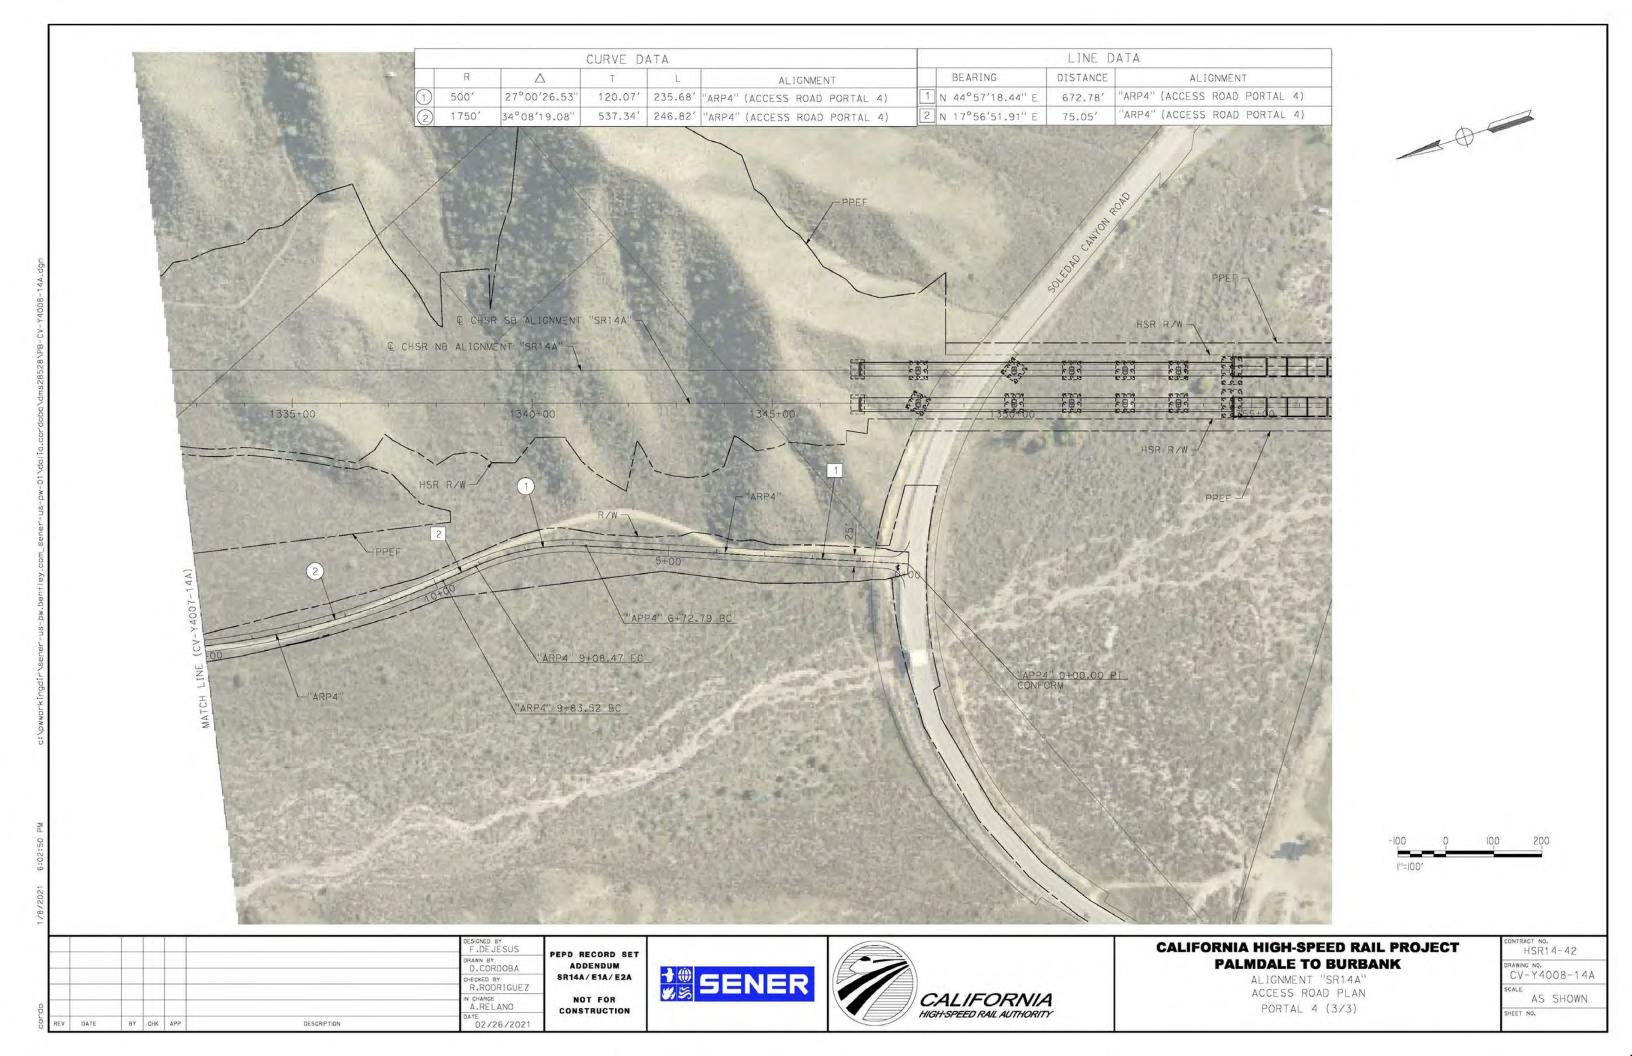


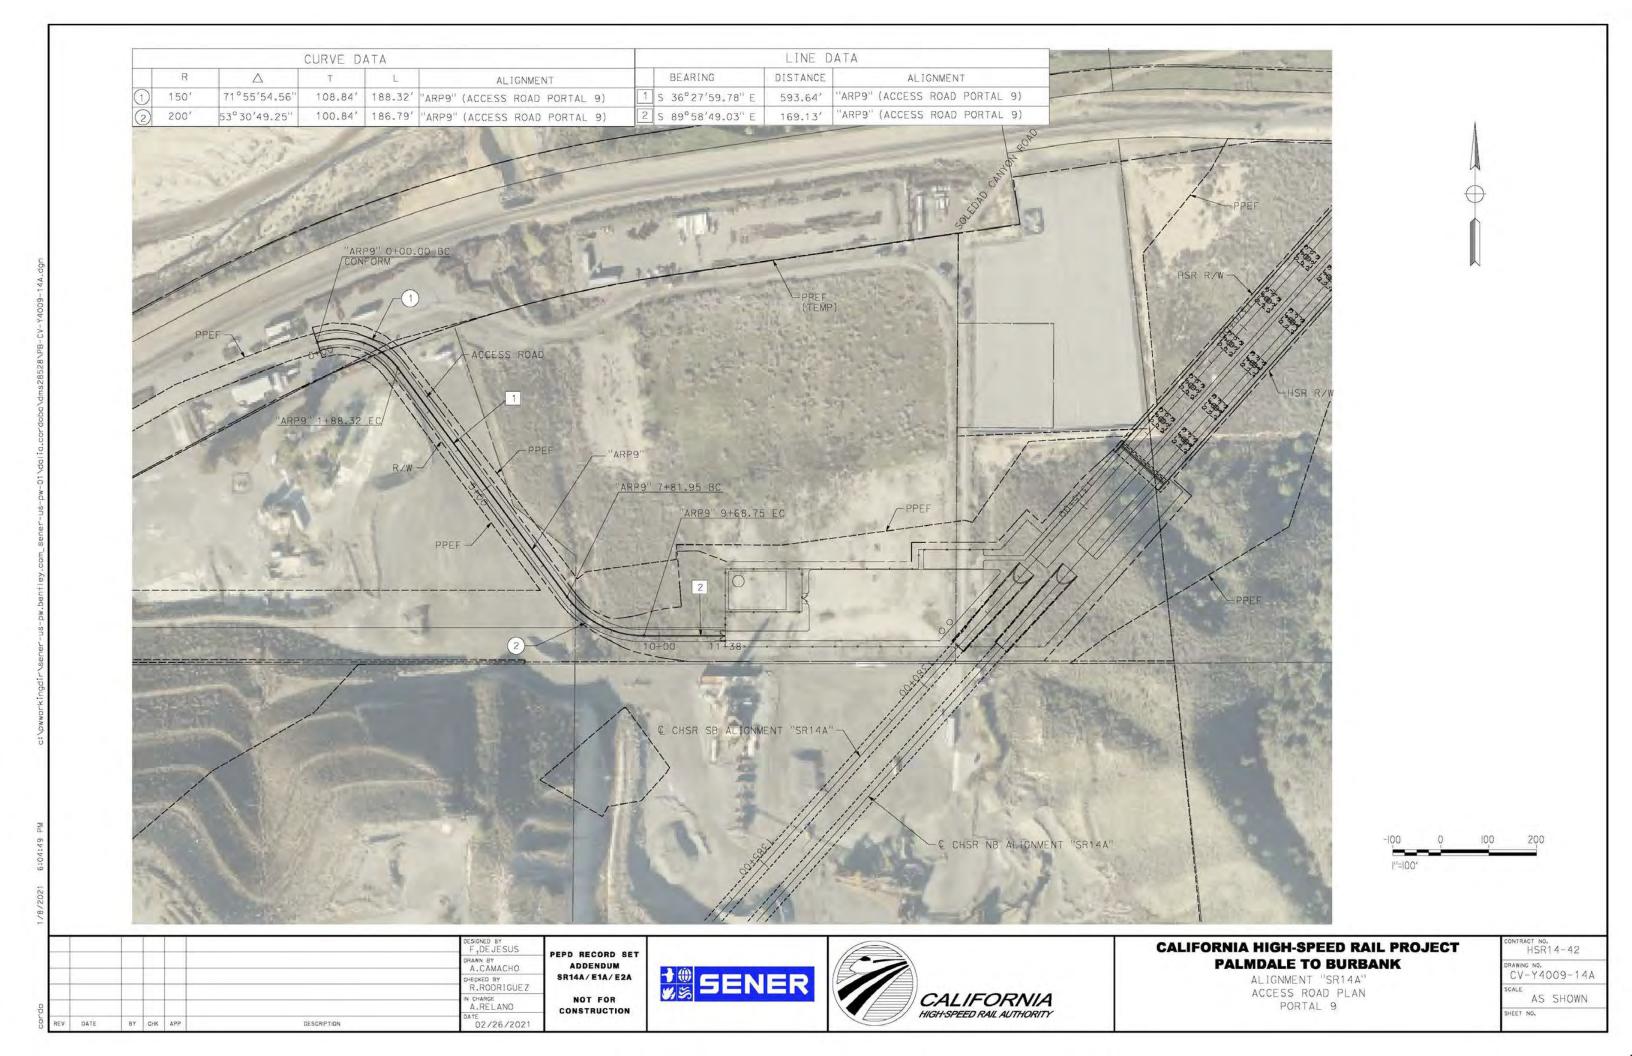


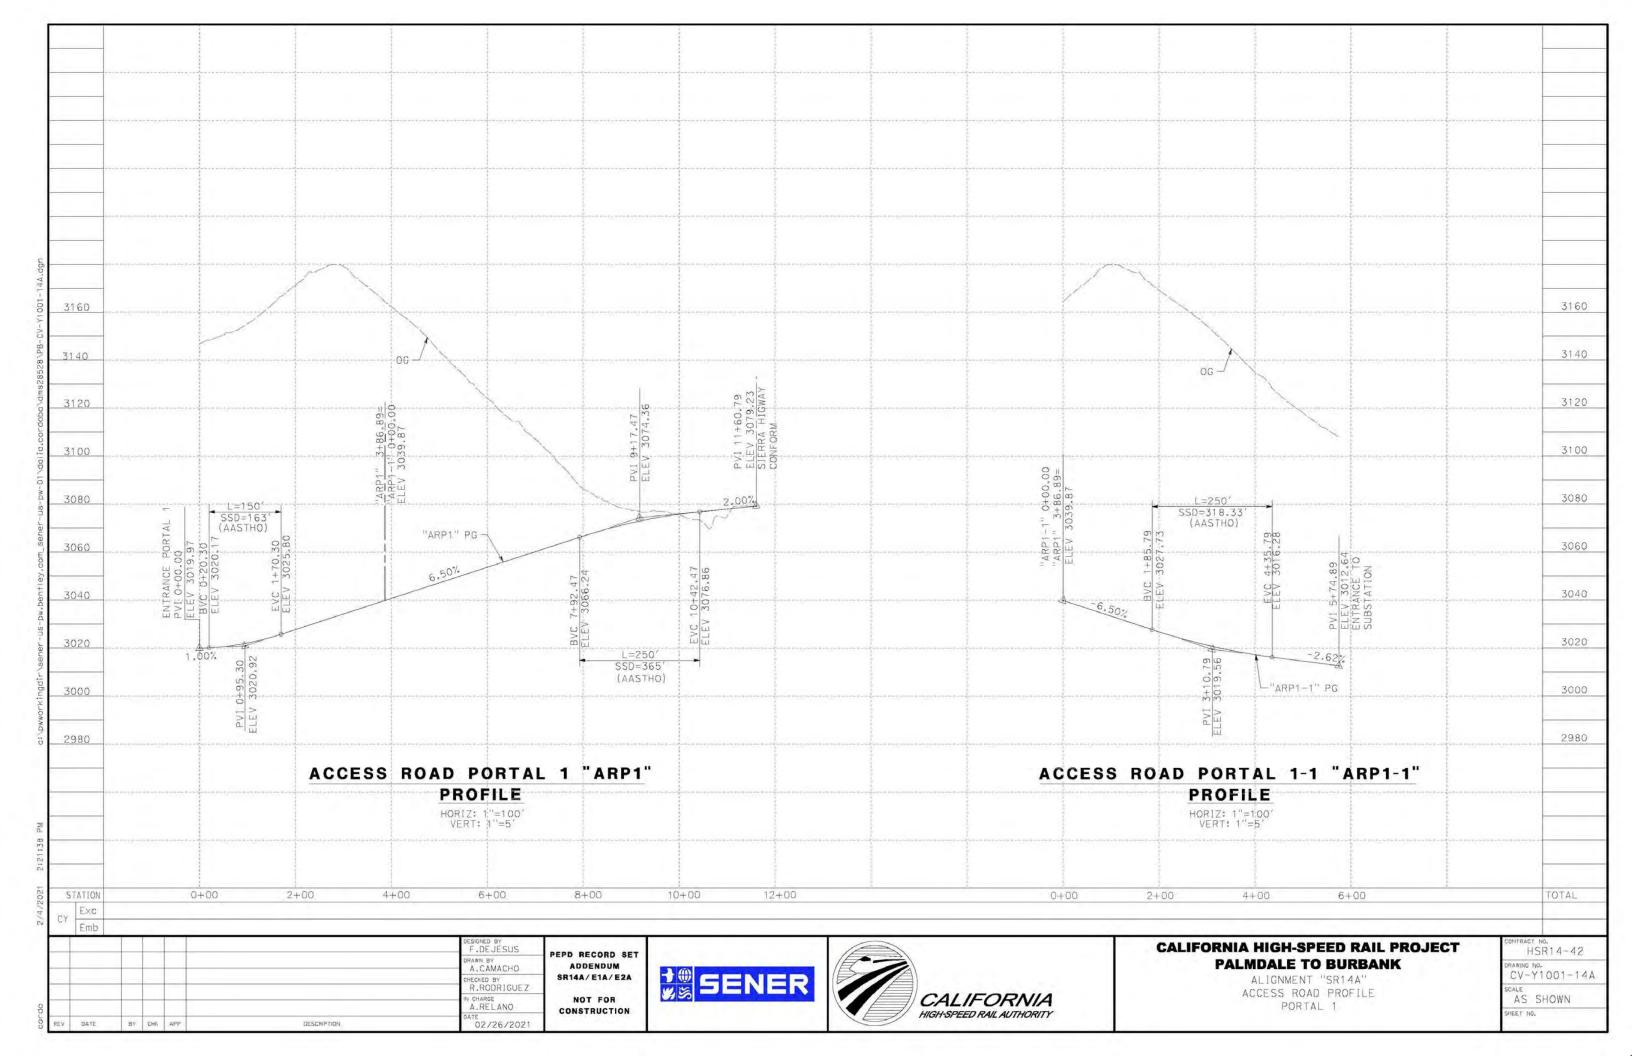


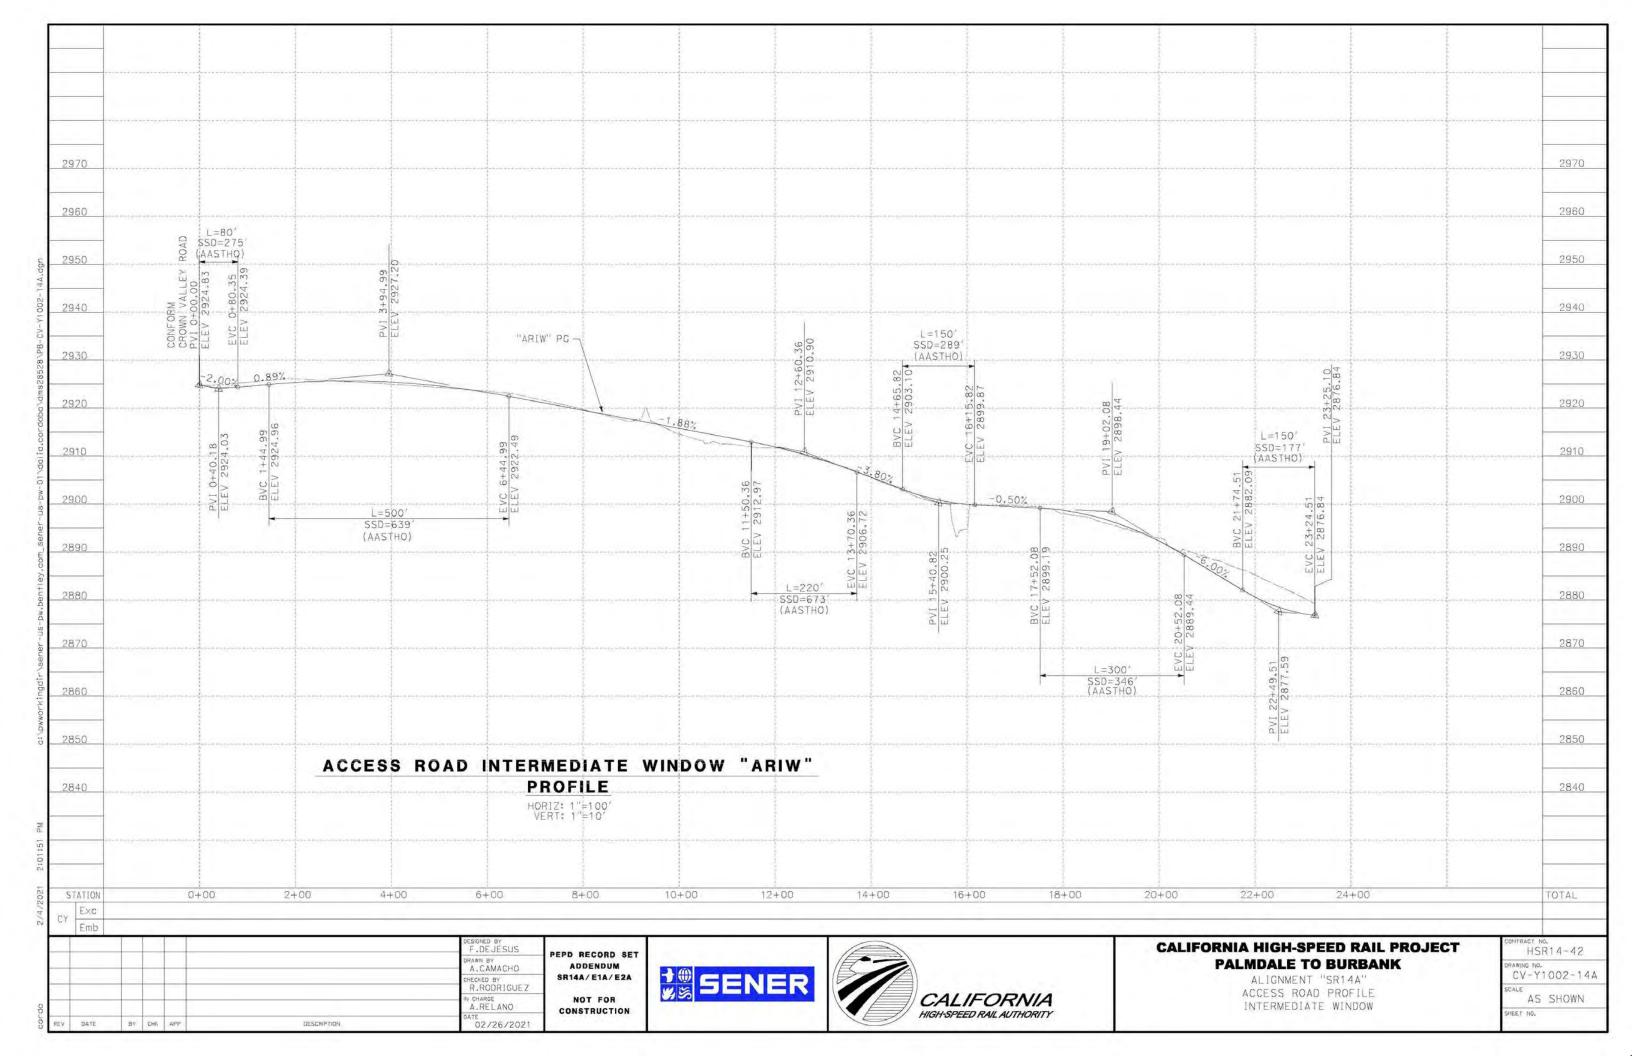


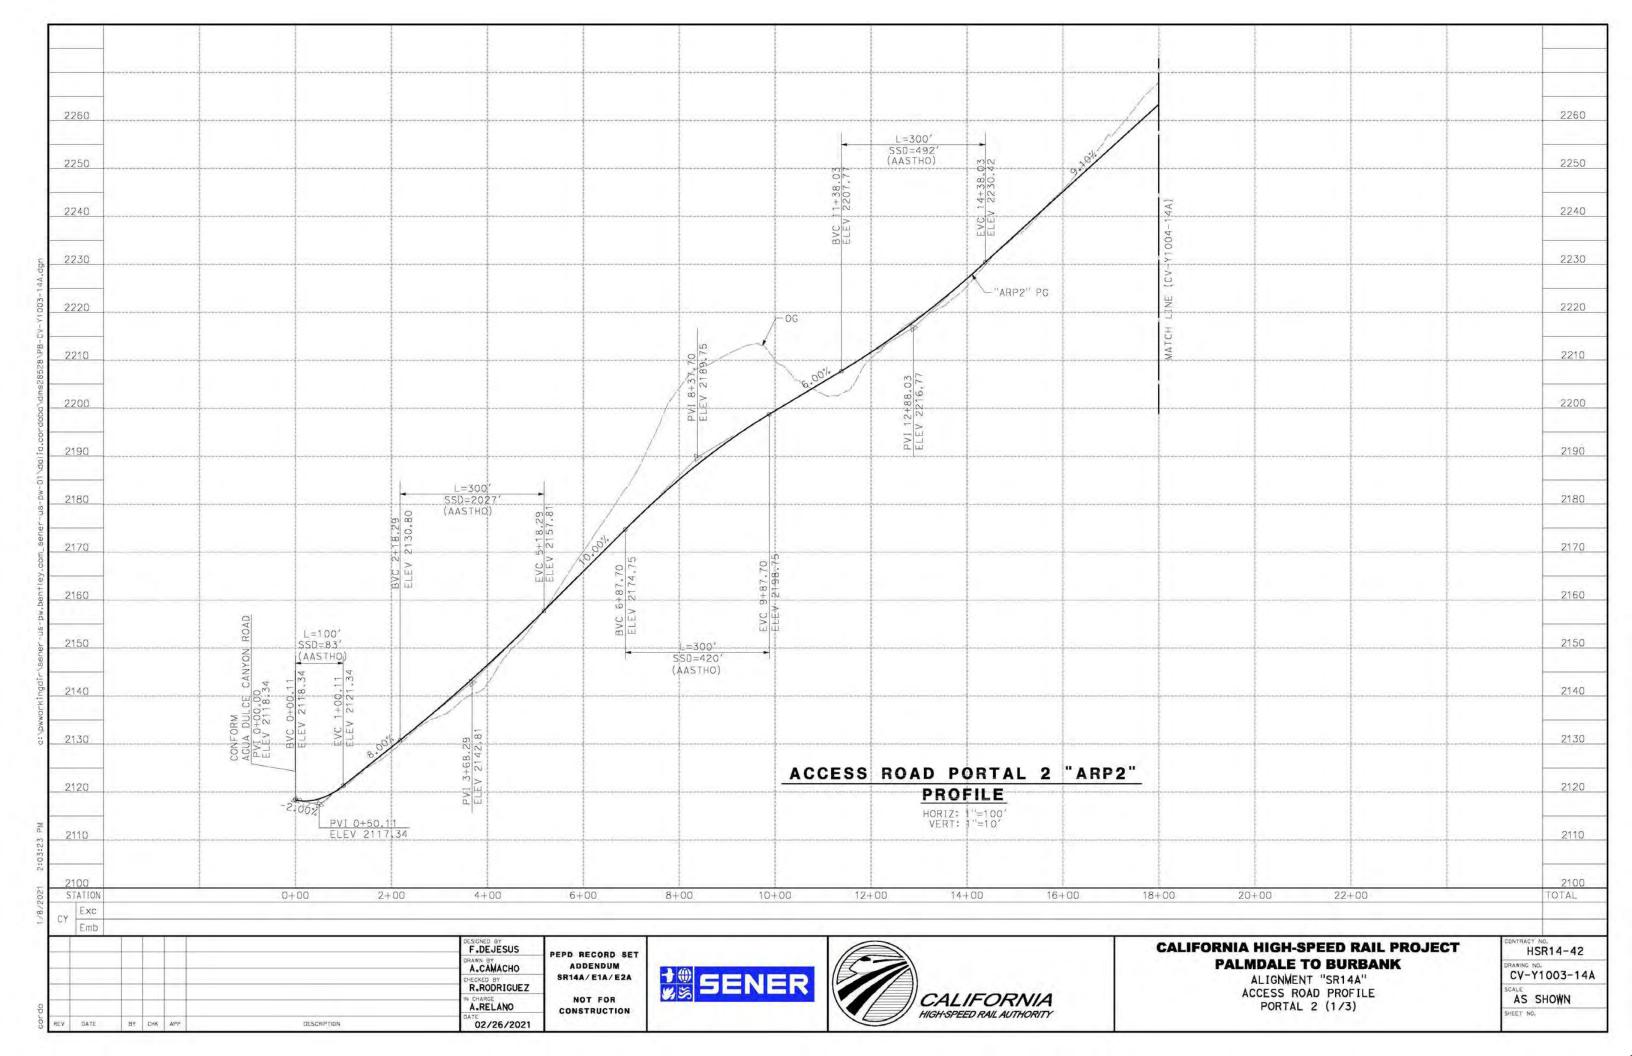


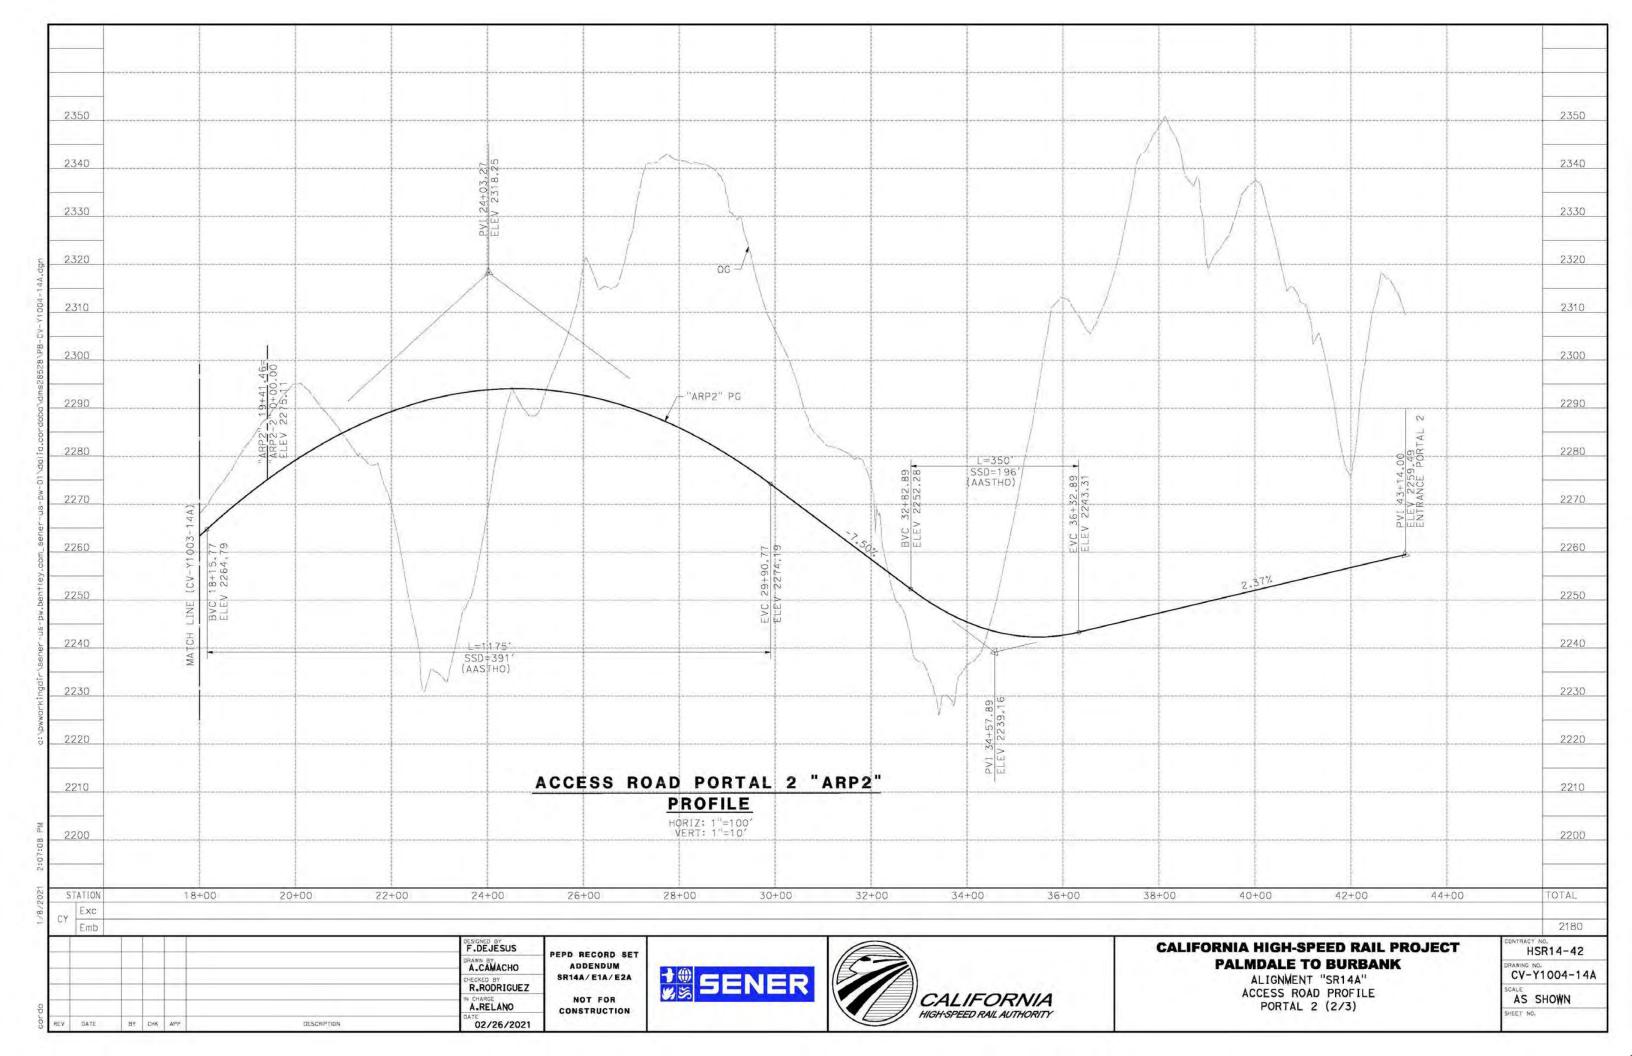


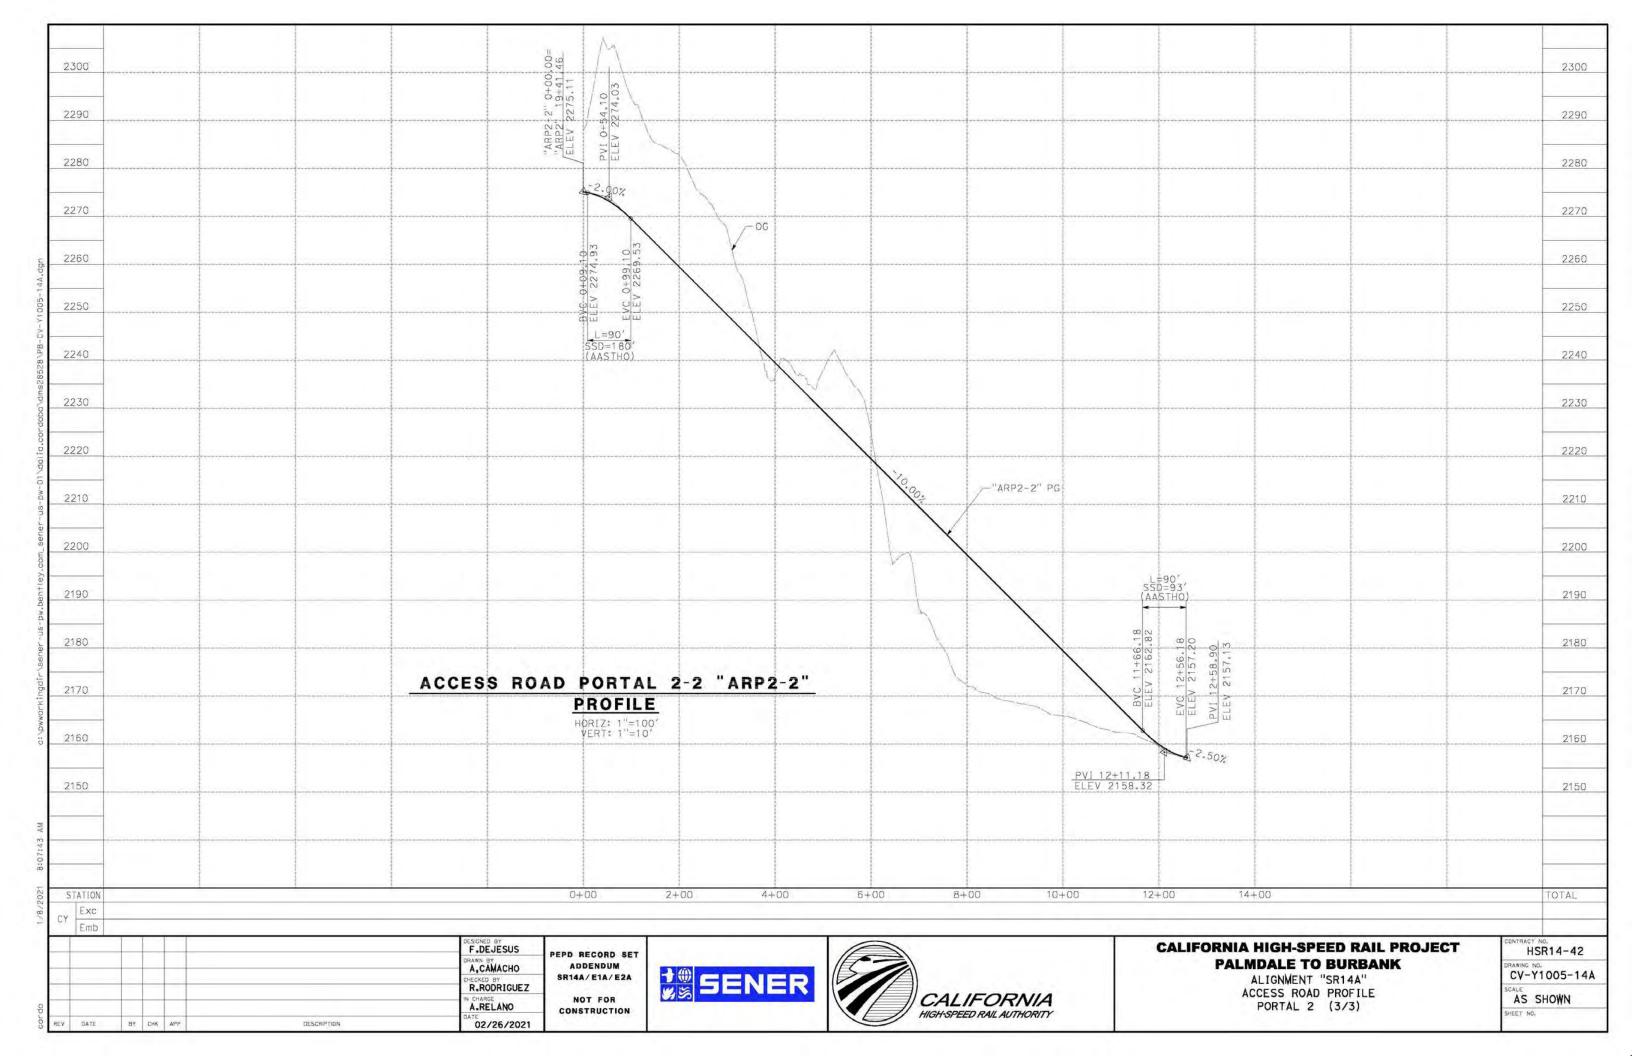


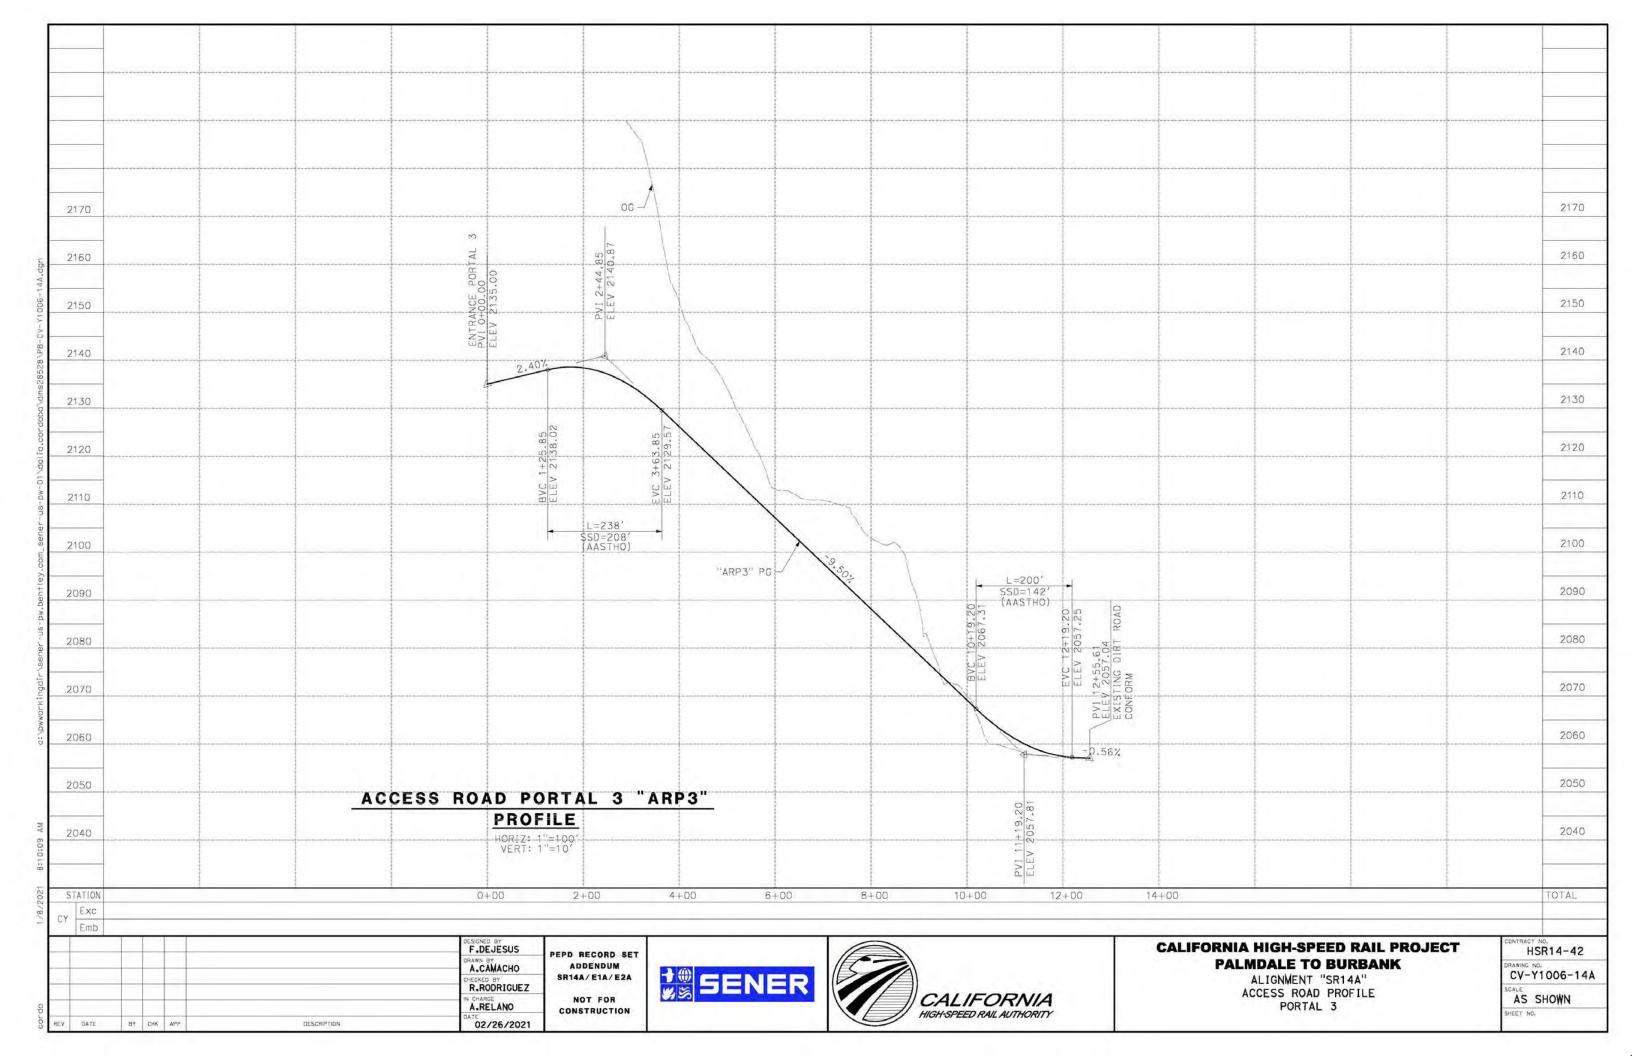

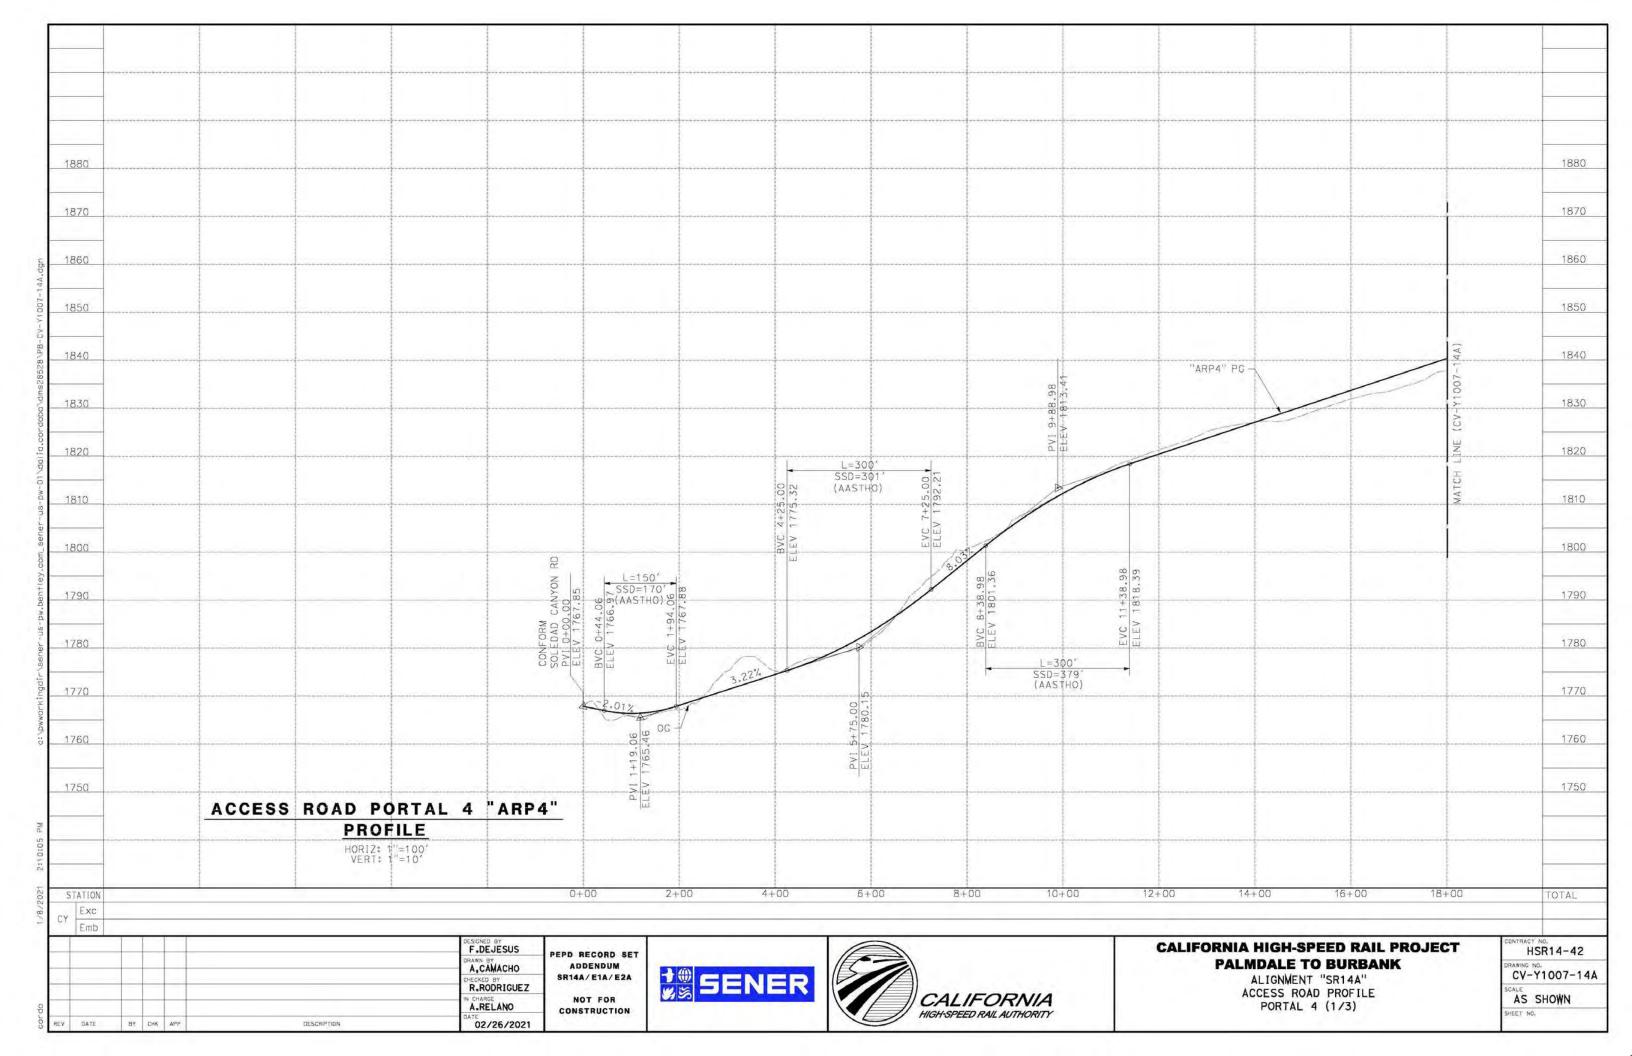

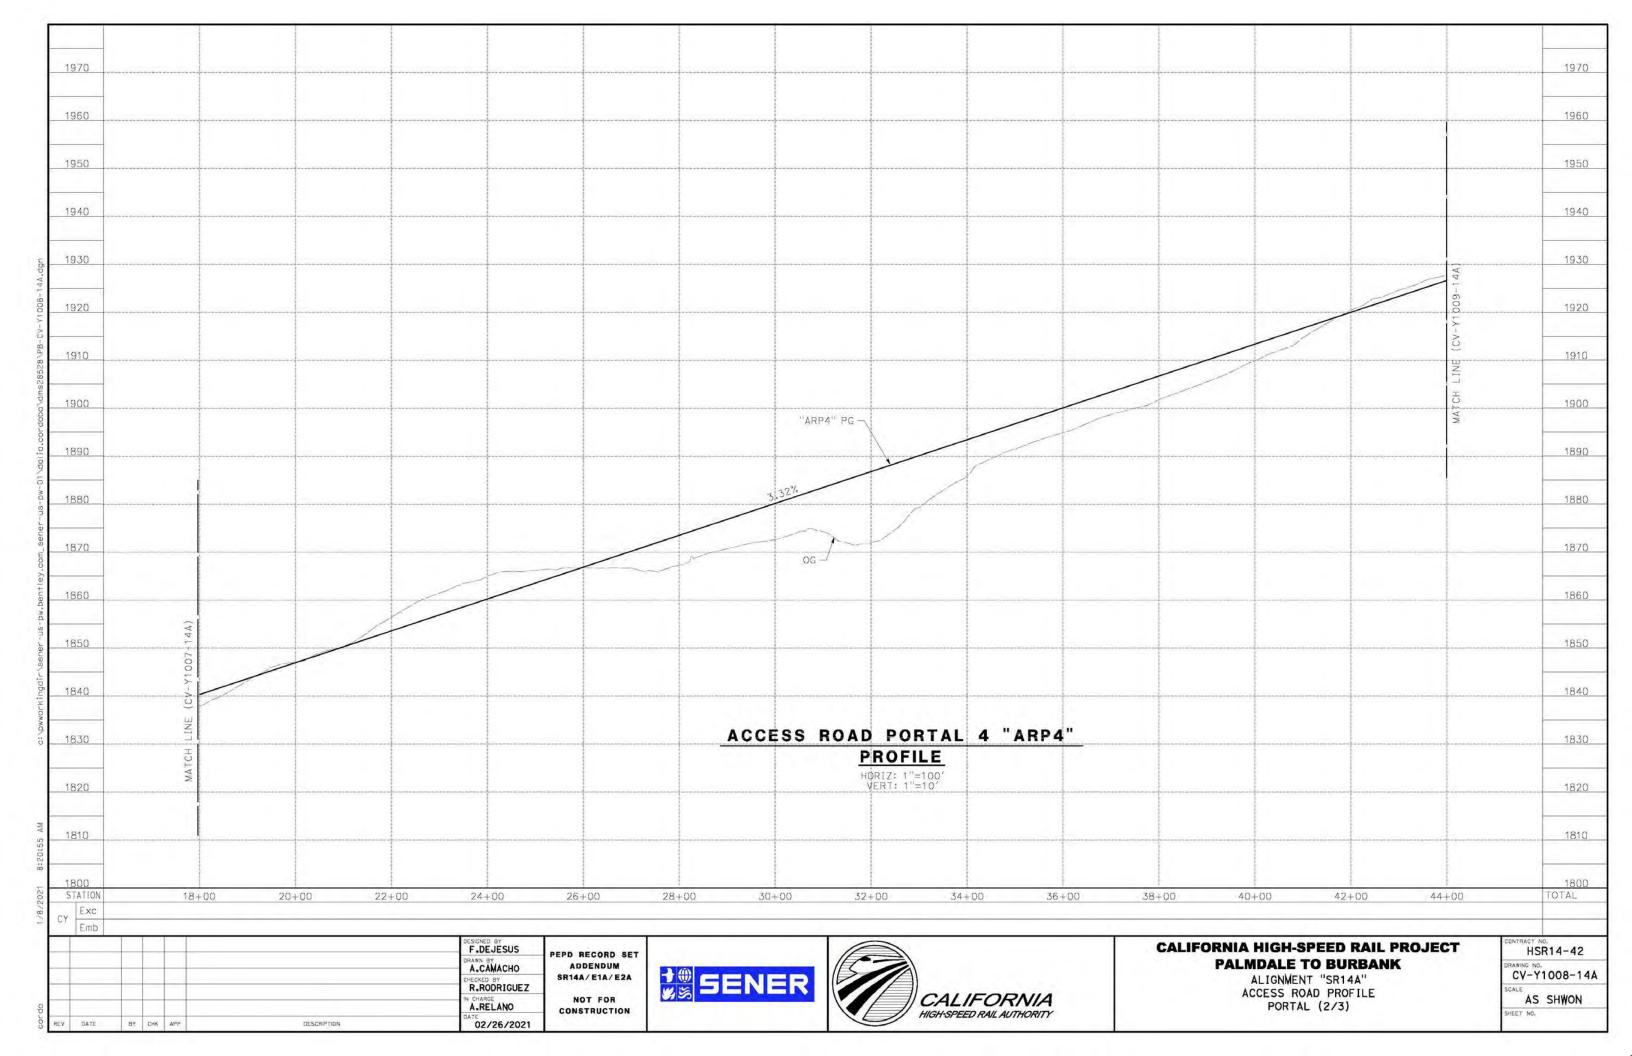

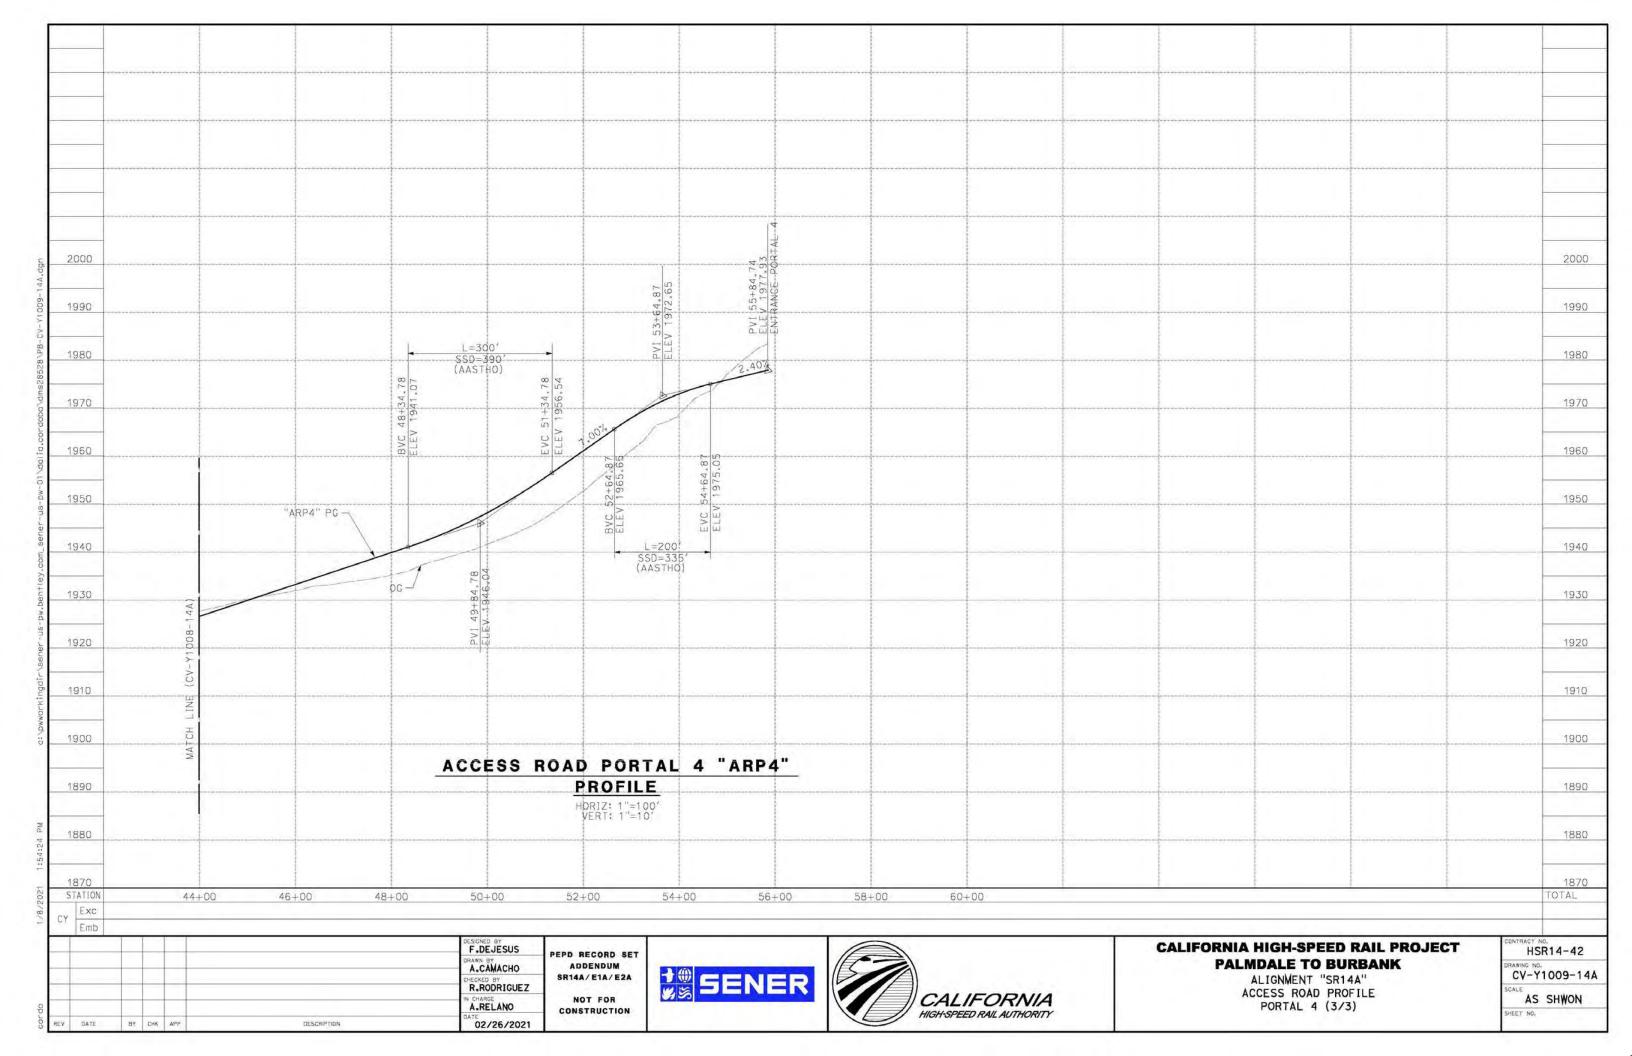

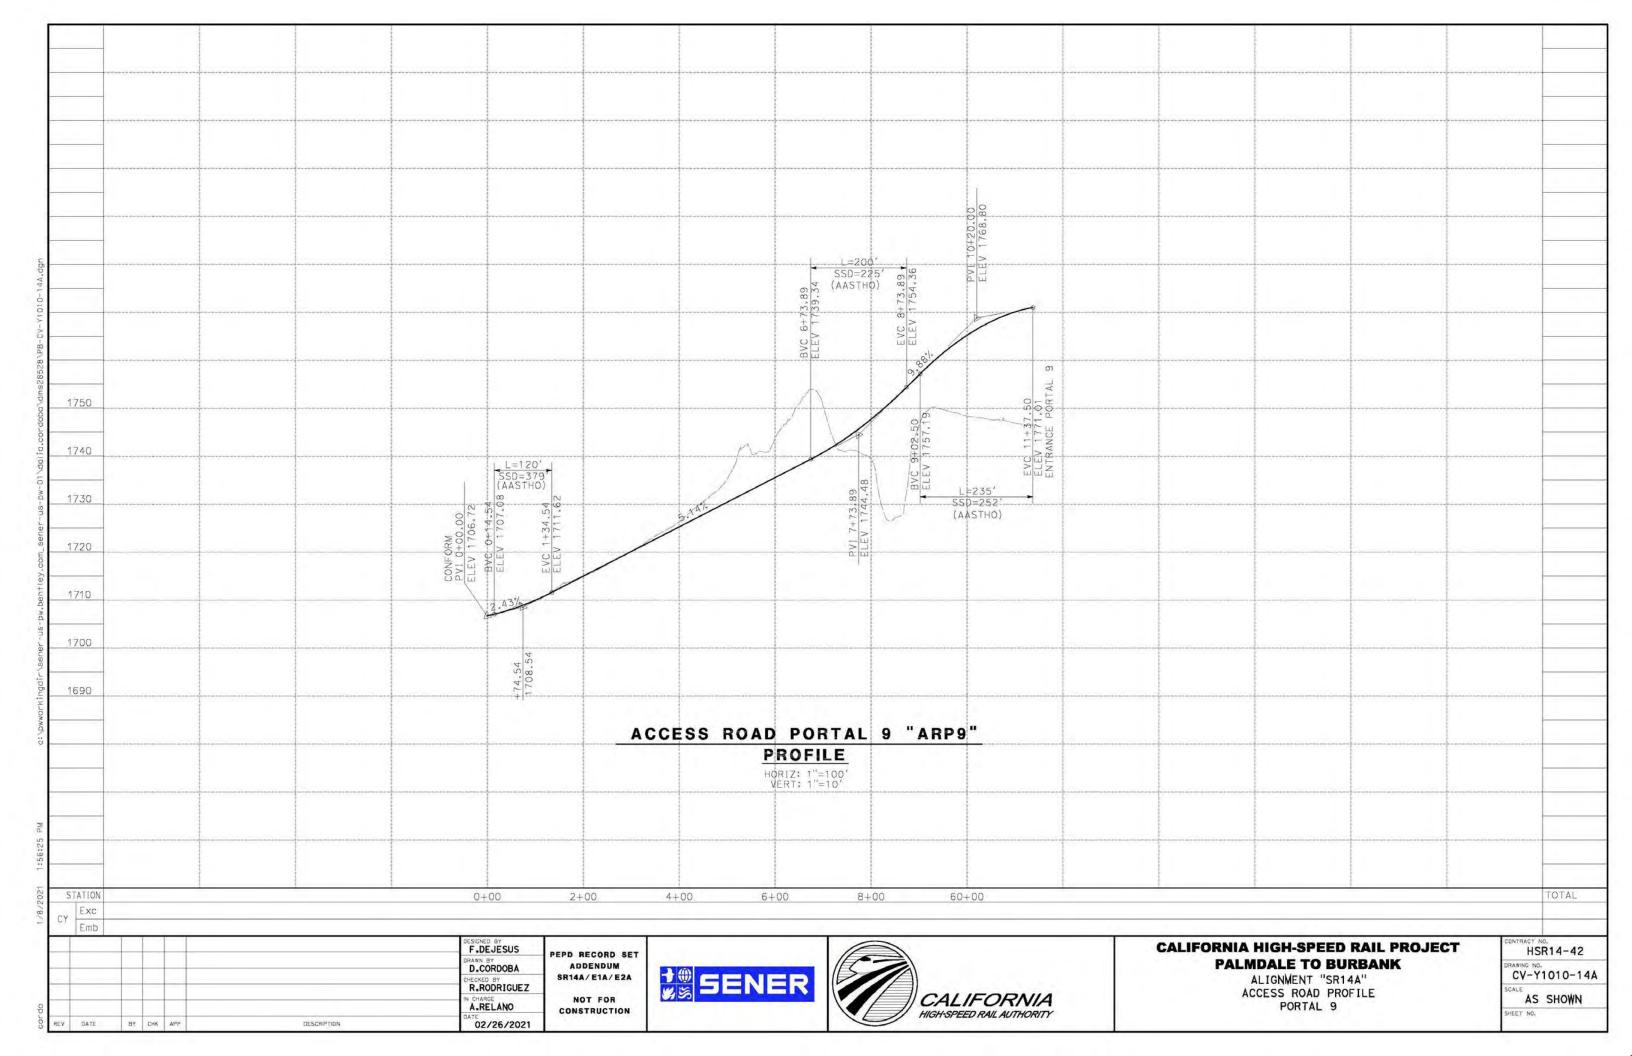



PEPD RECORD SET ADDENDUM SR14A/E1A/E2A NOT FOR

CONSTRUCTION



RIW

211 CUT-OR FILL

0G -



INTERMEDIATE WINDOW STA 0+00.00 TO STA 23+25.10

-2:1 CUT OR FILL

T_06

PORTAL 9 STA 0+00.00 TO 11+37.50

PORTAL 4

25'

NB LANE SB LANE

ACCESS ROADS SR14A PORTALS PORTAL 1 STA 0+00.00 TO STA 11+60.79 (ACCESS ROAD 1) STA 0+00.00 RO STA 5+74.89 (ACCESS ROAD 1-1) PORTAL 2 STA 0+00.00 TO STA 43+14.00 (ACCESS ROAS 2) STA 0+00.00 TO STA 12+58.90 (ACCESS ROAD 2-2) PORTAL 3

12.5

12.5

Ī	CALIFORNIA HIGH-SPEED RAIL PROJECT
	PALMDALE TO BURBANK

ALIGNMENT "SR14A" ACCESS ROADS TYPICAL SECTIONS
PORTALS SR41A

DRAWING	NO.
DIL	Y300
LV-	1300


AS SHOWN SHEET NO.


STA 0+00.00 TO STA 12+55.61 STA 0+00,00 TO STA 55+84.74


02/26/2021


BY CHK APP


DESCRIPTION

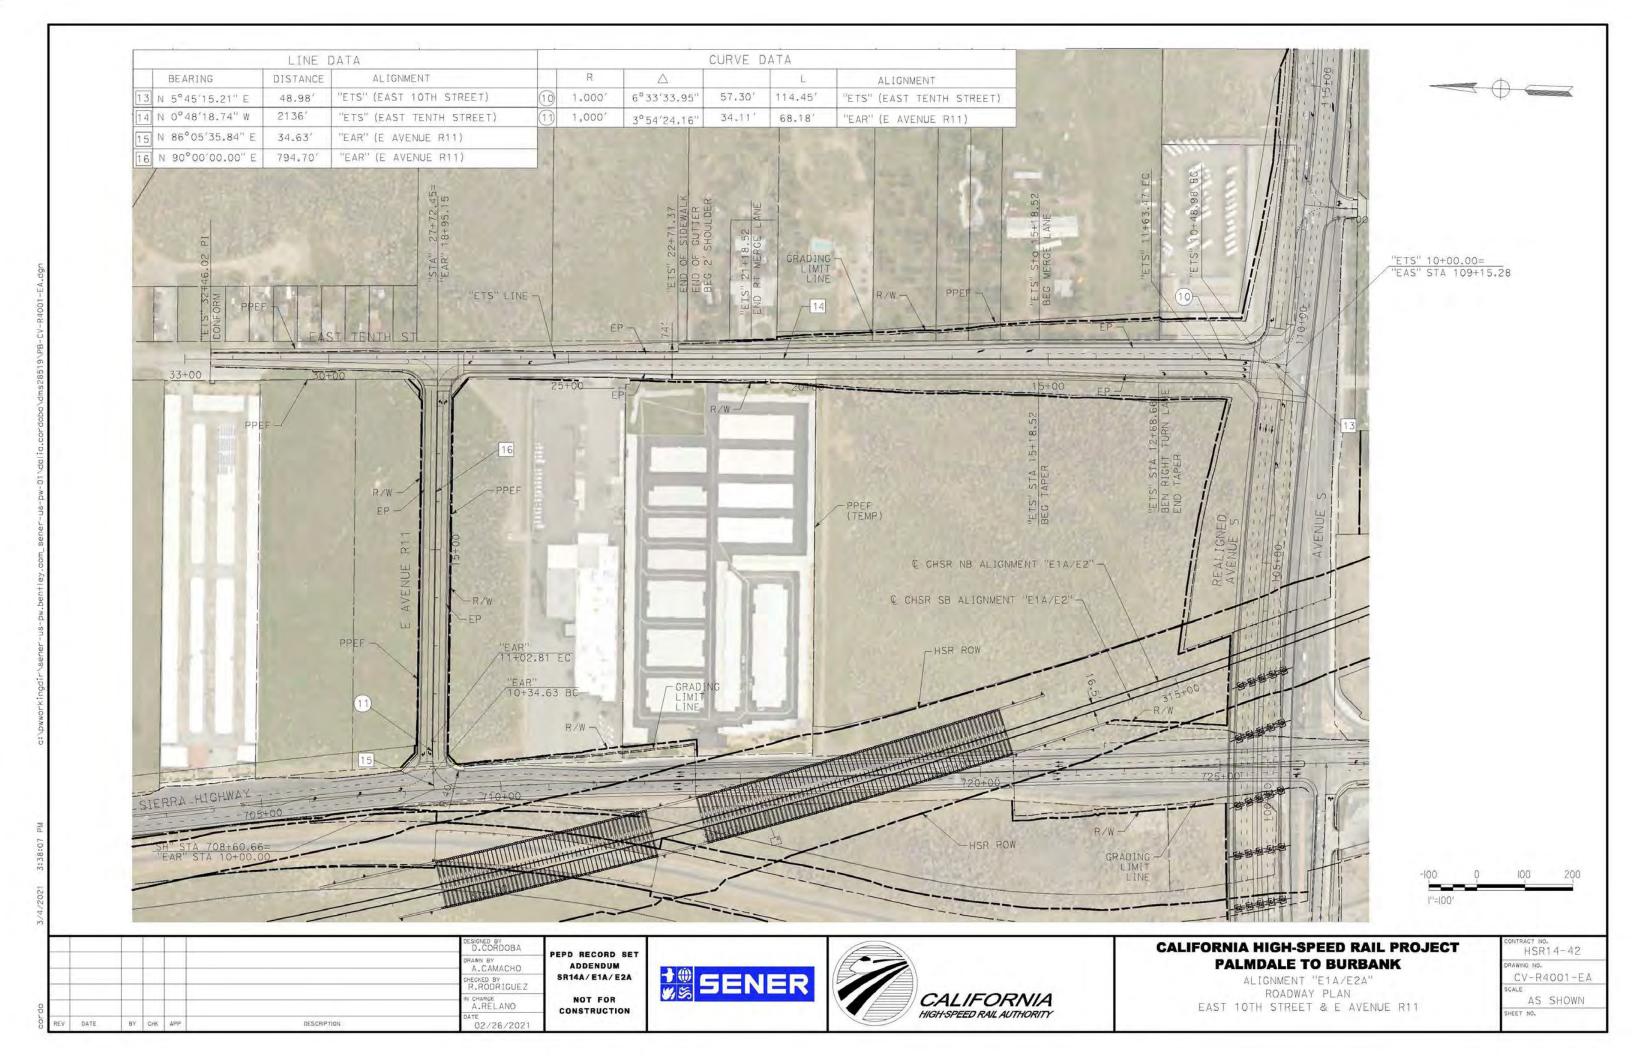


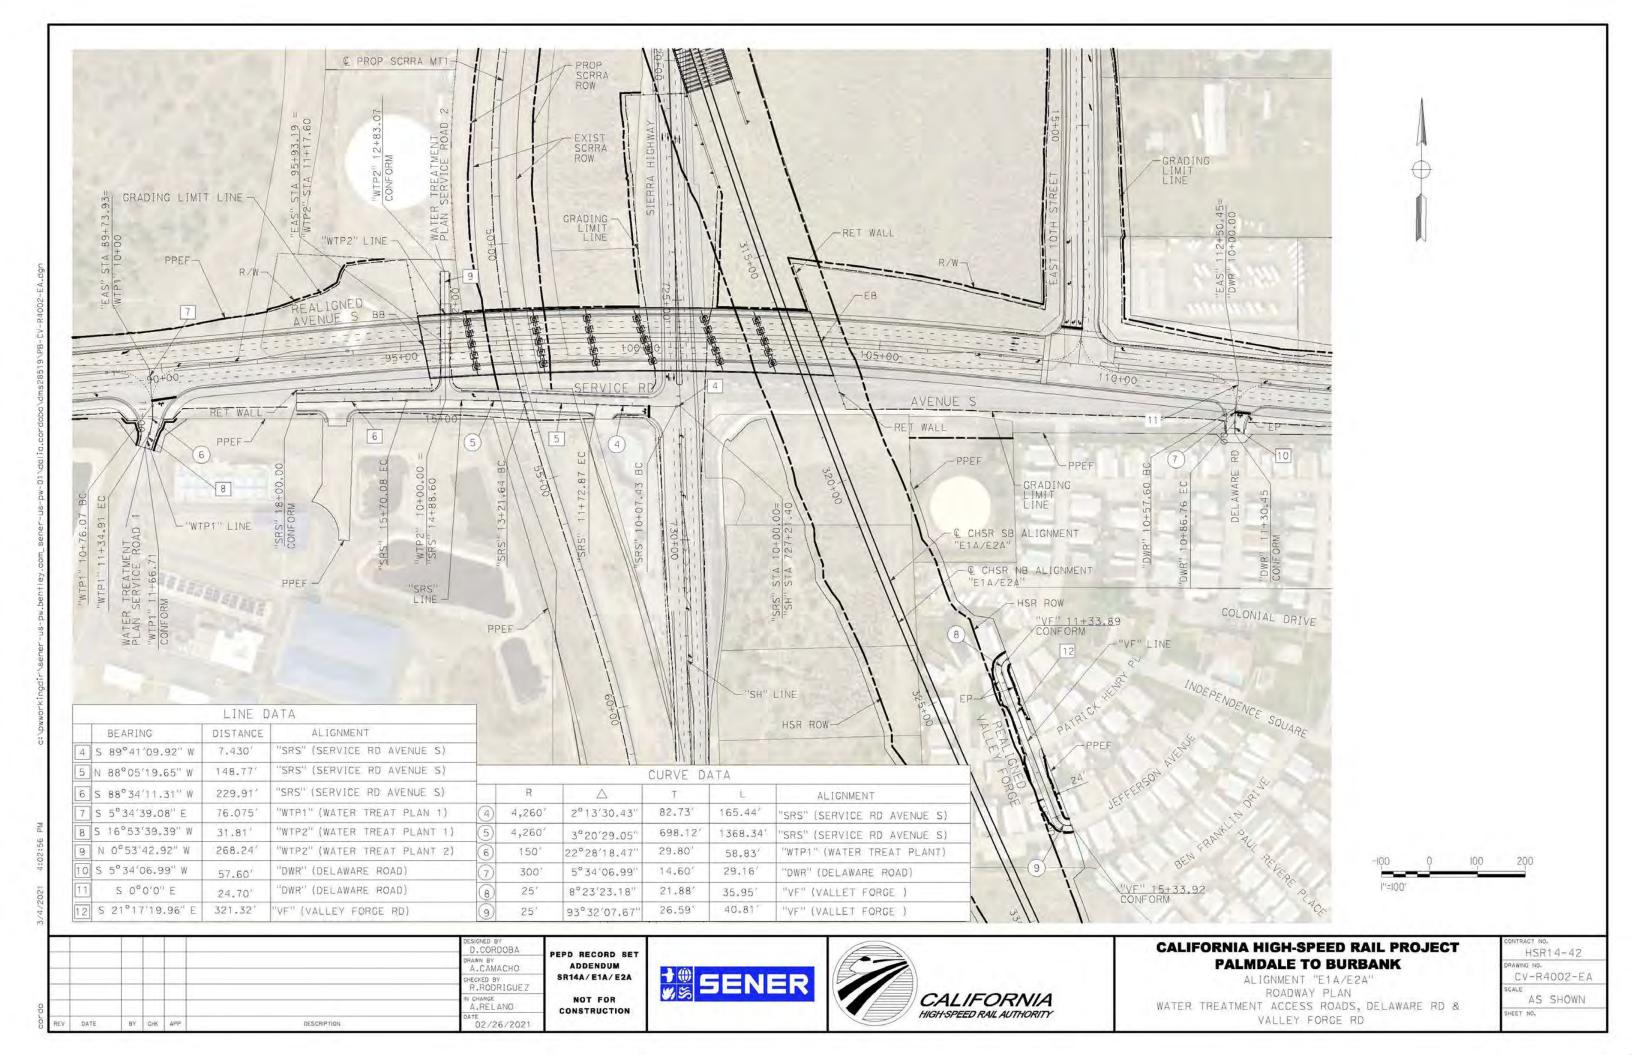

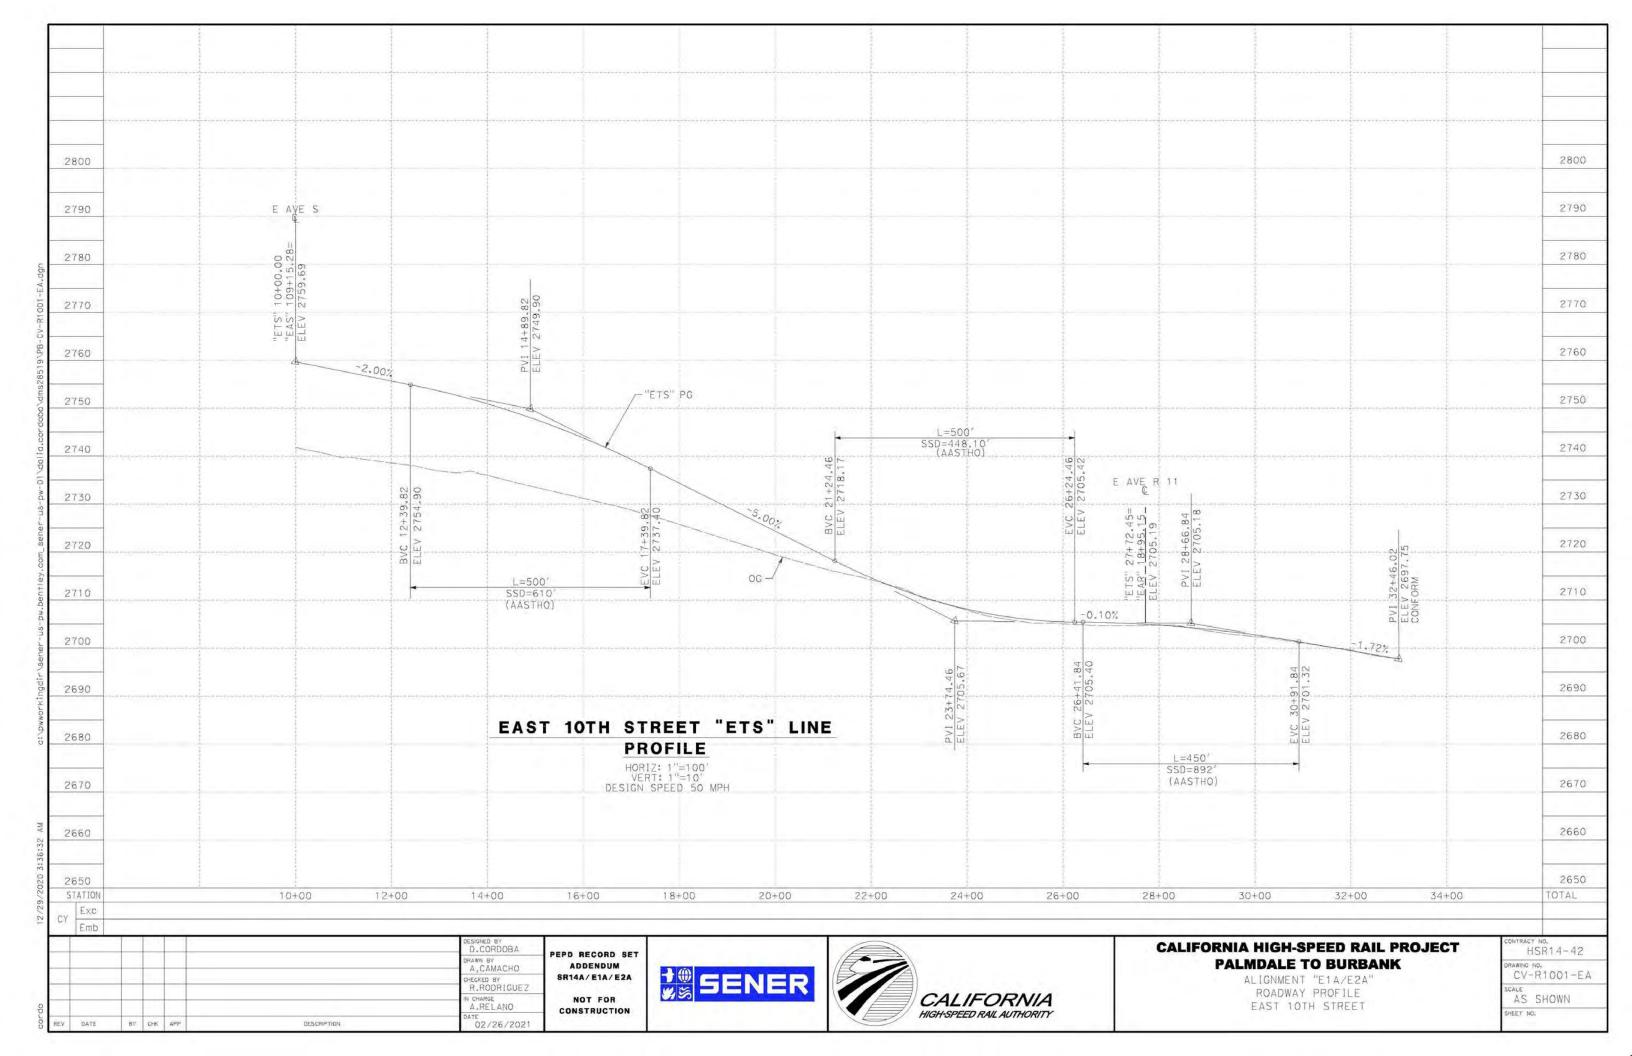

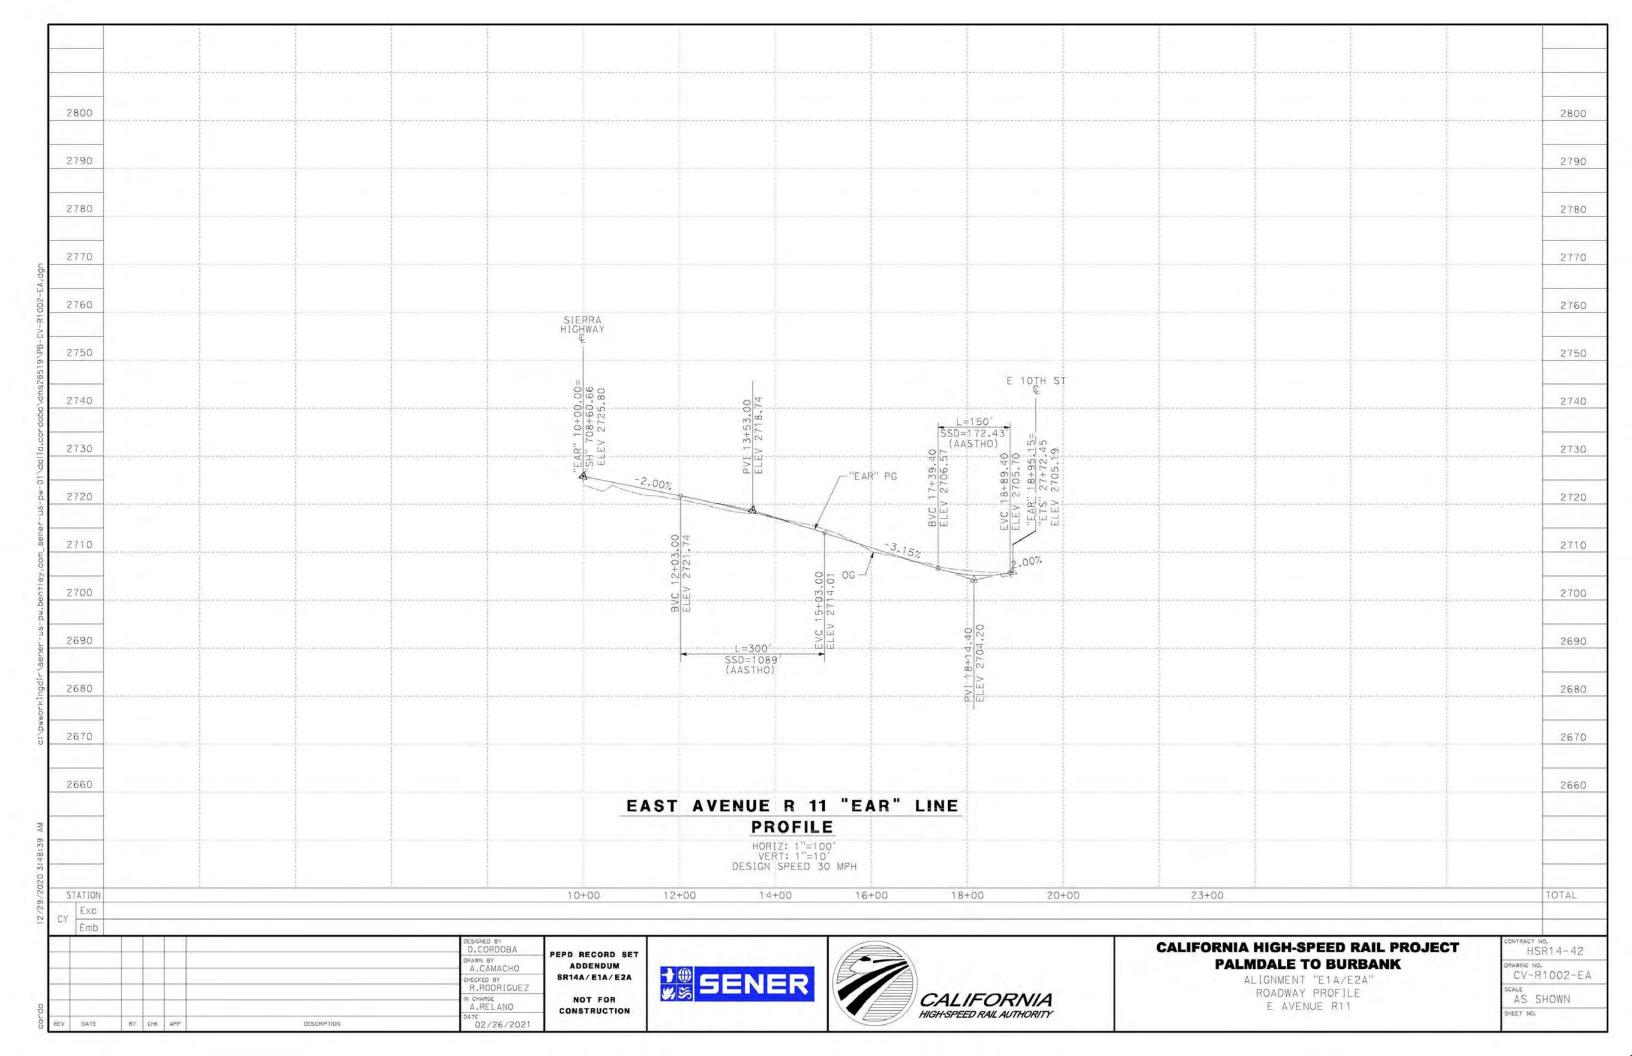

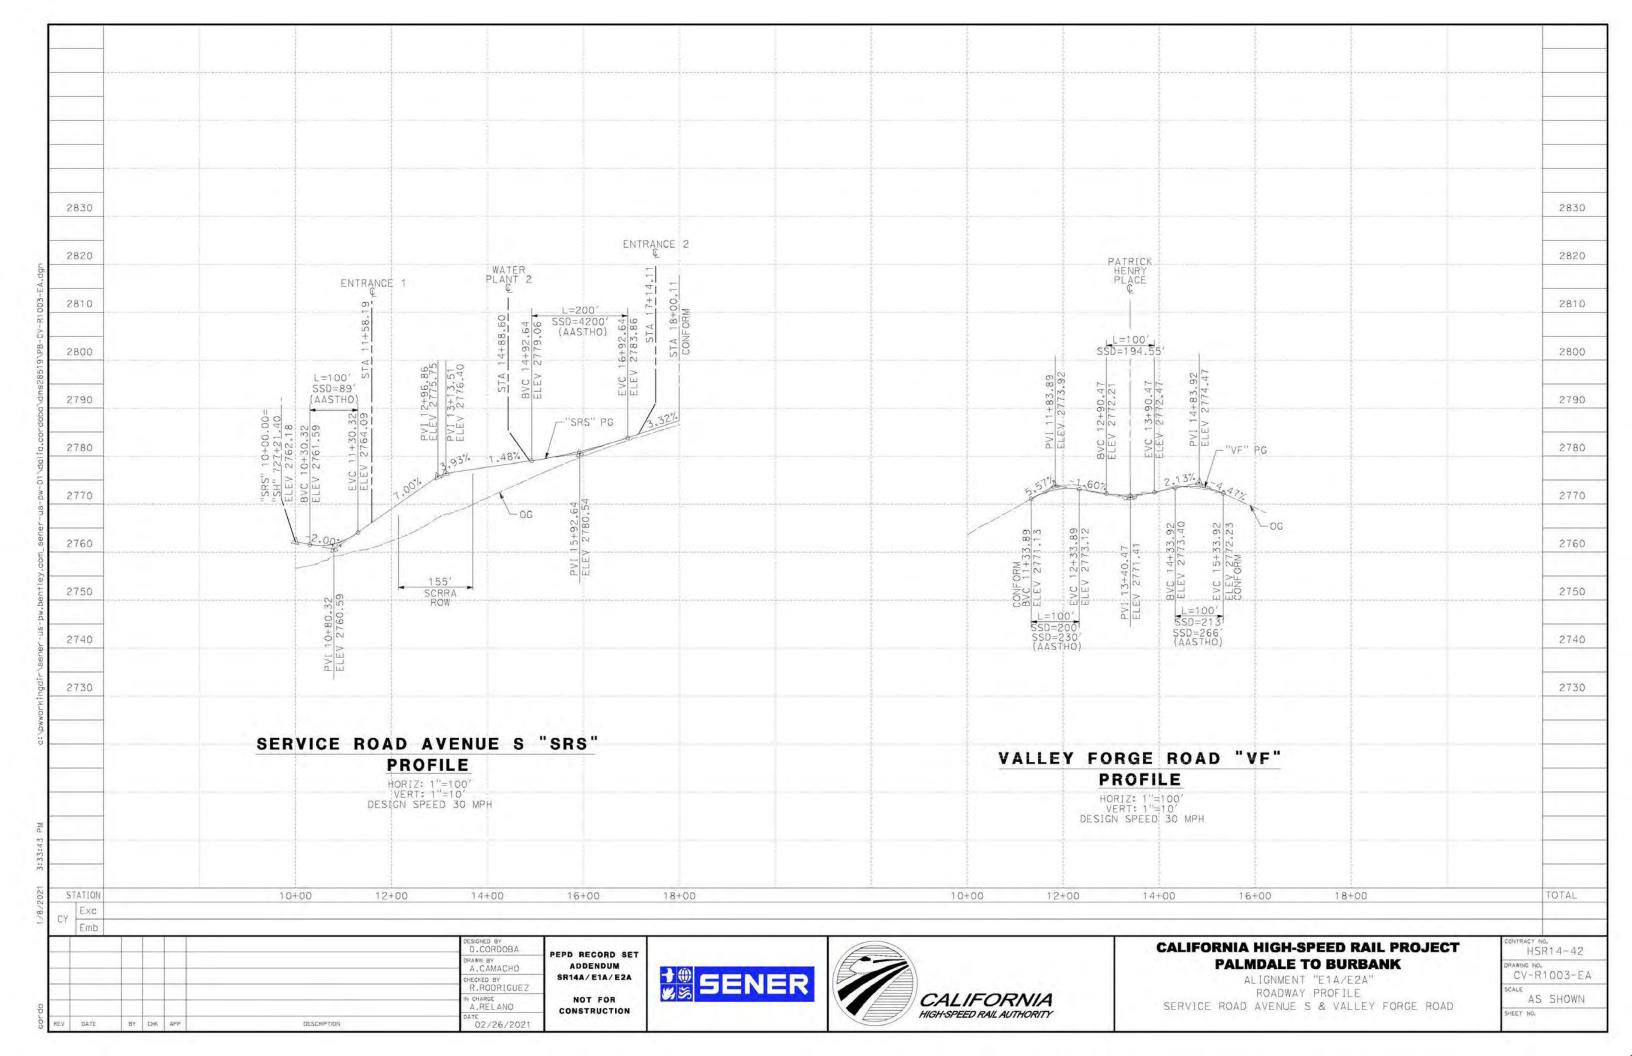

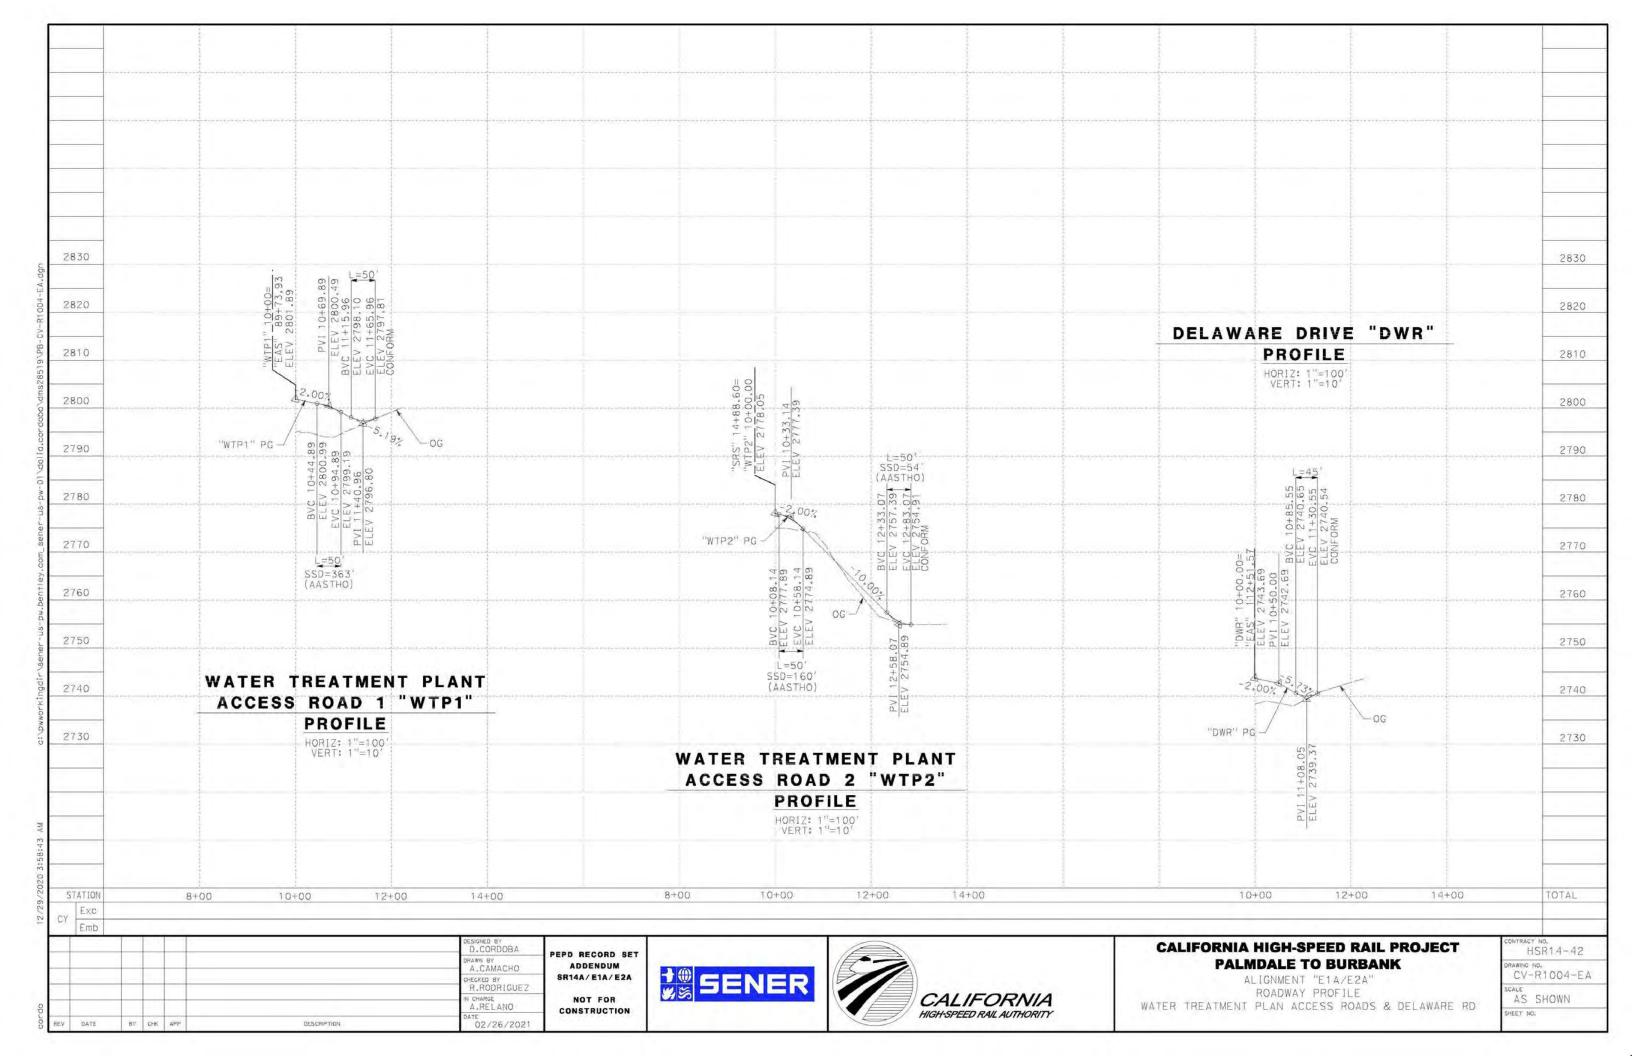




SENER



STA 12+68.66 TO STA 22+71.37 SECONDARY ARTERIAL PER CITY OF PALMDALE GENERAL PLAN

R.W

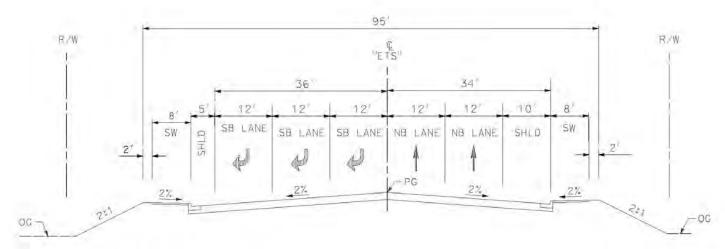

VARIES 71' - 95'

SB LANE SB LANE | NB LANE

EAST 10TH ST

44" 34

0'-12'

SHLD

49

R/W

EAST 10TH ST

STA 10+76.75 TO STA 12+68.66 SECONDARY ARTERIAL PER CITY OF PALMDALE GENERAL PLAN

CALIFORNIA HIGH-SPEED RAIL PROJECT PALMDALE TO BURBANK

ALIGNMENT "E1A/E2A" ROADWAY TYPICAL SECTIONS EAST 10TH STREET (1/2)

DRAWING	NO.
CV	-R3001-F
CV	-R3001-E

PEPD RECORD SET ADDENDUM SR14A/E1A/E2A NOT FOR CONSTRUCTION

"ETS"

16'

VARIES 43' - 55'

LEFT

EAST 10TH ST

STA 24+22.42 TO STA 27+49.52 SECONDARY ARTERIAL PER CITY OF PALMDALE GENERAL PLAN

"ETS"

VARIES 55'-60'

SB LANE SB LANE NB LANE

EAST 10TH ST

STA 22+71.37 TO STA 24+22.42 SECONDARY ARTERIAL PER CITY OF PALMDALE GENERAL PLAN

39


39"

R/W


R/W





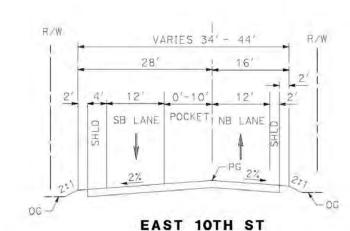

STA 27+49.52 TO STA STA 32+45.63 SECONDARY ARTERIAL PER CITY OF PALMDALE GENERAL PLAN

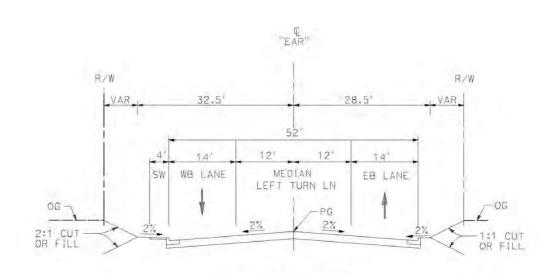

E AVENUE R11

STA 10+00 TO STA 18+95.15 LOCAL INTERIOR STREET PER CITY OF PALMDALE GENERAL PLAN



R/W

BZW

OG -

CALIFORNIA HIGH-SPEED RAIL PROJECT PALMDALE TO BURBANK

ALIGNMENT "E1A/E2A" ROADWAY TYPICAL SECTIONS EAST 10TH STREET (2/2) & E AVENUE R11

CONTRACT	NO.
HS	R14-42
DRAWING N	0.
CV-	R3002-EA
SCALE	
A.	S SHOWN
SHEET NO.	

R/W

WATER TREATMENT PLANT

ACCESS ROAD 2

STA 10+00 TO STA 12+68.24

"WTP1"

WATER TREATMENT PLANT

ACCESS ROAD1


STA 10+00 TO STA 11+66.71

12.5 NB LANE SB LANE R/W

PEPD RECORD SET ADDENDUM SR14A/E1A/E2A NOT FOR CONSTRUCTION






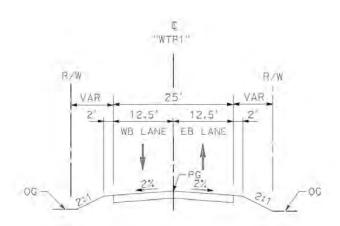

DELAWARE RD

STA 10+00 TO STA 11+66.71

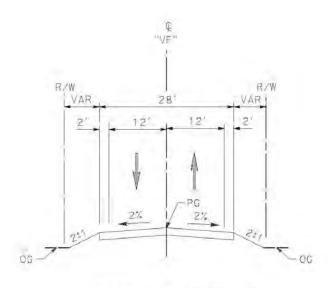

VALLEY FORGE RD


11+39.62 TO 15+33.61


SENER	


CALIFORNIA HIGH-SPEED RAIL PROJECT PALMDALE TO BURBANK


ALIGNMENT "E1A/E2A" ROADWAY TYPICAL SECTIONS
WATER TREATMENT PLANT ACCESS ROADS, DELAWARE RD &
VALLEY FORSE RD

CONTRA	HSR		2
DRAWIN C\	0 NO.	3003-	EA
SCALE	No	SCAL	E

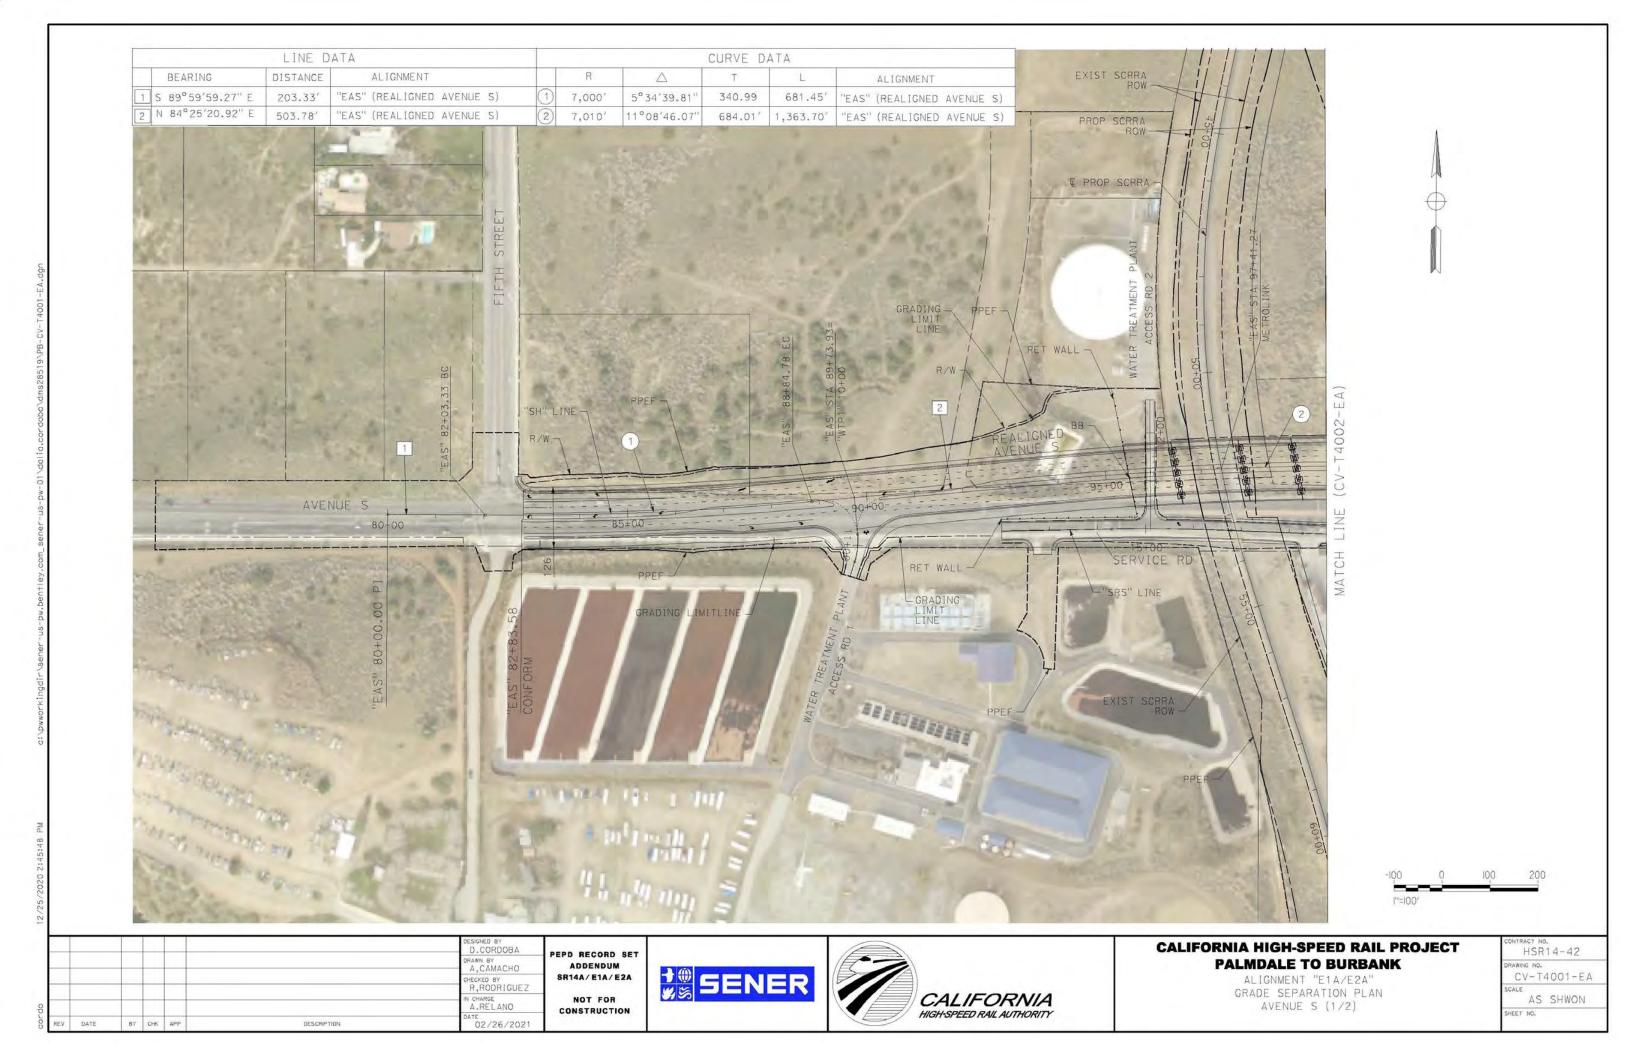

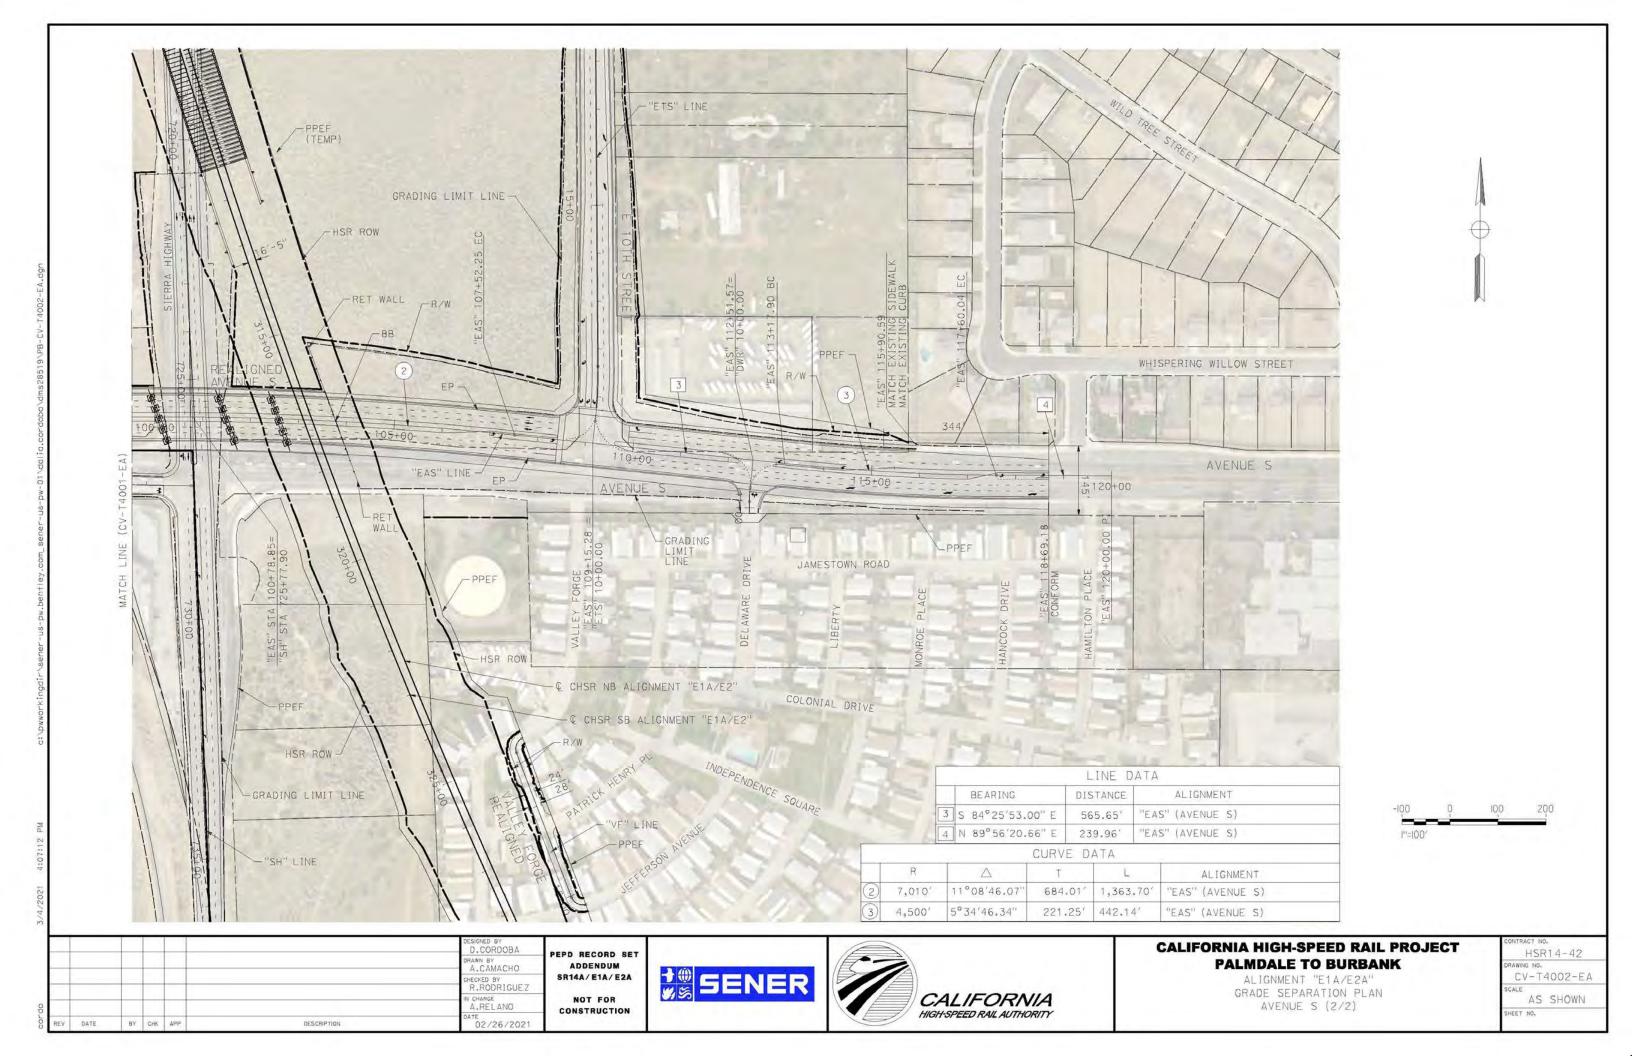

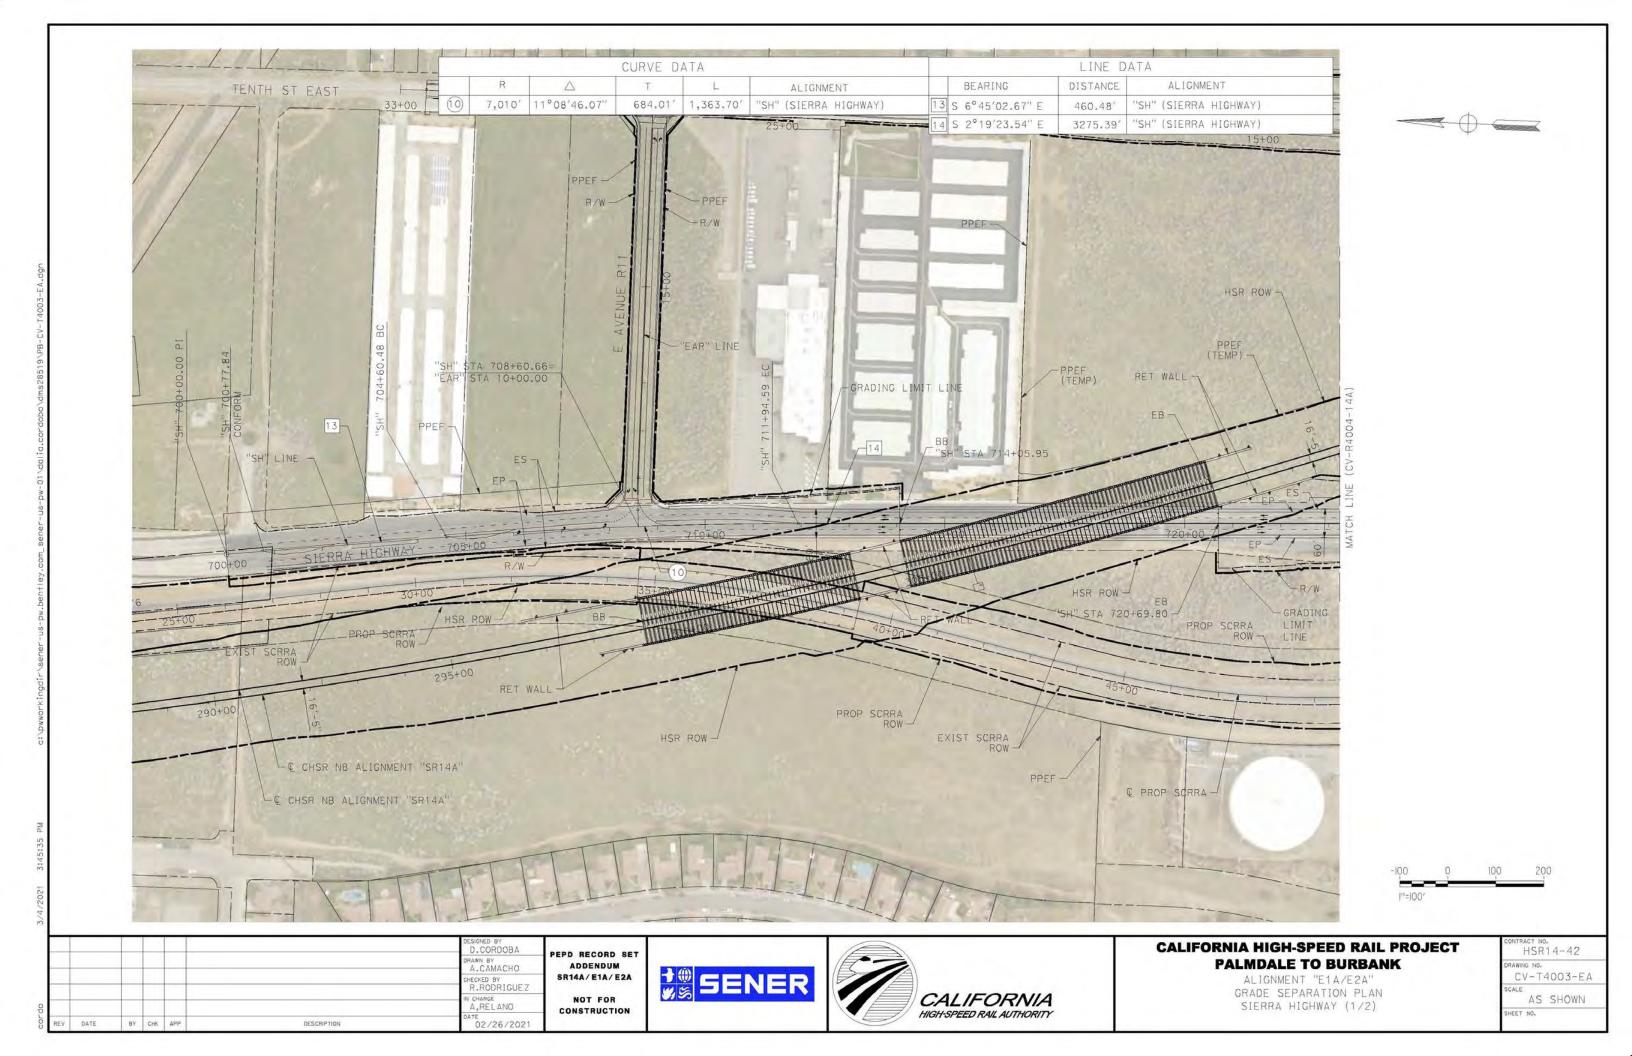

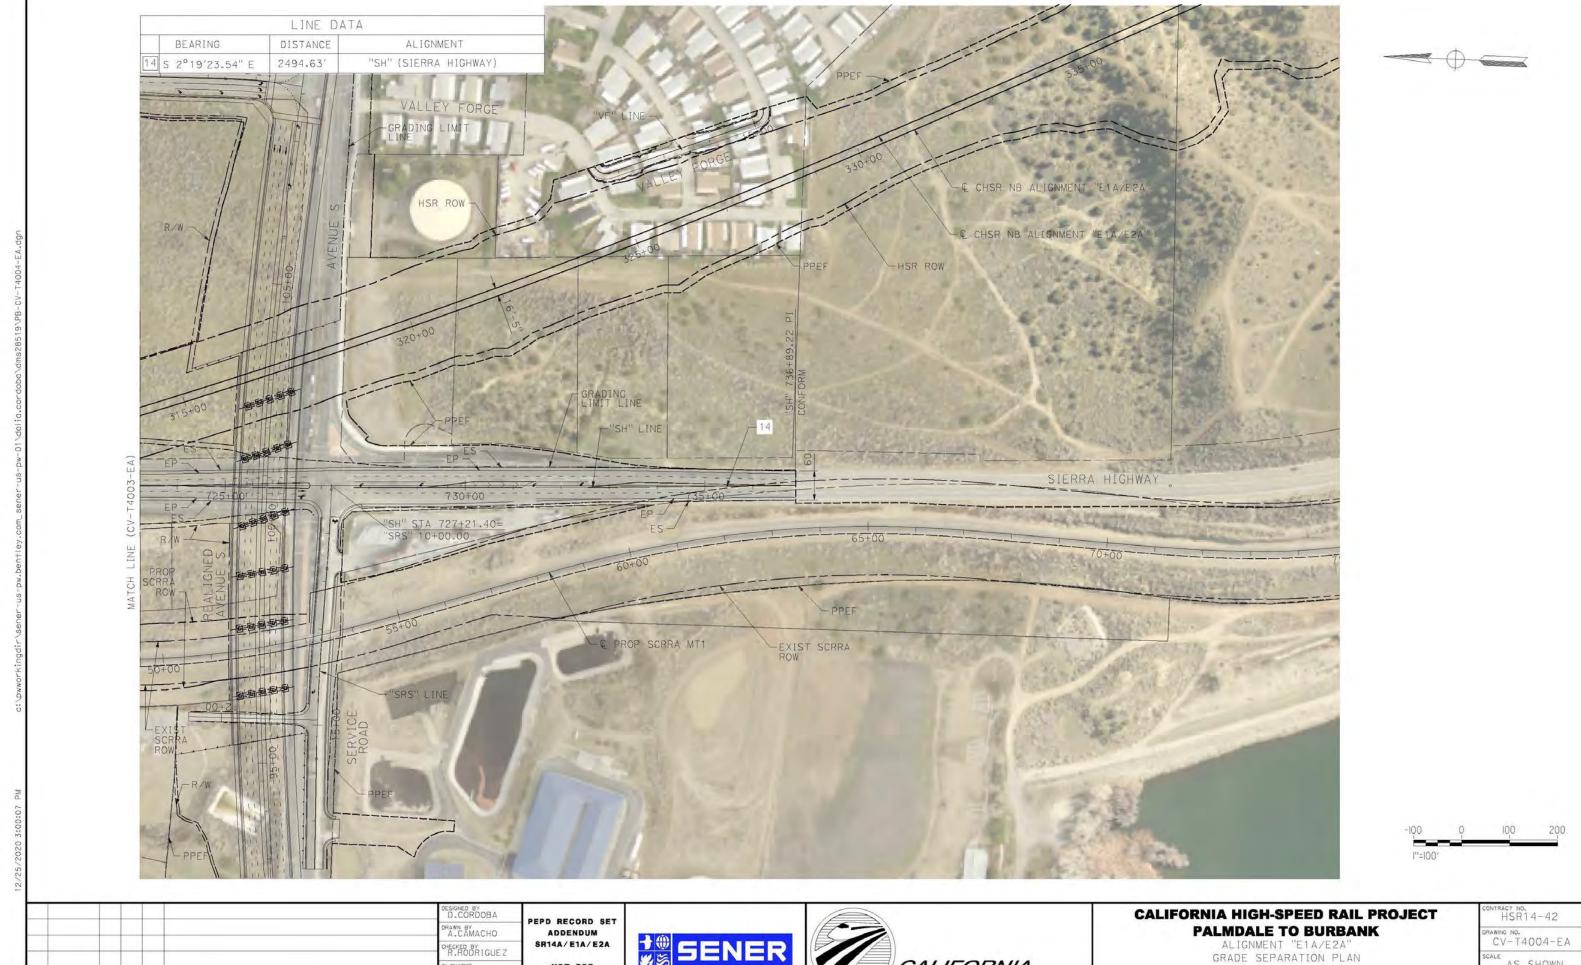

NOT FOR A RELANO CONSTRUCTION

ATE 02/26/2021

BY CHK APP


DESCRIPTION


SENER





SIERRA HIGHWAY (2/2)


CONTR	HSR	14-42
	ig No. √- T	4004-EA
SCALE	AS	SHOWN

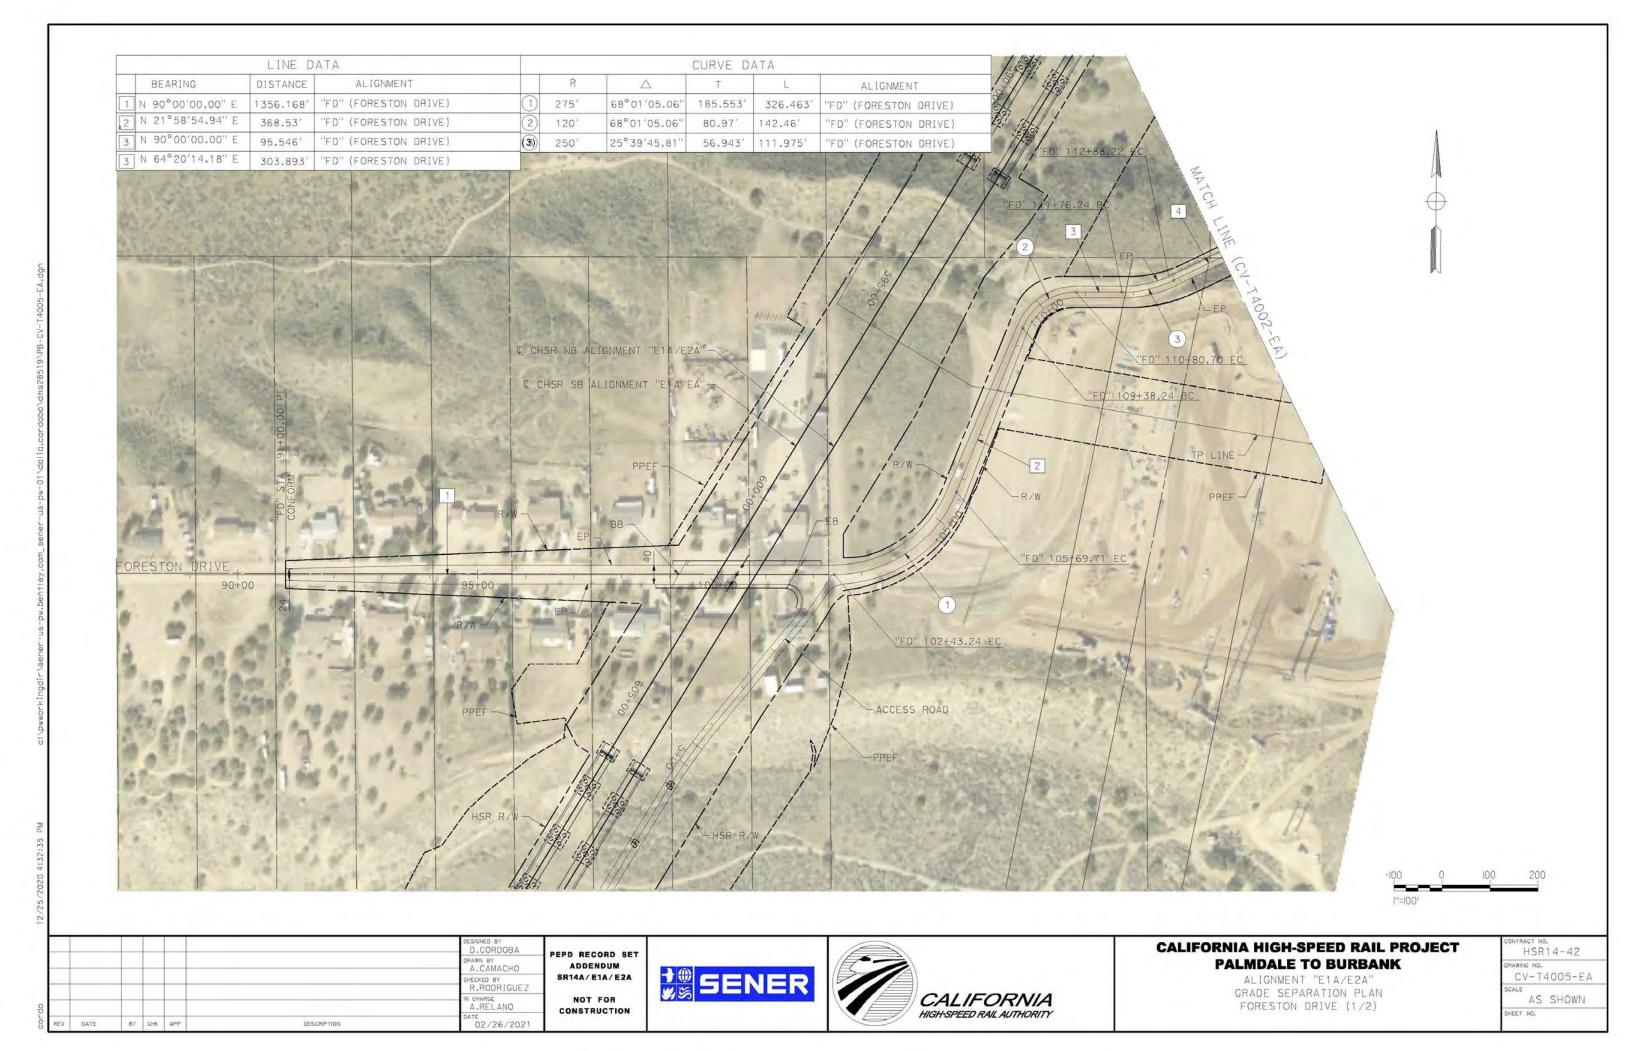


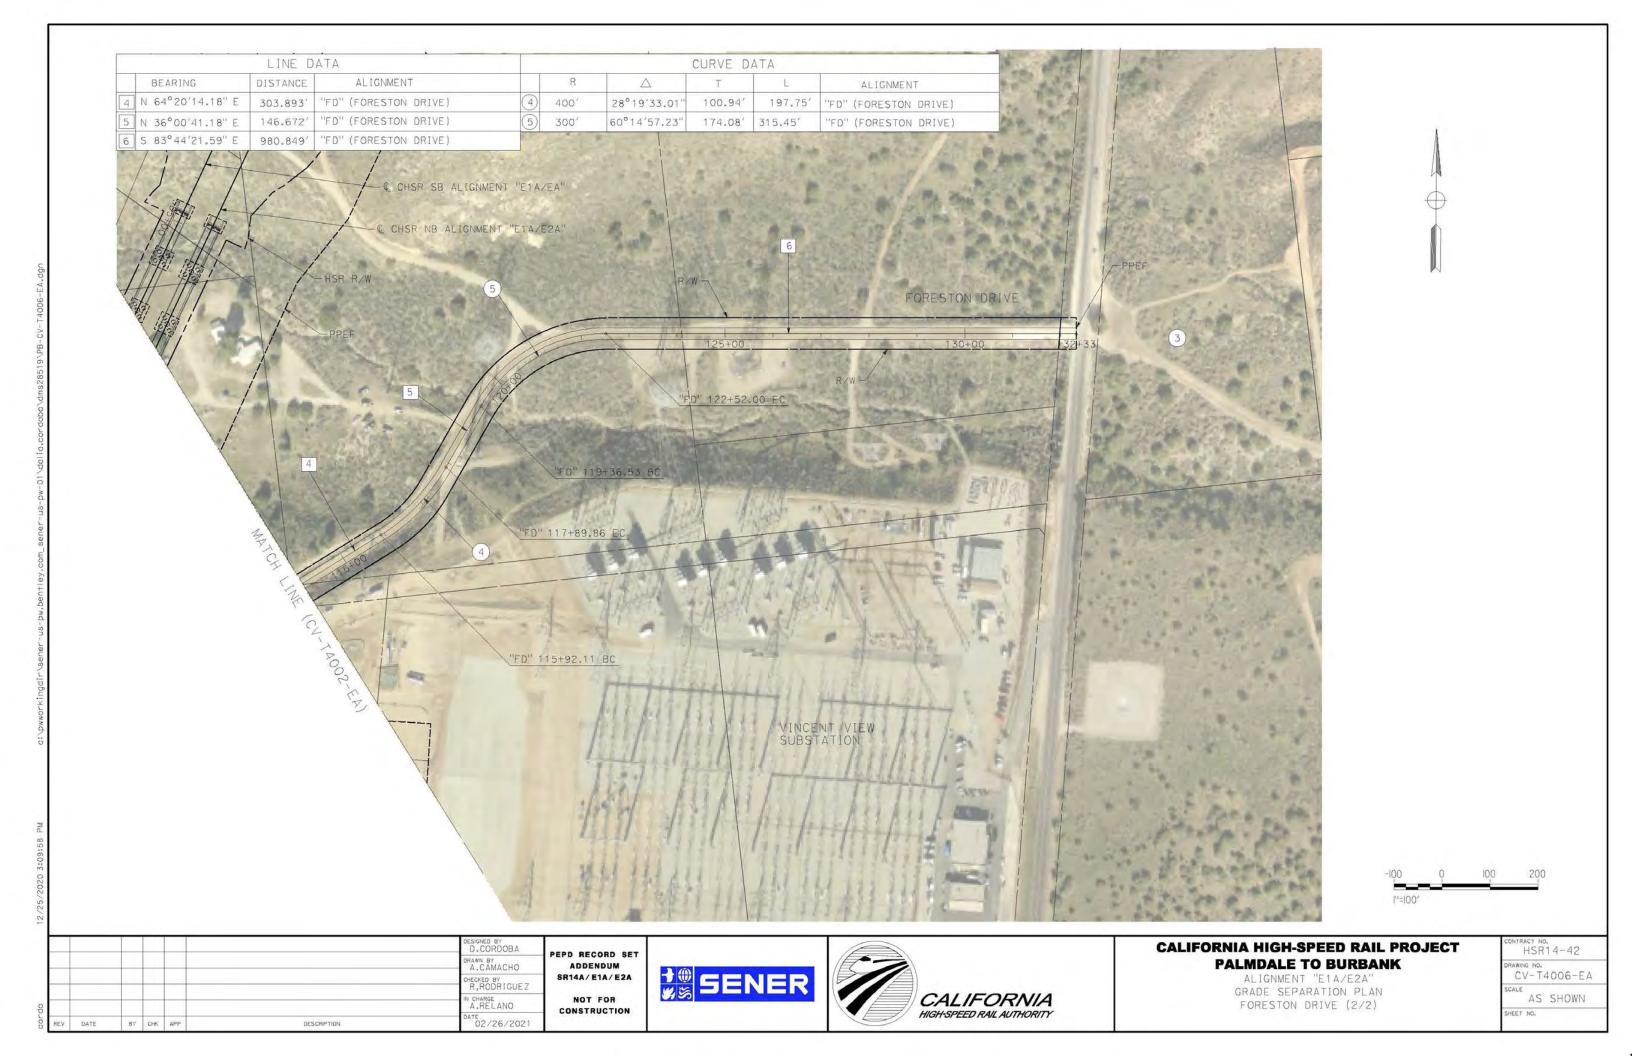


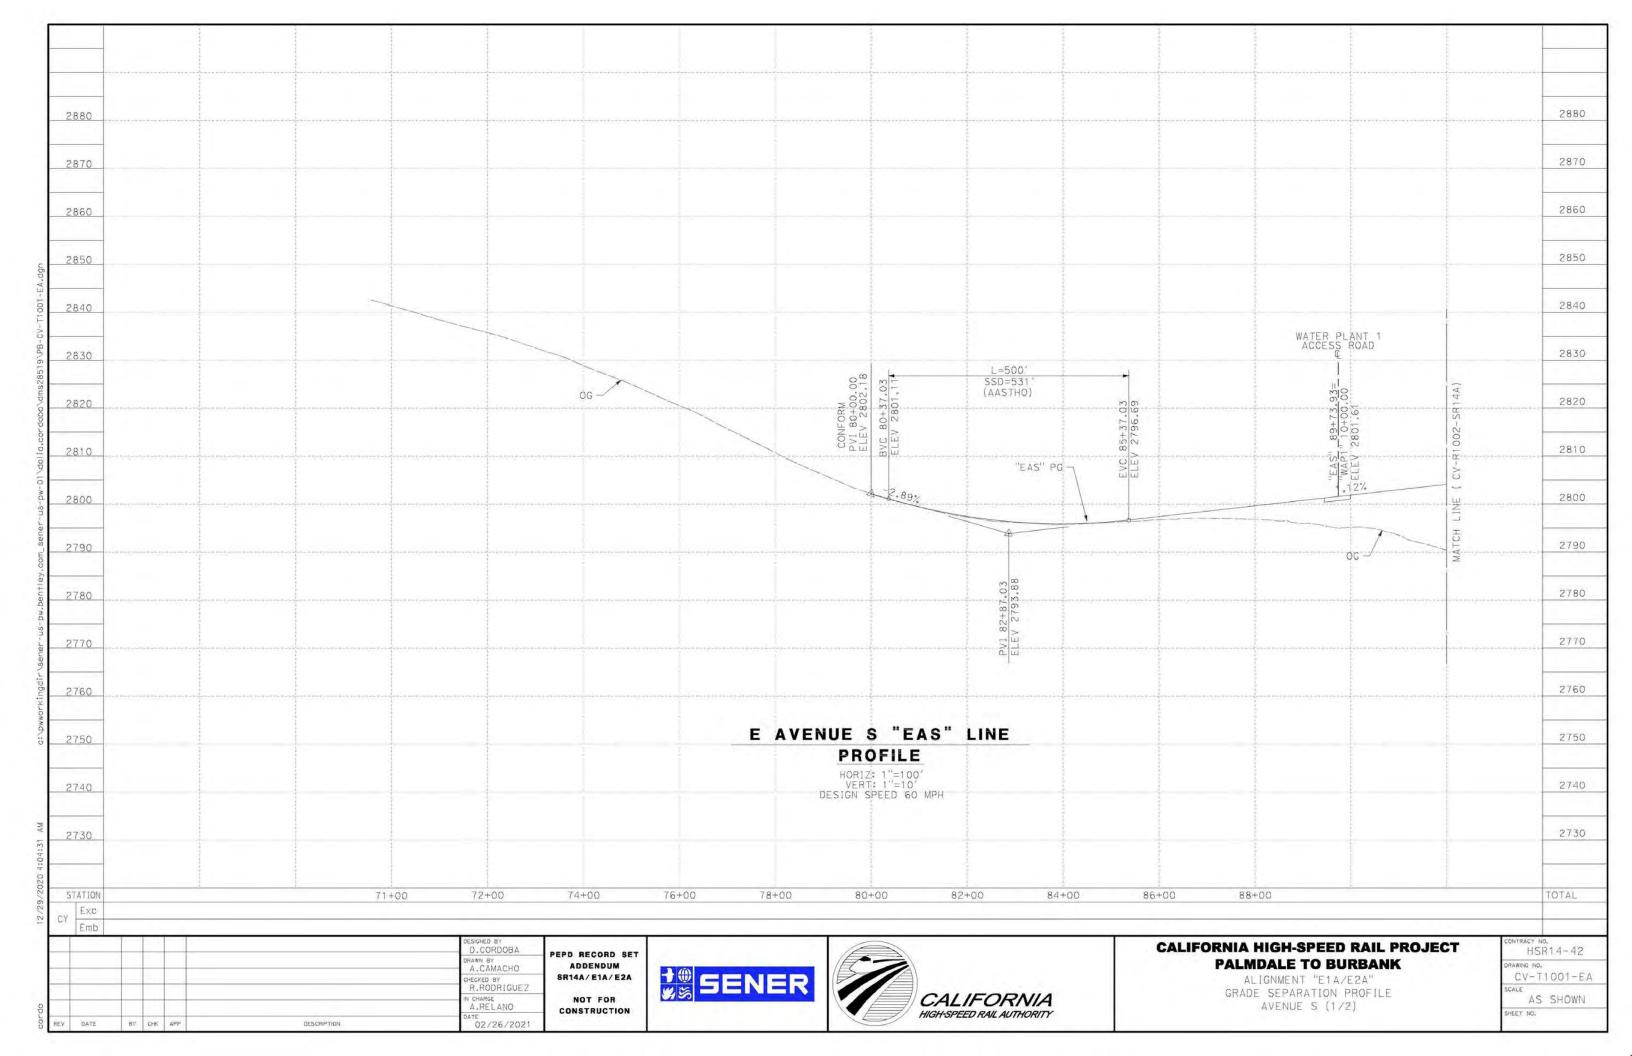


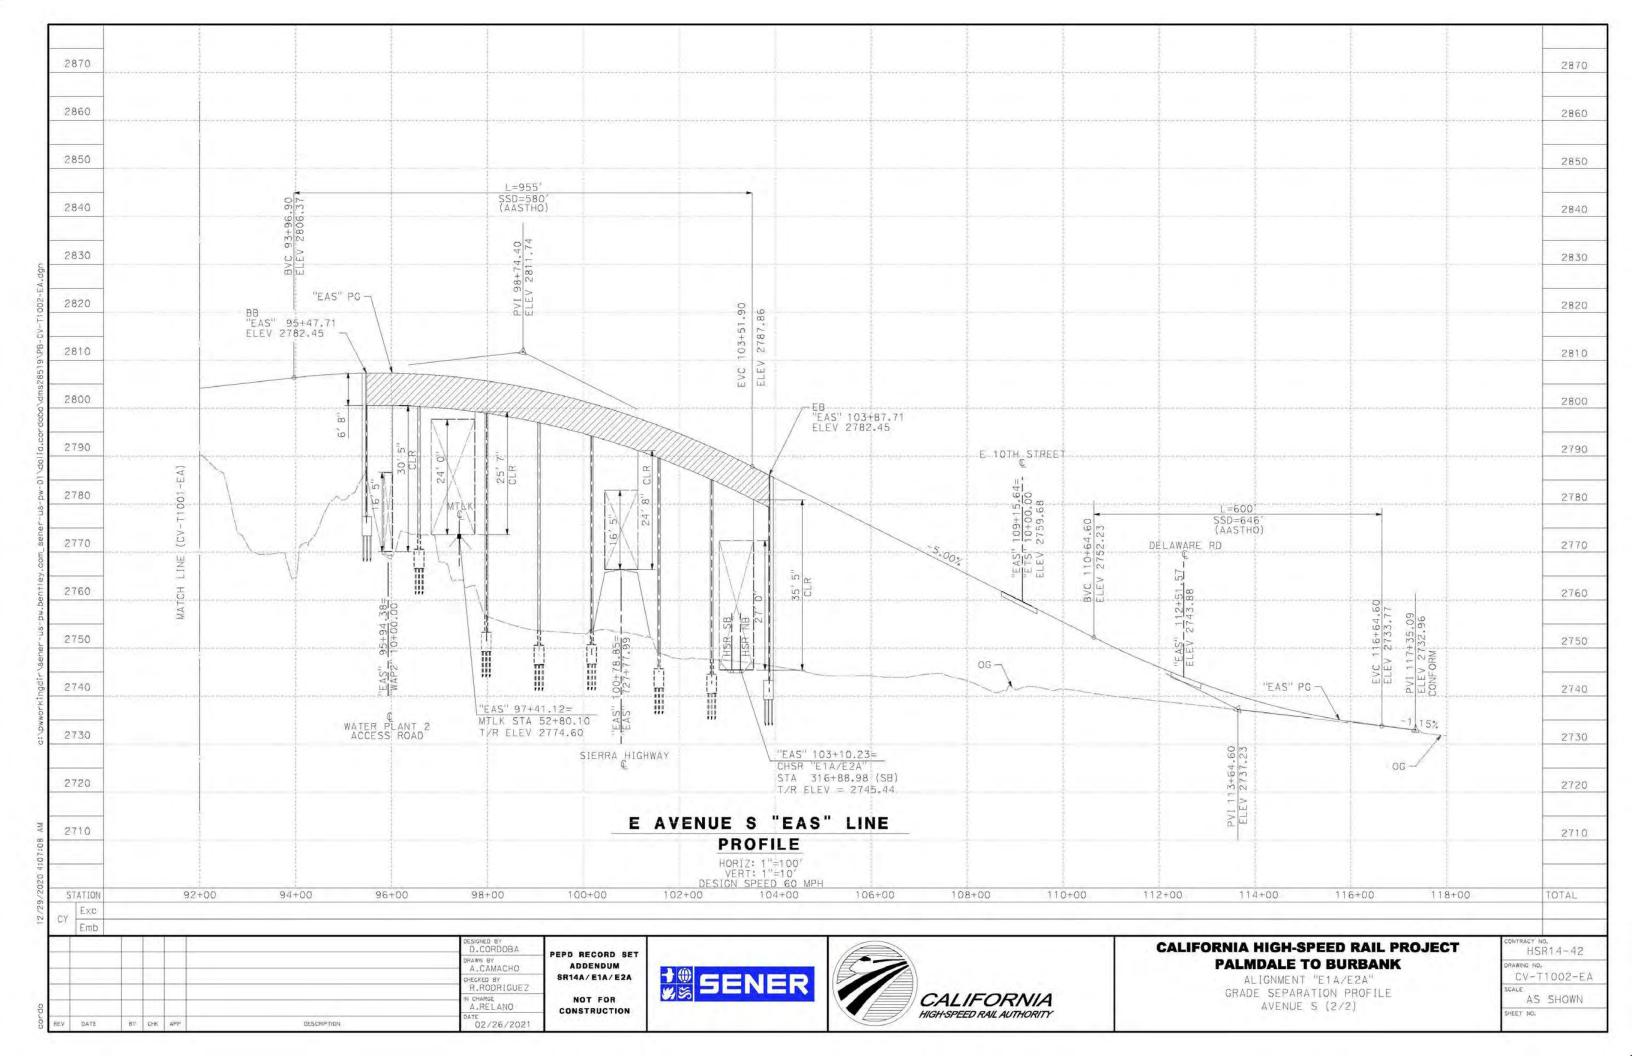


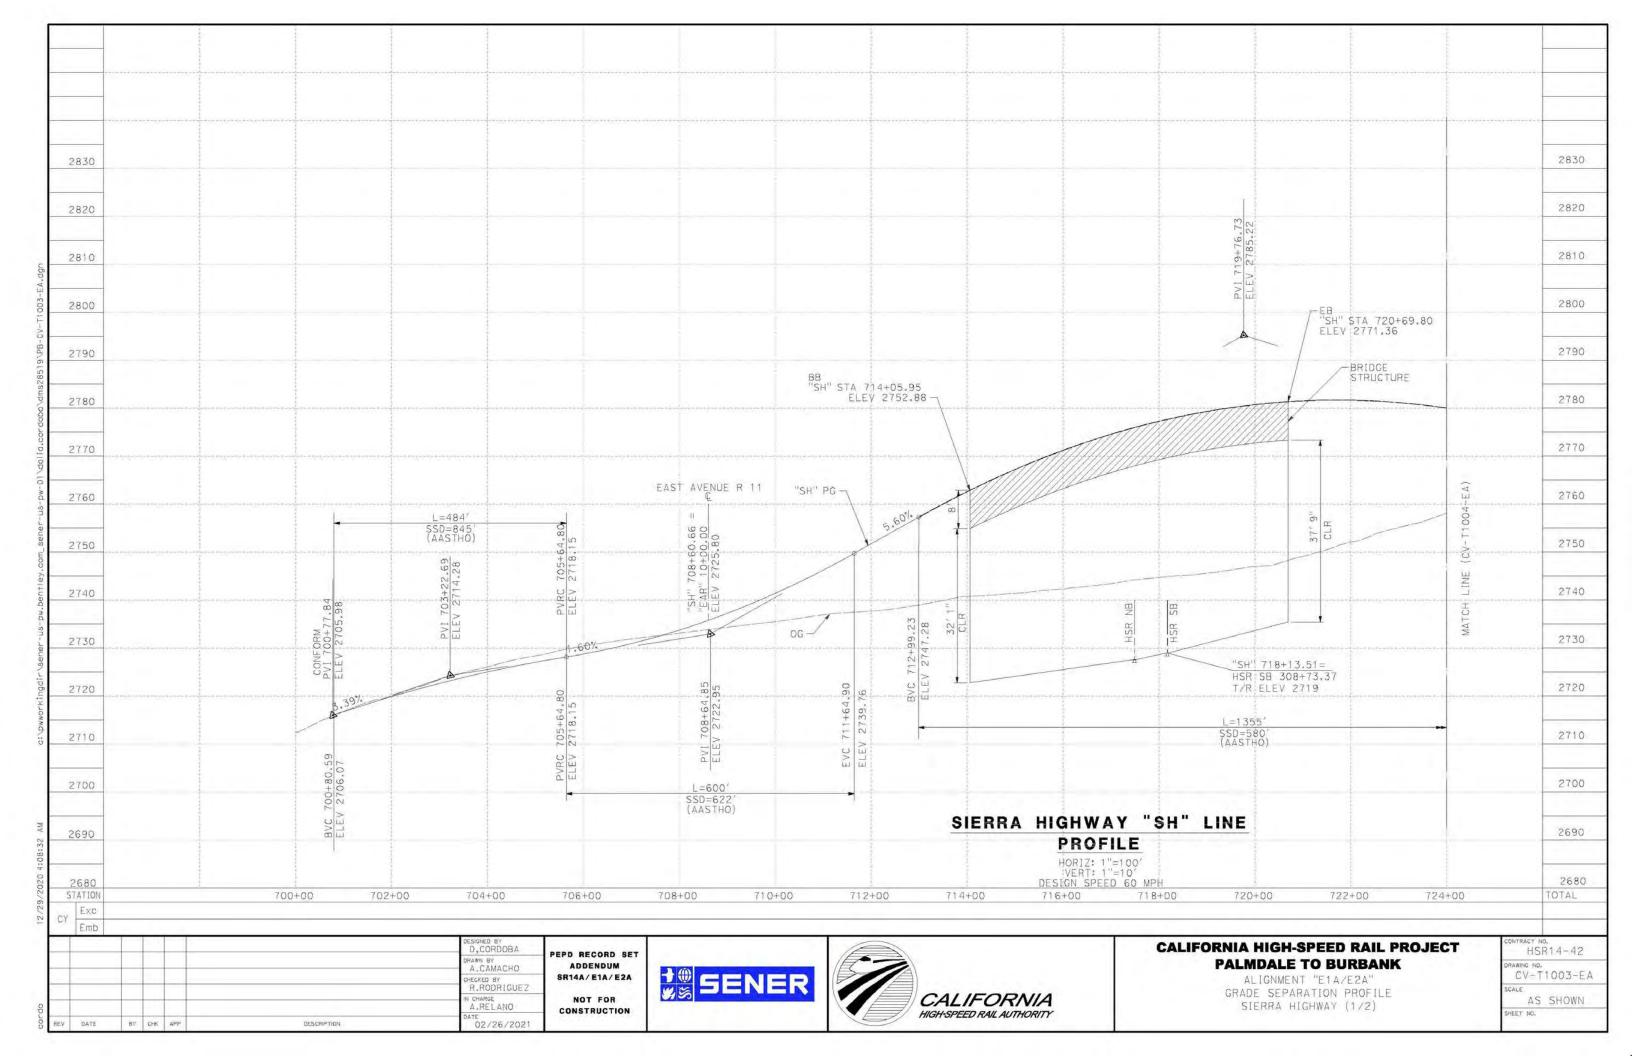

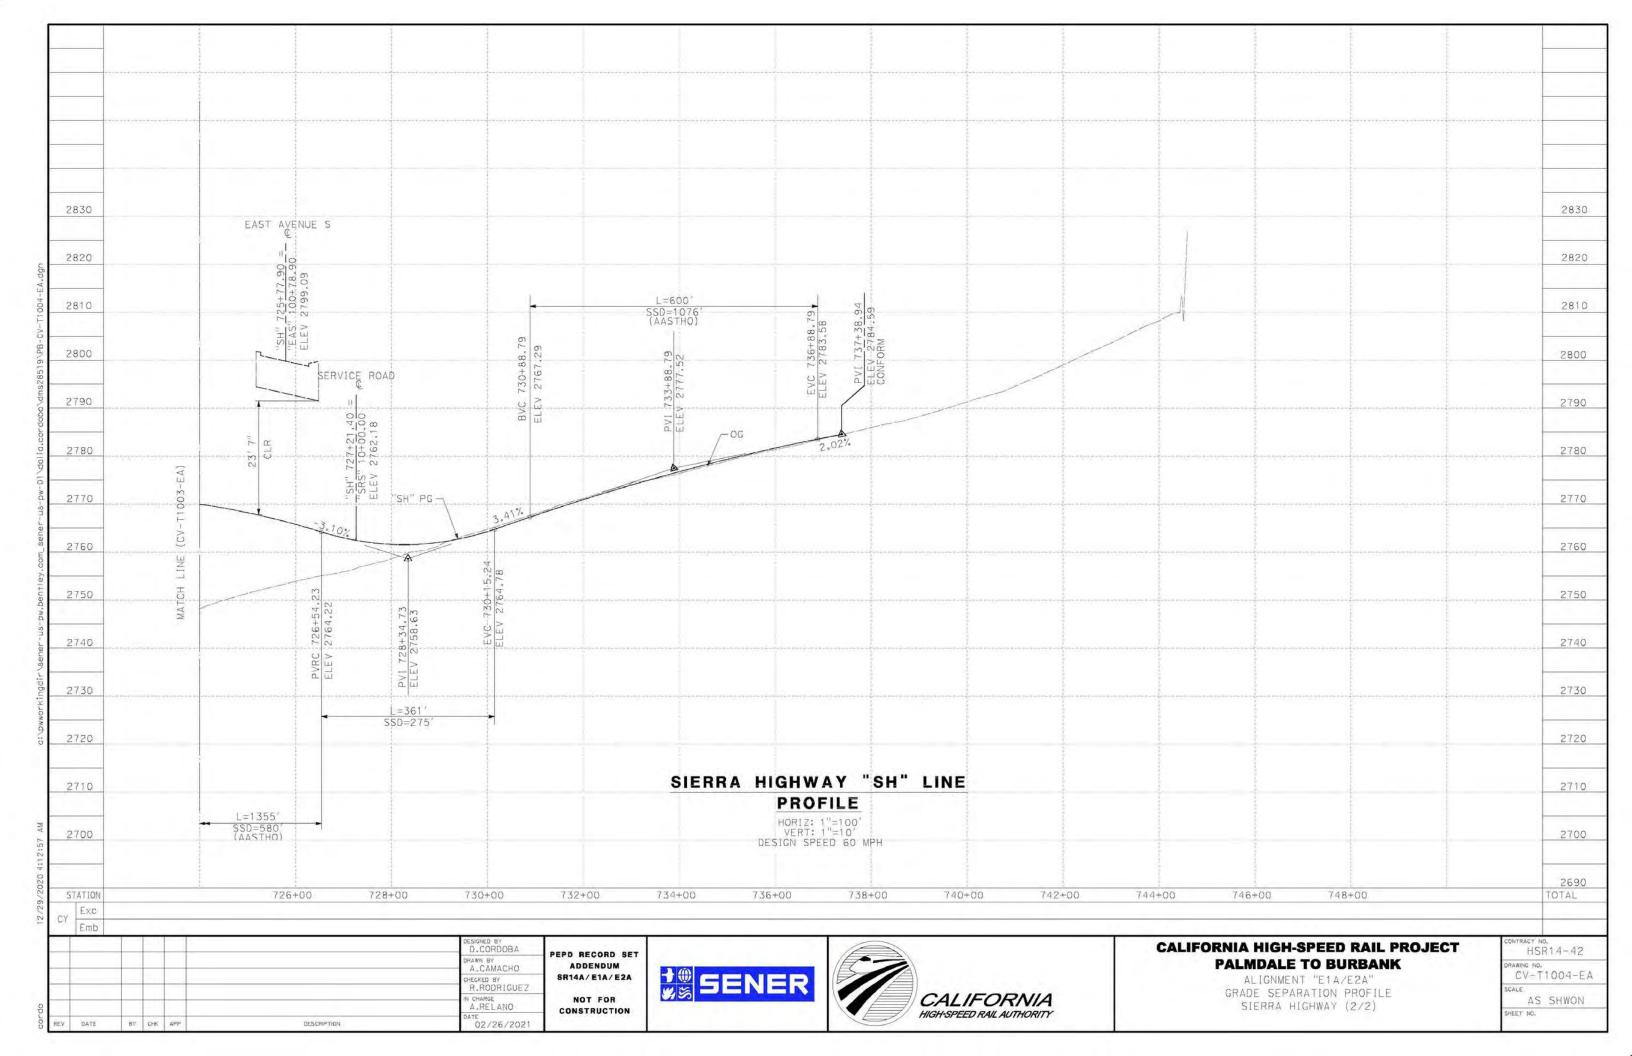


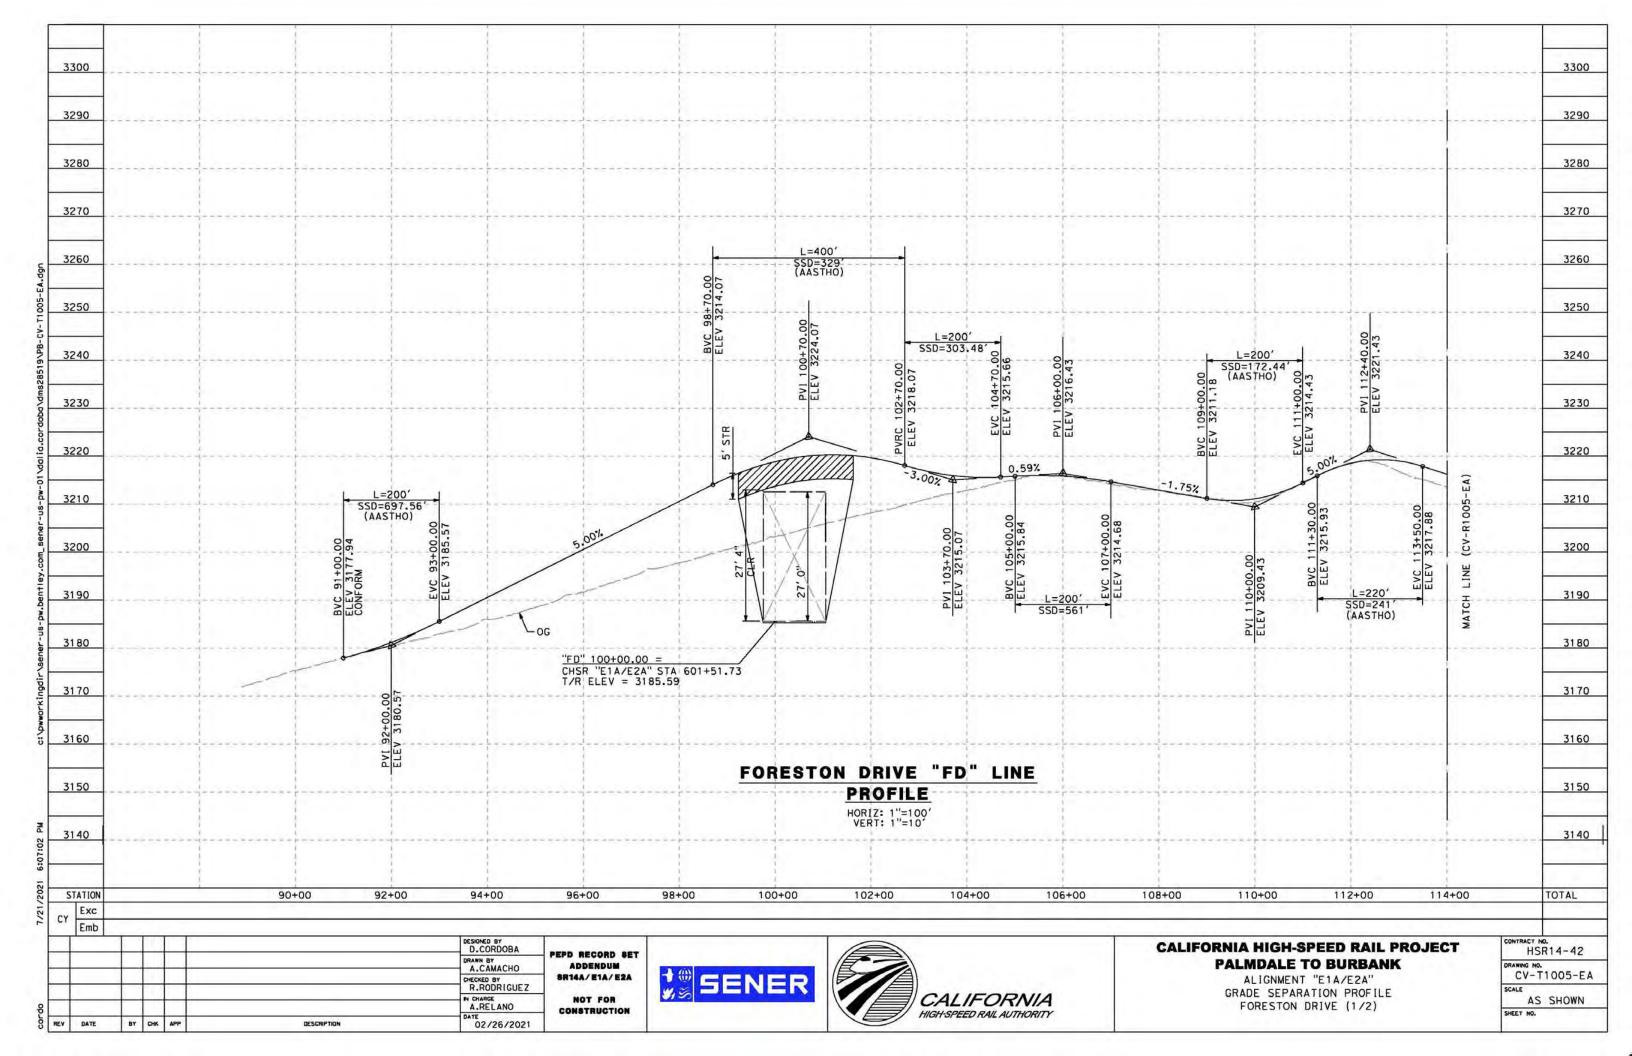

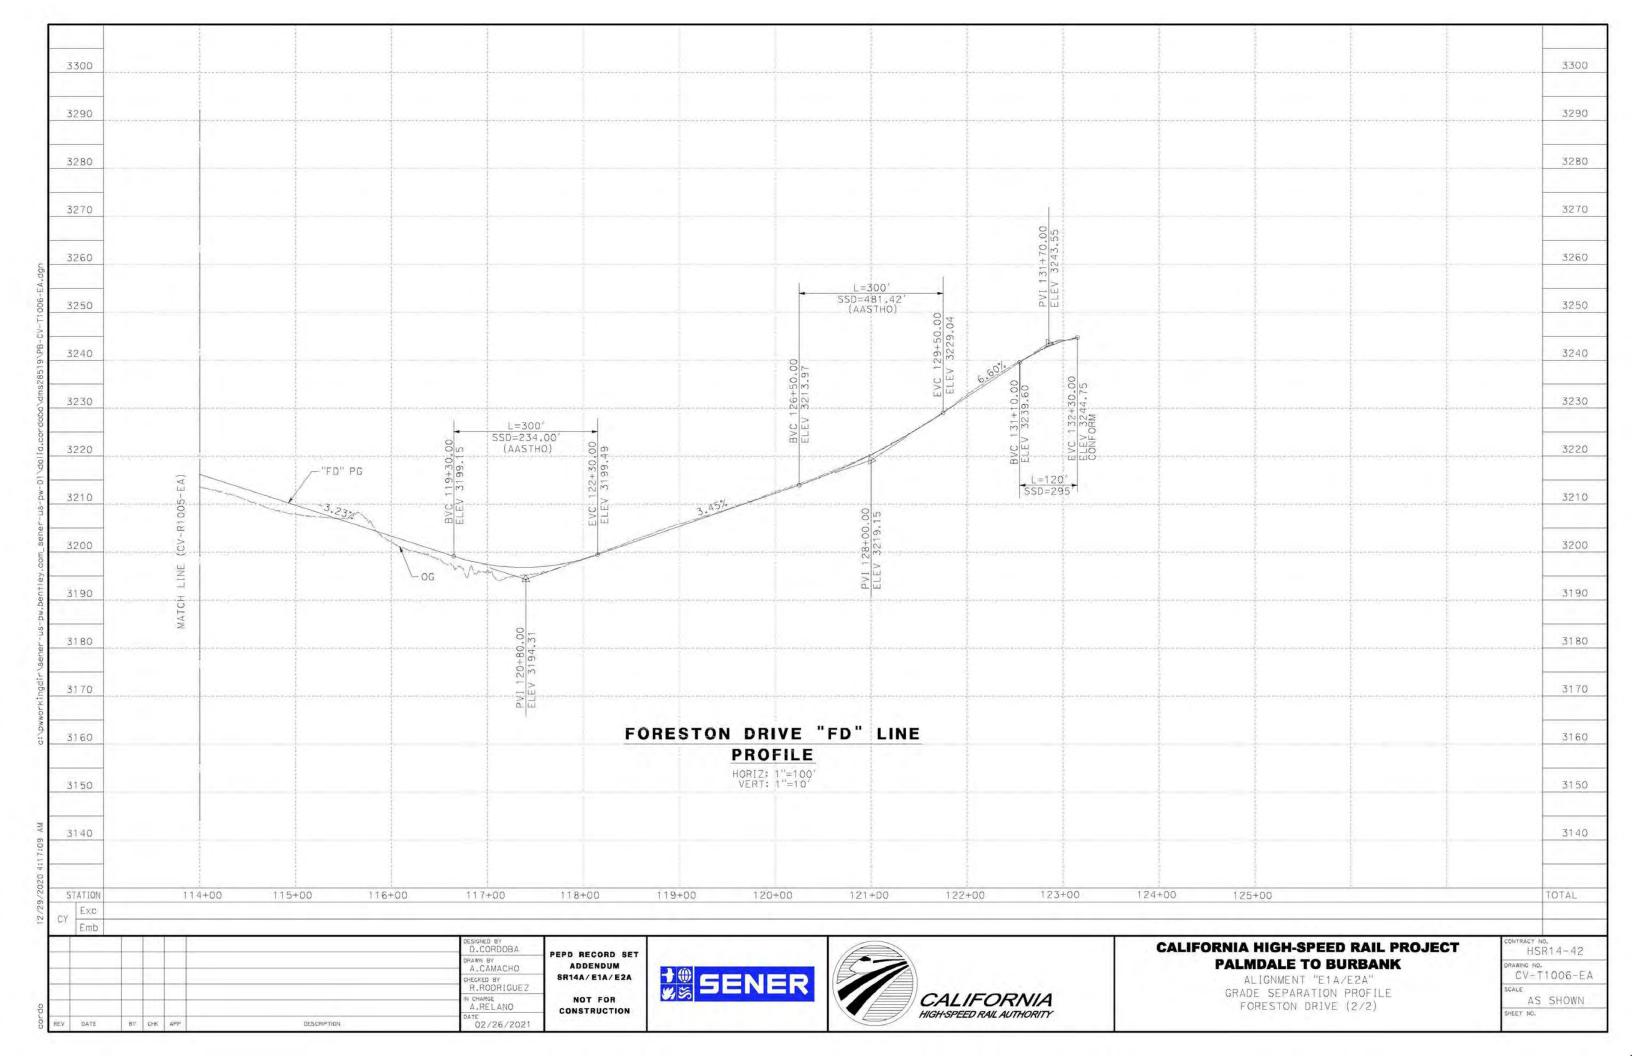

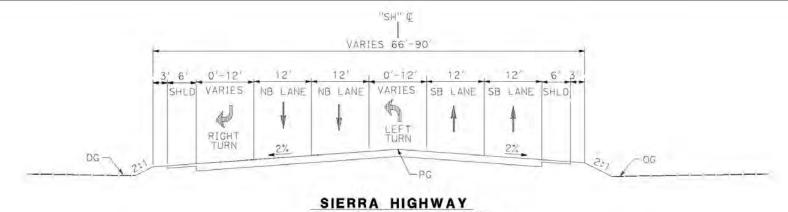


STA 705+22.61 to 707+98.97 PER CITY OF PALMDALE GENERAL PLAN

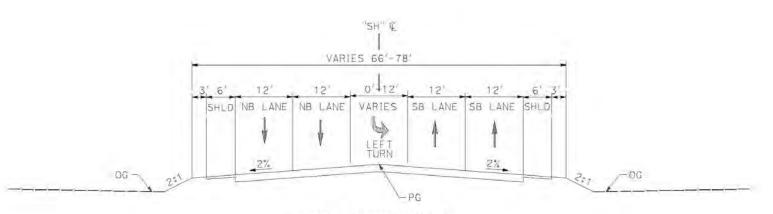

SIERRA HIGHWAY

STA 707+98.97 to 712+07.54 STA 723+76,85 to 736+89,22 PER CITY OF PALMDALE GENERAL PLAN

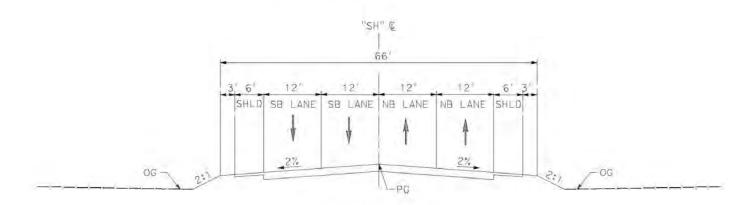

SIERRA HIGHWAY

STA 712+07.54 to 714+93.94 (BEG BRIDGE) STA 720+69.80 (END BRIDGE) TO 723+76.85 PER CITY OF PALMDALE GENERAL PLAN

						D_CORDOBA	P
						A.CAMACHO	1
-		-				R.RODRIGUEZ	
		+				IN CHARGE A.RELANO	ı
REV	DATE	NB	2005	APP	DESCRIPTION	02/26/2021	

PEPD RECORD SET ADDENDUM SR14A/E1A/E2A NOT FOR CONSTRUCTION






CALIFORNIA HIGH-SPEED RAIL PROJECT PALMDALE TO BURBANK

ALIGNMENT "E1A/E2A" ROADWAY TYPICAL SECTIONS SIERRA HIGHWAY

DRAWING	NO.
CV	-T3001-E

AVENUE S

STA 90+27.08 to 92+75.30 STA 103+77.01 (END BRIDGE) to STA 118+68.90 PER CITY OF PALMDALE GENERAL PLAN

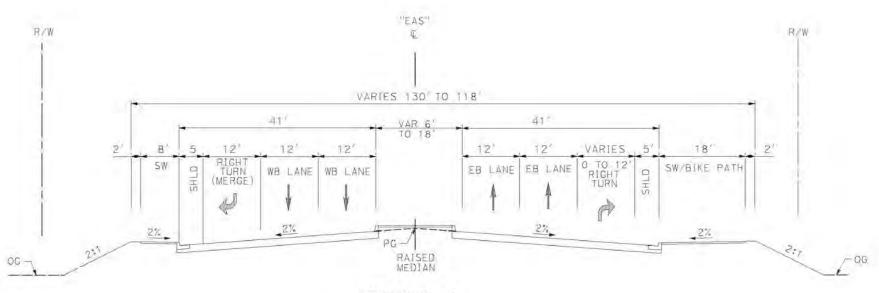

AVENUE S

STA 80+00,00 to 90+27.08 PER CITY OF PALMDALE GENERAL PLAN

			77			D_CORDOBA
-1						A.CAMACHO
-		+				R.RODRIGUEZ
						IN CHARGE A.RELANO
REV	DATE	BW	696	APP	DESCRIPTION	DATE 02/26/2021

PEPD RECORD SET ADDENDUM SR14A/E1A/E2A NOT FOR CONSTRUCTION






CALIFORNIA HIGH-SPEED RAIL PROJECT PALMDALE TO BURBANK

ALIGNMENT "E1A/E2A"
ROADWAY TYPICAL SECTIONS
AVENUE S (1/2)

HSR14-42	
des aute Vie	
DRAWING NO.	
CV-T3002-E	A

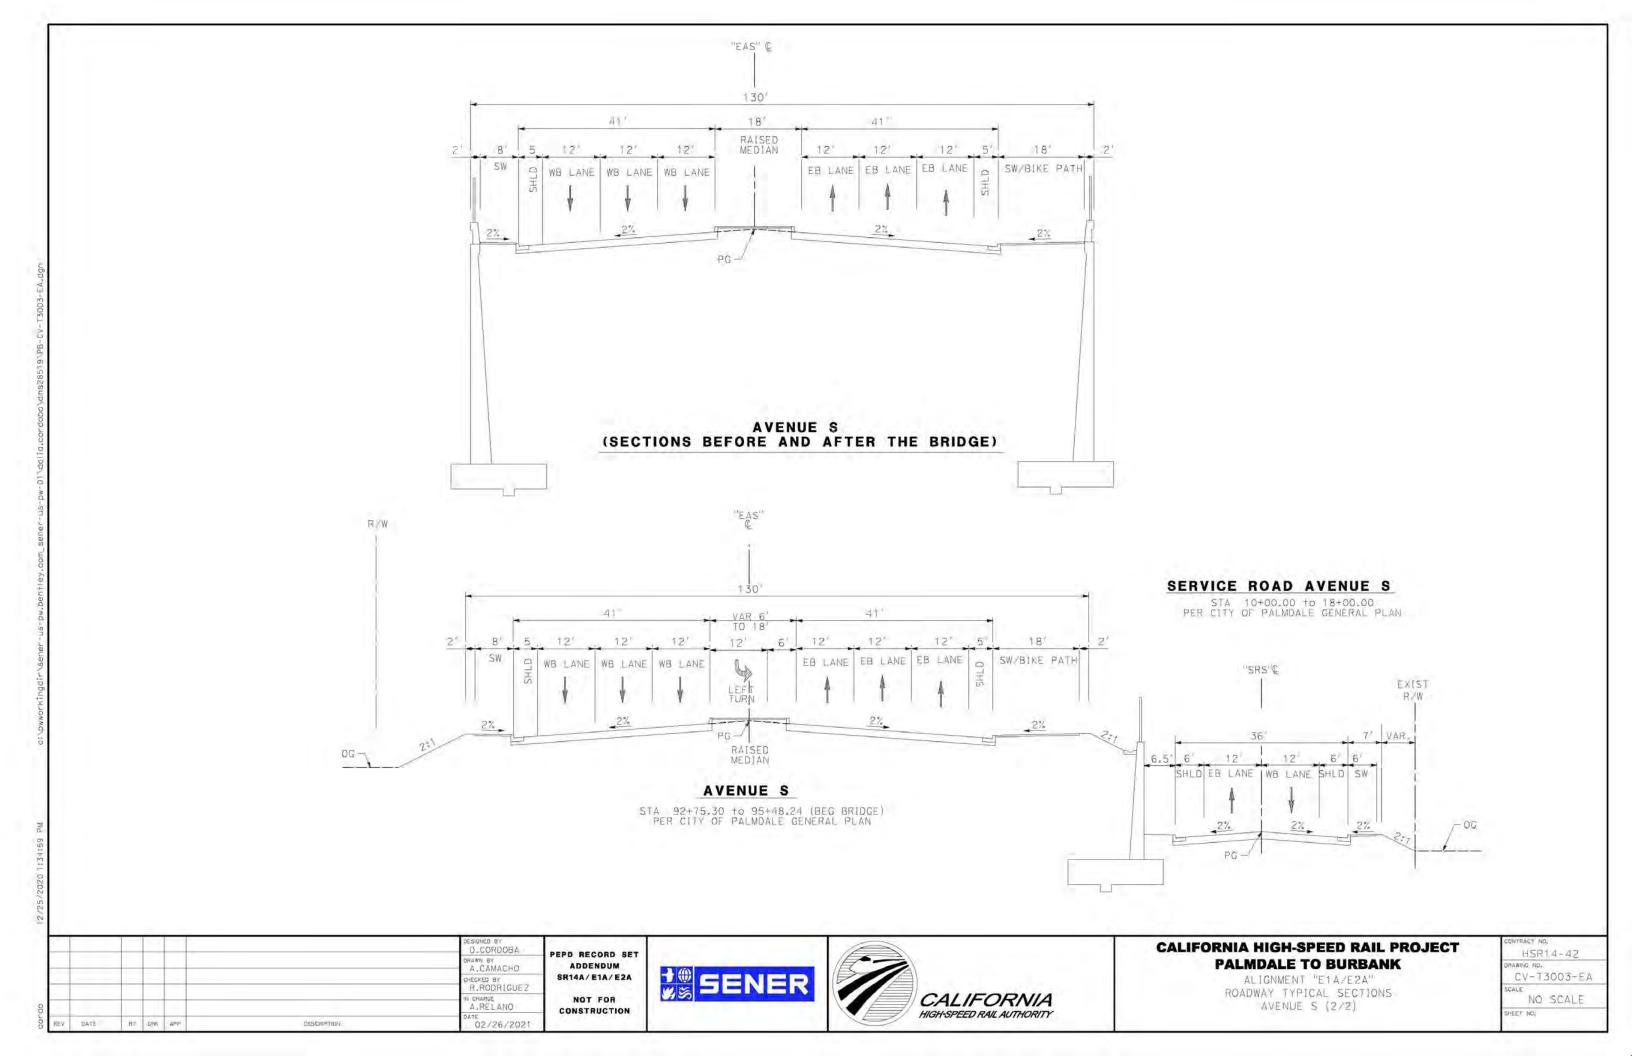




PEPD RECORD SET ADDENDUM SR14A/E1A/E2A NOT FOR

CONSTRUCTION






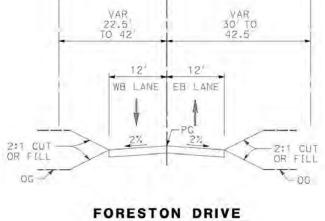

RXW

RXW

STA 105+64 TO STA 132+32 LOCAL ROADWAY PER LOS ANGELES COUNTY MUNICIPAL CODE CHAPTER 21 PARTS 2 AND 3

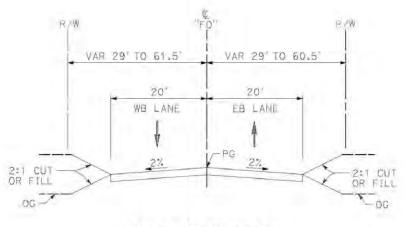


FORESTON DRIVE


STA 91+00 TO STA 105+64 LOCAL ROADWAY PER LOS ANGELES COUNTY MUNICIPAL CODE CHAPTER 21 PARTS 2 AND 3


CALIFORNIA HIGH-SPEED RAIL PROJECT PALMDALE TO BURBANK


ALIGNMENT "E1A/E2A" ROADWAT TYPICAL SECTIONS FORESTON DRIVE


	1SR	14-42
DRAWIN	G NO.	
CI	/-T	3004-FA
L.		3004-EA
SCALE	110	
	NO	SCALE

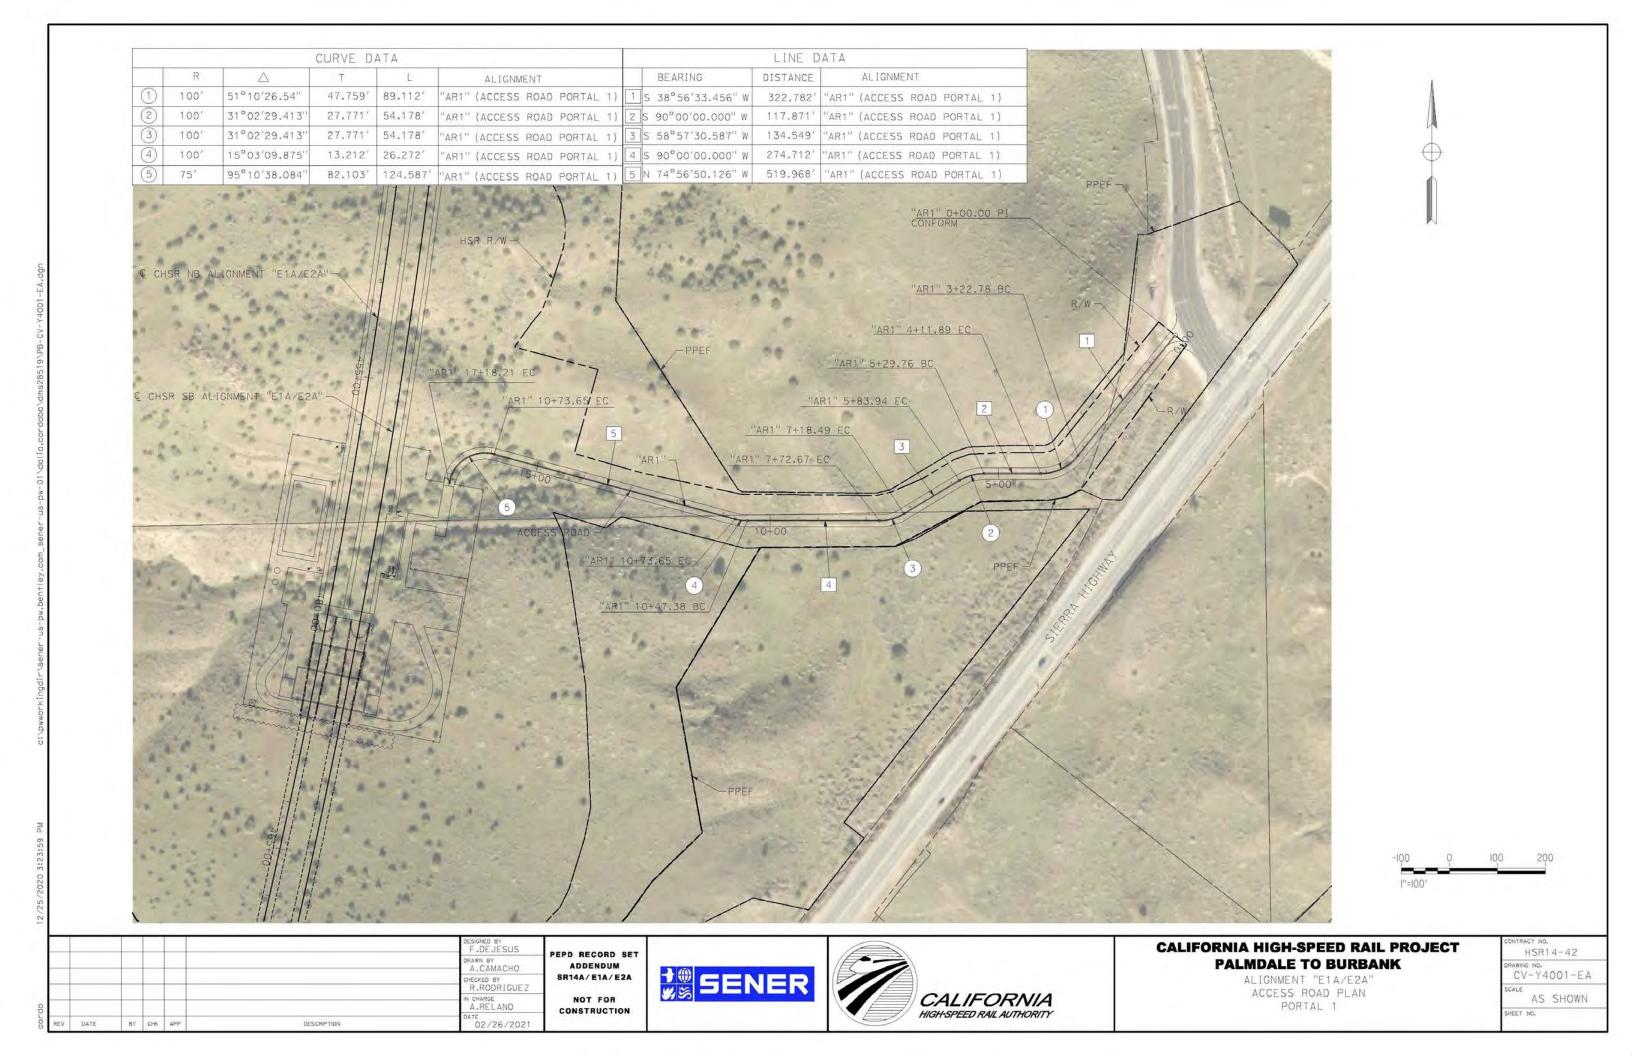

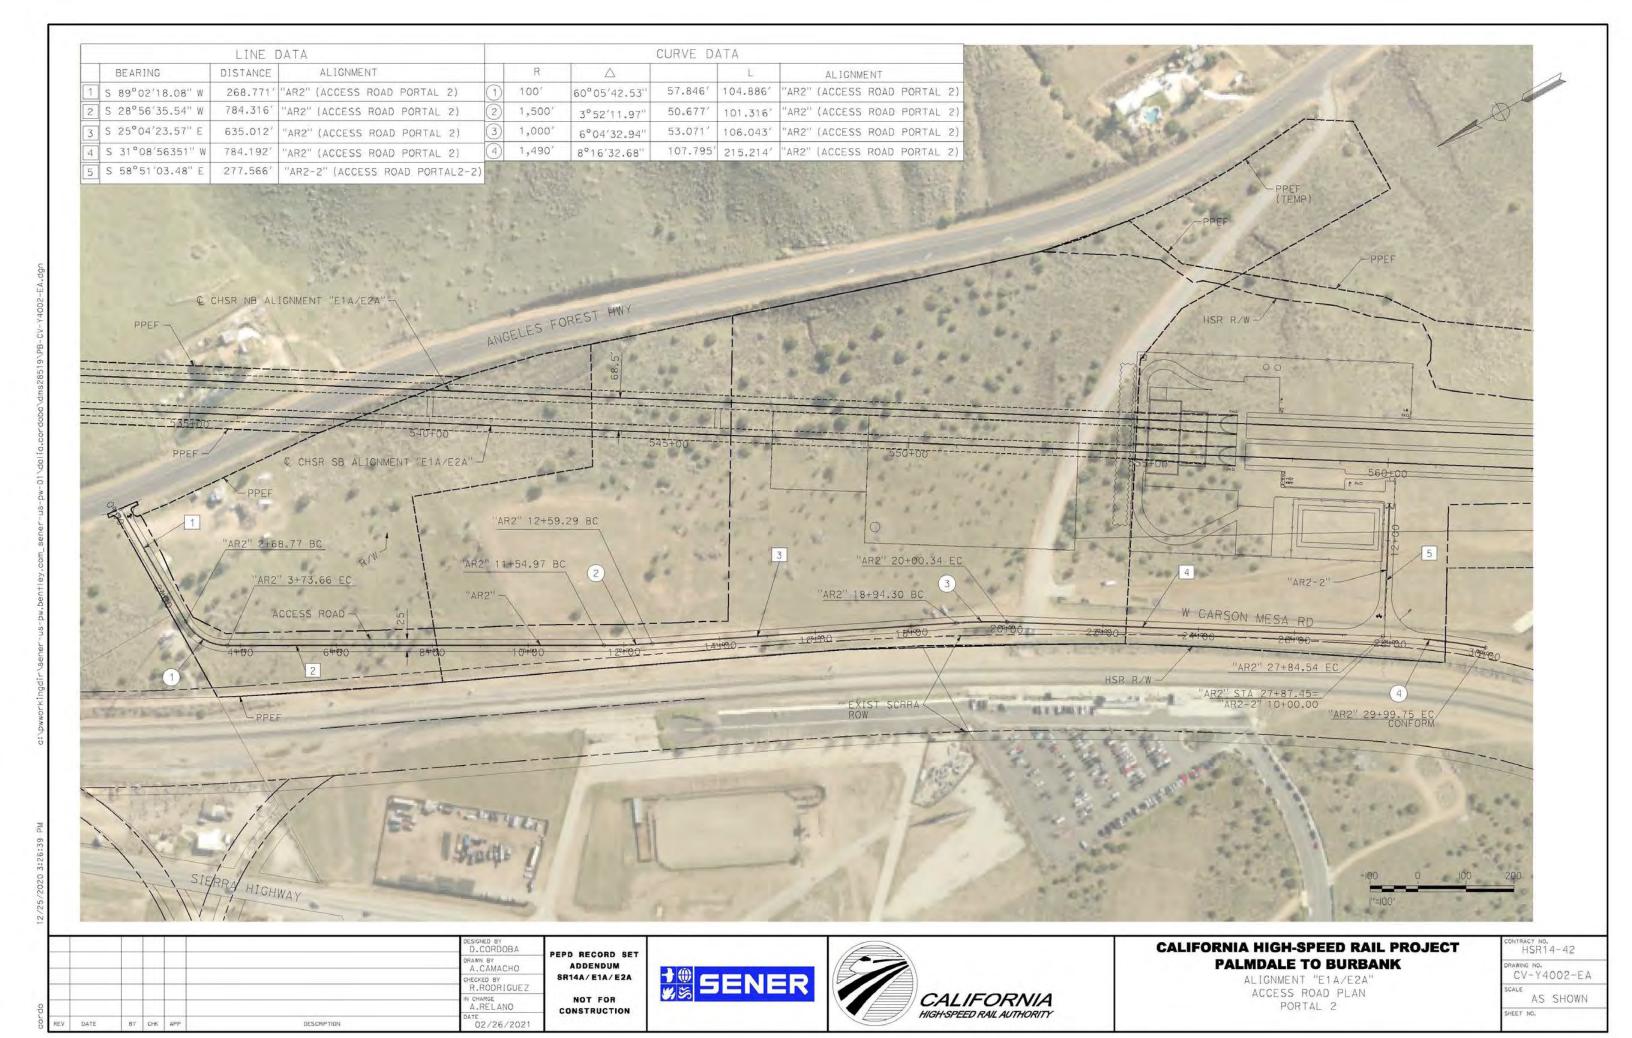

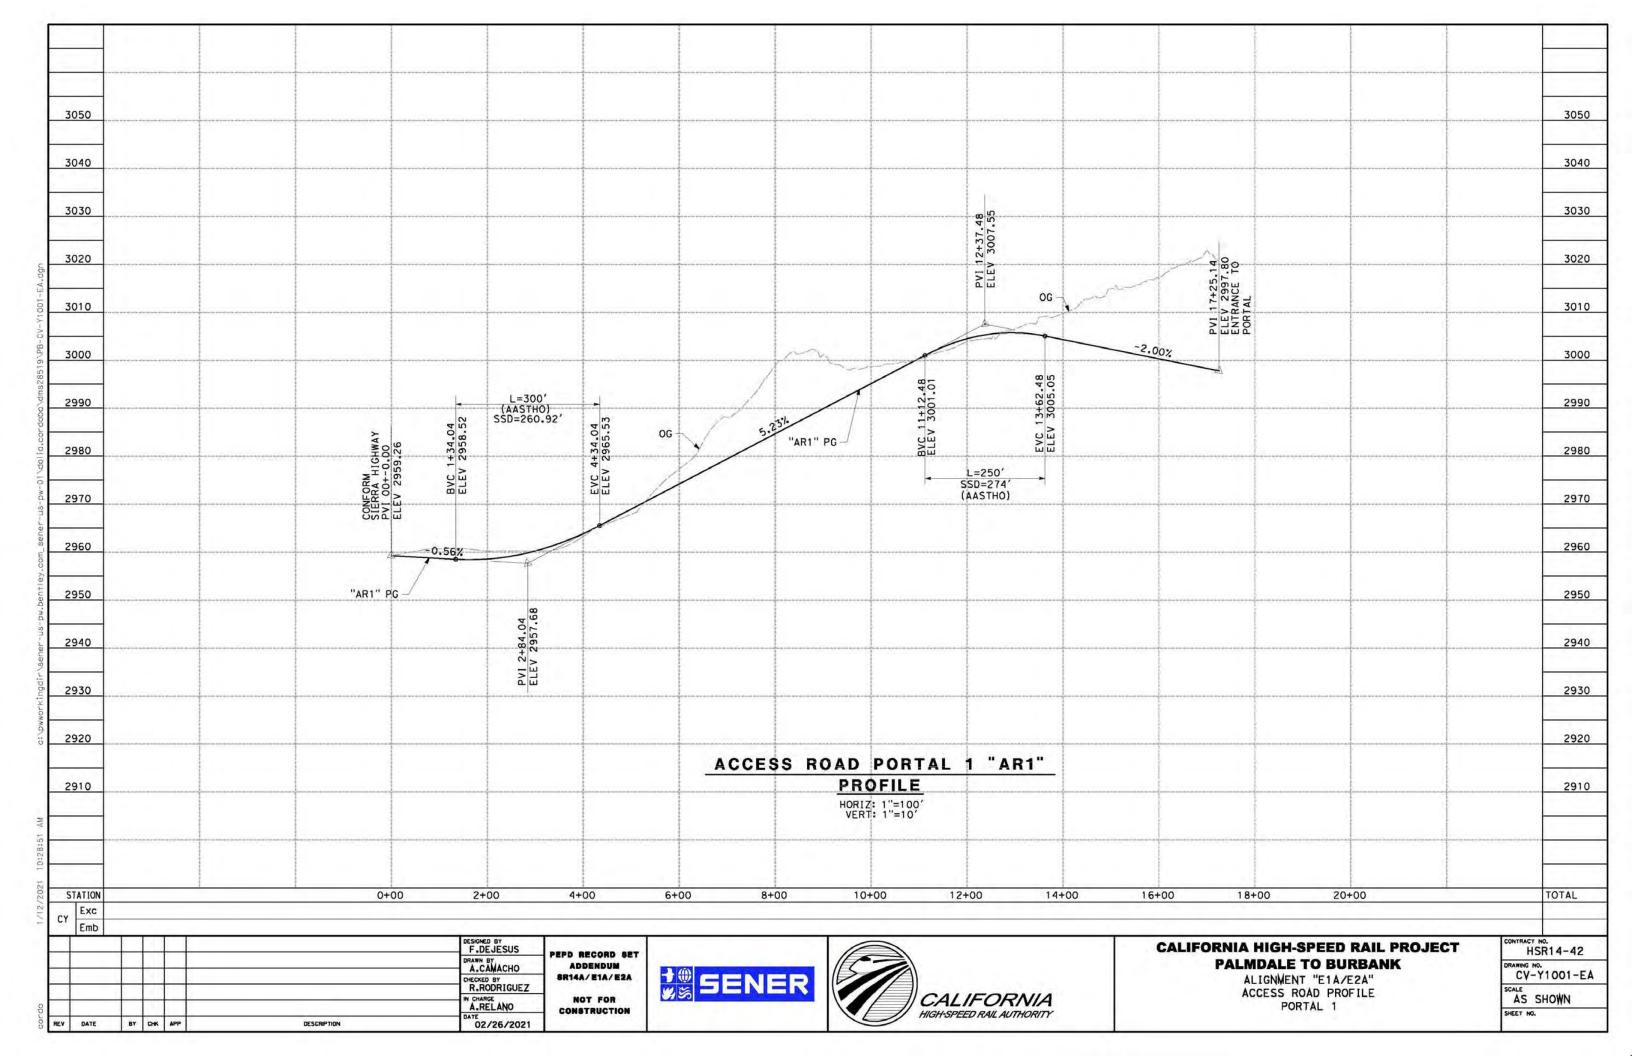

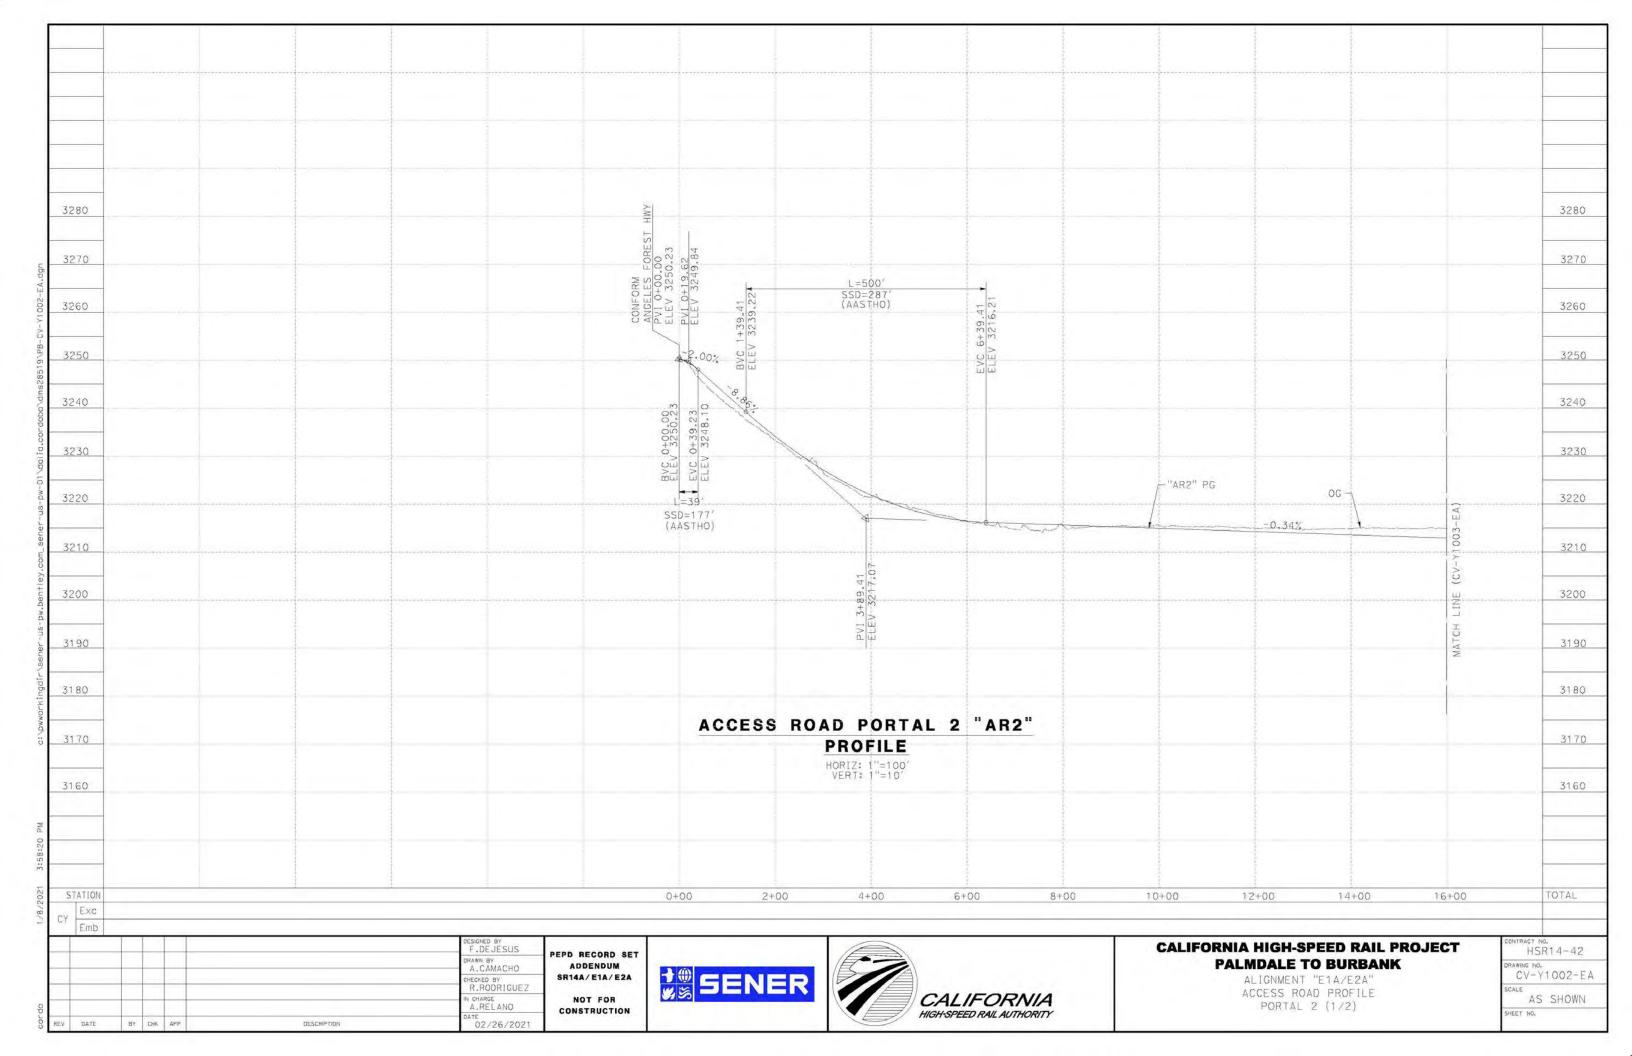

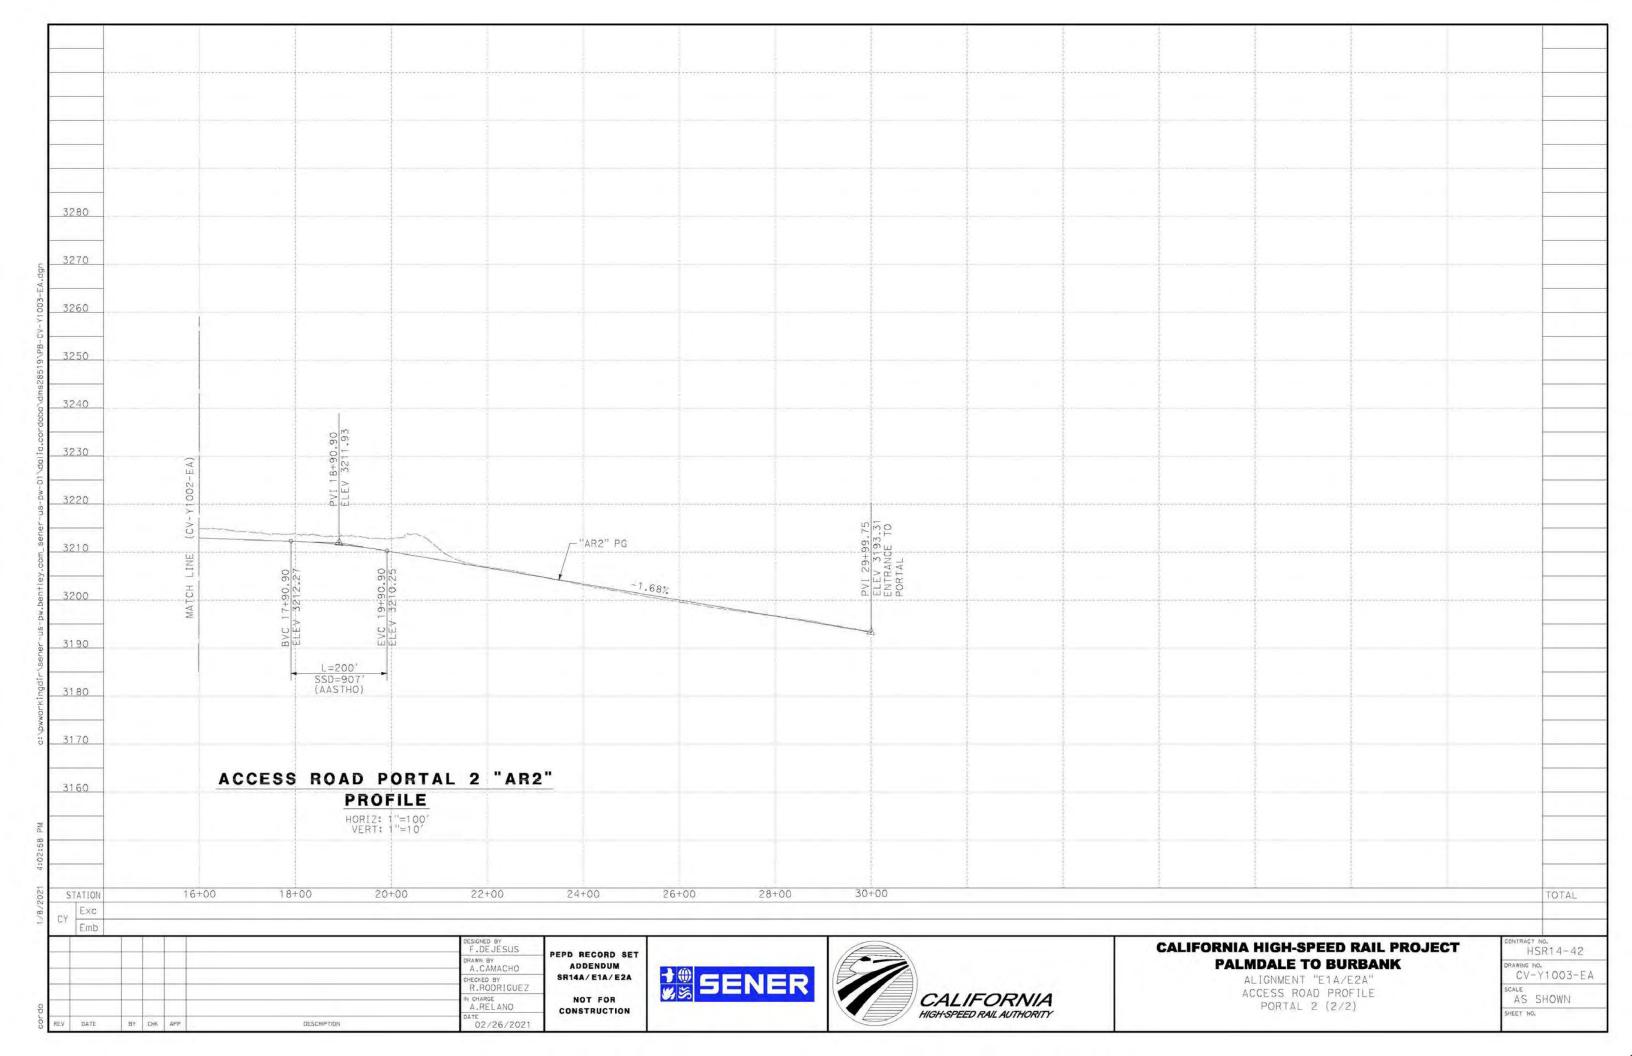



PEPD RECORD SET ADDENDUM SR14A/E1A/E2A NOT FOR

CONSTRUCTION



R/W



CALIFORNIA HIGH-SPEED RAIL PROJECT PALMDALE TO BURBANK

ALIGNMENT "E1A/E2A"
ACCESS ROADS TYPICAL SECTIONS
PORTALS E1A/E2A

	HSR14-42
	DRAWING NO.
	CV-Y3001-E
	SCALE NO COALE

NO SCALE

PORTAL 1
STA 0+00.00 TO STA 17+25.14 (ACCESS ROAD PORTAL 1)
PORTAL 2
STA 0+00.00 TO STA 29+99.75 (ACCESS ROAD PORTAL 2)

12.5" 12.5" MB LANE SB LANE