


# Merced to Fresno Section: Central Valley Wye

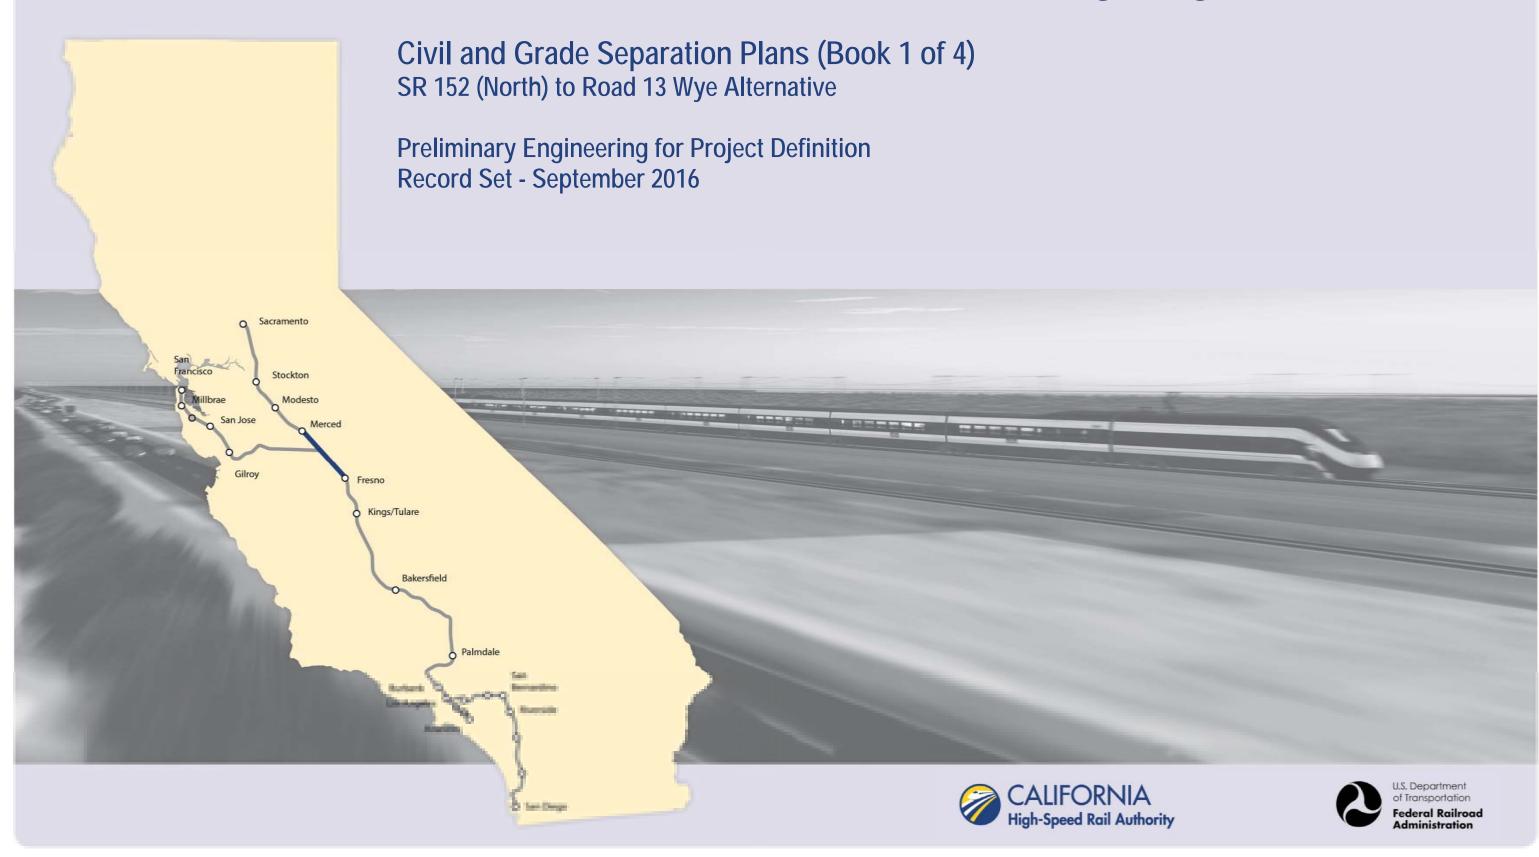

								DRAWN W. CHECK J.	JOHNSEN  KED BY  RAY	
								DRAWN W.	JOHNSEN	
								DRAWN	<sup>N BY</sup> JOHNSEN	
								_ <u> </u>	WELLS	
									NED BY WELLS	
			CV-B0081-A	CENTRAL VAL	LEY W	YYE	SR	152	(NORTH)	TC
		-	CV-B0080-A	CENTRAL VAL					(NORTH)	
		(	CV-B0073-A	CENTRAL VAL	LEY W	VYE	SR	152	(NORTH)	ТС
		(	CV-B0072-A	CENTRAL VAL	LEY W	VYE	SR	152	(NORTH)	ТС
		(	CV-B0071-A	CENTRAL VAL	LEY W	VYE	SR	152	(NORTH)	ТС
			CV-B0070-A	CENTRAL VAL	LEY W	VYE	SR	152	(NORTH)	ТС





### CALIFORNIA HIGH-SPEED TRAIN PROJECT MERCED TO FRESNO SECTION

CENTRAL VALLEY WYE
CIVIL AND GRADE SEPARATION PLANS
INDEX OF DRAWINGS
SHEET 1 OF 17

HSRO8-05	
DRAWING NO. CV-B0002	
NO SCALE	
SHEET NO.	

		I	NDEX OF DRAWINGS	
DRAWING NO.	SECTION	ALIGNMENT / PLAN SET	TITLE	DESCRIPTION
			GENERAL	
CV-B0001	CENTRAL VALLEY WYE	CIVIL AND GRADE SEPARATION PLANS	COVER	
CV-B0002	CENTRAL VALLEY WYE	CIVIL AND GRADE SEPARATION PLANS	INDEX OF DRAWINGS	SHEET 1 OF 17
CV-B0003	CENTRAL VALLEY WYE	CIVIL AND GRADE SEPARATION PLANS	INDEX OF DRAWINGS	SHEET 2 OF 17
CV-B0004	CENTRAL VALLEY WYE	CIVIL AND GRADE SEPARATION PLANS	INDEX OF DRAWINGS	SHEET 3 OF 17
CV-B0005	CENTRAL VALLEY WYE	CIVIL AND GRADE SEPARATION PLANS	INDEX OF DRAWINGS	SHEET 4 OF 17
CV-B0006	CENTRAL VALLEY WYE	CIVIL AND GRADE SEPARATION PLANS	INDEX OF DRAWINGS	SHEET 5 OF 17
CV-B0007	CENTRAL VALLEY WYE	CIVIL AND GRADE SEPARATION PLANS	INDEX OF DRAWINGS	SHEET 6 OF 17
CV-B0008	CENTRAL VALLEY WYE	CIVIL AND GRADE SEPARATION PLANS	INDEX OF DRAWINGS	SHEET 7 OF 17
CV-B0009	CENTRAL VALLEY WYE	CIVIL AND GRADE SEPARATION PLANS	INDEX OF DRAWINGS	SHEET 8 OF 17
CV-B0010	CENTRAL VALLEY WYE	CIVIL AND GRADE SEPARATION PLANS	INDEX OF DRAWINGS	SHEET 9 OF 17
CV-B0011	CENTRAL VALLEY WYE	CIVIL AND GRADE SEPARATION PLANS	INDEX OF DRAWINGS	SHEET 10 OF 17
CV-B0012	CENTRAL VALLEY WYE	CIVIL AND GRADE SEPARATION PLANS	INDEX OF DRAWINGS	SHEET 11 OF 17
CV-B0013	CENTRAL VALLEY WYE	CIVIL AND GRADE SEPARATION PLANS	INDEX OF DRAWINGS	SHEET 12 OF 17
CV-B0014	CENTRAL VALLEY WYE	CIVIL AND GRADE SEPARATION PLANS	INDEX OF DRAWINGS	SHEET 13 OF 17
CV-B0015	CENTRAL VALLEY WYE	CIVIL AND GRADE SEPARATION PLANS	INDEX OF DRAWINGS	SHEET 14 OF 17
CV-B0016	CENTRAL VALLEY WYE	CIVIL AND GRADE SEPARATION PLANS	INDEX OF DRAWINGS	SHEET 15 OF 17
CV-B0017	CENTRAL VALLEY WYE	CIVIL AND GRADE SEPARATION PLANS	INDEX OF DRAWINGS	SHEET 16 OF 17
CV-B0018	CENTRAL VALLEY WYE	CIVIL AND GRADE SEPARATION PLANS	INDEX OF DRAWINGS	SHEET 17 OF 17
CV-B0020	CENTRAL VALLEY WYE	CIVIL AND GRADE SEPARATION PLANS	ABBREVIATIONS	SHEET 1 OF 2
CV-B0021	CENTRAL VALLEY WYE	CIVIL AND GRADE SEPARATION PLANS	ABBREVIATIONS	SHEET 2 OF 2
CV-B4000	CENTRAL VALLEY WYE	CIVIL AND GRADE SEPARATION PLANS	LOCATION PLAN	
CV-B0030	CENTRAL VALLEY WYE	CIVIL AND GRADE SEPARATION PLANS	GENERAL NOTES	
	I.	SR 152 (NORTH	) TO ROAD 13 WYE ALTERNATIVE	
CV-B4050-A	CENTRAL VALLEY WYE	SR 152 (NORTH) TO ROAD 13 WYE ALTERNATIVE	KEY MAP	SHEET 1 OF 4
CV-B4051-A	CENTRAL VALLEY WYE	SR 152 (NORTH) TO ROAD 13 WYE ALTERNATIVE	KEY MAP	SHEET 2 OF 4
CV-B4052-A	CENTRAL VALLEY WYE	SR 152 (NORTH) TO ROAD 13 WYE ALTERNATIVE	KEY MAP	SHEET 3 OF 4
CV-B4053-A	CENTRAL VALLEY WYE	SR 152 (NORTH) TO ROAD 13 WYE ALTERNATIVE	KEY MAP	SHEET 4 OF 4
CV-B0060-A	CENTRAL VALLEY WYE	SR 152 (NORTH) TO ROAD 13 WYE ALTERNATIVE	GEOMETRY DATA TABLE	SHEET 1 OF 6
CV-B0061-A	CENTRAL VALLEY WYE	SR 152 (NORTH) TO ROAD 13 WYE ALTERNATIVE	GEOMETRY DATA TABLE	SHEET 2 OF 6
CV-B0062-A	CENTRAL VALLEY WYE	SR 152 (NORTH) TO ROAD 13 WYE ALTERNATIVE	GEOMETRY DATA TABLE	SHEET 3 OF 6
CV-B0063-A	CENTRAL VALLEY WYE	SR 152 (NORTH) TO ROAD 13 WYE ALTERNATIVE	GEOMETRY DATA TABLE	SHEET 4 OF 6
CV-B0064-A	CENTRAL VALLEY WYE	SR 152 (NORTH) TO ROAD 13 WYE ALTERNATIVE	GEOMETRY DATA TABLE	SHEET 5 OF 6
CV-B0065-A	CENTRAL VALLEY WYE	SR 152 (NORTH) TO ROAD 13 WYE ALTERNATIVE	GEOMETRY DATA TABLE	SHEET 6 OF 6
CV-B0070-A	CENTRAL VALLEY WYE	SR 152 (NORTH) TO ROAD 13 WYE ALTERNATIVE	UTILITY CONFLICT TABLE	SHEET 1 OF 4
CV-B0071-A	CENTRAL VALLEY WYE	SR 152 (NORTH) TO ROAD 13 WYE ALTERNATIVE	UTILITY CONFLICT TABLE	SHEET 2 OF 4
CV-B0072-A	CENTRAL VALLEY WYE	SR 152 (NORTH) TO ROAD 13 WYE ALTERNATIVE	UTILITY CONFLICT TABLE	SHEET 3 OF 4
CV-B0073-A	CENTRAL VALLEY WYE	SR 152 (NORTH) TO ROAD 13 WYE ALTERNATIVE	UTILITY CONFLICT TABLE	SHEET 4 OF 4
CV-B0080-A	CENTRAL VALLEY WYE	SR 152 (NORTH) TO ROAD 13 WYE ALTERNATIVE	TYPICAL SECTION	SHEET 1 OF 3
CV-B0081-A	CENTRAL VALLEY WYE	SR 152 (NORTH) TO ROAD 13 WYE ALTERNATIVE	TYPICAL SECTION	SHEET 2 OF 3

RECORD SET
15% DESIGN
SUBMITTAL
NOT FOR
CONSTRUCTION





# CALIFORNIA HIGH-SPEED TRAIN PROJECT MERCED TO FRESNO SECTION

CENTRAL VALLEY WYE
CIVIL AND GRADE SEPARATION PLANS
INDEX OF DRAWINGS
SHEET 2 OF 17

CONTRACT NO. HSR08-05
DRAWING NO. CV-B0003
NO SCALE
SHEET NO.

| DESIGNED BY | S. WELLS | DRAWN BY | W. JOHNSEN | CHECKED BY | J. RAY | IN CHARGE | C. LEMLEY | DATE | BY CHK APP | DESCRIPTION | DATE | D9/09/2016

RECORD SET
15% DESIGN
SUBMITTAL
NOT FOR
CONSTRUCTION





# CALIFORNIA HIGH-SPEED TRAIN PROJECT MERCED TO FRESNO SECTION

CENTRAL VALLEY WYE
CIVIL AND GRADE SEPARATION PLANS
INDEX OF DRAWINGS
SHEET 3 OF 17

HSR08-05	
DRAWING NO. CV-BOOO4	
NO SCALE	
SHEET NO.	

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RECORD SET
15% DESIGN
SUBMITTAL
NOT FOR
CONSTRUCTION





# CALIFORNIA HIGH-SPEED TRAIN PROJECT MERCED TO FRESNO SECTION

CENTRAL VALLEY WYE
CIVIL AND GRADE SEPARATION PLANS
INDEX OF DRAWINGS
SHEET 4 OF 17

CONTRACT NO. HSRO8-05
DRAWING NO.
CV-B0005
SCALE
NO SCALE
SHEET NO.

						DESIGNED BY S. WELLS
						DRAWN BY W. JOHNSEN
						CHECKED BY
						J. RAY IN CHARGE
						C. LEMLEY DATE
REV	DATE	BY	СНК	APP	DESCRIPTION	09/09/2016

RECORD SET
15% DESIGN
SUBMITTAL
NOT FOR
CONSTRUCTION





### CALIFORNIA HIGH-SPEED TRAIN PROJECT MERCED TO FRESNO SECTION

CENTRAL VALLEY WYE
CIVIL AND GRADE SEPARATION PLANS
INDEX OF DRAWINGS
SHEET 5 OF 17

CONTRACT NO. HSR08-05
DRAWING NO. CV-B0006
NO SCALE
SHEET NO.

S. WELLS W. JOHNSEN J. RAY C. LEMLEY DATE BY CHK APP DESCRIPTION 09/09/2016

RECORD SET 15% DESIGN SUBMITTAL NOT FOR CONSTRUCTION





#### CALIFORNIA HIGH-SPEED TRAIN PROJECT MERCED TO FRESNO SECTION

CENTRAL VALLEY WYE CIVIL AND GRADE SEPARATION PLANS INDEX OF DRAWINGS SHEET 6 OF 17

CONTRACT NO. HSR08-05
DRAWING NO.
CV-B0007
SCALE
NO SCALE
SHEET NO.

ALIGNMENT / PLAN SET

SR 152 (NORTH) TO ROAD 19 WYE ALTERNATIVE

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BY CHK APP

DESCRIPTION

DRAWING NO.

CV-S1191-B

CV-S1200-B

CV-S1210-B

CV-S1220-B

CV-S1230-B

SECTION

CENTRAL VALLEY WYE

CENTRAL VALLEY WYE

CENTRAL VALLEY WYF

CENTRAL VALLEY WYE

CENTRAL VALLEY WYE

NOT FOR

C. LEMLEY

09/09/2016



INDEX OF DRAWINGS

TITLE

CIVIL PLAN

CIVIL PLAN

CIVIL PLAN

CIVIL PLAN

CIVIL PLAN



#### CALIFORNIA HIGH-SPEED TRAIN PROJECT MERCED TO FRESNO SECTION

DESCRIPTION

SJD-FRE ACCESS ROAD

SJD-FRE STA 6402+00 TO 6458+00

SJD-FRE STA 6458+00 TO 6514+00

SJD-FRE STA 6514+00 TO 6570+00

SJD-FRE STA 6570+00 TO 6626+00

CENTRAL VALLEY WYE CIVIL AND GRADE SEPARATION PLANS INDEX OF DRAWINGS SHEET 7 OF 17

CONTRACT NO.	
HSR08-05	
DRAWING NO.	
CV-B0008	
SCALE	
NO SCALE	
SHEET NO.	

CONSTRUCTION

S. WELLS W. JOHNSEN J. RAY C. LEMLEY DATE BY CHK APP DESCRIPTION 09/09/2016

RECORD SET 15% DESIGN SUBMITTAL NOT FOR





#### CALIFORNIA HIGH-SPEED TRAIN PROJECT MERCED TO FRESNO SECTION

CENTRAL VALLEY WYE CIVIL AND GRADE SEPARATION PLANS INDEX OF DRAWINGS SHEET 8 OF 17

CONTRACT NO. HSR08-05
DRAWING NO.
CV-B0009
SCALE
NO SCALE
SHEET NO.

CONSTRUCTION

RECORD SET
15% DESIGN
SUBMITTAL
NOT FOR
CONSTRUCTION





# CALIFORNIA HIGH-SPEED TRAIN PROJECT MERCED TO FRESNO SECTION

CENTRAL VALLEY WYE
CIVIL AND GRADE SEPARATION PLANS
INDEX OF DRAWINGS
SHEET 9 OF 17

	HSR08-05
	DRAWING NO. CV-B0010
	NO SCALE
ı	SHEET NO.

RECORD SET
15% DESIGN
SUBMITTAL
NOT FOR
CONSTRUCTION





### CALIFORNIA HIGH-SPEED TRAIN PROJECT MERCED TO FRESNO SECTION

CENTRAL VALLEY WYE
CIVIL AND GRADE SEPARATION PLANS
INDEX OF DRAWINGS
SHEET 10 OF 17

RECORD SET
15% DESIGN
SUBMITTAL
NOT FOR
CONSTRUCTION





# CALIFORNIA HIGH-SPEED TRAIN PROJECT MERCED TO FRESNO SECTION

CENTRAL VALLEY WYE
CIVIL AND GRADE SEPARATION PLANS
INDEX OF DRAWINGS
SHEET 11 OF 17

HSR08-05	
DRAWING NO. CV-B0012	
NO SCALE	
SHEET NO.	

S. WELLS W. JOHNSEN J. RAY C. LEMLEY DATE BY CHK APP DESCRIPTION 09/09/2016

RECORD SET 15% DESIGN SUBMITTAL NOT FOR CONSTRUCTION





#### CALIFORNIA HIGH-SPEED TRAIN PROJECT MERCED TO FRESNO SECTION

CENTRAL VALLEY WYE CIVIL AND GRADE SEPARATION PLANS INDEX OF DRAWINGS SHEET 12 OF 17

CONTRACT NO. HSRO8-05	
DRAWING NO. CV-B0013	
NO SCALE	
SHEET NO.	

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-90							DESIGNED BY	Γ
							DRAWN BY W. JOHNSEN	ĺ
							CHECKED BY	ĺ
11							J. RAY IN CHARGE	ı
218							C. LEMLEY	١
p0021	REV	DATE	BY	СНК	APP	DESCRIPTION	09/09/2016	





### CALIFORNIA HIGH-SPEED TRAIN PROJECT MERCED TO FRESNO SECTION

CENTRAL VALLEY WYE
CIVIL AND GRADE SEPARATION PLANS
INDEX OF DRAWINGS
SHEET 13 OF 17

CONTRACT NO.
HSR08-05
DRAWING NO.
CV-B0014
SCALE
NO SCALE

SHEET NO.

		I	NDEX OF DRAWINGS	
DRAWING NO.	SECTION	ALIGNMENT / PLAN SET	TITLE	DESCRIPTION
CV-R1300-C	CENTRAL VALLEY WYE	AVENUE 21 TO ROAD 13 WYE ALTERNATIVE	PLAN AND PROFILE	AVENUE 20 1/2 GRADE SEPARATION
CV-R1301-C	CENTRAL VALLEY WYE	AVENUE 21 TO ROAD 13 WYE ALTERNATIVE	PLAN AND PROFILE	AVENUE 20 1/2 GRADE SEPARATION
CV-R1310-C	CENTRAL VALLEY WYE	AVENUE 21 TO ROAD 13 WYE ALTERNATIVE	PLAN AND PROFILE	ROAD 24 REALIGNMENT
CV-R1311-C	CENTRAL VALLEY WYE	AVENUE 21 TO ROAD 13 WYE ALTERNATIVE	PLAN AND PROFILE	ROAD 24 REALIGNMENT
CV-R1430-C	CENTRAL VALLEY WYE	AVENUE 21 TO ROAD 13 WYE ALTERNATIVE	PLAN AND PROFILE	ROAD 14 GRADE SEPARATION
CV-R1431-C	CENTRAL VALLEY WYE	AVENUE 21 TO ROAD 13 WYE ALTERNATIVE	PLAN AND PROFILE	ROAD 14 GRADE SEPARATION
CV-R1432-C	CENTRAL VALLEY WYE	AVENUE 21 TO ROAD 13 WYE ALTERNATIVE	PLAN AND PROFILE	AVENUE 21 1/2 GRADE SEPARATION
CV-R1433-C	CENTRAL VALLEY WYE	AVENUE 21 TO ROAD 13 WYE ALTERNATIVE	PLAN AND PROFILE	AVENUE 21 1/2 GRADE SEPARATION
CV-R1470-C	CENTRAL VALLEY WYE	AVENUE 21 TO ROAD 13 WYE ALTERNATIVE	PLAN AND PROFILE	AVENUE 25/WASHINGTON ROAD UNDERPASS
CV-R1471-C	CENTRAL VALLEY WYE	AVENUE 21 TO ROAD 13 WYE ALTERNATIVE	PLAN AND PROFILE	ROAD 13 REALIGNMENT
CV-R1490-C	CENTRAL VALLEY WYE	AVENUE 21 TO ROAD 13 WYE ALTERNATIVE	PLAN AND PROFILE	VISTA AVENUE/ROAD 13 REALIGNMENT
CV-R1491-C	CENTRAL VALLEY WYE	AVENUE 21 TO ROAD 13 WYE ALTERNATIVE	PLAN AND PROFILE	VISTA AVENUE/ROAD 13 REALIGNMENT
CV-R1500-C	CENTRAL VALLEY WYE	AVENUE 21 TO ROAD 13 WYE ALTERNATIVE	PLAN AND PROFILE	CROSS ROAD REALIGNMENT
CV-R1501-C	CENTRAL VALLEY WYE	AVENUE 21 TO ROAD 13 WYE ALTERNATIVE	PLAN AND PROFILE	CROSS ROAD REALIGNMENT
CV-R1502-C	CENTRAL VALLEY WYE	AVENUE 21 TO ROAD 13 WYE ALTERNATIVE	PLAN AND PROFILE	CROSS ROAD REALIGNMENT
CV-R1510-C	CENTRAL VALLEY WYE	AVENUE 21 TO ROAD 13 WYE ALTERNATIVE	PLAN AND PROFILE	ROAD 11 REALIGNMENT
CV-R1511-C	CENTRAL VALLEY WYE	AVENUE 21 TO ROAD 13 WYE ALTERNATIVE	PLAN AND PROFILE	ROAD 11 REALIGNMENT
CV-R1512-C	CENTRAL VALLEY WYE	AVENUE 21 TO ROAD 13 WYE ALTERNATIVE	PLAN AND PROFILE	ROAD 11 REALIGNMENT
CV-R1630-C	CENTRAL VALLEY WYE	AVENUE 21 TO ROAD 13 WYE ALTERNATIVE	PLAN AND PROFILE	AVENUE 21 1/2 SJD-MER GRADE SEPARATION
CV-R1631-C	CENTRAL VALLEY WYE	AVENUE 21 TO ROAD 13 WYE ALTERNATIVE	PLAN AND PROFILE	AVENUE 21 1/2 SJD-MER GRADE SEPARATION
CV-R1632-C	CENTRAL VALLEY WYE	AVENUE 21 TO ROAD 13 WYE ALTERNATIVE	PLAN AND PROFILE	ROAD 12 CONNECTOR ROAD
CV-I0001-C	CENTRAL VALLEY WYE	AVENUE 21 TO ROAD 13 WYE ALTERNATIVE	STAGE CONSTRUCTION PLAN	GENERAL NOTES
		SR 152 (NORTH	H) TO ROAD 11 WYE ALTERNATIVE	
CV-B4050-D	CENTRAL VALLEY WYE	SR 152 (NORTH) TO ROAD 11 WYE ALTERNATIVE	KEY MAP	SHEET 1 OF 4
CV-B4051-D	CENTRAL VALLEY WYE	SR 152 (NORTH) TO ROAD 11 WYE ALTERNATIVE	KEY MAP	SHEET 2 OF 4
CV-B4052-D	CENTRAL VALLEY WYE	SR 152 (NORTH) TO ROAD 11 WYE ALTERNATIVE	KEY MAP	SHEET 3 OF 4
CV-B4053-D	CENTRAL VALLEY WYE	SR 152 (NORTH) TO ROAD 11 WYE ALTERNATIVE	KEY MAP	SHEET 4 OF 4
CV-B0060-D	CENTRAL VALLEY WYE	SR 152 (NORTH) TO ROAD 11 WYE ALTERNATIVE	GEOMETRY DATA TABLE	SHEET 1 OF 6
CV-B0061-D	CENTRAL VALLEY WYE	SR 152 (NORTH) TO ROAD 11 WYE ALTERNATIVE	GEOMETRY DATA TABLE	SHEET 2 OF 6
CV-B0062-D	CENTRAL VALLEY WYE	SR 152 (NORTH) TO ROAD 11 WYE ALTERNATIVE	GEOMETRY DATA TABLE	SHEET 3 OF 6
CV-B0063-D	CENTRAL VALLEY WYE	SR 152 (NORTH) TO ROAD 11 WYE ALTERNATIVE	GEOMETRY DATA TABLE	SHEET 4 OF 6
CV-B0064-D	CENTRAL VALLEY WYE	SR 152 (NORTH) TO ROAD 11 WYE ALTERNATIVE	GEOMETRY DATA TABLE	SHEET 5 OF 6
CV-B0065-D	CENTRAL VALLEY WYE	SR 152 (NORTH) TO ROAD 11 WYE ALTERNATIVE	GEOMETRY DATA TABLE	SHEET 6 OF 6
CV-B0070-D	CENTRAL VALLEY WYE	SR 152 (NORTH) TO ROAD 11 WYE ALTERNATIVE	UTILITY CONFLICT TABLE	SHEET 1 OF 4
CV-B0071-D	CENTRAL VALLEY WYE	SR 152 (NORTH) TO ROAD 11 WYE ALTERNATIVE	UTILITY CONFLICT TABLE	SHEET 2 OF 4
CV-B0072-D	CENTRAL VALLEY WYE	SR 152 (NORTH) TO ROAD 11 WYE ALTERNATIVE	UTILITY CONFLICT TABLE	SHEET 3 OF 4
CV-B0073-D	CENTRAL VALLEY WYE	SR 152 (NORTH) TO ROAD 11 WYE ALTERNATIVE	UTILITY CONFLICT TABLE	SHEET 4 OF 4
CV-B0080-D	CENTRAL VALLEY WYE	SR 152 (NORTH) TO ROAD 11 WYE ALTERNATIVE	TYPICAL SECTION	SHEET 1 OF 3
CV-B0081-D	CENTRAL VALLEY WYE	SR 152 (NORTH) TO ROAD 11 WYE ALTERNATIVE	TYPICAL SECTION	SHEET 2 OF 3
CV-B0082-D	CENTRAL VALLEY WYE	SR 152 (NORTH) TO ROAD 11 WYE ALTERNATIVE	TYPICAL SECTION	SHEET 3 OF 3

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				CV-S1441-D	CENTRAL VALLEY WYE	SR	152 (NORTH) TO
							DESIGNED BY
							DRAWN BY W. JOHNSEN
							CHECKED BY J. RAY
							IN CHARGE C. LEMLEY
DATE	BY	СНК	APP		DESCRIPTION		DATE 09/09/2016
	DATE	DATE BY	DATE BY CHK		CV-S1441-D		





#### CALIFORNIA HIGH-SPEED TRAIN PROJECT MERCED TO FRESNO SECTION

CENTRAL VALLEY WYE CIVIL AND GRADE SEPARATION PLANS INDEX OF DRAWINGS SHEET 14 OF 17

CONTRACT NO. HSRO8-05
DRAWING NO. CV-B0015
SCALE NO SCALE

SHEET NO.

DRAWING NO.	SECTION	ALIGNMENT / PLAN SET	NDEX OF DRAWINGS  TITLE	DESCRIPTION
CV-S1010-D CV-S1020-D	CENTRAL VALLEY WYE  CENTRAL VALLEY WYE	SR 152 (NORTH) TO ROAD 11 WYE ALTERNATIVE  SR 152 (NORTH) TO ROAD 11 WYE ALTERNATIVE	CIVIL PLAN CIVIL PLAN	SJD-FRE STA 5338+00 TO 5394+00 SJD-FRE STA 5394+00 TO 5450+00
	CENTRAL VALLEY WYE	SR 152 (NORTH) TO ROAD 11 WYE ALTERNATIVE		SJD-FRE STA 5354+00 TO 5450+00  SJD-FRE STA 5450+00 TO 5506+00
CV-S1030-D			CIVIL PLAN	
V-S1040-D	CENTRAL VALLEY WYE	SR 152 (NORTH) TO ROAD 11 WYE ALTERNATIVE	CIVIL PLAN	SJD-FRE STA 5506+00 TO 5562+00
CV-S1050-D	CENTRAL VALLEY WYE	SR 152 (NORTH) TO ROAD 11 WYE ALTERNATIVE	CIVIL PLAN	SJD-FRE STA 5562+00 TO 5618+00
CV-S1060-D	CENTRAL VALLEY WYE	SR 152 (NORTH) TO ROAD 11 WYE ALTERNATIVE	CIVIL PLAN	SJD-FRE STA 5618+00 TO 5674+00
CV-S1070-D	CENTRAL VALLEY WYE	SR 152 (NORTH) TO ROAD 11 WYE ALTERNATIVE	CIVIL PLAN	SJD-FRE STA 5674+00 TO 5730+00
CV-S1080-D	CENTRAL VALLEY WYE	SR 152 (NORTH) TO ROAD 11 WYE ALTERNATIVE	CIVIL PLAN	SJD-FRE STA 5730+00 TO 5786+00
CV-S1090-D	CENTRAL VALLEY WYE	SR 152 (NORTH) TO ROAD 11 WYE ALTERNATIVE	CIVIL PLAN	SJD-FRE STA 5786+00 TO 5842+00
CV-S1100-D	CENTRAL VALLEY WYE	SR 152 (NORTH) TO ROAD 11 WYE ALTERNATIVE	CIVIL PLAN	SJD-FRE STA 5842+00 TO 5898+00
CV-S1110-D	CENTRAL VALLEY WYE	SR 152 (NORTH) TO ROAD 11 WYE ALTERNATIVE	CIVIL PLAN	SJD-FRE STA 5898+00 TO 5954+00
CV-S1120-D	CENTRAL VALLEY WYE	SR 152 (NORTH) TO ROAD 11 WYE ALTERNATIVE	CIVIL PLAN	SJD-FRE STA 5954+00 TO 6010+00
V-S1130-D	CENTRAL VALLEY WYE	SR 152 (NORTH) TO ROAD 11 WYE ALTERNATIVE	CIVIL PLAN	SJD-FRE STA 6010+00 TO 6066+00
CV-S1140-D	CENTRAL VALLEY WYE	SR 152 (NORTH) TO ROAD 11 WYE ALTERNATIVE	CIVIL PLAN	SJD-FRE STA 6066+00 TO 6122+00
CV-S1150-D	CENTRAL VALLEY WYE	SR 152 (NORTH) TO ROAD 11 WYE ALTERNATIVE	CIVIL PLAN	SJD-FRE STA 6122+00 TO 6178+00
CV-S1160-D	CENTRAL VALLEY WYE	SR 152 (NORTH) TO ROAD 11 WYE ALTERNATIVE	CIVIL PLAN	SJD-FRE STA 6178+00 TO 6234+00
CV-S1170-D	CENTRAL VALLEY WYE	SR 152 (NORTH) TO ROAD 11 WYE ALTERNATIVE	CIVIL PLAN	SJD-FRE STA 6234+00 TO 6290+00
V-S1180-D	CENTRAL VALLEY WYE	SR 152 (NORTH) TO ROAD 11 WYE ALTERNATIVE	CIVIL PLAN	SJD-FRE STA 6290+00 TO 6346+00
V-S1190-D	CENTRAL VALLEY WYE	SR 152 (NORTH) TO ROAD 11 WYE ALTERNATIVE	CIVIL PLAN	SJD-FRE STA 6346+00 TO 6402+00
V-S1200-D	CENTRAL VALLEY WYE	SR 152 (NORTH) TO ROAD 11 WYE ALTERNATIVE	CIVIL PLAN	SJD-FRE STA 6402+00 TO 6458+00
V-S1210-D	CENTRAL VALLEY WYE	SR 152 (NORTH) TO ROAD 11 WYE ALTERNATIVE	CIVIL PLAN	SJD-FRE STA 6458+00 TO 6514+00
V-S1220-D	CENTRAL VALLEY WYE	SR 152 (NORTH) TO ROAD 11 WYE ALTERNATIVE	CIVIL PLAN	SJD-FRE STA 6514+00 TO 6570+00
CV-S1230-D	CENTRAL VALLEY WYE	SR 152 (NORTH) TO ROAD 11 WYE ALTERNATIVE	CIVIL PLAN	SJD-FRE STA 6570+00 TO 6626+00
CV-S1240-D	CENTRAL VALLEY WYE	SR 152 (NORTH) TO ROAD 11 WYE ALTERNATIVE	CIVIL PLAN	SJD-FRE STA 6626+00 TO 6682+00
CV-S1241-D	CENTRAL VALLEY WYE	SR 152 (NORTH) TO ROAD 11 WYE ALTERNATIVE	CIVIL PLAN	SJD-FRE ACCESS ROAD
CV-S1250-D	CENTRAL VALLEY WYE	SR 152 (NORTH) TO ROAD 11 WYE ALTERNATIVE	CIVIL PLAN	SJD-FRE STA 6682+00 TO 6738+00
CV-S1260-D	CENTRAL VALLEY WYE	SR 152 (NORTH) TO ROAD 11 WYE ALTERNATIVE	CIVIL PLAN	SJD-FRE STA 6738+00 TO 6794+00
CV-S1270-D	CENTRAL VALLEY WYE	SR 152 (NORTH) TO ROAD 11 WYE ALTERNATIVE	CIVIL PLAN	SJD-FRE STA 6794+00 TO 6850+00
CV-S1280-D	CENTRAL VALLEY WYE	SR 152 (NORTH) TO ROAD 11 WYE ALTERNATIVE	CIVIL PLAN	SJD-FRE STA 6850+00 TO 6906+00
V-S1290-D	CENTRAL VALLEY WYE	SR 152 (NORTH) TO ROAD 11 WYE ALTERNATIVE	CIVIL PLAN	SJD-FRE STA 6906+00 TO 6962+00
:V-S1291-D	CENTRAL VALLEY WYE	SR 152 (NORTH) TO ROAD 11 WYE ALTERNATIVE	CIVIL PLAN	SJD-FRE ACCESS ROAD
CV-S1300-D	CENTRAL VALLEY WYE	SR 152 (NORTH) TO ROAD 11 WYE ALTERNATIVE	CIVIL PLAN	SJD-FRE STA 6962+00 TO 7018+00
CV-S1310-D	CENTRAL VALLEY WYE	SR 152 (NORTH) TO ROAD 11 WYE ALTERNATIVE	CIVIL PLAN	SJD-FRE STA 7018+00 TO 7074+00
CV-S1320-D	CENTRAL VALLEY WYE	SR 152 (NORTH) TO ROAD 11 WYE ALTERNATIVE	CIVIL PLAN	SJD-FRE STA 7074+00 TO 7130+00
SV-S1330-D	CENTRAL VALLEY WYE	SR 152 (NORTH) TO ROAD 11 WYE ALTERNATIVE	CIVIL PLAN	SJD-FRE STA 7130+00 TO 7170+94.51
CV-S1410-D	CENTRAL VALLEY WYE	SR 152 (NORTH) TO ROAD 11 WYE ALTERNATIVE	CIVIL PLAN	MER-FRE STA 15009+29.27 TO 15052+00
CV-S1410 D	CENTRAL VALLEY WYE	SR 152 (NORTH) TO ROAD 11 WYE ALTERNATIVE	CIVIL PLAN	MER-FRE STA 15052+00 TO 15108+00
CV-S1420-D CV-S1430-D	CENTRAL VALLEY WYE	SR 152 (NORTH) TO ROAD 11 WYE ALTERNATIVE	CIVIL PLAN	MER-FRE STA 15082+00 TO 15108+00  MER-FRE STA 15108+00 TO 15164+00
			CIVIL PLAN	MER-FRE STA 15108+00 TO 15164+00  MER-FRE STA 15164+00 TO 15220+00
CV-S1440-D CV-S1441-D	CENTRAL VALLEY WYE  CENTRAL VALLEY WYE	SR 152 (NORTH) TO ROAD 11 WYE ALTERNATIVE  SR 152 (NORTH) TO ROAD 11 WYE ALTERNATIVE	CIVIL PLAN	MER-FRE STA 15164+00 TO 15220+00

INDEX OF DRAWINGS

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	BY	снк	APP		DESCRIPTION		J. RAY IN CHARGE C. LEMLEY DATE 09/09/2016	-
							DRAWN BY W. JOHNSEN CHECKED BY	]
							DESIGNED BY S. WELLS	Т
				CV-R1164-D	CENTRAL VALLEY WYE	SR	152 (NORTH) T	0
				CV-R1163-D	CENTRAL VALLEY WYE	SR	152 (NORTH) T	.0
				CV-R1162-D	CENTRAL VALLEY WYE	SR	152 (NORTH) T	O





### CALIFORNIA HIGH-SPEED TRAIN PROJECT MERCED TO FRESNO SECTION

CENTRAL VALLEY WYE
CIVIL AND GRADE SEPARATION PLANS
INDEX OF DRAWINGS
SHEET 15 OF 17

CONTRACT NO.
HSR08-05
DRAWING NO.
CV-B0016
SCALE
NO SCALE
SHEET NO.

		INI	DEX OF DRAWINGS	
DRAWING NO.	SECTION	ALIGNMENT / PLAN SET	TITLE	DESCRIPTION
CV-S1450-D	CENTRAL VALLEY WYE	SR 152 (NORTH) TO ROAD 11 WYE ALTERNATIVE	CIVIL PLAN	MER-FRE STA 15220+00 TO 15276+00
CV-S1460-D	CENTRAL VALLEY WYE	SR 152 (NORTH) TO ROAD 11 WYE ALTERNATIVE	CIVIL PLAN	MER-FRE STA 15276+00 TO 15332+00
CV-S1470-D	CENTRAL VALLEY WYE	SR 152 (NORTH) TO ROAD 11 WYE ALTERNATIVE	CIVIL PLAN	MER-FRE STA 15332+00 TO 15388+00
CV-S1480-D	CENTRAL VALLEY WYE	SR 152 (NORTH) TO ROAD 11 WYE ALTERNATIVE	CIVIL PLAN	MER-FRE STA 15388+00 TO 15444+00
CV-S1490-D	CENTRAL VALLEY WYE	SR 152 (NORTH) TO ROAD 11 WYE ALTERNATIVE	CIVIL PLAN	MER-FRE STA 15444+00 TO 15500+00
CV-S1500-D	CENTRAL VALLEY WYE	SR 152 (NORTH) TO ROAD 11 WYE ALTERNATIVE	CIVIL PLAN	MER-FRE STA 15500+00 TO 15556+00
V-S1510-D	CENTRAL VALLEY WYE	SR 152 (NORTH) TO ROAD 11 WYE ALTERNATIVE	CIVIL PLAN	MER-FRE STA 15556+00 TO 15612+00
V-S1520-D	CENTRAL VALLEY WYE	SR 152 (NORTH) TO ROAD 11 WYE ALTERNATIVE	CIVIL PLAN	MER-FRE STA 15612+00 TO 15655+00
V-S1610-D	CENTRAL VALLEY WYE	SR 152 (NORTH) TO ROAD 11 WYE ALTERNATIVE	CIVIL PLAN	SJD-MER STA 36134+00.59 TO 36184+00
V-S1620-D	CENTRAL VALLEY WYE	SR 152 (NORTH) TO ROAD 11 WYE ALTERNATIVE	CIVIL PLAN	SJD-MER STA 36184+00 TO 36240+00
V-S1630-D	CENTRAL VALLEY WYE	SR 152 (NORTH) TO ROAD 11 WYE ALTERNATIVE	CIVIL PLAN	SJD-MER STA 36240+00 TO 36296+00
V-S1640-D	CENTRAL VALLEY WYE	SR 152 (NORTH) TO ROAD 11 WYE ALTERNATIVE	CIVIL PLAN	SJD-MER STA 36296+00 TO 36352+00
V-S1650-D	CENTRAL VALLEY WYE	SR 152 (NORTH) TO ROAD 11 WYE ALTERNATIVE	CIVIL PLAN	SJD-MER STA 36352+00 TO 36408+00
V-S1660-D	CENTRAL VALLEY WYE	SR 152 (NORTH) TO ROAD 11 WYE ALTERNATIVE	CIVIL PLAN	SJD-MER STA 36408+00 TO 36457+64.63
V-R1030-D	CENTRAL VALLEY WYE	SR 152 (NORTH) TO ROAD 11 WYE ALTERNATIVE	PLAN AND PROFILE	HENRY MILLER ROAD REALIGNMENT
V-R1031-D	CENTRAL VALLEY WYE	SR 152 (NORTH) TO ROAD 11 WYE ALTERNATIVE	PLAN AND PROFILE	HENRY MILLER ROAD REALIGNMENT
V-R1032-D	CENTRAL VALLEY WYE	SR 152 (NORTH) TO ROAD 11 WYE ALTERNATIVE	PLAN AND PROFILE	HENRY MILLER ROAD REALIGNMENT
/-R1033-D	CENTRAL VALLEY WYE	SR 152 (NORTH) TO ROAD 11 WYE ALTERNATIVE	PLAN AND PROFILE	HENRY MILLER ROAD REALIGNMENT
V-R1050-D	CENTRAL VALLEY WYE	SR 152 (NORTH) TO ROAD 11 WYE ALTERNATIVE	PLAN AND PROFILE	INDIANA ROAD GRADE SEPARATION
/-R1051-D	CENTRAL VALLEY WYE	SR 152 (NORTH) TO ROAD 11 WYE ALTERNATIVE	PLAN AND PROFILE	INDIANA ROAD GRADE SEPARATION
V-R1090-D	CENTRAL VALLEY WYE	SR 152 (NORTH) TO ROAD 11 WYE ALTERNATIVE	PLAN AND PROFILE	COYOTE ROAD REALIGNMENT
V-R1091-D	CENTRAL VALLEY WYE	SR 152 (NORTH) TO ROAD 11 WYE ALTERNATIVE	PLAN AND PROFILE	COYOTE ROAD REALIGNMENT
V-R1100-D	CENTRAL VALLEY WYE	SR 152 (NORTH) TO ROAD 11 WYE ALTERNATIVE	PLAN AND PROFILE	SR 152 REALIGNMENT AT SR 59
V-R1101-D	CENTRAL VALLEY WYE	SR 152 (NORTH) TO ROAD 11 WYE ALTERNATIVE	PLAN AND PROFILE	SR 152 REALIGNMENT AT SR 59
V-R1102-D	CENTRAL VALLEY WYE	SR 152 (NORTH) TO ROAD 11 WYE ALTERNATIVE	PLAN AND PROFILE	SR 152 REALIGNMENT AT SR 59
V-R1103-D	CENTRAL VALLEY WYE	SR 152 (NORTH) TO ROAD 11 WYE ALTERNATIVE	PLAN AND PROFILE	SR 152 REALIGNMENT AT SR 59
/-R1104-D	CENTRAL VALLEY WYE	SR 152 (NORTH) TO ROAD 11 WYE ALTERNATIVE	PLAN AND PROFILE	SR 59/SR 152 EB OFF RAMP GRADE SEPARATION
V-R1105-D	CENTRAL VALLEY WYE	SR 152 (NORTH) TO ROAD 11 WYE ALTERNATIVE	PLAN AND PROFILE	SR 59/SR 152 EB OFF RAMP GRADE SEPARATION
/-R1106-D	CENTRAL VALLEY WYE	SR 152 (NORTH) TO ROAD 11 WYE ALTERNATIVE	PLAN AND PROFILE	SR 59/SR 152 WB ON RAMP GRADE SEPARATION
V-R1107-D	CENTRAL VALLEY WYE	SR 152 (NORTH) TO ROAD 11 WYE ALTERNATIVE	PLAN AND PROFILE	SR 59/SR 152 WB ON RAMP GRADE SEPARATION
V-R1108-D	CENTRAL VALLEY WYE	SR 152 (NORTH) TO ROAD 11 WYE ALTERNATIVE	PLAN AND PROFILE	SR 59/SR 152 WB OFF RAMP GRADE SEPARATION
/-R1109-D	CENTRAL VALLEY WYE	SR 152 (NORTH) TO ROAD 11 WYE ALTERNATIVE	PLAN AND PROFILE	SR 59/SR 152 WB OFF RAMP GRADE SEPARATION
V-R1110-D	CENTRAL VALLEY WYE	SR 152 (NORTH) TO ROAD 11 WYE ALTERNATIVE	PLAN AND PROFILE	SR 59/SR 152 EB LOOP ON RAMP
V-R1111-D	CENTRAL VALLEY WYE	SR 152 (NORTH) TO ROAD 11 WYE ALTERNATIVE	PLAN AND PROFILE	ROAD 4/LINCOLN ROAD GRADE SEPARATION
V-R1112-D	CENTRAL VALLEY WYE	SR 152 (NORTH) TO ROAD 11 WYE ALTERNATIVE	PLAN AND PROFILE	ROAD 4/LINCOLN ROAD GRADE SEPARATION
V-R1160-D	CENTRAL VALLEY WYE	SR 152 (NORTH) TO ROAD 11 WYE ALTERNATIVE	PLAN AND PROFILE	ROAD 9/HEMLOCK ROAD GRADE SEPARATION
V-R1161-D	CENTRAL VALLEY WYE	SR 152 (NORTH) TO ROAD 11 WYE ALTERNATIVE	PLAN AND PROFILE	ROAD 9/HEMLOCK ROAD GRADE SEPARATION
V-R1162-D	CENTRAL VALLEY WYE	SR 152 (NORTH) TO ROAD 11 WYE ALTERNATIVE	PLAN AND PROFILE	SR 152 REALIGNMENT AT ROAD 9
V-R1163-D	CENTRAL VALLEY WYE	SR 152 (NORTH) TO ROAD 11 WYE ALTERNATIVE	PLAN AND PROFILE	SR 152 REALIGNMENT AT ROAD 9
V-R1164-D	CENTRAL VALLEY WYE	SR 152 (NORTH) TO ROAD 11 WYE ALTERNATIVE	PLAN AND PROFILE	SR 152 REALIGNMENT AT ROAD 9

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DESIGNED BY S. WELLS DRAWN BY W. JOHNSEN CHECKED BY J. RAY IN CHARGE	-201					CV-R1280-D	CENTRAL VALLEY WYE	. SR	152 (NORTH) TO
DRAWN BY W. JOHNSEN CHECKED BY J. RAY IN CHARGE									
J. RAY IN CHARGE CLEFIT EX									DRAWN BY
	-								J. RAY
REV DATE BY CHK APP DESCRIPTION 09/09/2016	_	DATE	BY	CHK	ADD		DESCRIPTION		C. LEMLEY DATE





### CALIFORNIA HIGH-SPEED TRAIN PROJECT MERCED TO FRESNO SECTION

CENTRAL VALLEY WYE CIVIL AND GRADE SEPARATION PLANS INDEX OF DRAWINGS SHEET 16 OF 17

CONTRACT NO. HSRO8-05
DRAWING NO. CV-B0017
SCALE NO SCALE

SHEET NO.

		INDE	EX OF DRAWINGS	
RAWING NO.	SECTION	ALIGNMENT / PLAN SET	TITLE	DESCRIPTION
V-R1165-D	CENTRAL VALLEY WYE	SR 152 (NORTH) TO ROAD 11 WYE ALTERNATIVE	PLAN AND PROFILE	ROAD 9/SR 152 EB OFF RAMP
V-R1166-D	CENTRAL VALLEY WYE	SR 152 (NORTH) TO ROAD 11 WYE ALTERNATIVE	PLAN AND PROFILE	ROAD 9/SR 152 EB ON RAMP
:V-R1167-D	CENTRAL VALLEY WYE	SR 152 (NORTH) TO ROAD 11 WYE ALTERNATIVE	PLAN AND PROFILE	ROAD 9/SR 152 LOOP RAMP
CV-R1168-D	CENTRAL VALLEY WYE	SR 152 (NORTH) TO ROAD 11 WYE ALTERNATIVE	PLAN AND PROFILE	ROAD 9/SR 152 WB ON RAMP
CV-R1169-D	CENTRAL VALLEY WYE	SR 152 (NORTH) TO ROAD 11 WYE ALTERNATIVE	PLAN AND PROFILE	ROAD 9/SR 152 WB OFF RAMP
CV-R1190-D	CENTRAL VALLEY WYE	SR 152 (NORTH) TO ROAD 11 WYE ALTERNATIVE	PLAN AND PROFILE	ROAD 12 GRADE SEPARATION
CV-R1191-D	CENTRAL VALLEY WYE	SR 152 (NORTH) TO ROAD 11 WYE ALTERNATIVE	PLAN AND PROFILE	ROAD 12 GRADE SEPARATION
V-R1192-D	CENTRAL VALLEY WYE	SR 152 (NORTH) TO ROAD 11 WYE ALTERNATIVE	PLAN AND PROFILE	SR 152 REALIGNMENT AT ROAD 12
V-R1193-D	CENTRAL VALLEY WYE	SR 152 (NORTH) TO ROAD 11 WYE ALTERNATIVE	PLAN AND PROFILE	SR 152 REALIGNMENT AT ROAD 12
V-R1194-D	CENTRAL VALLEY WYE	SR 152 (NORTH) TO ROAD 11 WYE ALTERNATIVE	PLAN AND PROFILE	SR 152 REALIGNMENT AT ROAD 12
V-R1200-D	CENTRAL VALLEY WYE	SR 152 (NORTH) TO ROAD 11 WYE ALTERNATIVE	PLAN AND PROFILE	SR 152 REALIGNMENT AT SR 233
V-R1201-D	CENTRAL VALLEY WYE	SR 152 (NORTH) TO ROAD 11 WYE ALTERNATIVE	PLAN AND PROFILE	SR 152 REALIGNMENT AT SR 233
CV-R1202-D	CENTRAL VALLEY WYE	SR 152 (NORTH) TO ROAD 11 WYE ALTERNATIVE	PLAN AND PROFILE	SR 152 REALIGNMENT AT SR 233
CV-R1203-D	CENTRAL VALLEY WYE	SR 152 (NORTH) TO ROAD 11 WYE ALTERNATIVE	PLAN AND PROFILE	SR 233/SR 152 EB OFF RAMP
:V-R1204-D	CENTRAL VALLEY WYE	SR 152 (NORTH) TO ROAD 11 WYE ALTERNATIVE	PLAN AND PROFILE	SR 233/SR 152 EB LOOP RAMP
V-R1205-D	CENTRAL VALLEY WYE	SR 152 (NORTH) TO ROAD 11 WYE ALTERNATIVE	PLAN AND PROFILE	SR 233/SR 152 WB ON RAMP
V-R1210-D	CENTRAL VALLEY WYE	SR 152 (NORTH) TO ROAD 11 WYE ALTERNATIVE	PLAN AND PROFILE	SR 233/ROBERTSON BLVD GRADE SEPARATION
V-R1211-D	CENTRAL VALLEY WYE	SR 152 (NORTH) TO ROAD 11 WYE ALTERNATIVE	PLAN AND PROFILE	SR 233/ROBERTSON BLVD GRADE SEPARATION
V-R1212-D	CENTRAL VALLEY WYE	SR 152 (NORTH) TO ROAD 11 WYE ALTERNATIVE	PLAN AND PROFILE	SR 233/SR 152 EB ON RAMP
CV-R1213-D	CENTRAL VALLEY WYE	SR 152 (NORTH) TO ROAD 11 WYE ALTERNATIVE	PLAN AND PROFILE	SR 233/SR 152 EB ON RAMP
CV-R1214-D	CENTRAL VALLEY WYE	SR 152 (NORTH) TO ROAD 11 WYE ALTERNATIVE	PLAN AND PROFILE	SR 233/SR 152 WB OFF RAMP
V-R1224-D	CENTRAL VALLEY WYE	SR 152 (NORTH) TO ROAD 11 WYE ALTERNATIVE	PLAN AND PROFILE	SR 152 REALIGNMENT AT ROAD 16
V-R1225-D	CENTRAL VALLEY WYE	SR 152 (NORTH) TO ROAD 11 WYE ALTERNATIVE	PLAN AND PROFILE	SR 152 REALIGNMENT AT ROAD 16
V-R1226-D	CENTRAL VALLEY WYE	SR 152 (NORTH) TO ROAD 11 WYE ALTERNATIVE	PLAN AND PROFILE	SR 152 REALIGNMENT AT ROAD 16
V-R1227-D	CENTRAL VALLEY WYE	SR 152 (NORTH) TO ROAD 11 WYE ALTERNATIVE	PLAN AND PROFILE	ROAD 16/SR 152 EB OFF RAMP
V-R1228-D	CENTRAL VALLEY WYE	SR 152 (NORTH) TO ROAD 11 WYE ALTERNATIVE	PLAN AND PROFILE	ROAD 16/SR 152 EB OFF RAMP
V-R1229-D	CENTRAL VALLEY WYE	SR 152 (NORTH) TO ROAD 11 WYE ALTERNATIVE	PLAN AND PROFILE	ROAD 16/SR 152 WB ON RAMP
V-R1230-D	CENTRAL VALLEY WYE	SR 152 (NORTH) TO ROAD 11 WYE ALTERNATIVE	PLAN AND PROFILE	ROAD 16 GRADE SEPARATION
V-R1231-D	CENTRAL VALLEY WYE	SR 152 (NORTH) TO ROAD 11 WYE ALTERNATIVE	PLAN AND PROFILE	ROAD 16 GRADE SEPARATION
V-R1232-D	CENTRAL VALLEY WYE	SR 152 (NORTH) TO ROAD 11 WYE ALTERNATIVE	PLAN AND PROFILE	ROAD 16/SR 152 EB ON RAMP
V-R1233-D	CENTRAL VALLEY WYE	SR 152 (NORTH) TO ROAD 11 WYE ALTERNATIVE	PLAN AND PROFILE	ROAD 16/SR 152 EB LOOP RAMP
V-R1234-D	CENTRAL VALLEY WYE	SR 152 (NORTH) TO ROAD 11 WYE ALTERNATIVE	PLAN AND PROFILE	ROAD 16/SR 152 WB OFF RAMP
V-R1235-D	CENTRAL VALLEY WYE	SR 152 (NORTH) TO ROAD 11 WYE ALTERNATIVE	PLAN AND PROFILE	ROAD 16 CONNECTOR REALIGNMENT
V-R1240-D	CENTRAL VALLEY WYE	SR 152 (NORTH) TO ROAD 11 WYE ALTERNATIVE	PLAN AND PROFILE	ROAD 17 1/2 GRADE SEPARATION
V-R1241-D	CENTRAL VALLEY WYE	SR 152 (NORTH) TO ROAD 11 WYE ALTERNATIVE	PLAN AND PROFILE	ROAD 17 1/2 GRADE SEPARATION
V-R1242-D	CENTRAL VALLEY WYE	SR 152 (NORTH) TO ROAD 11 WYE ALTERNATIVE	PLAN AND PROFILE	ROAD 17 1/2 GRADE SEPARATION
V-R1250-D	CENTRAL VALLEY WYE	SR 152 (NORTH) TO ROAD 11 WYE ALTERNATIVE	PLAN AND PROFILE	FAIRMEAD BOULEVARD REALIGNMENT
V-R1260-D	CENTRAL VALLEY WYE	SR 152 (NORTH) TO ROAD 11 WYE ALTERNATIVE	PLAN AND PROFILE	ROAD 20 GRADE SEPARATION
V-R1261-D	CENTRAL VALLEY WYE	SR 152 (NORTH) TO ROAD 11 WYE ALTERNATIVE	PLAN AND PROFILE	ROAD 20 GRADE SEPARATION
V-R1280-D	CENTRAL VALLEY WYE	SR 152 (NORTH) TO ROAD 11 WYE ALTERNATIVE	PLAN AND PROFILE	ROAD 22 GRADE SEPARATION

-70							DESIGNED BY
							DRAWN BY
							CHECKED BY
21811							IN CHARGE C. LEMLEY
D005	REV	DATE	BY	снк	APP	DESCRIPTION	DATE 09/09/2016





#### CALIFORNIA HIGH-SPEED TRAIN PROJECT MERCED TO FRESNO SECTION

CENTRAL VALLEY WYE CIVIL AND GRADE SEPARATION PLANS INDEX OF DRAWINGS SHEET 17 OF 17

HSR08-05
DRAWING NO. CV-B0018
NO SCALE
SHEET NO.

		II	NDEX OF DRAWINGS	
DRAWING NO.	SECTION	ALIGNMENT / PLAN SET	TITLE	DESCRIPTION
CV-R1281-D	CENTRAL VALLEY WYE	SR 152 (NORTH) TO ROAD 11 WYE ALTERNATIVE	PLAN AND PROFILE	ROAD 22 GRADE SEPARATION
CV-R1290-D	CENTRAL VALLEY WYE	SR 152 (NORTH) TO ROAD 11 WYE ALTERNATIVE	PLAN AND PROFILE	AVENUE 22 REALIGNMENT
CV-R1310-D	CENTRAL VALLEY WYE	SR 152 (NORTH) TO ROAD 11 WYE ALTERNATIVE	PLAN AND PROFILE	ROAD 24 REALIGNMENT
CV-R1311-D	CENTRAL VALLEY WYE	SR 152 (NORTH) TO ROAD 11 WYE ALTERNATIVE	PLAN AND PROFILE	ROAD 24 REALIGNMENT
CV-R1312-D	CENTRAL VALLEY WYE	SR 152 (NORTH) TO ROAD 11 WYE ALTERNATIVE	PLAN AND PROFILE	ROAD 24 REALIGNMENT
CV-R1313-D	CENTRAL VALLEY WYE	SR 152 (NORTH) TO ROAD 11 WYE ALTERNATIVE	PLAN AND PROFILE	AVENUE 20 1/2 GRADE SEPARATION
CV-R1314-D	CENTRAL VALLEY WYE	SR 152 (NORTH) TO ROAD 11 WYE ALTERNATIVE	PLAN AND PROFILE	AVENUE 20 1/2 GRADE SEPARATION
CV-R1320-D	CENTRAL VALLEY WYE	SR 152 (NORTH) TO ROAD 11 WYE ALTERNATIVE	PLAN AND PROFILE	AVENUE 20 REALIGNMENT
CV-R1321-D	CENTRAL VALLEY WYE	SR 152 (NORTH) TO ROAD 11 WYE ALTERNATIVE	PLAN AND PROFILE	AVENUE 20 REALIGNMENT
CV-R1450-D	CENTRAL VALLEY WYE	SR 152 (NORTH) TO ROAD 11 WYE ALTERNATIVE	PLAN AND PROFILE	AVENUE 25 GRADE SEPARATION
CV-R1451-D	CENTRAL VALLEY WYE	SR 152 (NORTH) TO ROAD 11 WYE ALTERNATIVE	PLAN AND PROFILE	AVENUE 25 GRADE SEPARATION
CV-R1490-D	CENTRAL VALLEY WYE	SR 152 (NORTH) TO ROAD 11 WYE ALTERNATIVE	PLAN AND PROFILE	ATHLONE ROAD REALIGNMENT
CV-R1491-D	CENTRAL VALLEY WYE	SR 152 (NORTH) TO ROAD 11 WYE ALTERNATIVE	PLAN AND PROFILE	ATHLONE ROAD REALIGNMENT
CV-R1630-D	CENTRAL VALLEY WYE	SR 152 (NORTH) TO ROAD 11 WYE ALTERNATIVE	PLAN AND PROFILE	ROAD 10 REALIGNMENT
CV-R1631-D	CENTRAL VALLEY WYE	SR 152 (NORTH) TO ROAD 11 WYE ALTERNATIVE	PLAN AND PROFILE	ROAD 10 REALIGNMENT
CV-R1632-D	CENTRAL VALLEY WYE	SR 152 (NORTH) TO ROAD 11 WYE ALTERNATIVE	PLAN AND PROFILE	AVENUE 23 1/2 GRADE SEPARATION
CV-R1633-D	CENTRAL VALLEY WYE	SR 152 (NORTH) TO ROAD 11 WYE ALTERNATIVE	PLAN AND PROFILE	AVENUE 23 1/2 GRADE SEPARATION
CV-R1650-D	CENTRAL VALLEY WYE	SR 152 (NORTH) TO ROAD 11 WYE ALTERNATIVE	PLAN AND PROFILE	ROAD 11 REALIGNMENT
CV-R1651-D	CENTRAL VALLEY WYE	SR 152 (NORTH) TO ROAD 11 WYE ALTERNATIVE	PLAN AND PROFILE	ROAD 11 REALIGNMENT
CV-I0001-D	CENTRAL VALLEY WYE	SR 152 (NORTH) TO ROAD 11 WYE ALTERNATIVE	STAGE CONSTRUCTION PLAN	GENERAL NOTES
CV-I4100-D	CENTRAL VALLEY WYE	SR 152 (NORTH) TO ROAD 11 WYE ALTERNATIVE	STAGE CONSTRUCTION PLAN	SR 59/SR 152 STAGE 1 OF 4
CV-I4101-D	CENTRAL VALLEY WYE	SR 152 (NORTH) TO ROAD 11 WYE ALTERNATIVE	STAGE CONSTRUCTION PLAN	SR 59/SR 152 STAGE 2 OF 4
CV-I4102-D	CENTRAL VALLEY WYE	SR 152 (NORTH) TO ROAD 11 WYE ALTERNATIVE	STAGE CONSTRUCTION PLAN	SR 59/SR 152 STAGE 3 OF 4
CV-I4103-D	CENTRAL VALLEY WYE	SR 152 (NORTH) TO ROAD 11 WYE ALTERNATIVE	STAGE CONSTRUCTION PLAN	SR 59/SR 152 STAGE 4 OF 4
CV-I4160-D	CENTRAL VALLEY WYE	SR 152 (NORTH) TO ROAD 11 WYE ALTERNATIVE	STAGE CONSTRUCTION PLAN	ROAD 9/SR 152 STAGE 1 OF 4
CV-I4161-D	CENTRAL VALLEY WYE	SR 152 (NORTH) TO ROAD 11 WYE ALTERNATIVE	STAGE CONSTRUCTION PLAN	ROAD 9/SR 152 STAGE 2 OF 4
CV-I4162-D	CENTRAL VALLEY WYE	SR 152 (NORTH) TO ROAD 11 WYE ALTERNATIVE	STAGE CONSTRUCTION PLAN	ROAD 9/SR 152 STAGE 3 OF 4
CV-I4163-D	CENTRAL VALLEY WYE	SR 152 (NORTH) TO ROAD 11 WYE ALTERNATIVE	STAGE CONSTRUCTION PLAN	ROAD 9/SR 152 STAGE 4 OF 4
CV-I4210-D	CENTRAL VALLEY WYE	SR 152 (NORTH) TO ROAD 11 WYE ALTERNATIVE	STAGE CONSTRUCTION PLAN	SR 233/SR 152 STAGE 1 OF 5
CV-I4211-D	CENTRAL VALLEY WYE	SR 152 (NORTH) TO ROAD 11 WYE ALTERNATIVE	STAGE CONSTRUCTION PLAN	SR 233/SR 152 STAGE 2 OF 5
CV-I4212-D	CENTRAL VALLEY WYE	SR 152 (NORTH) TO ROAD 11 WYE ALTERNATIVE	STAGE CONSTRUCTION PLAN	SR 233/SR 152 STAGE 3 OF 5
CV-I4213-D	CENTRAL VALLEY WYE	SR 152 (NORTH) TO ROAD 11 WYE ALTERNATIVE	STAGE CONSTRUCTION PLAN	SR 233/SR 152 STAGE 4 OF 5
CV-I4214-D	CENTRAL VALLEY WYE	SR 152 (NORTH) TO ROAD 11 WYE ALTERNATIVE	STAGE CONSTRUCTION PLAN	SR 233/SR 152 STAGE 5 OF 5
CV-I4230-D	CENTRAL VALLEY WYE	SR 152 (NORTH) TO ROAD 11 WYE ALTERNATIVE	STAGE CONSTRUCTION PLAN	ROAD 16/SR 152 STAGE 1 OF 4
CV-I4231-D	CENTRAL VALLEY WYE	SR 152 (NORTH) TO ROAD 11 WYE ALTERNATIVE	STAGE CONSTRUCTION PLAN	ROAD 16/SR 152 STAGE 2 OF 4
CV-I4232-D	CENTRAL VALLEY WYE	SR 152 (NORTH) TO ROAD 11 WYE ALTERNATIVE	STAGE CONSTRUCTION PLAN	ROAD 16/SR 152 STAGE 3 OF 4
CV-I4233-D	CENTRAL VALLEY WYE	SR 152 (NORTH) TO ROAD 11 WYE ALTERNATIVE	STAGE CONSTRUCTION PLAN	ROAD 16/SR 152 STAGE 4 OF 4

AB AGGREGATE BASE ABBC ASBESTOS BONDED BITUMINOUS COATED ABM AIR-BLOWN MORTAR ABN ABANDON	CAA CAP CAPA CAS	CABLE ANCHOR ASSEMBLY CORRUGATED ALUMINUM PIPE	DET	D CONTINUED  DETAIL, DETOUR	FNTB	FACING NORTHBOUND TRAFFIC	JS	J CONTINUED  JUNCTION STRUCTURE
ABBC ASBESTOS BONDED BITUMINOUS COATED ABM AIR-BLOWN MORTAR	CAP CAPA				FNTB	FACING NORTHBOUND TRAFFIC	JS	JUNCTION STRUCTURE
ABM AIR-BLOWN MORTAR	CAPA	CORRUGATED ALUMINUM PIPE		DOLLOL AG EID DIDEOT EIVATION				
			DF	DOUGLAS FIR, DIRECT FIXATION	FOB	FREE ON BOARD	JT	JOINT
ARN ARANDON	CAC	CORRUGATED ALUMINUM PIPE ARCH	DI	DRAINAGE INLET, DROP INLET	FOC	FACE OF CONCRETE		
		CONSTRUCTION AREA SIGN	DIA	DIAMETER	FR RD	FRONTAGE ROAD		L
ABUT ABUTMENT	СВ	CONCRETE BARRIER	DIAPH	DIAPHRAGM	FRE	FRESNO	L	LENGTH
AC ASPHALT CONCRETE	CBW	CONCRETE BLOCK WALL	DIST	DISTANCE, DISTRICT	FS	FAR SIDE, FINISHED SURFACE	LAT	LATITUDE
ACB ASPHALT CONCRETE BASE	C – C	CENTER TO CENTER	DMBB	DOUBLE METAL BEAM BARRIER	FSBT	FACING SOUTHBOUND TRAFFIC	LCB	LEAN CONCRETE BASE
ACP ASBESTOS CEMENT PIPE	CHSRA	CALIFORNIA HIGH-SPEED RAIL	DR	DRIVE	FTG	FOOTING	LLT	LAST LONG TIE
ADL ADDED DEAD LOAD		AUTHORITY (SEE AUTHORITY)	DTBB	DOUBLE THRIE BEAM BARRIER	FWBT	FACING WESTBOUND TRAFFIC	LN	LANE
ADJ ADJUST	CHSR	CALIFORNIA HIGH-SPEED RAIL	DWY	DRIVEWAY	FWY	FREEWAY	LOC	LOCATION
AFES ALTERNATIVE FLARED END SECTION	CHST	CALIFORNIA HIGH-SPEED TRAIN		E		G	LOL	LAYOUT LINE
AHD AHEAD	CG	CENTER OF GRAVITY	_				LONG	LONGITUDE
ALT ALTERNATE	CHNL	CHANNEL	E	EAST	G	GRADE, ACCELERATION DUE TO	LONGIT	LONGITUDINAL
AM TIME FROM MIDNIGHT TO NOON	CI	CAST IRON	EA	ACTUAL SUPERELEVATION		GRAVITY	LS	LUMP SUM, LENGTH OF SPIRAL
AP ALTERNATIVE PIPE	CIDH	CAST-IN-DRILLED-HOLE	EASE	EASEMENT	GA	GAGE	LT	LEFT
APC ALTERNATIVE PIPE CULVERT	CIP	CAST-IN-PLACE, CAST IRON PIPE	EB	END OF BRIDGE, EASTBOUND	GALV	GALVANIZED	LVC	LENGTH OF VERTICAL CURVE
APPROX APPROXIMATE	CIPCP	CAST IN STEEL SUELL	EC	END HORIZONTAL CURVE	GP GB	GRADING PLANE		M
APU ALTERNATIVE PIPE UNDERDRAIN	CISS	CAST-IN-STEEL SHELL	ECR	END CURB RETURN	GR	GUARD RAILING	14A T1-T	
AR ACCESS RESTRICTION	CJP	COMPLETE JOINT PENETRATION	EDC	EDGE DRAIN CLEANOUT	GRDR	GIRDER	MAINT	MAINTENANCE
ARS ACCELERATION RESPONSE SPECTRUM	CL	CHAIN LINK, CLASS	EDC	EDGE DRAIN CLEANOUT	GSP	GALVANIZED STEEL PIPE	MAX	MAXIMUM METAL BEAM
AS AGGREGATE SUBBASE  ASRP ALUMINUM SPIRAL RIB PIPE	CL-6 CLR	CHAIN LINK FENCE (6 FT) CLEAR, CLEARANCE	EDO EDV	EDGE DRAIN OUTLET EDGE DRAIN VENT	GTR	GUTTER	MB MBB	METAL BEAM METAL BEAM BARRIER
ASSY ASSEMBLY	CLR	CORRUGATED METAL	EDV ELEC	ELECTROLIER		H	MBGR	METAL BEAM GUARD RAILING
	CMP	CORRUGATED METAL CORRUGATED METAL PIPE	ELECT	ELECTRIC	Н	HEIGHT	MED	MEDIAN
ATC AUTOMATIC TRAIN CONTROL  ATPB ASPHALT TREATED PERMEABLE BASE	CMP	COUNTY	ELEV	ELEVATION	н Н, HR	HOUR	MER	MERCED
ATPM ASPHALT TREATED PERMEABLE MATERIA		COLUMN	EMB	EMBANKMENT	n, nk HD	HORIZONTAL DRAIN	MER	MERCED TO FRESNO
AUTHORITY CALIFORNIA HIGH-SPEED RAIL AUTHORI		CONCRETE	ENGR	ENGINEER	HDWL	HEADWALL	MH	MANHOLE
AVE AVENUE	COND	CONDUIT	EOD	EDGE OF DECK	HEX HD	HEXAGONAL HEAD	MIN	MINIMUM
AVENOL AVENOL AVENOL AVENOL	COND	CONNECTOR	EP	EDGE OF PAVEMENT	HMA	HOT MIXED ASPHALT	MISC	MISCELLANEOUS
@ AT	CONST	CONSTRUCT, CONSTRUCTION	EQ	EQUATION	HORIZ	HORIZONTAL		S MISCELLANEOUS IRON AND STEEL
	CONT	CONTINUOUS	ES	EDGE OF SHOULDER	HP	HINGE POINT, HORSEPOWER	MKR	MARKER
В	COORD	COORDINATE	ET	END TUNNEL	HPS	HIGH PERFORMANCE STEEL	MOD	MODIFIED, MODIFY
BAGR BRIDGE APPROACH GUARD RAILING	CP	CANDLEPOWER	ETW	EDGE OF TRAVELED WAY	HS	HIGH STRENGTH	MON	MONUMENT
BB BEGINNING OF BRIDGE	CP1	CONSTRUCTION PACKAGE 1	EU	UNBALANCED SUPERELEVATION	HSR	HIGH-SPEED RAIL	MOW	MAINTENANCE-OF-WAY FACILITY
B-B BACK-TO-BACK	CR	CREEK	EVC	END VERTICAL CURVE	HST	HIGH-SPEED TRAIN	MP	METAL PLATE
BC BEGIN HORIZONTAL CURVE	CRCP	CONTINUOUS REINFORCED CONCRETE PAVEMENT	EW	ENDWALL	HW	HEADWALL,	MPGR	METAL PLATE GUARD RAILING
BCR BEGIN CURB RETURN	CRSP	CONCRETED ROCK SLOPE PROTECTION	EXC	EXCAVATION		100-YR HIGH WATER (UNLESS NOTED	MPH	MILES PER HOUR
BEG BEGIN	CRZ	CLEAR RECOVERY ZONE	EXIST, (E)	EXISTING		OTHERWISE)	MR	MOVEMENT RATING
BIT CTD BITUMINOUS COATED	CS	CURVE SPIRAL POINT	EXP	EXPANSION, EXPRESSWAY	нwм	HIGH WATER MARK	MSE	MECHANICALLY STABILIZED EARTH
ВК ВАСК	CSP	CORRUGATED STEEL PIPE	EXP JT	EXPANSION JOINT	HWY	HIGHWAY	MTL	MATERIAL
BKF BACKFILL	CSPA	CORRUGATED STEEL PIPE ARCH	EXT	EXTERIOR		Ţ		N
BLDG BUILDING	СТВ	CEMENT TREATED BASE		Г				( N )
BLM BRIDGE-LOG MILE	СТРВ	CEMENT TREATED PERMEABLE BASE		( <u>F</u>	IB	IMPORTED BORROW	N	NORTH
BLVD BOULEVARD	СТРМ	CEMENT TREATED PERMEABLE MATERIAL	F & C	FRAME AND COVER	ID	INSIDE DIAMETER	NB	NORTHBOUND
BM BENCH MARK	CTRS	CENTERS	F & G	FRAME AND GRATE	IF	INSIDE FACE	NC	NORMAL CROWN
BOT BOTTOM	CULV	CULVERT	FB	FLOOR BEAM	INT	INTERIOR	NIC	NOT IN CONTRACT
BNSF RAILWAY	<u>C</u>	CENTERLINE	FDN	FOUNDATION	INV	INVERT	NO.	NUMBER (MUST HAVE PERIOD)
BR BRIDGE			FEBT	FACING EASTBOUND TRAFFIC	IRR	IRRIGATION	NOS.	NUMBERS (MUST HAVE PERIOD)
BRG BEARING			FES	FLARED END SECTION	IS	INTERLOCKING SITE	NPS	NOMINAL PIPE SIZE
BT BEGIN TUNNEL	D	DEPTH	FF	FILTER FABRIC			NS	NEAR SIDE
BTU BRITISH THERMAL UNIT  BVC BEGIN VERTICAL CURVE	DD	DOWNDRAIN	FG	FINISHED GRADE		J	NTS	NOT TO SCALE
BVC BEGIN VERTICAL CURVE	DBL	DOUBLE	FH	FIRE HYDRANT	JCT	JUNCTION		0
BW BARBED WIRE	DEG	DEGREE	FIG	FIGURE	JP	JOINT POLE		
	DEL	DELINEATOR	FL	FLOW LINE	JPCP	JOINTED PLAIN CONCRETE PAVEMENT	OBLR	OBLITERATE
-51		DESIGNED BY S. WELLS RECORD SET				CALIFORNIA HIGH-SPI	EED TRA	IN PROJECT CONTRACT NO. HSR08-05
		DRAWN BY 15% DESIGN				MERCED TO FRI		CTION DRAWING NO.
			RSONS			CENTRAL VA		CV-B0020
100		IN CHARGE NOT FOR	.nJUI43	CALIFOR	PN/A	CIVIL AND GRADE S		PLANS SCALE NO SCALE
0021		C. LEMLEY CONSTRUCTION		HIGH-SPEED RAIL AU		ABBREVI SHEET 1		SHEET NO.
REV DATE BY CHK APP DESCRIPTION		08/12/2016				JIICELLI	VI 2	

	(O CONTINUED)		( P CONTINUED )		(S CONTINUED)		( T CONTINUED )
		DVI		C 114		TC	
00	OVERCROSSING	PVI	POINT OF VERTICAL INTERSECTION	SJM	SAN JOSE TO MERCED	TS	TRANSVERSE, TRAFFIC SIGNAL,
ocs	OVERHEAD CONTACT SYSTEM	PVMT	PAVEMENT PANCENT	SJV	SAN JOAQUIN VALLEY	TVD	TUBULAR STEEL, TANGENT SPIRAL POINT
OD	OUTSIDE DIAMETER	PVT	POINT OF VERTICAL TANGENT	S	STATION LINE	TYP	TYPICAL
OF OC	OUTSIDE FACE		Q	SM SPEC	SELECTED MATERIAL		U
OG	ORIGINAL GROUND	OTV	QUANTITY	SPEC	SPECIAL, SPECIFICATIONS	ШС	UNDERCROSSING
OGAC	OPEN GRADED ASPHALT CONCRETE	QTY	QUANTITY		SLOTTED PLASTIC PIPE	UC	
OH	OVERHEAD		R	SR	STATE ROUTE	UD	UNDERDRAIN
0-0 0PP	OUT TO OUT	D	DADILIC	SRS	STANDALONE RADIO SITE	UON	UNLESS OTHERWISE NOTED
l OPP	OPPOSITE	R	RADIUS	SS	SLOPE STAKE, SUBSTATION	UP	UNDERPASS
	P	R&D R&S	REMOVE AND SALVACE	SSBM	STRAP AND SADDLE BRACKET METHOD	UPRR	UNION PACIFIC RAILROAD
P	PAGE		REMOVE AND SALVAGE	SSD SSPA	STRUCTURAL SECTION DRAIN	UXO	UNIVERSAL CROSSOVER
PAP	PERFORATED ALUMINUM PIPE	R/C RCA	RATE OF CHANGE	SSPP	STRUCTURAL STEEL PLATE ARCH		V
			REINFORCED CONCRETE ARCH	SSPPA	STRUCTURAL STEEL PLATE PIPE	W	DESIGN SPEED WALVE
PB	PULL BOX, PHASE BREAK	RCB	REINFORCED CONCRETE BOX		STRUCTURAL STEEL PLATE PIPE ARCH	V	DESIGN SPEED, VALVE
PC	POINT OF COMPOUND CURVE	RCP	REINFORCED CONCRETE PIPE	SSRP	STEEL SPIRAL RIB PIPE	VAR	VARIABLE
PCC	POINT OF COMPOUND CURVE,	RCPA	REINFORCED CONCRETE PIPE ARCH	STA	STREET, SPIRAL TANGENT POINT	VCD	VERTICAL CURVE
DOD	PORTLAND CEMENT CONCRETE	RD	ROAD	STA	STATION	VCP	VITRIFIED CLAY PIPE
PCP	PERFORATED CONCRETE PIPE,	REINF	REINFORCED, REINFORCEMENT,	STBB	SINGLE THRIE BEAM BARRIER	VERT	VERTICAL
DOVO	PRESTRESSED CONCRETE PIPE	חרו	REINFORCING	STD	STANDARD	VIA	VIADUCT
PCVC	POINT OF COMPOUND VERTICAL CURVE	REL	RELOCATE	STR	STRUCTURE	VOL	VOLUME
PED	PEDESTRIAN	REPL	REPLACEMENT	SURF	SURFACING		W
PED OC	PEDESTRIAN OVERCROSSING	RET	RETAINING	SW	SIDEWALK, SOUND WALL	w	WEST WINTH
PED UC	PEDESTRIAN UNDERCROSSING	REV	REVISED	SWR	SEWER	W	WEST, WIDTH
PERM MTL		RDWY	ROADWAY	SWS	SWITCHING STATION	WB	WESTBOUND
PG	PROFILE GRADE	RM	ROAD-MIXED	SYM	SYMMETRICAL	WCB	WORLD COORDINATE BEARING
PG&E	PACIFIC GAS AND ELECTRIC	RP	RADIUS POINT,	S4S	SURFACE 4 SIDES	WH	WEEP HOLE
PI	POINT OF INTERSECTION	55	REFERENCE POINT		T	WM	WIRE MESH
PITO	POINT OF INTERSECTION TURNOUT	RR	RAILROAD	-	CENT TANGENT	WS	WATER SURFACE
PJP	PARTIAL JOINT PENETRATION	RSP	ROCK SLOPE PROTECTION	T	SEMI-TANGENT	WSP	WELDED STEEL PIPE
P, PL	PLATE	RT	RIGHT	TAB	TANCENT	WT	WEIGHT
P/L	PROPERTY LINE	RTE	ROUTE	TAN	TANGENT	WV	WATER VALVE
PM	POST MILE,	RW	REDWOOD,	TBB	THRIE BEAM BARRIER	WW	WINGWALL
DNI	TIME FROM NOON TO MIDNIGHT	D (W	RETAINING WALL	TBD	TO BE DETERMINED	WWLOL	WINGWALL LAYOUT LINE
PN	PAVING NOTCH	R/W	RIGHT-OF-WAY	TBR	TIMBER		X
POB	POINT OF HORIZONTAL CURVE	RWY	RAILWAY	TC	TOP OF CURB, TRAIN CONTROL	V 656	CDOCC CECTION
POC	POINT OF HORIZONTAL CURVE		S	TCB	TRAFFIC CONTROL BOX	X SEC	CROSS SECTION
POE	POINT OF END	6	COUTH CHORLENGE	TCE	TEMPORARY CONSTRUCTION EASEMENT	XING	CROSSING
POT	POINT OF VERTICAL CURVE	S	SOUTH, SUPPLEMENT STRUCTURE APPROACH EMBANKMENT	TEL	TELEPHONE	XO	CROSSOVER
POVC	POINT OF VERTICAL CURVE	SAE		TEMP	TEMPORARY		Y
PP	PIPE PILE, PLASTIC PIPE,	SALV SAPP	SALVAGE STRUCTURAL ALUMINUM PLATE PIPE	TG TM	TOP OF GRADE	VD	YEAR
DDI	POWER POLE PREFORMED PERMEABLE LINER	SAPP	STRUCTURAL ALUMINUM PLATE PIPE SOUTHBOUND	TM TO	TECHNICAL MEMORANDUM TURNOUT	YR YRS	YEARS
PPL PPP	PERFORMED PERMEABLE LINER PERFORATED PLASTIC PIPE	SC SB	SAND CUSHION, SPIRAL CURVE POINT	TOT	TOTAL	СЛІ	ILMINO
5 PRC	POINT OF REVERSE CURVE	SCSP	SLOTTED CORRUGATED STEEL PIPE	TP	TELEPHONE POLE		
PRF	PAVEMENT REINFORCING FABRIC	SD	STORM DRAIN	TPB	TREATED PERMEABLE BASE		
PRVC	POINT OF REVERSE VERTICAL CURVE	SEC	SECOND, SECTION	TPF	TRACTION POWER FACILITY		
PRVC PS&E	PLANS, SPECIFICATIONS AND ESTIMATES	SEC	SECOND, SECTION SEPARATION	TPM	TRACTION POWER FACILITY TREATED PERMEABLE MATERIAL		
7	POINT OF SWITCH, PRESTRESSED,		SEPARATION SUBGRADE	TPSS	TRACTION POWER SUBSTATION		
PS, P/S		SG SHLD		T/R	TOP OF RAIL		
PSP	PARALLELING STATION PERFORATED STEEL PIPE	SHLD SHT	SHOULDER SHEET	TRANS	TRANSITION		
9 PT	POINT OF TANGENCY	SHI	SHEET SIMILAR	TRANS	TRACK		
PVC	POLYVINYL CHLORIDE,	SIM	SIMILAR SAN JOSE DIRIDON STATION	IUV	INACK		
5	•	300	SAIN JOSE DIKIDON STATION				
2 - 2	POINT OF VERTICAL CURVE						
9-AL			DESIGNED BY				T 044 (B00)(4   100)   100   1
2			S. WELLS RECORD SET				CALIFORNIA HIGH-SPEED TRAIN PROJECT MERCED TO FRESNO SECTION
			W. JOHNSEN	1			CENTRAL VALLEY WYE
92			J. RAY	PARSO	INS I	<i>(( )</i>	CIVIL AND GRADE SEPARATION PLANS
152:			IN CHARGE NOT FOR C. LEMLEY CONSTRUCTION	*	CALIFORN	<i>IA</i>	ABBREVIATIONS

CALIFORNIA HIGH-SPEED RAIL AUTHORITY

NOT FOR CONSTRUCTION

DATE 08/12/2016


DESCRIPTION

BY CHK APP

CENTRAL VALLEY WYE
CIVIL AND GRADE SEPARATION PLANS
ABBREVIATIONS SHEET 2 OF 2

CONTRACT NO. HSRO8-05 DRAWING NO. CV-B0021 SCALE NO SCALE

SHEET NO.

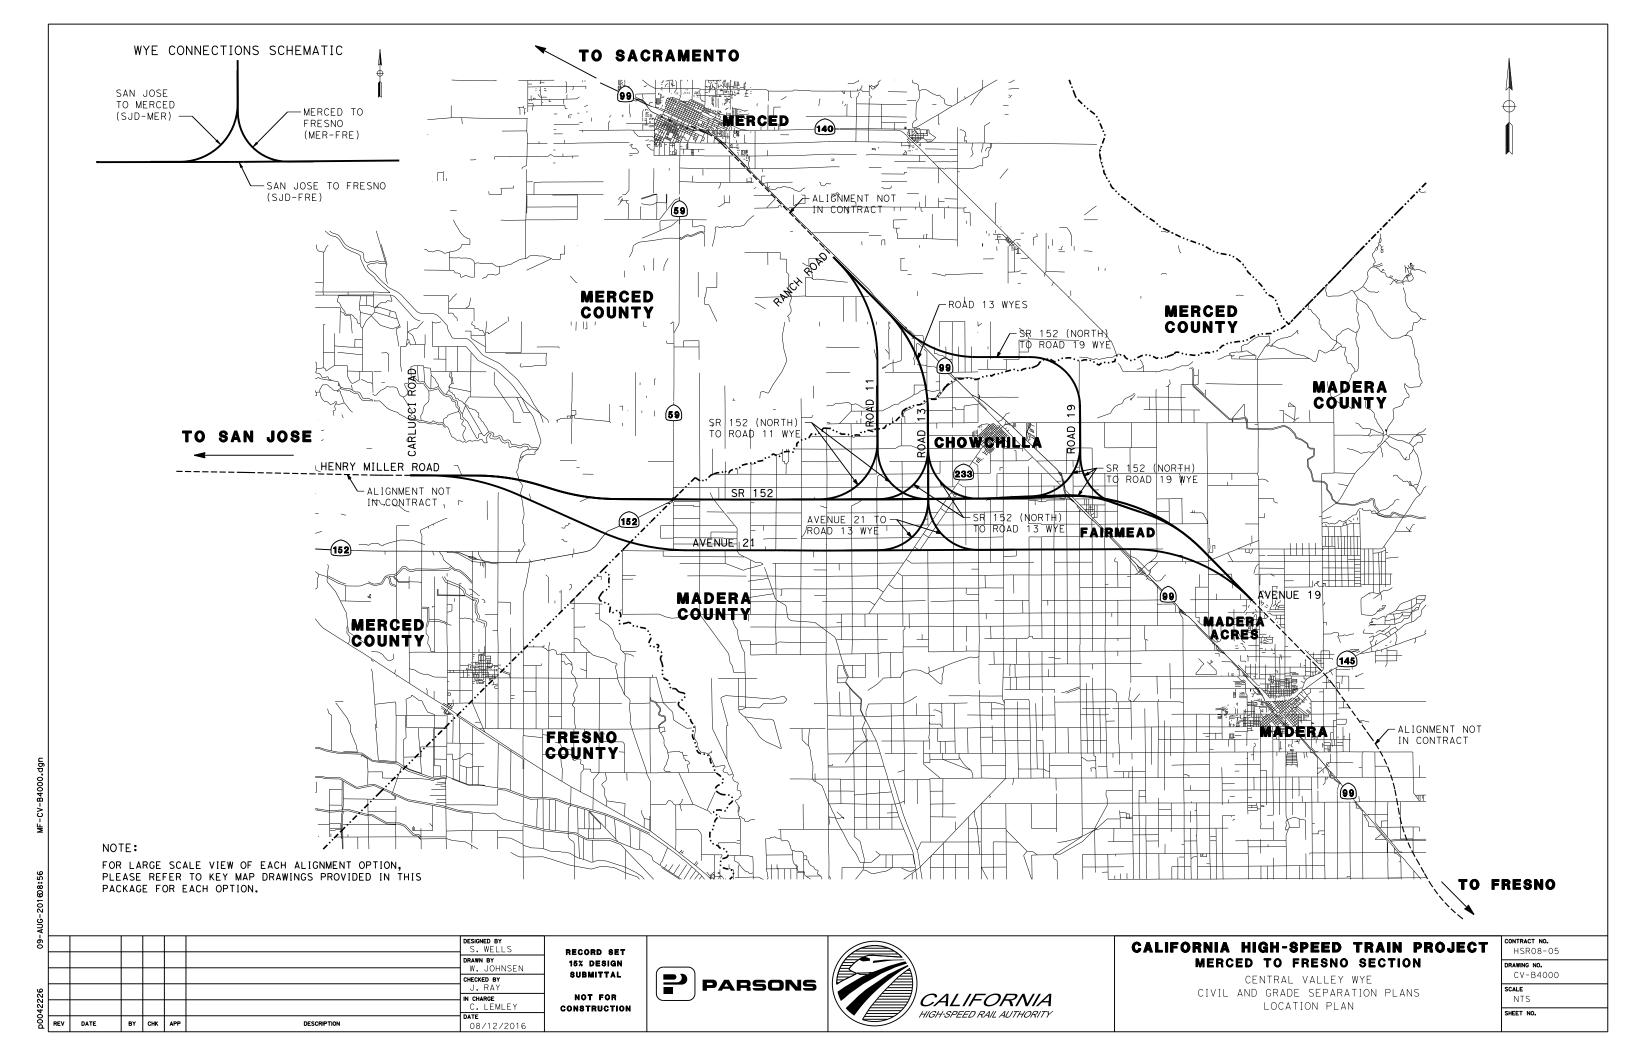

- 1. DESIGN IS BASED ON THE FOLLOWING STANDARDS:
  - CALIFORNIA HIGH-SPEED RAIL AUTHORITY DIRECTIVE DRAWINGS FOR HIGH-SPEED RAIL PROJECT FACILITIES
  - CALTRANS HIGHWAY DESIGN MANUAL FOR STATE HIGHWAY FACILITIES
     LOCAL AGENCY STANDARDS FOR ALL OTHER FACILITIES
- 2. THE HORIZONTAL CONTROL DATUM IS NAD 83. ALL ELEVATIONS ARE BASED ON NAVD 88.
- 3. ALL MAJOR UTILITIES ARE SHOWN ON THE PLANS. PLEASE REFERENCE THE SECTION UTILITY REPORT FOR A DISCUSSION OF HIGH VS. LOW RISK AND MINOR UTILITIES.
- 4. RETAINING WALL TYPES ARE NOT SHOWN DUE TO CURRENT LACK OF GEOTECHNICAL BORINGS. IT CAN BE ASSUMED FOR COST PURPOSES THAT ALL FILL RETAINING WALLS ARE MSE AND THAT ALL CUT RETAINING WALLS ARE SOIL NAIL. PRELIMINARY RETAINING WALL TYPES WILL BE FINALIZED BASED ON SUBSEQUENT GEOTECHNICAL EXPLORATION.
- 5. MAJOR WATERCOURSES, IRRIGATION CANALS, AND BODIES OF WATER ARE SHOWN ON THE PLANS. FOR FURTHER INFORMATION REGARDING DRAINAGE DESIGN, PLEASE REFER TO THE FOLLOWING:

  - HYDROLOGY AND HYDRAULICS REPORT FLOODPLAIN IMPACTS ASSESSMENT REPORT
  - STORM WATER MANAGEMENT REPORT
  - STRUCTURE, VIADUCT AND TUNNEL PLANS (FOR FLOW DIRECTION)
- 6. WHERE PROPOSED ROADWAY R/W AND ROADWAY TCE LINES CROSS PERPENDICULAR TO EXISTING ROADWAY R/W LINES, IT IS ASSUMED THESE LINES SHOW A DEMARCATION OF CONSTRUCTION LIMITS. THEY ARE NOT INTENDED TO BE CONSTRUED AS A JURISDICTIONAL
- 7. EMERGENCY VEHICLE ACCESS SHALL BE MAINTAINED AT ALL TIMES.
- 8. CUL-DE-SACS WERE DESIGNED BASED ON MERCED COUNTY STANDARD (ST-12).
- 9. METAL BEAM GUARD RAILING WAS DESIGNED PER CALTRANS STANDARD PLANS (A77) AND AASHTO ROADSIDE DESIGN GUIDE (TABLE 5-10).

Ā								
-60							DESIGNED BY	
							DRAWN BY W. JOHNSEN	
و							CHECKED BY J. RAY	
p0042226							IN CHARGE C. LEMLEY	
D00	REV	DATE	BY	снк	APP	DESCRIPTION	DATE 08/12/2016	

RECORD SET 15% DESIGN SUBMITTAL






#### CALIFORNIA HIGH-SPEED TRAIN PROJECT MERCED TO FRESNO SECTION


CENTRAL VALLEY WYE CIVIL AND GRADE SEPARATION PLANS GENERAL NOTES


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NO SCALE SHEET NO.

NOT FOR CONSTRUCTION



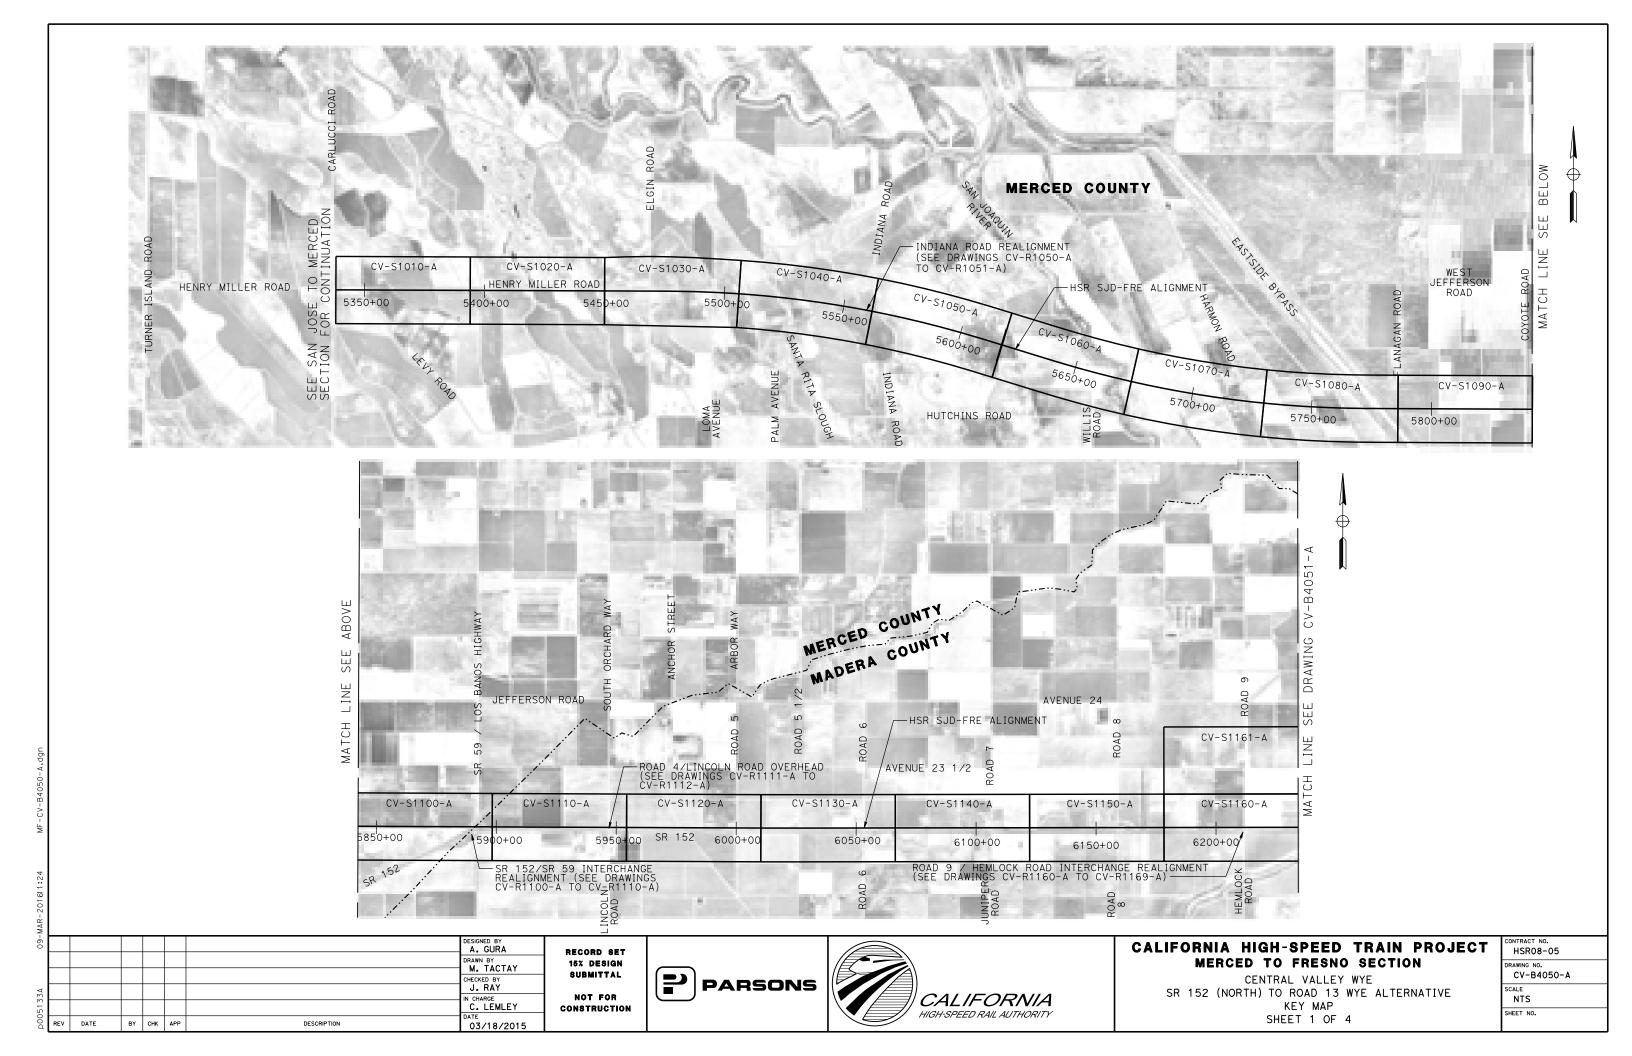

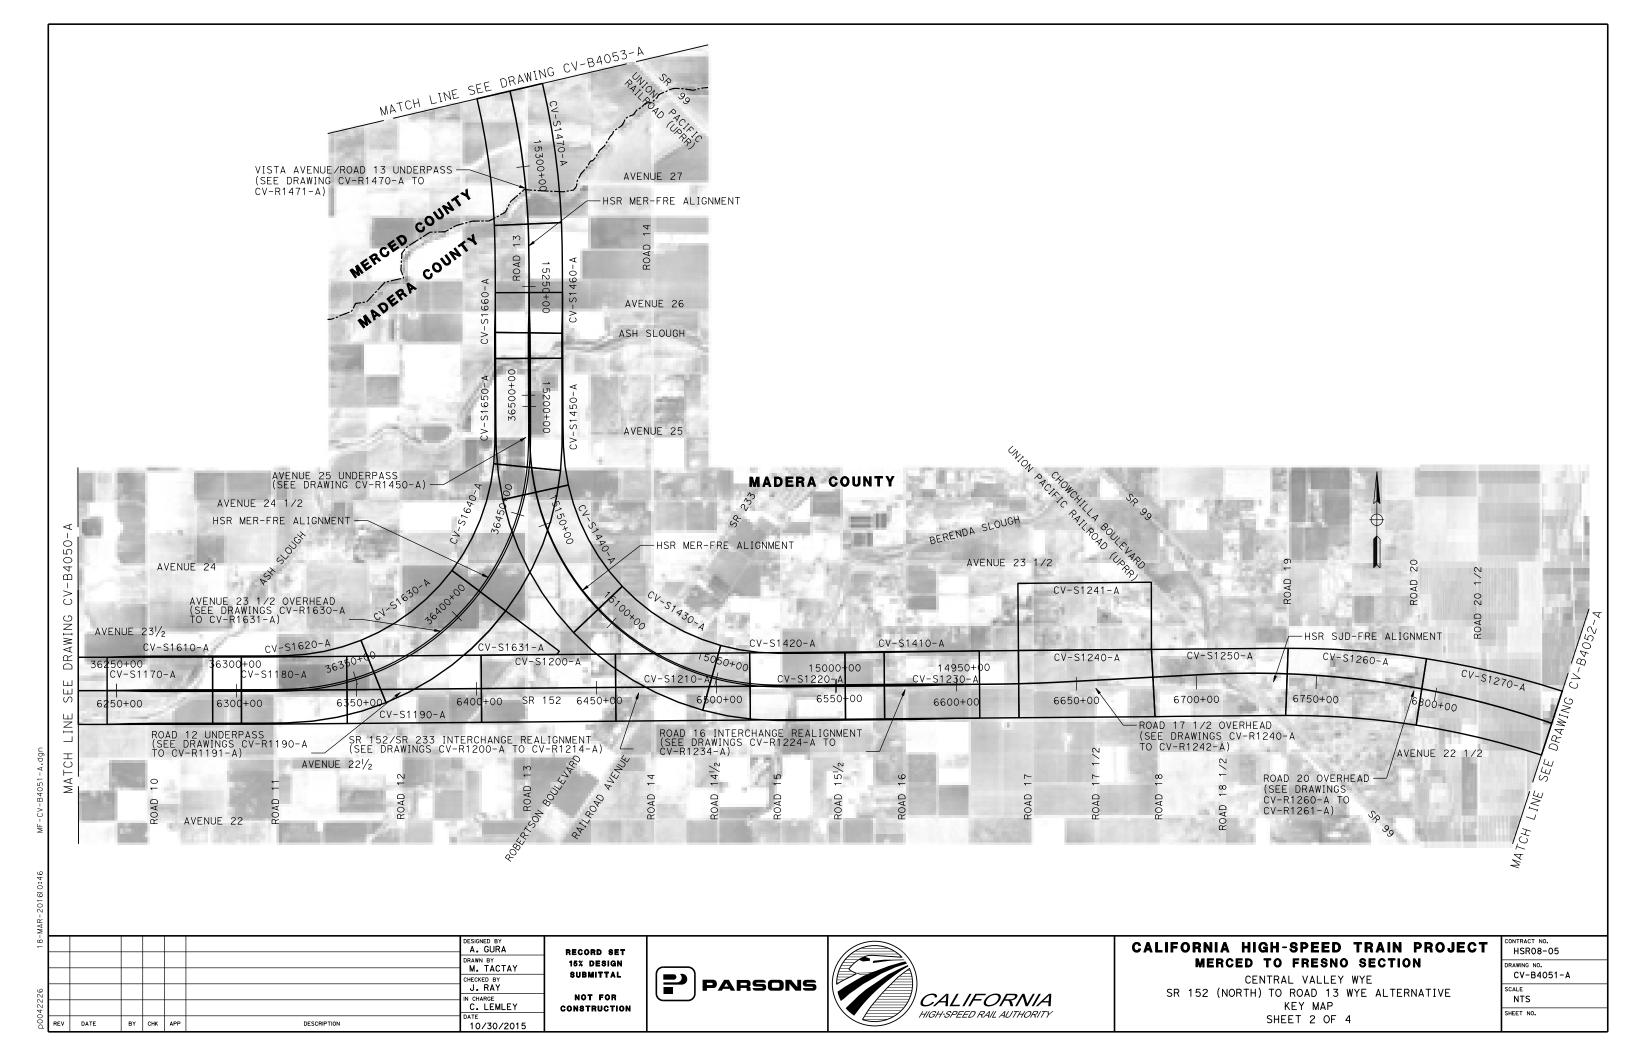

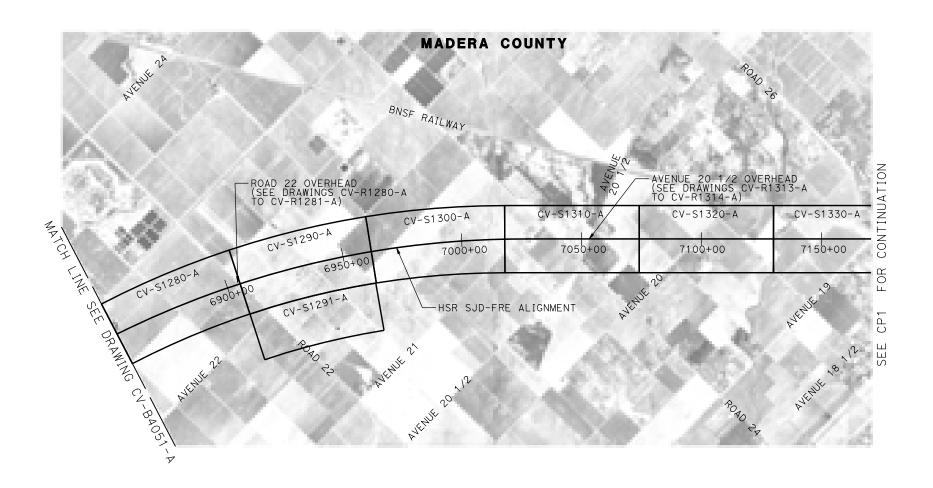

DESIGNED BY
A. GURA
DRAWN BY
M. TACTAY
CHECKED BY
J. RAY
IN CHARGE
C. LEMLEY
DATE
BY CHK APP
DESCRIPTION
DATE
03/18/2016

RECORD SET
15% DESIGN
SUBMITTAL
NOT FOR
CONSTRUCTION





### CALIFORNIA HIGH-SPEED TRAIN PROJECT MERCED TO FRESNO SECTION

CENTRAL VALLEY WYE
SR 152 (NORTH) TO ROAD 13 WYE ALTERNATIVE
KEY MAP
SHEET 3 OF 4

CONTRACT NO.
HSR08-05
DRAWING NO.
CV-B4052-A
SCALE
NTS
SHEET NO.

-MA								
-60							DESIGNED BY A. GURA	
							DRAWN BY M. TACTAY	
А							CHECKED BY J. RAY	
5133							IN CHARGE C. LEMLEY	C
00d	REV	DATE	BY	СНК	APP	DESCRIPTION	03/18/2016	





# CALIFORNIA HIGH-SPEED TRAIN PROJECT MERCED TO FRESNO SECTION

CENTRAL VALLEY WYE
SR 152 (NORTH) TO ROAD 13 WYE ALTERNATIVE
KEY MAP
SHEET 4 OF 4

CONTRACT NO.
HSR08-05
DRAWING NO.
CV-B4053-A
SCALE
NTS
SHEET NO.
NTS

1:26 MF-CV-B4053-A

09-MAR-201611:26 M

CC

ЕC

MAF							
-60							DESIGNED BY A. GURA
							DRAWN BY M. TACTAY
4							CHECKED BY J. RAY
5133A							IN CHARGE C. LEMLEY
00d	REV	DATE	BY	снк	APP	DESCRIPTION	DATE 10/30/2015

ROAD

"ALIGNMENT NAME"

CURVE NO.

ВС

RECORD SET
15% DESIGN
SUBMITTAL
NOT FOR
CONSTRUCTION





DELTA

 $\triangle$ 

RADIUS

(FT)

### CALIFORNIA HIGH-SPEED TRAIN PROJECT MERCED TO FRESNO SECTION

CENTRAL VALLEY WYE
SR 152 (NORTH) TO ROAD 13 WYE ALTERNATIVE
GEOMETRY DATA TABLE
SHEET 1 OF 6

CONTRACT NO.
HSR08-05
DRAWING NO.
CV-B0060-A
SCALE
NO SCALE
SHEET NO.

TANGENT

(FT)

LENGTH

(FT)

DEGREE OF CURVATURE (ARC)

MF-CV-B0060-,

09-MAR-201610:44

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		EASTING	6563936.73	6563948.06	6566929.56	6563977.13					
		STATION	55+31.05	63+97.93		69+59.47	1,000.00	81° 50′33.51"	5°43′46.48"	1,428.42	866.
WB SR 152 TO NB SR 59 RAMP "WB OFF RAMP"	103-02	NORTHING	1853651.29	1852798.16	1853828.68	1852829.33		LEFT			
WB OTT IVAMI		EASTING	6563977.13	6564130.91	6564961.27	6564997.23					
SB SR 59 TO EB SR 152 LOOP ON RAMP "EB LOOP RAMP"		STATION	77+47.81	80+63.60		83+79.32	18,077.00	2°00′05.77"	0°19′01.03"	631.51	315.
	103-03	NORTHING	1852857.67	1852869.02	1834792.36	1852869.35		RIGHT			
		EASTING	6565785.06	6566100.64	6566435.00	6566416.43					
		STATION	45+66.64			50+57.29	150.00	187° 24′58.88"	38°11′49.87"	490.65	0.0
	104-01	NORTHING	1851816.07		1851950.65	1852092.65		RIGHT			
		EASTING	6563300.54		6563234.29	6563185.97					
		STATION	53+88.24	54+71.80		55+55.31	2,570.00	3° 43′28.19"	2°13′45.87"	167.06	83.
	104-02	NORTHING	1852199.27	1852226.18	1849766.26	1852247.91		RIGHT			
25 2001 11111111		EASTING	6563499.28	6563578.38	6564327.17	6563659.07					
		STATION	55+55.31	57+05.36		58+55.41	17,921.00	0°57′34.14"	0°19′10.97"	300.11	150.
	104-03	NORTHING	1852247.91	1852286.91	1834943.04	1852323.49		RIGHT			
		EASTING	6563659.07	6563803.97	6568317.82	6563949.50					
		STATION	14+30.85	18+97.60		23+61.75	5,100.00	10°27′29.06"	1°07′24.41″	930.89	466
	160-01	NORTHING	1852856.89	1852856.05	1847756.90	1852770.49		RIGHT			
		EASTING	6592662.51	6593129.26	6592653.25	6593588.09					
		STATION	31+86.42	36+65.87		41+42.52	5,100.00	10° 44′28.52"	1°07′24.41″	956.10	479
	160-02	NORTHING	1852619.33	1852531.44	1857632.91	1852532.94		LEFT			
SR 152 REALIGNMENT AT ROAD 9		EASTING	6594398.79	6594870.12	6595333.63	6595349.57					
"SR 152/ROAD 9"		STATION	52+03.02	56+66.40		61+27.24	5,100.00	10°22′59.34"	1°07′24.41″	924.22	463
	160-03	NORTHING	1852536.25	1852537.7	1857636.23	1852622.64		LEFT			
		EASTING	6596410.07	6596873.45	6596394.13	6597328.98					
		STATION	69+37.21	74+00.59		78+61.43	5,100.00	10°22′59.34"	1°07′24.41"	924.22	463
	160-04	NORTHING	1852771.11	1852856.05	1847757.52	1852857.5		RIGHT			
		EASTING	6598125.22	6598580.75	6599060.06	6599044.13					
		STATION	25+62.64	28+26.67		30+89.34	3,000.00	10°03′32.93"	1° 54′35.49"	526.70	264.
	161-01	NORTHING	1852632.87	1852562.61	1849741.01	1852448.99		RIGHT			
ROAD 9/SR 152 EB OFF RAMP		EASTING	6593767.2	6594021.71	6592968.96	6594260.03					
"EB OFF RAMP"		STATION	38+53.84	41+86.88		45+09.29	1,500.00	25°02′11.73"	3°49′10.99"	655.46	333.
	161-02	NORTHING	1852119.98	1851976.65	1853473.97	1851974.01		LEFT			
		EASTING	6594950.11	6595250.74	6595595.65	6595583.77					
		STATION	46+58.21	49+60.83		52+55.44	1,500.00	22°48′44.95"	3°49′10.99"	597.23	302
	162-01	NORTHING	1851984.11	1851984.11	1853484.11	1852101.44		LEFT			
ROAD 9/SR 152 EB ON RAMP		EASTING	6595983.41	6596286.03	6595983.41	6596564.98					
"EB ON RAMP"		STATION	62+99.90	65+91.52		68+81.32	3,000.00	11°06′15.69"	1°54′35.49''	581.42	291.
	162-02	NORTHING	1852506.39	1852619.46	1849741.06	1852678.64		RIGHT			
		EASTING	6597527.74	6597796.56	6598690.89	6598082.11					

ΡI

53+67.46

1853812.6

ВС

52+03.54

1853976.13

СС

1854183.46

ROAD "ALIGNMENT NAME"

CURVE NO.

103-01

STATION

NORTHING

RECORD SET
15% DESIGN
SUBMITTAL
NOT FOR
CONSTRUCTION





RADIUS (FT)

3,000.00

ЕC

55+31.05

1853651.29

DELTA

 $\triangle$ 

6°15′17.78"

LEFT

DEGREE OF CURVATURE (ARC)

1°54′35.49"

### CALIFORNIA HIGH-SPEED TRAIN PROJECT MERCED TO FRESNO SECTION

LENGTH (FT)

327.51

TANGENT (FT)

163.92

CENTRAL VALLEY WYE
SR 152 (NORTH) TO ROAD 13 WYE ALTERNATIVE
GEOMETRY DATA TABLE
SHEET 2 OF 6

CONTRACT NO.
HSR08-05
DRAWING NO.
CV-B0061-A
SCALE
NO SCALE
SHEET NO.

ΑĀ							
90							DESIGNED BY A. GURA
							DRAWN BY M. TACTAY
NΑ							CHECKED BY J. RAY
$\circ$							IN CHARGE C. LEMLEY
cond	REV	DATE	BY	снк	APP	DESCRIPTION	DATE 03/18/2016





### CALIFORNIA HIGH-SPEED TRAIN PROJECT MERCED TO FRESNO SECTION

CENTRAL VALLEY WYE
SR 152 (NORTH) TO ROAD 13 WYE ALTERNATIVE
GEOMETRY DATA TABLE
SHEET 3 OF 6

CONTRACT NO. HSRO8-05
DRAWING NO. CV-B0062-A
NO SCALE
SHEET NO.

MF-CV-B0062-

09-MAR-201610:48

						DESIGNED BY A. GURA	Г
						DRAWN BY M. TACTAY	
						CHECKED BY J. RAY	
						IN CHARGE C. LEMLEY	
REV	DATE	BY	снк	APP	DESCRIPTION	DATE 03/18/2016	





## CALIFORNIA HIGH-SPEED TRAIN PROJECT MERCED TO FRESNO SECTION

CENTRAL VALLEY WYE SR 152 (NORTH) TO ROAD 13 WYE ALTERNATIVE GEOMETRY DATA TABLE SHEET 4 OF 6

CONTRACT NO.
HSR05-05
DRAWING NO.
CV-B0063-A
SCALE
NO SCALE
SHEET NO.

ROAD "ALIGNMENT NAME"	CURVE NO.		ВС	PI	СС	EC	RADIUS (FT)	DELTA	DEGREE OF CURVATURE (ARC)	LENGTH (FT)	TANGEN (FT)
		STATION	10+00.00	10+86.90		11+39.78	93.00	86°06′5Ø\38''	61° 36′30.11"	139.78	86.90
	202-01	NORTHING	1852116.15	1852044.25	1852168.37	1852088.05		RIGHT			
		EASTING	6620190.24	6620141.45	6620113.28	6620066.40					
		STATION	13+02.25	19+40.71		18+09.14	200.00	145°12′47.90"	28° 38′52.40"	506.89	638.4
SR 233/SR 152 EB LOOP RAMP "EB LOOP RAMP"	202-02	NORTHING	1852169.95	1852491.79	1852342.68	1852542.06		RIGHT			
EB EGGI MAMI		EASTING	6619926.08	6619374.67	6620026.90	6620011.15					
		STATION	22+51.67	23+35.24		24+18.76	3,000.00	3°11′28.67"	1° 54′35.49"	167.10	83.5
	202-03	NORTHING	1852576.90	1852583.48	1849586.22	1852585.42		RIGHT			
		EASTING	6620452.30	6620535.61	6620688.52	6620619.16					
		STATION	16+72.81	22+15.00		27+45.61	3,000.00	20° 29′20''	1° 54′35"	1,072.80	542.1
	203-01	NORTHING	1852867.39	1852793.36	1855839.30	1852912.03		LEFT		·	
SR 233/SR 152 WB ON RAMP		EASTING	6618965.65	6619502.76	6619375.23	6620031.81					
"WB ON RAMP"		STATION	31+35.85	32+43.86		33+45.37	350.00	34°17′55"	16° 22′13"	209.52	108.0
	203-02	NORTHING	1852997.44	1853021.07	1852655.92	1852981.22		RIGHT			
		EASTING	6620412.59	6620517.98	6620489.19	6620618.36					
		STATION	12+18.03	15+67.22		18+50.52	600.00	60°23′53.55"	9° 32′57.47"	632.49	349.2
	210-01	NORTHING	1851893.73	1851717.71	1852411.92	1851892.98		LEFT			
SR 233/SR 152 EB ON RAMP		EASTING	6620323.95	6620625.53	6620626.40	6620927.55					
"EB ON RAMP"		STATION	29+50.66	34+43.98		39+28.54	3,000.00	18° 40′34.42"	1° 54′35.49"	977.88	493.3
	210-02	NORTHING	1852445.17	1852692.78	1849850.44	1852790.72	,	RIGHT			
		EASTING	6621879.08	6622305.75	6623384.86	6622789.25					
		STATION	37+30.21	38+77.53		40+19.14	600.00	27° 35′29"	9° 32′57"	288.94	147.3
	211-01	NORTHING	1852847.48	1852793.11	1853405.13	1852808.35		LEFT	3 32 3 .		
SR 233/SR 152 WB OFF RAMP		EASTING	6620987.67	6621124.60	6621209.10	6621271.14					
"WB OFF RAMP"		STATION	52+23.14	54+44.03		56+64.66	5,177.00	4° 53′11"	1° 06′24"	441.52	220.9
	211-02	NORTHING	1852932.83	1852955.67	1847783.58	1852959.71		RIGHT	. 33 2 1		
		EASTING	6622468.68	6622688.39	6623003.95	6622909.25					
		STATION	13+44.20	14+13.01	0020000100	14+78.49	250.00	30° 46′36.50"	22°55′05 <b>.</b> 92"	134.29	68.8
	212-01	NORTHING	1854386.24	1854347.54	1854179.52	1854285.18	230100	RIGHT	22 33 33.32	101123	00.0
OATEC COURT	212 01	EASTING	6622168.17	6622225.07	6622027.58	6622254.15		T(TOTT)			
CATES COURT "CATES CT"		STATION	15+34.15	16+02.94	0022021.50	16+68.41	250.00	30° 46′14.25"	22°55′05 <b>.</b> 92"	134.26	68.7
	212-01	NORTHING	1854234.74	1854172.40	1854340.41	1854133.70	230.00	LEFT	22 33 03.32	134.20	00.1
	212 01	EASTING	6622277.68	6622306.75	6622504.25	6622363.63					
		STATION	14+25.89	19+02.52	0022304.23	23+76.40	5,100.00	10°40′42.20"	1° 07′24.41"	950.50	476.6
	220-01	NORTHING	1853031.56	1853042.05	1847932.80	1852964.06	3,100.00	RIGHT	1 07 24.41	930.30	470.0
	220-01	EASTING	6629753.42	6630229.94	6629865.63	6630700.14		MIGHT			
		STATION	28+57.10	33+02.66	0029003.03	37+45.96	5,100.00	9°59′09.18"	1°07′24.41"	888.86	445.5
	220-02	NORTHING	1852885.4	1852812.49	1857916.66	1852816.91	3,100.00	LEFT	1 07 24.41	888.88	443.5
	220-02	EASTING	6631174.37	6631613.92	6632008.89	6632059.46		LEFI			
SR 152 REALIGNMENT AT ROAD 16 "SR 152/ROAD 16"					0032000.09		5 100 00	0° 50′24 30″	1°07′24.41"	975 99	439.0
552518	220 07	STATION	48+64.72	53+03.74	1957027 75	57+40.60	5,100.00	9° 50′24.30"	1 01 24.41	875.88	439.0
	220-03	NORTHING	1852828.00	1852832.36	1857927.75	1852911.67		LEFT			
		EASTING	6633178.16	6633617.16	6633127.59	6634048.96	E 100 00	10007/00 07/	19.07/04.4411	004.57	440
	000 01	STATION	63+83.13	68+31.57	4040044.0=	72+77.70	5,100.00	10°03′00.07"	1°07′24.41"	894.57	448.4
	220-04	NORTHING	1853027.75	1853108.76	1848011.67	1853111.57		RIGHT			
		EASTING	6634680.92	6635121.98	6635602.29	6635570.4					

ROAD "ALIGNMENT NAME"	CURVE NO.		BC	PI	СС	EC	RADIUS (FT)	DELTA	DEGREE OF CURVATURE (ARC)	LENGTH (FT)	TANGEN <sup>*</sup> (FT)
		STATION	16+67.72	23+35.36		29+95.16	5,000.00	15°12′40.64"	1°08′45.30″	1,327.44	667.64
	221-01	NORTHING	1852981.15	1852877.22	1848042.10	1852603.89		RIGHT			
ROAD 16/SR 152 EB OFF RAMP		EASTING	6629993.95	6630653.46	6629215.62	6631262.59					
"EB OFF RAMP"		STATION	34+96.52	38+17.64		41+29.21	1,500.00	24°10′00.28"	3°49′10.99"	632.68	321.12
	221-02	NORTHING	1852398.63	1852267.17	1853767.17	1852267.17		LEFT			
		EASTING	6631720.02	6632012.99	6632334.11	6632334.11					
		STATION	19+63.41	21+13.74		22+63.98	5,024.00	3° 25′40''	1° 08′26"	300.57	150.33
	222-01	NORTHING	1853068.53	1853065.87	1848045.32	1853054.22		RIGHT			
ROAD 16/SR 152 WB ON RAMP		EASTING	6630294.90	6630445.21	6630205.95	6630595.08					
"WB ON RAMP"		STATION	25+90.18	29+78.04		33+65.52	10,000.00	4° 26′32''	0° 34′23''	775.33	387.86
	222-02	NORTHING	1853028.96	1852998.91	1862998.91	1852998.91		LEFT			
		EASTING	6630920.31	6631307.00	6631694.86	6631694.86					
		STATION	43+83.24	46+71.67		49+49.35	1,200.00	27°01′47.16"	4° 46′28.73"	566.11	288.42
	230-01	NORTHING	1852279.17	1852279.17	1853479.17	1852410.24		LEFT			
ROAD 16/SR 152 EB ON RAMP		EASTING	6632824.23	6633112.66	6632824.23	6633369.58					
"EB ON RAMP"		STATION	55+18.08	59+25.72		63+28.39	3,000.00	15°28′32.72"	1° 54′35.49"	810.31	407.6
	230-02	NORTHING	1852668.7	1852853.95	1849996.39	1852935.60	,	RIGHT			
		EASTING	6633876.18	6634239.29	6635239.54	6634638.67					
		STATION	31+70.24	32+40.24		32+80.20	70.00	90°00′00.00"	81° 51 ′04.01"	109.96	70.00
	231-01	NORTHING	1852367.17	1852297.17	1852367.17	1852297.17		RIGHT			
		EASTING	6632596.67	6632596.67	6632526.67	6632526.67					
		STATION	34+31.05			40+38.88	200.00	174°07′43.56"	28°38′52.40"	607.82	3,900.0
ROAD 16/SR 152 EB LOOP RAMP	231-02	NORTHING	1852297.17		1852497.17	1852696.12		RIGHT			,,,,,,,,,,,,,,,,,,,,,,,,,,,,,,,,,,,,,,,
"EB LOOP RAMP"	231 32	EASTING	6632375.81		6632375.81	6632355.35					
		STATION	43+46.98	44+55.87		45+64.66	3,000.00	4°09′26.29"	1° 54′35.49"	217.68	108.8
	231-03	NORTHING	1852727.64	1852738.77	1849743.37	1852742.03	3,00000	RIGHT	, 3, 331, 1		
		EASTING	6632661.85	6632770.16	6632968.73	6632879.00					
		STATION	49+57.47	53+00.61	0002000110	56+43.20	7,000.00	5° 36′46.15"	0°49′06.64"	685.74	343.1
	232-01	NORTHING	1853010.91	1853010.91	1860010.91	1853044.48	1,000.00	LEFT	0 10 00101		0.101.1
DOAD 16 /CD 152 WD OFF DAMP		EASTING	6633247.64	6633590.78	6633247.64	6633932.28					
ROAD 16/SR 152 WB OFF RAMP "WB OFF RAMP"		STATION	61+34.77	63+33.48	0000211101	65+32.00	5,177.00	4°23′46.86"	1° 06′24.25"	397.24	198.7
	232-02	NORTHING	1853092.55	1853111.99	1847940.37	1853116.21	3,11123	RIGHT	1 00 2 1020	031121	13011
	232 02	EASTING	6634421.48	6634619.25	6634927.82	6634817.92		1110111			
		STATION	13+45.79	14+93.90	0031321102	16+33.77	500.00	32°59′59"	11°27′33"	287.98	148.1
	233-01	NORTHING	1853652.19	1853652.19	1853152.19	1853571.52	300.00	RIGHT	11 21 33	201.30	11011
	233 01	EASTING	6632960.46	6633108.57	6632960.46	6633232.78		1(10111			
ROAD 16 CONNECTOR "RD 16 CONNECTOR"		STATION	17+26.67	18+74.78	0032300.40	20+14.65	500.00	32°59′59"	11°27′33"	287.98	148.1
	233-01	NORTHING	1853520.92	1853440.26	1853940.26	1853440.26	300.00	LEFT	11 21 33	201.30	140.1
	233-01	EASTING	6633310.69	6633434.91	6633583.01	6633583.01		LEFT			
		STATION		55+23.03	0033303.01	54+72.90	700.00	135°19′11"	8° 11′06"	1 657 24	1,703.
	340.01		38+19.65		1050010 17		700.00		0 11 00	1,653.24	1,703.
	240-01	NORTHING	1852923.08	1851219.73	1852919.17	1852424.20		LEFT			
ROAD 17 1/2 "RD 17 1/2"		EASTING	6640581.25	6640571.74	6641281.24	6641776.21	700.00	4.49.70/70!!	0944/0011	E 4 E 4 A	007 -
110 11 172	0.40.00	STATION	60+75.88	63+63.26	1050755 55	66+21.28	700.00	44° 38′30"	8° 11′06"	545.40	287.3
	240-02	NORTHING	1852850.57	1853053.78	1852355.59	1853055.58		RIGHT			
		EASTING	6642202.58	6642405.80	6642697.56	6642693.18					

S-9							DESIGNED BY	г
90							A. GURA	]
							DRAWN BY M. TACTAY	l
							CHECKED BY	l
=							J. RAY	1
ω							C. LEMLEY	
p0021	REV	DATE	BY	снк	APP	DESCRIPTION	DATE 09/09/2016	





### CALIFORNIA HIGH-SPEED TRAIN PROJECT MERCED TO FRESNO SECTION

CENTRAL VALLEY WYE
SR 152 (NORTH) TO ROAD 13 WYE ALTERNATIVE
GEOMETRY DATA TABLE
SHEET 5 OF 6

CONTRACT NO.
HSR05-05
DRAWING NO.
CV-B0064-A
SCALE
NO SCALE
SHEET NO.

:P-2016							
06-SE							DESIGNED BY A. GURA
							DRAWN BY M. TACTAY
1							CHECKED BY J. RAY
2181							IN CHARGE C. LEMLEY
p005	REV	DATE	BY	СНК	APP	DESCRIPTION	DATE 09/09/2016

RECORD SET 15% DESIGN SUBMITTAL NOT FOR

CONSTRUCTION





### CALIFORNIA HIGH-SPEED TRAIN PROJECT MERCED TO FRESNO SECTION

CENTRAL VALLEY WYE SR 152 (NORTH) TO ROAD 13 WYE ALTERNATIVE GEOMETRY DATA TABLE SHEET 6 OF 6

CONTRACT NO.
HSR05-05
DRAWING NO.
CV-B0065-A
SCALE
NO SCALE
SHEET NO.

ROAD "ALIGNMENT NAME"	CURVE NO.		ВС	PI	CC	EC	RADIUS (FT)	DELTA	DEGREE OF CURVATURE (ARC)	LENGTH (FT)	TANGEN <sup>®</sup>
		STATION	12+50.00	13+72.86		14+95.59	3,000.00	4° 41 ′26''	1° 54′35''	245.59	122.86
	250-01	NORTHING	1854217.48	1854130.08	1856325.85	1854050.03		LEFT			
		EASTING	6646152.11	6646238.46	6648286.31	6646331.67					
		STATION	16+98.79	19+44.19		21+88.49	3,000.00	9° 21′10''	1° 54′35"	489.71	245.40
FAIRMEAD BLVD REALIGNMENT "FAIR BLVD" LINE	250-02	NORTHING	1853917.63	1853757.74	1851641.81	1853569.73		RIGHT			
TAIN BEYS LINE		EASTING	6646485.81	6646671.97	6644531.17	6646829.67					
		STATION	23+95.89	25+18.01		26+40.00	3,000.00	4° 39′44''	1° 54′35"	244.11	122.1
	250-03	NORTHING	1853410.83	1853317.26	1855338.75	1853230.38		LEFT			
		EASTING	6646962.95	6647041.43	6649261.46	6647127.26					
		STATION	27+78.31	35+81.73		43+06.23	2,000.00	43° 46′18''	2° 51′53"	1,527.92	803.4
	310-01	NORTHING	1839905.08	1839902.68	1841905.07	1840456.73		LEFT			
AVENUE 20 1/2		EASTING	6675844.57	6676647.98	6675850.55	6677229.80					
"AVE 20 1/2"		STATION	49+74.10	53+43.44		57+04.54	2,000.00	20° 55′32"	2° 51′53"	730.44	369.3
	310-02	NORTHING	1840917.31	1841172.01	1839468.97	1841314.39		RIGHT			
		EASTING	6677713.45	6677980.91	6679092.70	6678321.70					
		STATION	13+01.85	24+70.25		31+54.79	1,200.00	88° 28′17''	4° 46′29''	1,852.94	1,168.
	311-01	NORTHING	1842114.13	1840945.76	1842122.67	1840922.90		LEFT			
ROAD 24 REALIGNMENT		EASTING	6675261.67	6675269.98	6676461.64	6676438.16					
"RD 24"		STATION	35+52.49	37+81.87		39+87.13	550.00	45°16′44''	10° 25′03"	434.65	229.3
	311-02	NORTHING	1840915.12	1840910.63	1840365.22	1840744.52		RIGHT			
		EASTING	6676835.79	6677065.13	6676825.03	6677223.32					
		STATION	11+69.34	14+64.90		17+28.66	700.00	45° 46′52''	8°11′06"	559.32	295.5
	320-01	NORTHING	1837282.83	1837284.39	1836582.84	1837073.66		RIGHT			
AVENUE 20		EASTING	6678557.18	6678852.73	6678560.87	6679059.97					
"AVE 20"		STATION	36+78.85	39+59.61		42+12.86	700.00	43° 42′35"	8° 11′06"	534.01	280.7
	320-02	NORTHING	1835683.20	1835483.02	1835192.38	1835202.30		RIGHT			
		EASTING	6680427.38	6680624.24	6679928.29	6680628.22					
		STATION	112+46.35	115+35.02		118+16.72	1,500.00	21° 47′11''	3° 49′11"	570.36	288.6
	470-01	NORTHING	1873944.61	1874233.28	1873937.52	1874500.82		LEFT			
		EASTING	6616773.38	6616772.01	6615273.40	6616663.61					
		STATION	122+74.47	127+94.78		132+56.36	1,200.00	46° 52′55"	4° 46′29''	981.89	520.3
VISTA AVENUE/ROAD 13 REALIGNMENT "VISTA AV" LINE	470-02	NORTHING	1874925.07	1875407.29	1875375.71	1875879.52		RIGHT			
VISTA AV EINE		EASTING	6616491.71	6616296.32	6617603.88	6616514.76					
		STATION	135+77.46	138+44.54		141+03.06	1,200.00	25° 05′44''	4° 46′29''	525.60	267.0
	470-03	NORTHING	1876170.95	1876413.35	1876674.76	1876680.43		LEFT			
		EASTING	6616649.57	6616761.70	6615560.45	6616760.44					
		STATION	79+26.46	83+28.04		87+24.88	3,000.00	15°14′56''	1° 54′35''	798.43	401.5
ROAD 13 REALIGNMENT "RD 13"	640-01	NORTHING	1862557.57	1862945.47	1863334.02	1863347.05		LEFT			
10 13		EASTING	6616721.01	6616824.95	6613823.23	6616823.21					

~				
12-N				
p0042226				
р0С	REV	DATE	BY	

Electrical Utility >60KV

Conflict ID #

JVC-2

JVC-3

WYH-1

WYH-2

DESCRIPTION

U+ili+y

Electric Overhead

Electric Overhead

Electric Overhead

Electric Overhead

DESIGNED BY
D.SCHWANIK
DRAWN BY
M. TACTAY
CHECKED BY
A. GURA
IN CHARGE
C. LEMLEY
DATE
02/13/2015

RECORD SET
15% DESIGN
SUBMITTAL
NOT FOR
CONSTRUCTION





#### NOTES:

- 1. ALL CONFLICTS ARE TRANSVERSE UNLESS OTHERWISE NOTED. ALL PIPE SIZES ARE SHOWN IN INCHES IN DIAMETER.
- 2. REFER TO THE 15% UTILITY REPORT FOR ADDITIONAL UTILITY INFORMATION.
- 3. REFER TO THE 15% HYDROLOGY AND HYDRAULICS REPORT FOR ADDITIONAL WATER CROSSING INFORMATION.

# CALIFORNIA HIGH-SPEED TRAIN PROJECT HSR08-05 MERCED TO FRESNO SECTION CONTRACT NO. HSR08-05 DRAWING NO.

Potential Project Impact

High Risk

Sheet #

CV-S1080-A to CV-S1090-A

CV-S1110-A

CV-S1180-A

CV-S1620-A

CV-S1200-A

CV-S1640-A to CV-1650-A

Approximate Location of Conflict

5786+10

5945+70

6315+85

36315+85 6420+35

36452+10 to 36503+80

CENTRAL VALLEY WYE
SR 152 (NORTH) TO ROAD 13 WYE ALTERNATIVE
UTILITY CONFLICT TABLE
SHEET 1 OF 4

H3K06-05
DRAWING NO.
CV-B0070-A
SCALE
NO SCALE
SHEET NO.

	WALL 15	Flootsia Overbood	445 KW south side of Australia of	15233+50 to 15239+50		CV-S1460-A
	WYH-15	Electric Overhead	115 KV, south side of Avenue 26	36528+75 to 36535+10		CV-S1660-A
	WYH-7	Electric Overhead	230 KV	6883+50 +o 6930+85		CV-S1280-A to CV-S1290-
	WYH-16	Electric Overhead	115 KV, north side of Sandy Mush Road	15467+80		CV-S1500-A
	G30	Natural Gas	12", west side of UPRR	15476+75 to 15655+00		CV-S1500-A to CV-S1530-
	G52	Natural Gas	8" line on west side of Fairmead Blvd	6718+10		CV-S1250-A
	G51	Natural Gas	12" line on west side of Fairmead Blvd	6718+25		CV-S1250-A
Natural Gas Line	WYH-8	Natural Gas	4" feeder main on west side of Road 22	6905+20	High Risk	CV-S1280-A to CV-S1291-
	WYH-8	Natural Gas	4" feeder main on north side of Avenue 22	6938+90		CV-S1290-A
	G4	Natural Gas	4" feeder line at unknown location on west side of Road 4 (Lincoln Rd)	Approximately 5946+35		CV-S1110-A
	JVC-8	Challenger Pipeline	8-inch, high pressure natural gas gathering steel line on east side of Harmon Road.	5724+30		CV-S1070-A
Petroleum Products	P2	Petroleum	12.75" OD 0.219" WT X-60 high pressure, east side of UPRR ROW	6717+85	High Risk	CV-S1250-A
	JVC-65	Irrigation Ditch #40	Unknown flow, irrigation infrastructure	5348+00		CV-S1010-A
	JVC-66	West San Juan Drain No. 1	Max flow - 20 cfs, irrigation infrastructure	5361+10		CV-S1010-A
	JVC-137	Irrigation Ditch #41	Unknown flow, irrigation infrastructure	5378+70	1	CV-S1010-A
Water Infrastructure	JVC-38	Irrigation Ditch #42	Low Risk	CV-S1010-A		
	JVC-39	San Juan Canal	Max flow - 80 cfs, irrigation infrastructure	5399+50		CV-S1020-A
	JVC-40	San Juan Drain	Unknown flow, irrigation infrastructure	5419+00		CV-S1020-A
	JVC-85	Irrigation Ditch #43	Max flow - 80 cfs, irrigation infrastructure	5427+90		CV-S1020-A

Description

115 KV, crossing at Eastside Bypass

70 KV, west side of Road 4 / Lincoln Road

115 KV, east side of Road 11

115 KV, west side of Road 13

						D.SCHWANIK
						DRAWN BY M. TACTAY
						CHECKED BY
						A. GURA IN CHARGE
						C. LEMLEY
REV	DATE	ВҮ	СНК	APP	DESCRIPTION	02/13/2015
	REV	REV DATE	REV DATE BY	REV DATE BY CHK	REV DATE BY CHK APP	REV DATE BY CHK APP DESCRIPTION

Water Infrastructure

Conflict ID #

JVC-41

JVC-42

JVC-67

JVC-68

JVC-85

JVC-45

JVC-70

JVC-71

JVC-72

JVC-73

JVC-86

JVC-88

JVC-87

JVC-12 JVC-148

JVC-13

JVC-147

JVC-74

JVC-98

JVC-101

JVC-15

JVC-46

JVC-77

U+ili+y

Temple Santa Rita Canal

West Santa Rita Drain

Drain No. 2

Escano Branch Ditch

Drain No. 3

Orchard Ditch

Santa Rita Slough

Santa Rita Drain No. 1

Drain No. 4

Santa Rita Drain No. 1A

Drain No. 5

Santa Rita Ditch

Island Field

Lucerne Ditch

Historical Wood Slough

Wood Slough

Irrigation Ditch #57

Riverside Canal

San Joaquin River

Mariposa Slough

Eastside Bypass

Chowchilla Canal

Ash Slough





#### NOTES:

Description

Unknown flow, irrigation infrastructure

Max flow - 40 cfs, irrigation infrastructure

N/A

Unknown flow, concrete lined irrigation infrastructure

N/A

- 1. ALL CONFLICTS ARE TRANSVERSE UNLESS OTHERWISE NOTED. ALL PIPE SIZES ARE SHOWN IN INCHES IN DIAMETER.
- 2. REFER TO THE 15% UTILITY REPORT FOR ADDITIONAL UTILITY INFORMATION.
- 3. REFER TO THE 15% HYDROLOGY AND HYDRAULICS REPORT FOR ADDITIONAL WATER CROSSING INFORMATION.

### CALIFORNIA HIGH-SPEED TRAIN PROJECT CONTRACT NO. HSR08-05 MERCED TO FRESNO SECTION

Potential Project Impact

Low Risk

Sheet #

CV-S1020-A CV-S1020-A

CV-S1030-A

CV-S1030-A

CV-S1040-A

CV-S1040-A

CV-S1040-A

CV-S1040-A

CV-S1040-A

CV-S1040-A

CV-S1050-A

CV-S1050-A

CV-S1050-A

CV-S1050-A

CV-S1050-A

CV-S1060-A

CV-S1060-A

CV-S1060-A

CV-S1060-A

CV-S1070-A

CV-S1080-A

CV-S1120-A

CV-S1170-A

CV-S1610-A

Approximate Location of Conflict

5436+95

5446+30

5494+60

5496+90

5509+15

5521+70

5522+75

5527+90

5535+55

5544+75

5564+20

5564+75

5573+20

5594+40

5596+00 to 5596+75

5623+55

5646+00

5666+55

5567+20 to 5570+40

5685+85

5772+10 to 5783+85

5976+00

6276+40 to 6282+40

36276+50 to 36282+75

CENTRAL VALLEY WYE SR 152 (NORTH) TO ROAD 13 WYE ALTERNATIVE UTILITY CONFLICT TABLE SHEET 2 OF 4

H2K08-05
DRAWING NO.
CV-B0071-A
SCALE
NO SCALE
SHEET NO.

IN CHARGE C. LEMLEY CONSTRUCTION								
	DATE	BY	СНК	APP	DESCRIPTION	D.SCHWANIK  DRAWN BY M. TACTAY  CHECKED BY A. GURA IN CHARGE C. LEMLEY	15% DESIGN Submittal Not for	PARS

						D.SCHWANIK
						DRAWN BY
						CHECKED BY
						A. GURA IN CHARGE
						C. LEMLEY
REV	DATE	BY	СНК	APP	DESCRIPTION	10/30/2015
	REV	REV DATE	REV DATE BY	REV DATE BY CHK	REV DATE BY CHK APP	REV DATE BY CHK APP DESCRIPTION

Water Infrastructure

Conflict ID #

JVC-80

JVC-82

JVC-133

JVC-120

JVC-111

JVC-113

WYH-17

JVC-130

JVC-129

JVC-143

JVC-134

JVC-131

JVC-133

JVC-115

JVC-106

JVC-77

JVC-106

Utility

Road 11 Canal

Bethel Canal

Berenda Canal

Berenda Pipeline

Berenda Slough

Califa Canal

Lat 32.2

Berenda Creek

24.2-8.9-1.0

24.2-8.9

Dry Creek

24.2

Berenda Canal

Malti P.L.

Ash Main Canal

Ash Slough

Ash Main Canal

RECORD SET 15% DESIGN SUBMITTAL NOT FOR CONSTRUCTION





### NOTES:

Description

Max flow - 24 cfs, irrigation infrastructure

Max flow - 40 cfs, irrigation infrastructure

Max flow - 875 cfs, irrigation infrastructure

42" M.C.P., Unknown flow, buried irrigation infrastructure, east side of Road 15

N/A

Unknown flow, irrigation infrastructure

Max flow - 600 cfs, irrigation infrastructure

N/A

Max flow - 320 cfs, irrigation infrastructure

Unknown flow, irrigation infrastructure

N/A

Max flow - 990 cfs, irrigation infrastructure

Max flow - 875 cfs, irrigation infrastructure

M.C.P.; Unknown flow, buried irrigation infrastructure

Unknown flow, irrigation infrastructure

N/A

Unknown flow, irrigation infrastructure

- 1. ALL CONFLICTS ARE TRANSVERSE UNLESS OTHERWISE NOTED. ALL PIPE SIZES ARE SHOWN IN INCHES IN DIAMETER.
- 2. REFER TO THE 15% UTILITY REPORT FOR ADDITIONAL UTILITY INFORMATION.
- 3. REFER TO THE 15% HYDROLOGY AND HYDRAULICS REPORT FOR ADDITIONAL WATER CROSSING INFORMATION.

### CALIFORNIA HIGH-SPEED TRAIN PROJECT CONTRACT NO. HSR08-05 MERCED TO FRESNO SECTION

Potential Project

Impact

Low Risk

Sheet #

CV-S1180-A

CV-S1620-A

CV-S1200-A

CV-S1210-A

CV-S1220-A

CV-S1420-A

CV-S1220-A

CV-S1420-A

CV-S1250-A

CV-S1280-A

CV-S1300-A

CV-S1320-A

CV-S1320-A

CV-S1320-A to CV-S1330-A

CV-S1330-A

CV-S1430-A

CV-S1430-A

CV-S1450-A

CV-S1650-A

CV-S1450-A

CV-S1650-A

CV-S1450-A

CV-S1650-A

Approximate Location of Conflict

6316+30

36316+15

6406+55

6478+40

6526+85

15022+80

6544+00 to 6547+65

15002+35 to 15005+90

6737+80

6876+70

7011+10 to 7011+55

7098+35

7117+00

7129+75 to 7130+60

7168+00

15066+50

15094+55

15213+70

36509+05

15214+25 to 15217+80

36509+60 to 36513+05

15217+20

36512+90

CENTRAL VALLEY WYE SR 152 (NORTH) TO ROAD 13 WYE ALTERNATIVE UTILITY CONFLICT TABLE SHEET 3 OF 4

H3K06-05
DRAWING NO.
CV-B0072-A
SCALE
NO SCALE
SHEET NO.

MAR-							
12-							D.SCHWANIK
							DRAWN BY M. TACTAY
							CHECKED BY
56							A. GURA
422							IN CHARGE C. LEMLEY
р00	REV	DATE	BY	СНК	APP	DESCRIPTION	10/30/2015
ш,							10/30/2013

Water Infrastructure

Storm Water Infrastructure

Wastewater Infrastructure

Communication Facilities

Conflict ID #

JVC-107

JVC-108

JVC-145

JVC-109

JVC-110

JVC-105

JVC-82

JVC-149

T97

T99

F9

F11

JVC-56

JVC-57

Utility

Chowchilla River

Lat 4

Lat 3

Lat 2

Dutchman Creek

Deadman's Creek

Bethel Canal
Un-named Delivery
Irrigation Canal

Fiber Optic

Fiber Optic

Fiber Optic

Fiber Optic

Copper Cable

Copper Cable

RECORD SET
15% DESIGN
SUBMITTAL
NOT FOR
CONSTRUCTION





#### NOTES:

Description

N/A

Max flow - 600 cfs, irrigation infrastructure

Max flow - 600 cfs, irrigation infrastructure

Max flow - 600 cfs, irrigation infrastructure, south side of Cross Road

N/A

N/A

Max flow - 40 cfs, irrigation infrastructure

Unknown flow, irrigation infrastructure

Underground Trenched Ducts with Fiber Optic, east side of Fairmead Blvd.

Buried cable, south side of Avenue 25

Underground 2-2"HDPE, west side of UPRR

Underground telephone, west side of UPRR

Buried cable. Runs North-South on the West side of Elgin Road right-of-way. 12 Pair

Buried cable. Runs North-South on the East side of Indiana Road right-of-way. 6 Pair.

None Found

None Found

- 1. ALL CONFLICTS ARE TRANSVERSE UNLESS OTHERWISE NOTED. ALL PIPE SIZES ARE SHOWN IN INCHES IN DIAMETER.
- 2. REFER TO THE 15% UTILITY REPORT FOR ADDITIONAL UTILITY INFORMATION.
- 3. REFER TO THE 15% HYDROLOGY AND HYDRAULICS REPORT FOR ADDITIONAL WATER CROSSING INFORMATION.

# CALIFORNIA HIGH-SPEED TRAIN PROJECT MERCED TO FRESNO SECTION

Potential Project

Impact

Low Risk

Low Risk

Sheet #

CV-S1470-A

CV-S1470-A

CV-S1480-A

CV-S1480-A

CV-S1490-A

CV-S1520-A

CV-S1640-A to CV-1650-A

CV-S1640-A

CV-S1250-A

CV-S1450-A

CV-S1650-A

CV-S1250-A

CV-S1250-A

CV-S1030-A to CV-S1032-A

CV-S1050-A

Approximate Location of Conflict

15288+00 to 15290+15

15307+00

15347+25

15374+25

15436+10

15575+70

36457+00 to 36470+00

36455+30

6718+65

15186+80

36482+15

6717+45


6717+70

5468+20

5565+00

CENTRAL VALLEY WYE
SR 152 (NORTH) TO ROAD 13 WYE ALTERNATIVE
UTILITY CONFLICT TABLE
SHEET 4 OF 4

HSR08-05
DRAWING NO.
CV-B0073-A
SCALE
NO SCALE
SHEET NO.

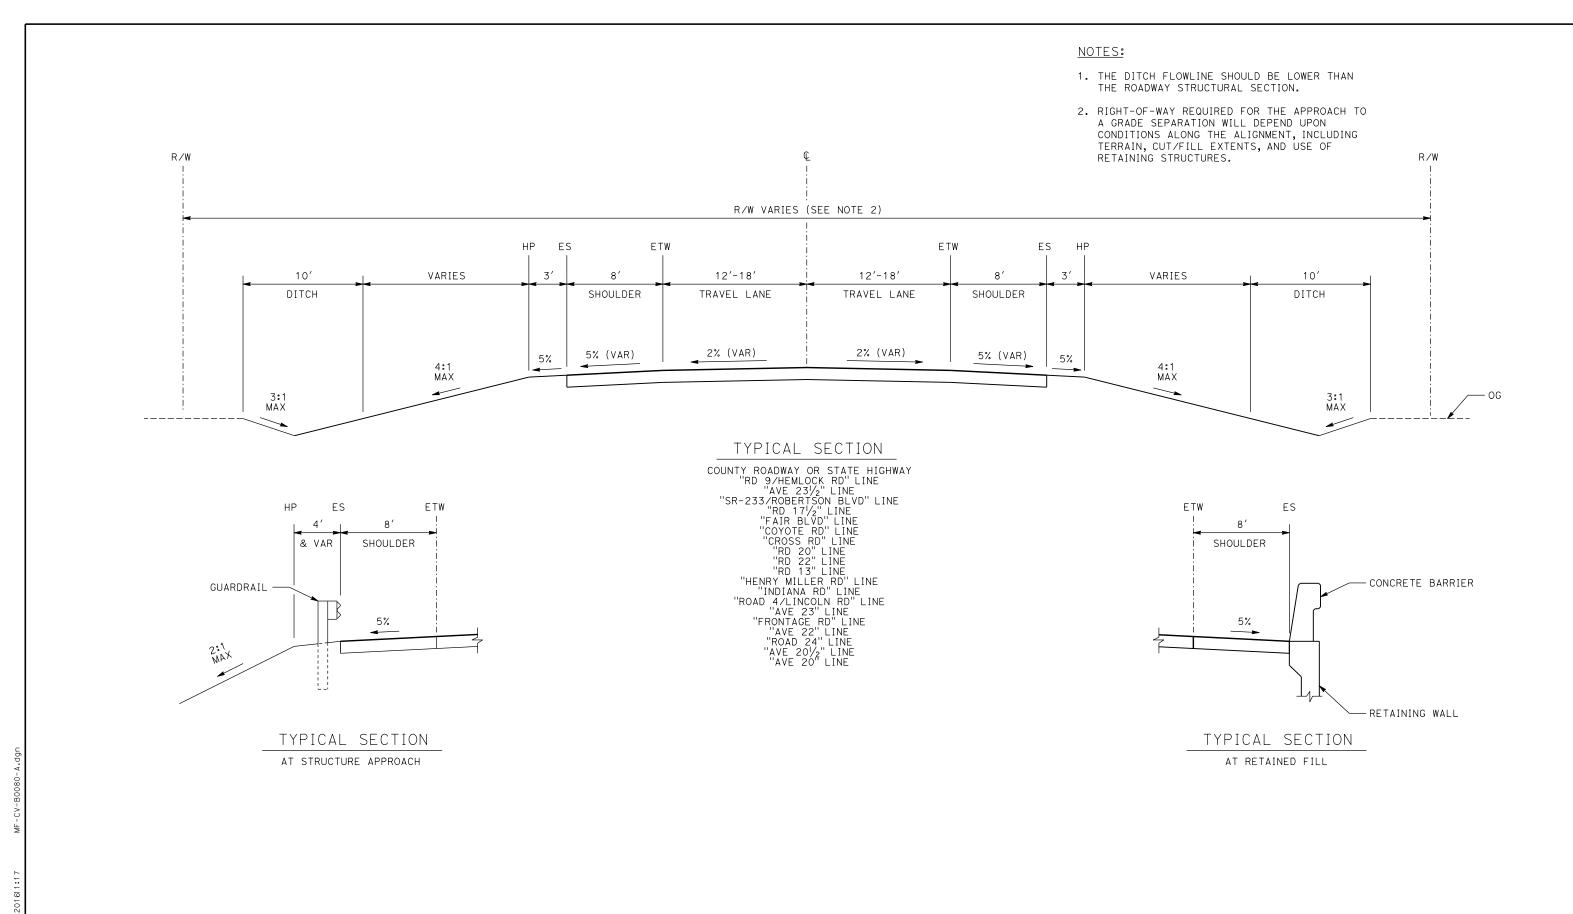

MA								
-60							DESIGNED BY A. GURA	
							DRAWN BY M. TACTAY	
							CHECKED BY J. RAY	
5133A							IN CHARGE C. LEMLEY	c
900d	REV	DATE	BY	СНК	APP	DESCRIPTION	DATE 03/18/2016	

RECORD SET
15% DESIGN
SUBMITTAL
NOT FOR
CONSTRUCTION






# CALIFORNIA HIGH-SPEED TRAIN PROJECT MERCED TO FRESNO SECTION

CENTRAL VALLEY WYE
SR 152 (NORTH) TO ROAD 13 WYE ALTERNATIVE
TYPICAL SECTION
SHEET 1 OF 3

CONTRACT NO.
HSR08-05
DRAWING NO.
CV-B0080-A
SCALE
NO SCALE
SHEET NO.

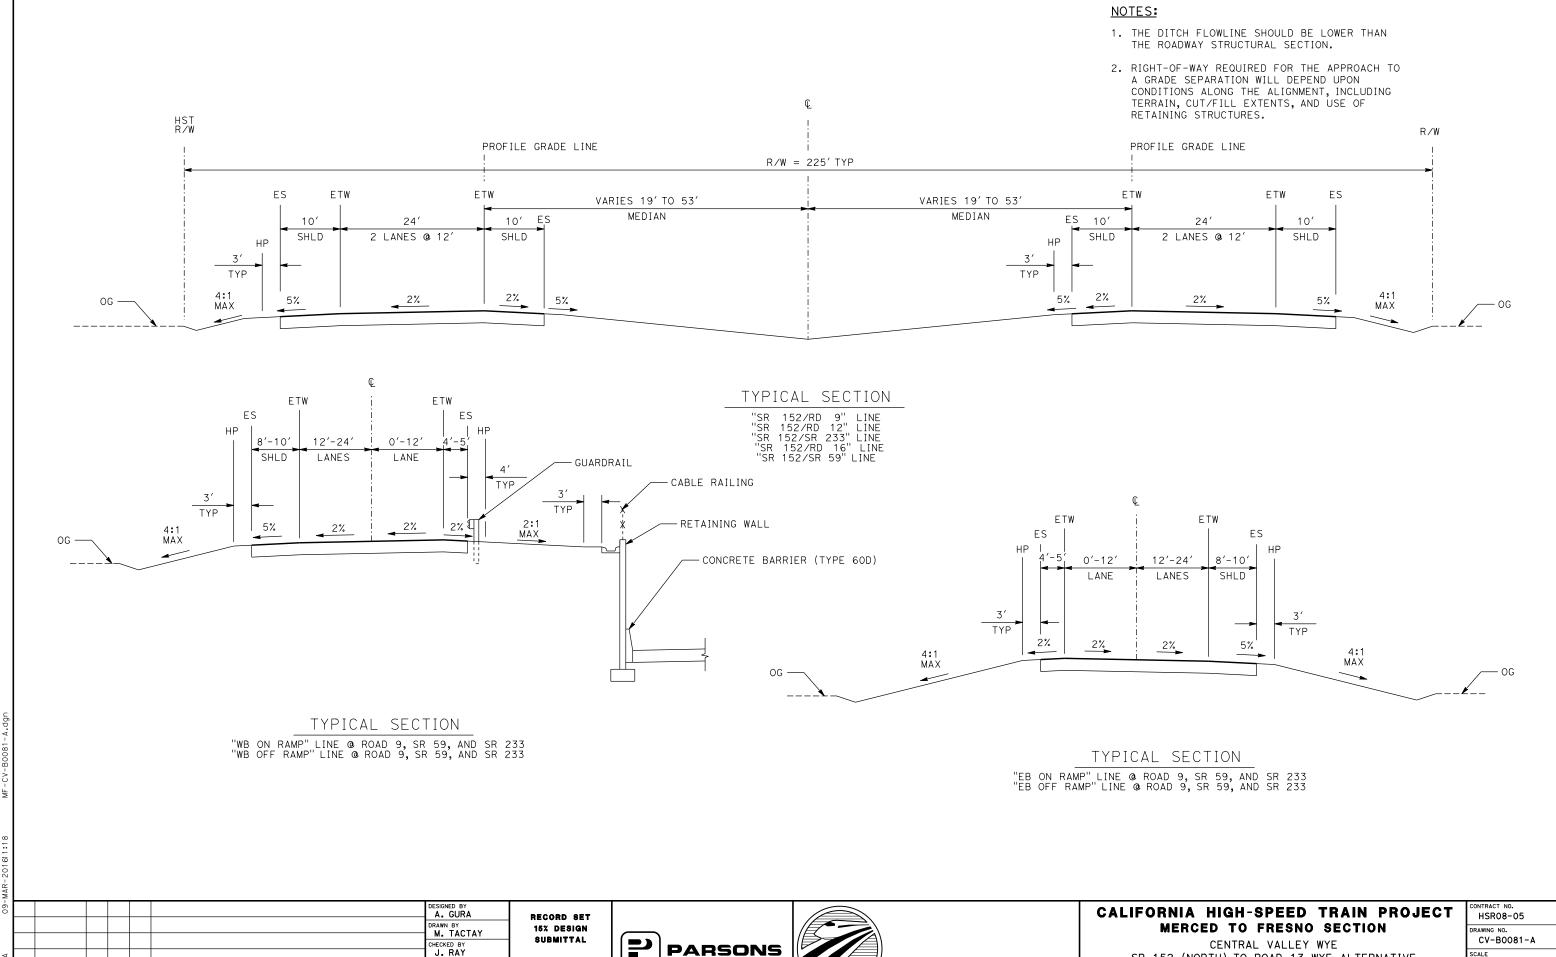

**CALIFORNIA** 

HIGH-SPEED RAIL AUTHORITY

NOT FOR

CONSTRUCTION

IN CHARGE
C. LEMLEY

03/18/2016

DATE

BY CHK APP

DESCRIPTION

CV-B0081-A

SCALE


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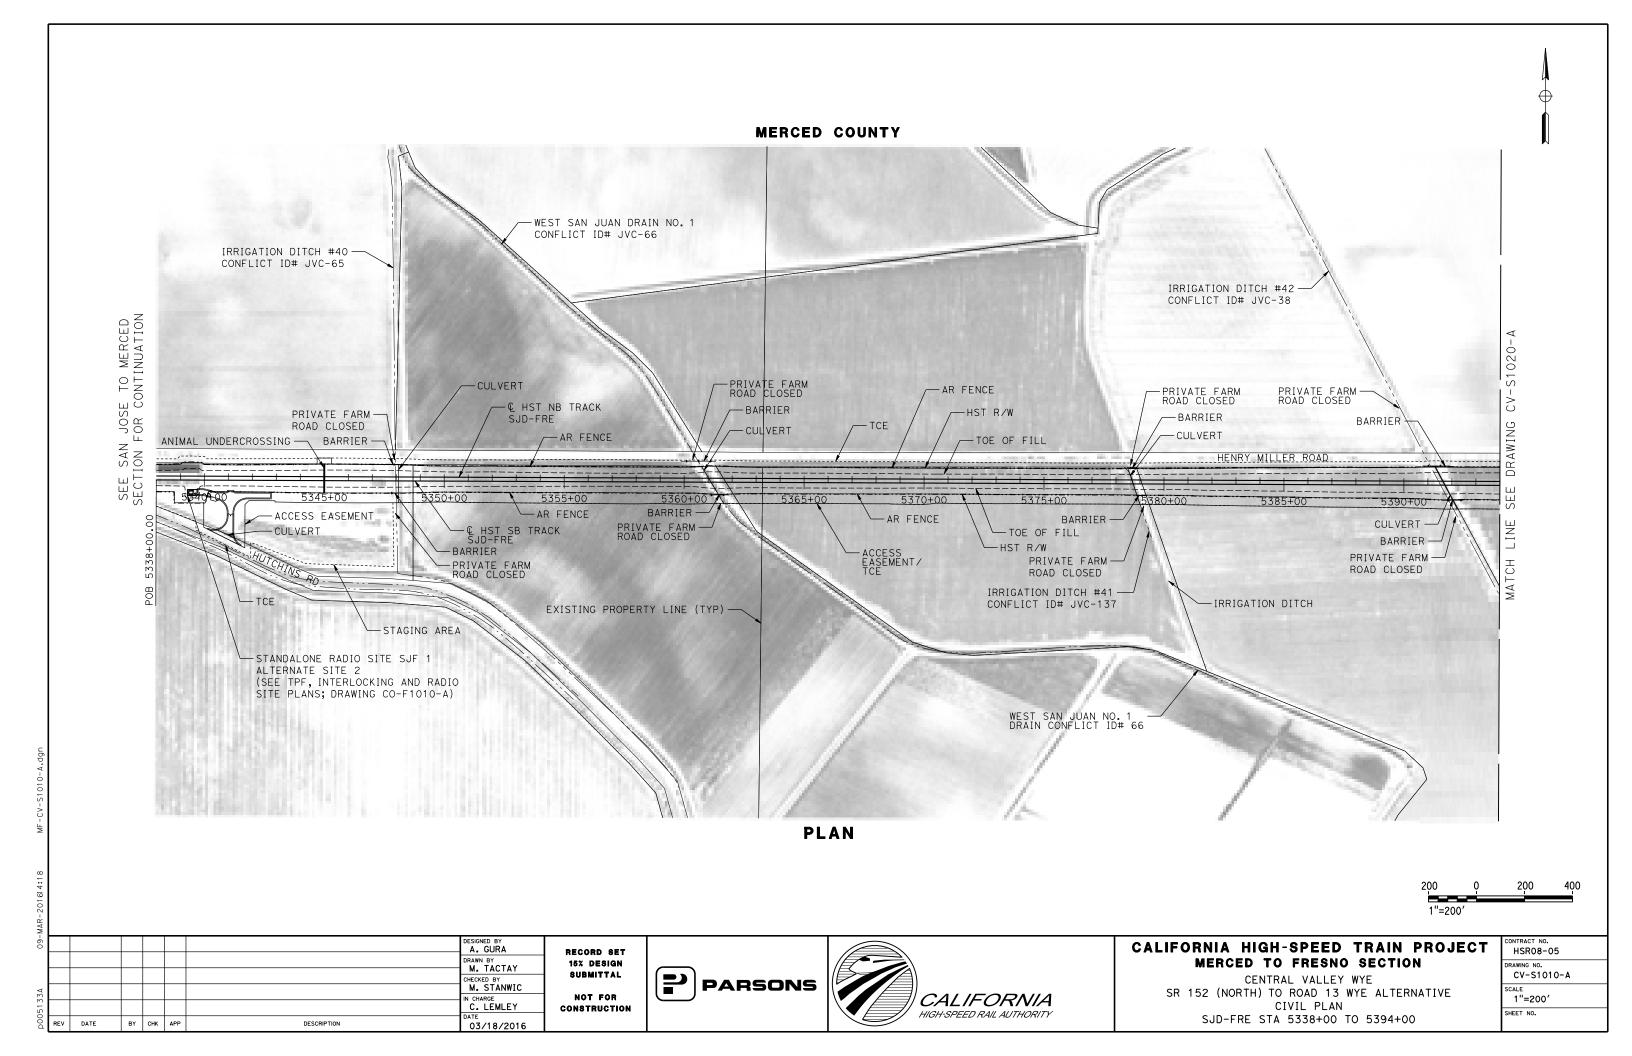
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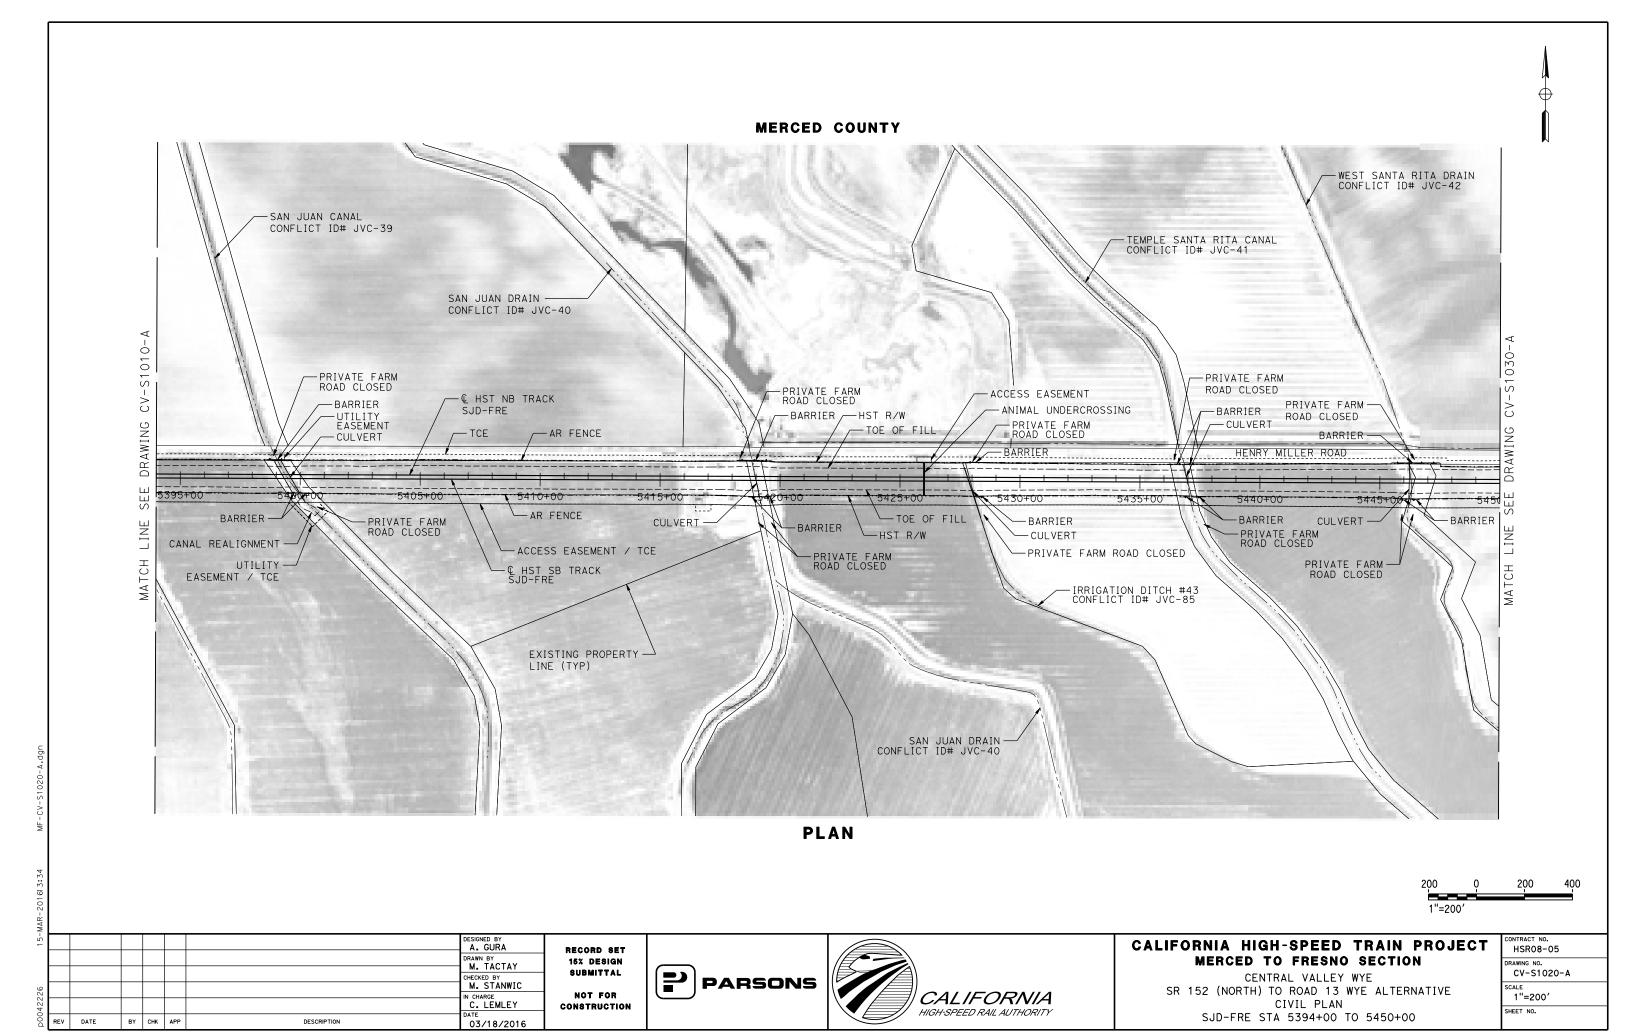
SR 152 (NORTH) TO ROAD 13 WYE ALTERNATIVE


TYPICAL SECTION


SHEET 2 OF 3





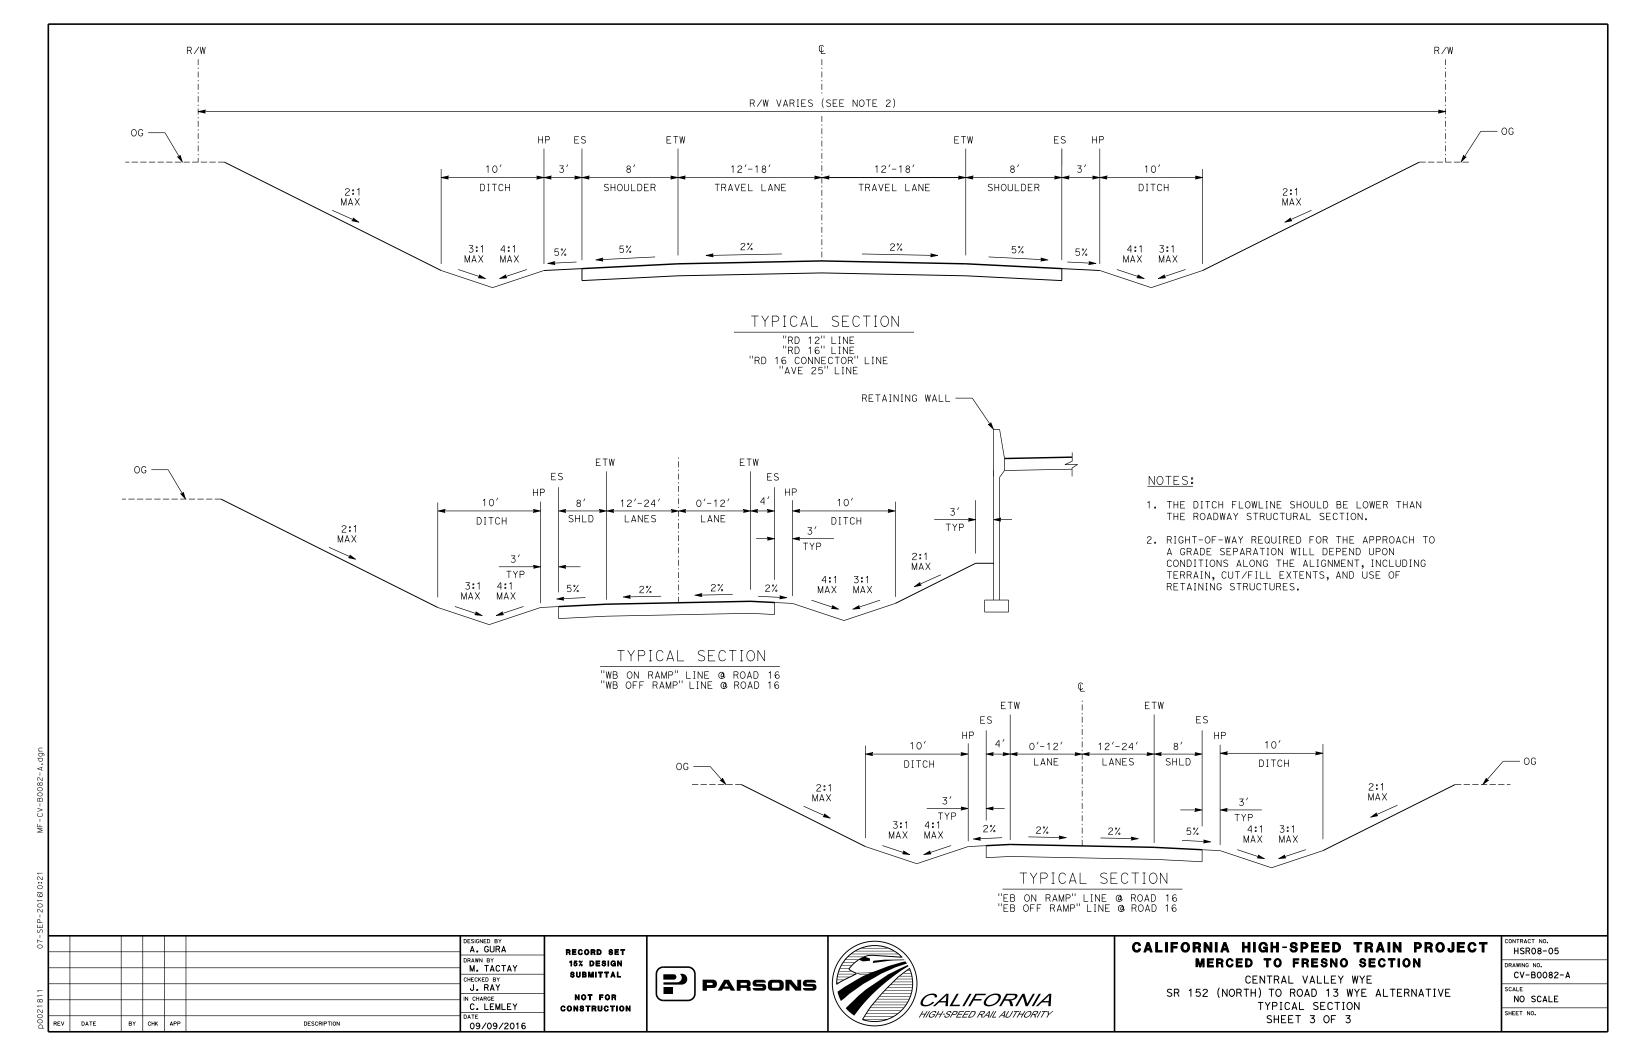

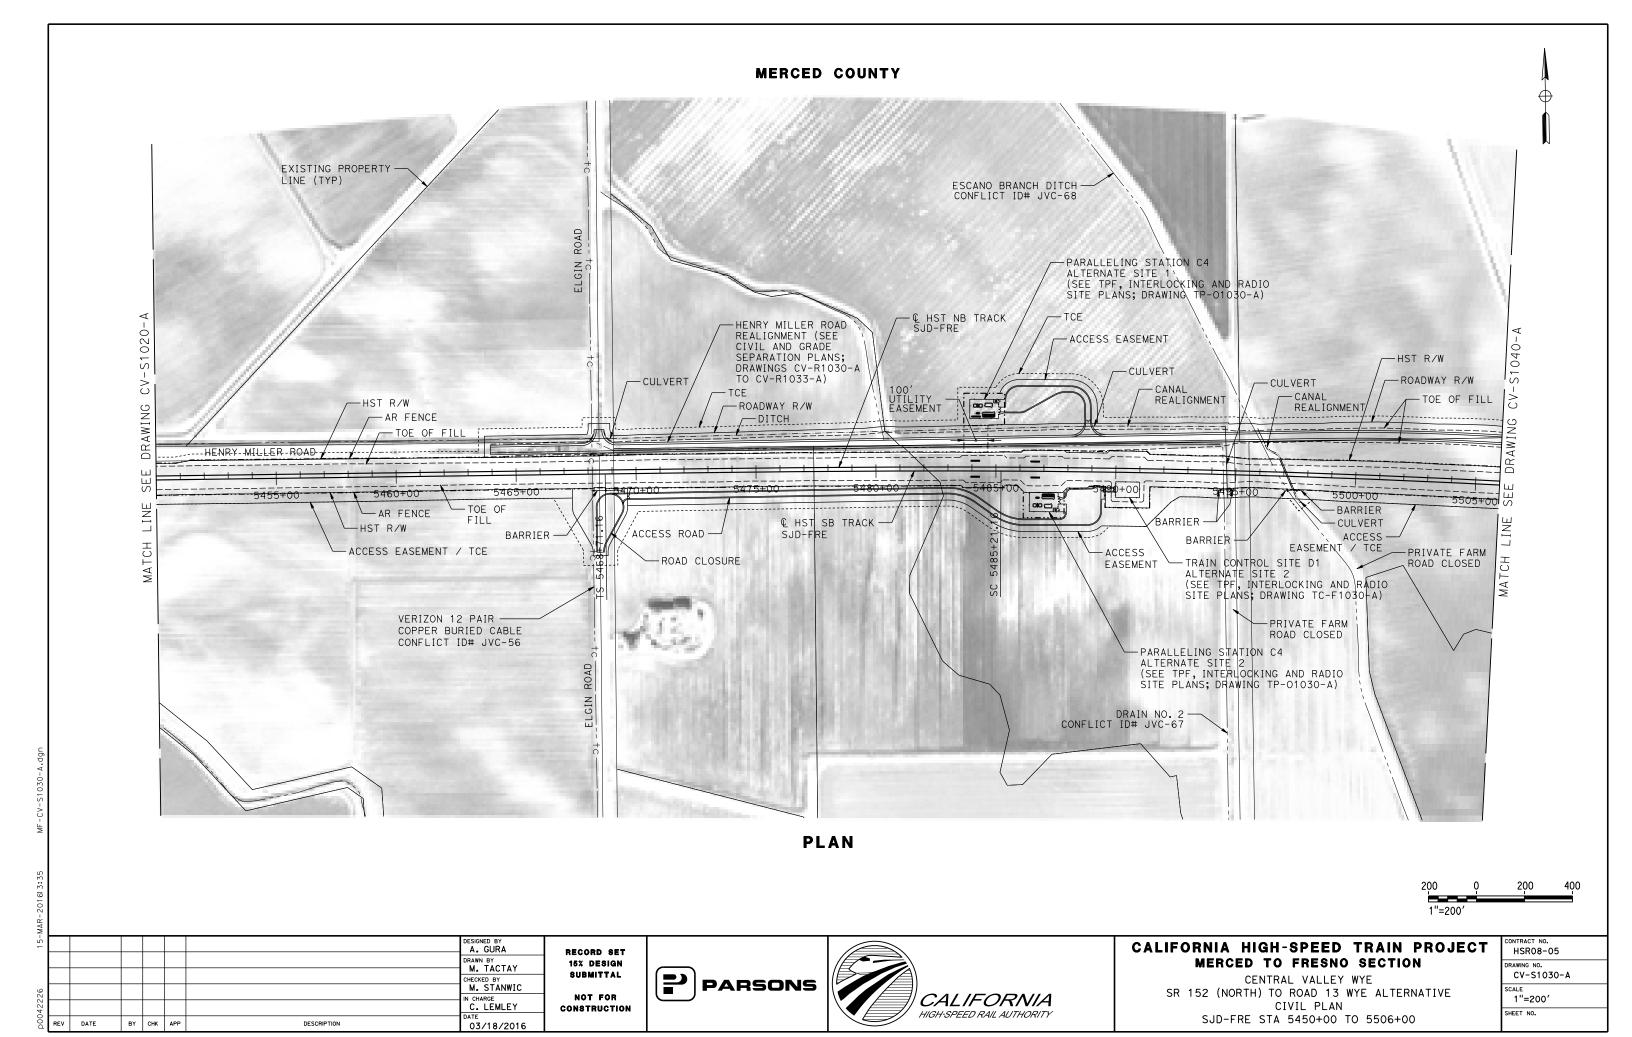

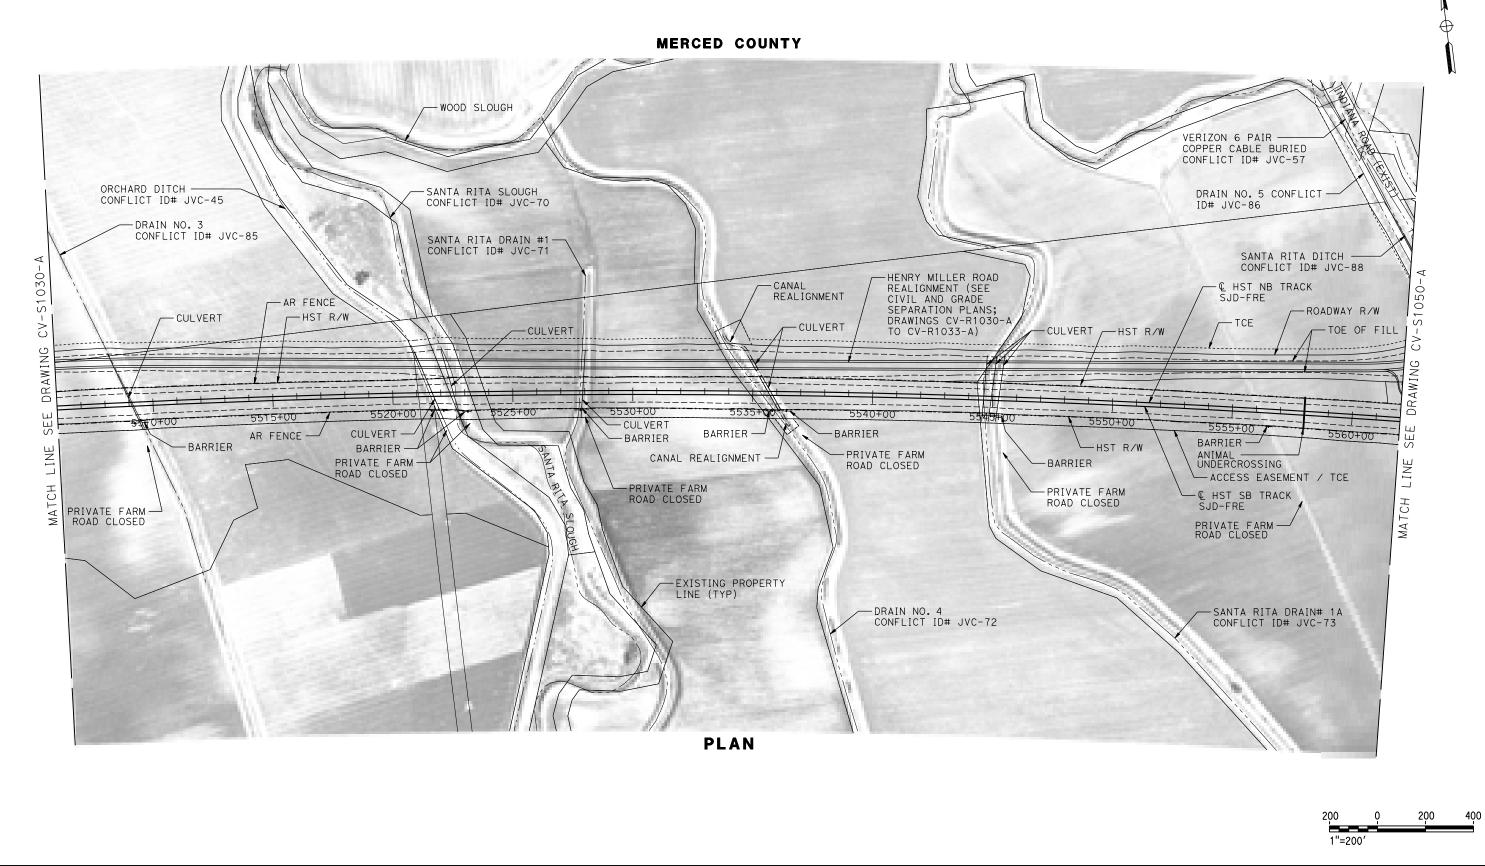

| DESIGNED BY A. GURA | DRAWN BY | M. TACTAY | CHECKED BY | M. STANWIC | IN CHARGE | C. LEMLEY | DATE | BY CHK | APP | DESCRIPTION | DATE | DATE | O 3/18/2016

RECORD SET
15% DESIGN
SUBMITTAL
NOT FOR
CONSTRUCTION






## CALIFORNIA HIGH-SPEED TRAIN PROJECT MERCED TO FRESNO SECTION

CENTRAL VALLEY WYE
SR 152 (NORTH) TO ROAD 13 WYE ALTERNATIVE
CIVIL PLAN
SJD-FRE STA 5506+00 TO 5562+00

CONTRACT NO.
HSR08-05
DRAWING NO.
CV-S1040-A
SCALE
1"=200'
SHEET NO.

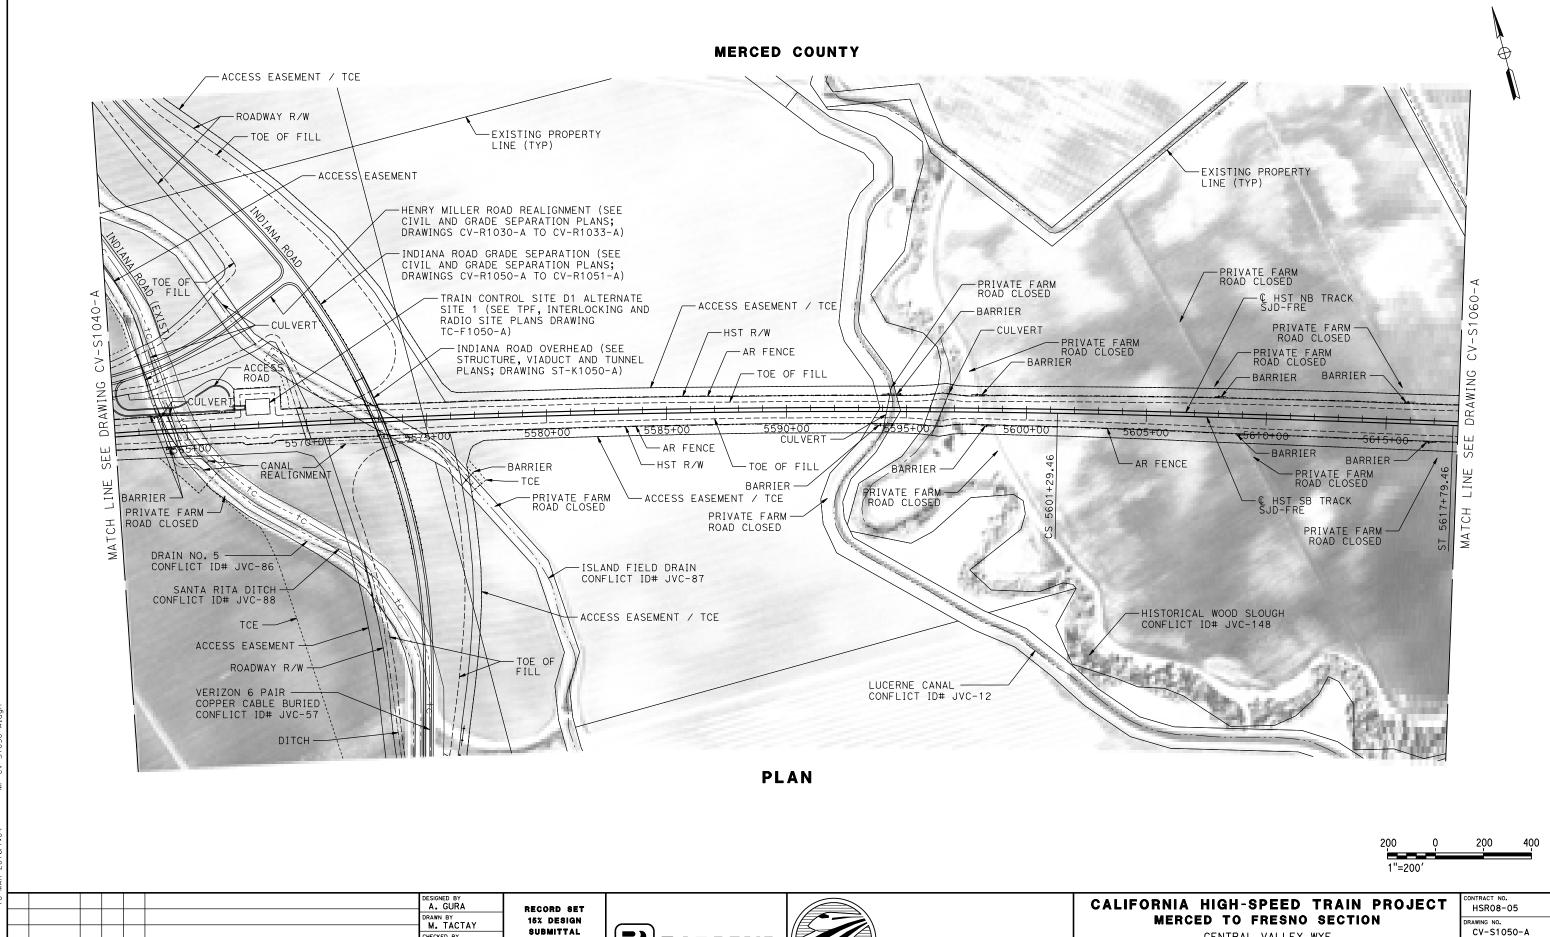

**PARSONS** 

**CALIFORNIA** 

HIGH-SPEED RAIL AUTHORITY

M. STANWIC

IN CHARGE
C. LEMLEY

03/18/2016

DATE

BY CHK APP

DESCRIPTION


NOT FOR

CONSTRUCTION

CENTRAL VALLEY WYE
SR 152 (NORTH) TO ROAD 13 WYE ALTERNATIVE
CIVIL PLAN
SJD-FRE STA 5562+00 TO 5618+00

1"=200'

SHEET NO.

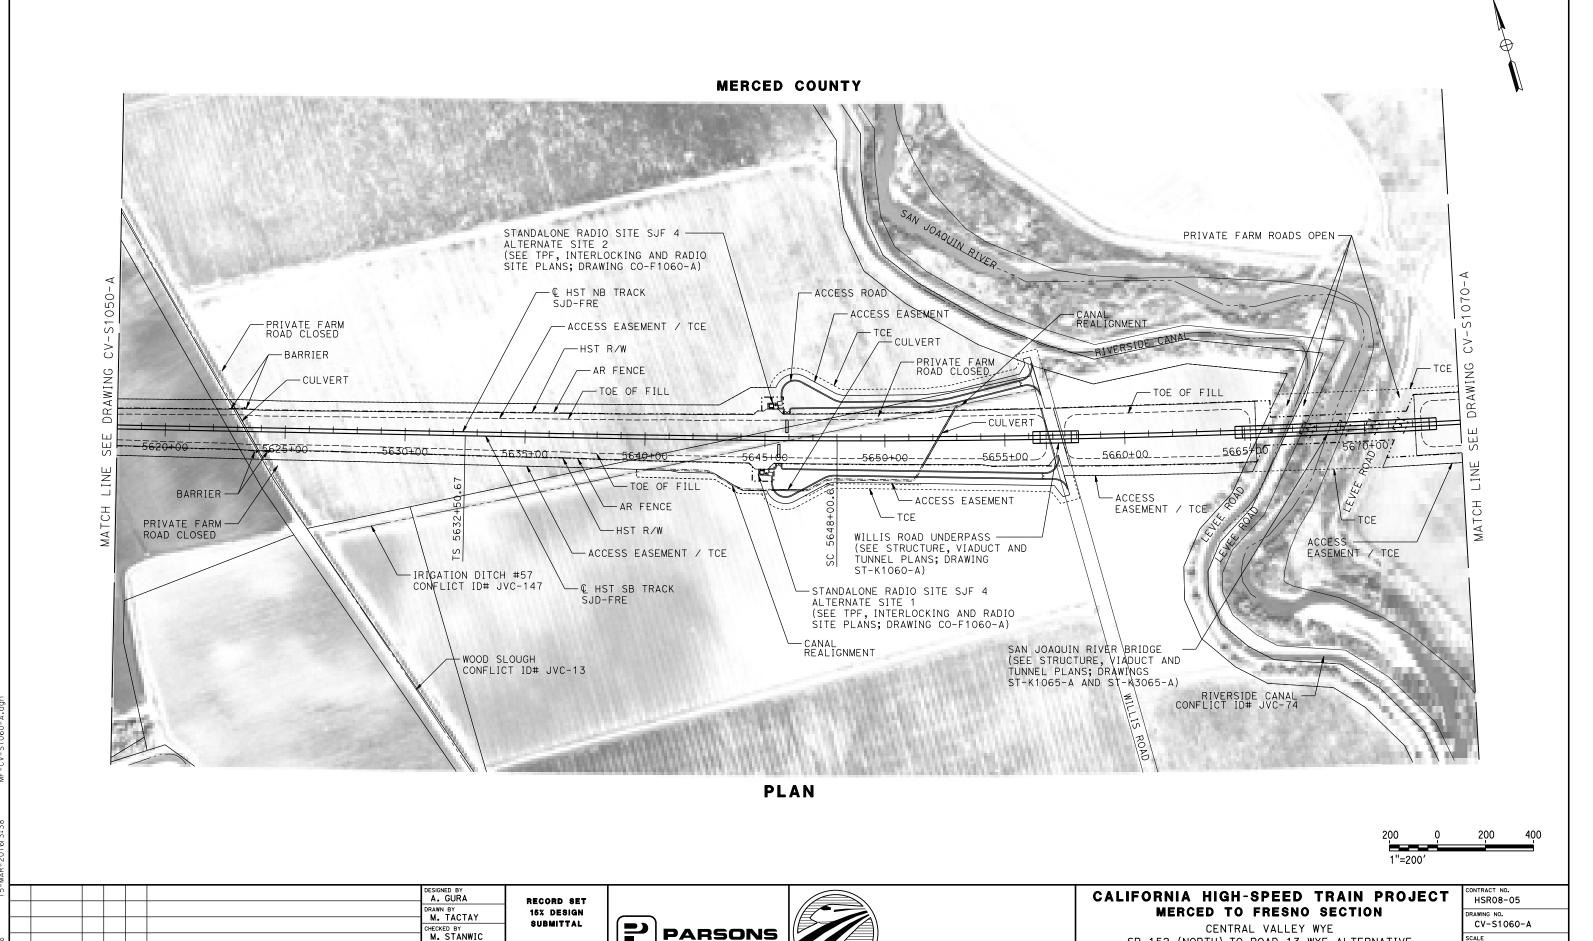

CALIFORNIA

HIGH-SPEED RAIL AUTHORITY

NOT FOR

CONSTRUCTION

IN CHARGE
C. LEMLEY

03/18/2016

BY CHK APP

DESCRIPTION


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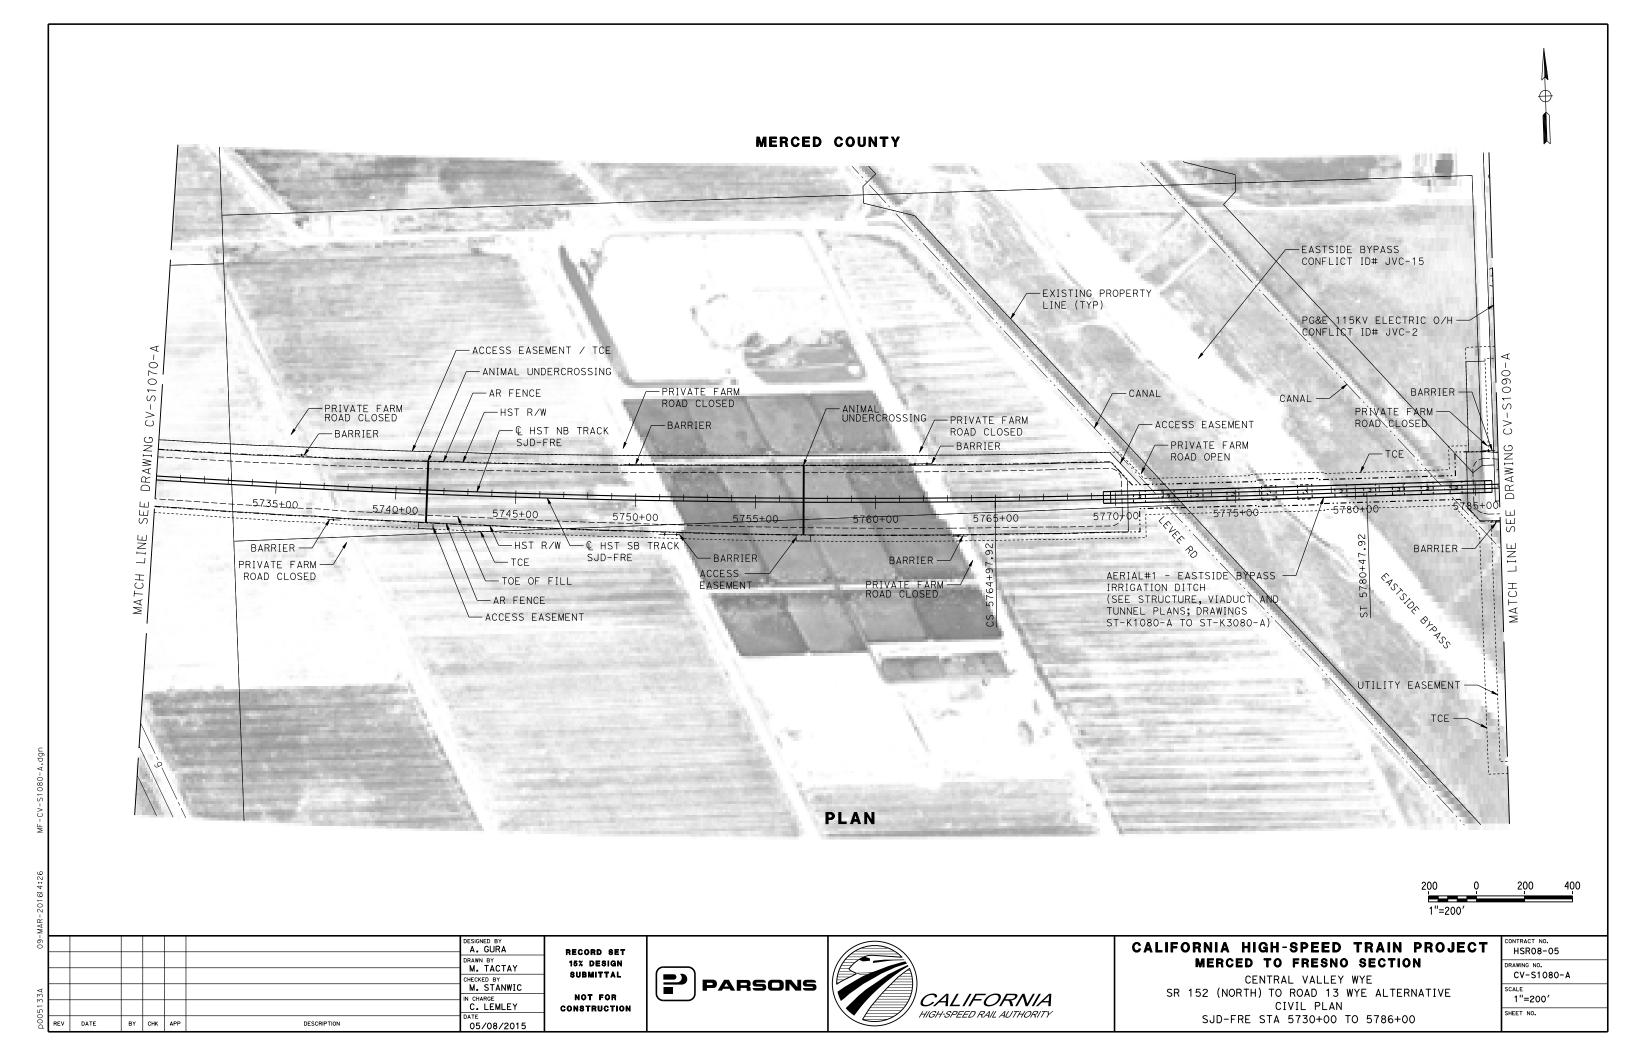
CIVIL PLAN


SJD-FRE STA 5618+00 TO 5674+00


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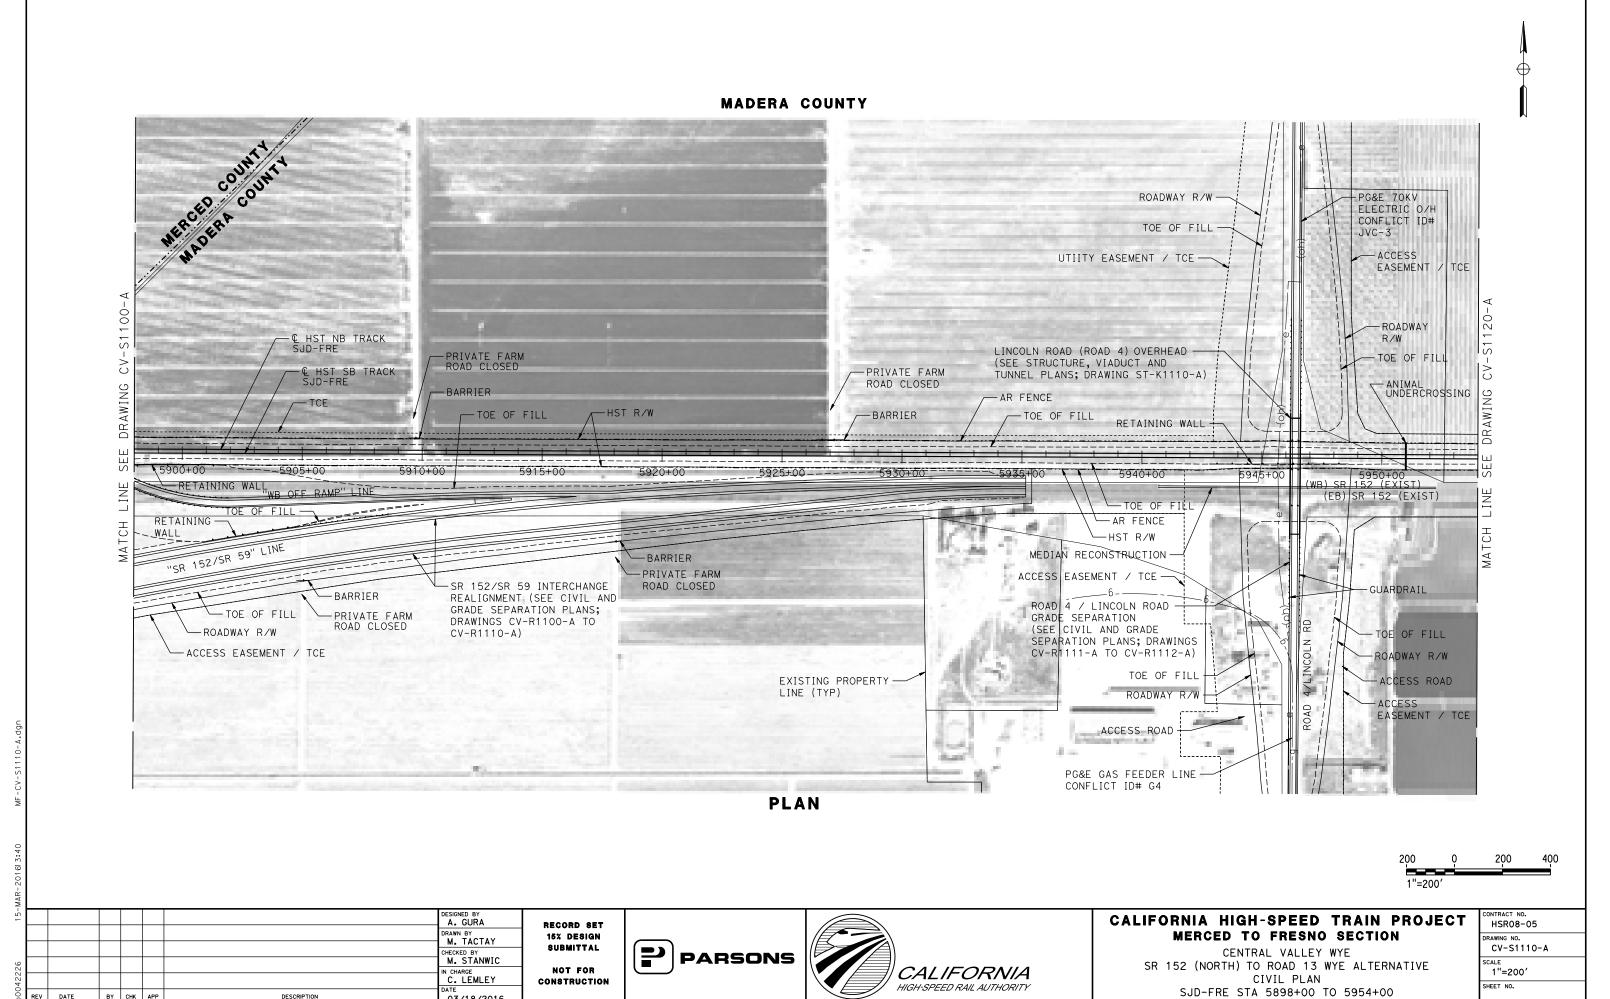
SHEET NO.





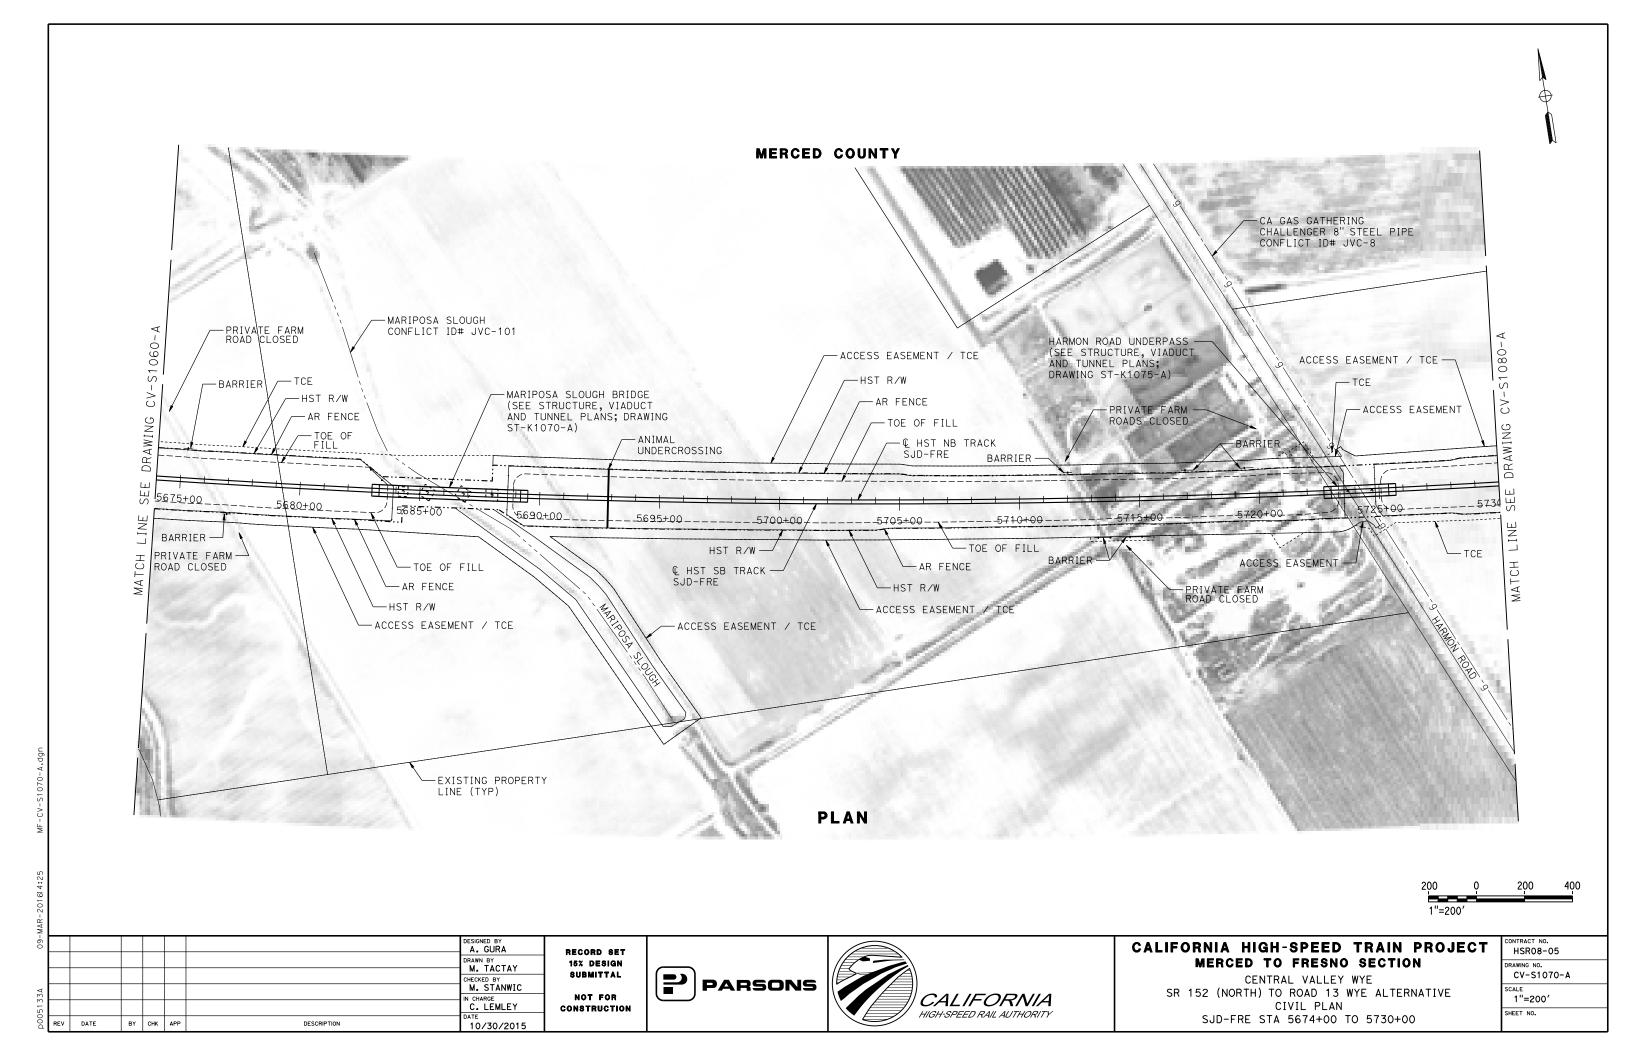

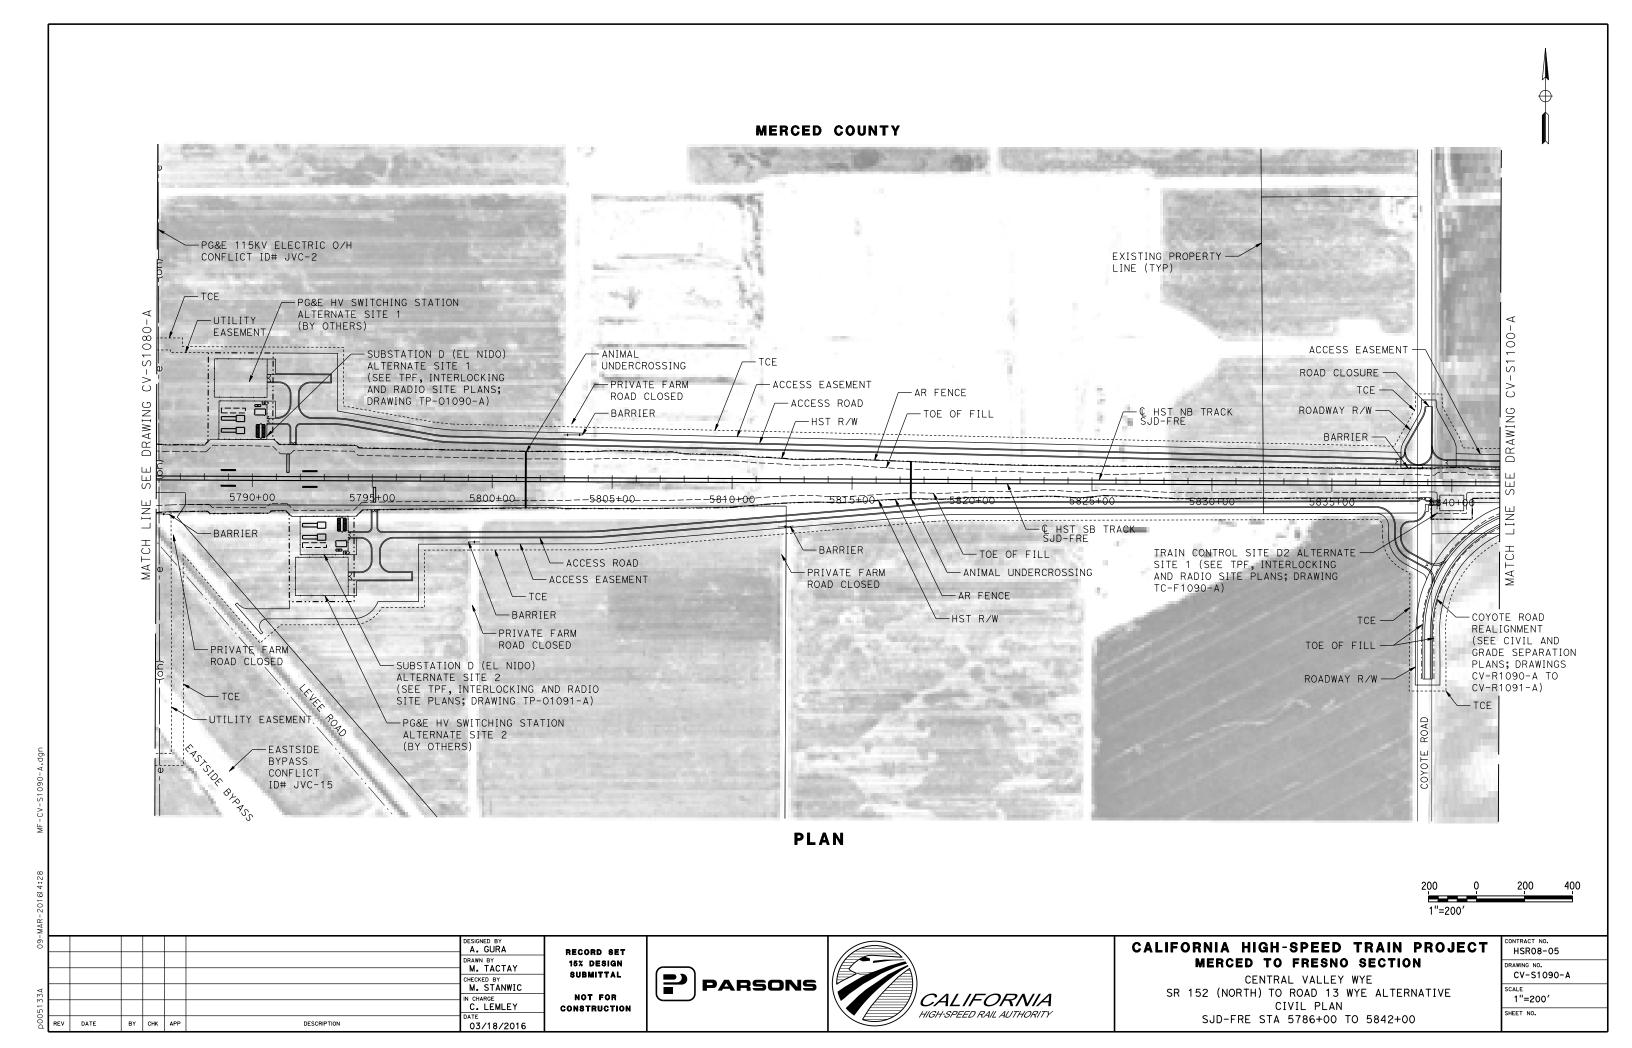


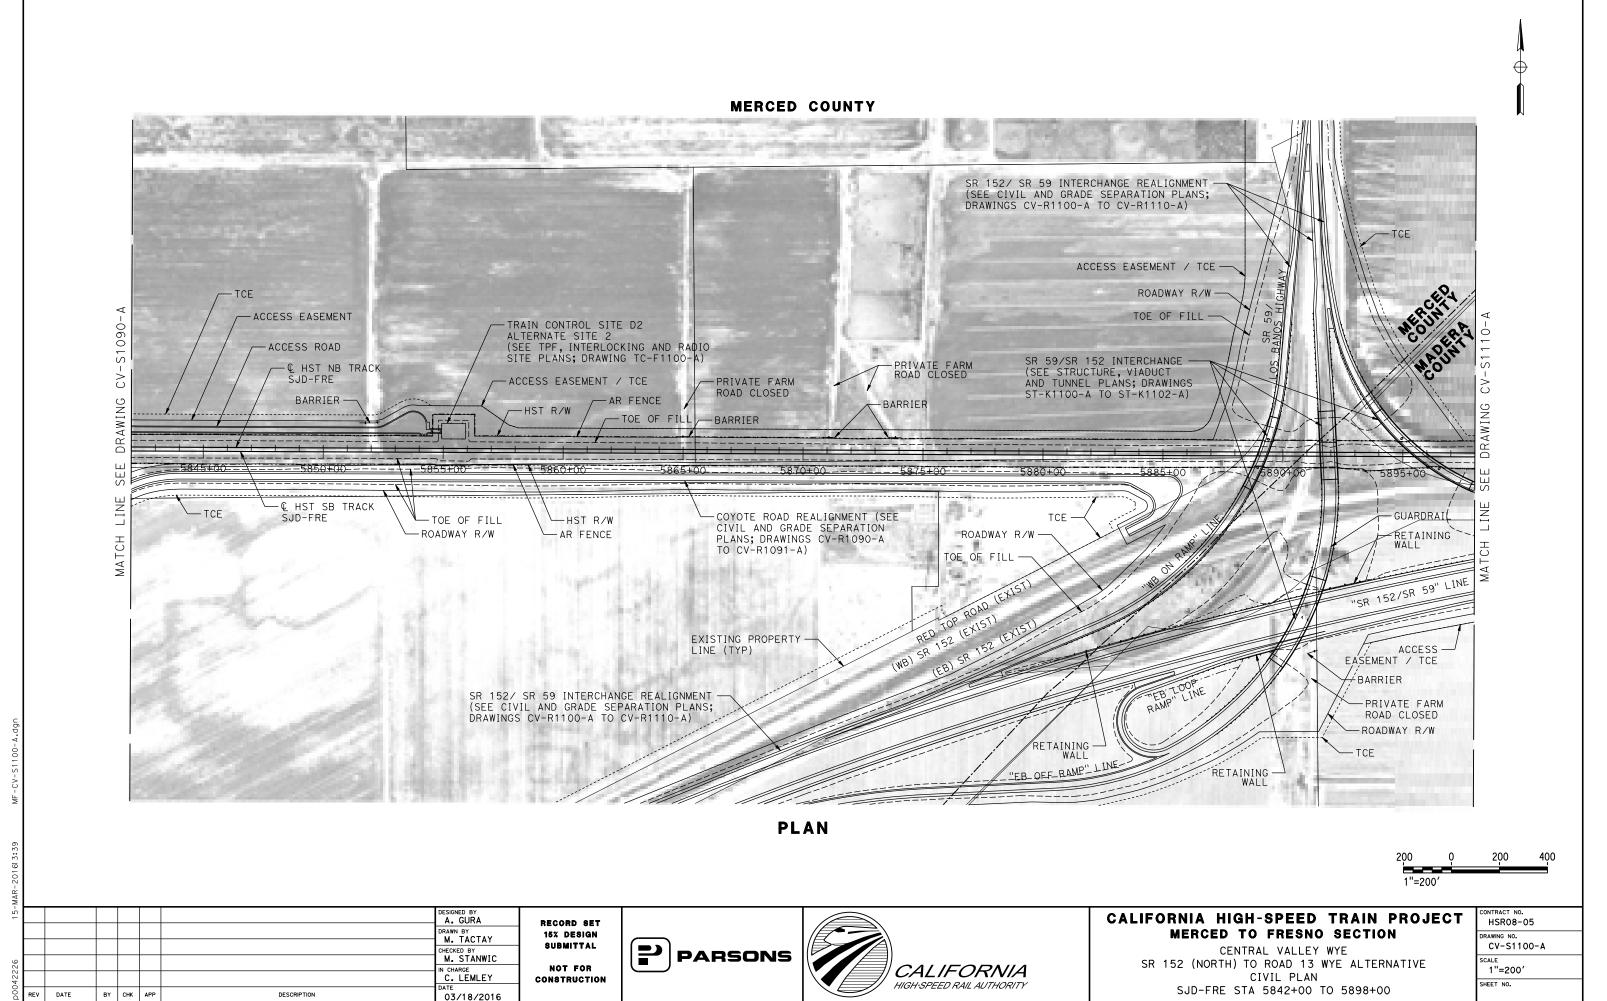



BY CHK APP

DESCRIPTION

03/18/2016

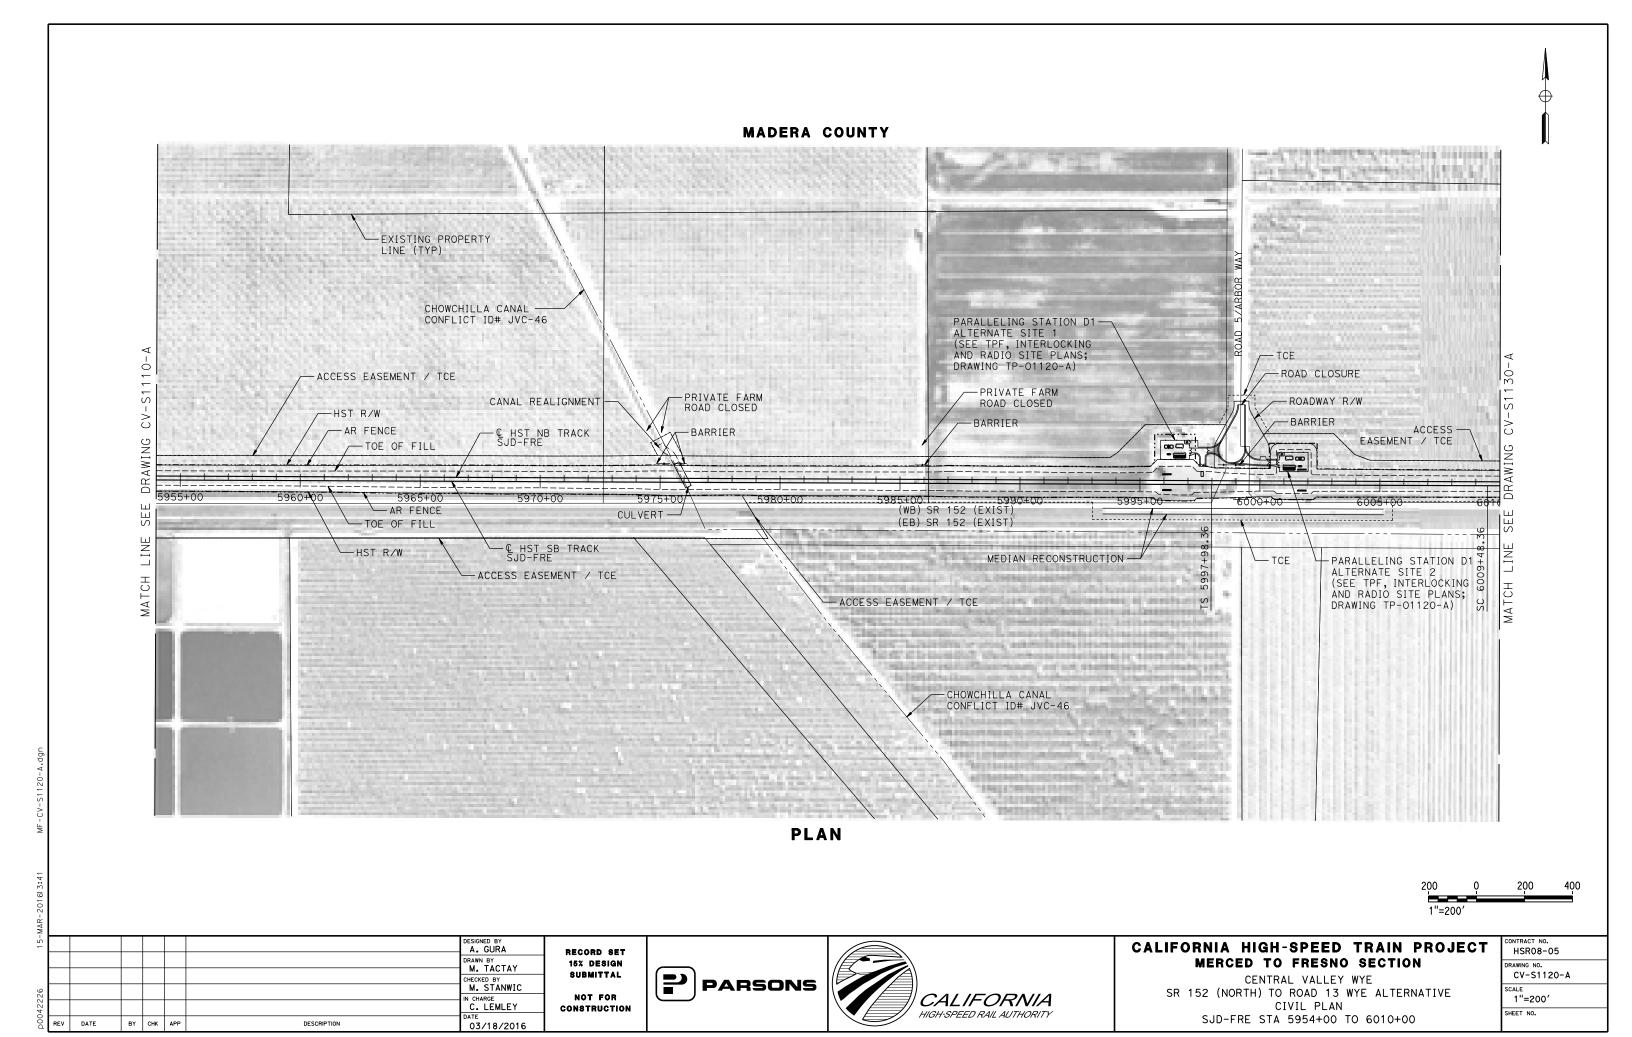

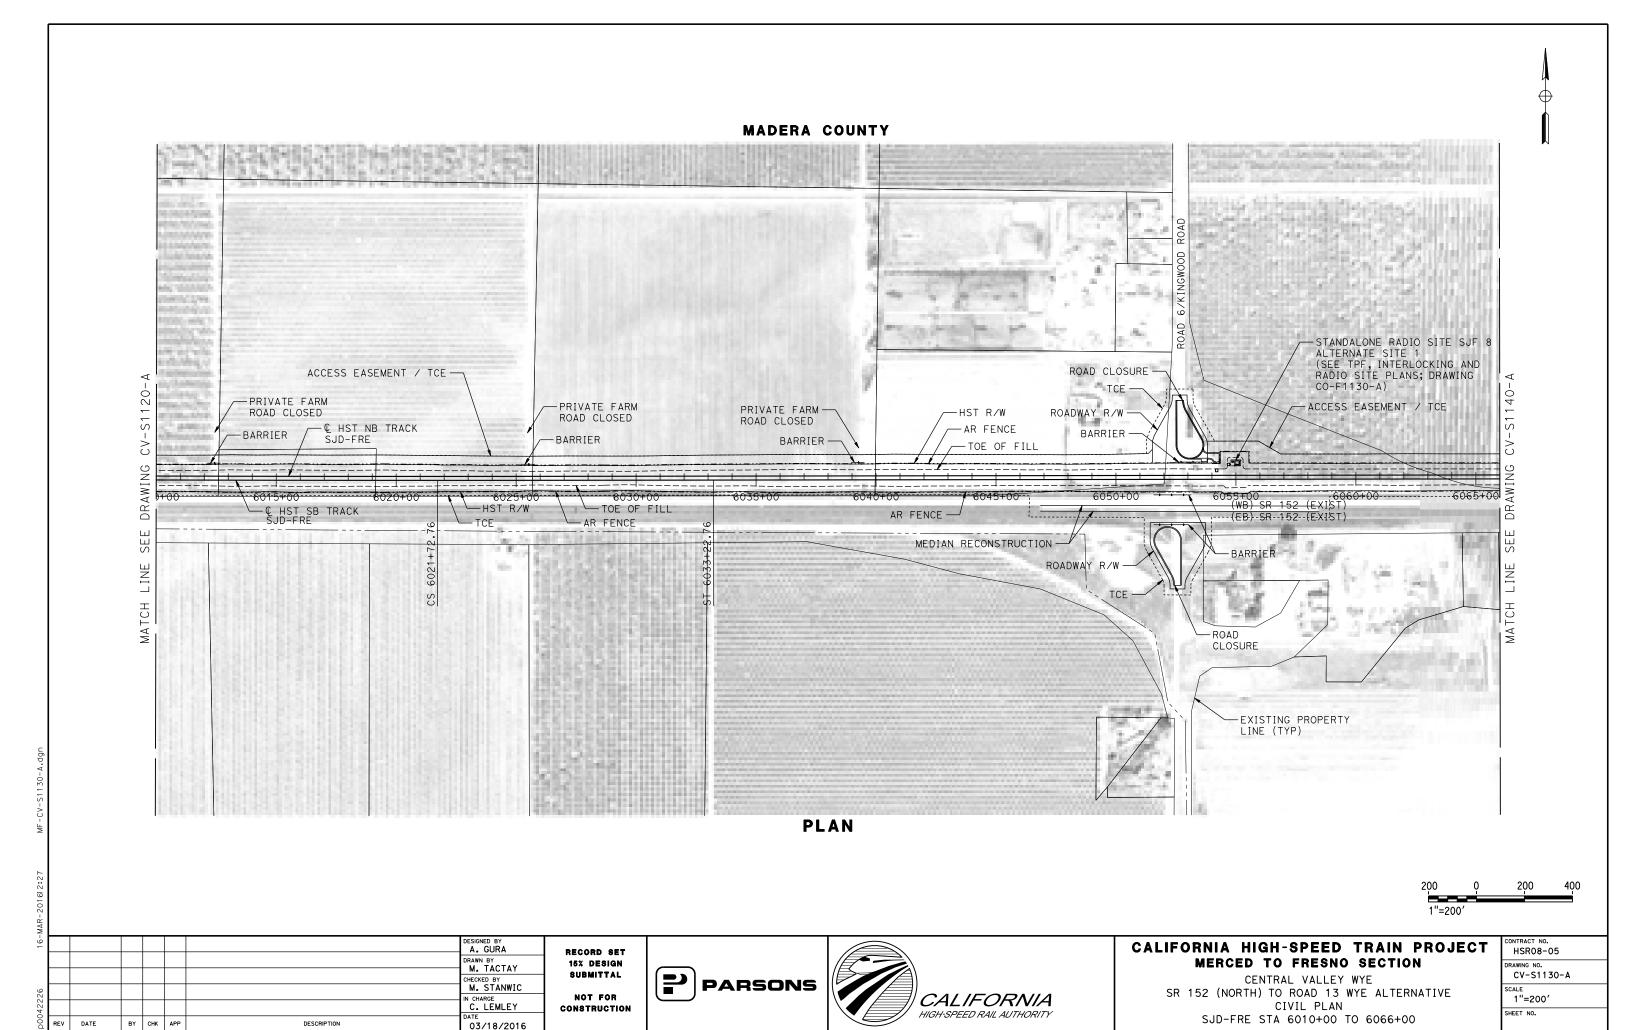


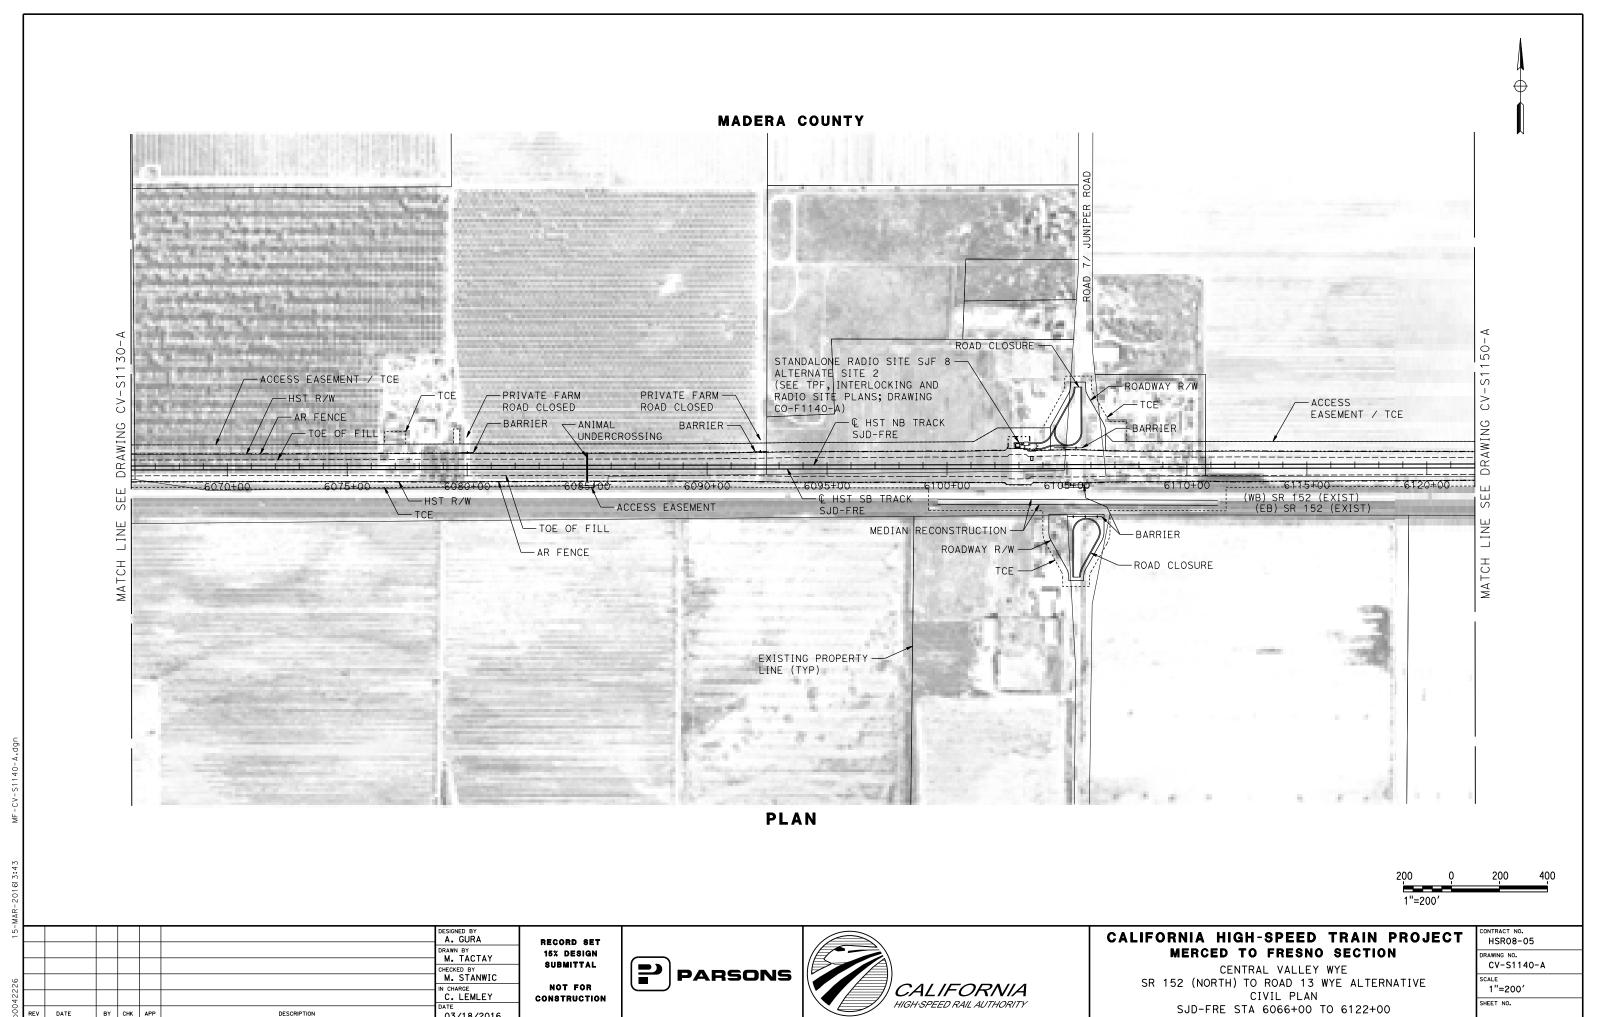


BY CHK APP

DESCRIPTION

03/18/2016

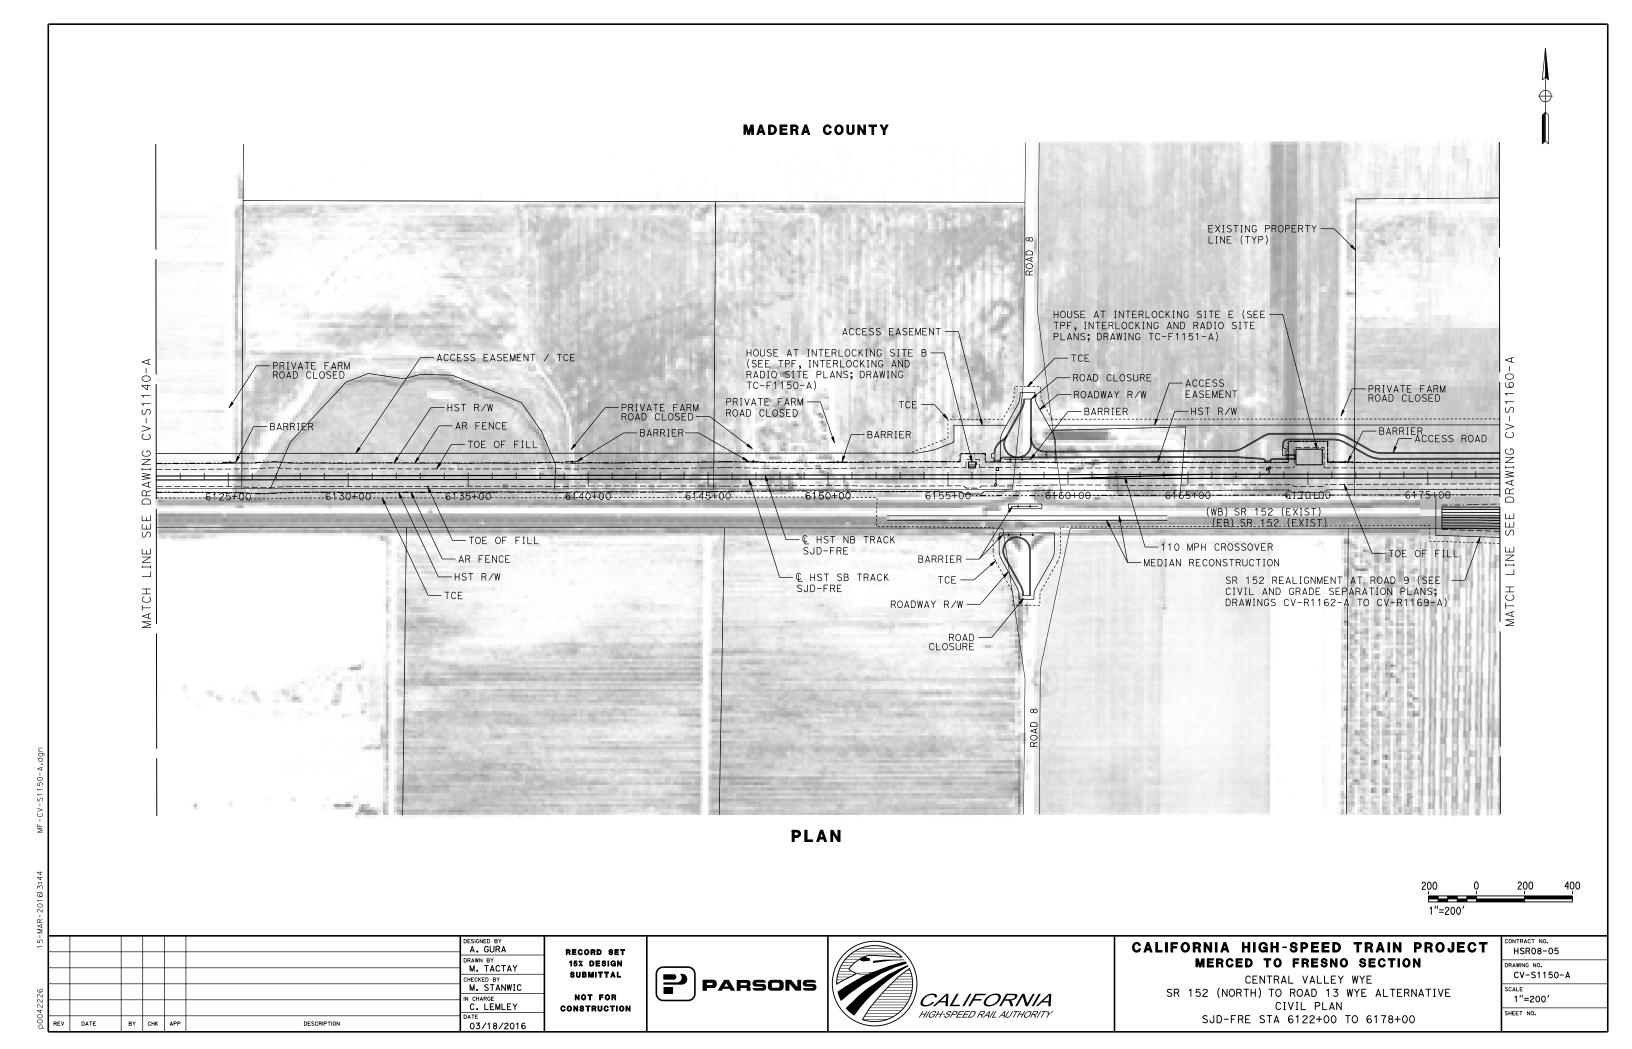

#### MADERA COUNTY

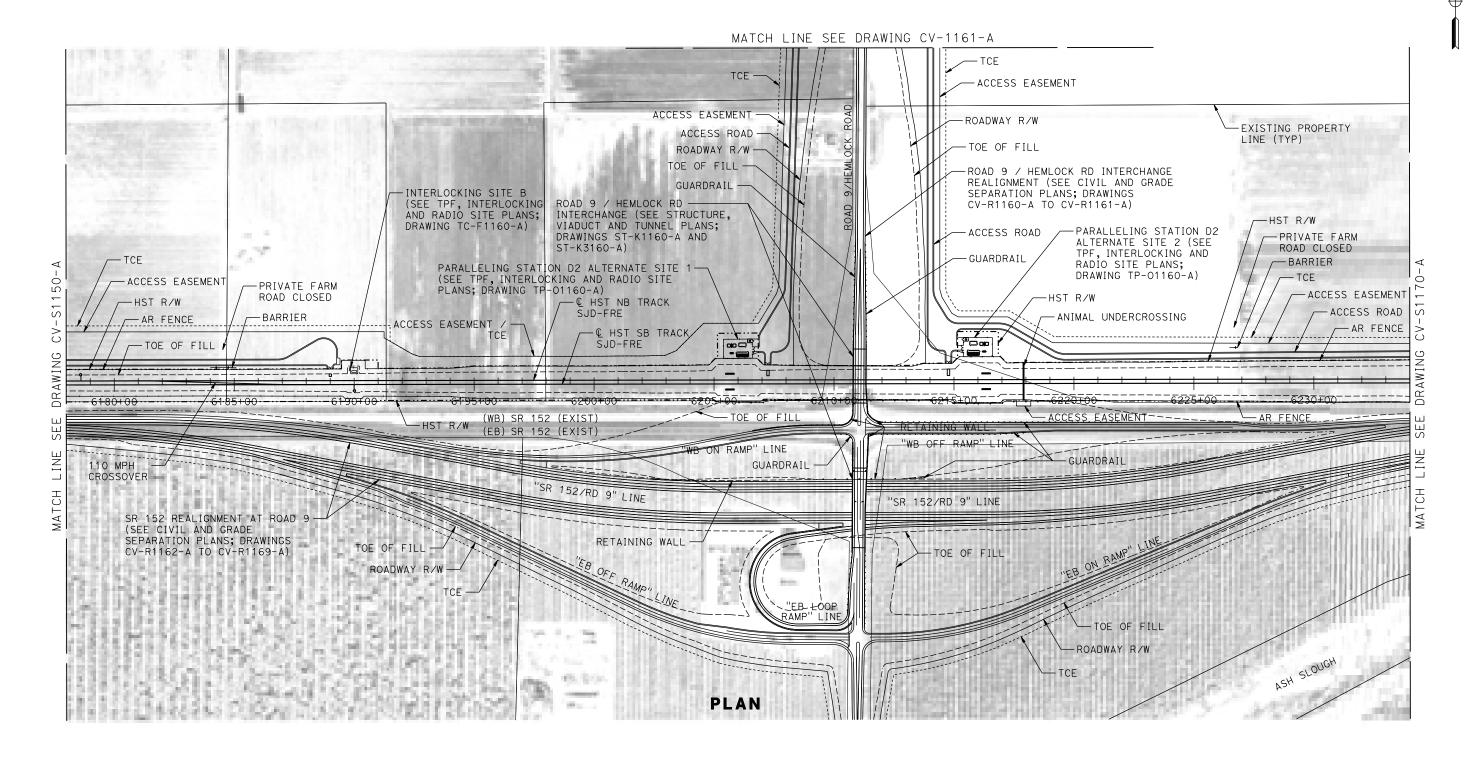

200	Q	200	400	
1"=20	0'			

-								
16-							DESIGNED BY A. GURA	R
							DRAWN BY M. TACTAY	"
							CHECKED BY	!
226							M. STANWIC IN CHARGE	
42							C. LEMLEY	Co
D00	REV	DATE	BY	снк	APP	DESCRIPTION	03/18/2016	

RECORD SET
15% DESIGN
SUBMITTAL
NOT FOR
CONSTRUCTION








#### CALIFORNIA HIGH-SPEED TRAIN PROJECT MERCED TO FRESNO SECTION

CENTRAL VALLEY WYE
SR 152 (NORTH) TO ROAD 13 WYE ALTERNATIVE
CIVIL PLAN
SJD-FRE STA 6178+00 TO 6234+00

CONTRACT NO. HSR08-05
DRAWING NO. CV-S1160-A
1"=200'
SHEET NO.

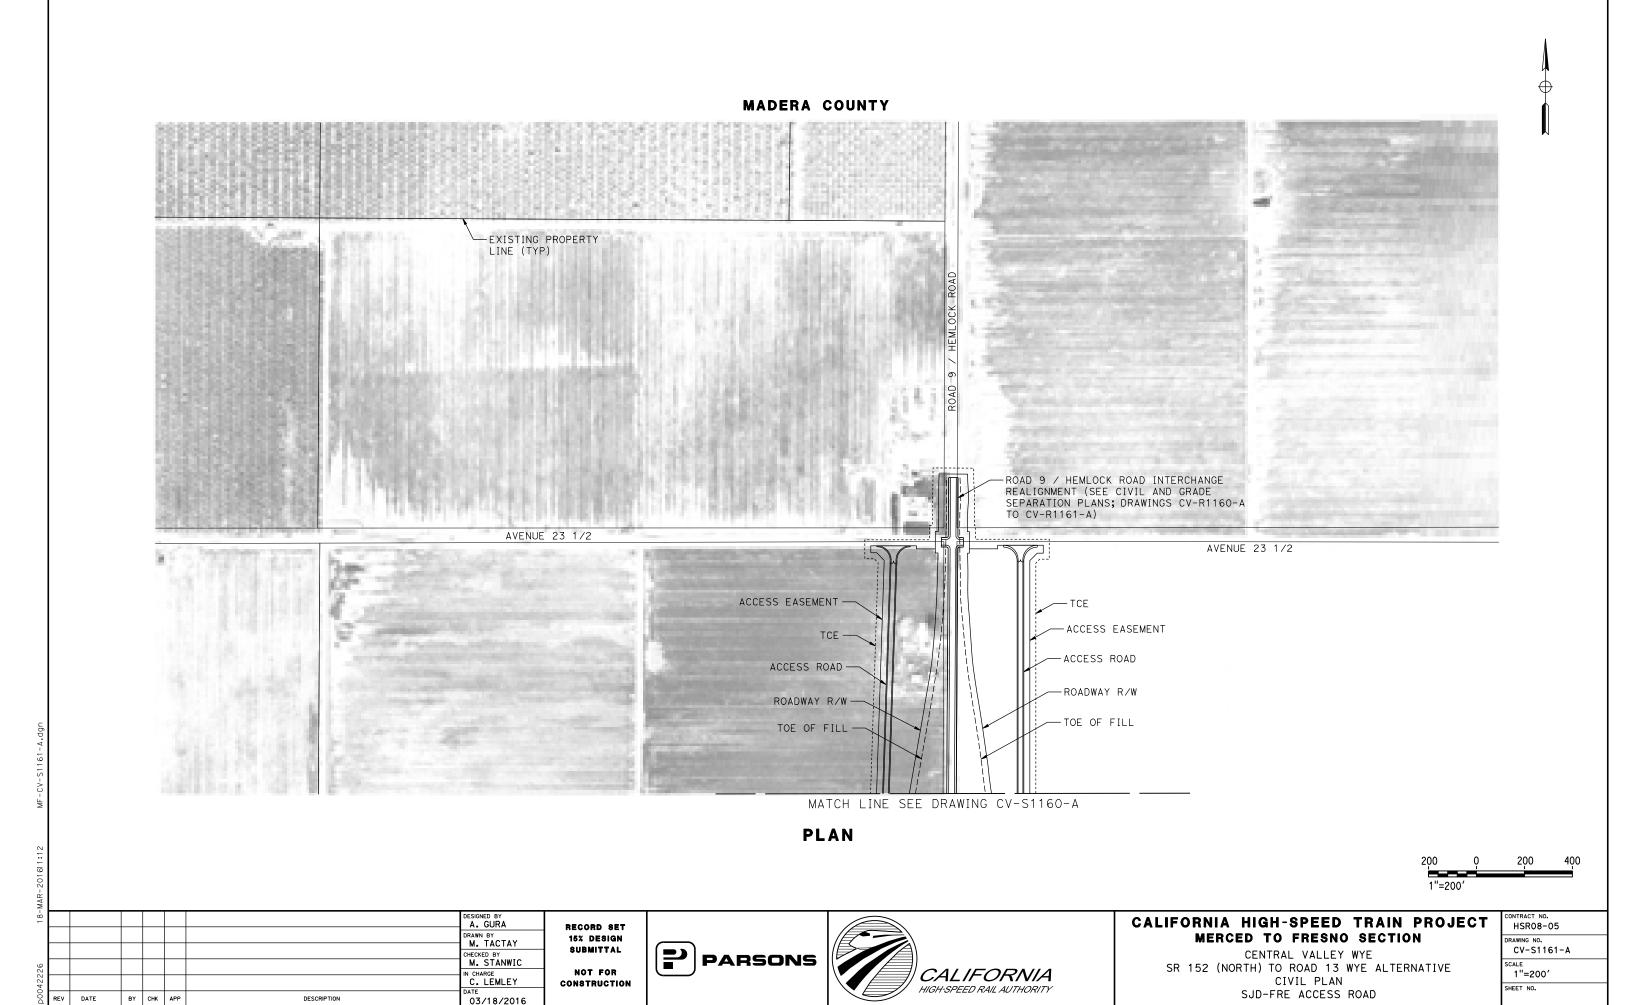

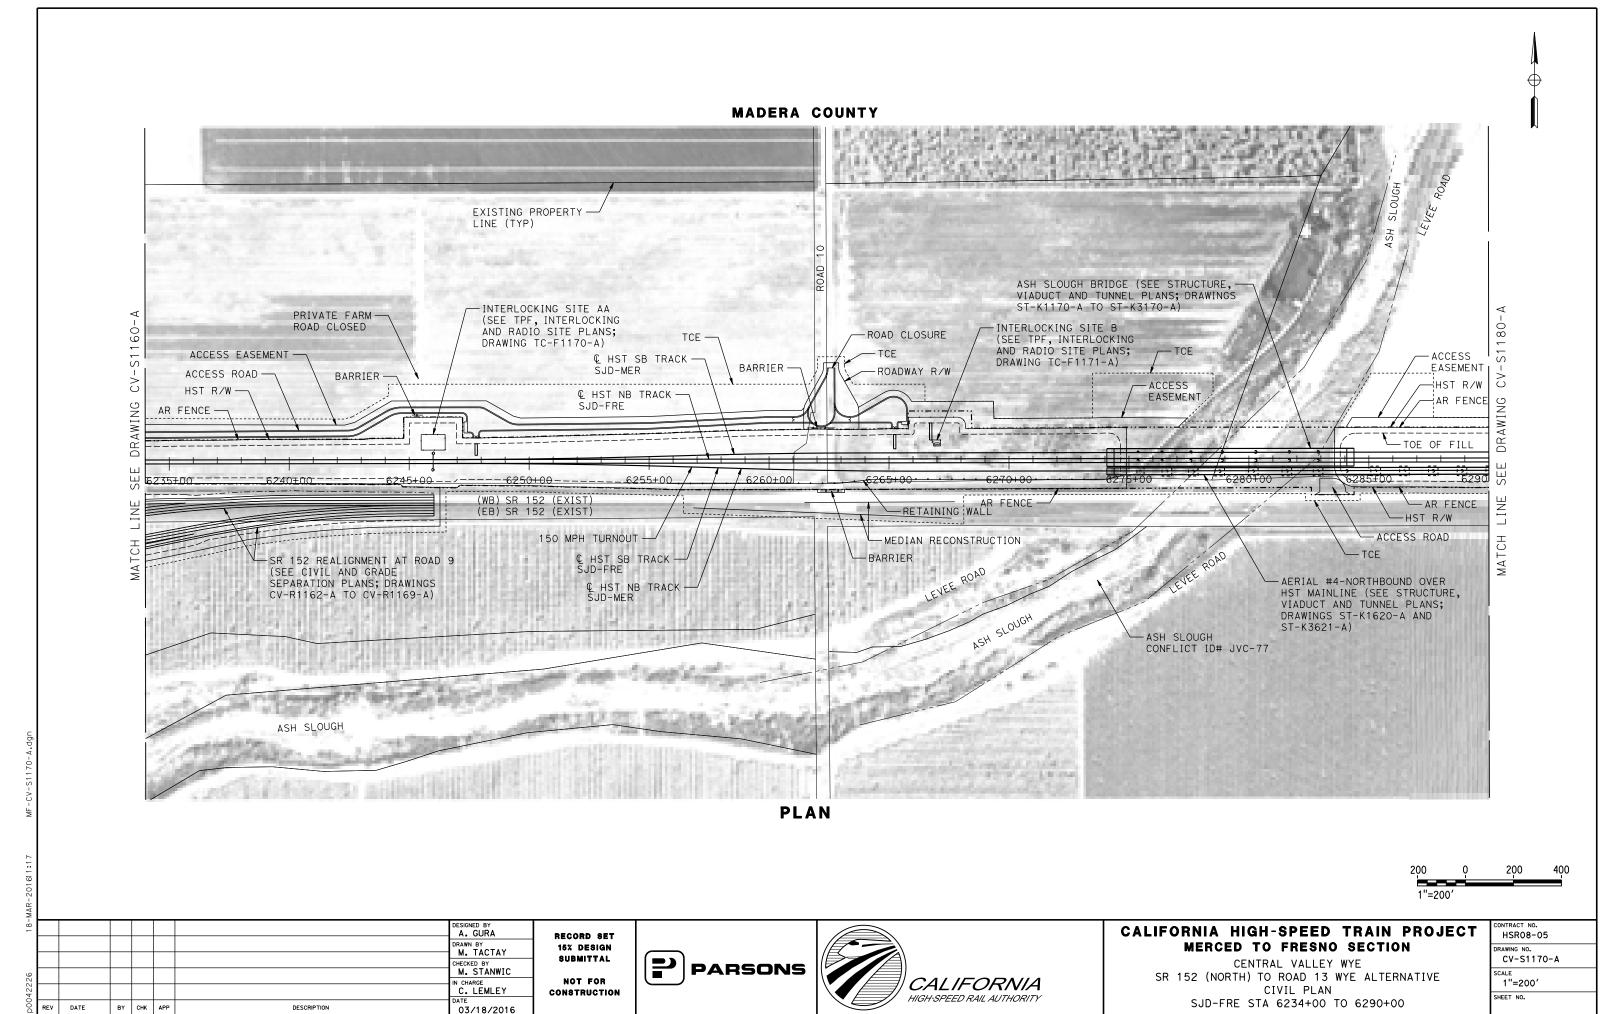

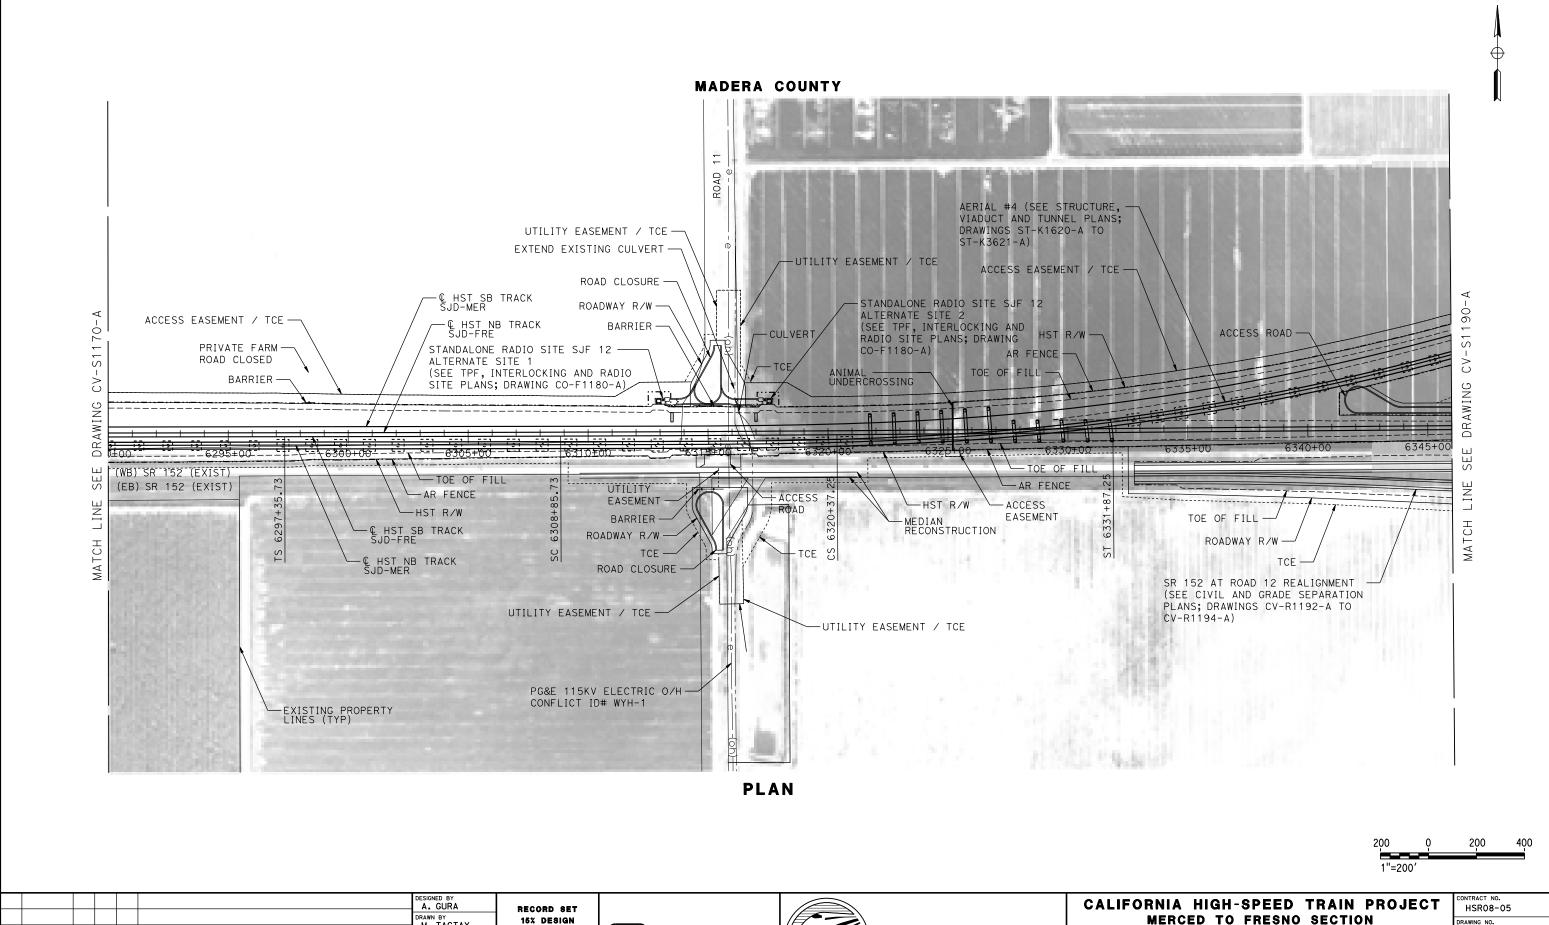

DRAWN BY
M. TACTAY M. STANWIC IN CHARGE
C. LEMLEY CONSTRUCTION BY CHK APP DESCRIPTION 03/18/2016

SUBMITTAL

NOT FOR






#### MERCED TO FRESNO SECTION

CENTRAL VALLEY WYE SR 152 (NORTH) TO ROAD 13 WYE ALTERNATIVE CIVIL PLAN SJD-FRE STA 6290+00 TO 6346+00

CONTRACT NO. HSR08-05						
DRAWING NO. CV-S1180-A						
1"=200'						
SHEET NO.						

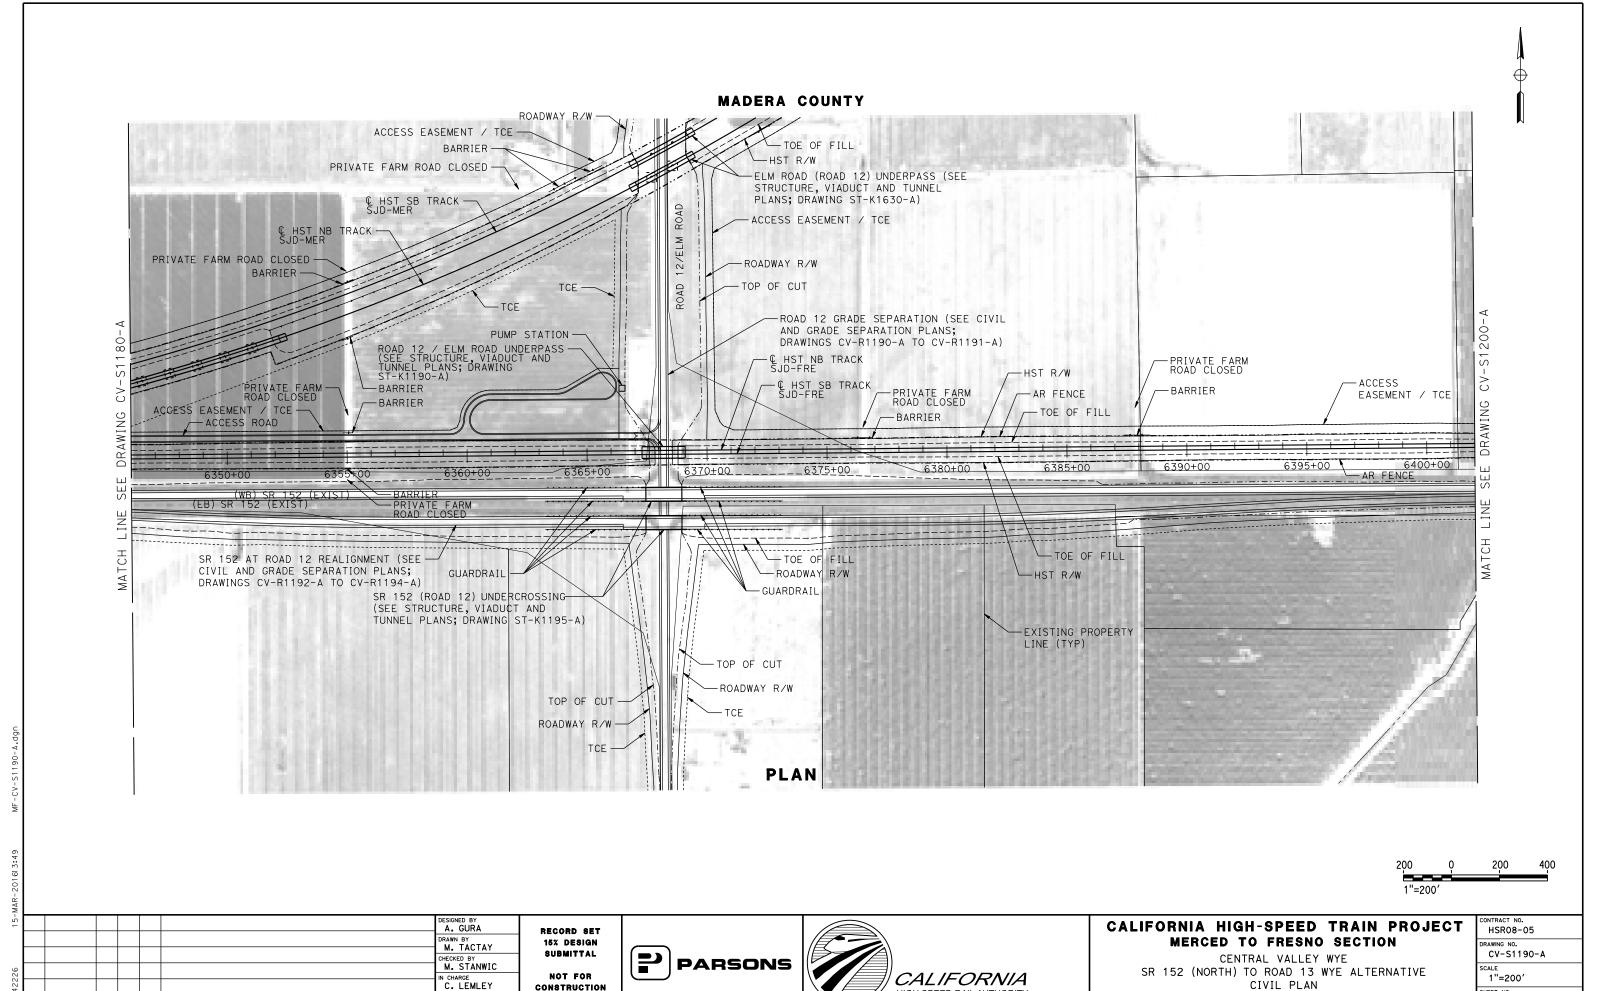

BY CHK APP


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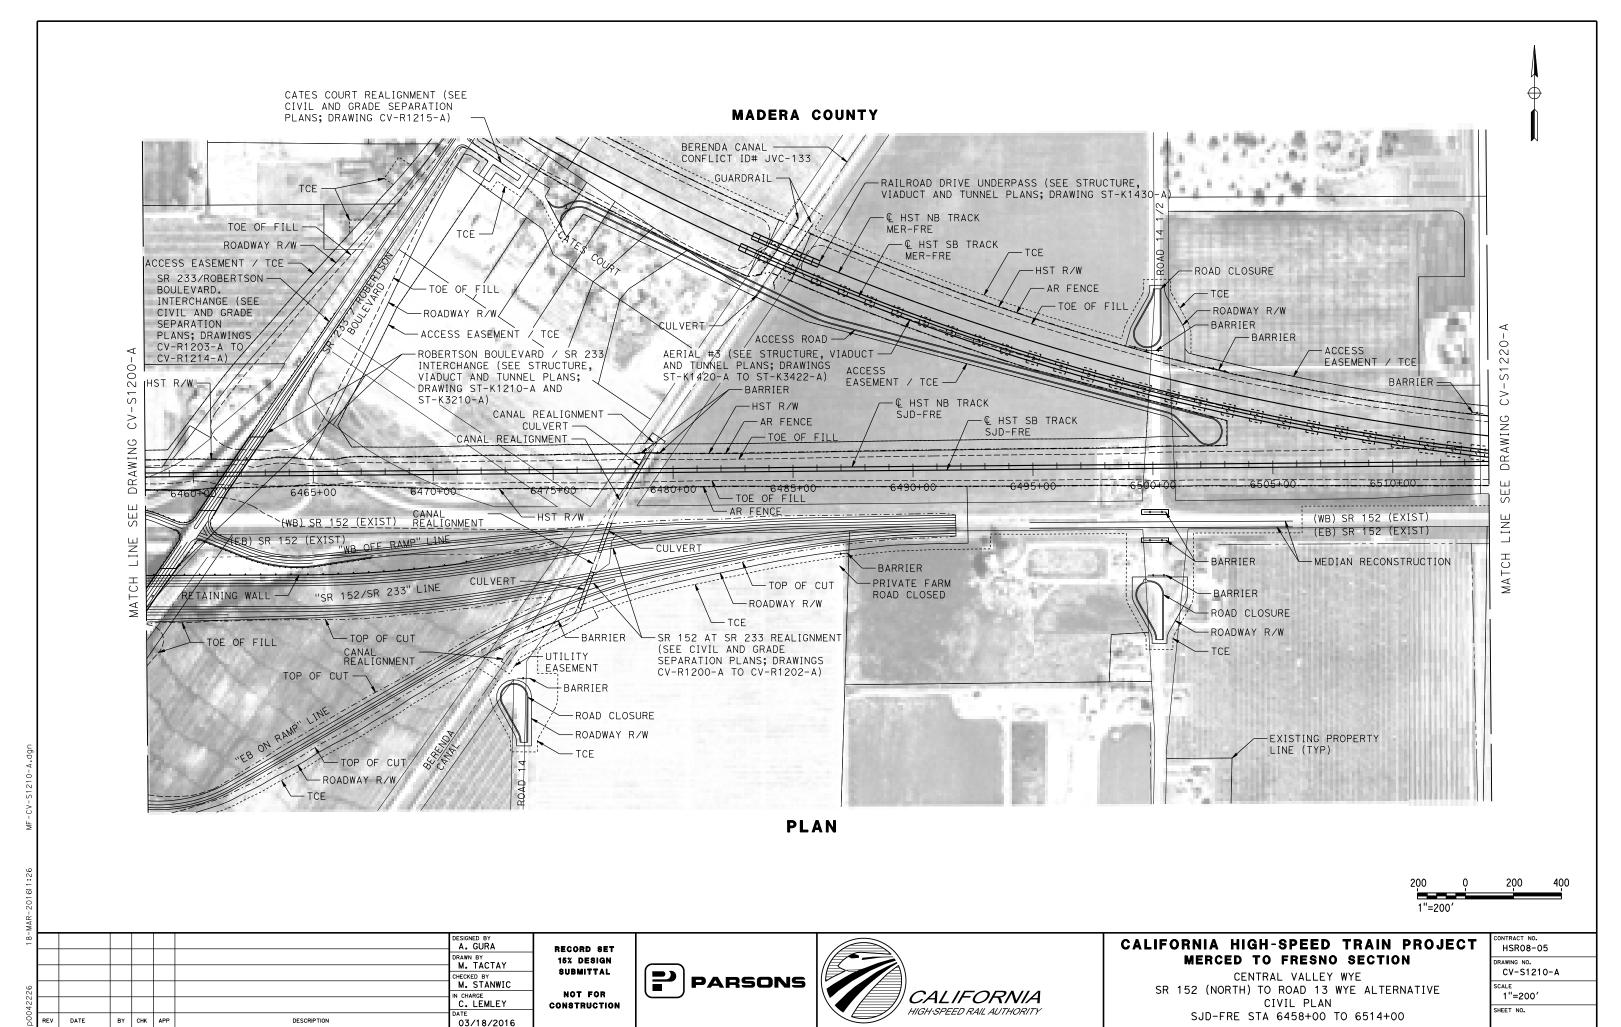
03/18/2016


HIGH-SPEED RAIL AUTHORITY


SHEET NO.


SJD-FRE STA 6346+00 TO 6402+00




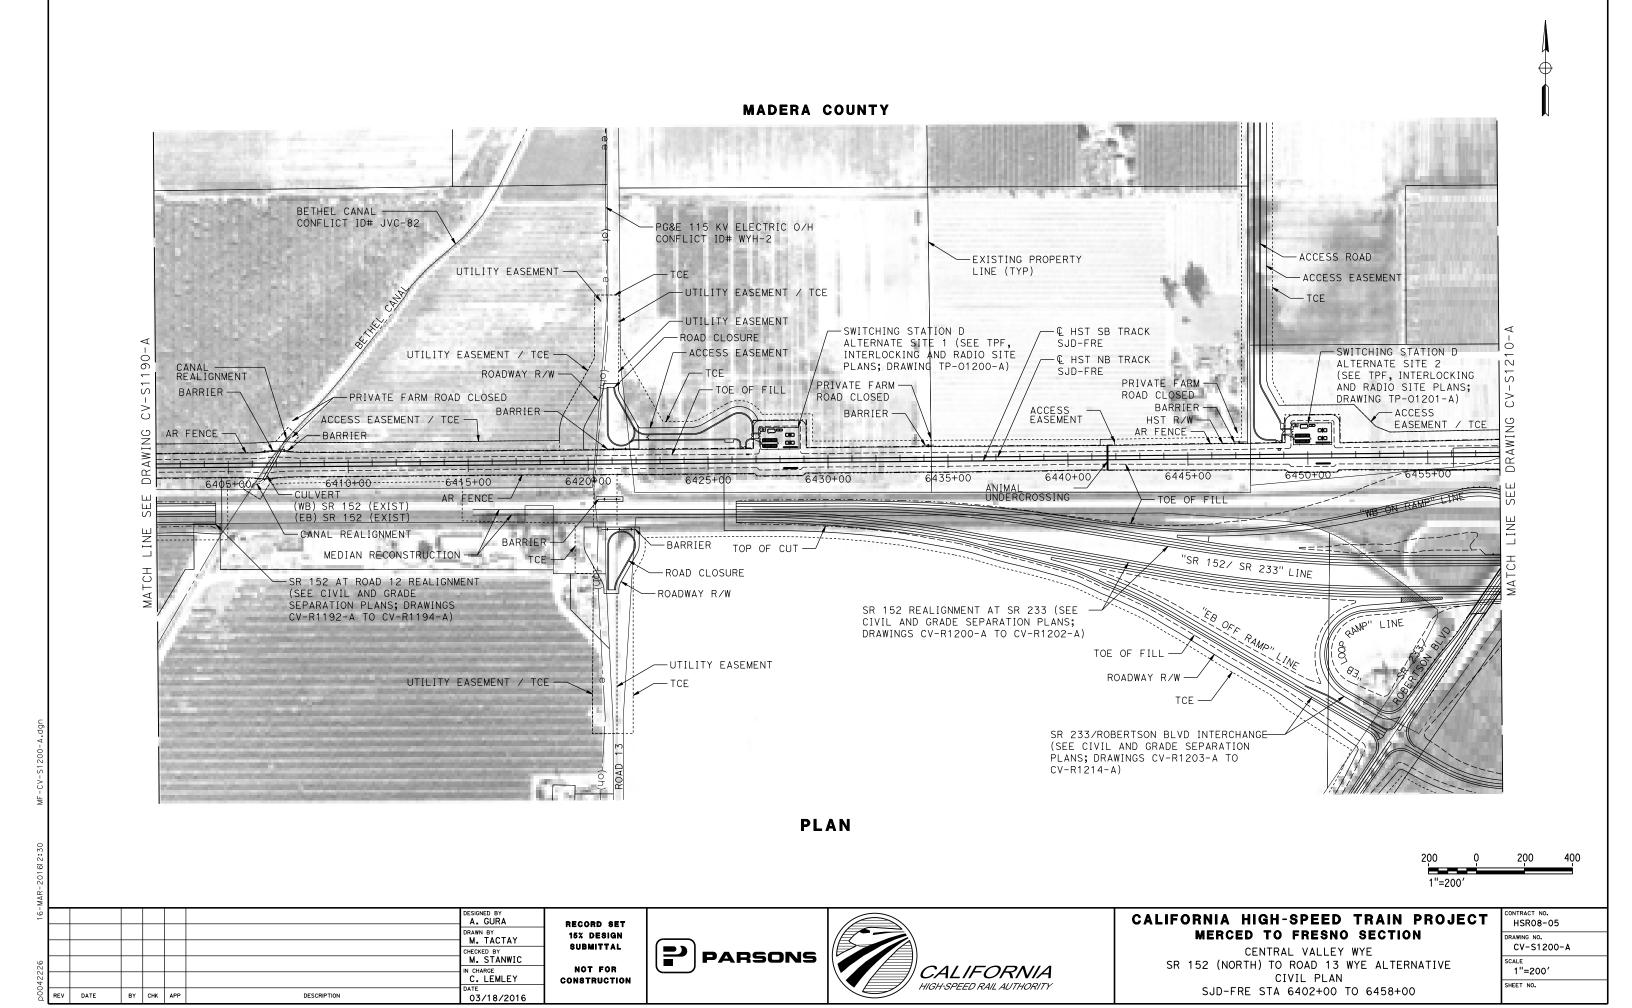


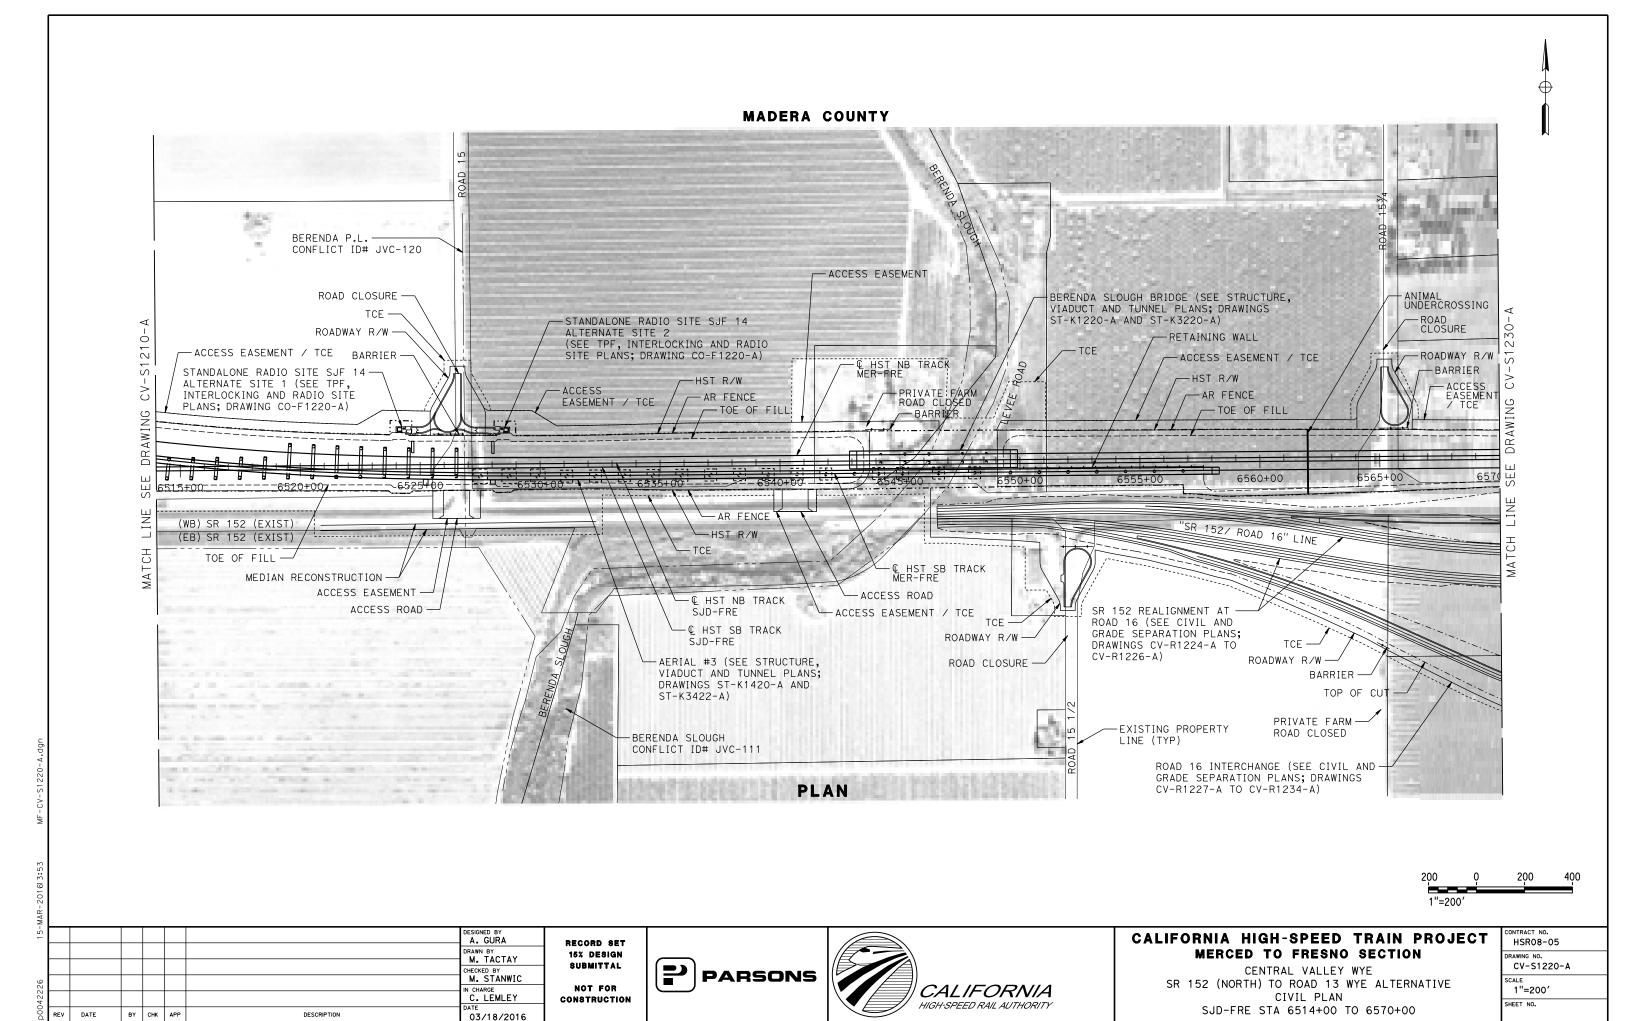

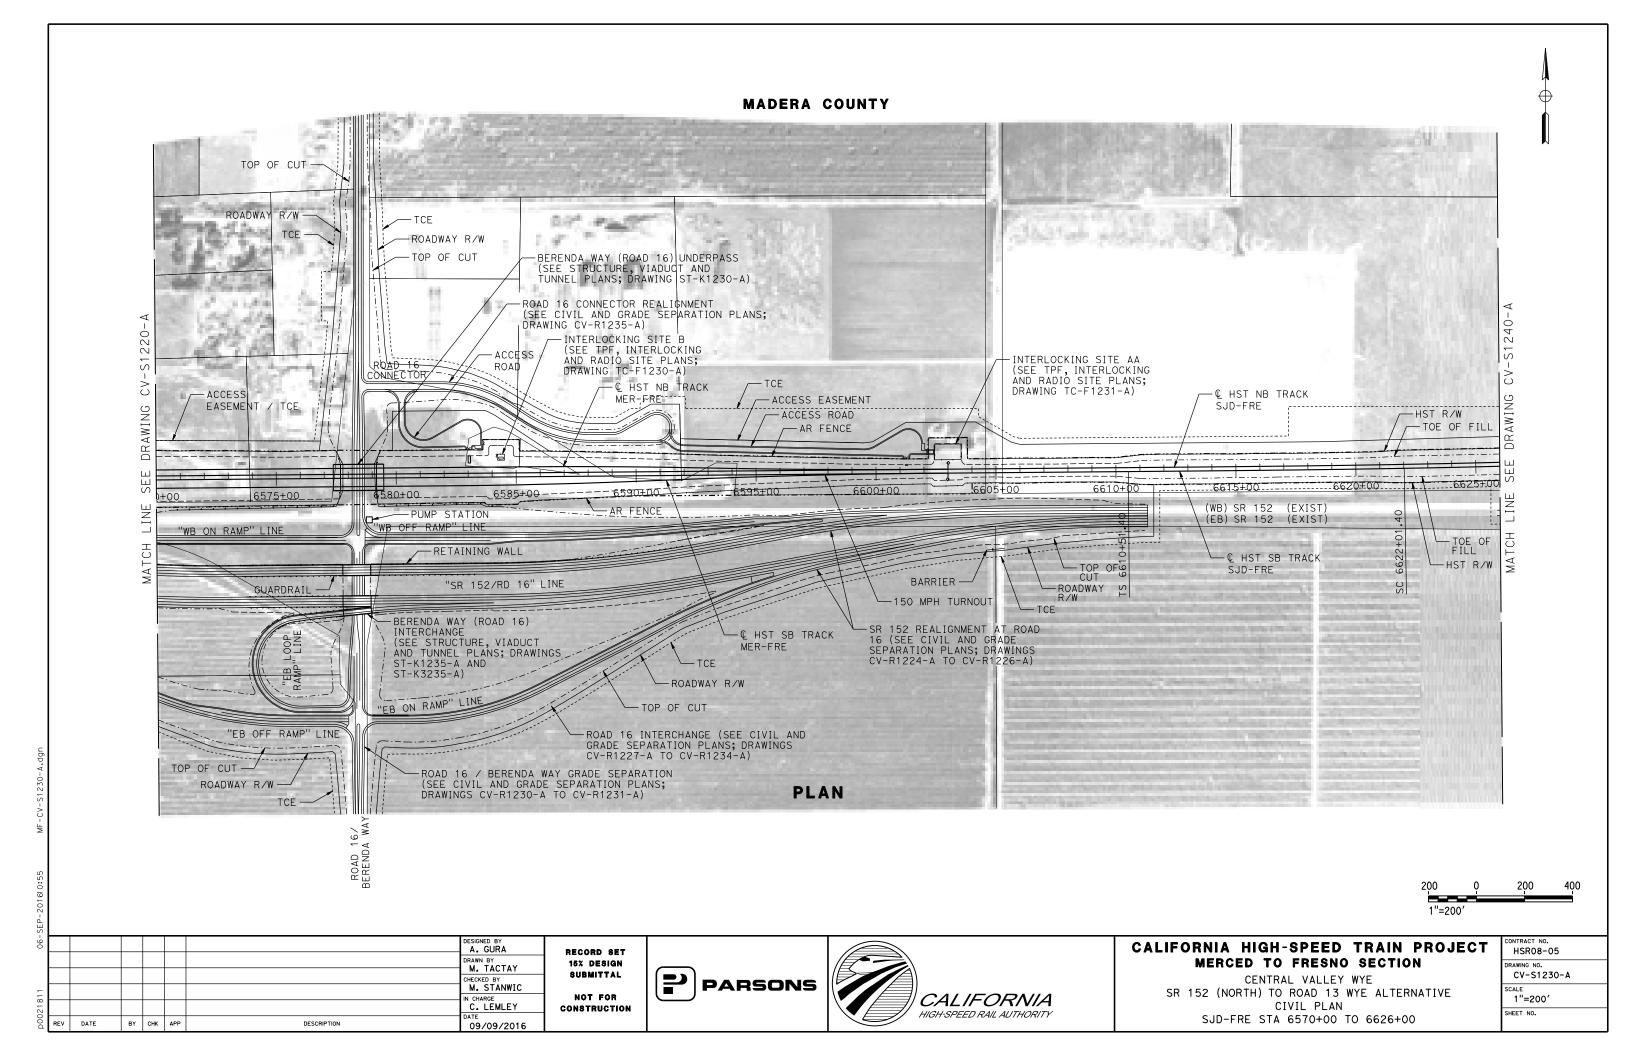

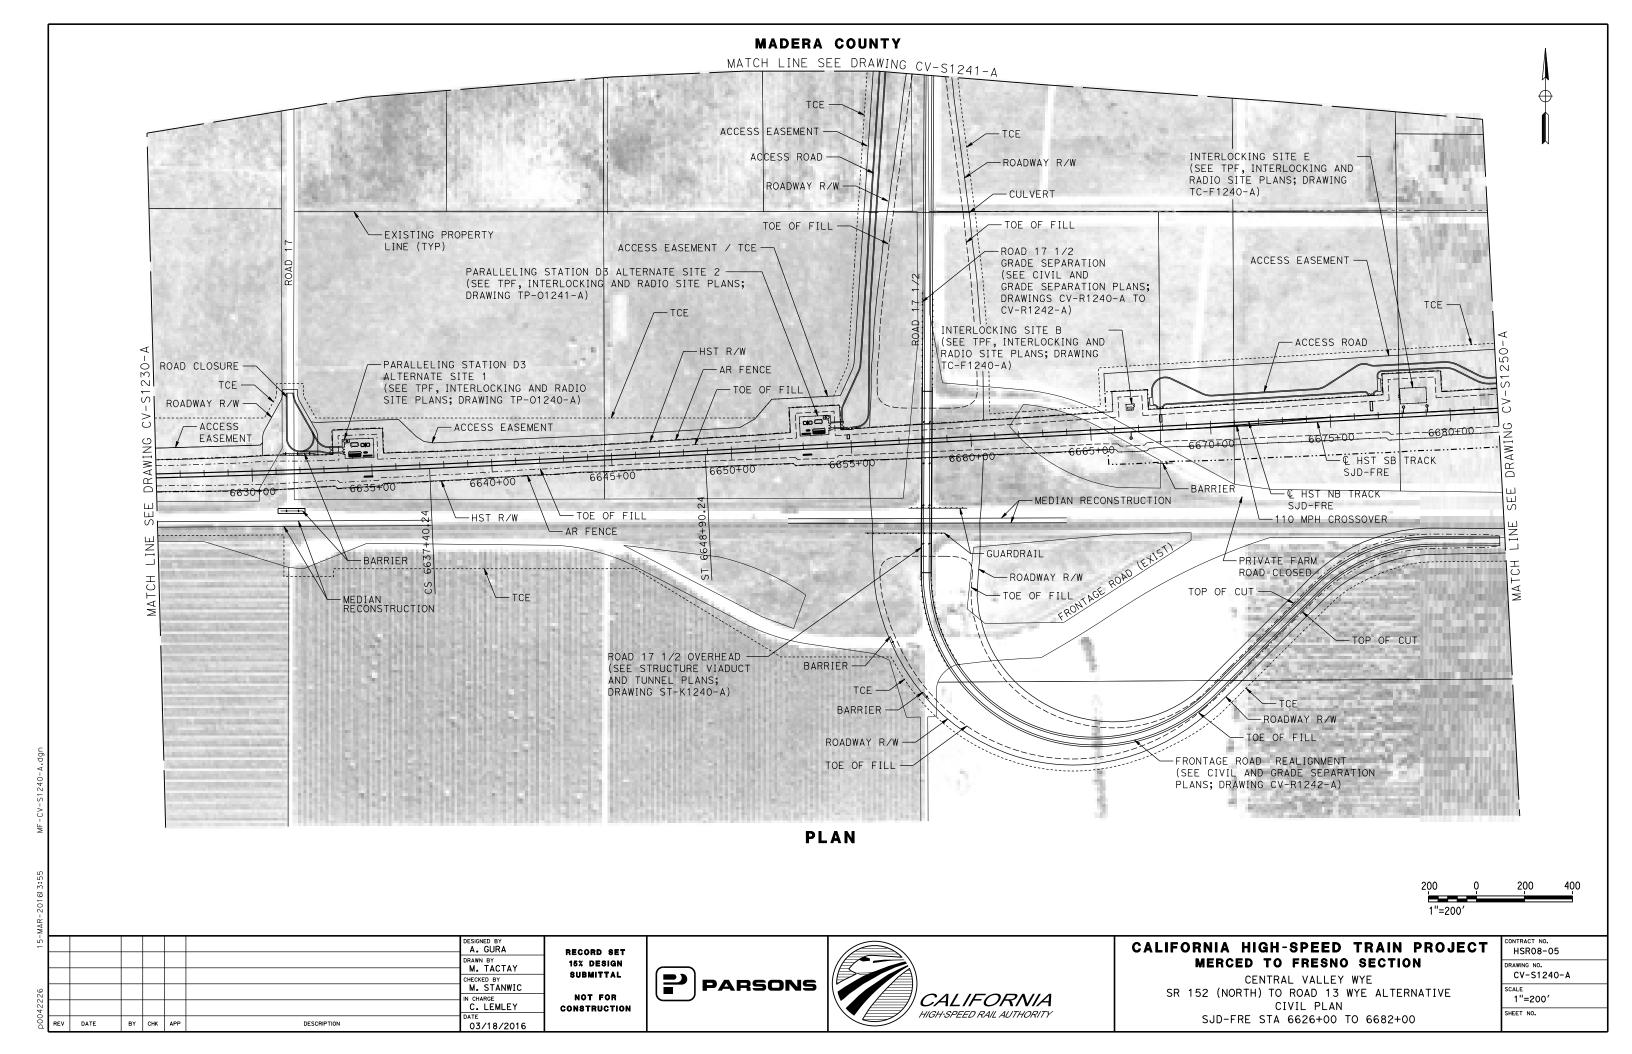

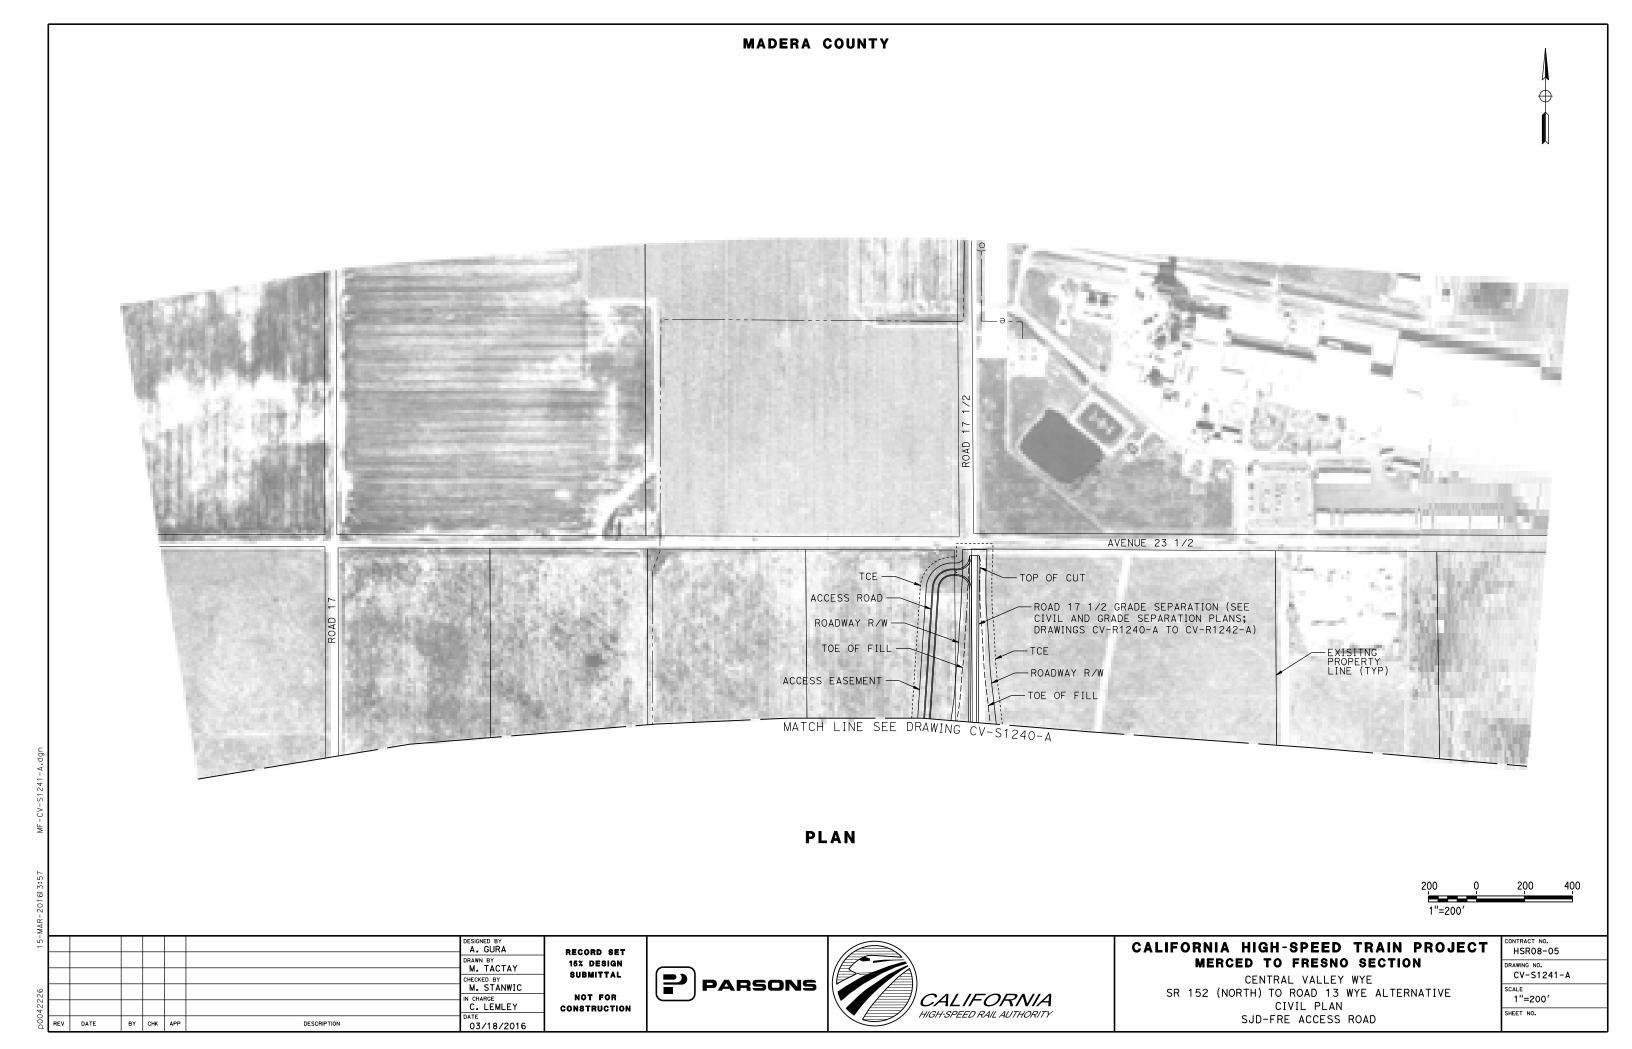

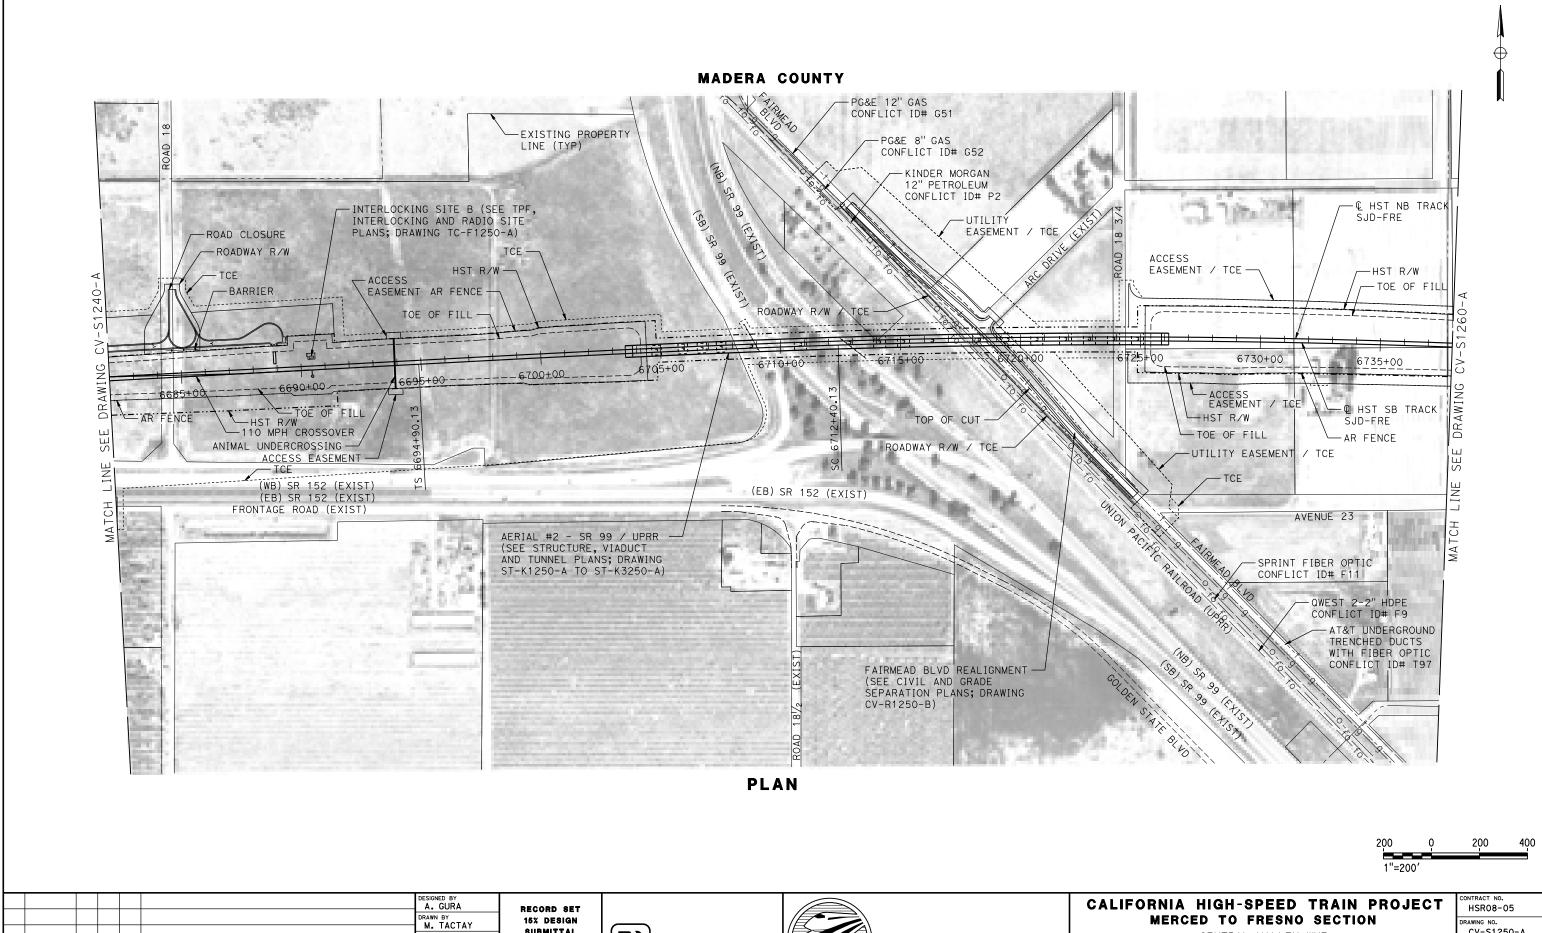

D0042226 16-MAR-

A. GURA

DRAWN BY
M. TACTAY

CHECKED BY
M. STANWIC

IN CHARGE
C. LEMLEY

DATE

EV DATE
BY CHK APP

DESCRIPTION

A. GURA

DATA M. TACTAY

CHECKED BY
M. STANWIC

IN CHARGE
C. LEMLEY

DATE
O 3/18/2016


RECORD SET
15% DESIGN
SUBMITTAL
NOT FOR
CONSTRUCTION





CENTRAL VALLEY WYE
SR 152 (NORTH) TO ROAD 13 WYE ALTERNATIVE
CIVIL PLAN
SJD-FRE STA 6682+00 TO 6738+00

,	CONTRACT NO. HSR08-05
	DRAWING NO. CV-S1250-A
	1"=200'
	SHEET NO.

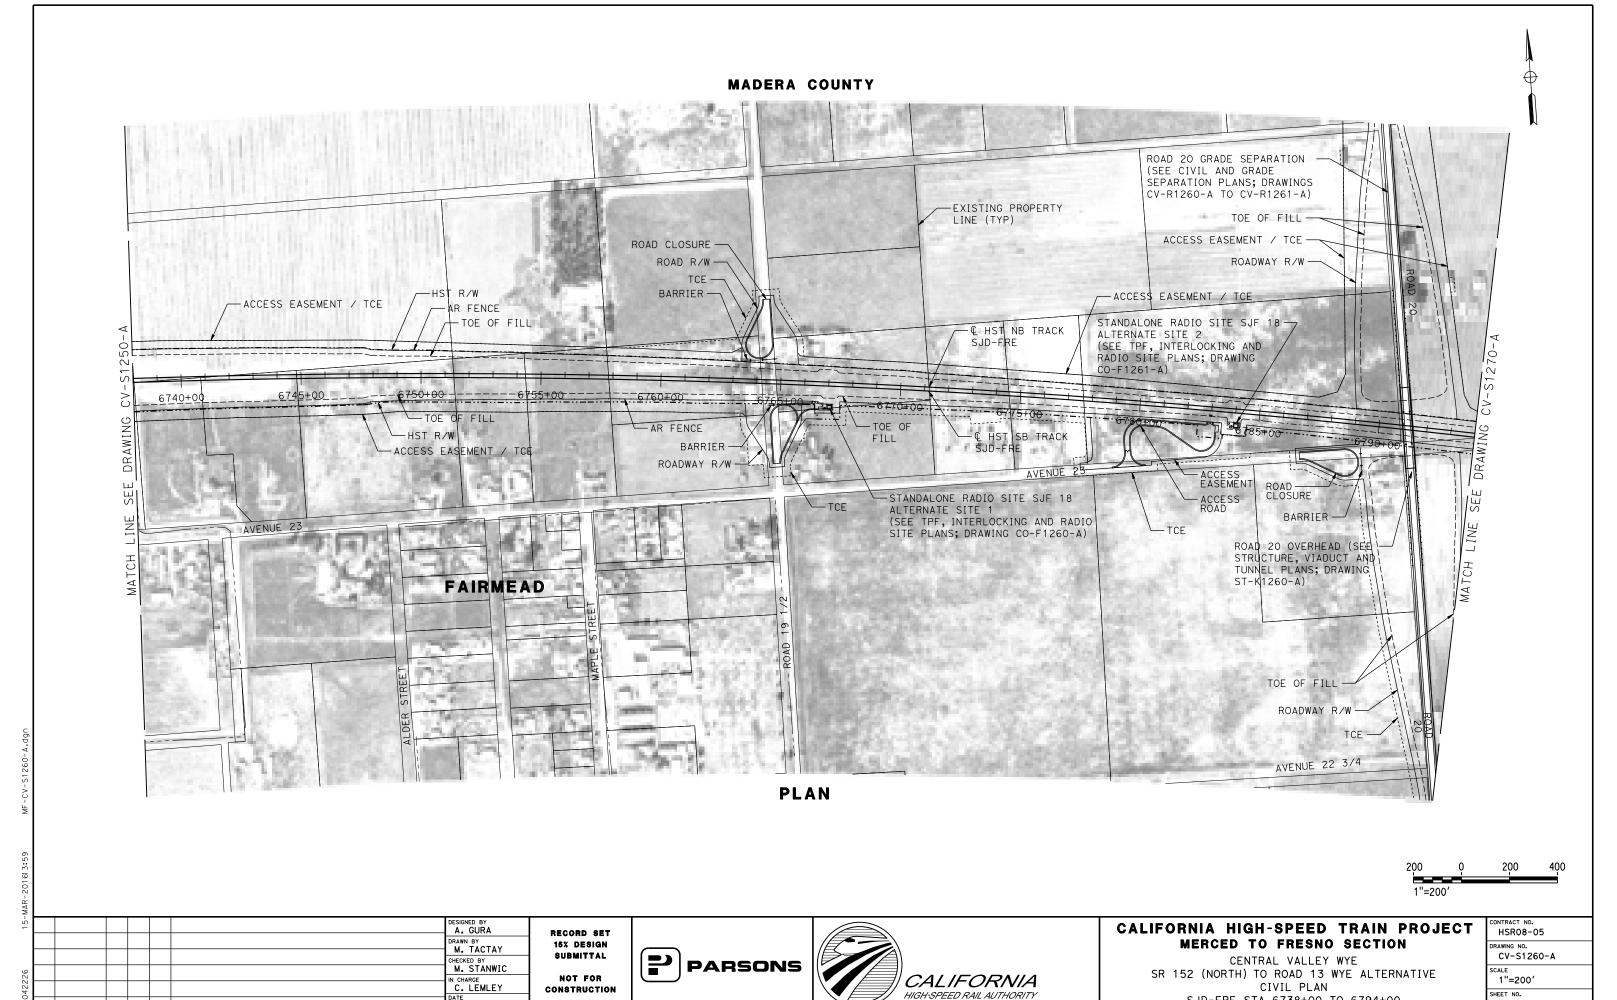


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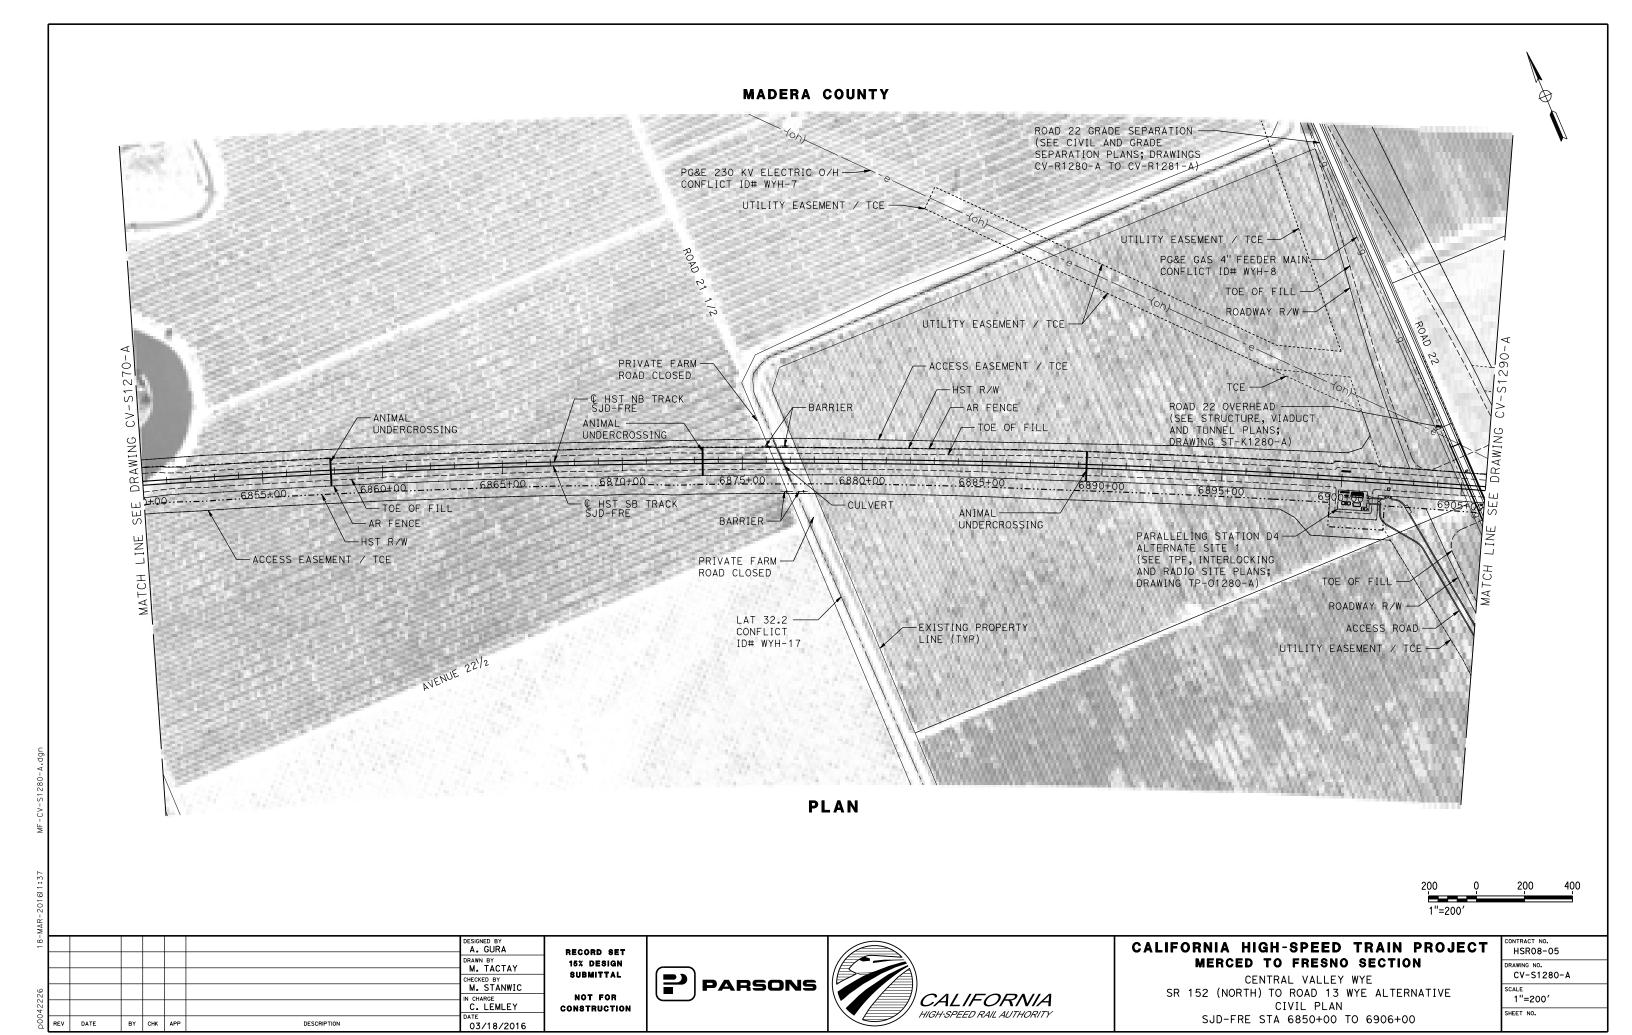
BY CHK APP


DESCRIPTION

03/18/2016

SJD-FRE STA 6738+00 TO 6794+00



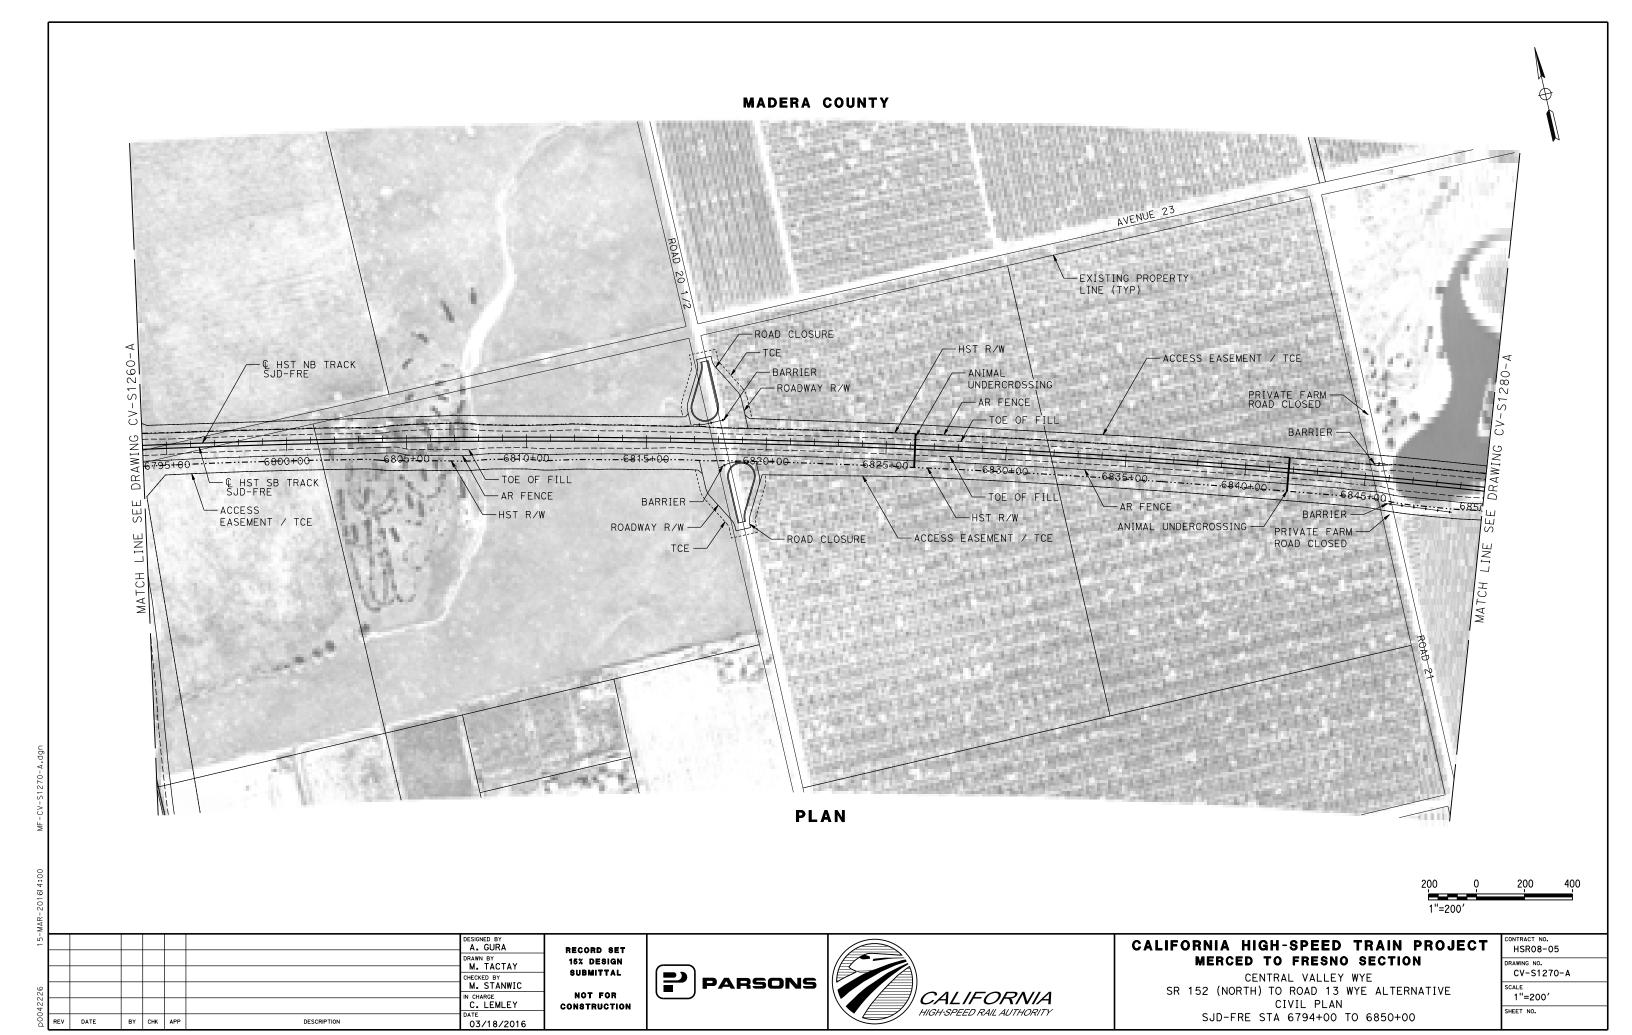

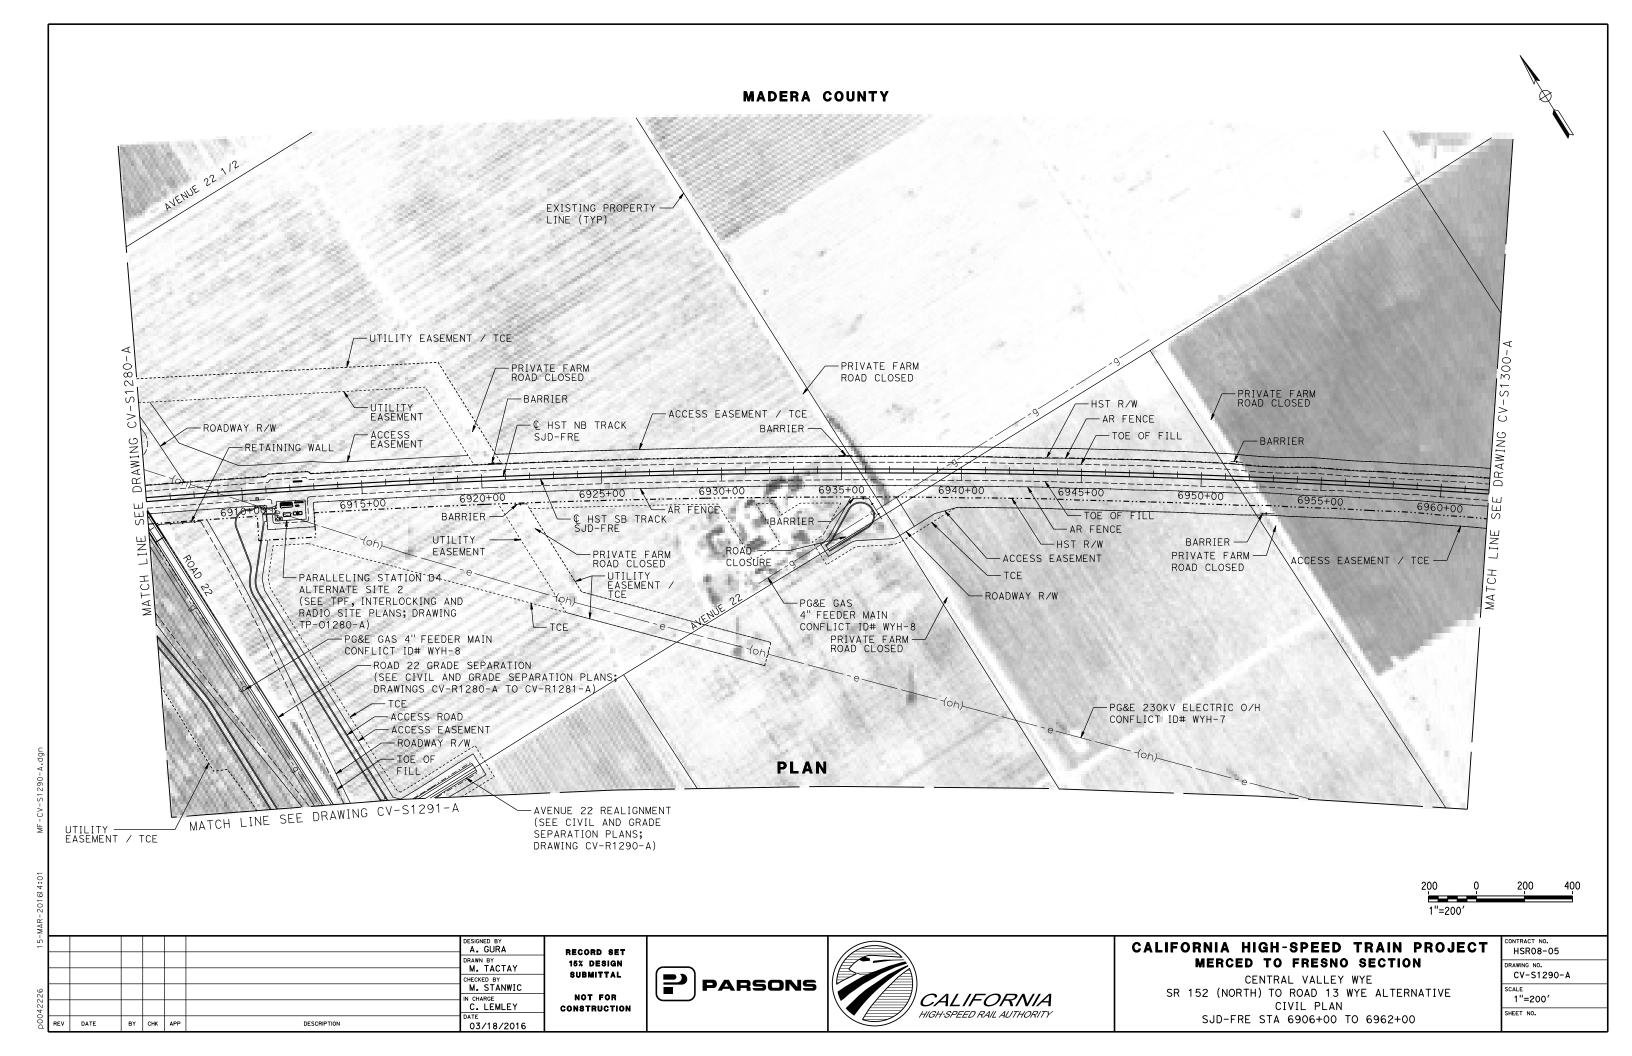

#### MADERA COUNTY





200 0 200 400

1"=200'

Š								
5							DESIGNED BY  A. GURA	RE
							DRAWN BY  J. KIDWELL	18
_							CHECKED BY M. STANWIC	8
40010							IN CHARGE  C. LEMLEY	COL
2000	REV	DATE	BY	СНК	APP	DESCRIPTION	DATE 03/18/2016	

RECORD SET
15% DESIGN
SUBMITTAL
NOT FOR
CONSTRUCTION







## CALIFORNIA HIGH-SPEED TRAIN PROJECT MERCED TO FRESNO SECTION

CENTRAL VALLEY WYE
SR 152 (NORTH) TO ROAD 13 WYE ALTERNATIVE
CIVIL PLAN
SJD-FRE ACCESS ROAD

CONTRACT NO. HSR08-05
DRAWING NO. CV-S1291-A
SCALE 1"=200'
SHEET NO.

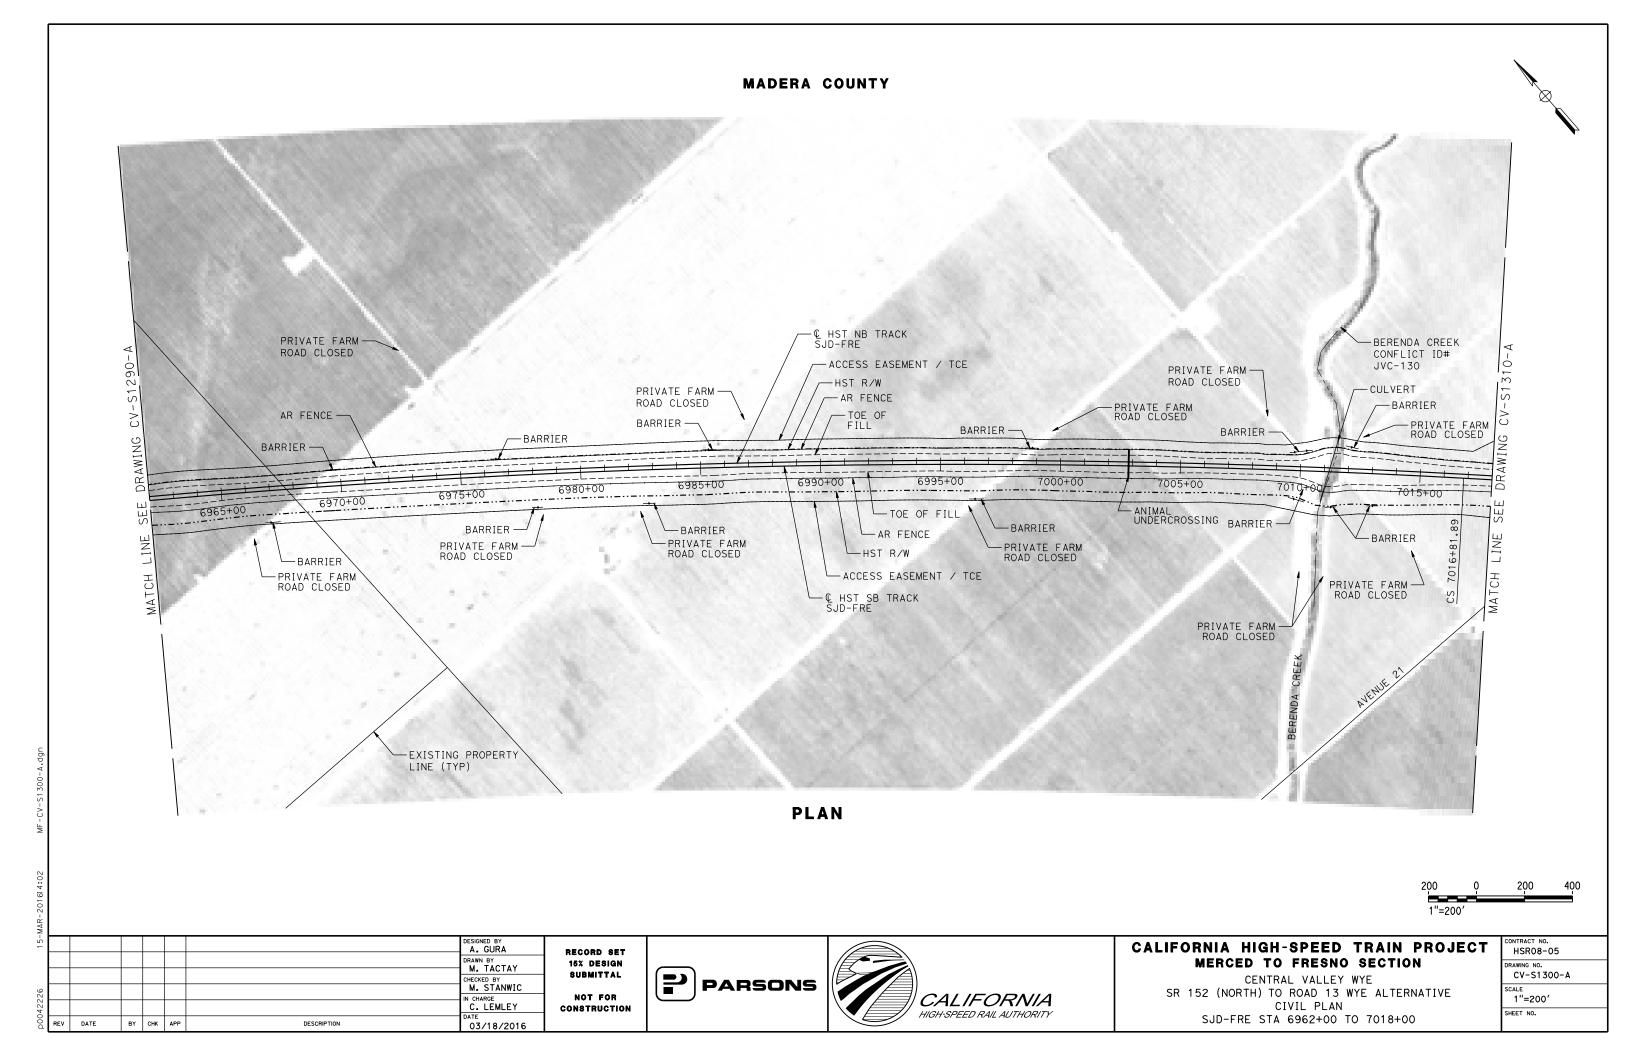

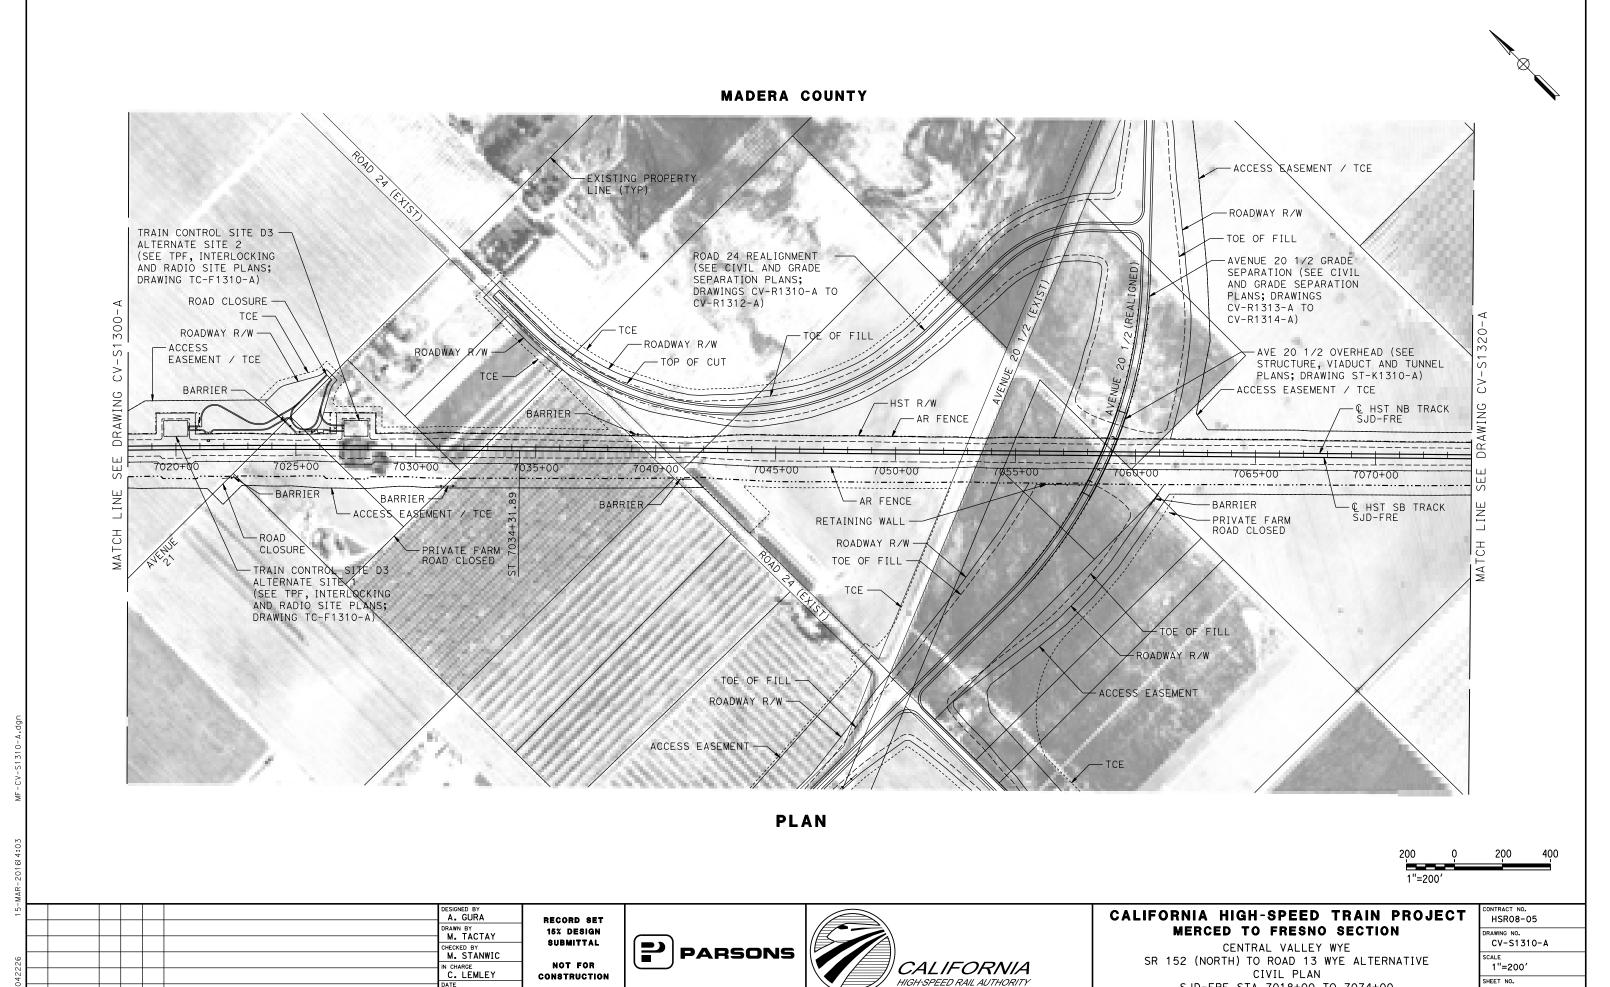


BY CHK APP

DESCRIPTION

03/18/2016

SJD-FRE STA 7018+00 TO 7074+00

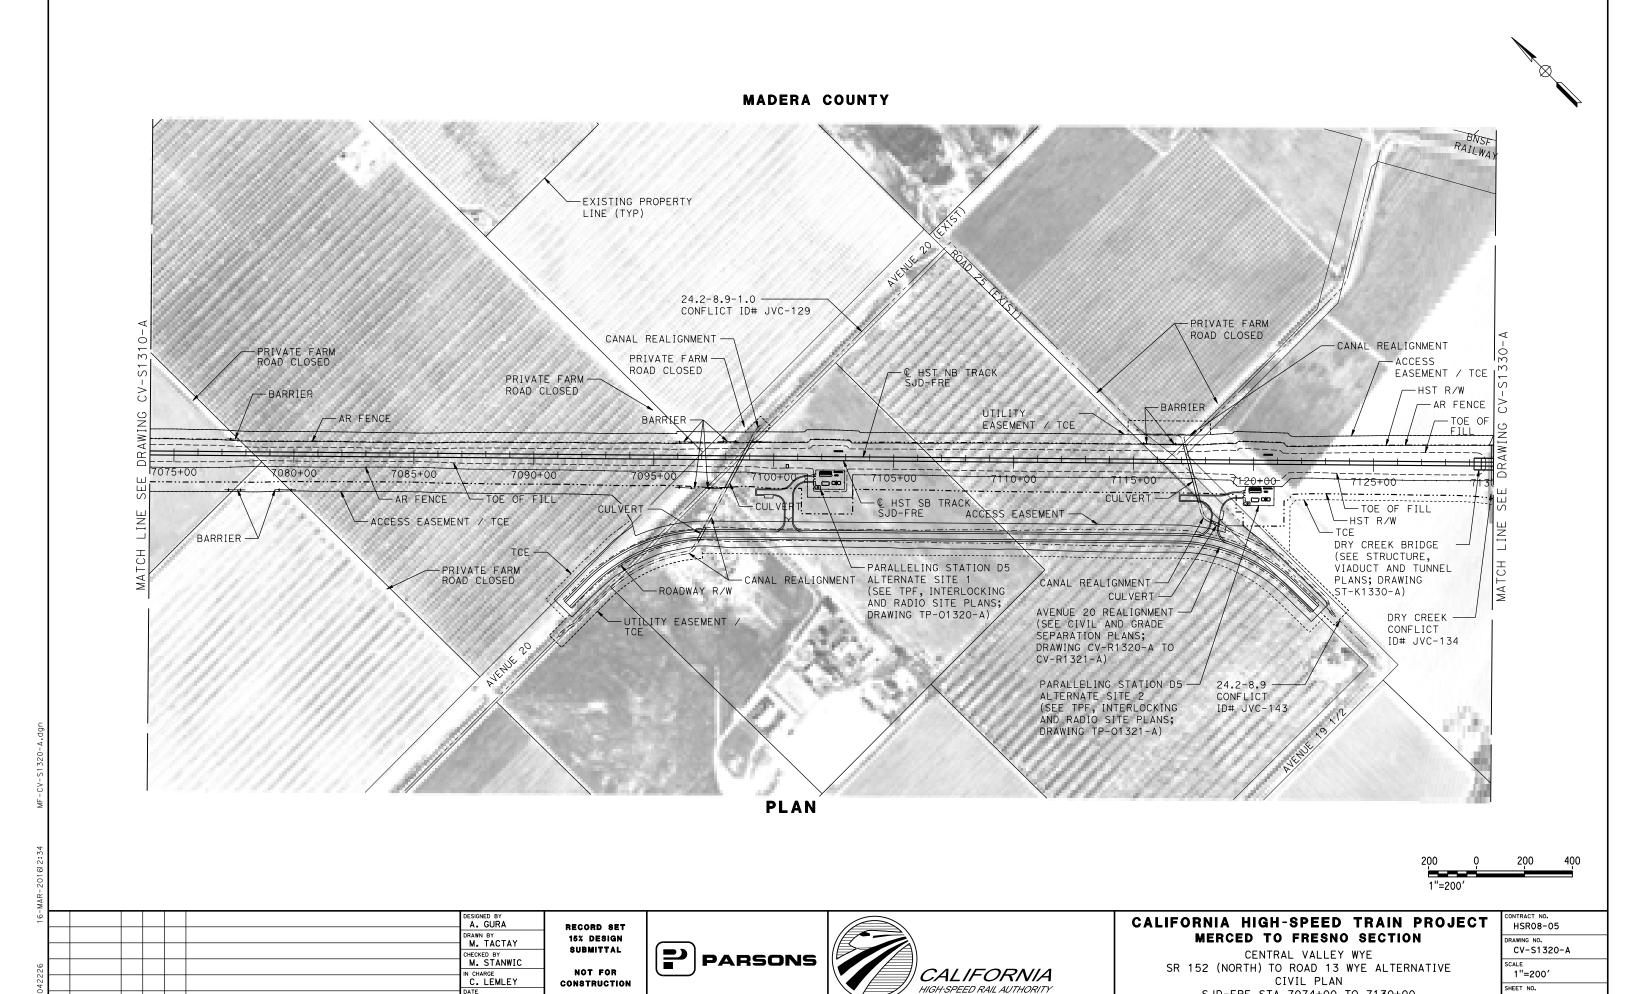


BY CHK APP

DESCRIPTION

03/18/2016

SJD-FRE STA 7074+00 TO 7130+00

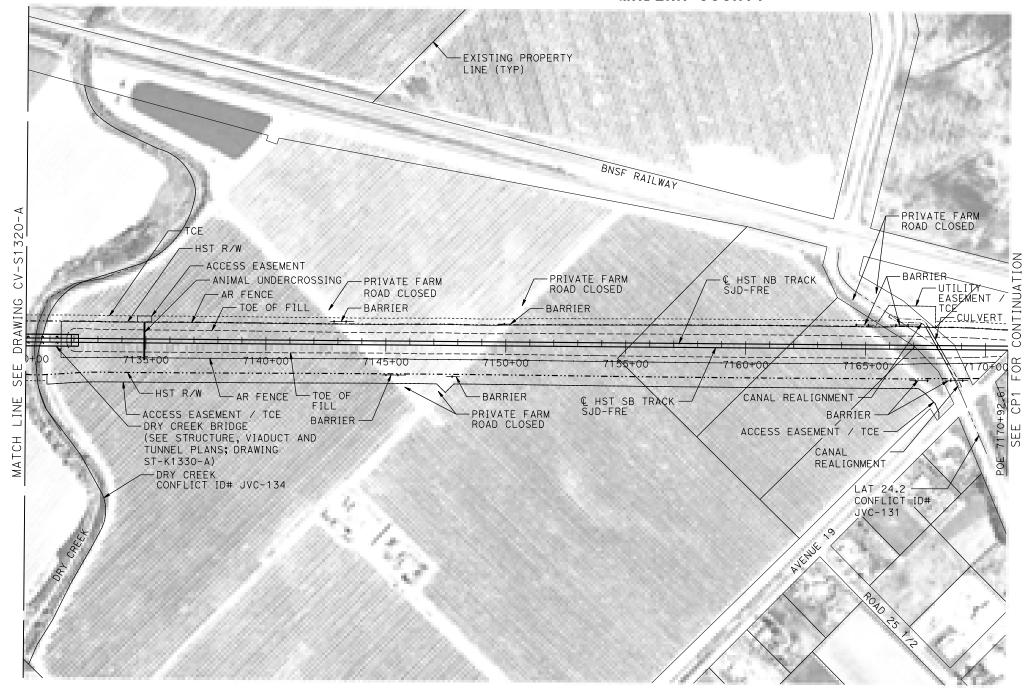

**PLAN** 

200	Ò	200	400
1"=20	0′		

15-M							DESIGNED BY A. GURA	
							DRAWN BY M. TACTAY	RE:
(0							CHECKED BY M. STANWIC	SI
42226							IN CHARGE C. LEMLEY	CON
00d	REV	DATE	BY	снк	APP	DESCRIPTION	03/18/2016	

RECORD SET
15% DESIGN
SUBMITTAL
NOT FOR
CONSTRUCTION








# CALIFORNIA HIGH-SPEED TRAIN PROJECT MERCED TO FRESNO SECTION


CENTRAL VALLEY WYE
SR 152 (NORTH) TO ROAD 13 WYE ALTERNATIVE
CIVIL PLAN
SJD-FRE STA 7130+00 TO 7170+92.61


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DRAWING NO. CV-S1330-A	
SCALE 1"=200'	
SHEET NO.	

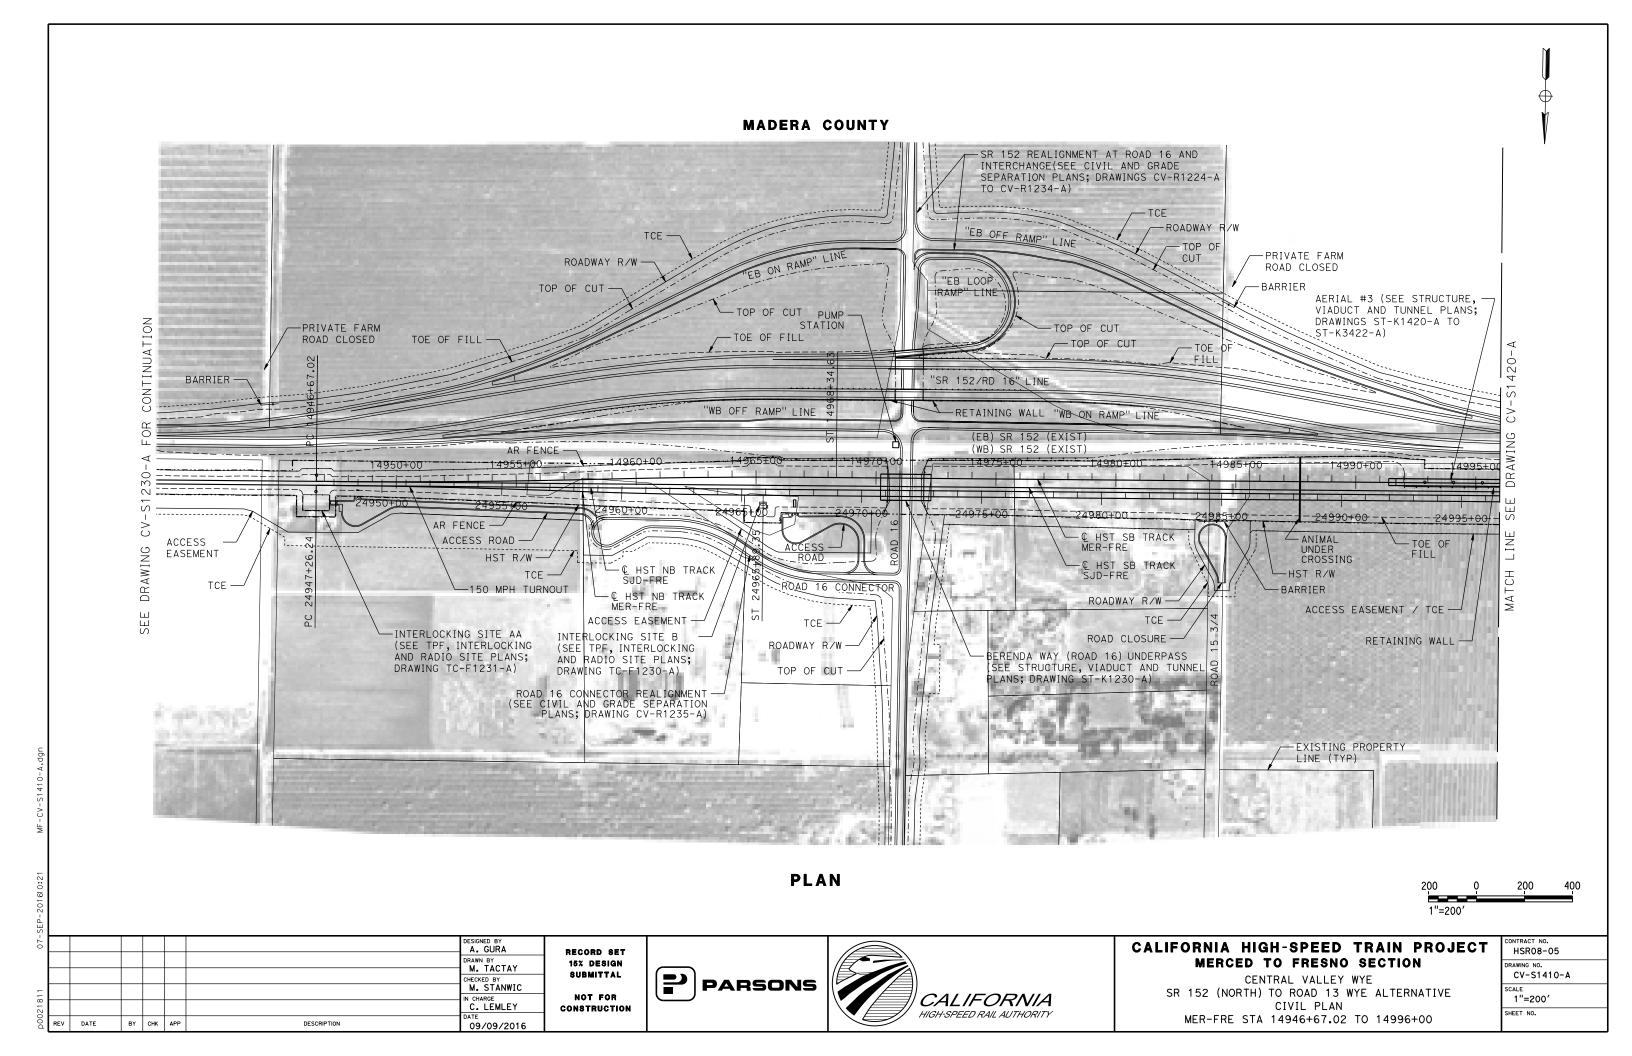

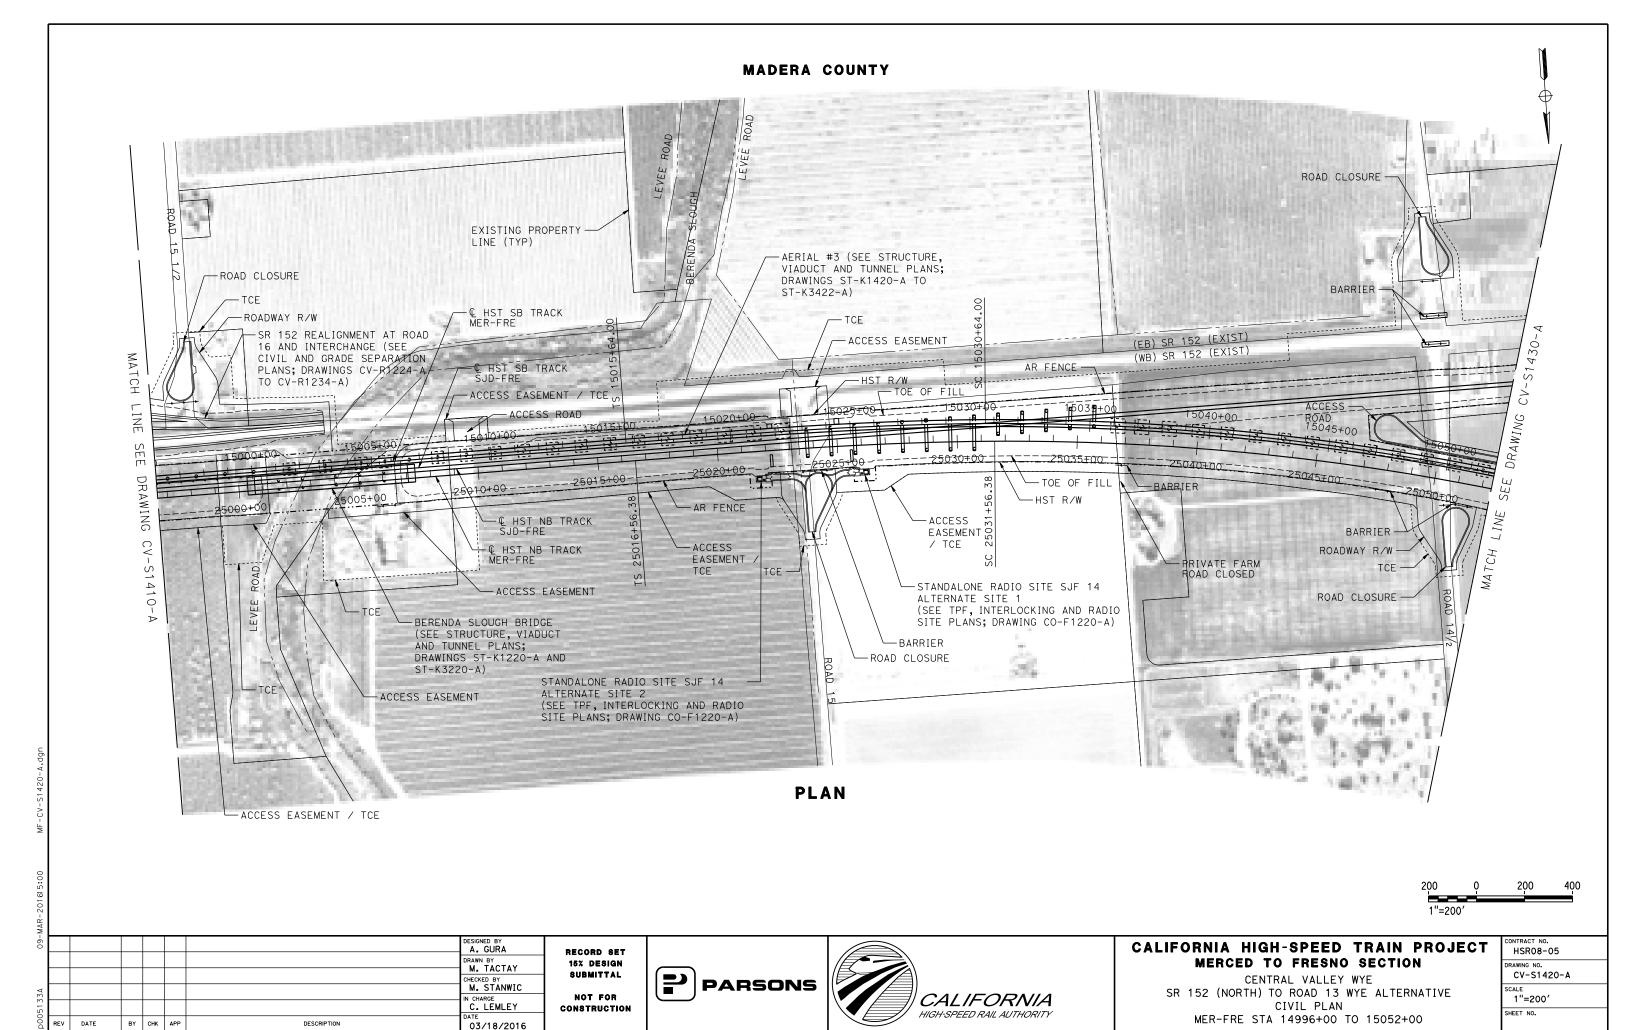


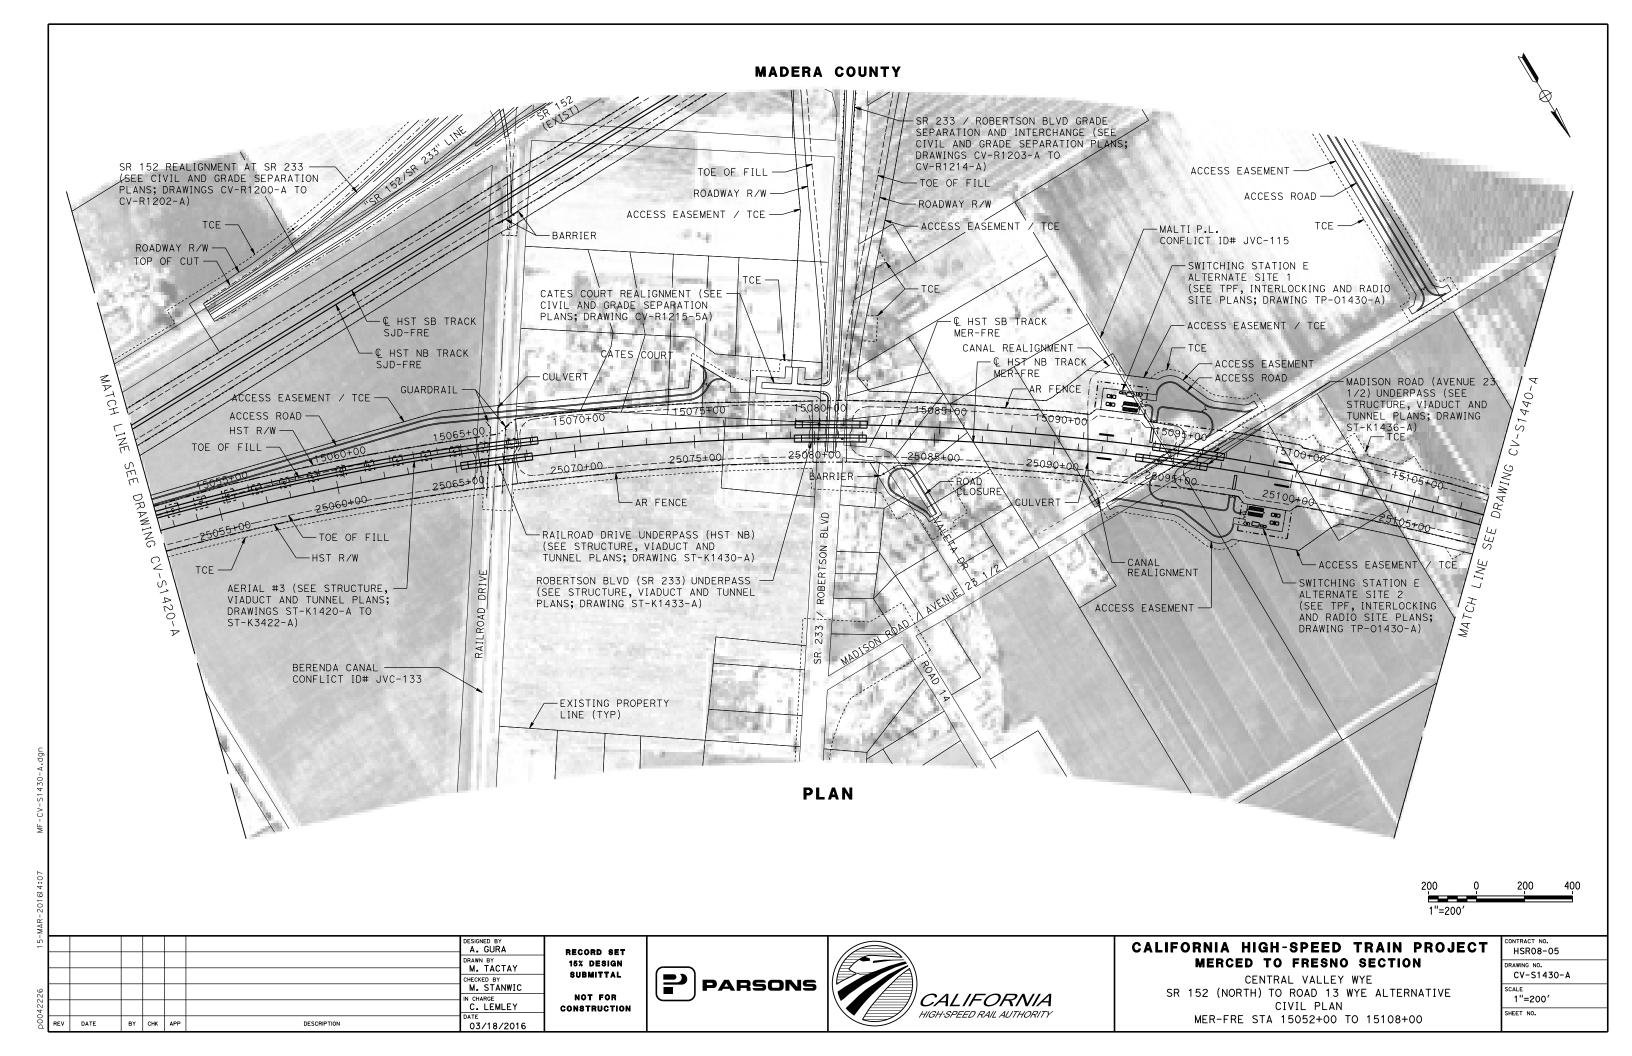

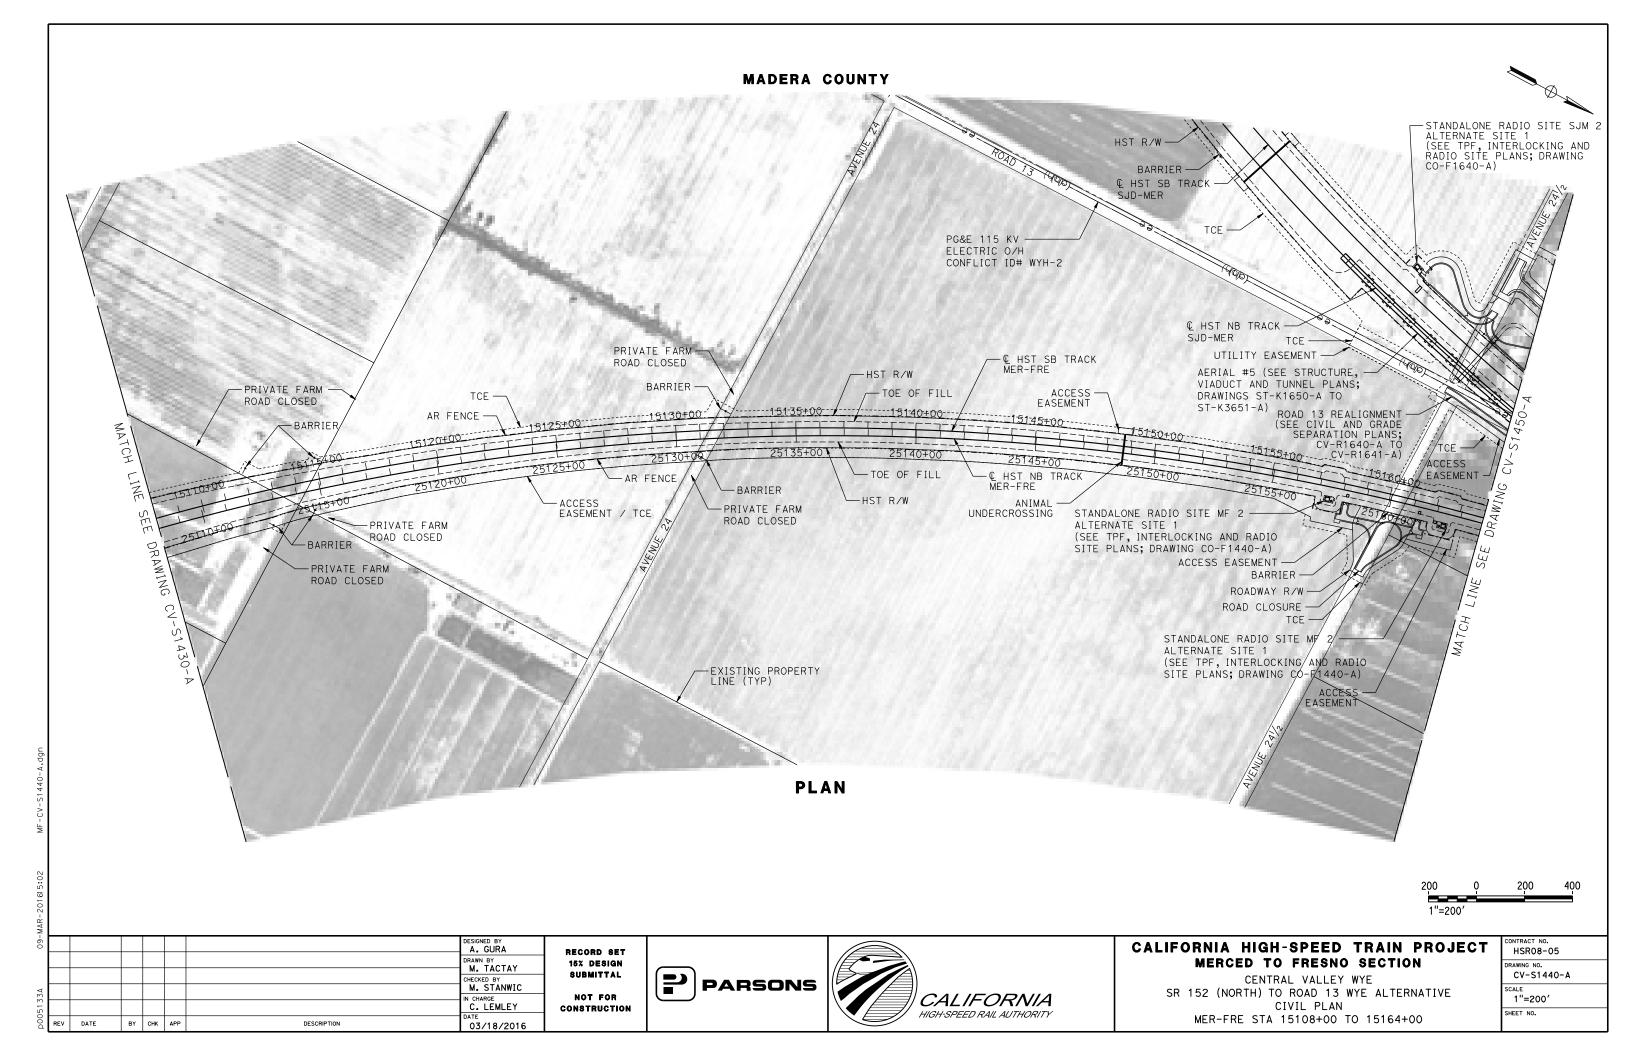

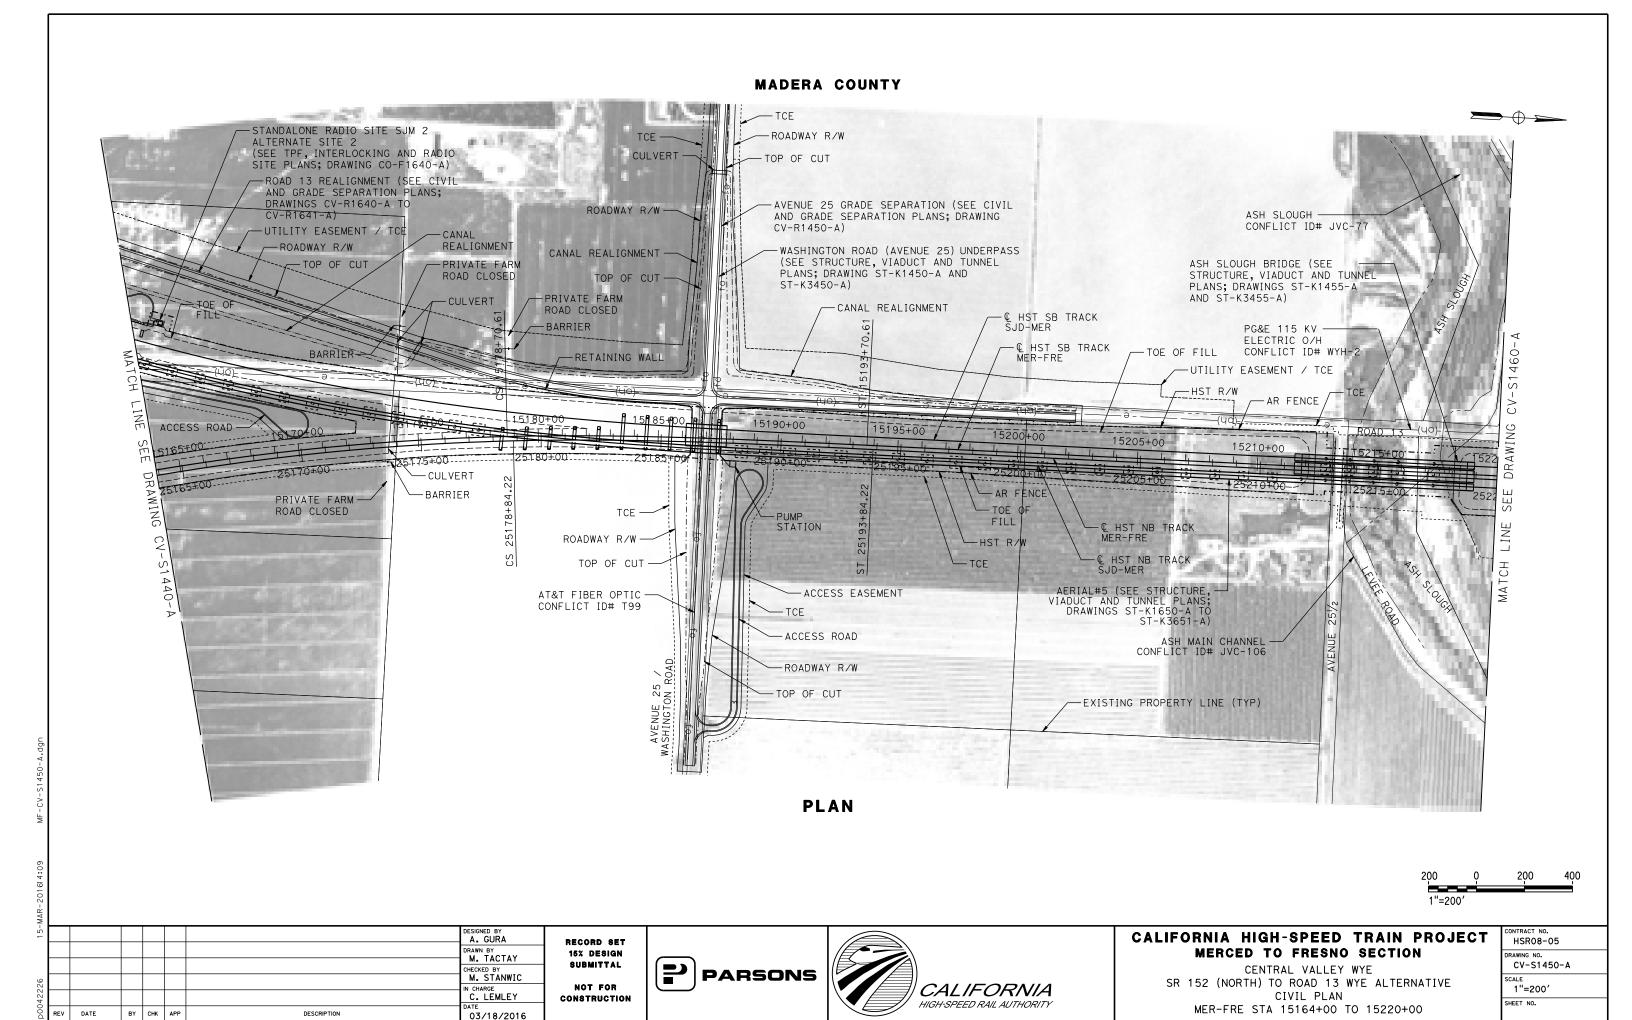



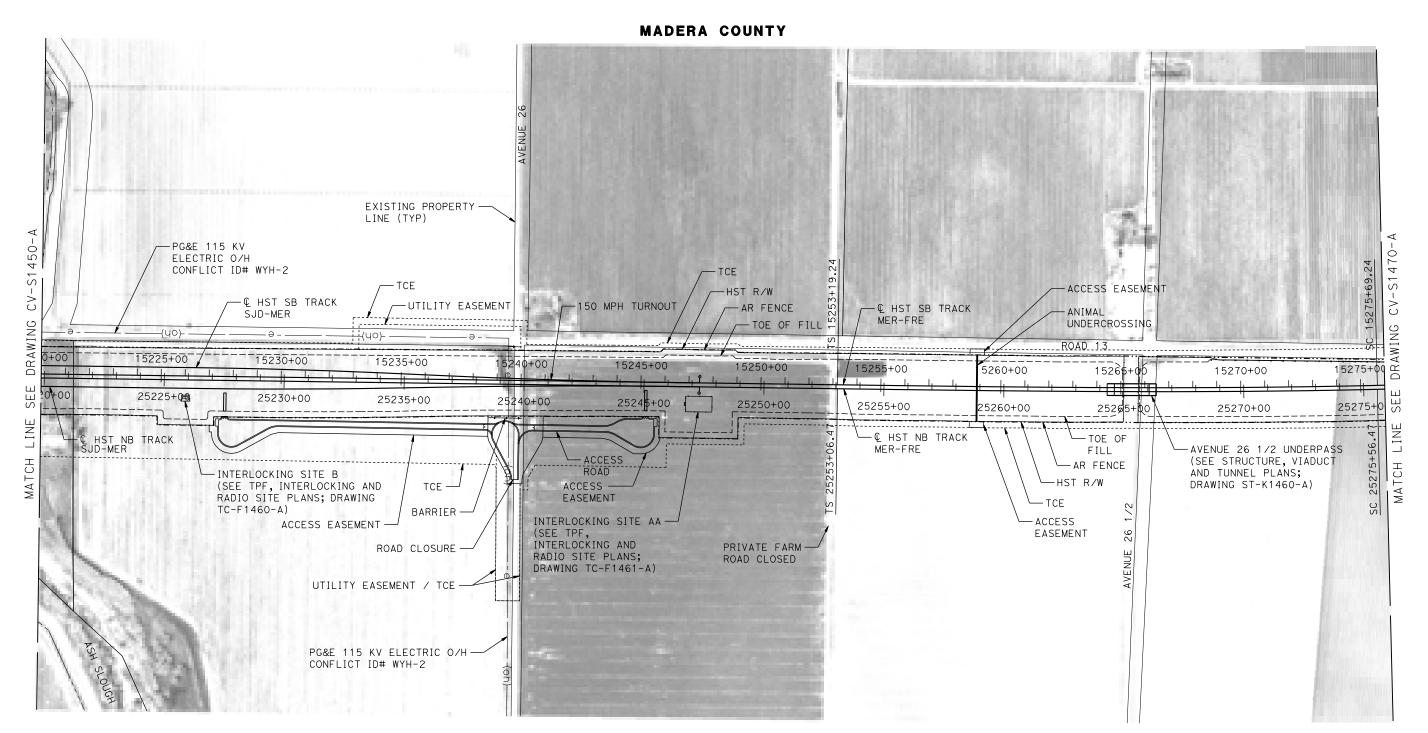

PLAN



16-M							DESIGNED BY A. GURA	
							DRAWN BY M. TACTAY	15
(O							CHECKED BY M. STANWIC	SI
42226							IN CHARGE C. LEMLEY	CON
, 000	REV	DATE	BY	снк	APP	DESCRIPTION	03/18/2016	

RECORD SET
15% DESIGN
SUBMITTAL
NOT FOR
CONSTRUCTION







# CALIFORNIA HIGH-SPEED TRAIN PROJECT MERCED TO FRESNO SECTION

CENTRAL VALLEY WYE
SR 152 (NORTH) TO ROAD 13 WYE ALTERNATIVE
CIVIL PLAN
MER-FRE STA 15220+00 TO 15276+00

CONTRACT NO.
HSR08-05
DRAWING NO.
CV-S1460-A
SCALE
1"=200′
SHEET NO.



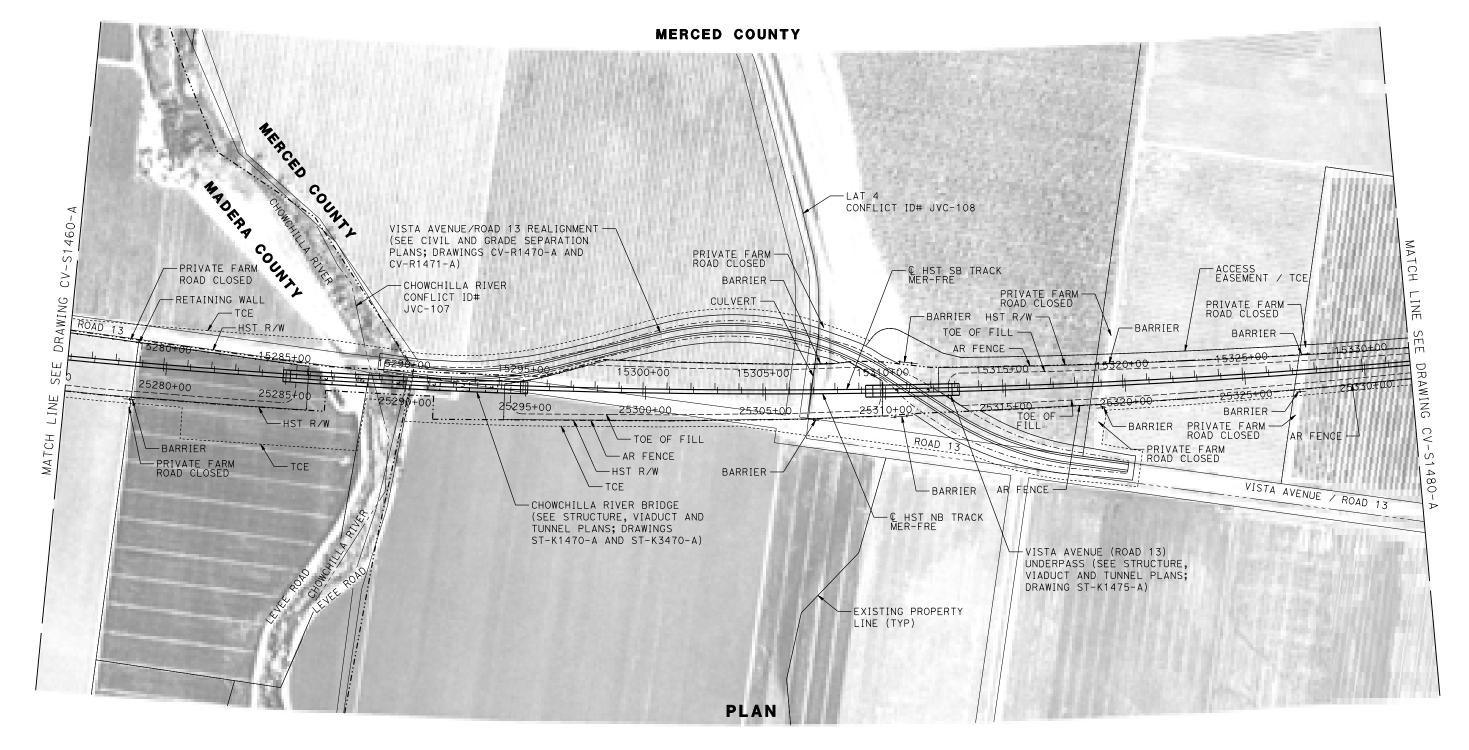

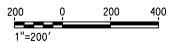

-								
16-							DESIGNED BY A. GURA	F
							DRAWN BY M. TACTAY	
							CHECKED BY	
526							M. STANWIC IN CHARGE	
p0042226							C. LEMLEY	C
0d	REV	DATE	BY	СНК	APP	DESCRIPTION	03/18/2016	

RECORD SET
15% DESIGN
SUBMITTAL
NOT FOR
CONSTRUCTION








# CALIFORNIA HIGH-SPEED TRAIN PROJECT MERCED TO FRESNO SECTION


CENTRAL VALLEY WYE
SR 152 (NORTH) TO ROAD 13 WYE ALTERNATIVE
CIVIL PLAN
MER-FRE STA 15276+00 TO 15332+00


CONTRACT NO. HSR08-05
DRAWING NO. CV-S1470-A
SCALE 1"=200'
SHEET NO.

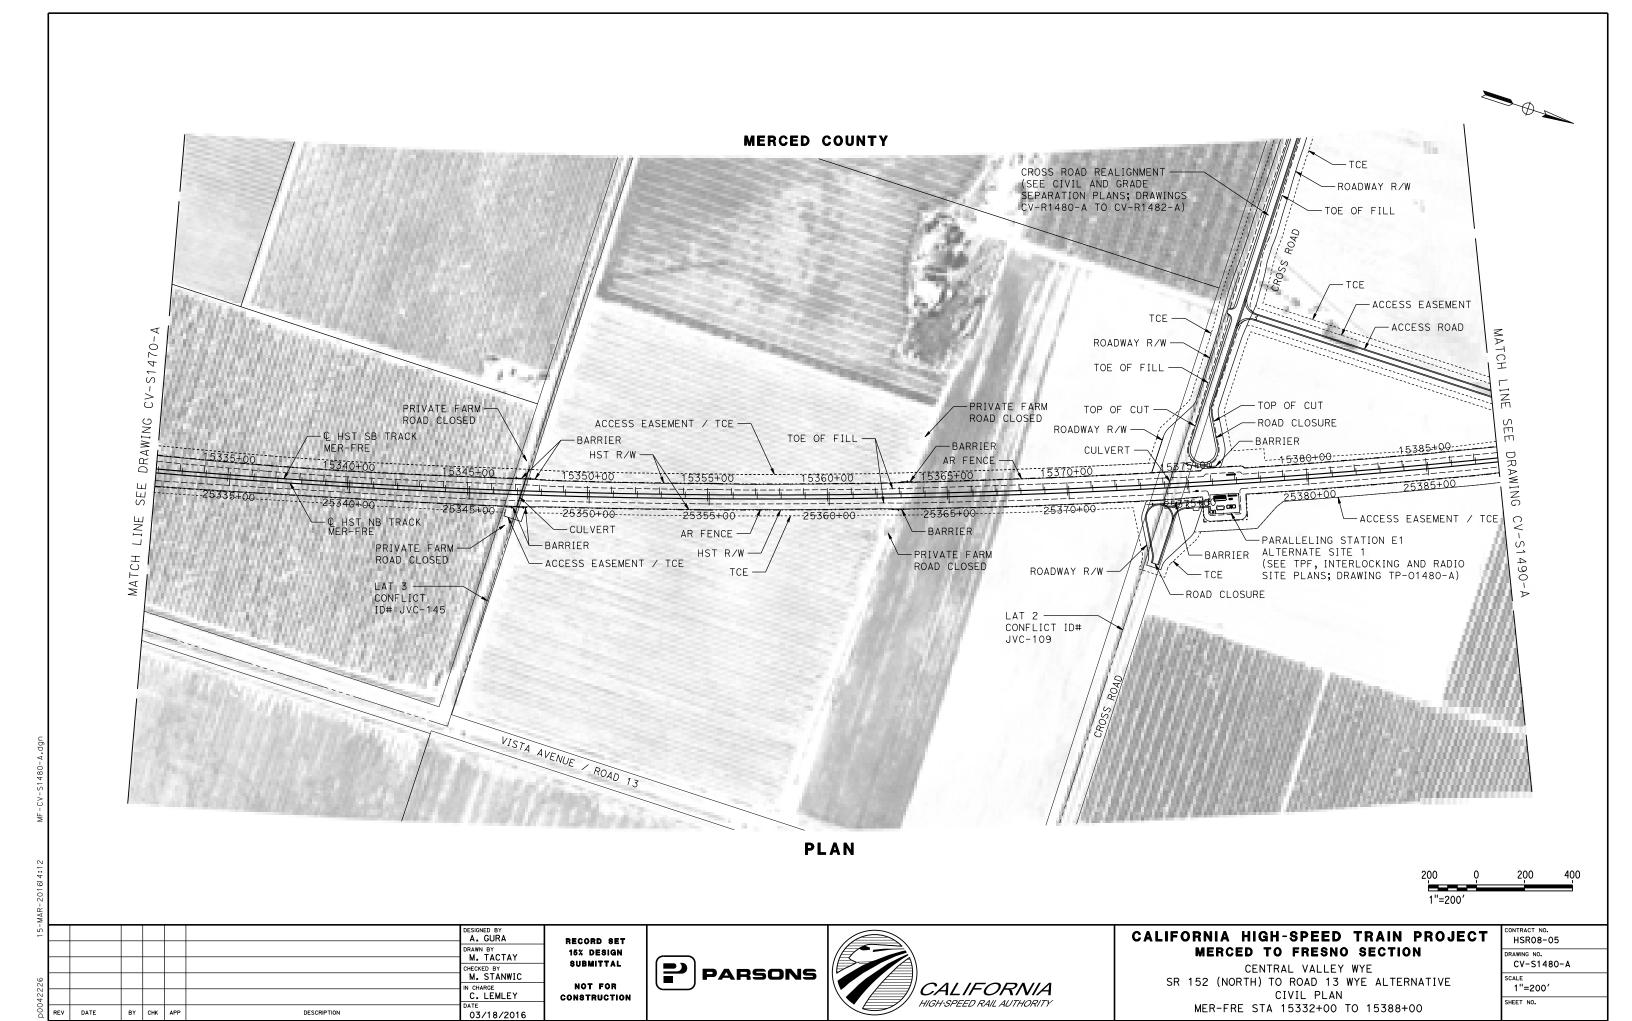

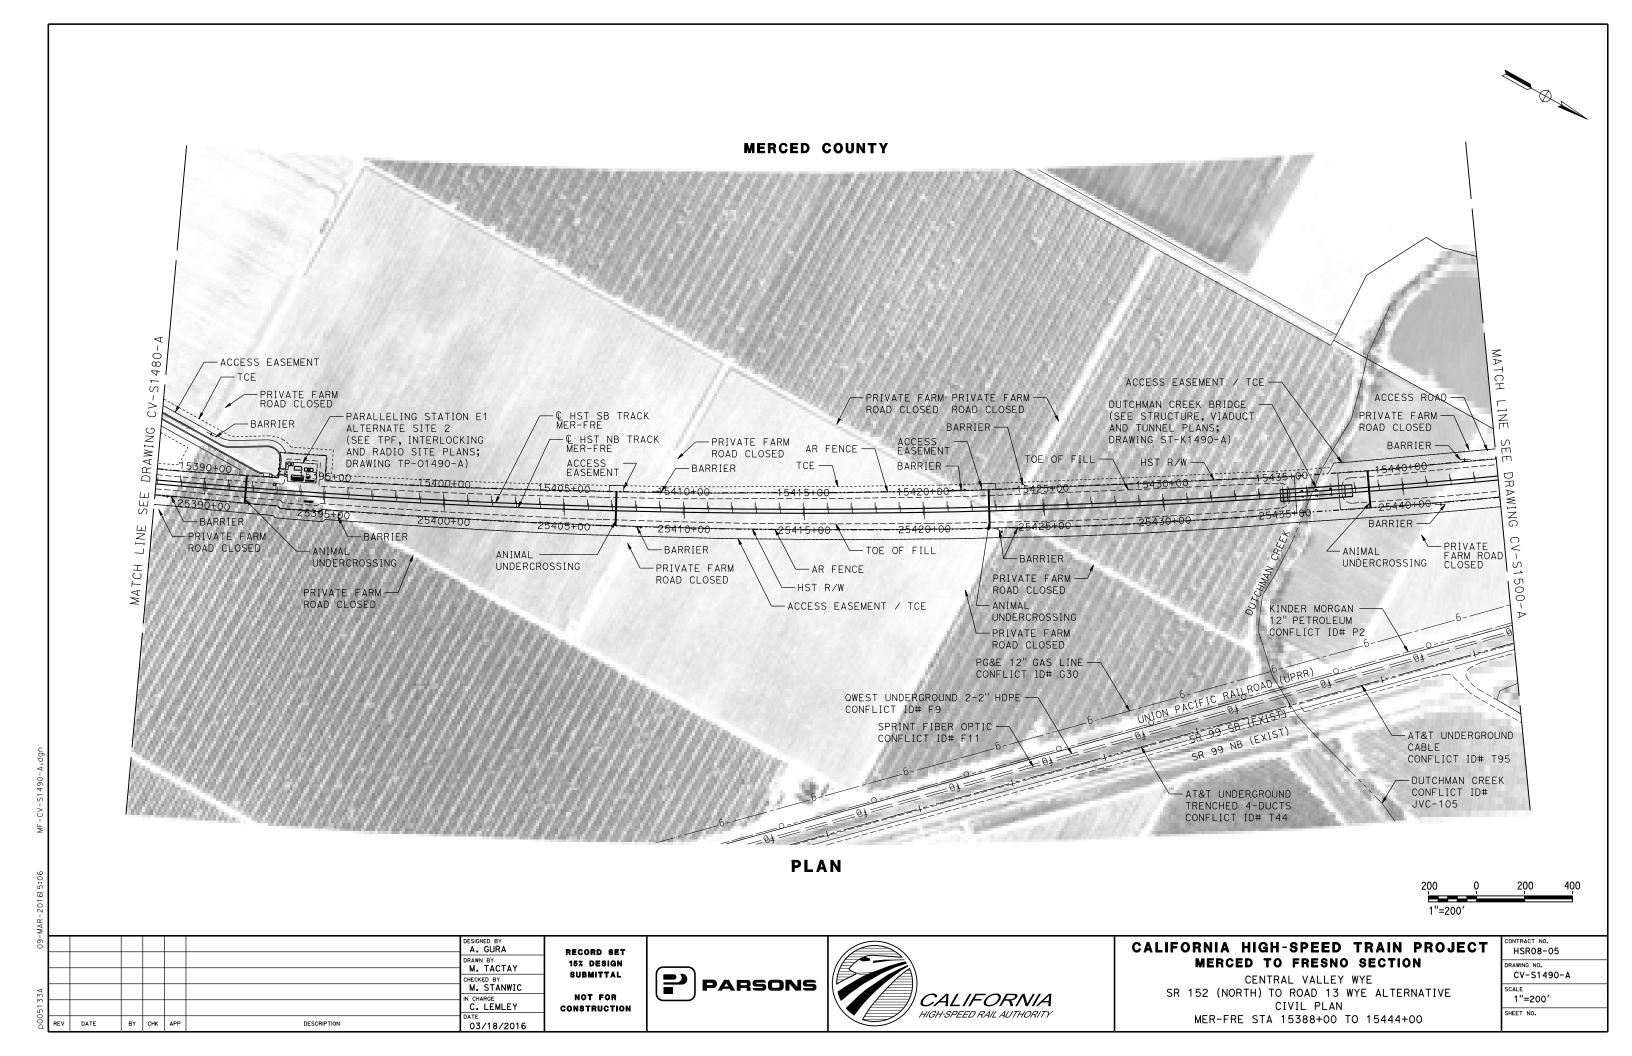

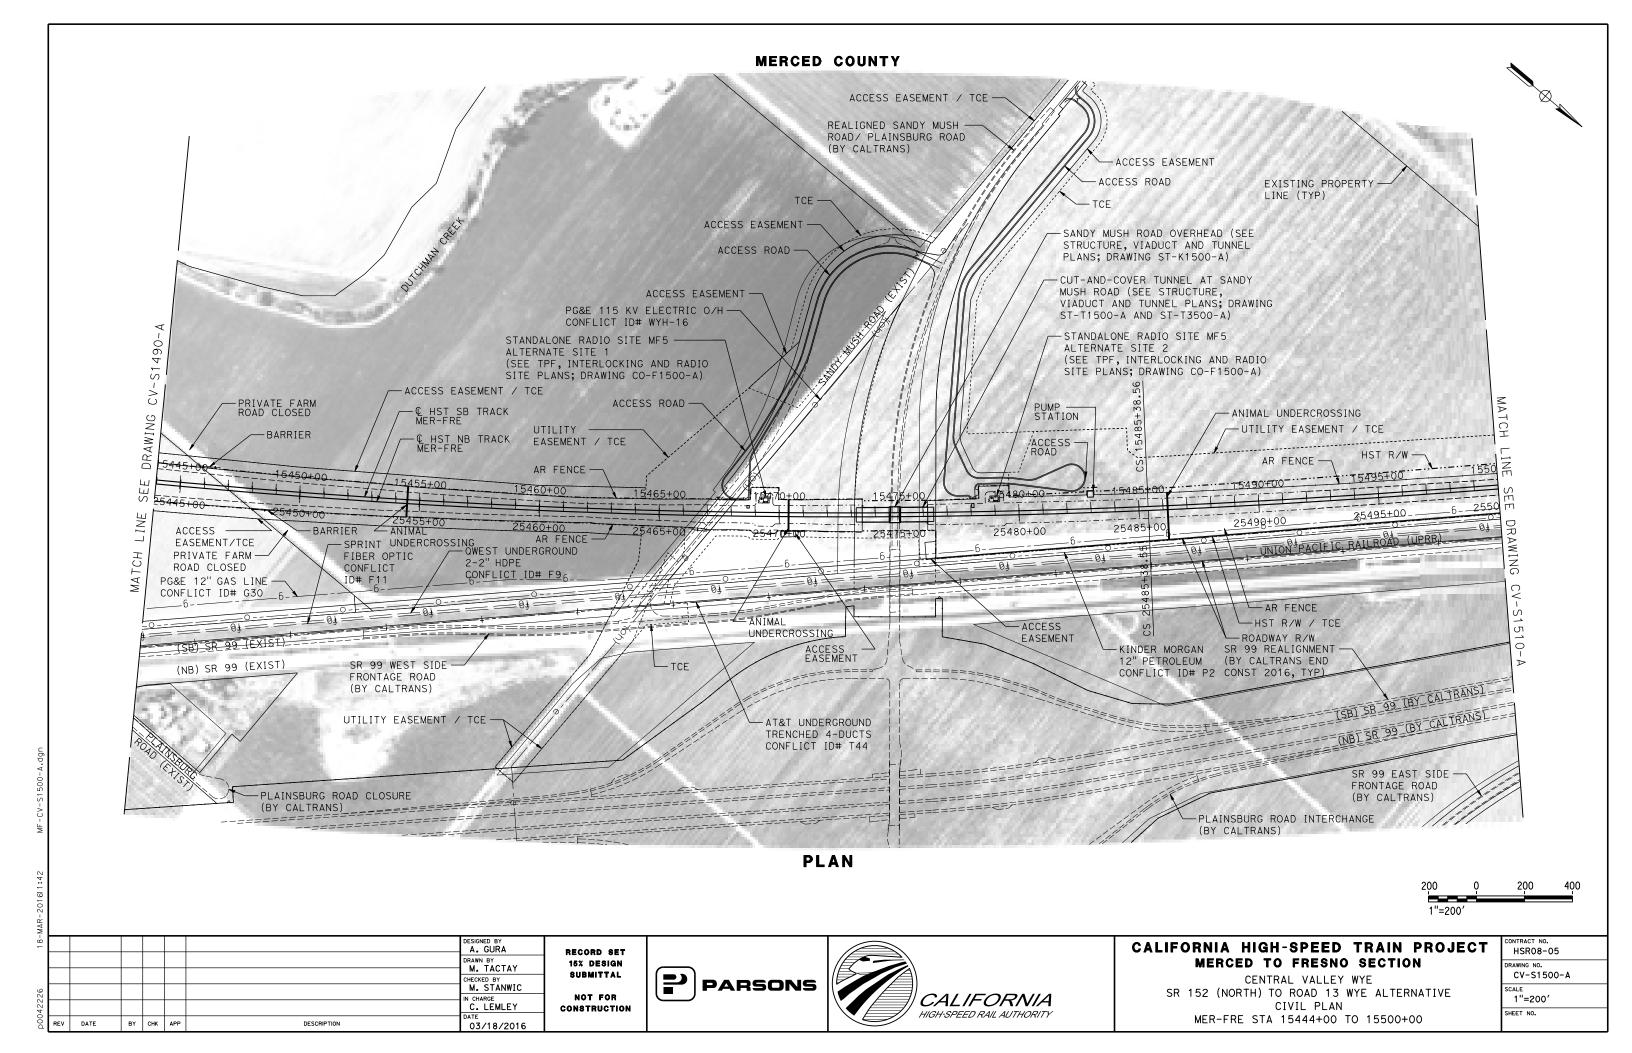

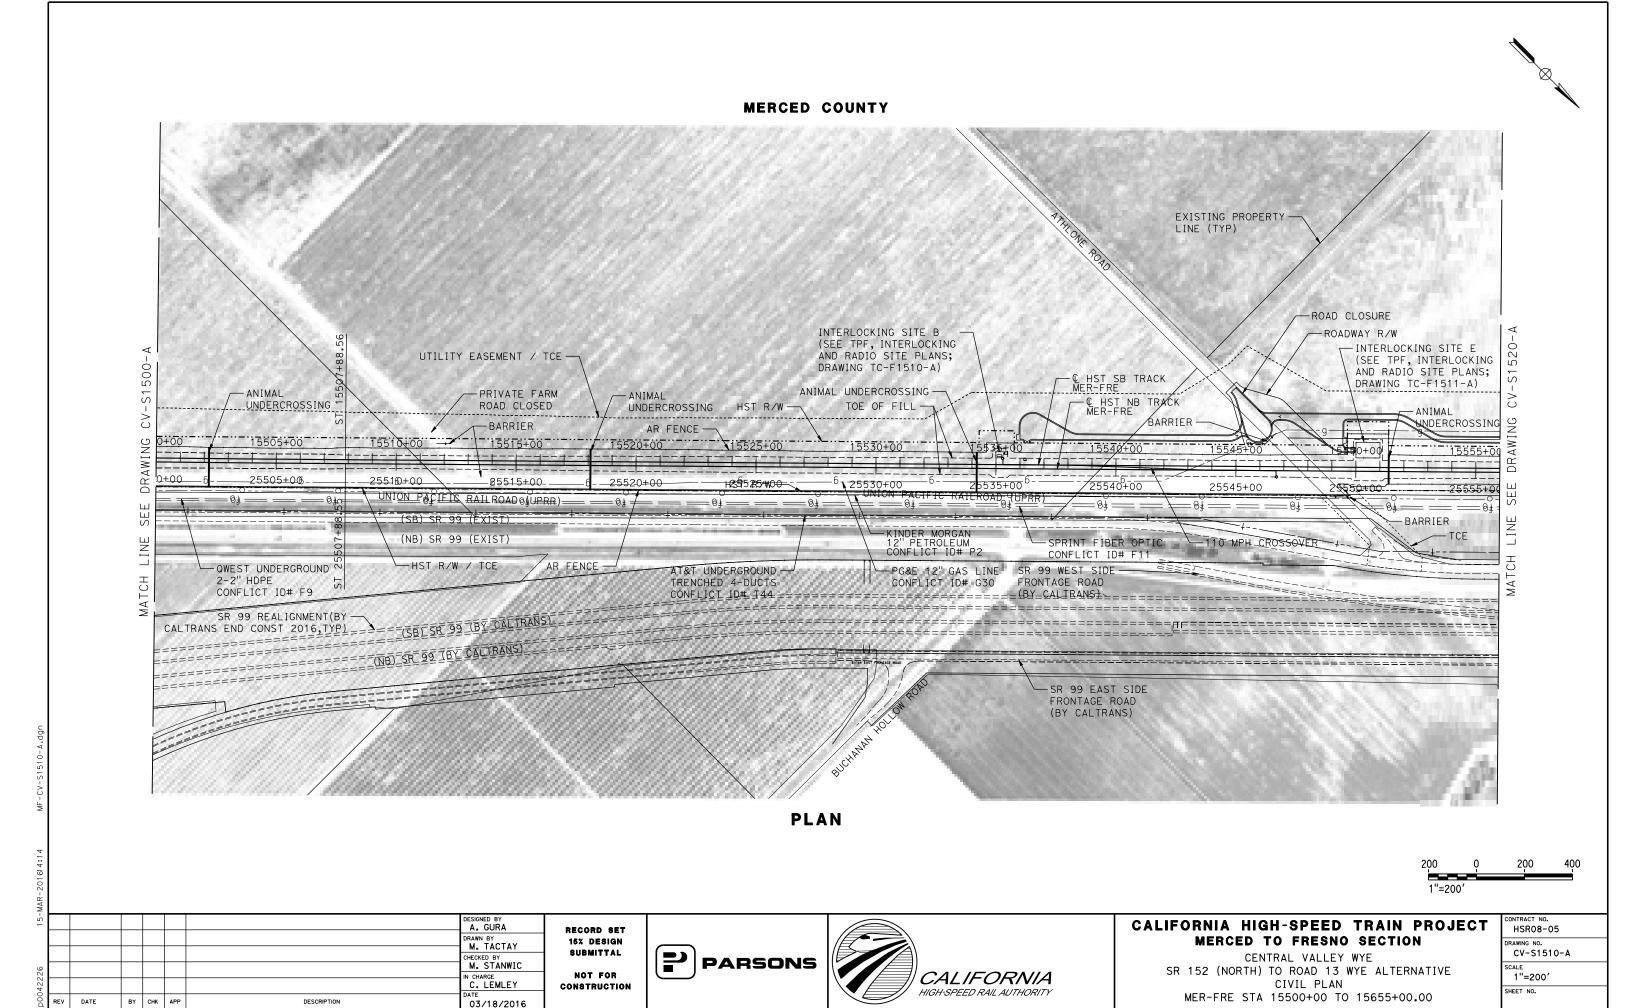


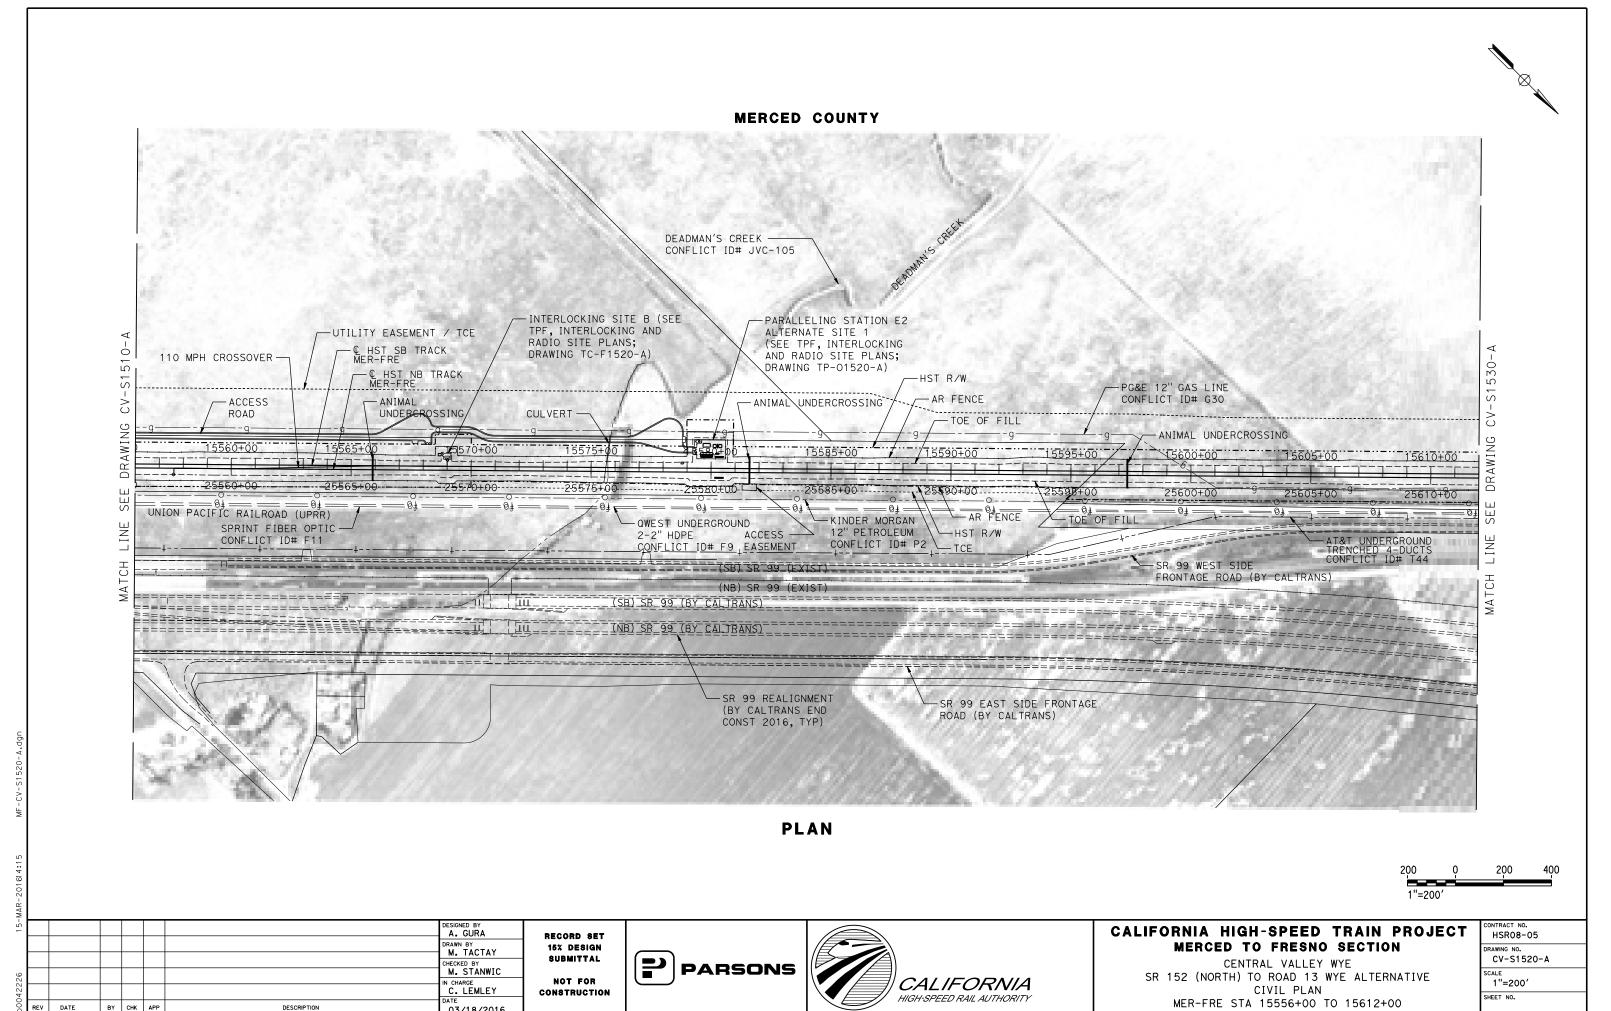

BY CHK APP

DESCRIPTION

03/18/2016

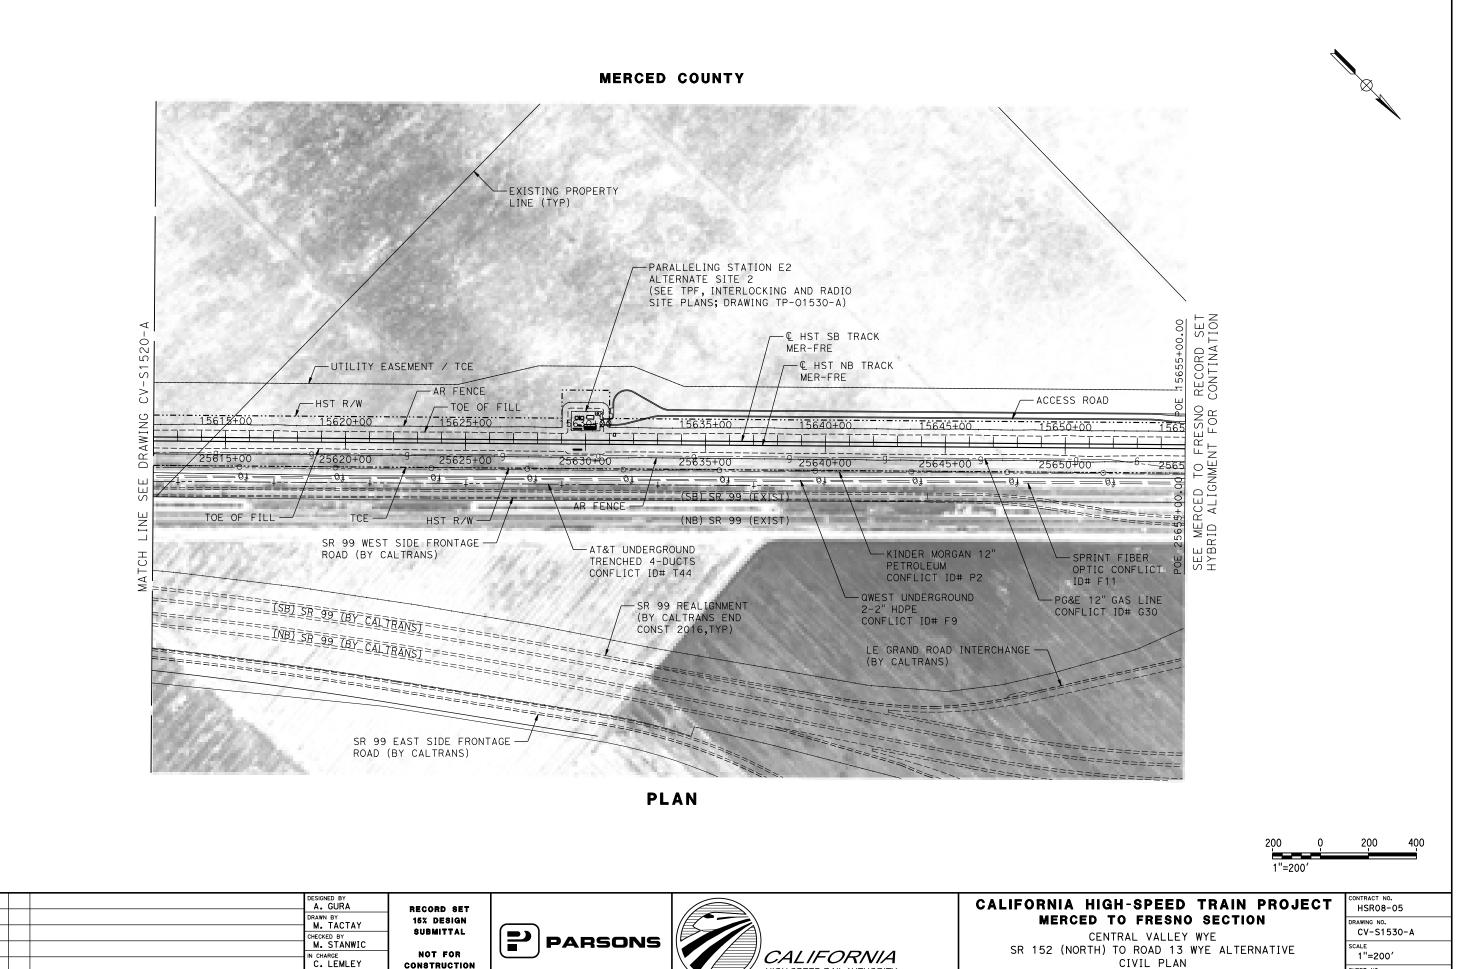

HIGH-SPEED RAIL AUTHORITY

CONSTRUCTION

03/18/2016

DATE


BY CHK APP


DESCRIPTION


CIVIL PLAN


MER-FRE STA 15612+00 TO 15655+00

SHEET NO.

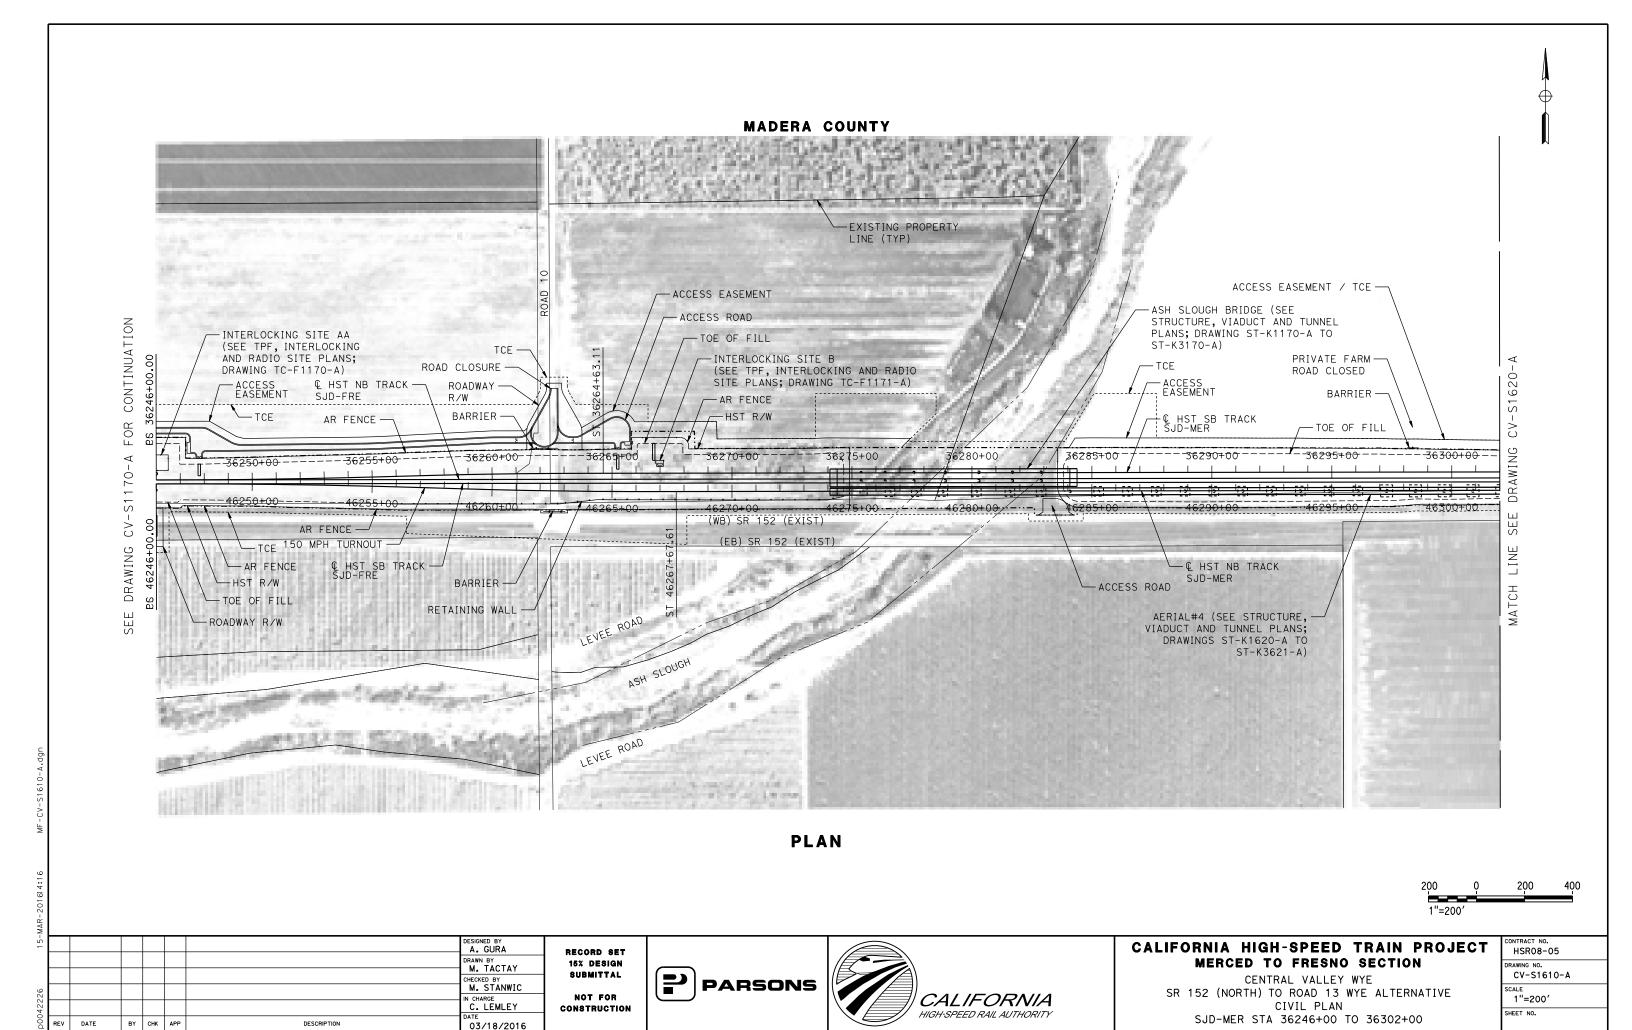

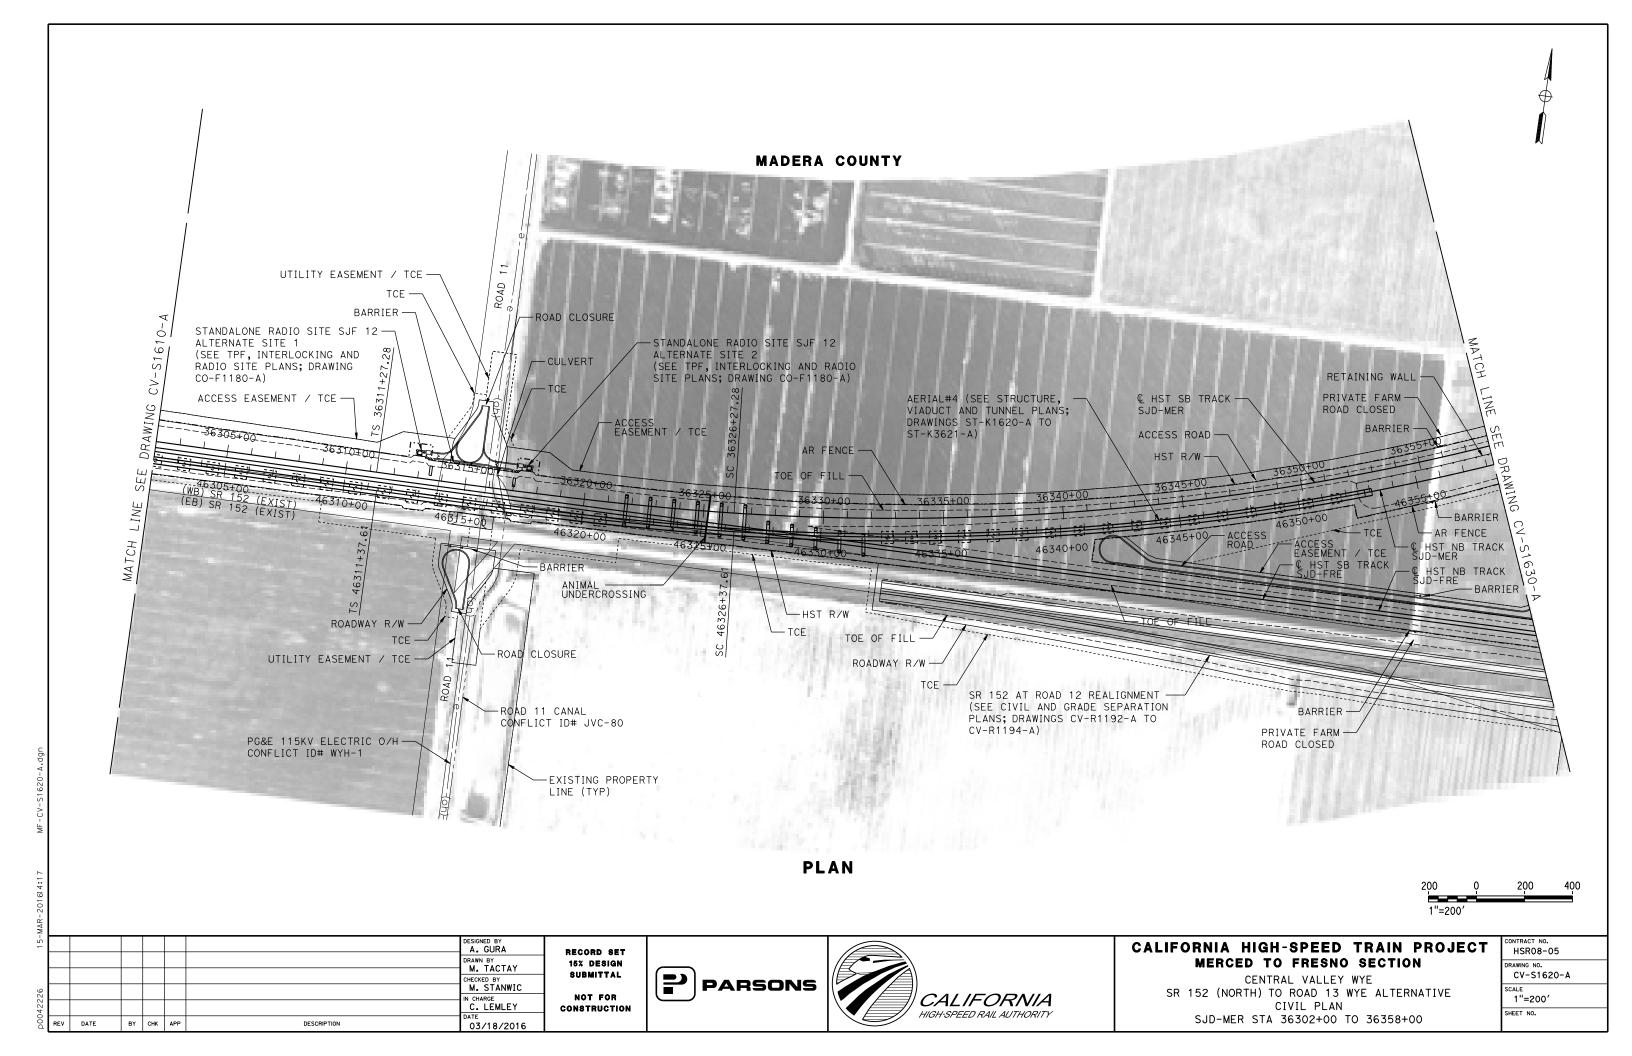

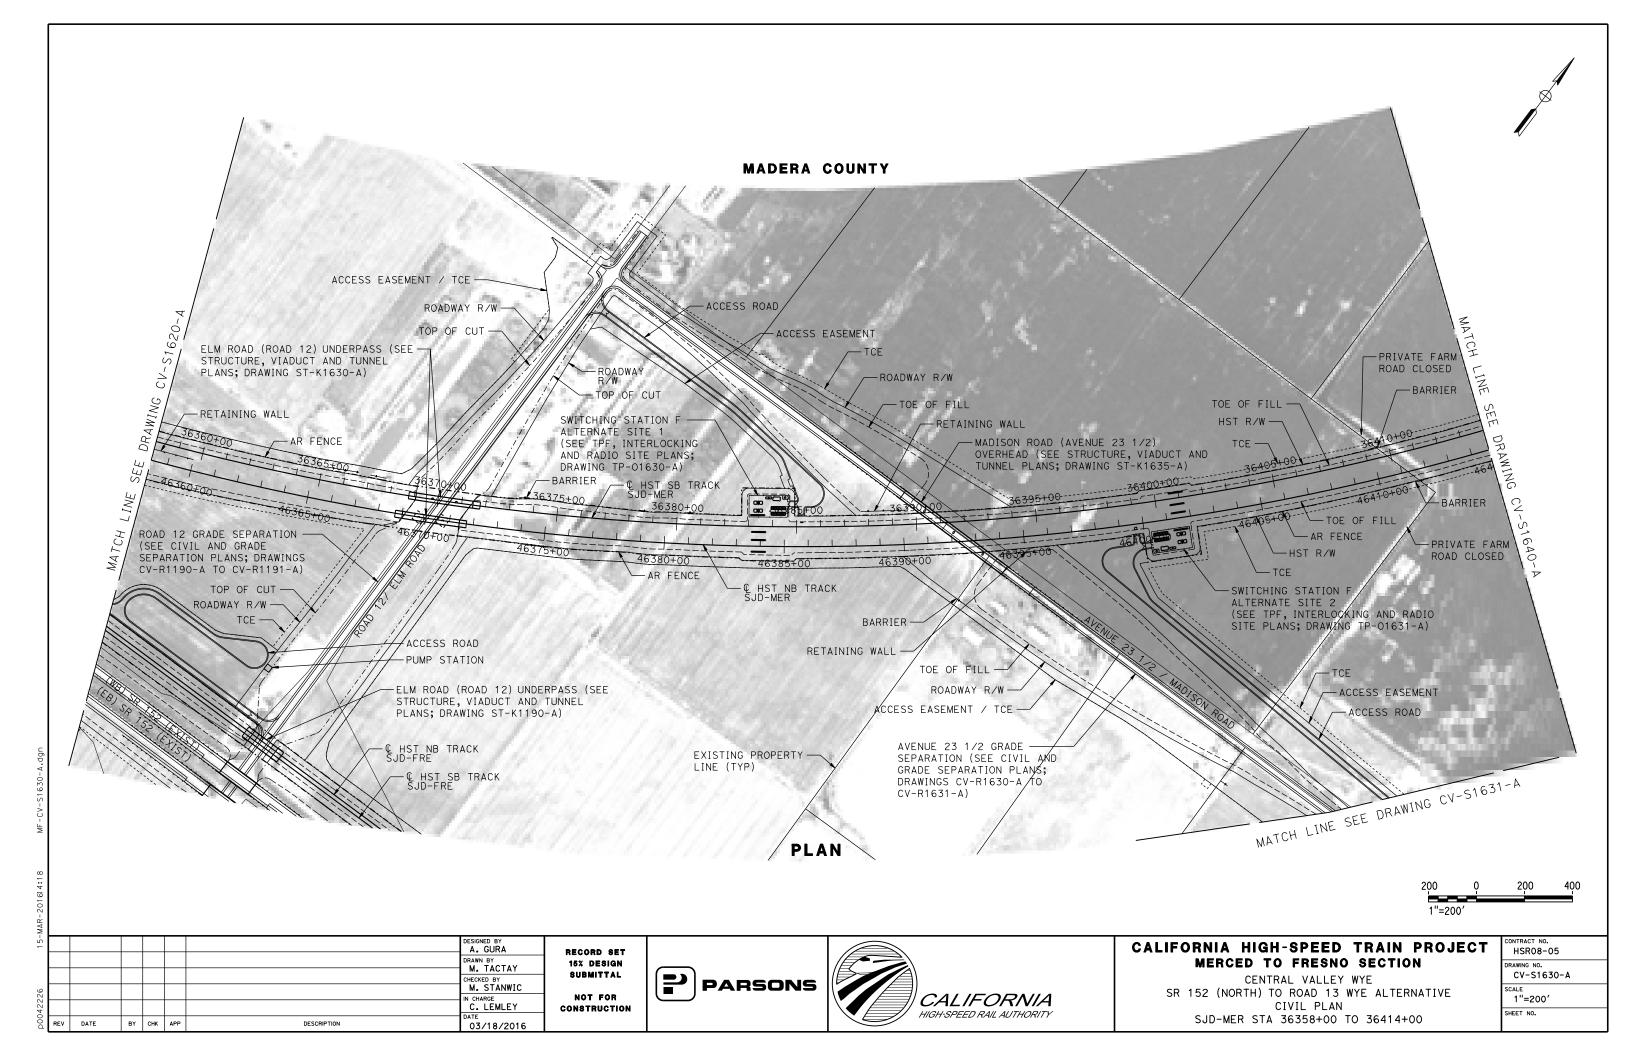

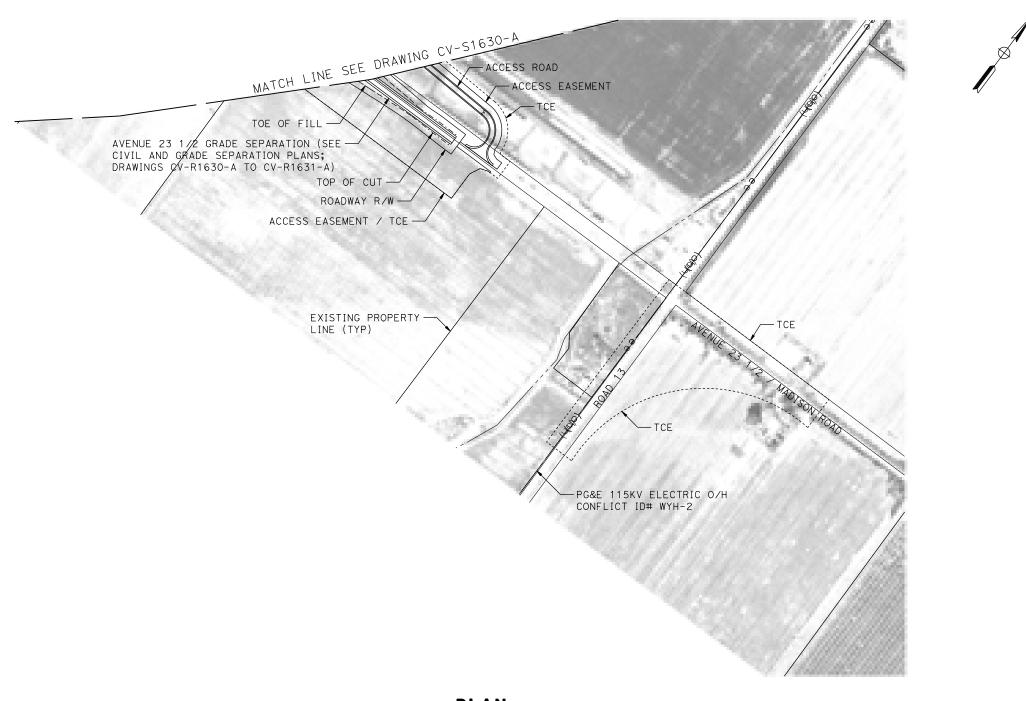

PLAN



î l								
-60							DESIGNED BY A. GURA	
							DRAWN BY M. TACTAY	
							CHECKED BY	
33A							M. STANWIC IN CHARGE	
p00513							C. LEMLEY	C
) 0d	REV	DATE	BY	снк	APP	DESCRIPTION	03/18/2016	

RECORD SET
15% DESIGN
SUBMITTAL
NOT FOR
CONSTRUCTION







# CALIFORNIA HIGH-SPEED TRAIN PROJECT MERCED TO FRESNO SECTION

CENTRAL VALLEY WYE
SR 152 (NORTH) TO ROAD 13 WYE ALTERNATIVE
CIVIL PLAN
SJD-MER ACCESS ROAD

CONTRACT NO. HSR08-05
DRAWING NO. CV-S1631-A
SCALE 1"=200'
SHEET NO.

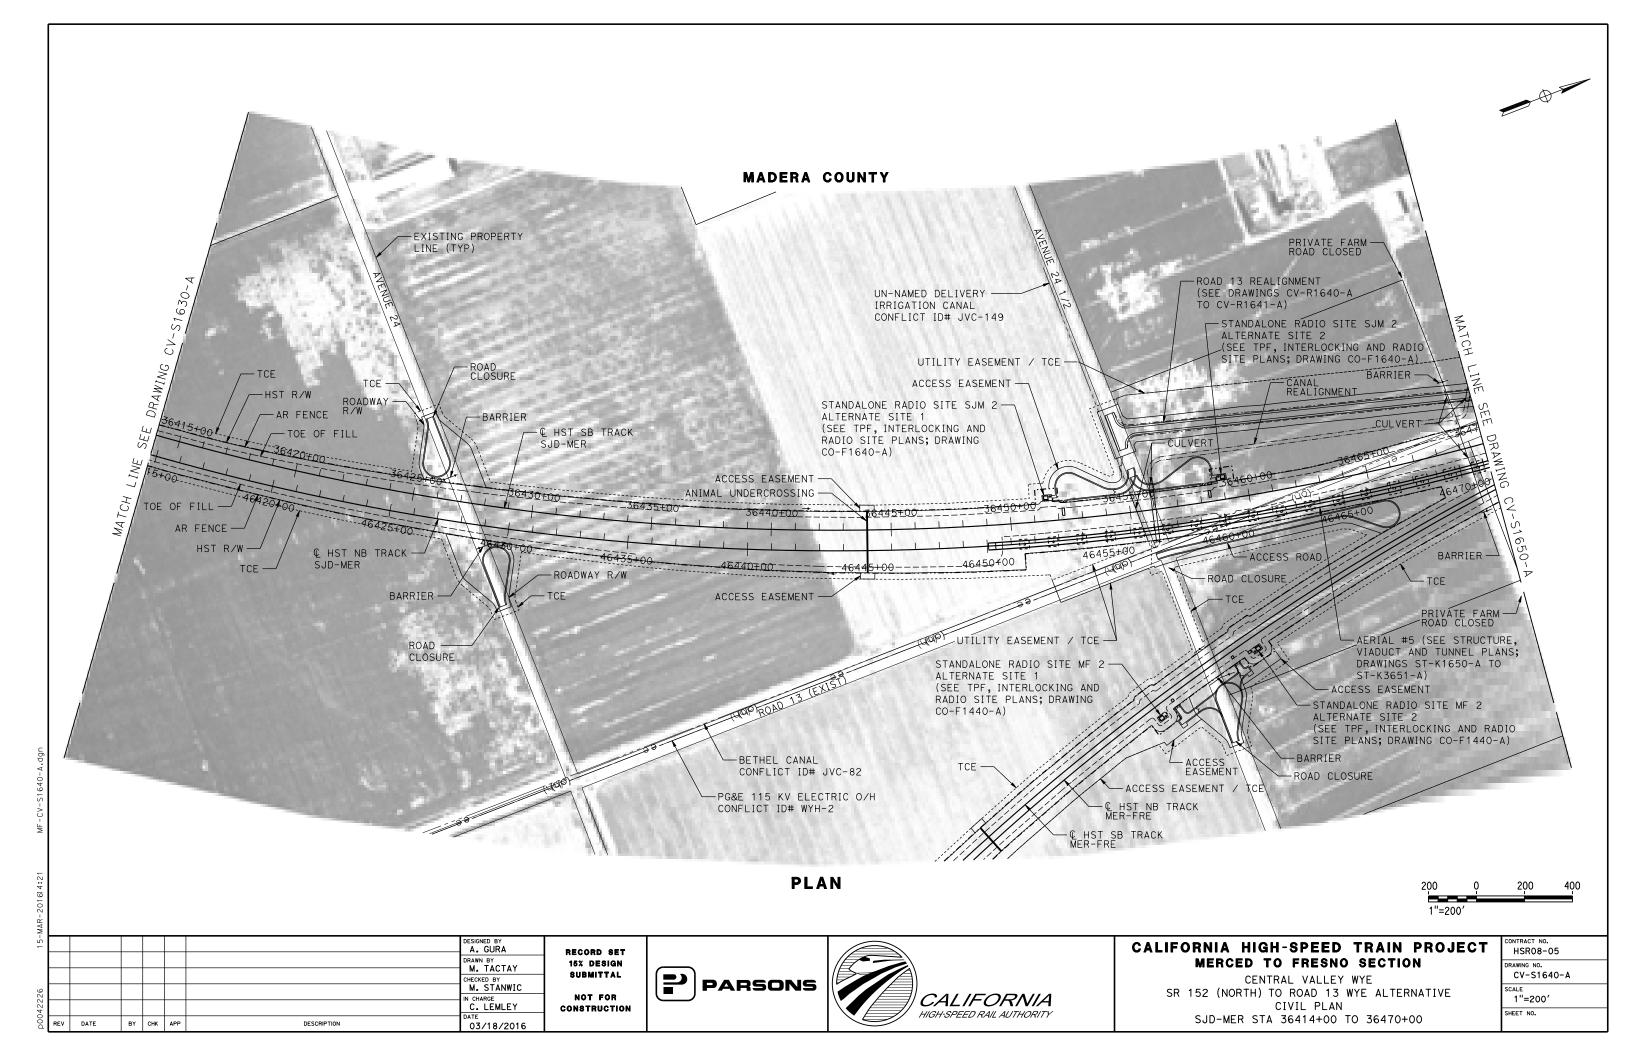



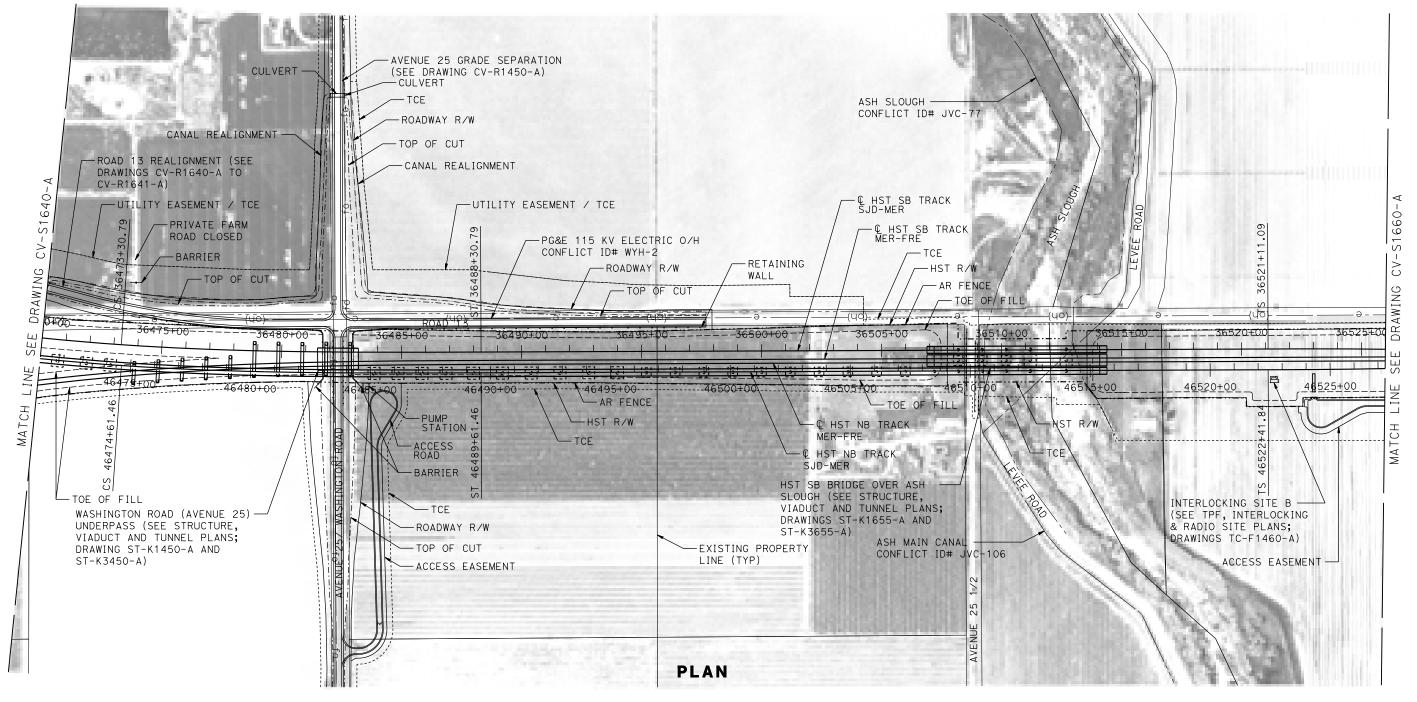

200	Q	200	400
1"=20	0′		

-								
15-							DESIGNED BY A. GURA	
							DRAWN BY M. TACTAY	l '
							CHECKED BY	i
226							M. STANWIC IN CHARGE	ł
42							C. LEMLEY	c
D00	REV	DATE	BY	снк	APP	DESCRIPTION	03/18/2016	

RECORD SET
15% DESIGN
SUBMITTAL
NOT FOR
CONSTRUCTION







# CALIFORNIA HIGH-SPEED TRAIN PROJECT MERCED TO FRESNO SECTION

CENTRAL VALLEY WYE
SR 152 (NORTH) TO ROAD 13 WYE ALTERNATIVE
CIVIL PLAN
SJD-MER STA 36470+00 TO 36526+00

	CONTRACT NO. HSRO8-05
	DRAWING NO. CV-S1650-A
	1"=200'
	SHEET NO.

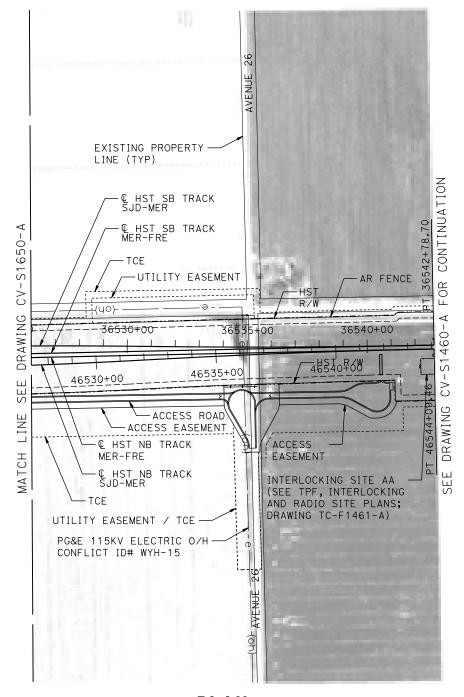

**PLAN** 

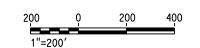

-							DESIGNED BY A. GURA	RI
							DRAWN BY M. TACTAY	1
							CHECKED BY	s
1							M. STANWIC IN CHARGE	
j							C. LEMLEY DATE	CO
7	REV	DATE	BY	СНК	APP	DESCRIPTION	03/18/2016	

RECORD SET
15% DESIGN
SUBMITTAL
NOT FOR
CONSTRUCTION








# CALIFORNIA HIGH-SPEED TRAIN PROJECT MERCED TO FRESNO SECTION


CENTRAL VALLEY WYE
SR 152 (NORTH) TO ROAD 13 WYE ALTERNATIVE
CIVIL PLAN
SJD-MER STA 36526+00 TO 36542+78.70


CONTRACT NO. HSR08-05
DRAWING NO. CV-S1660-A
SCALE 1"=200'
SHEET NO.

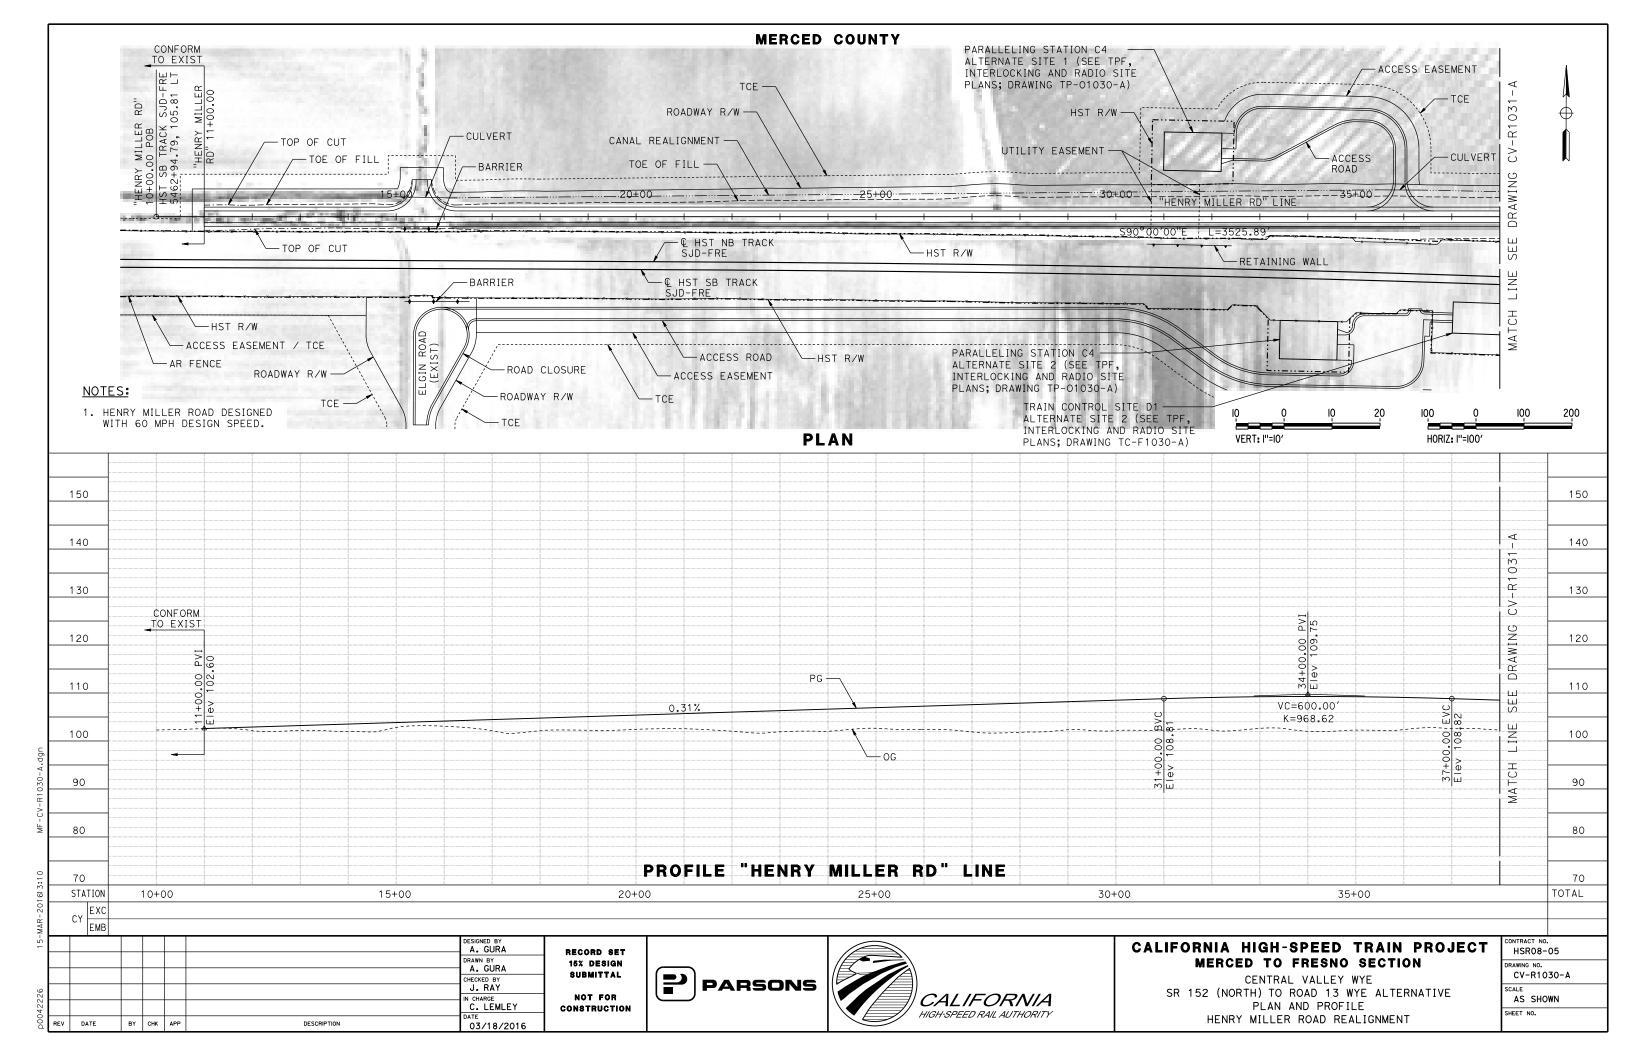


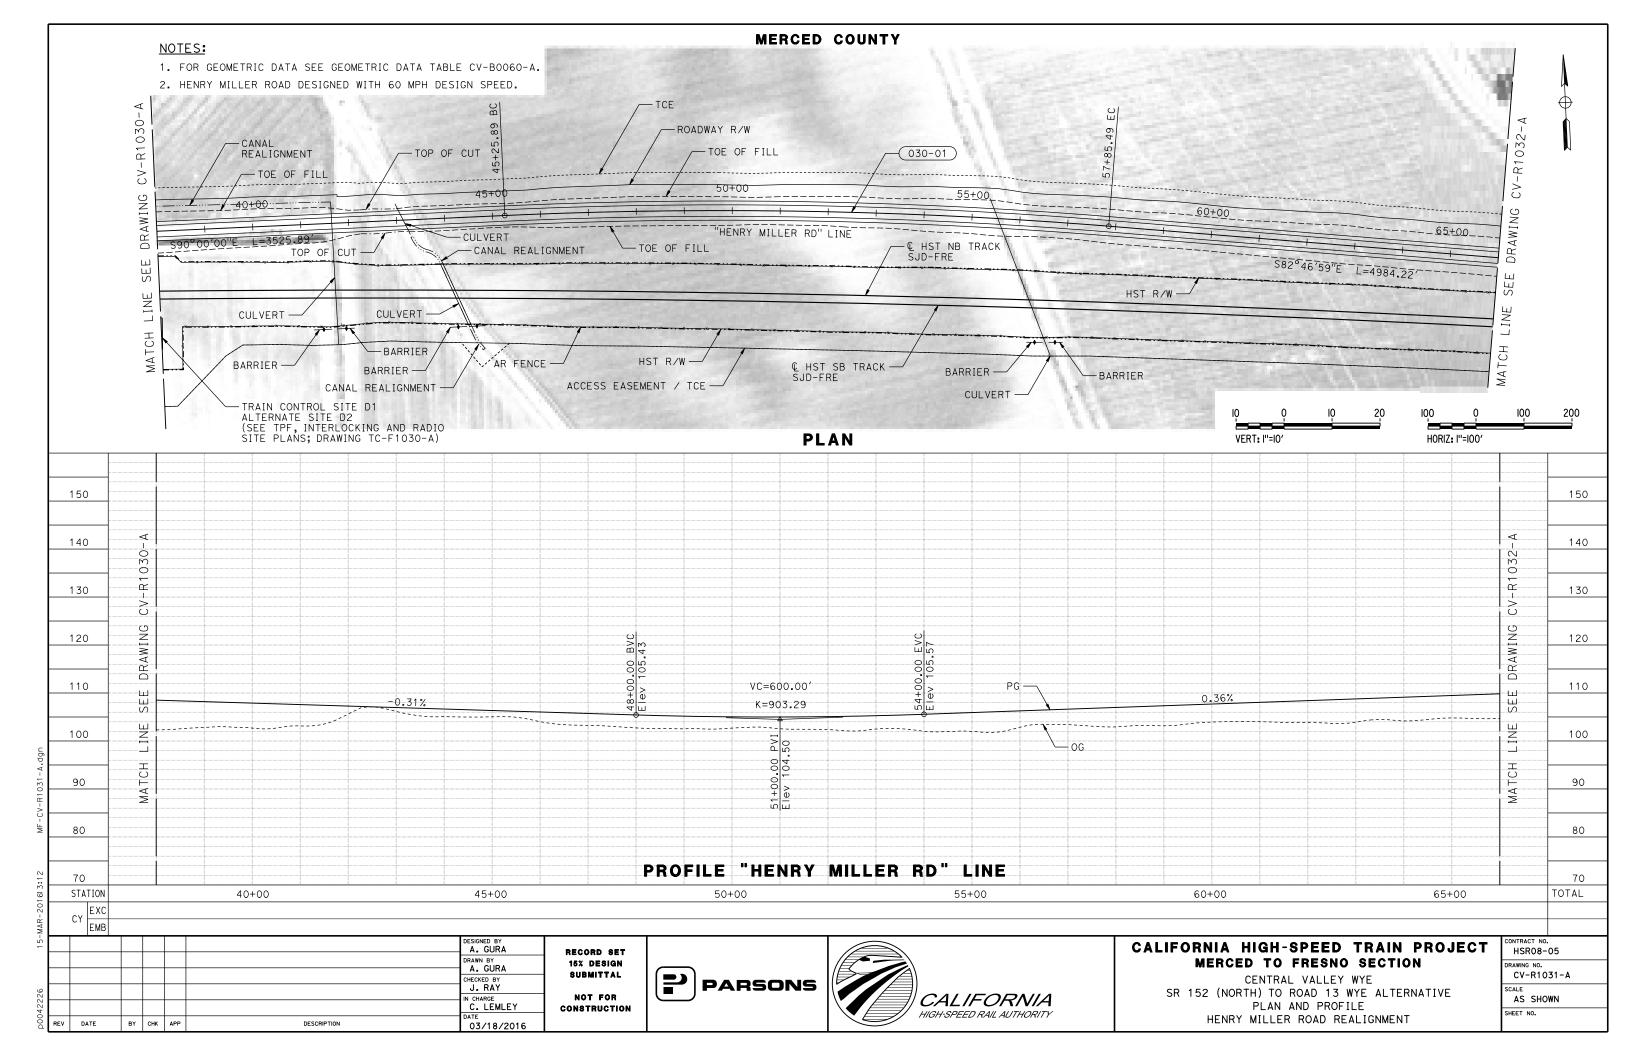


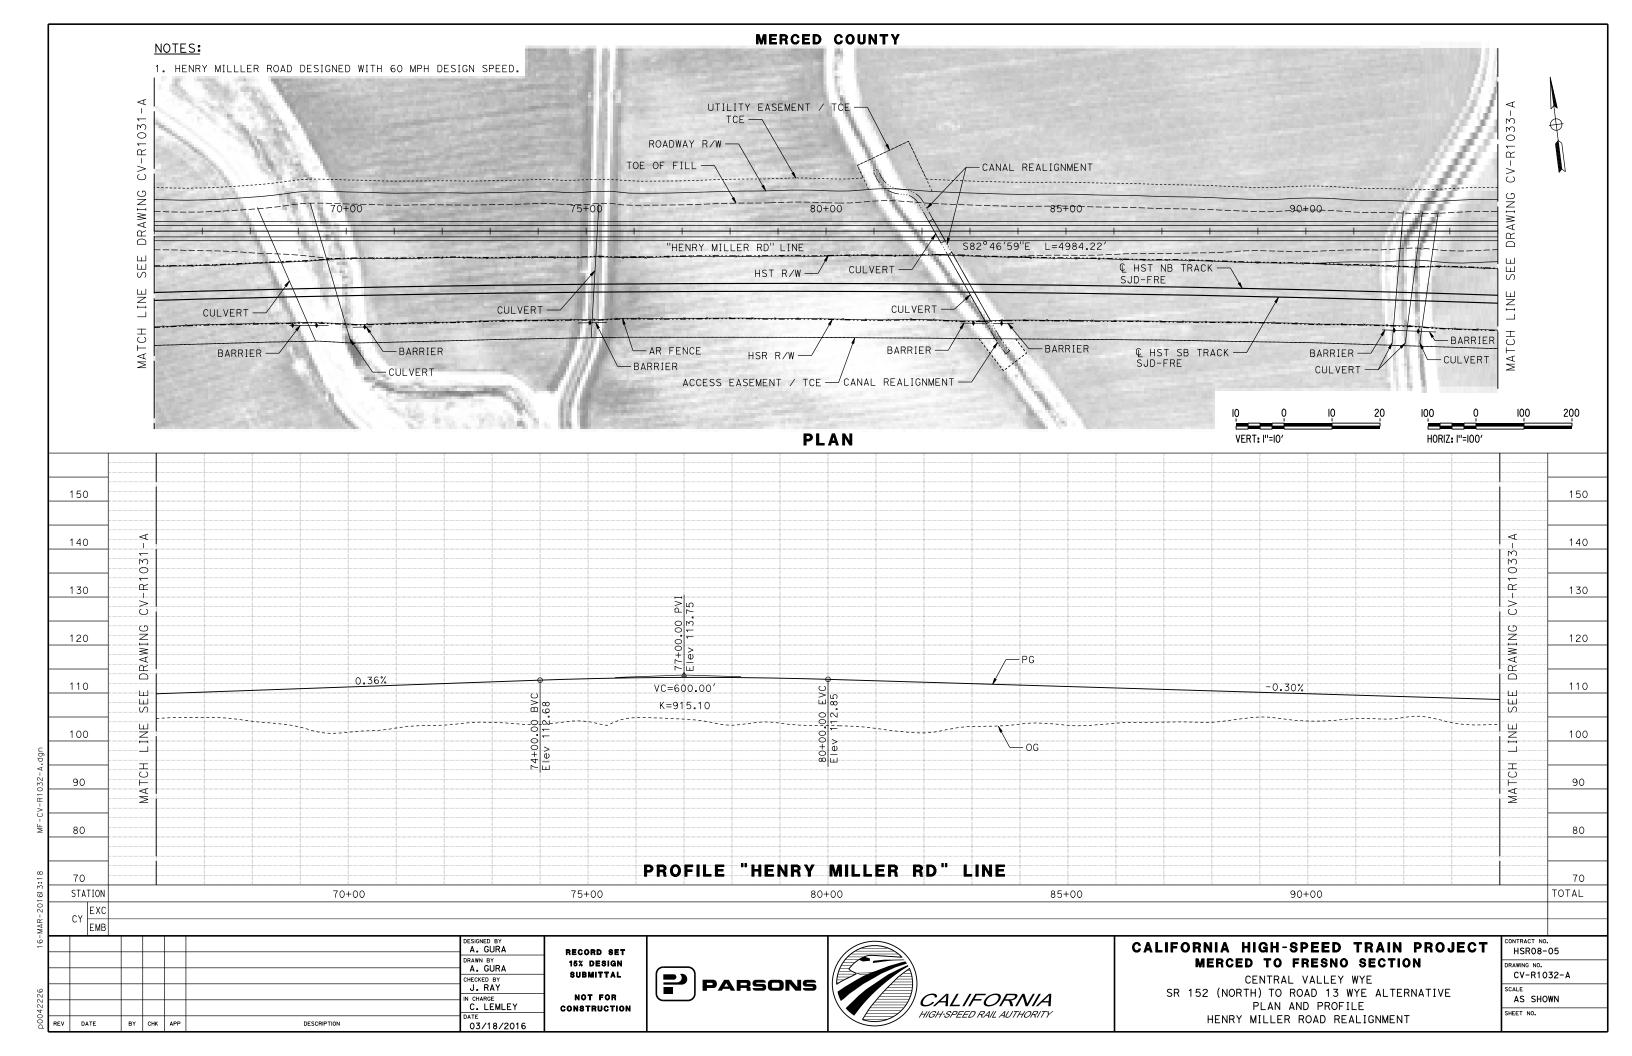


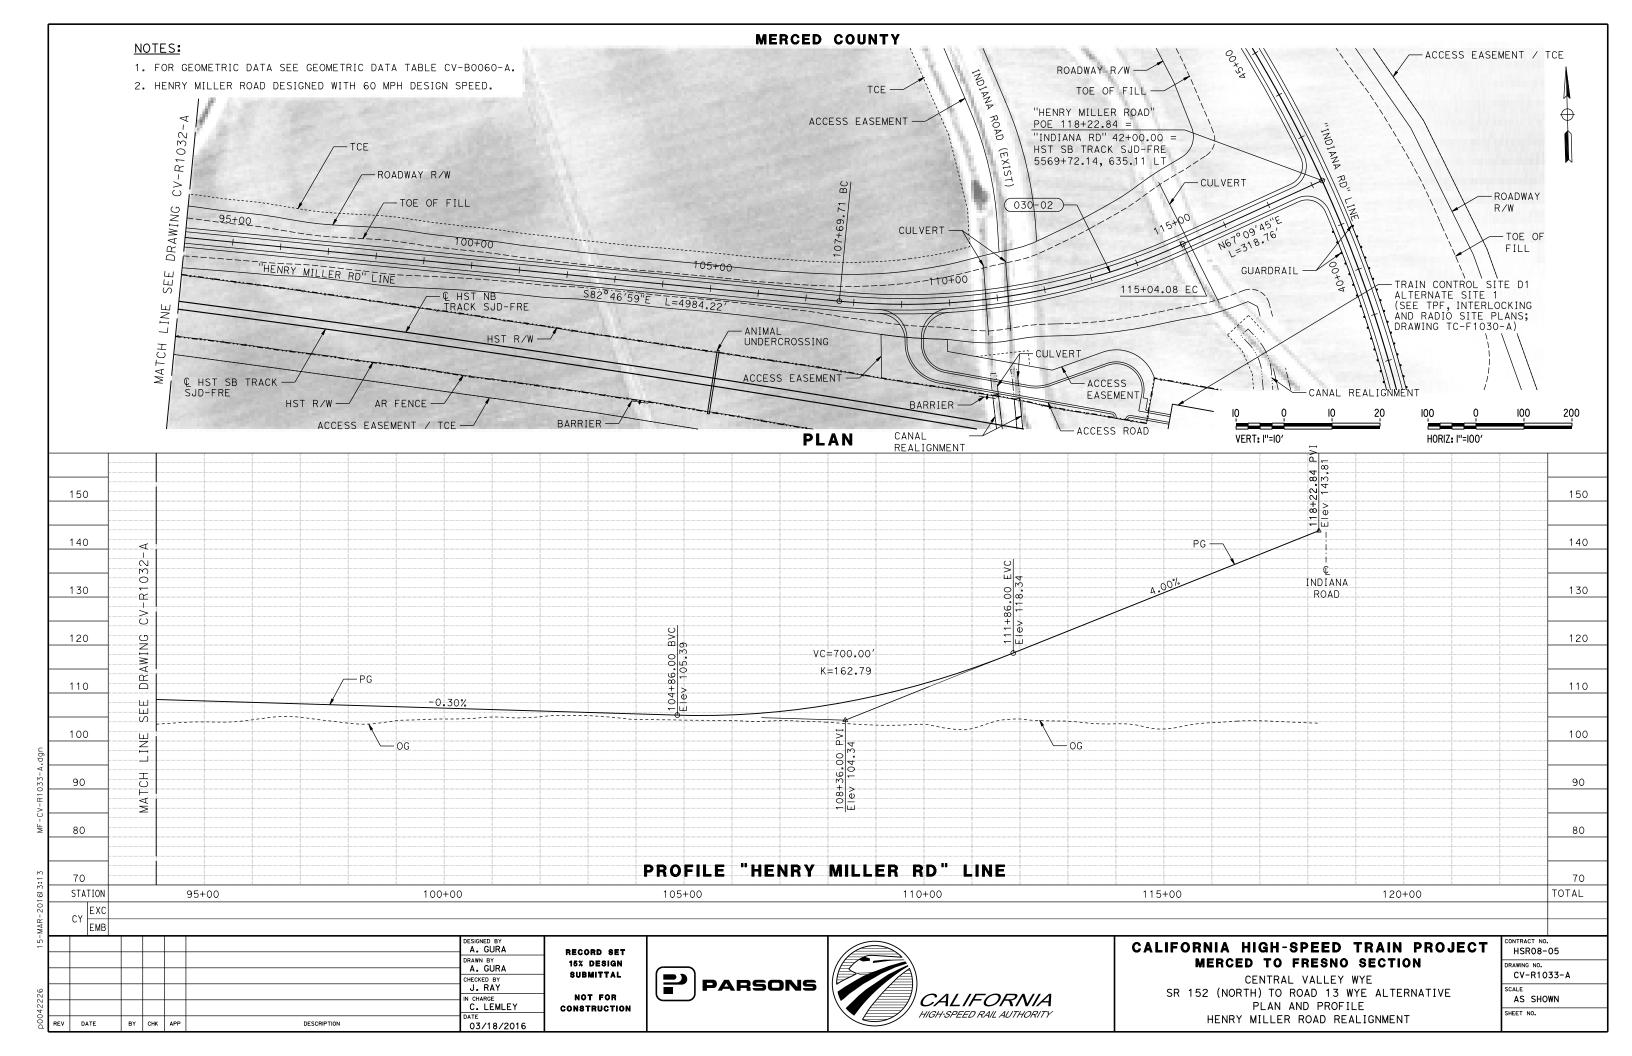


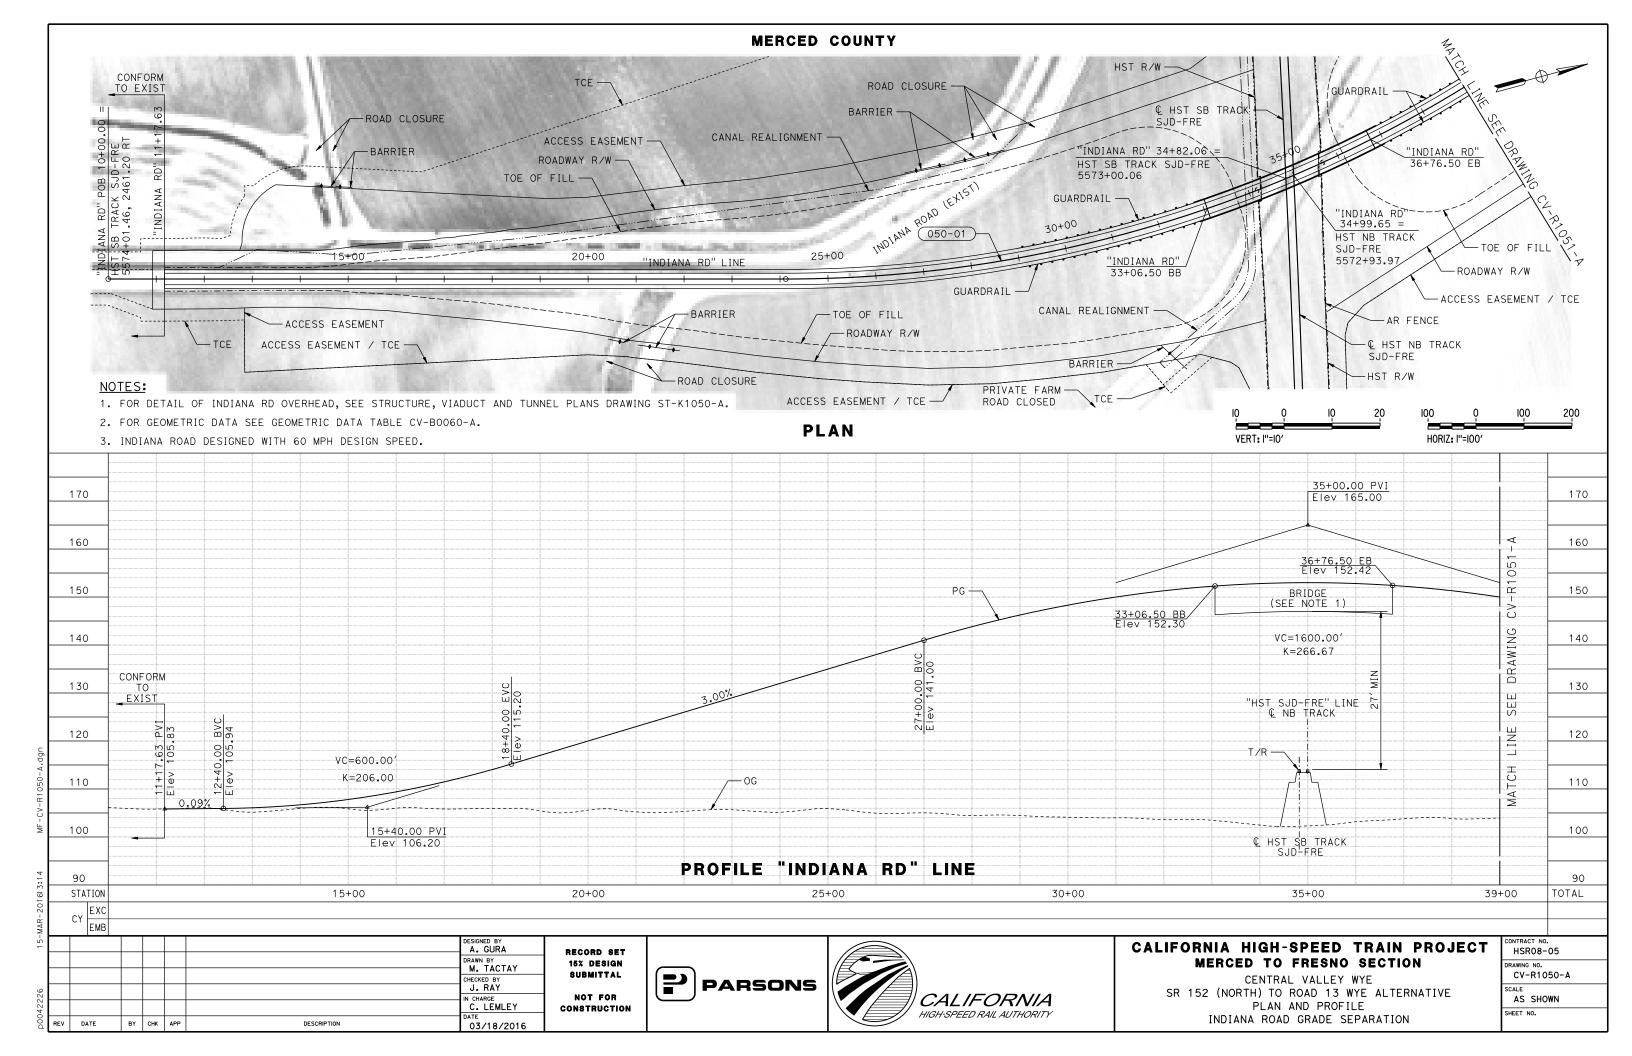


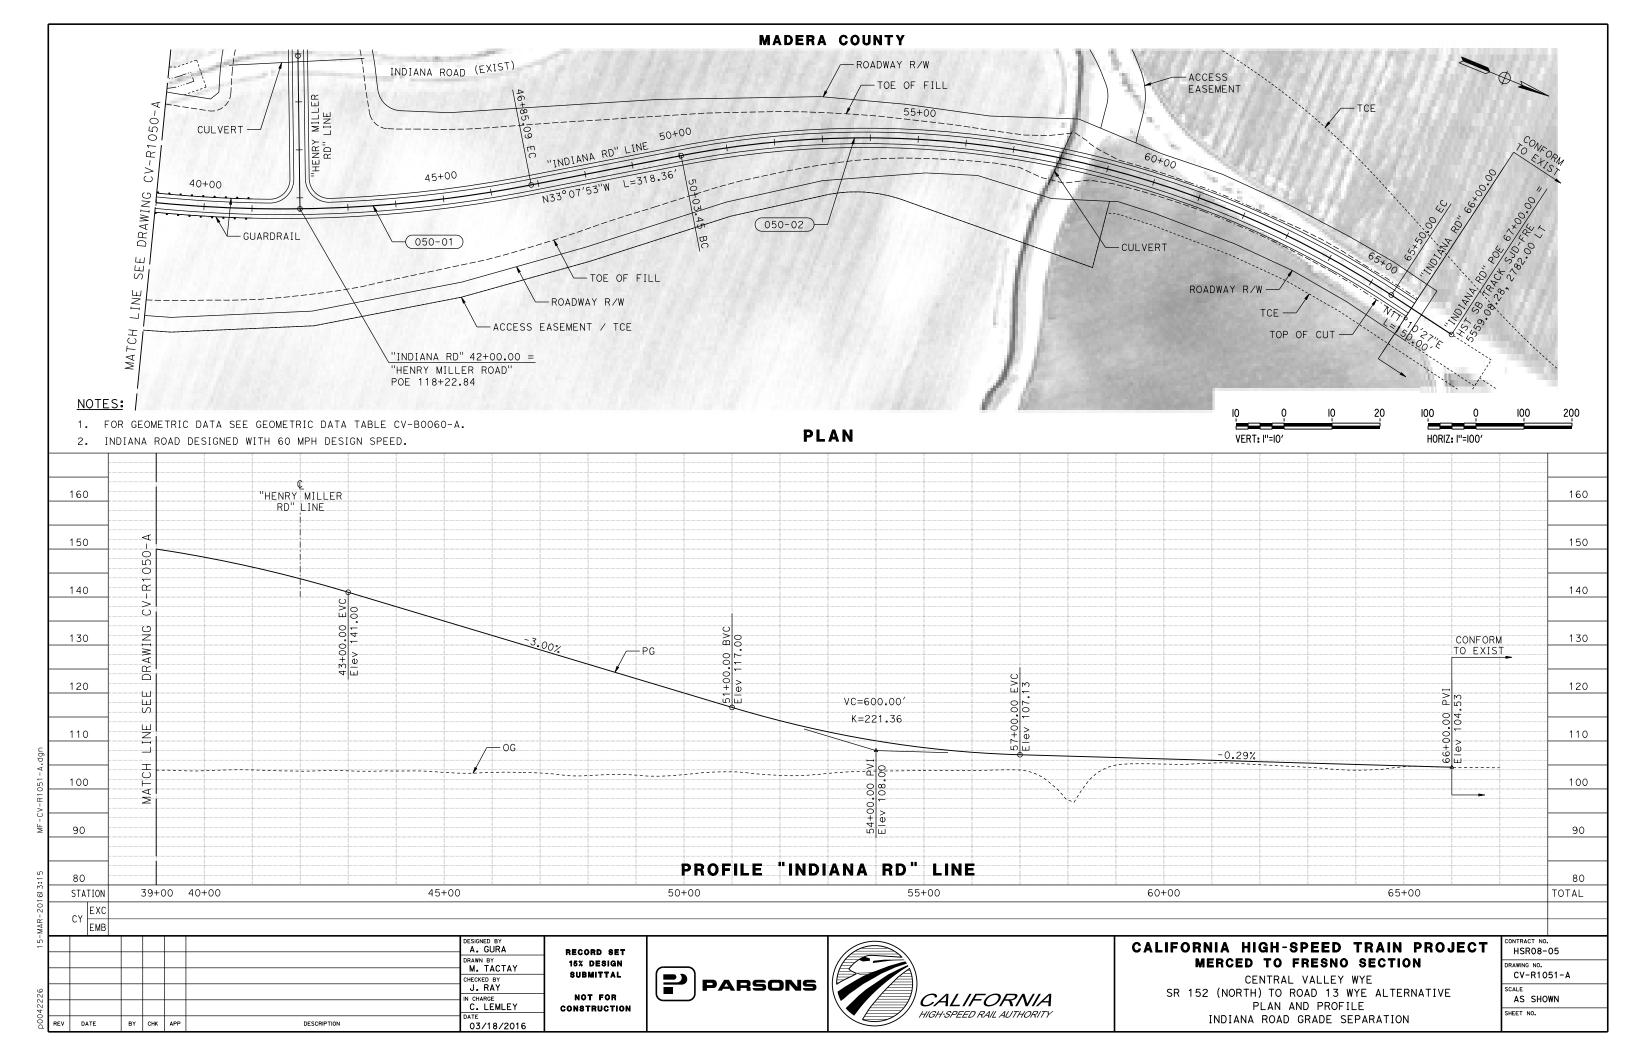


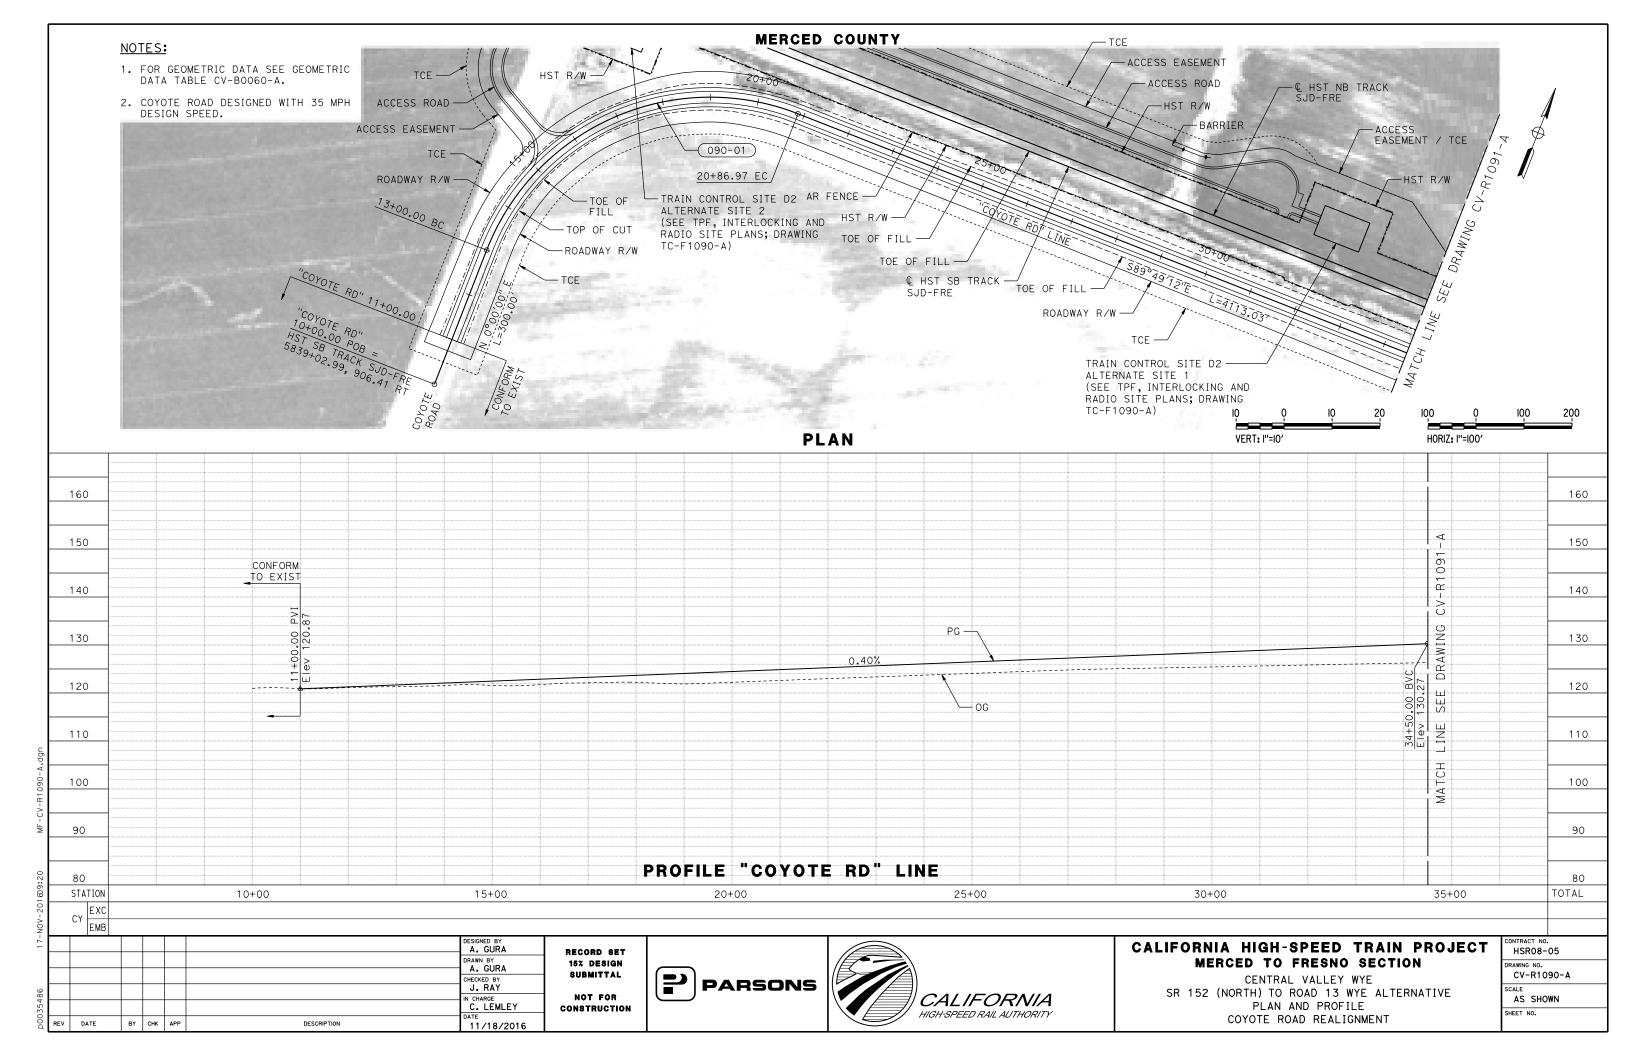


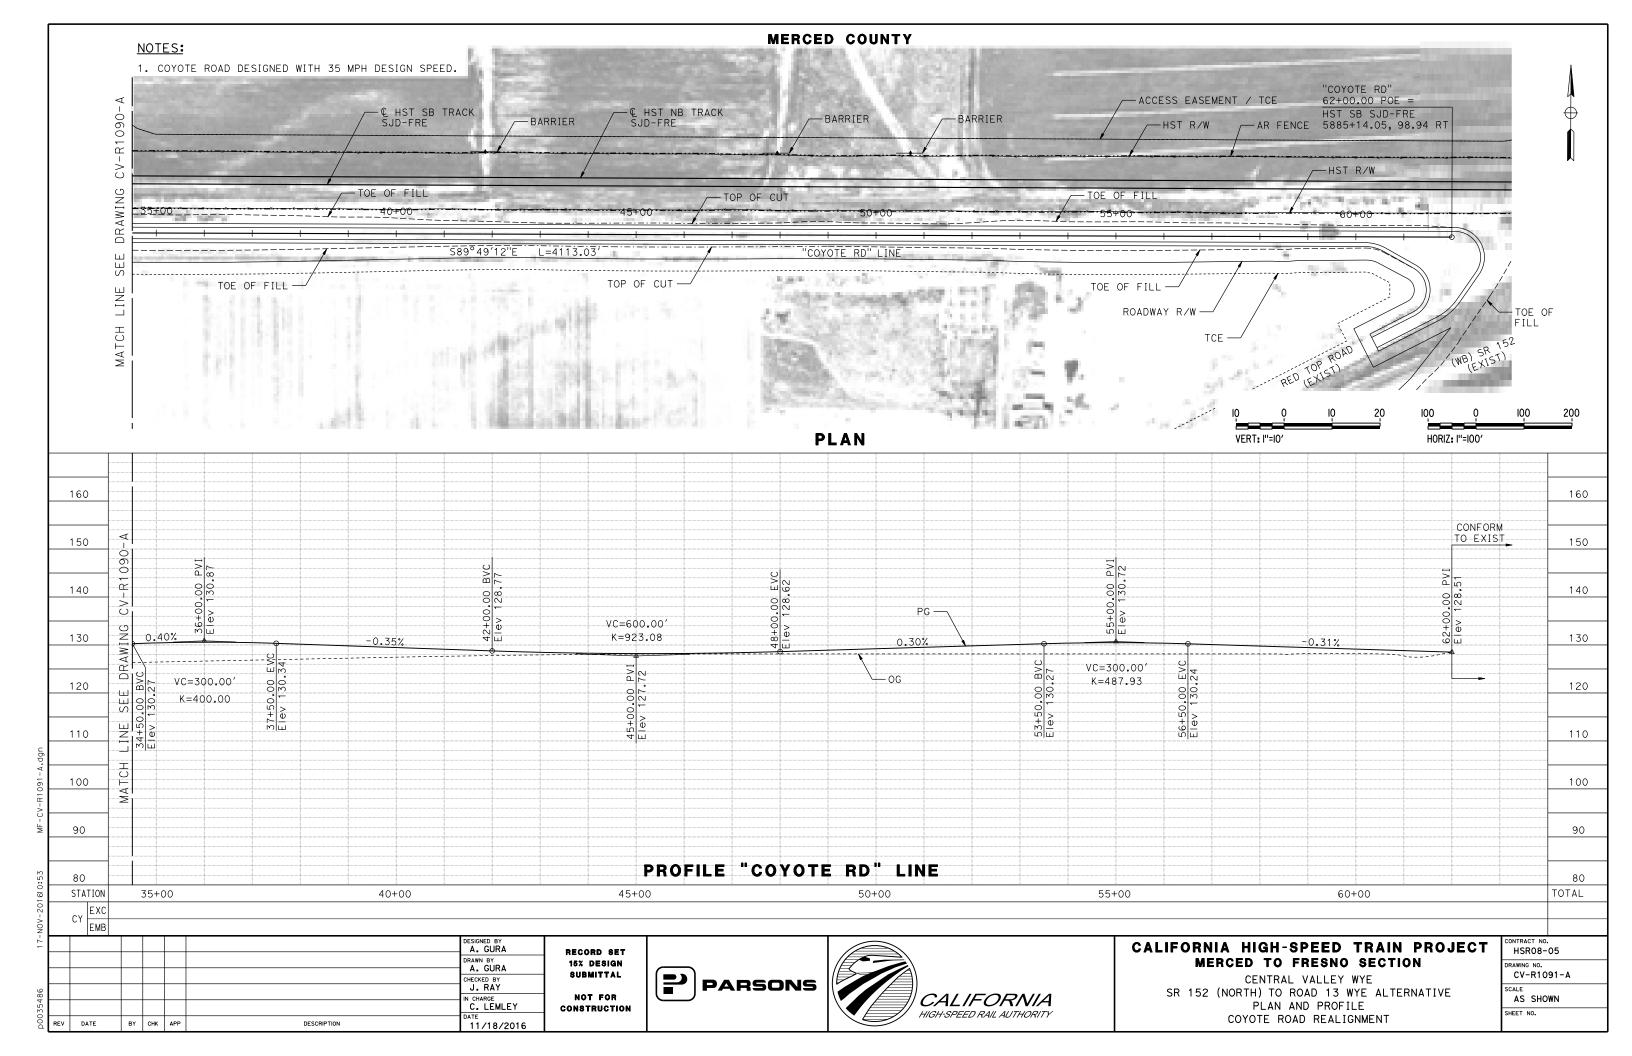


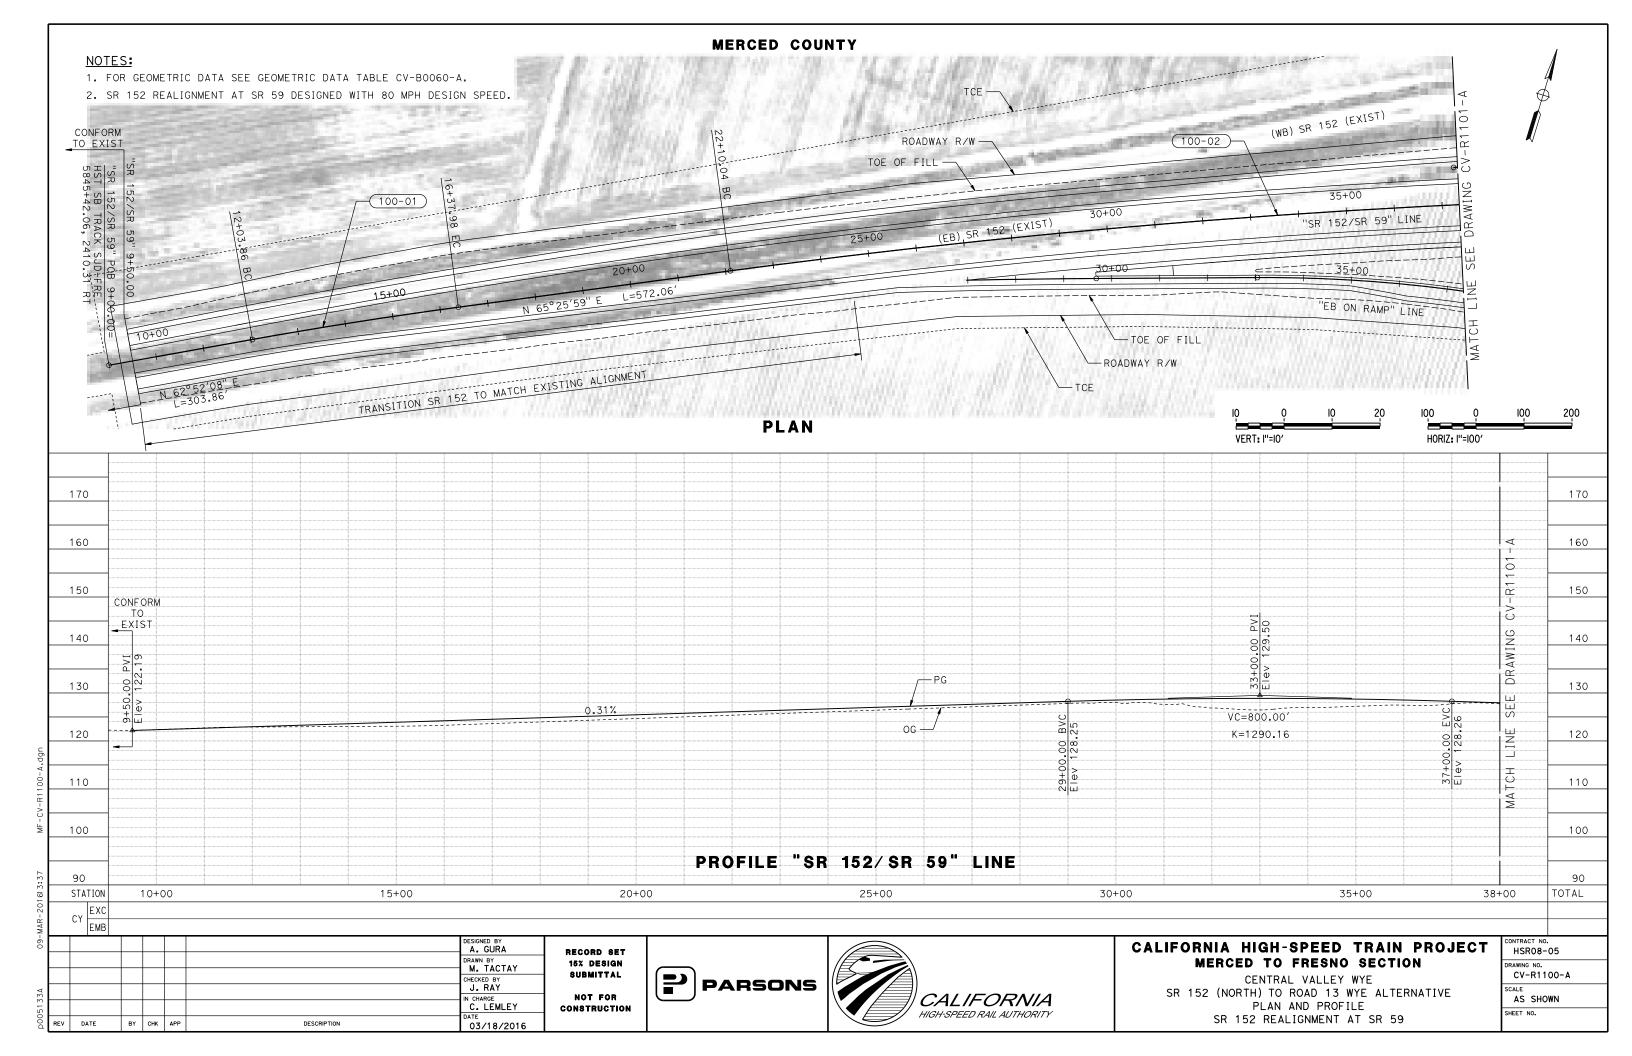


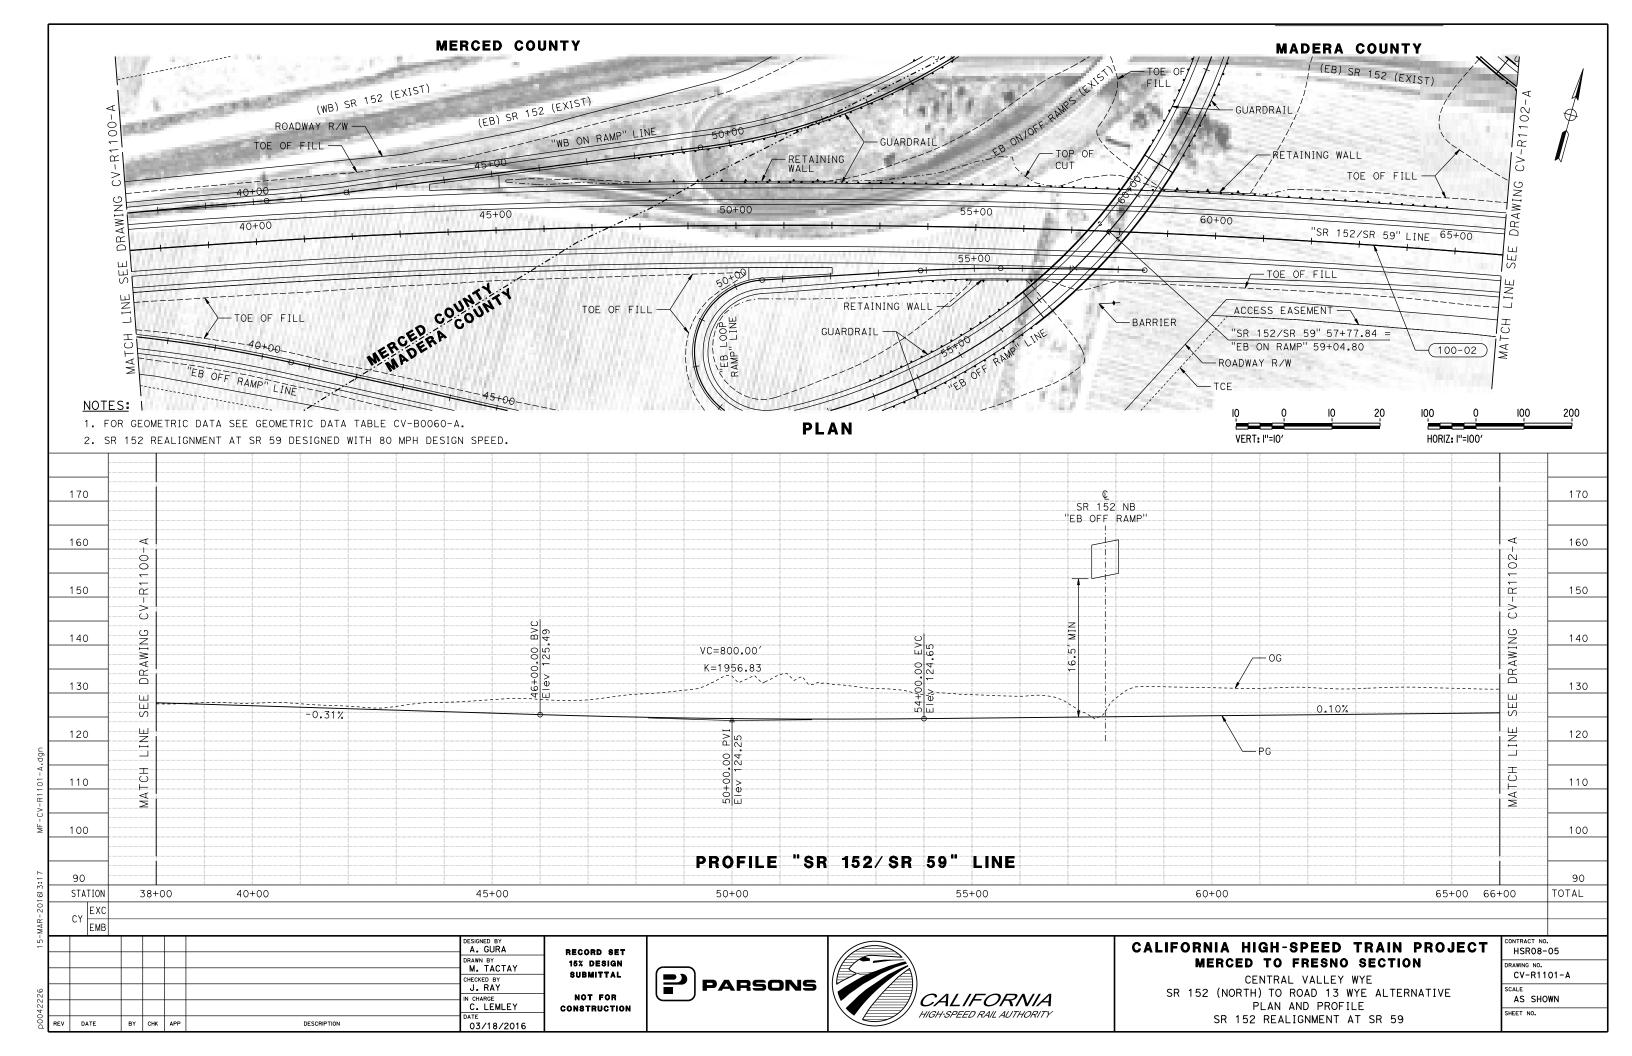


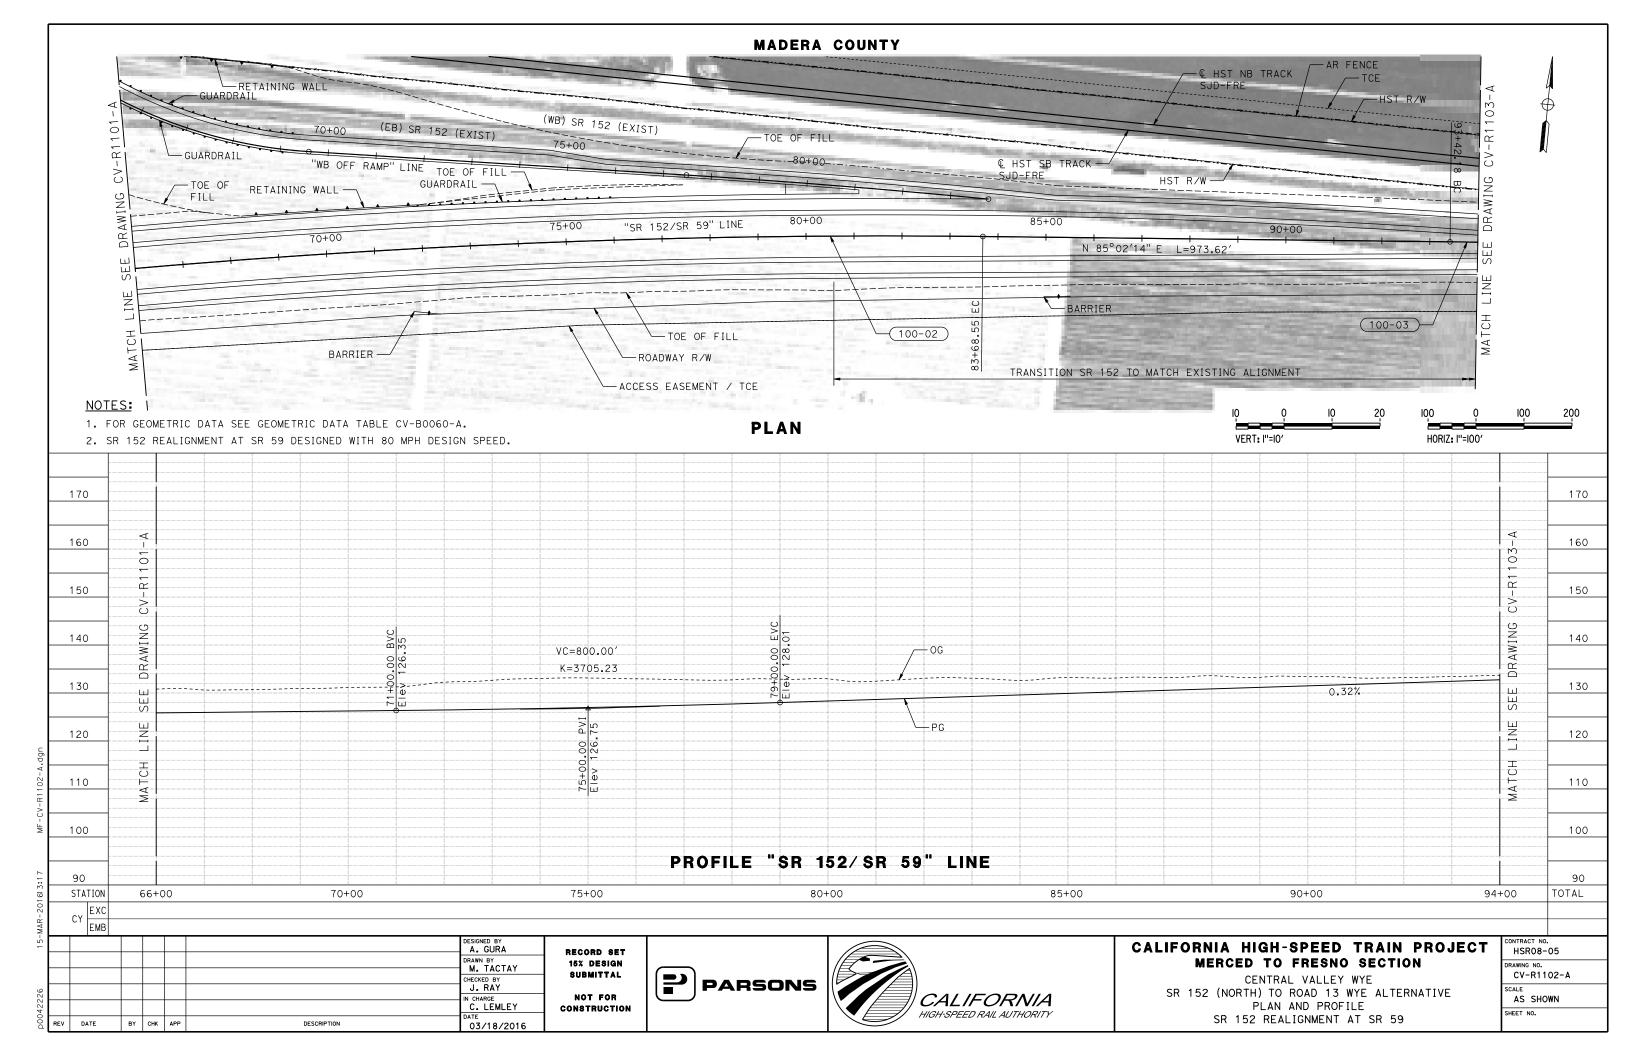


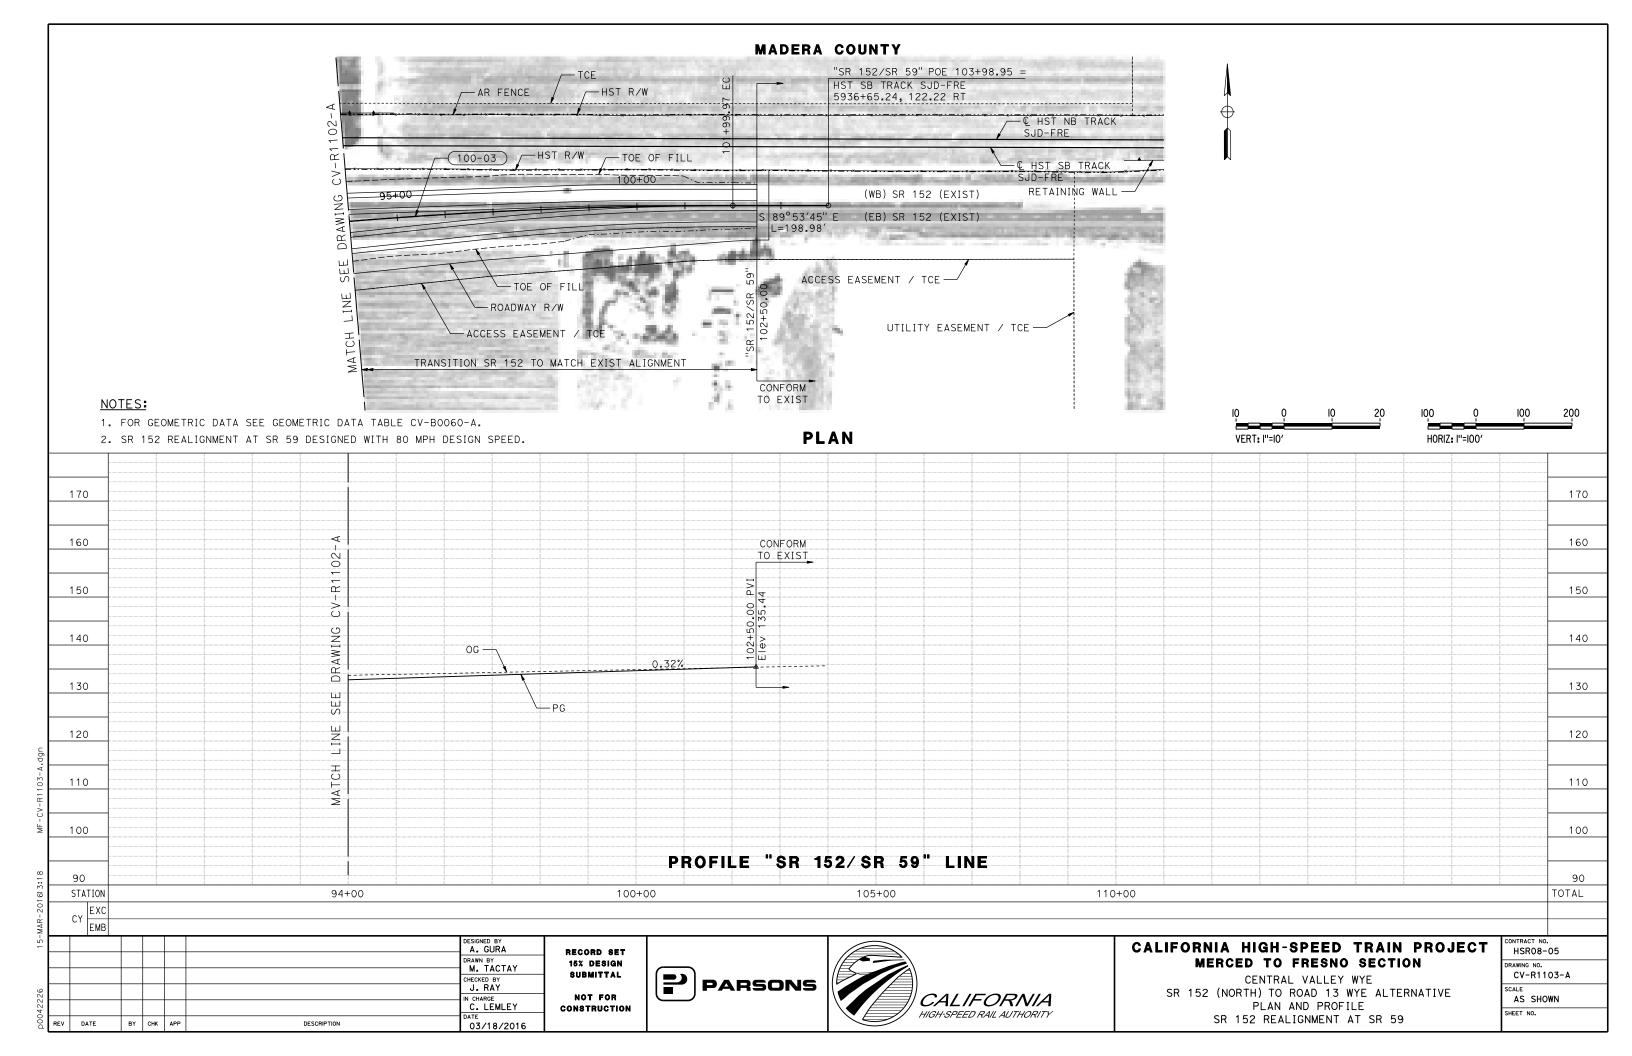


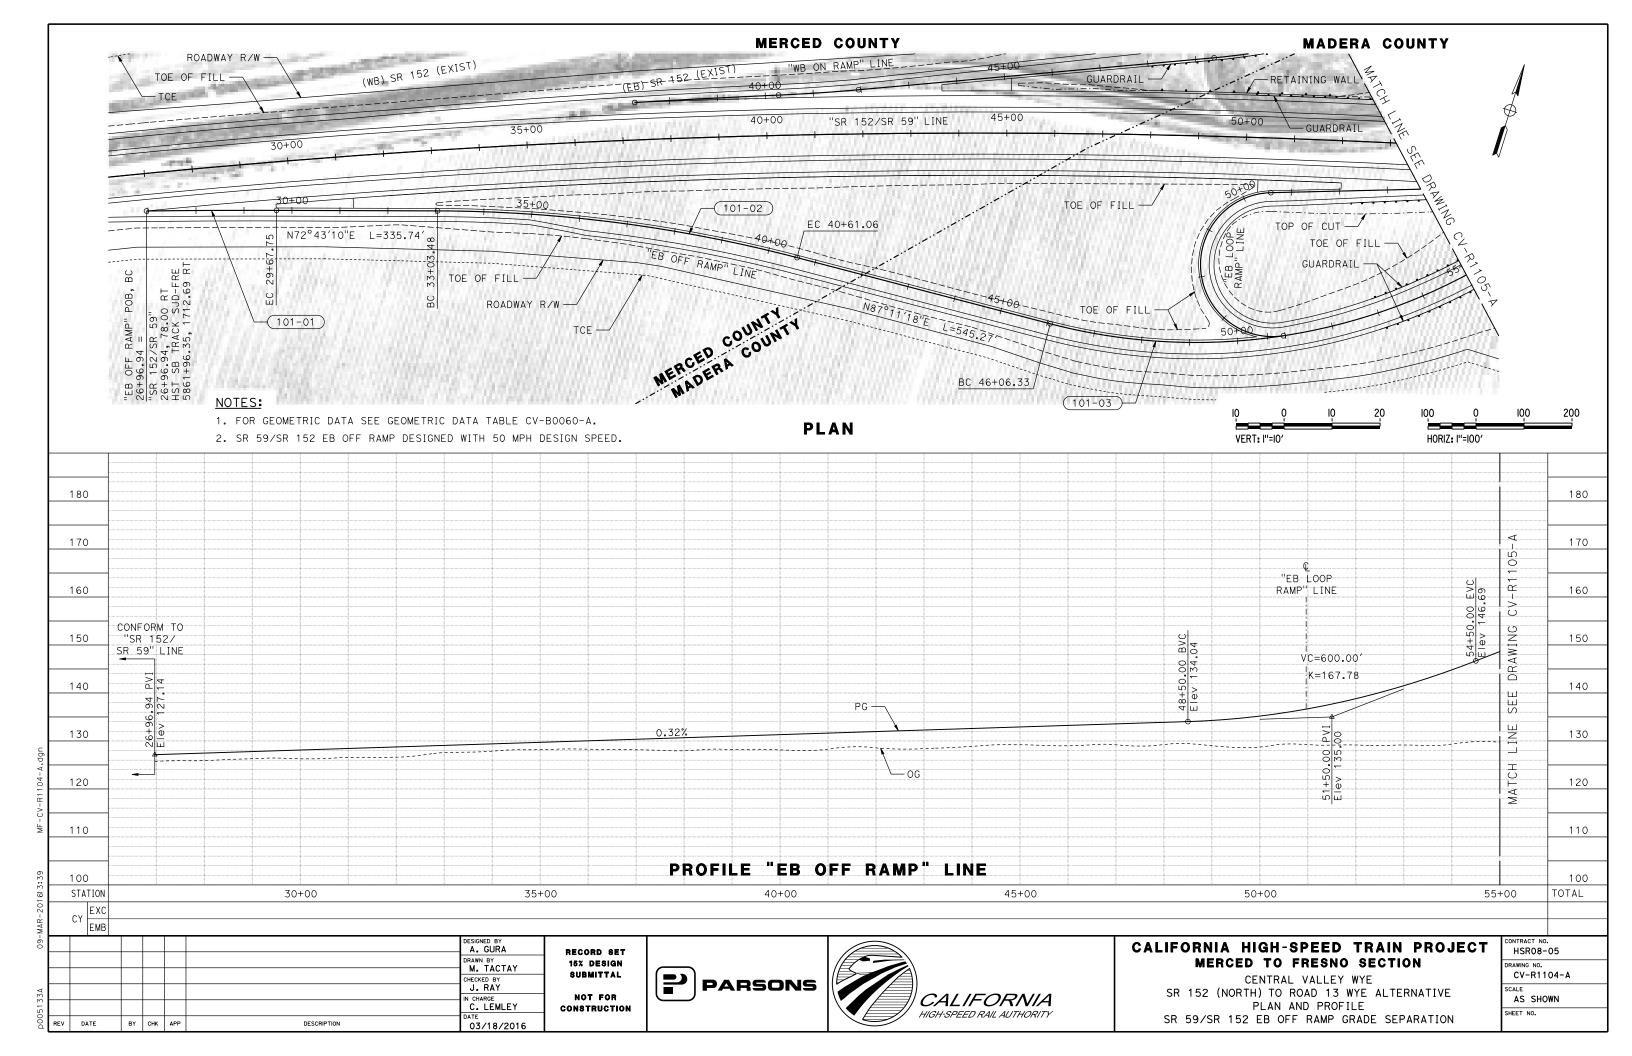


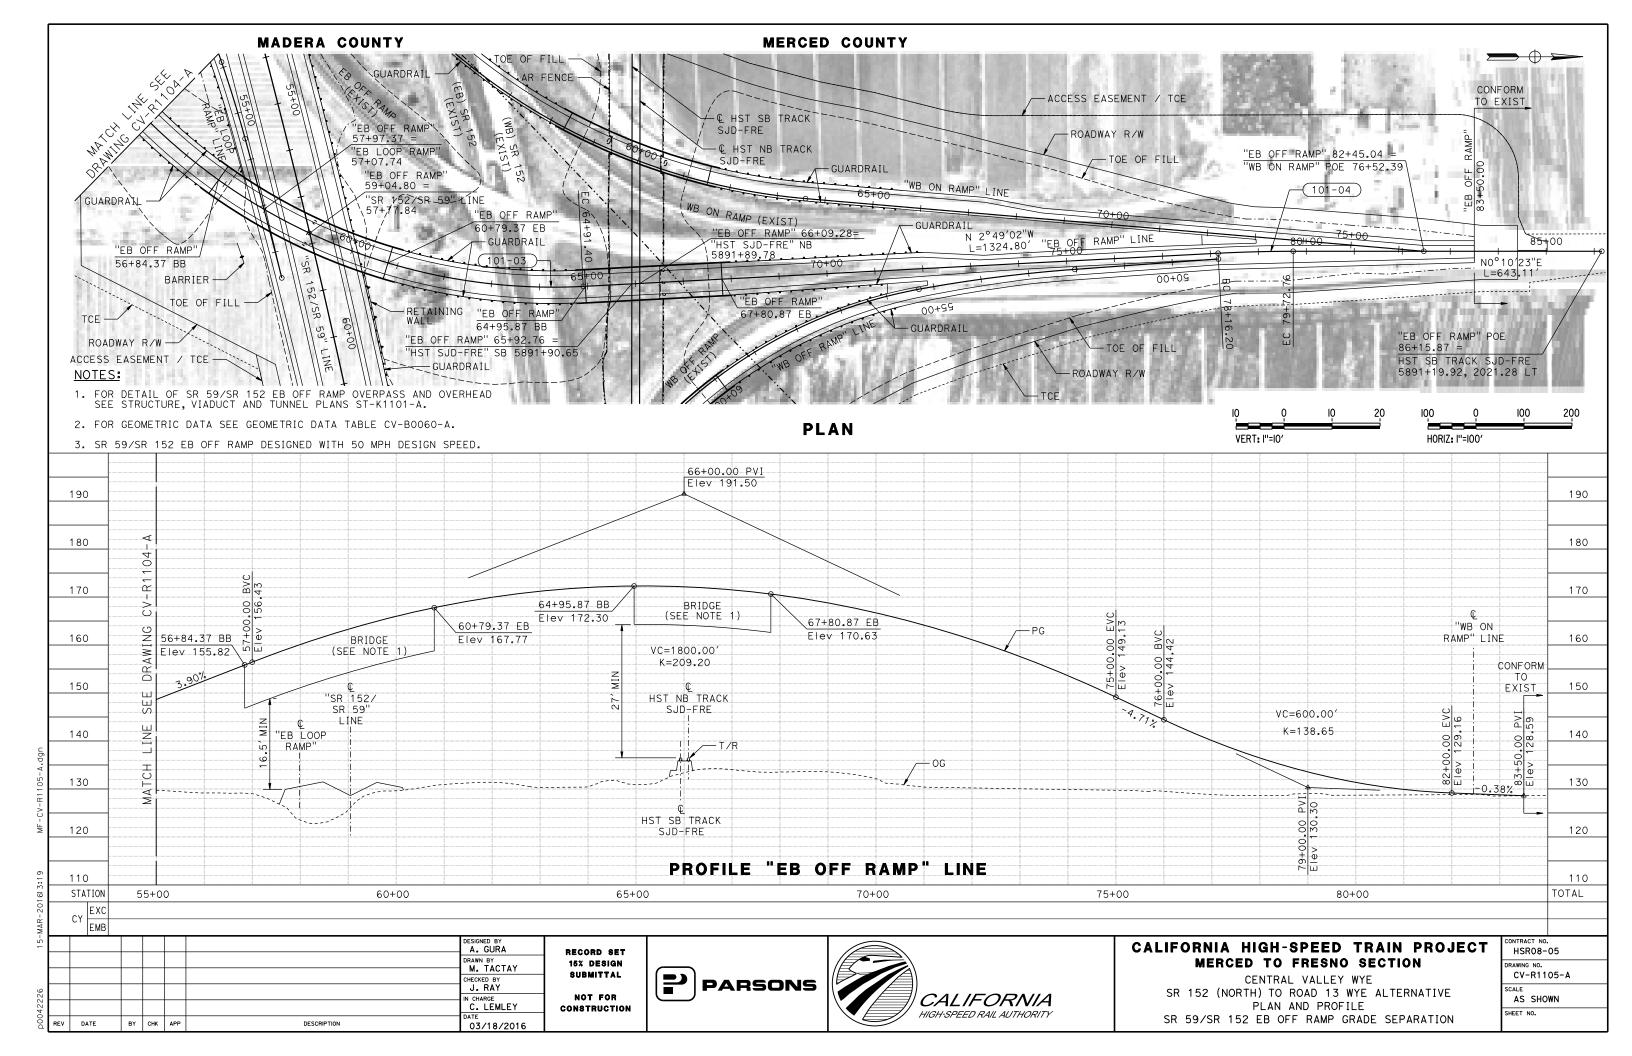


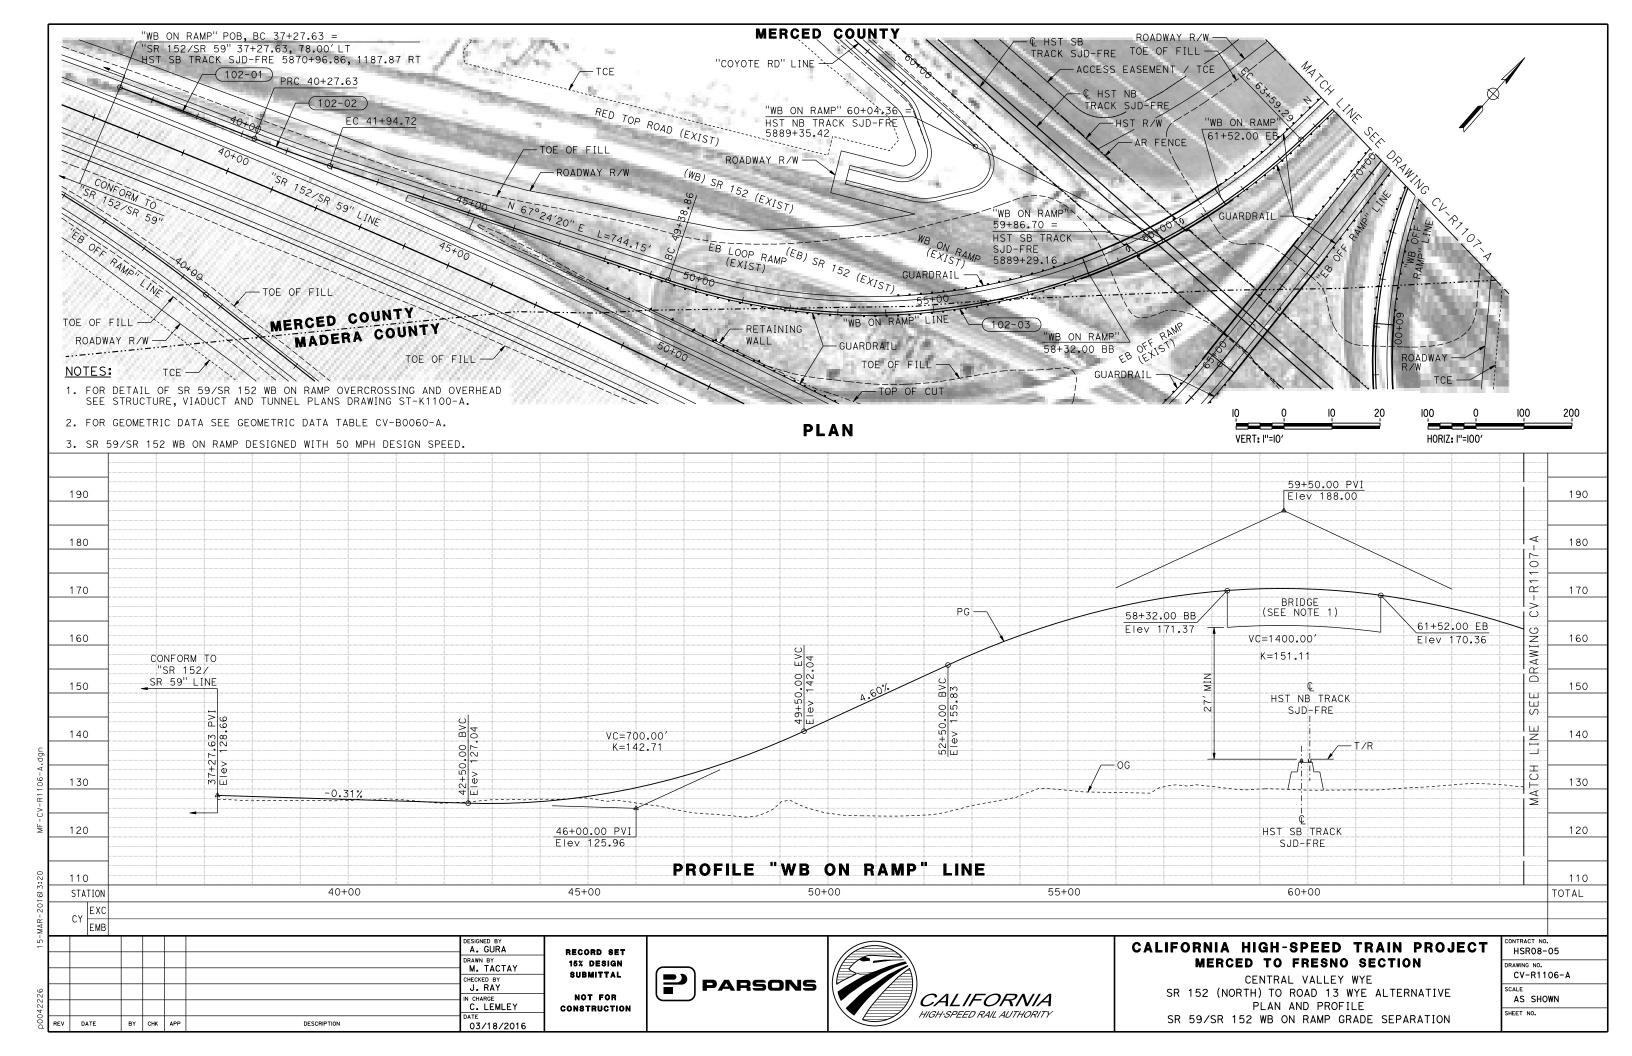


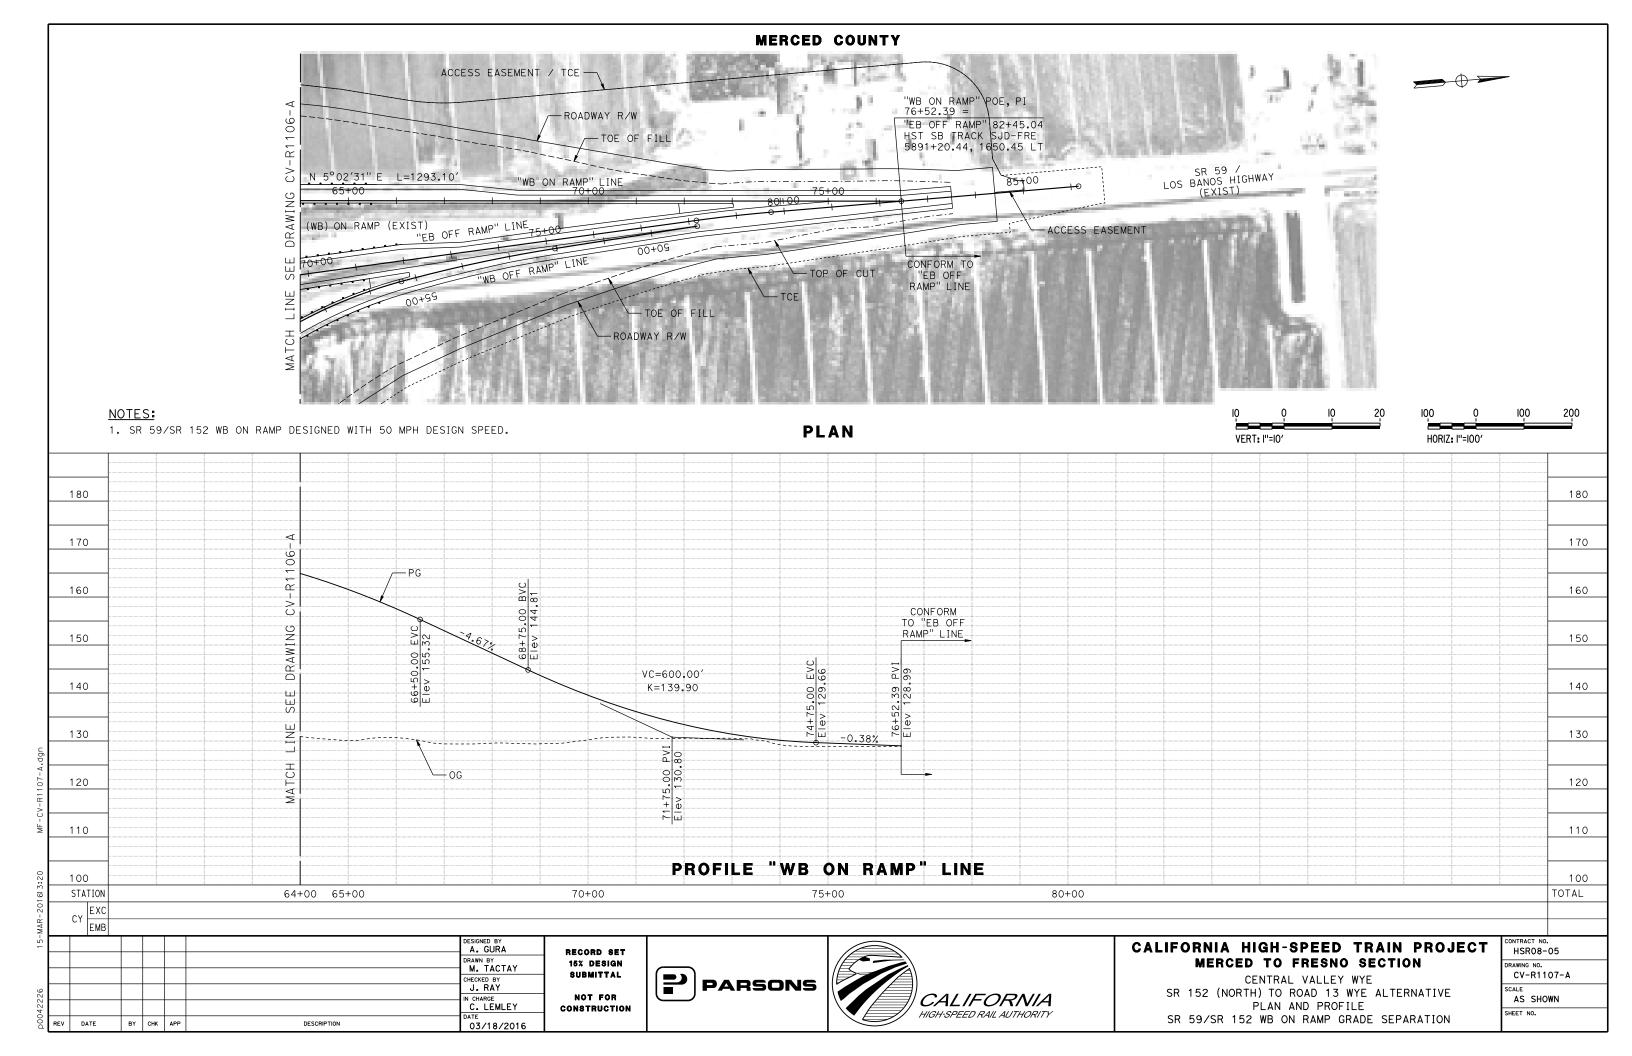


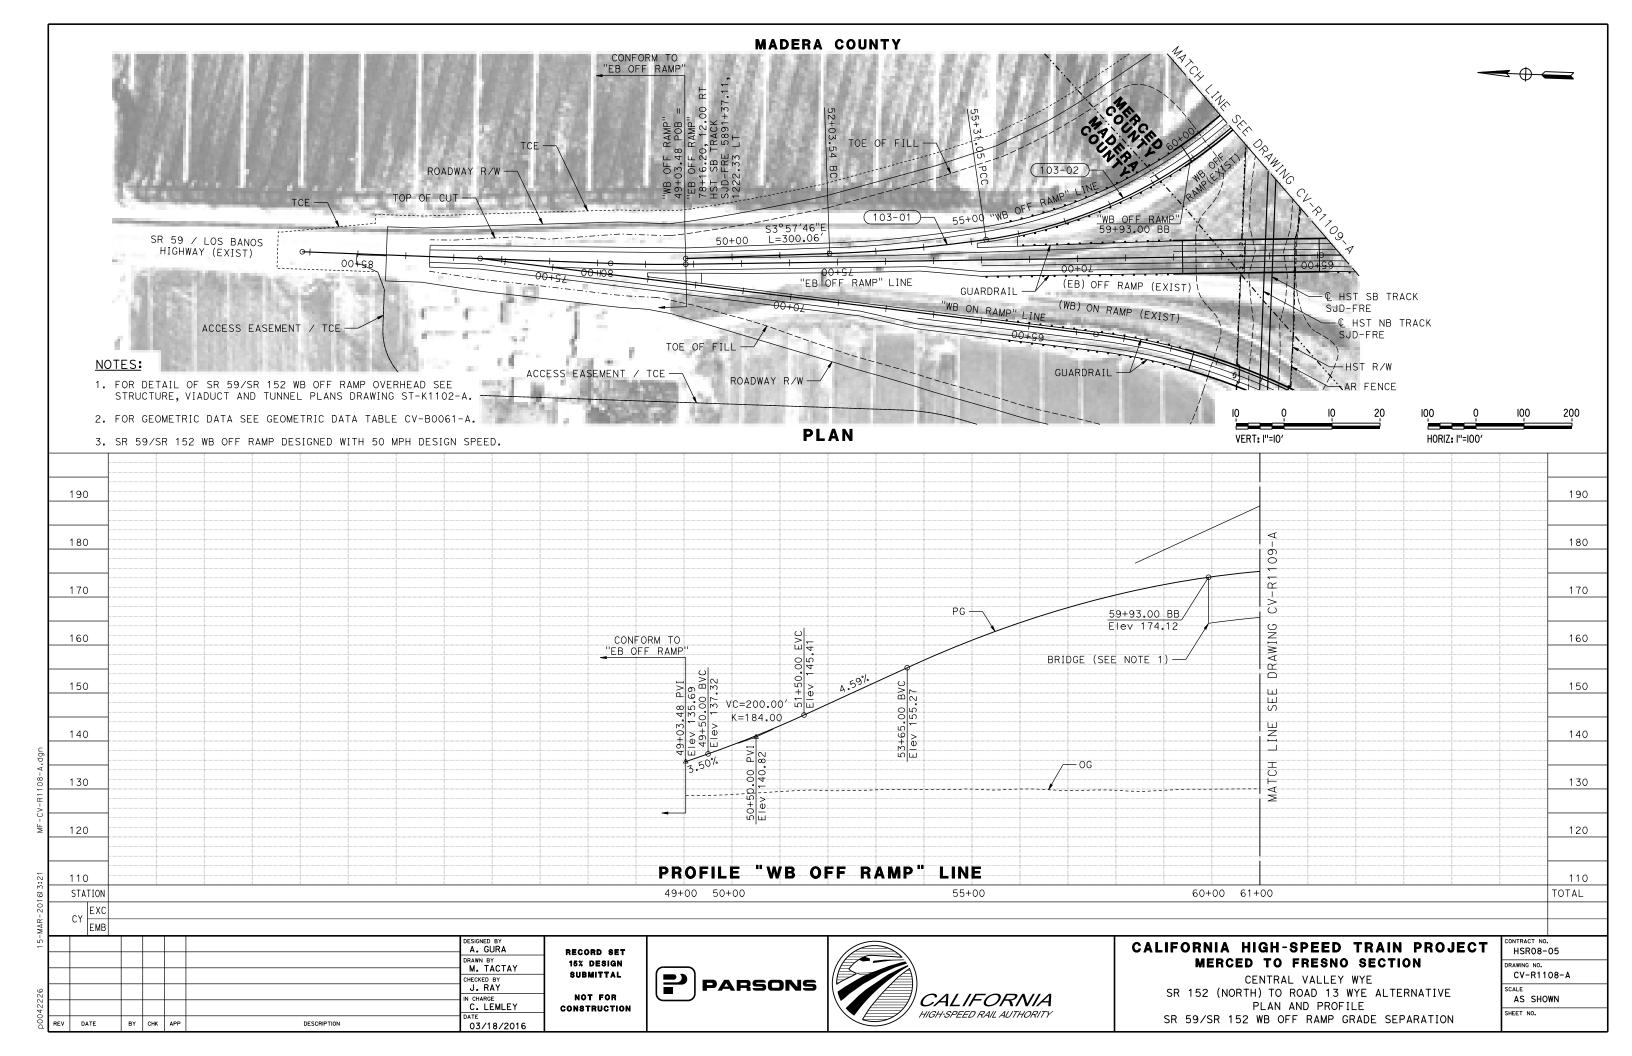


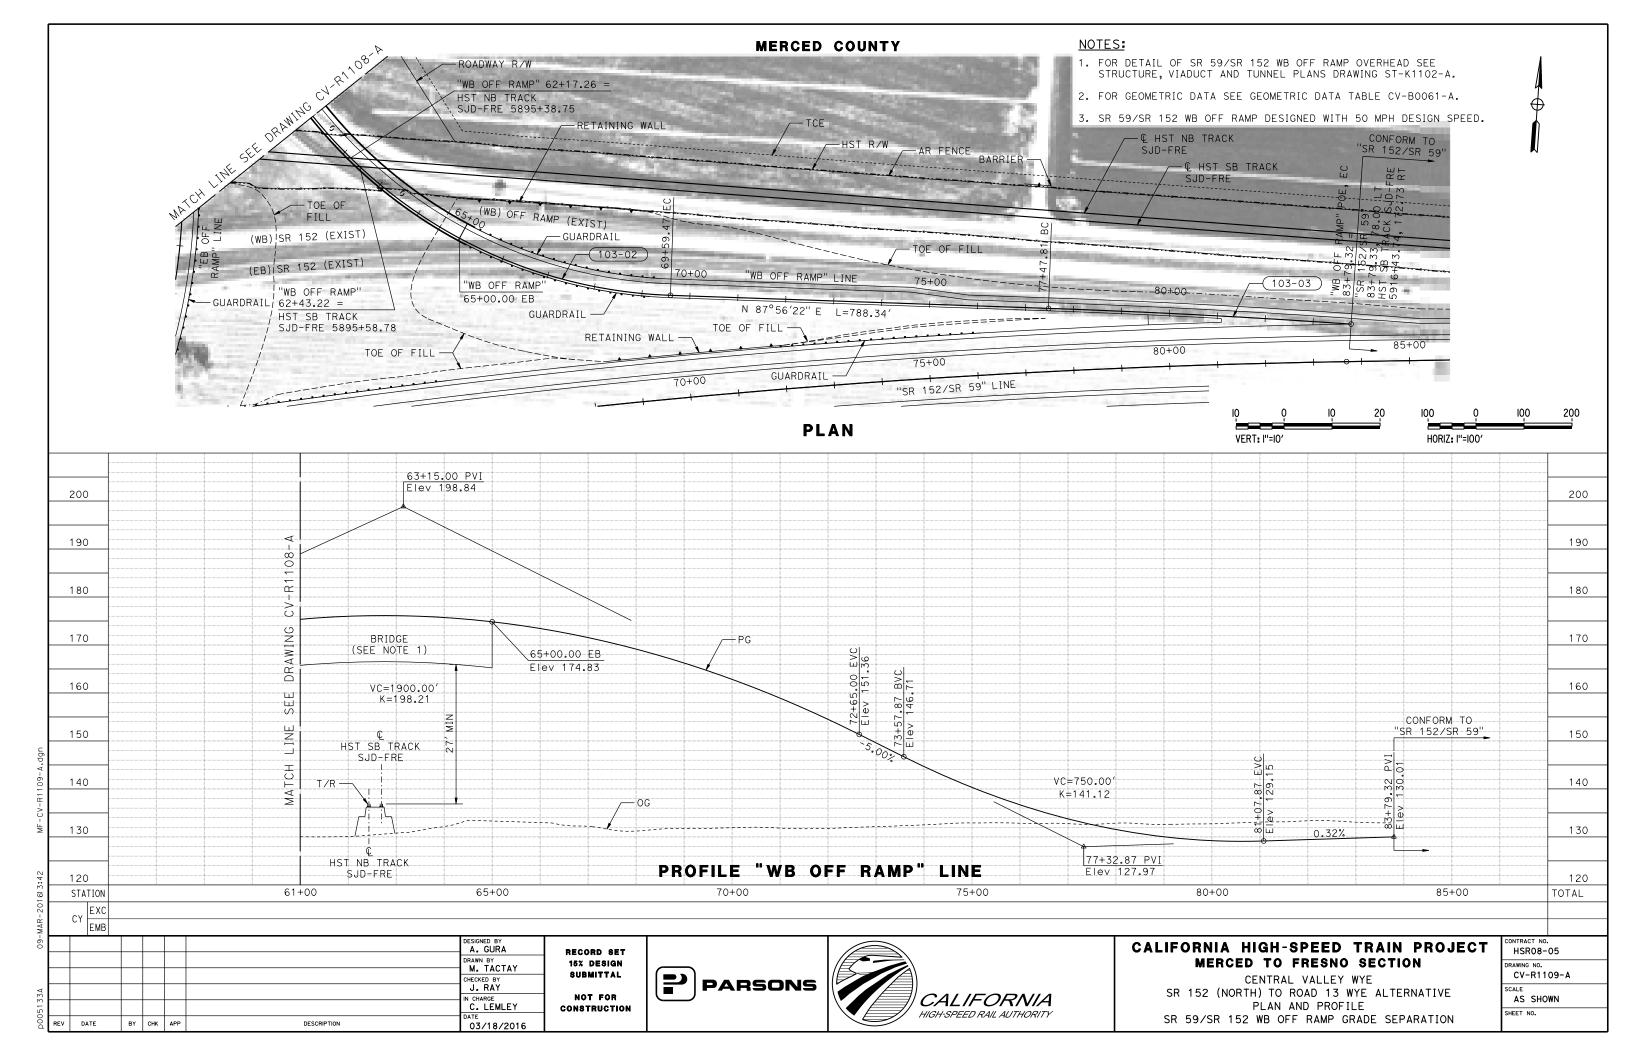


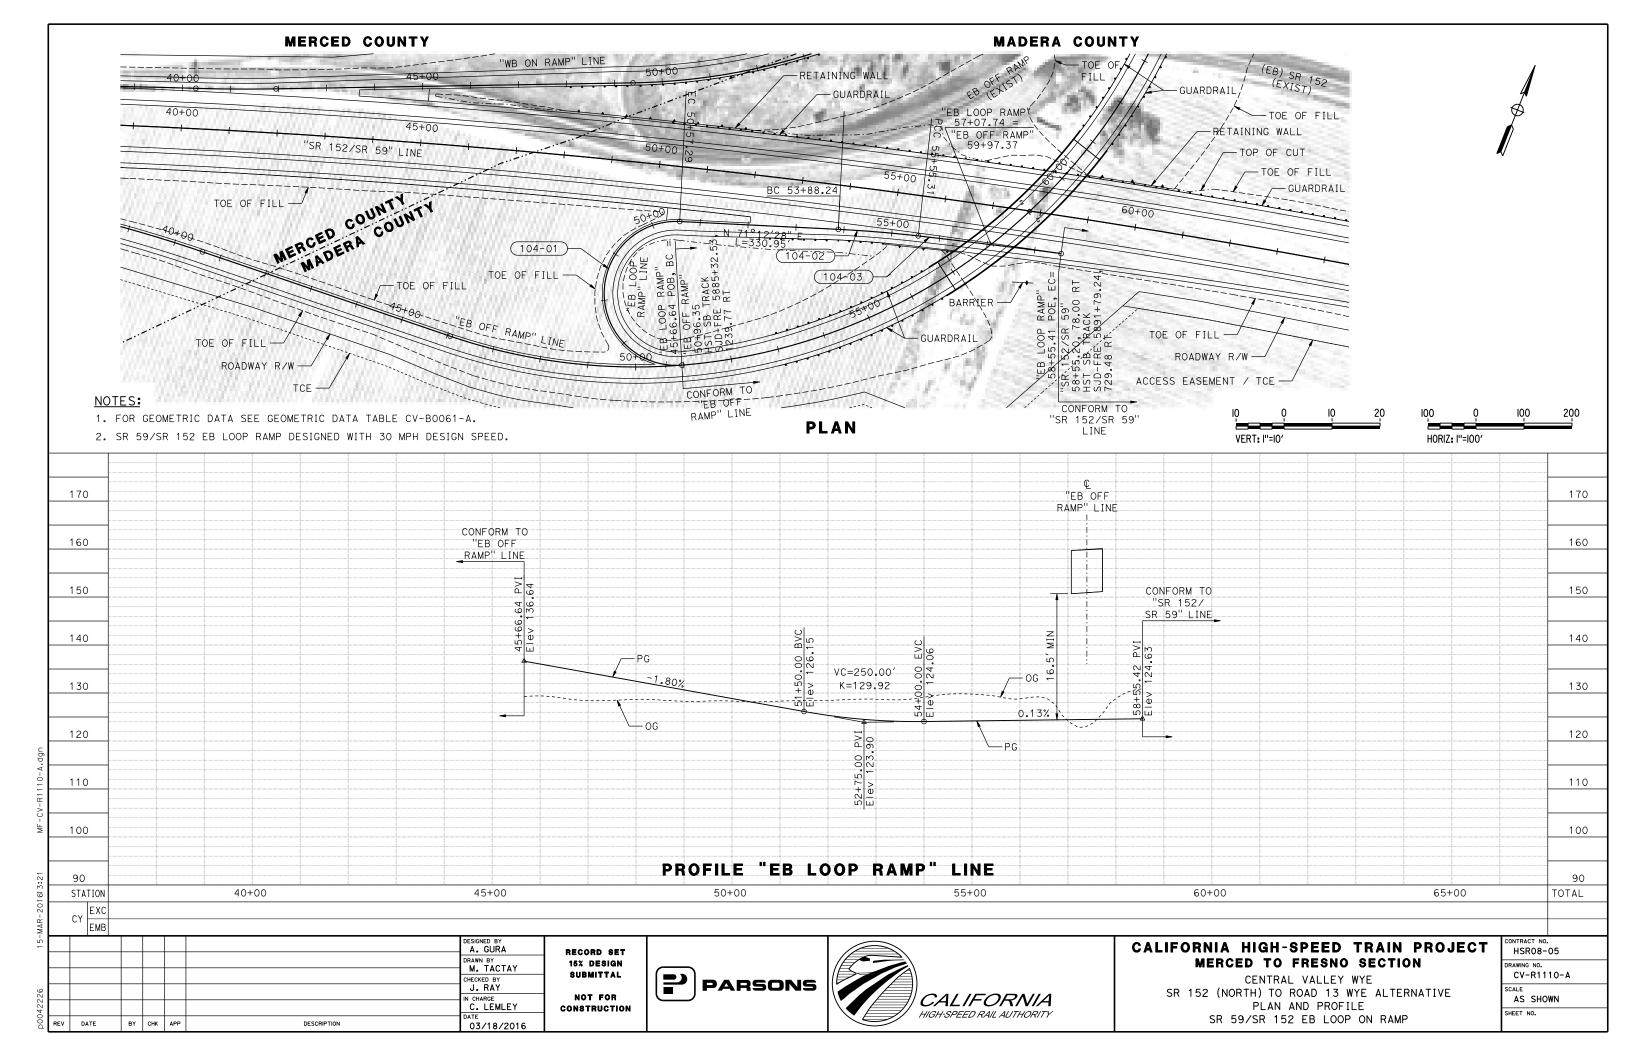


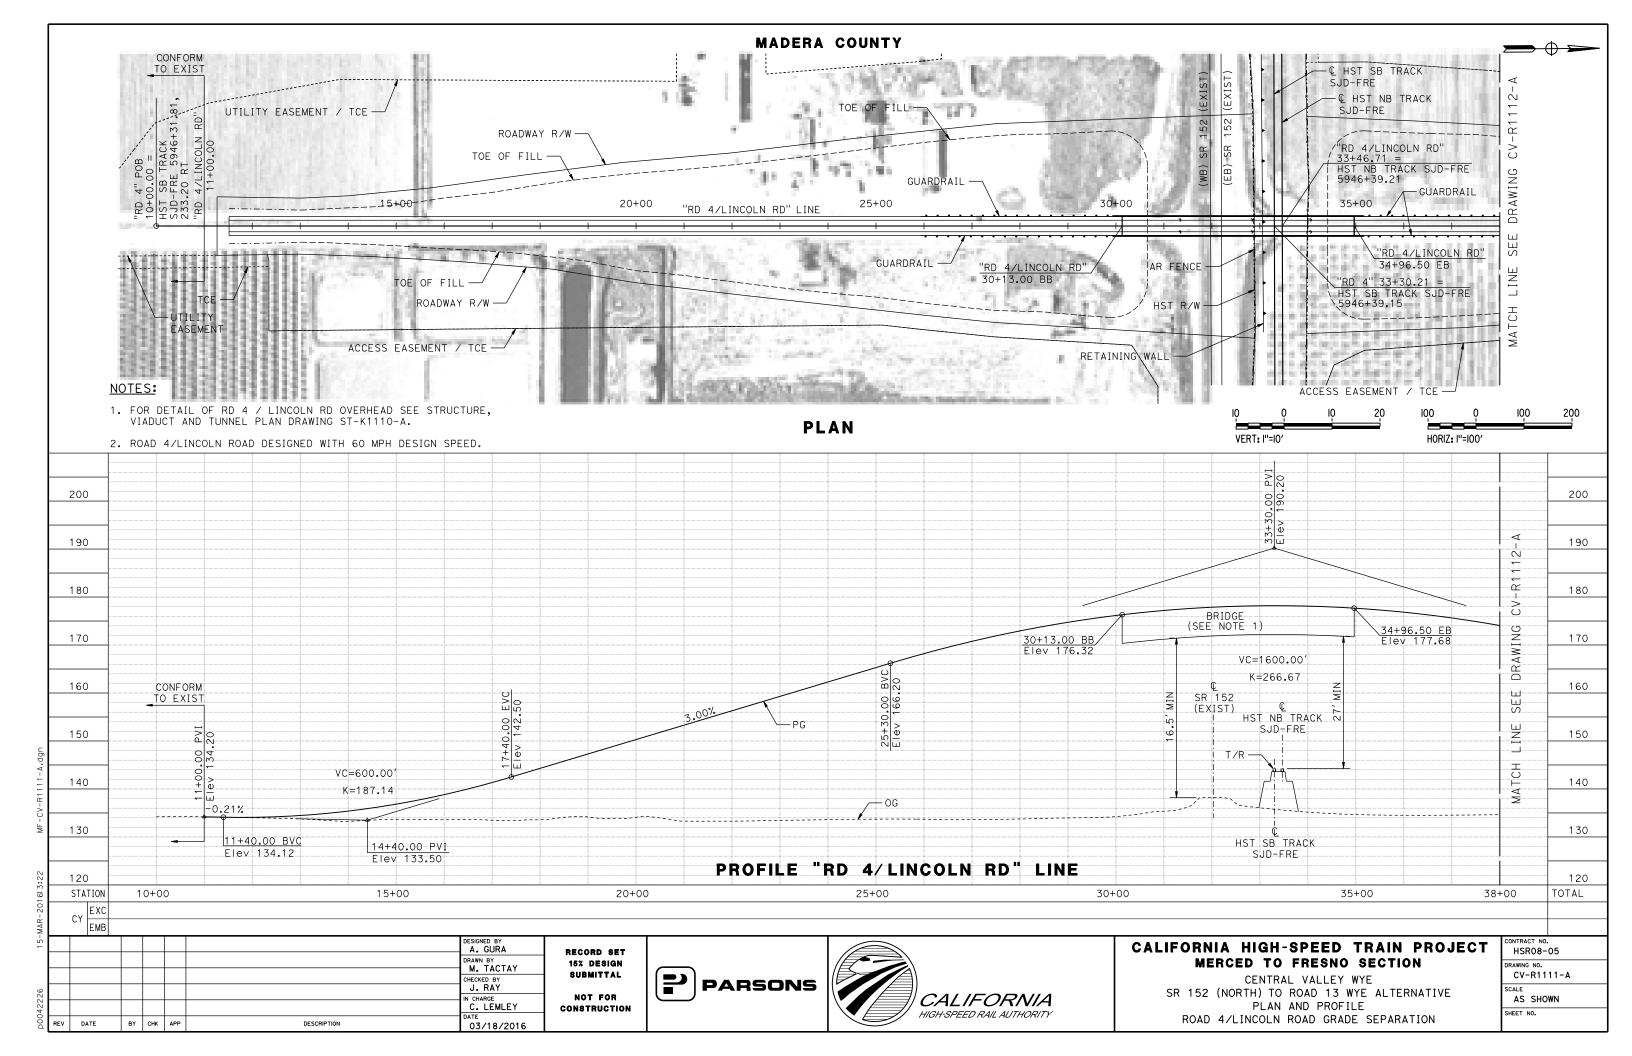


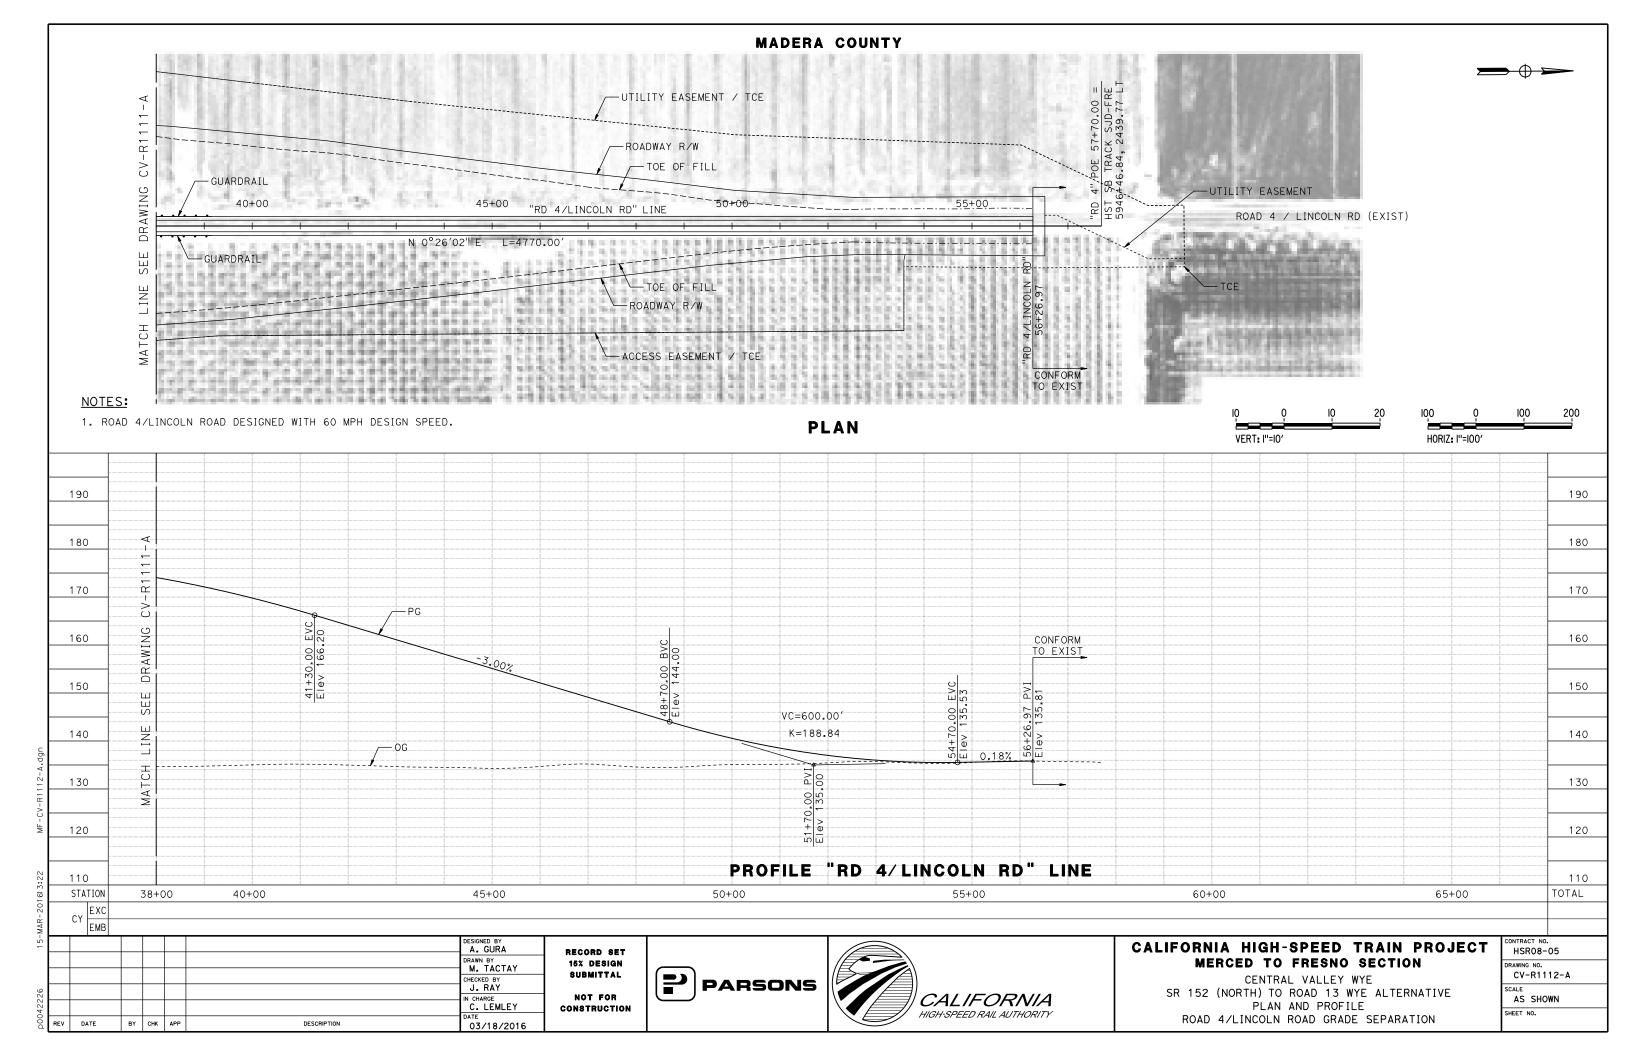


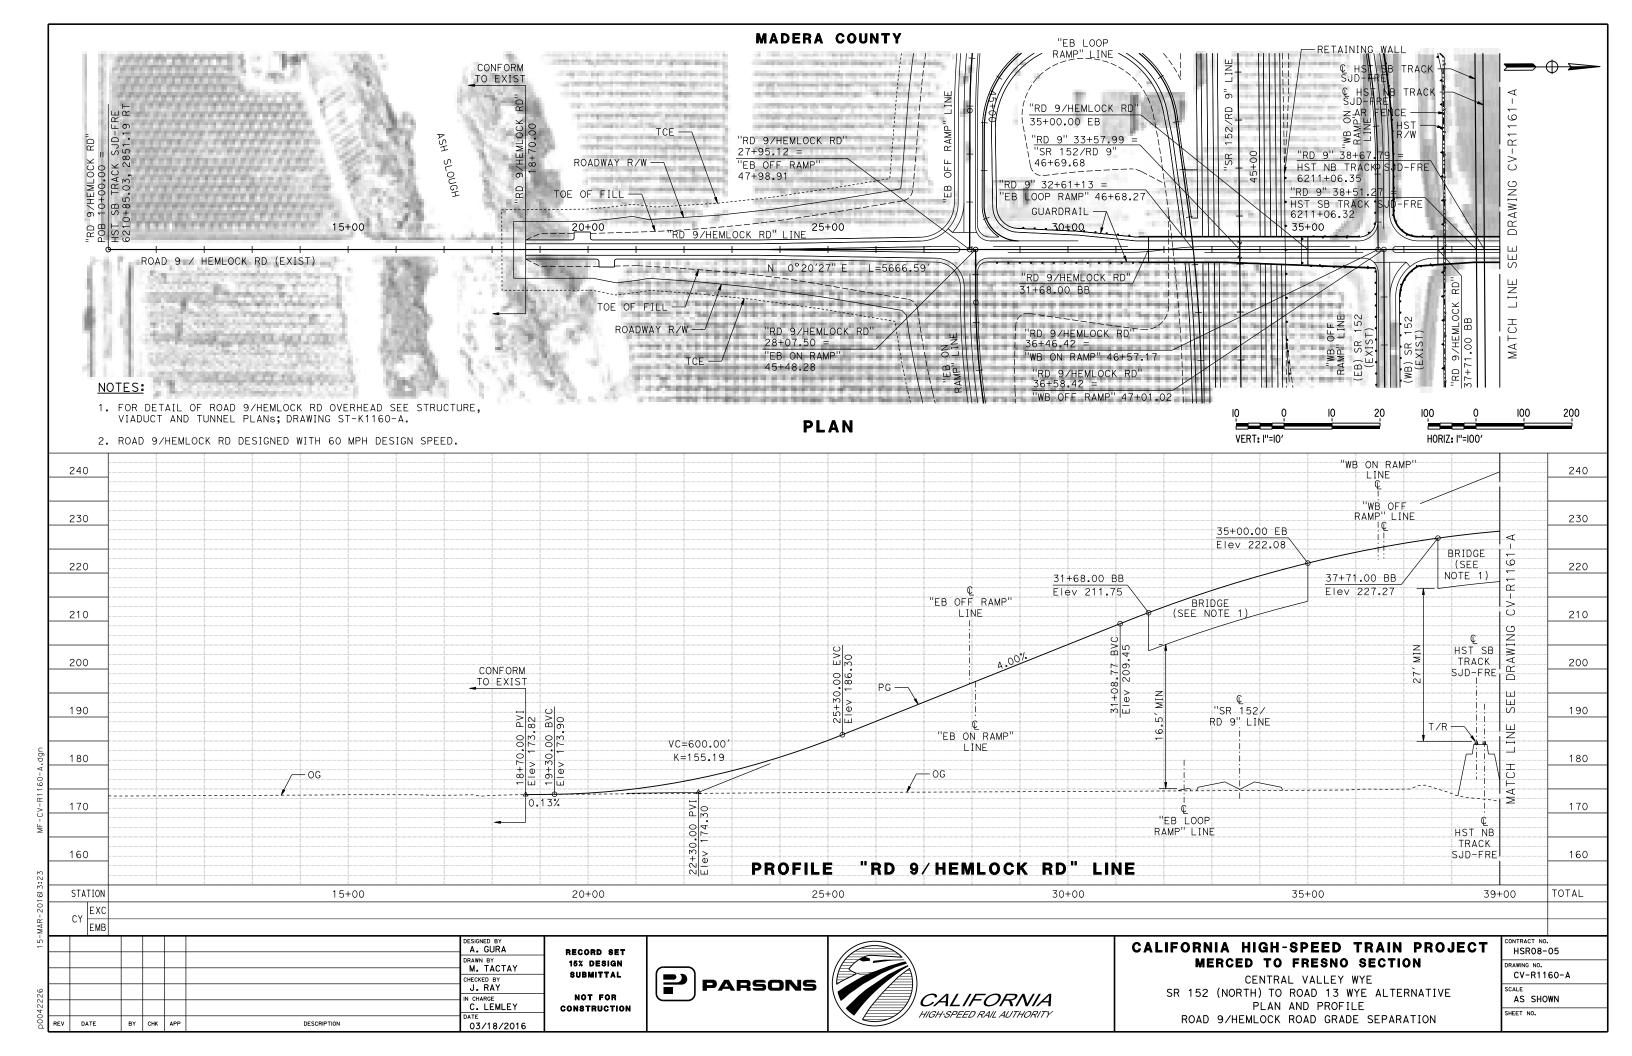


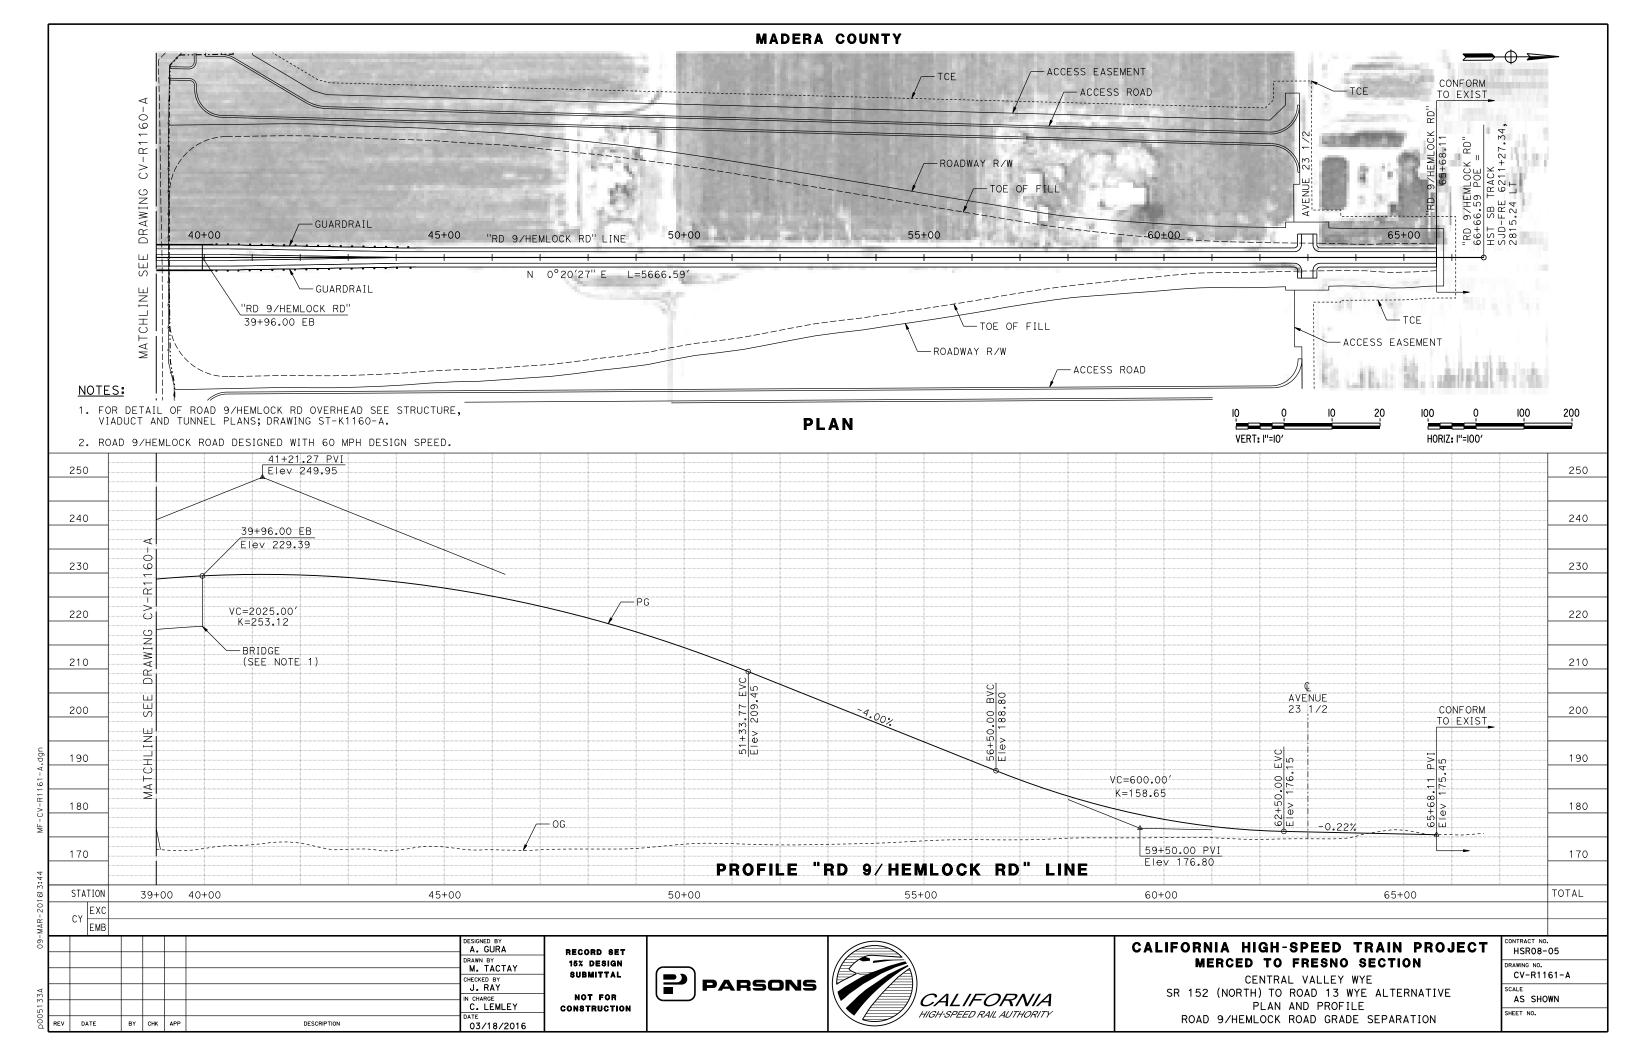


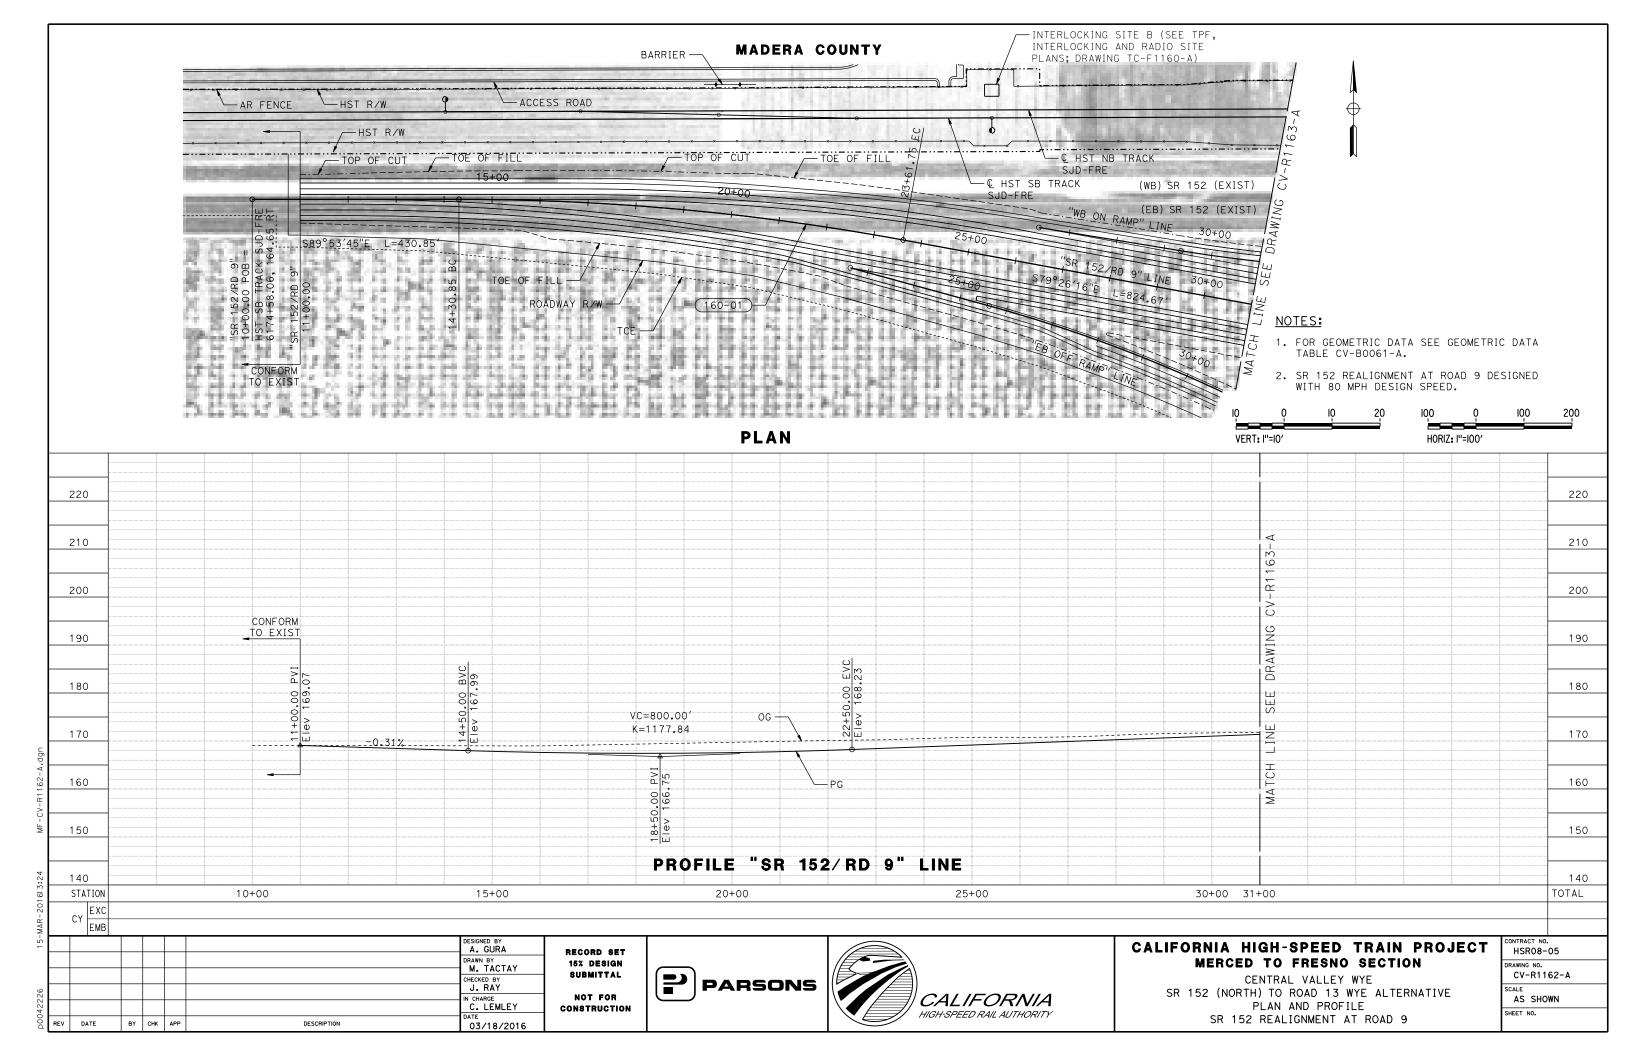


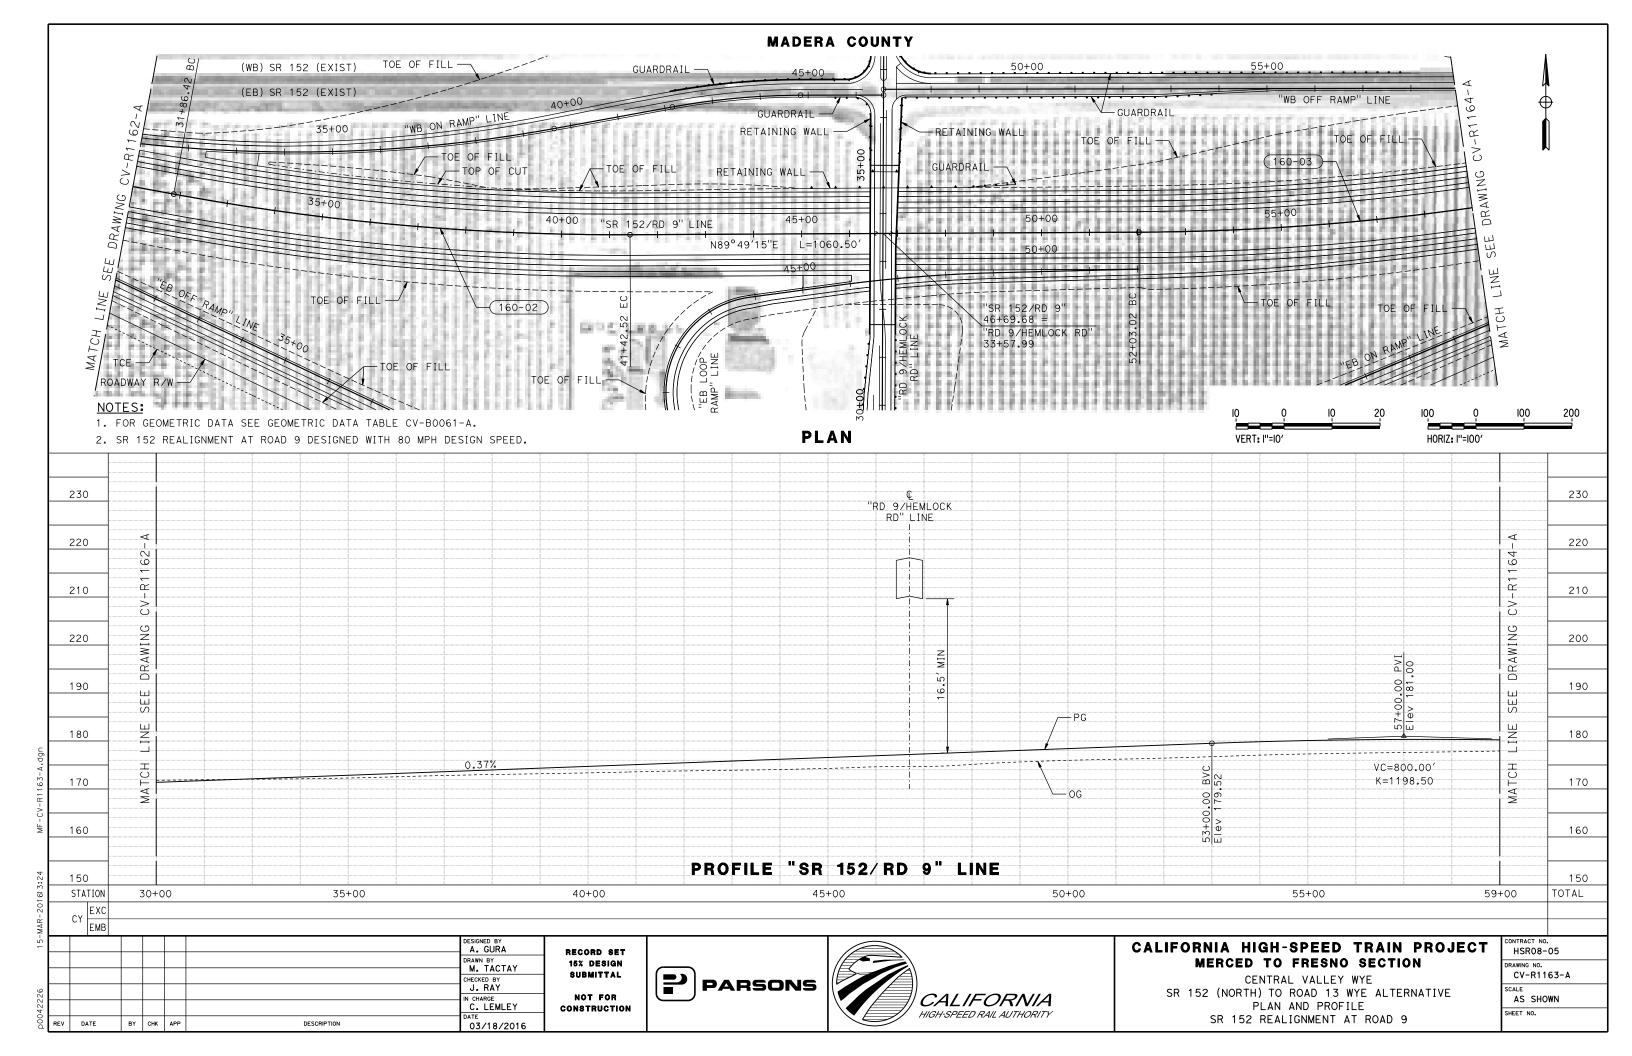


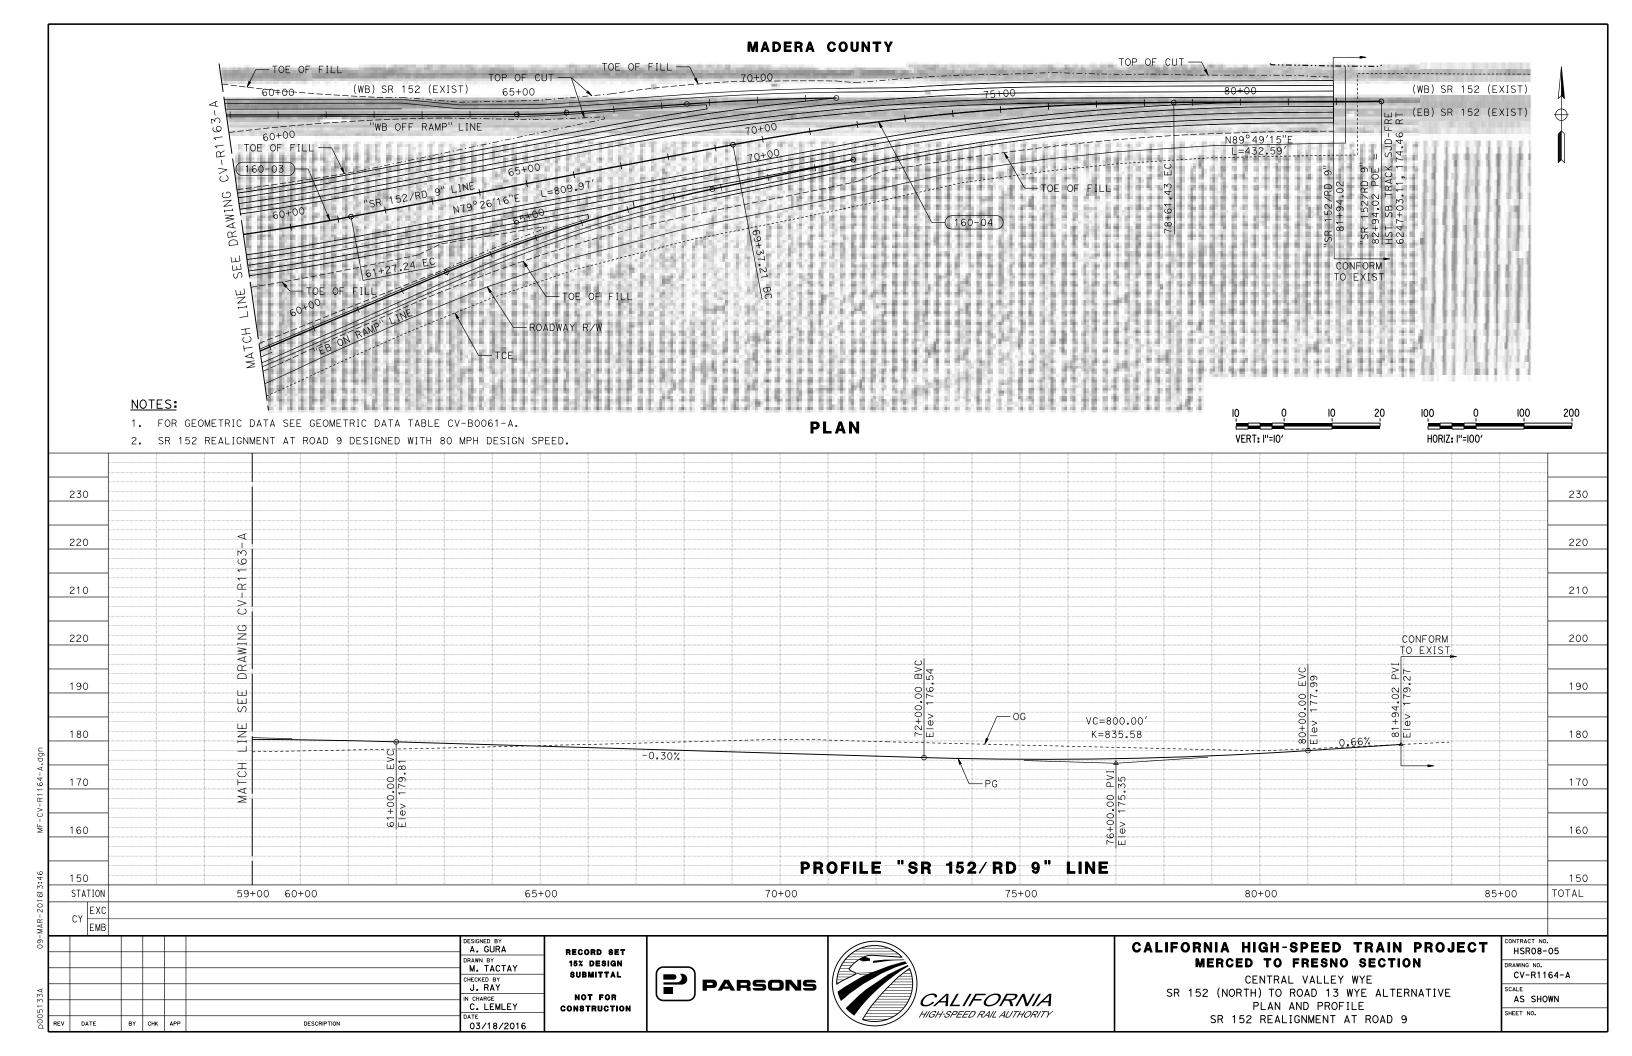


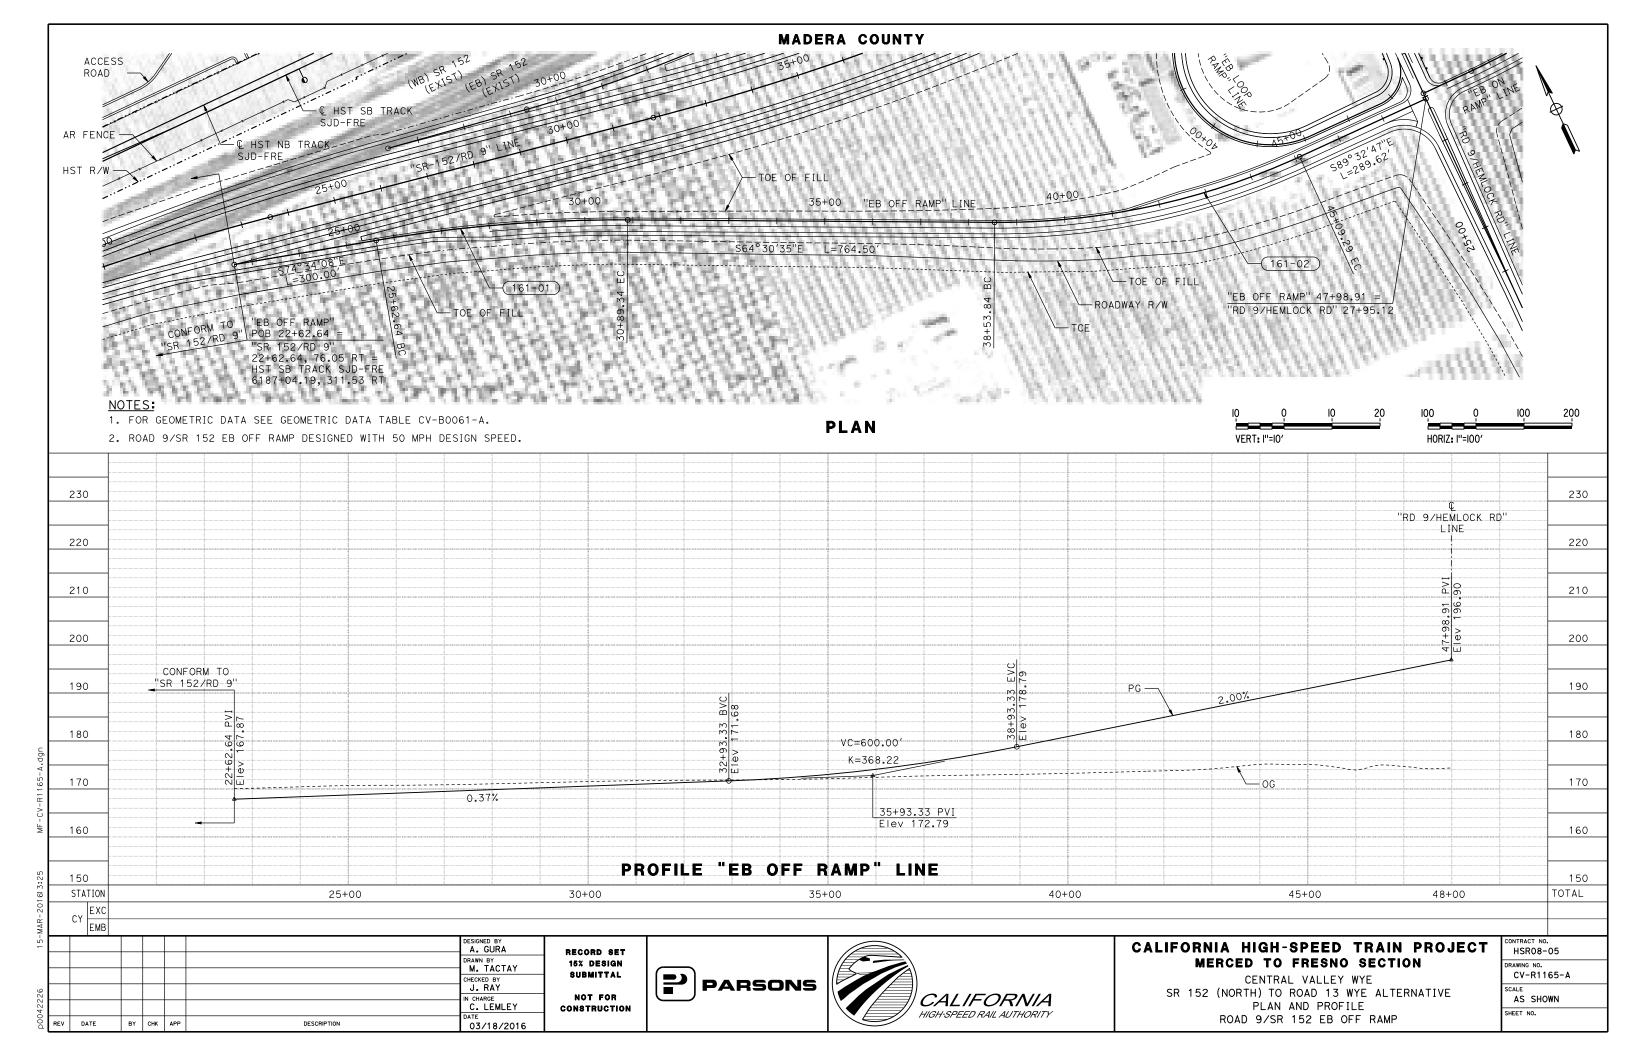


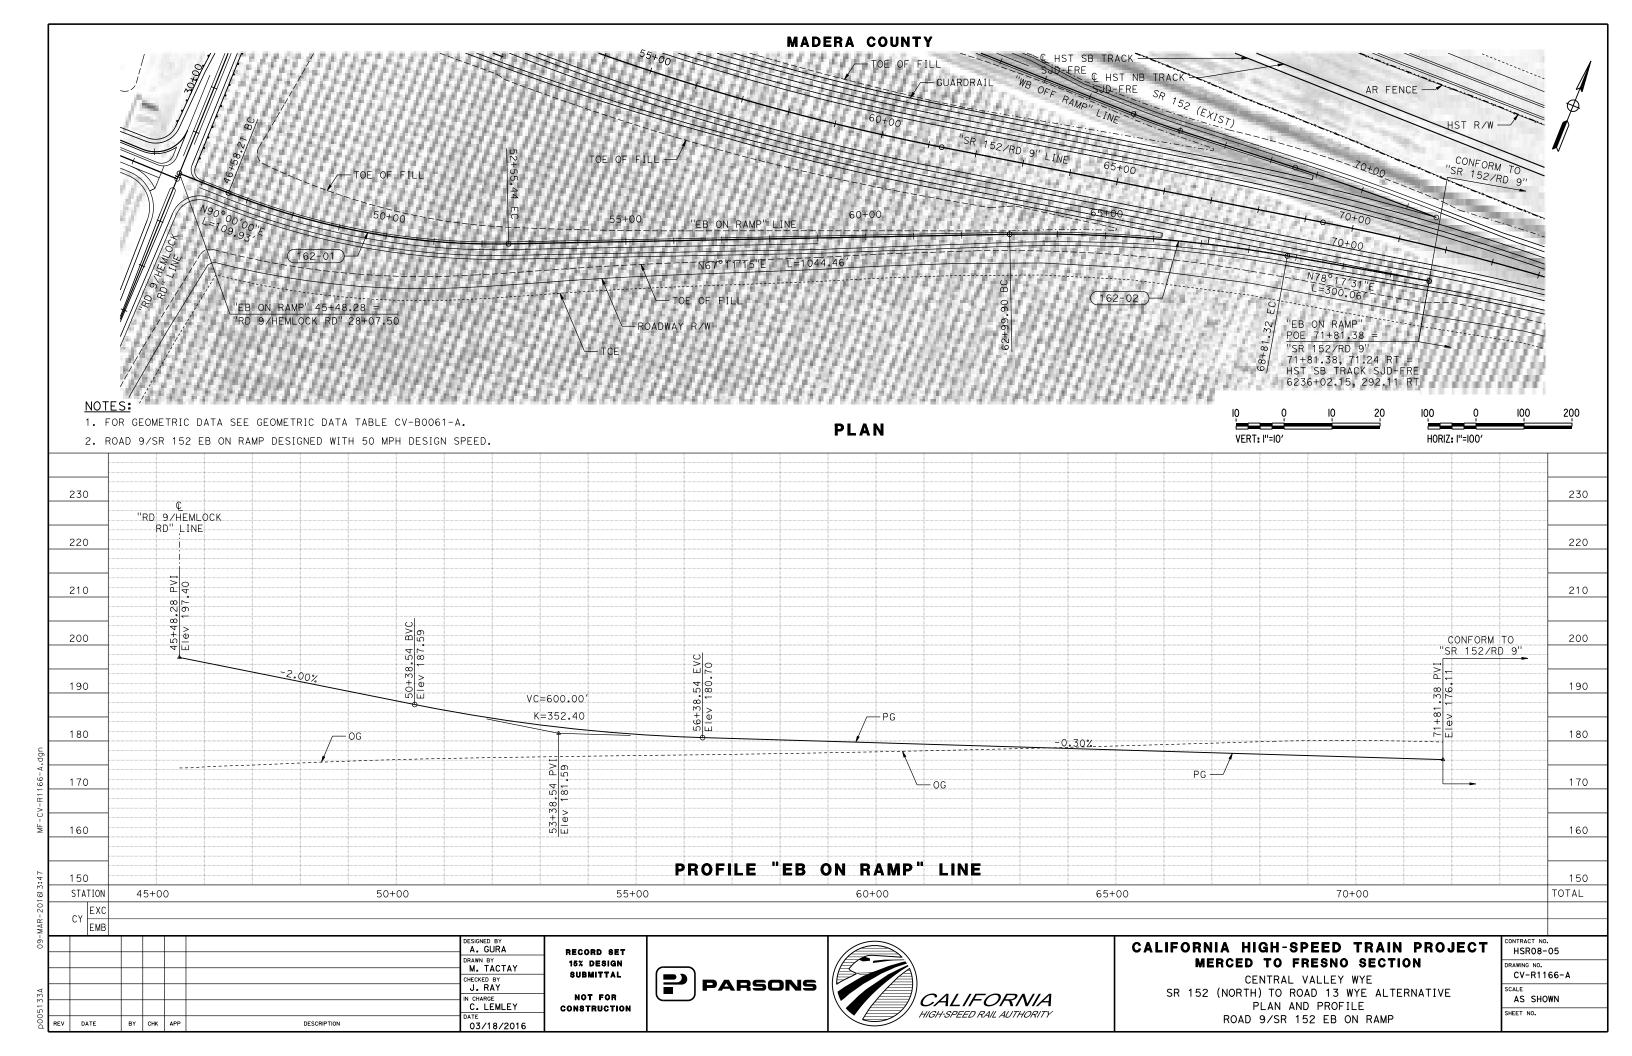


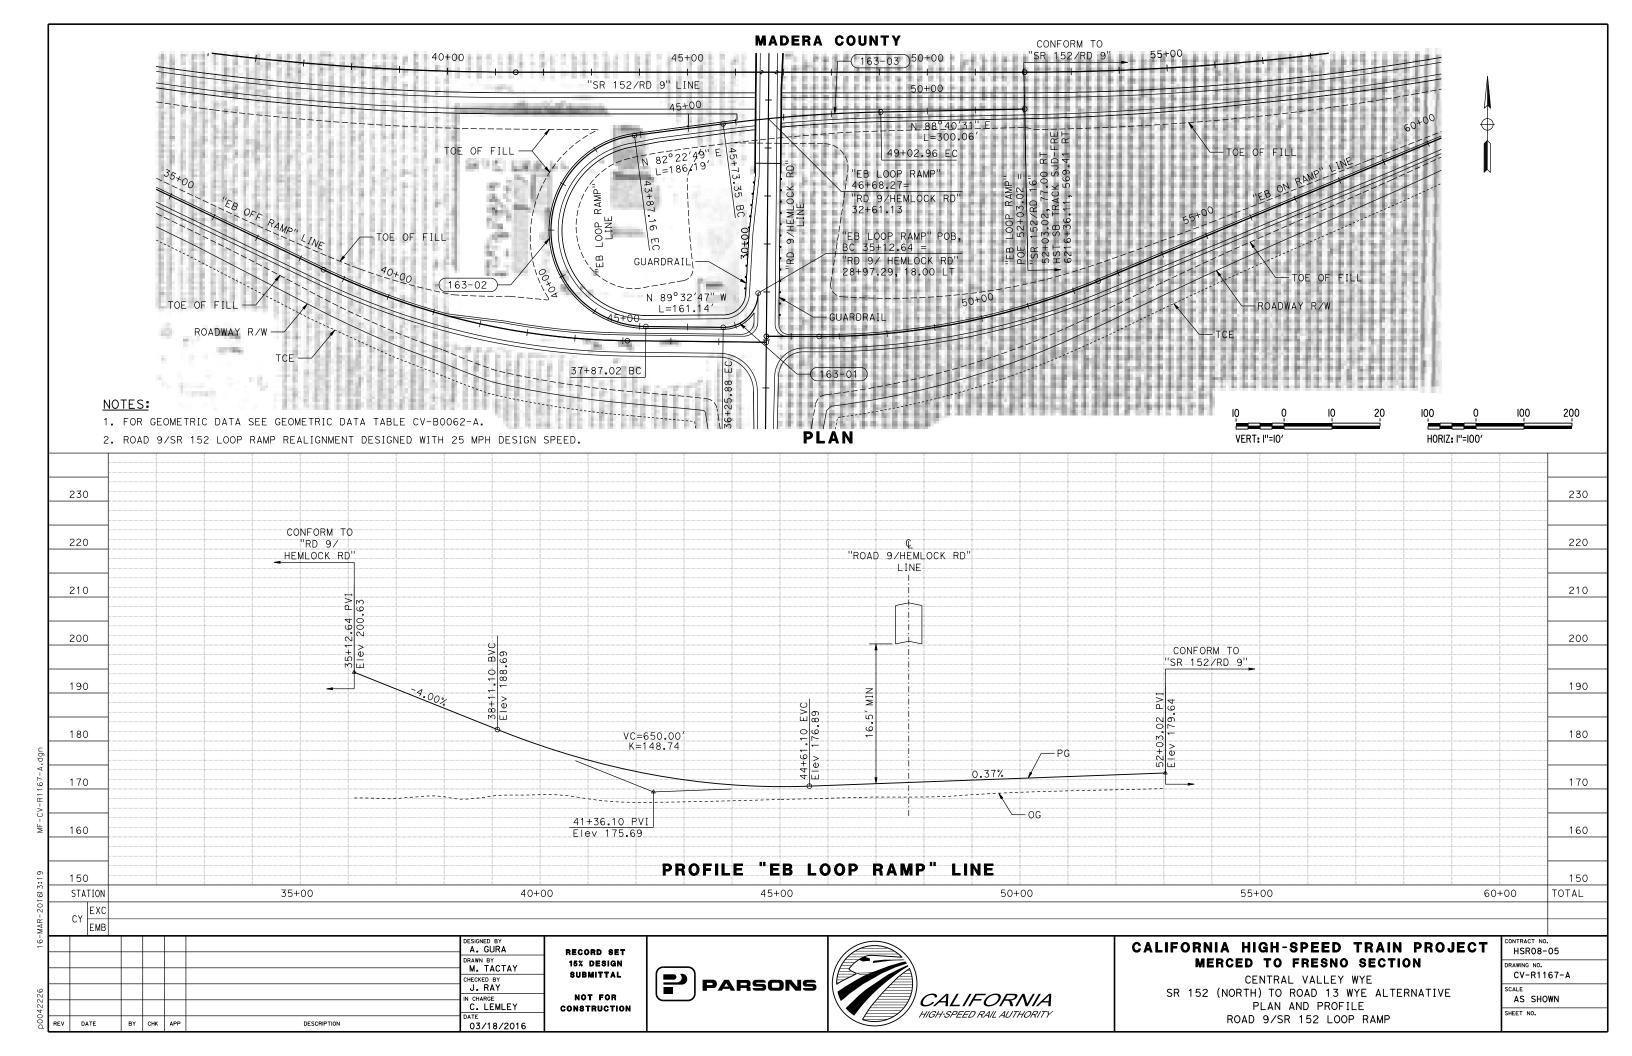


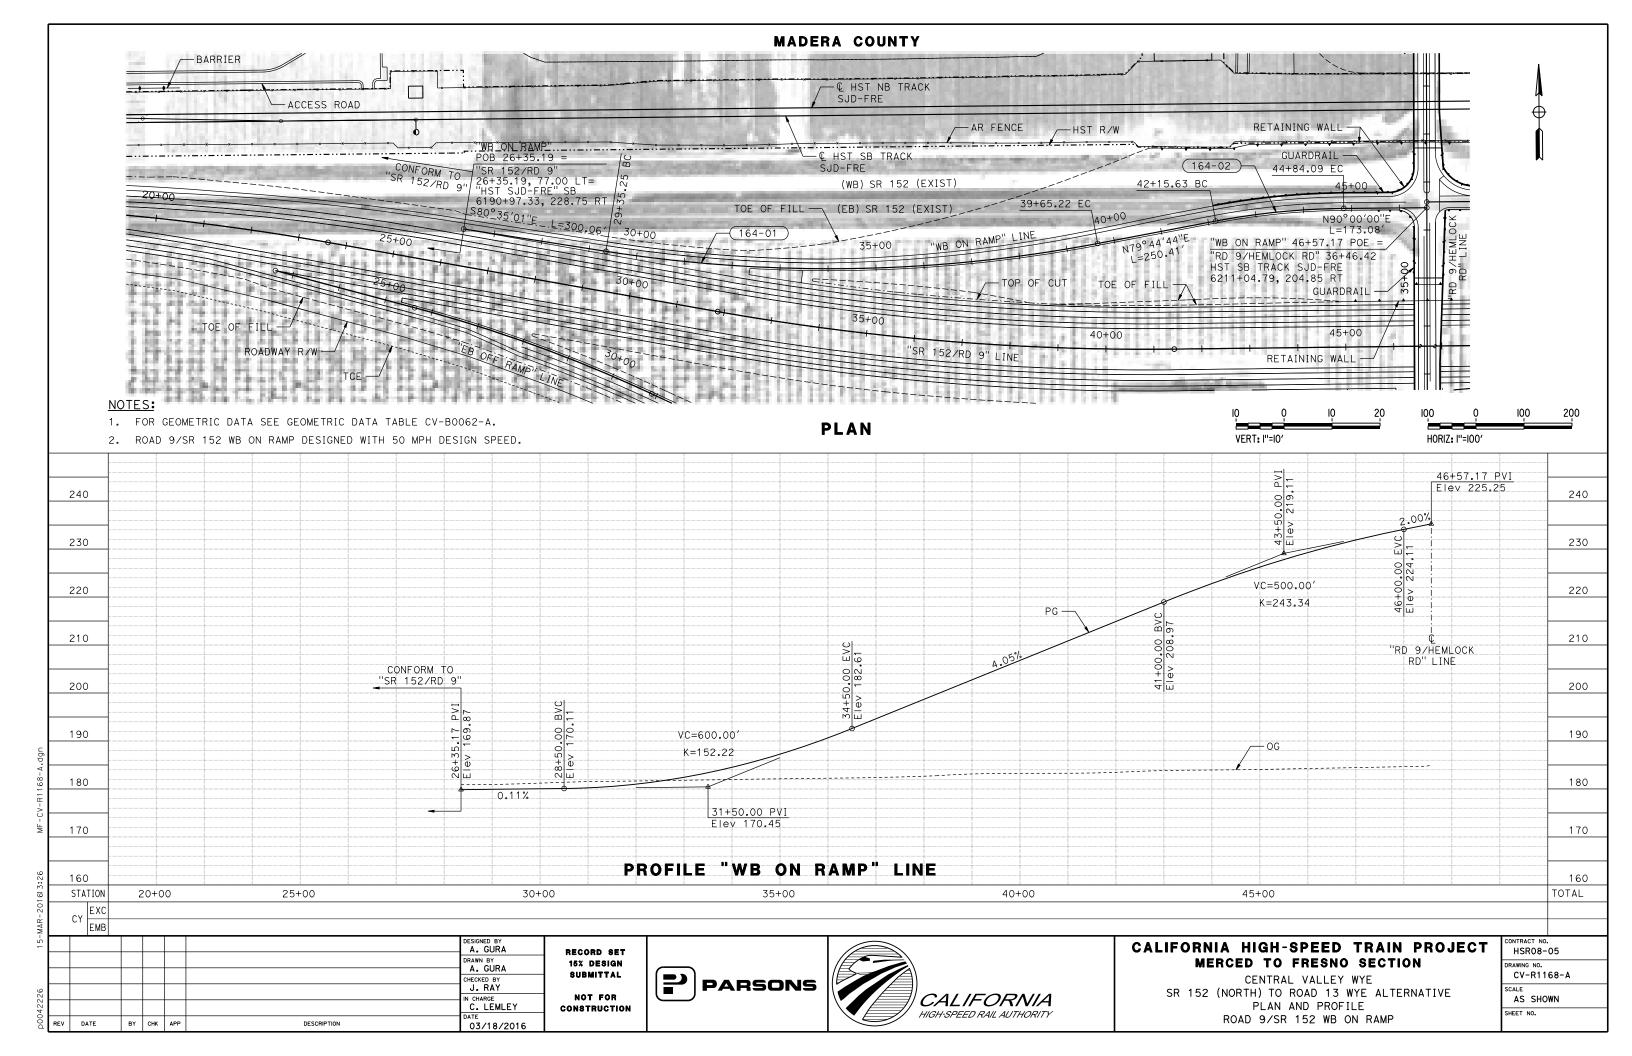


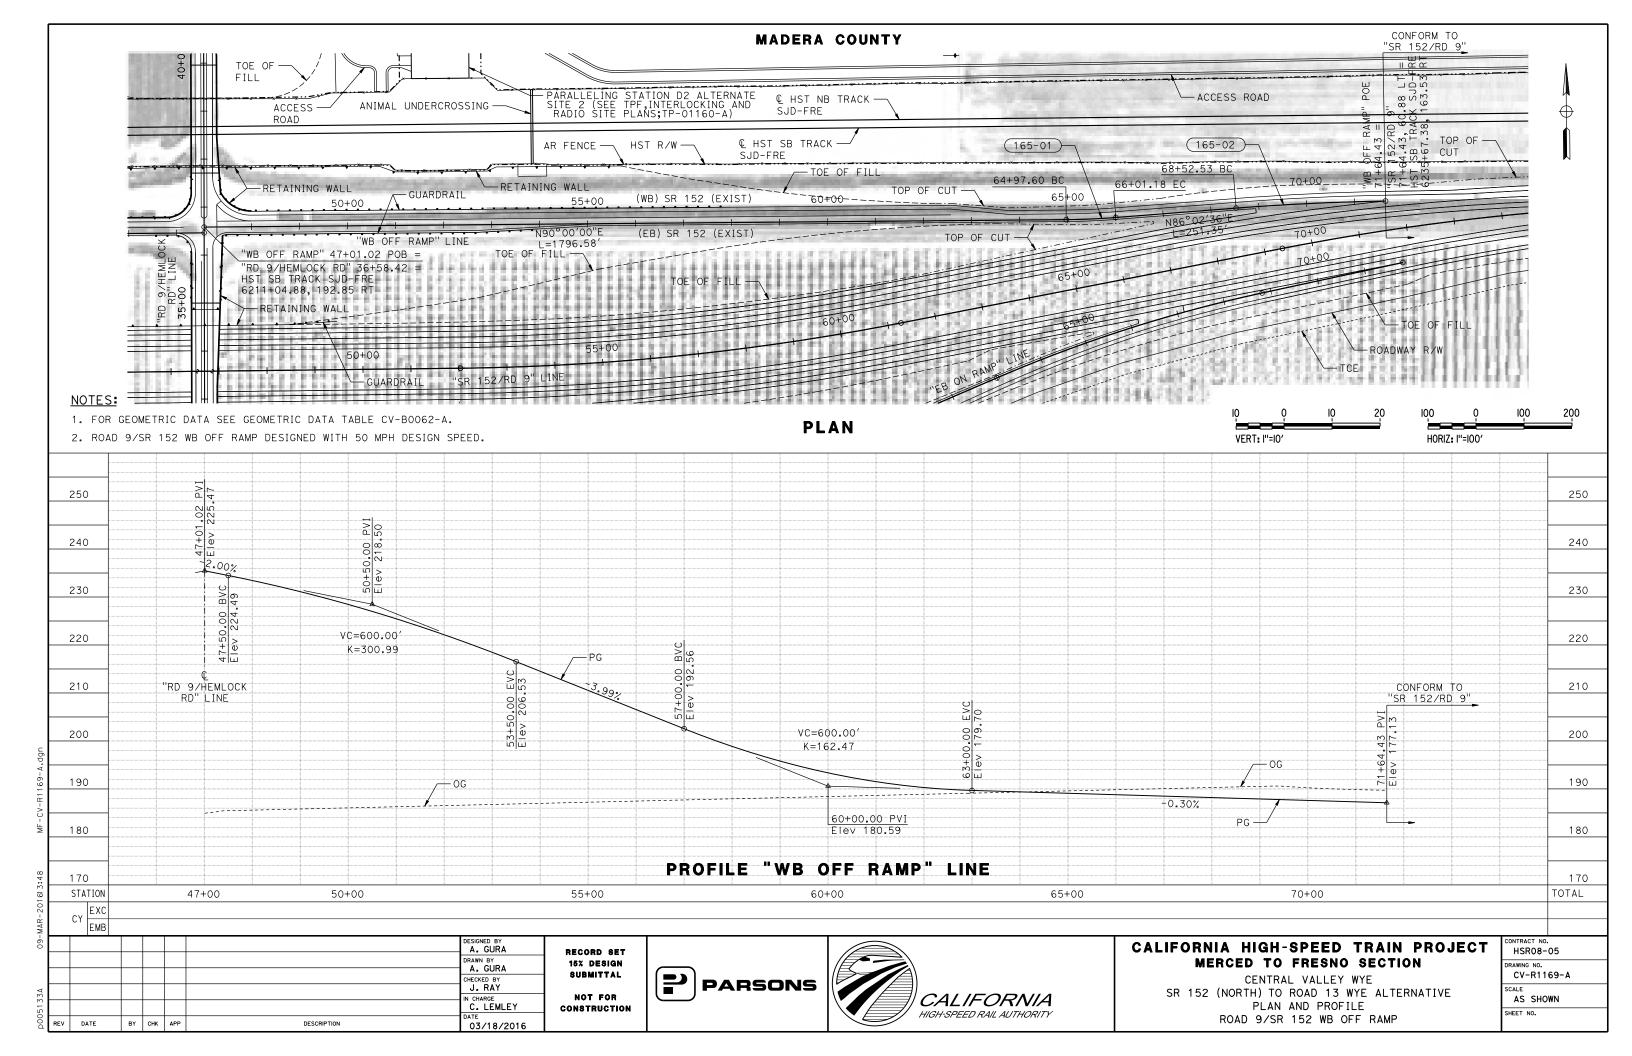


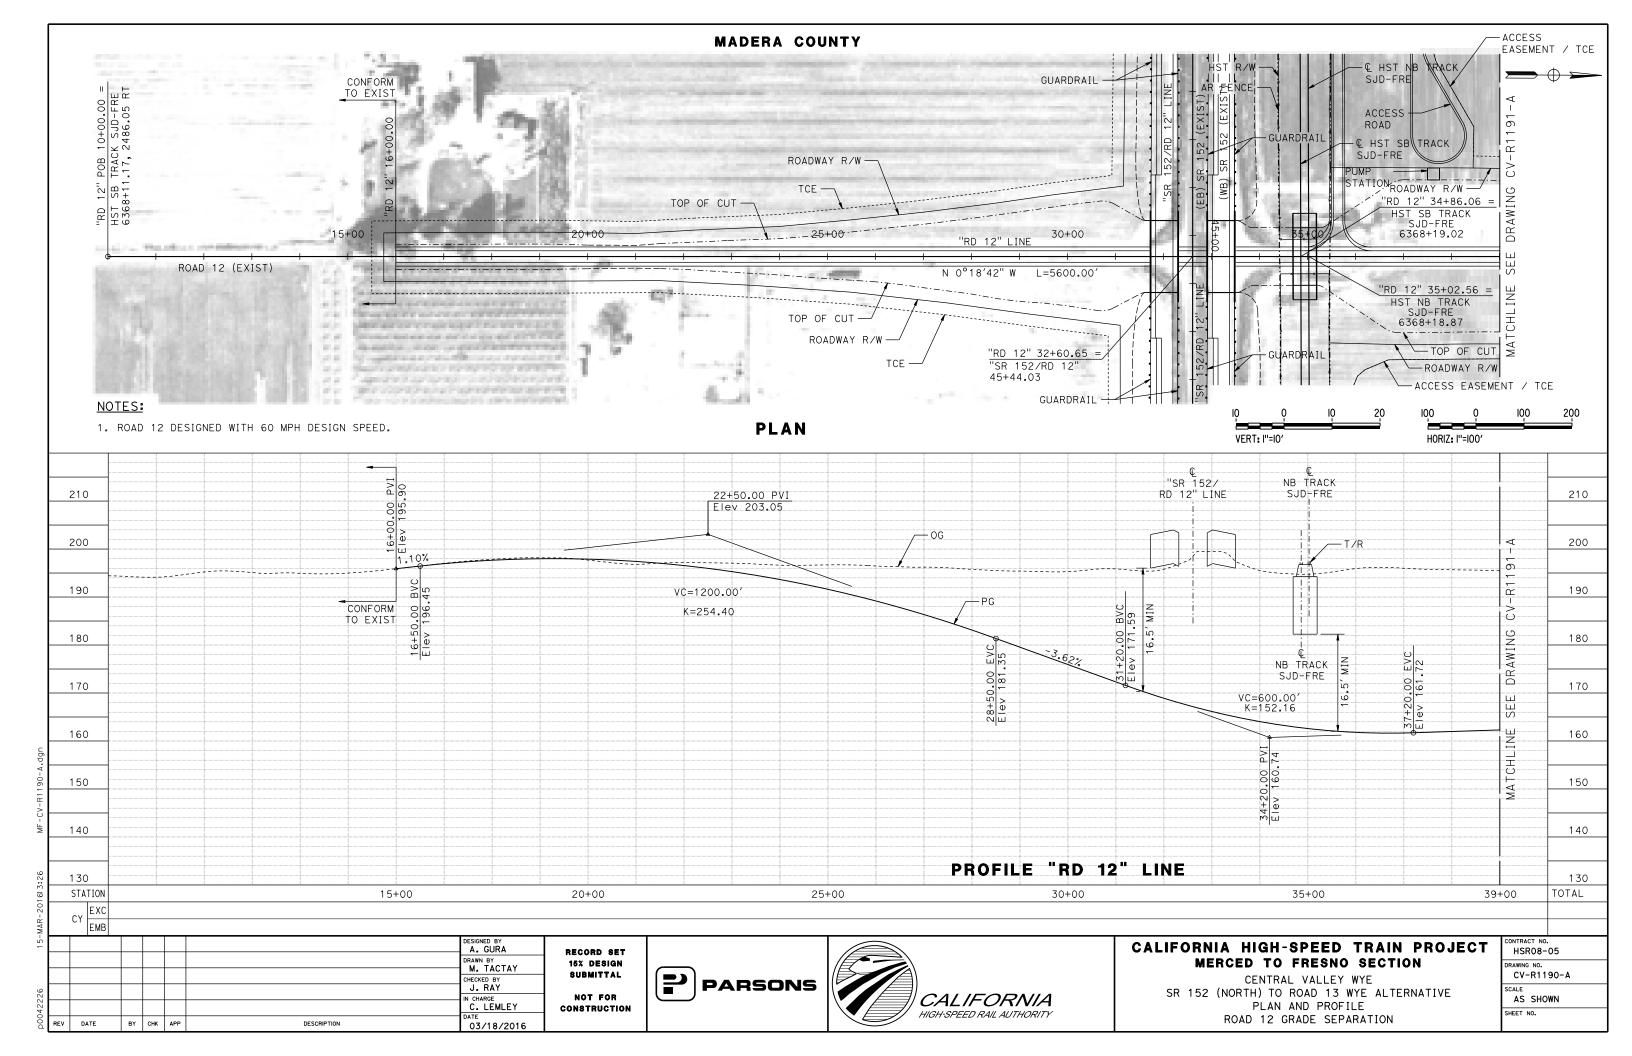


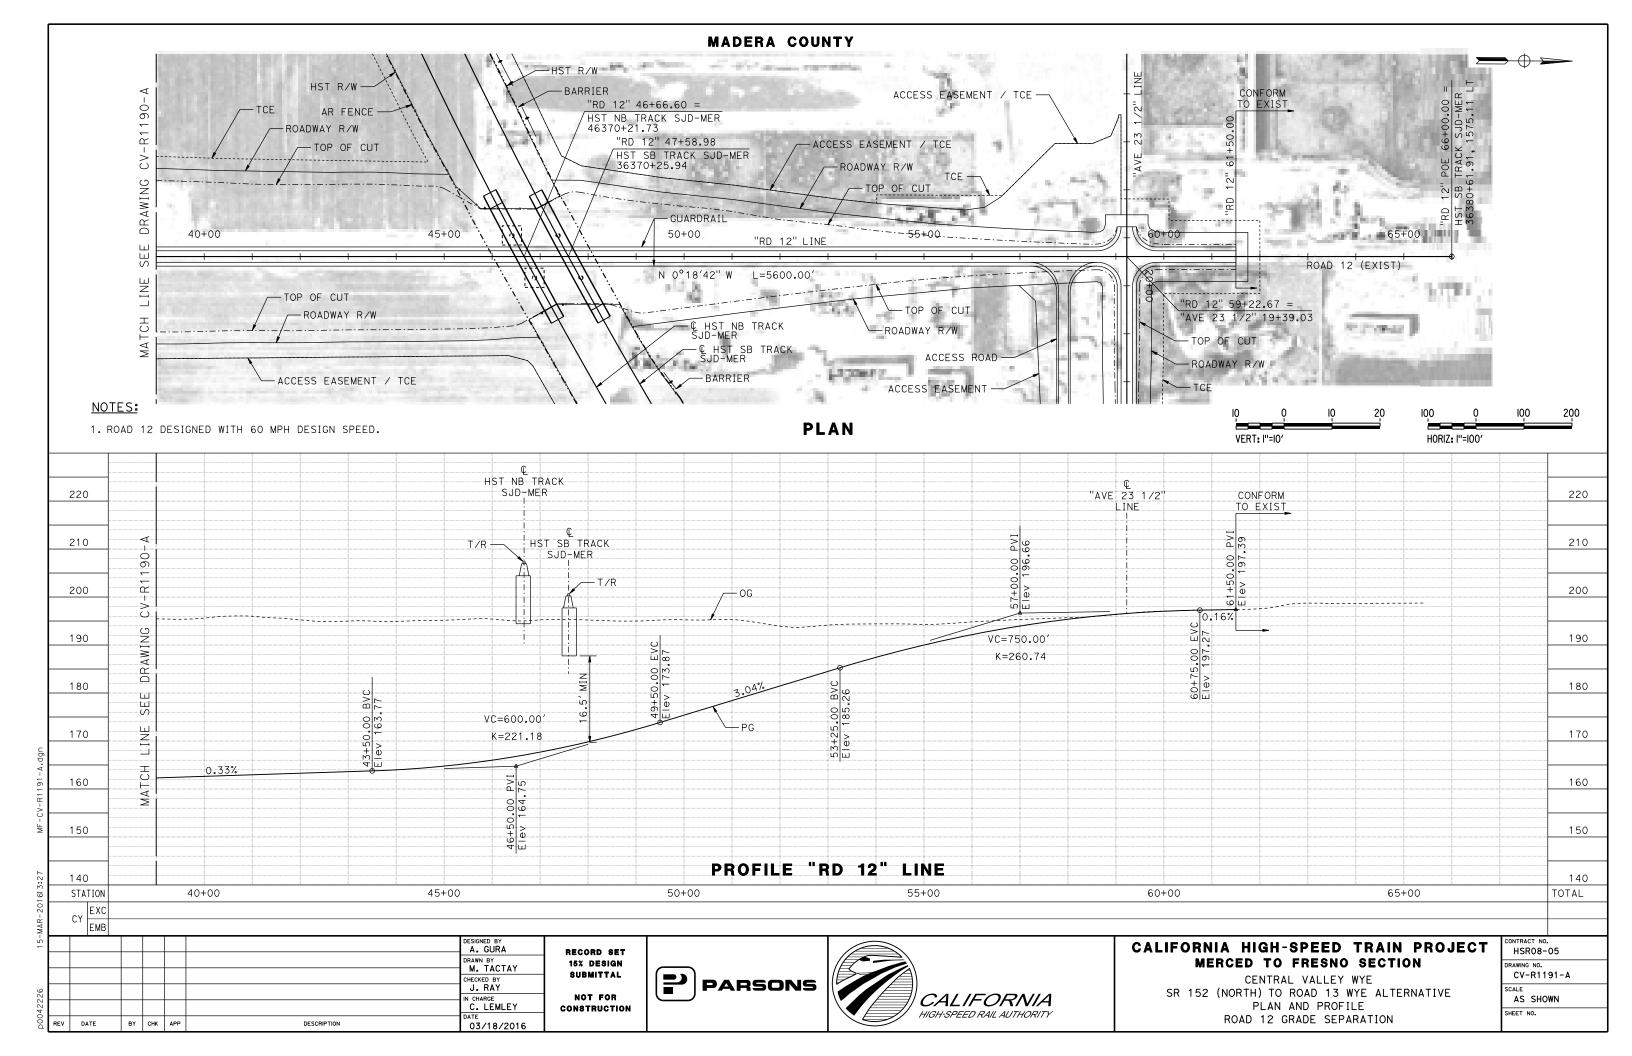


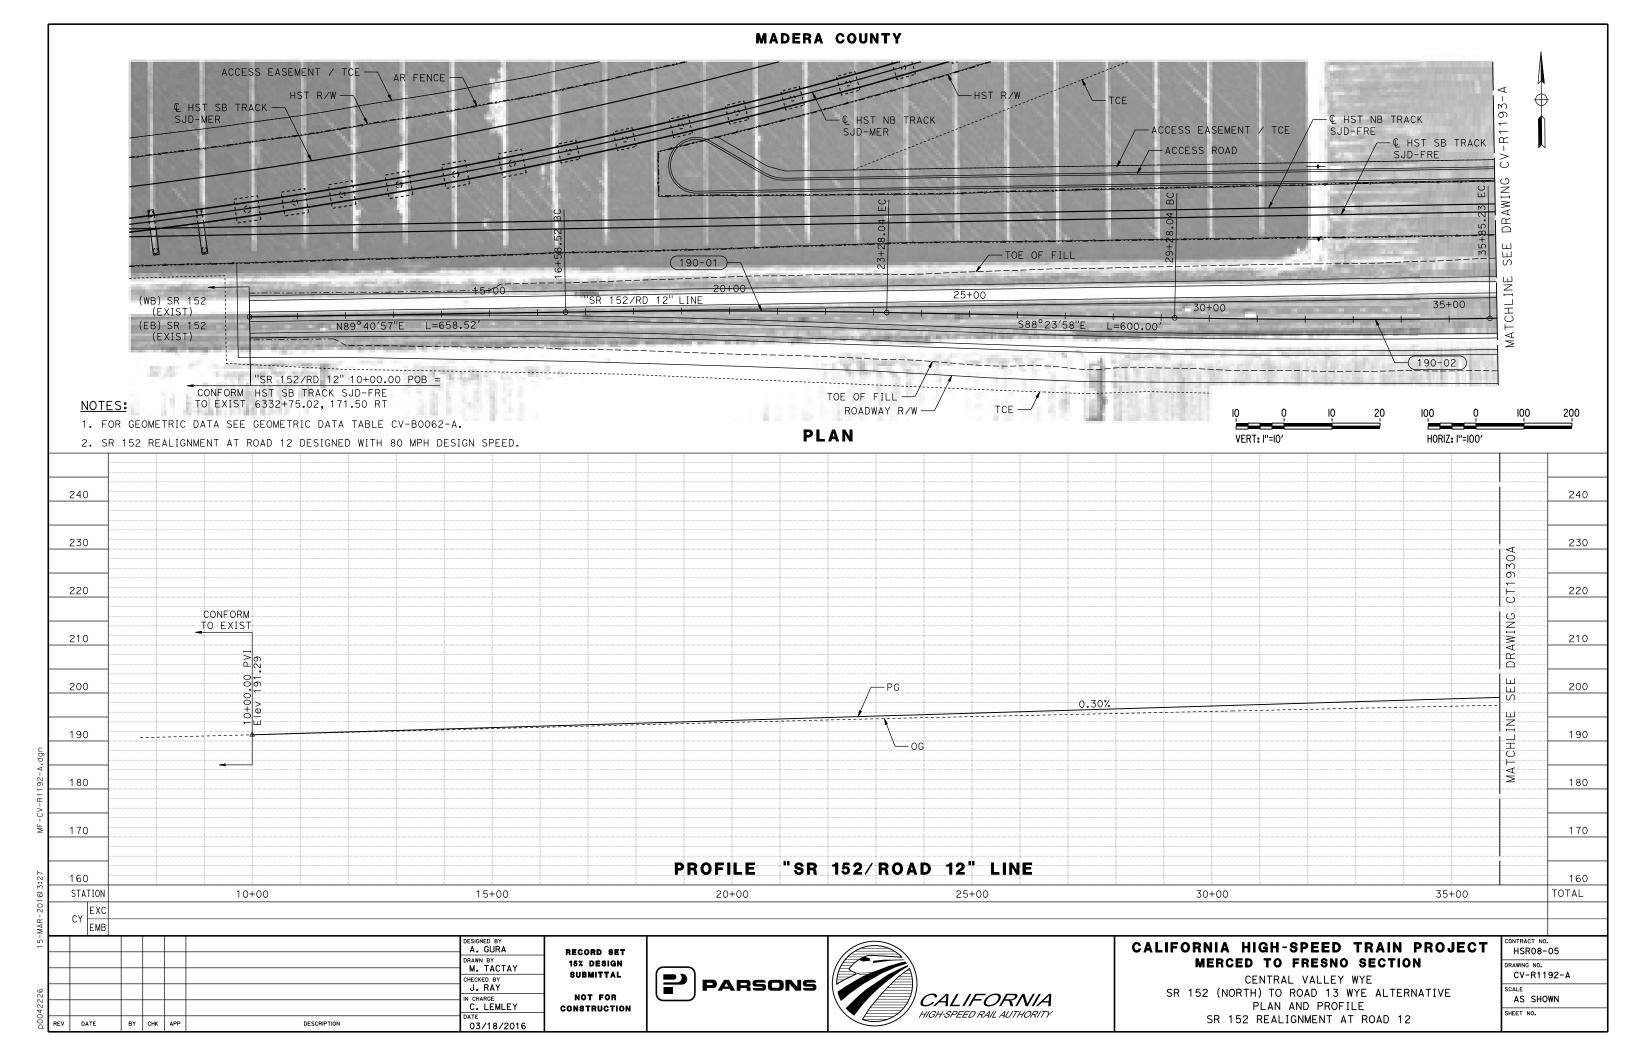


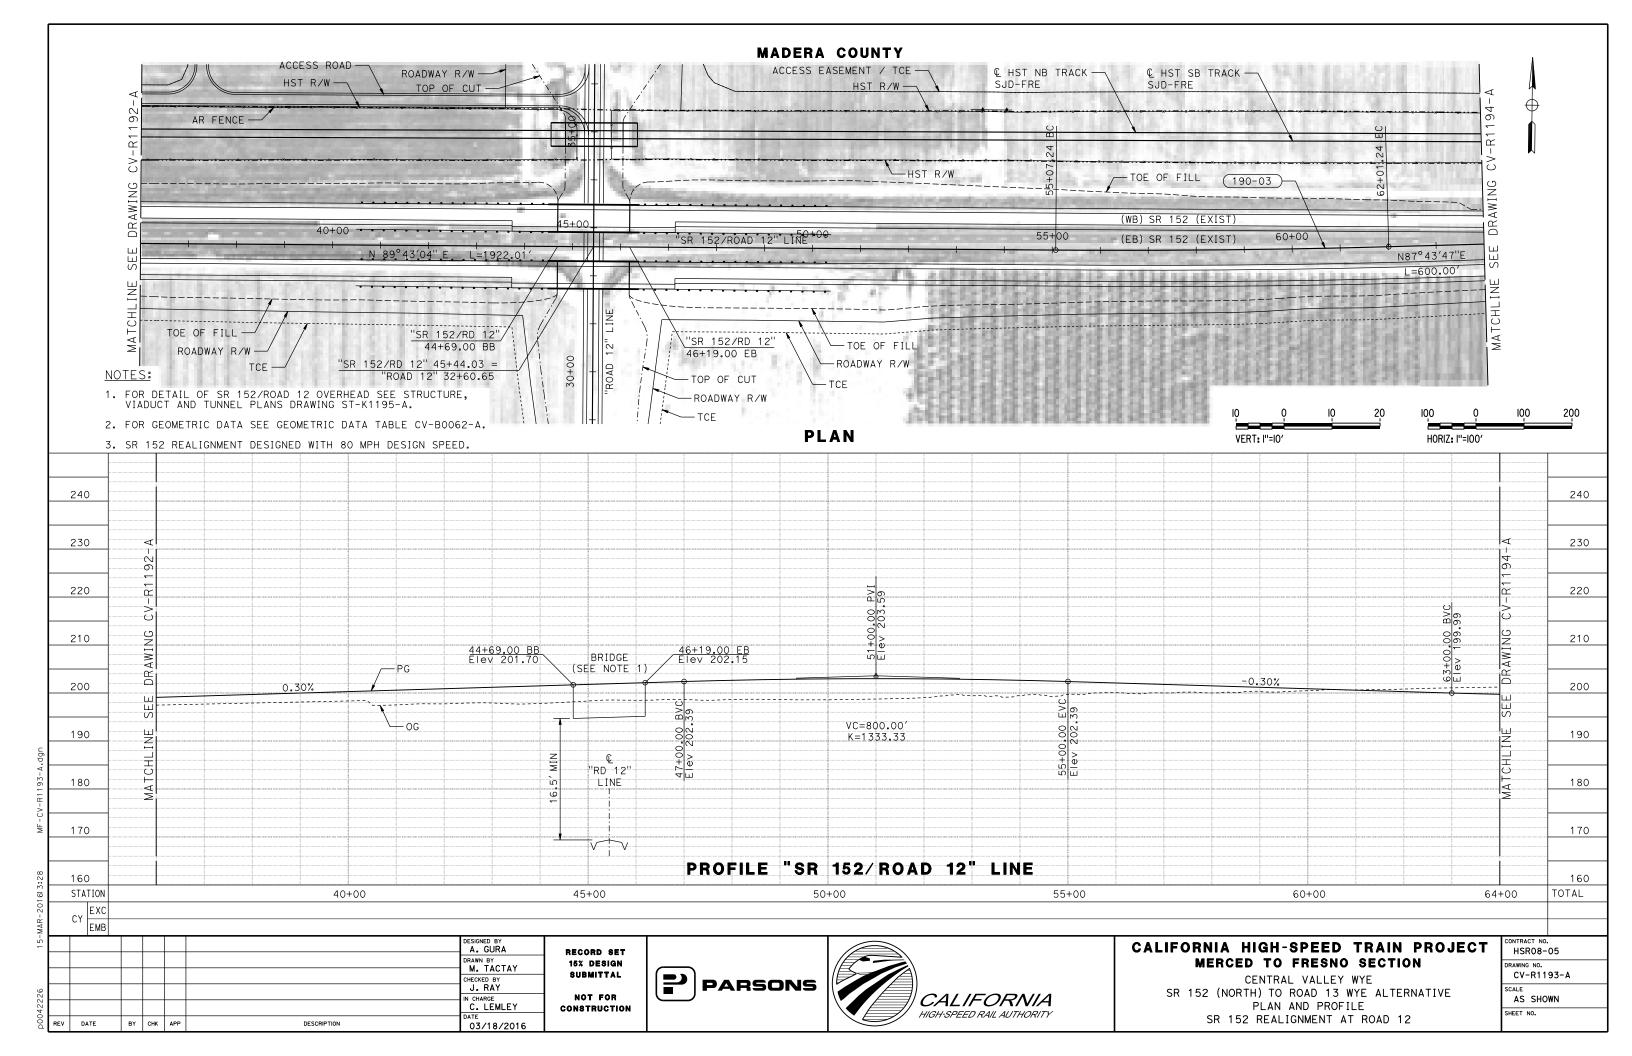


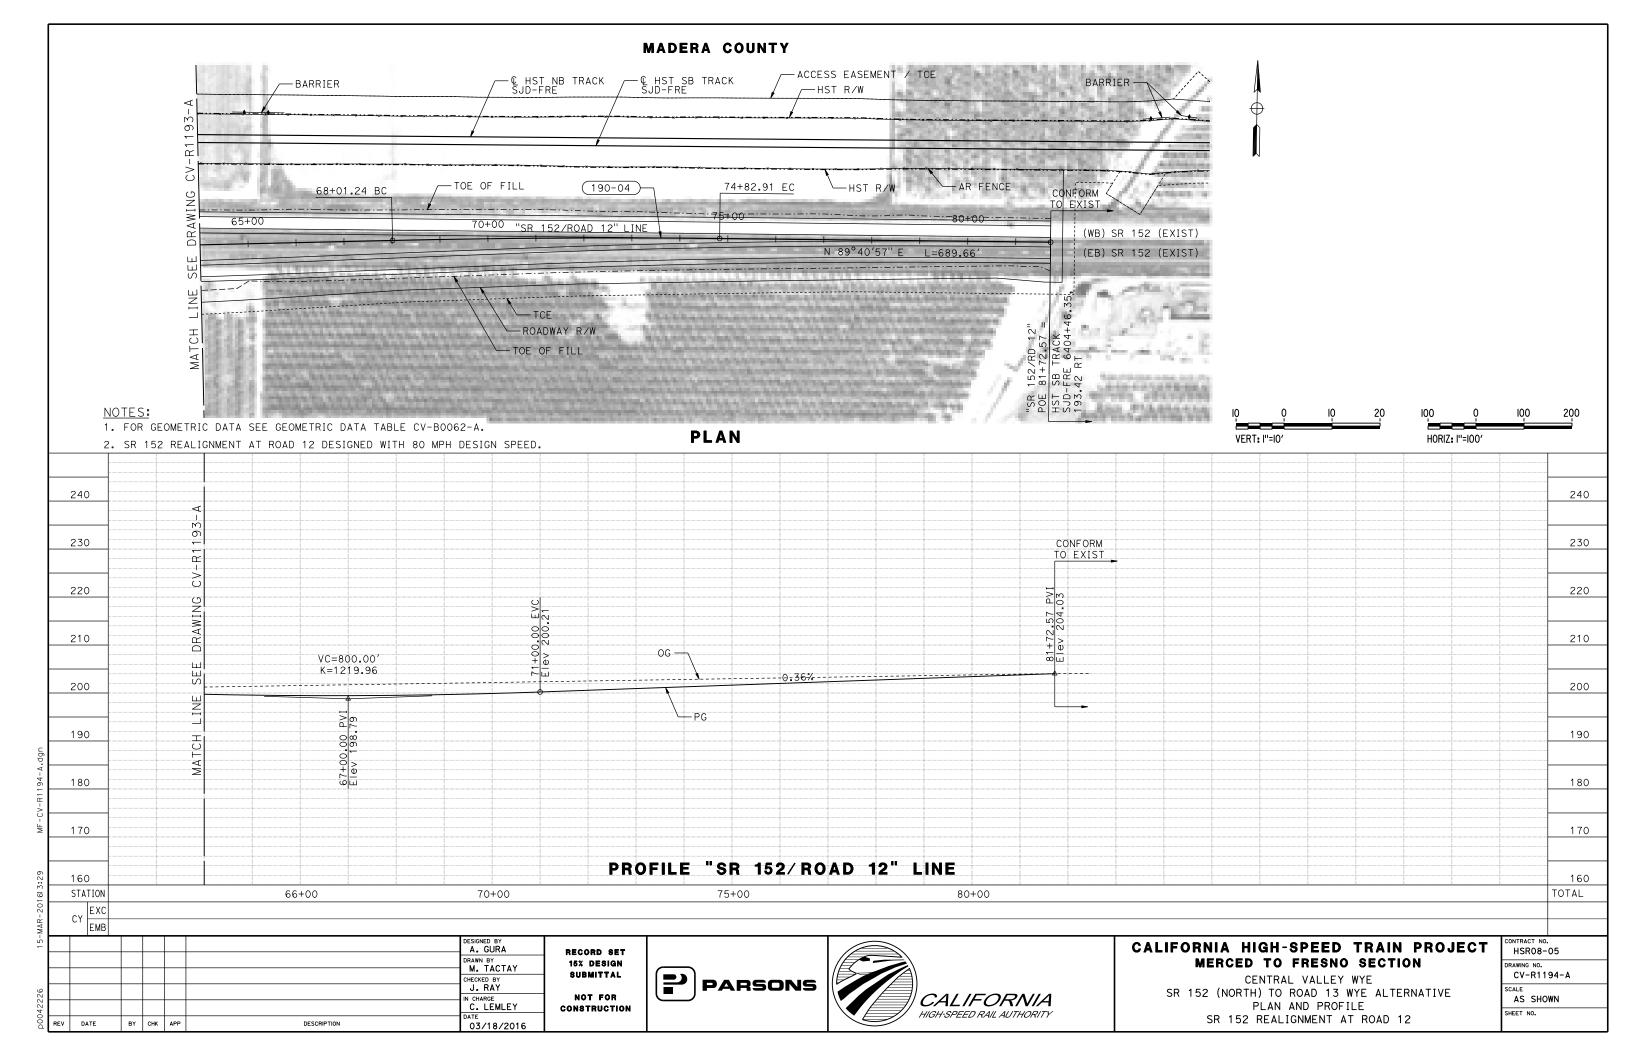


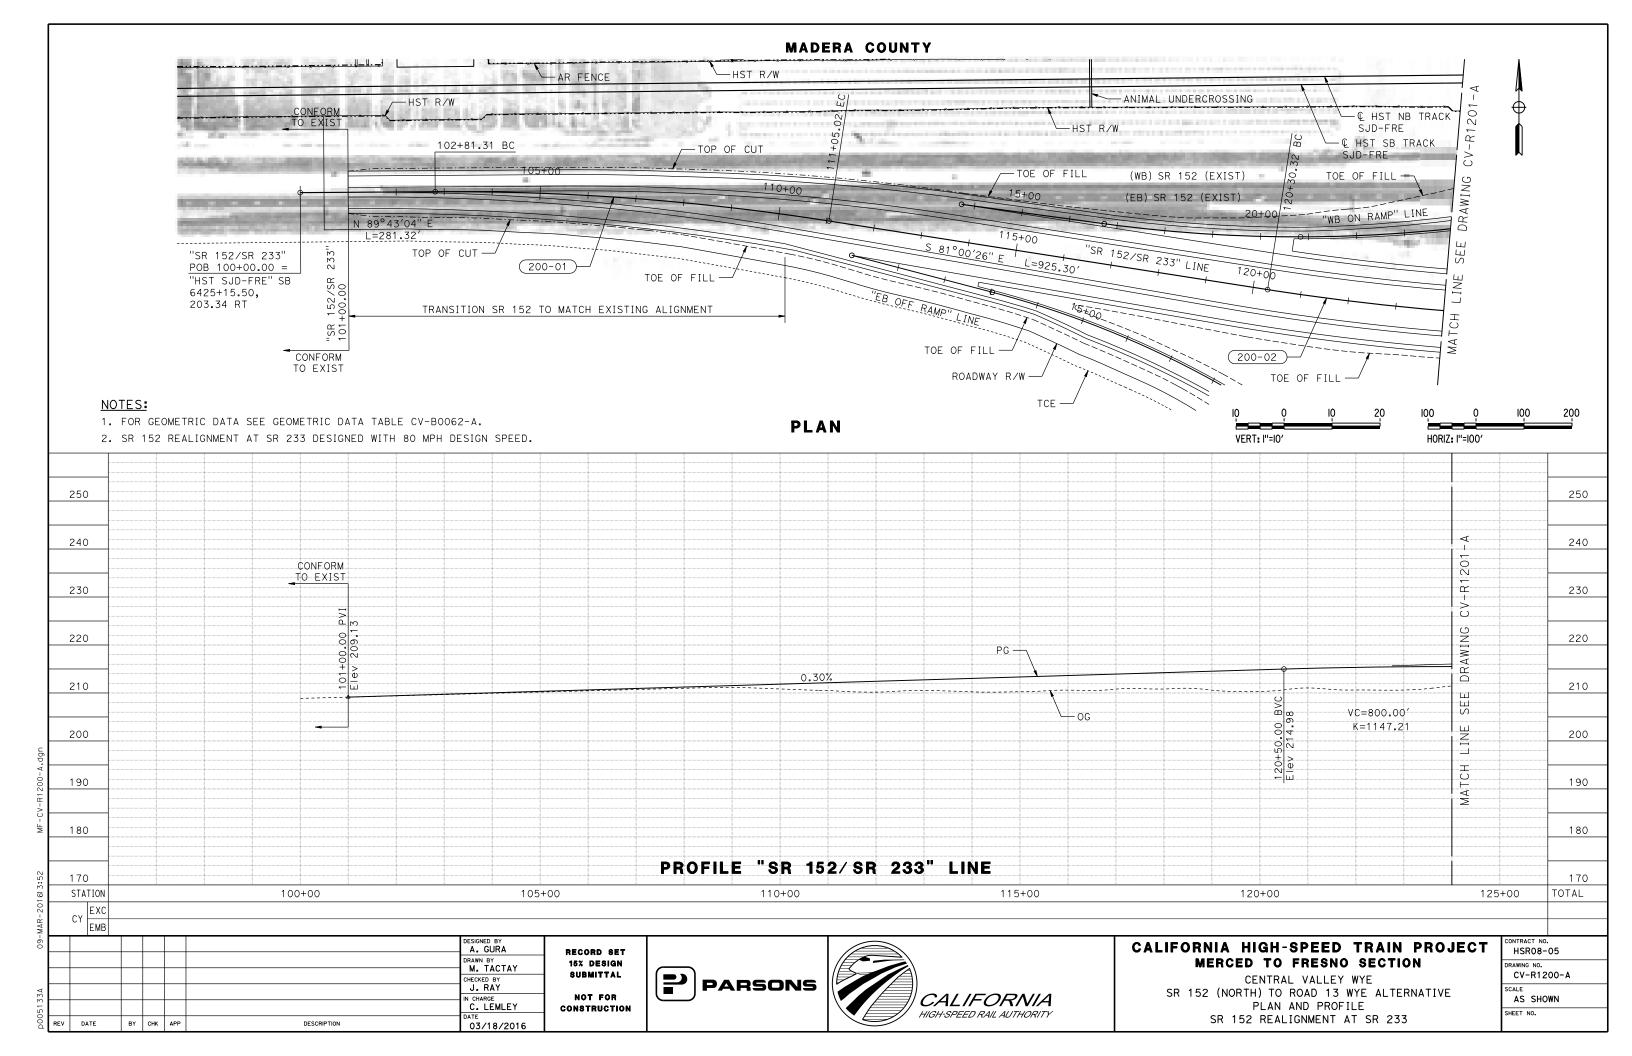


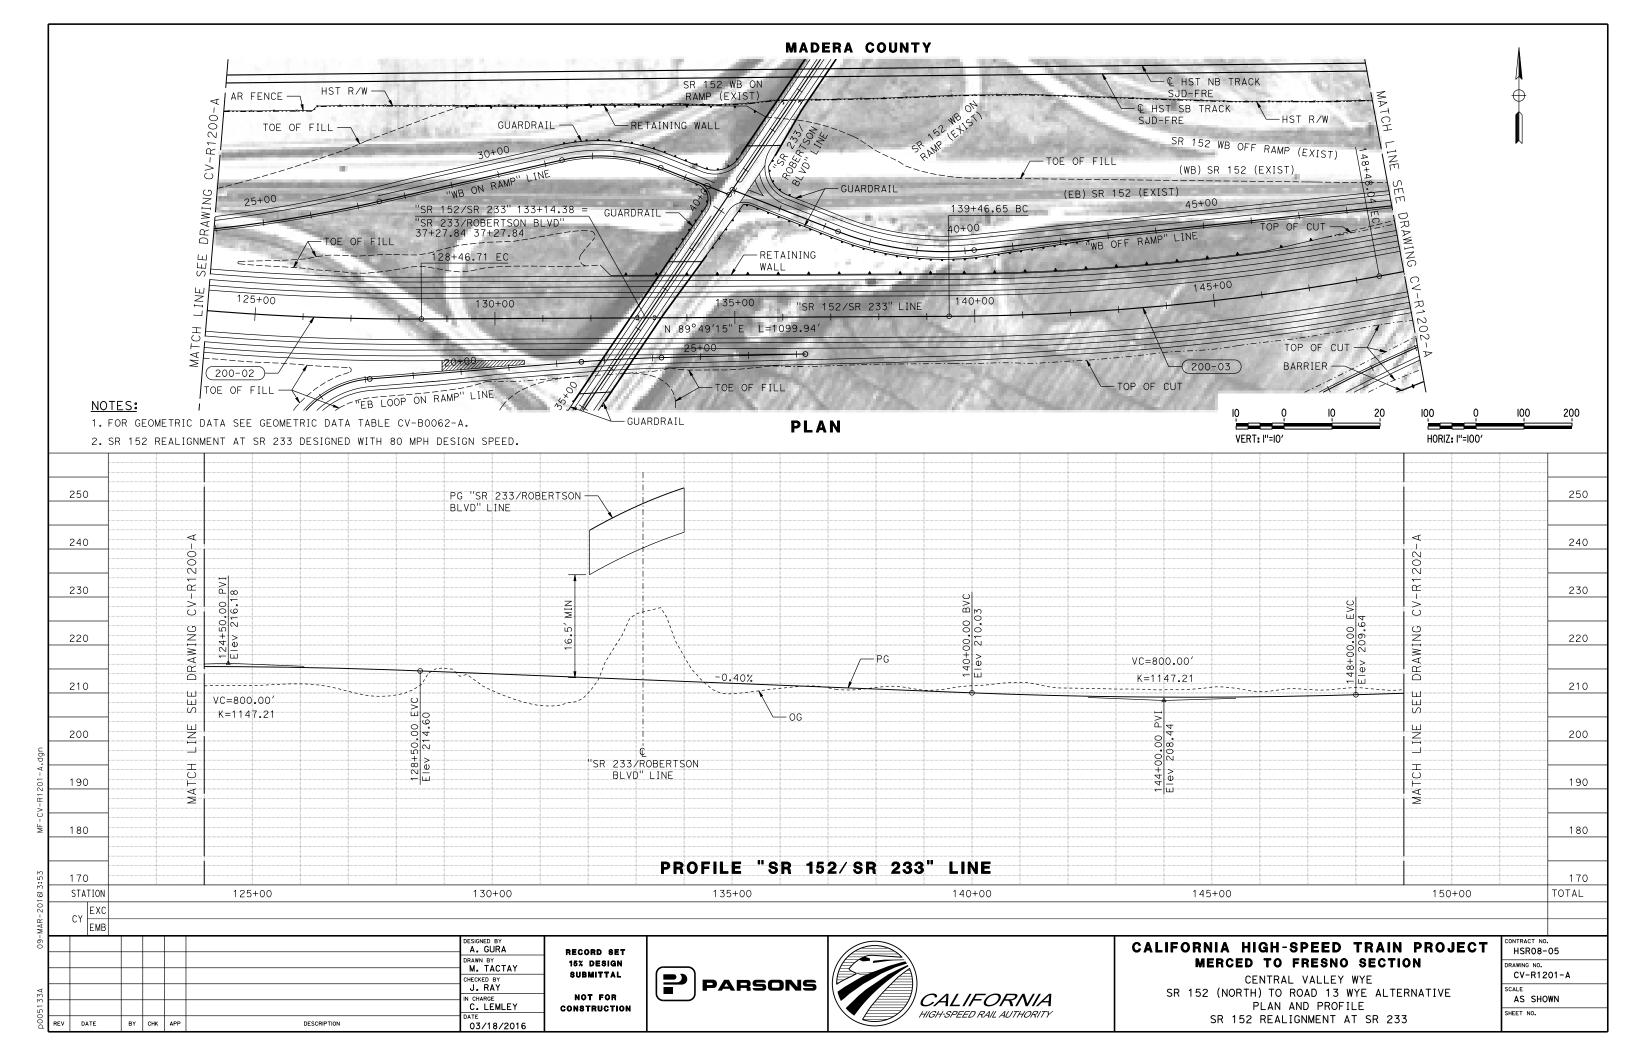


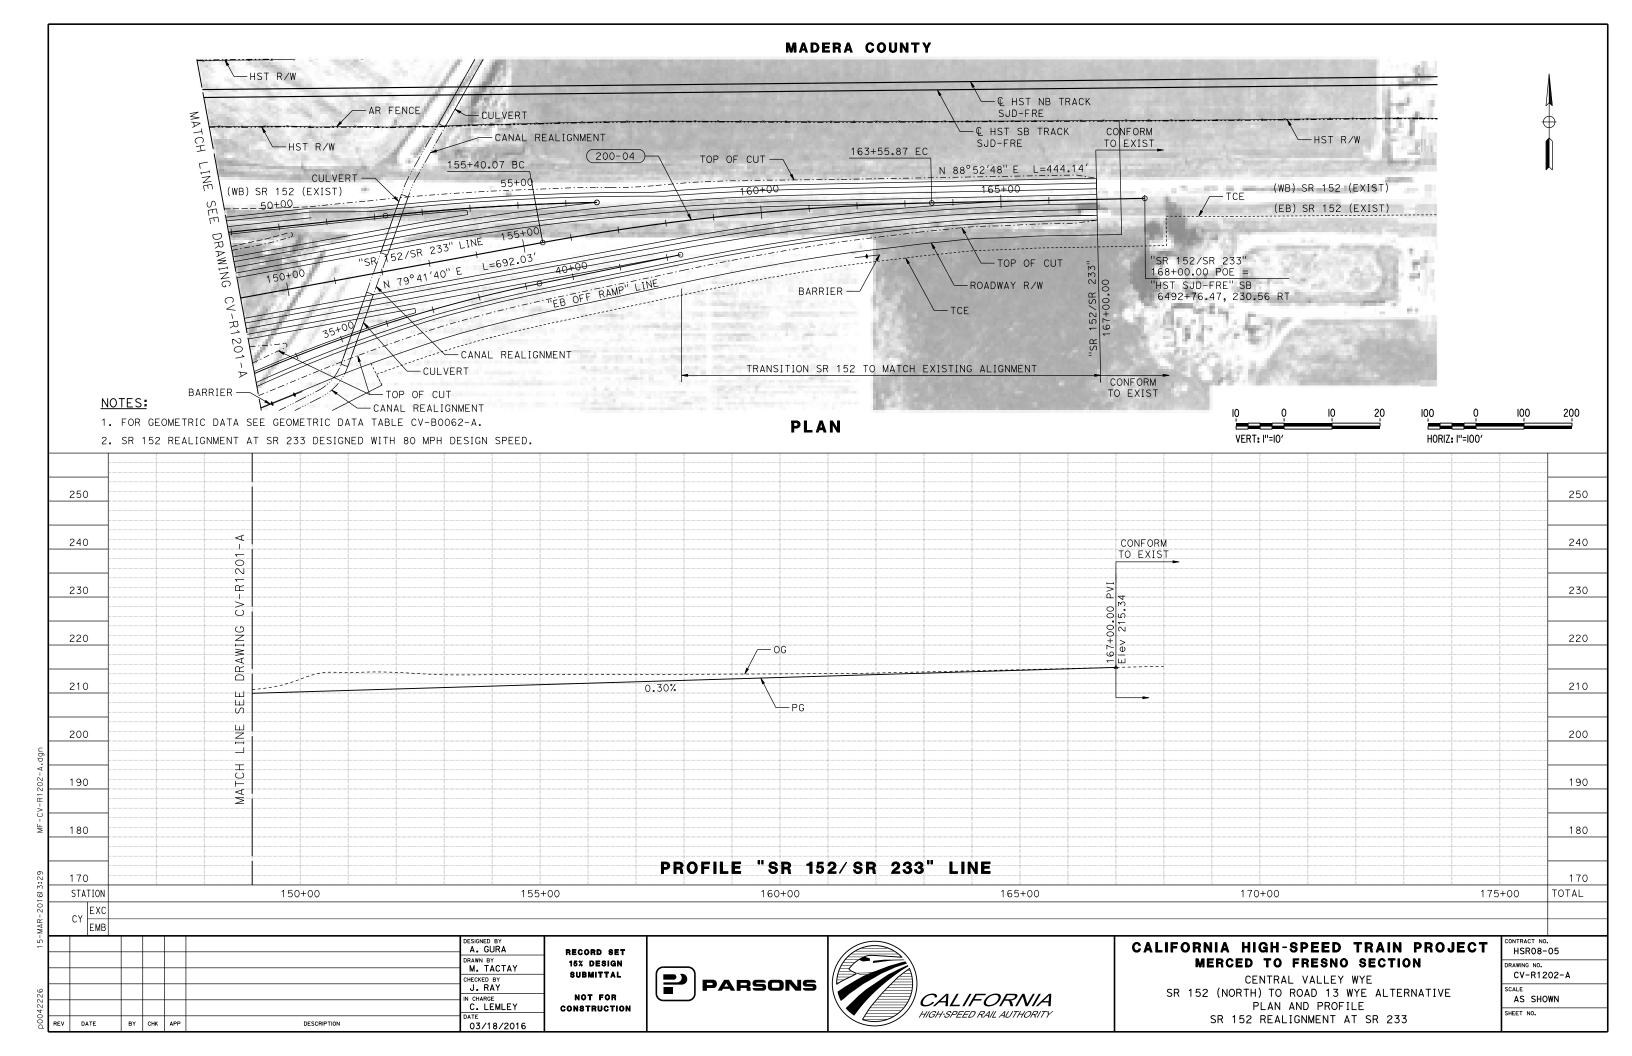


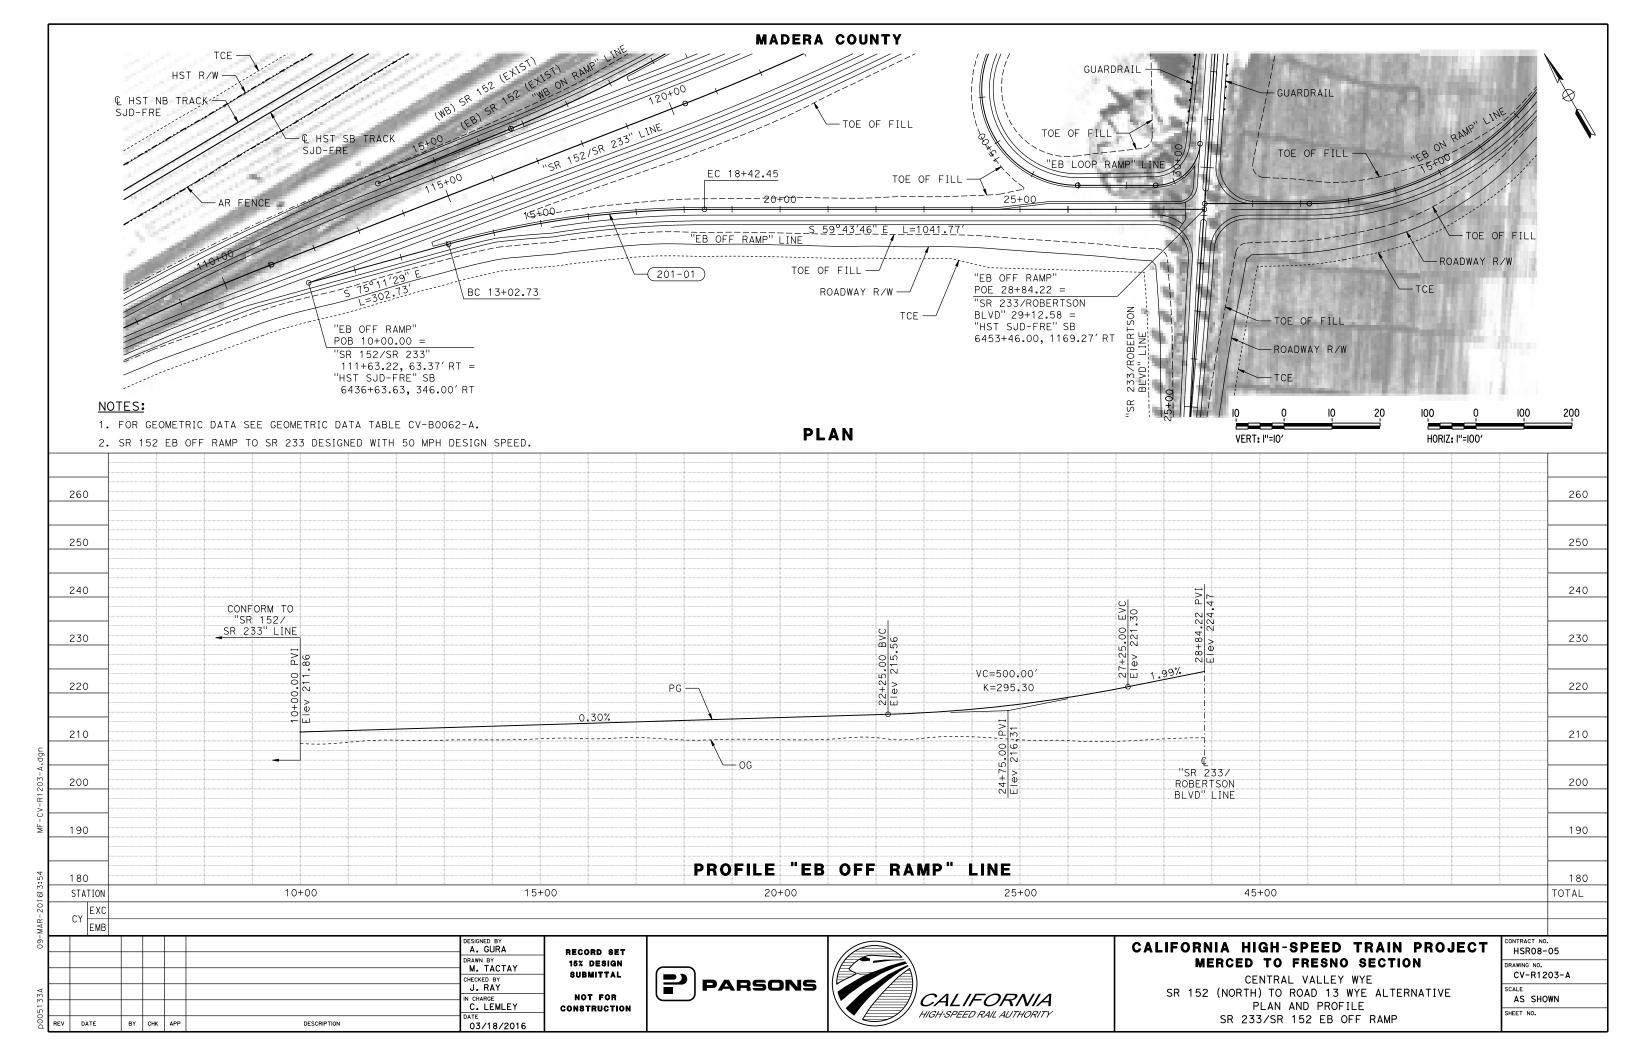


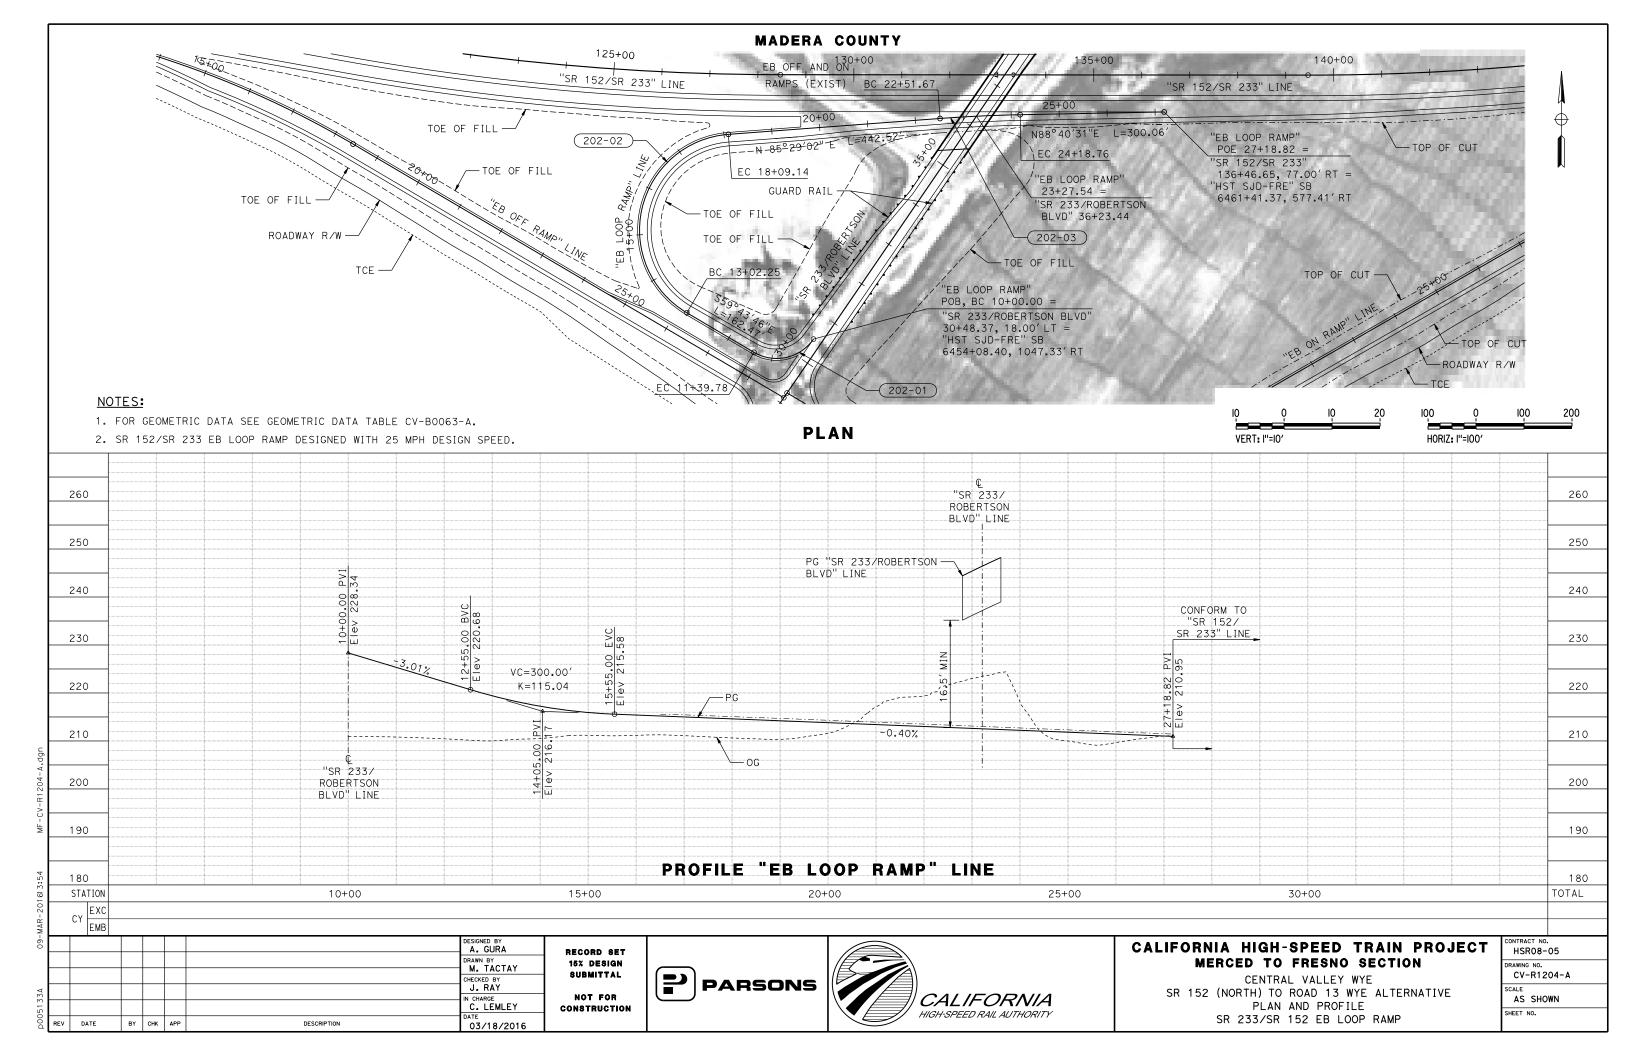


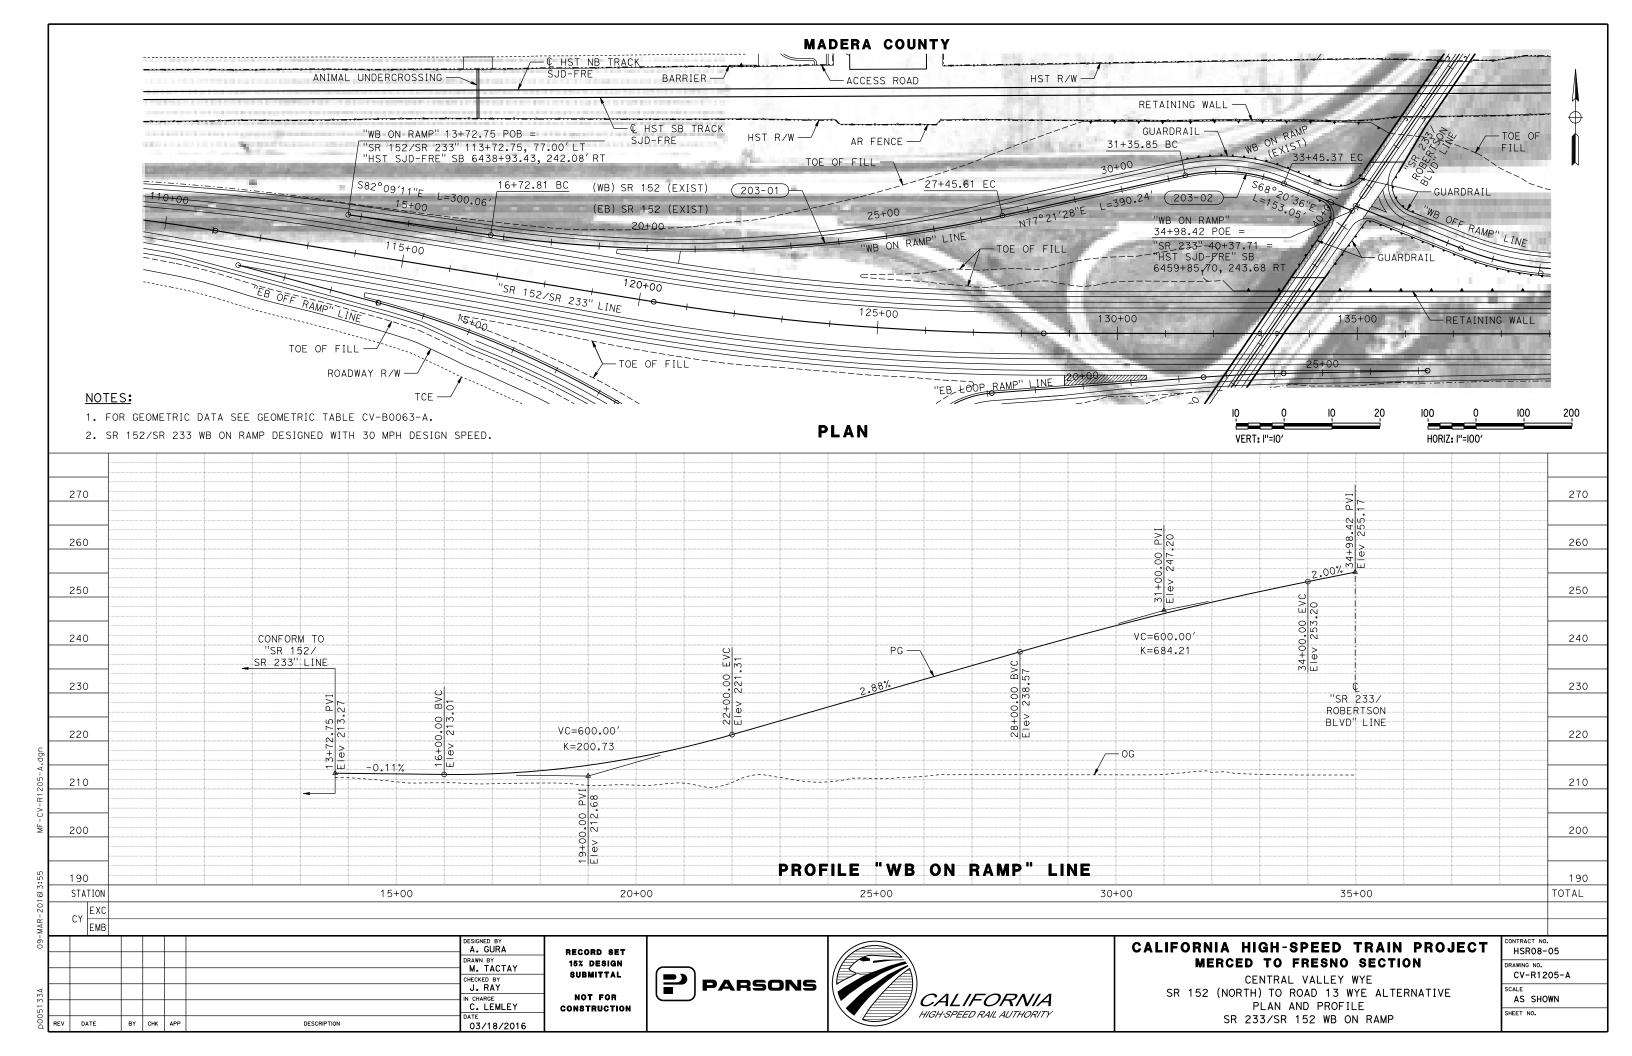


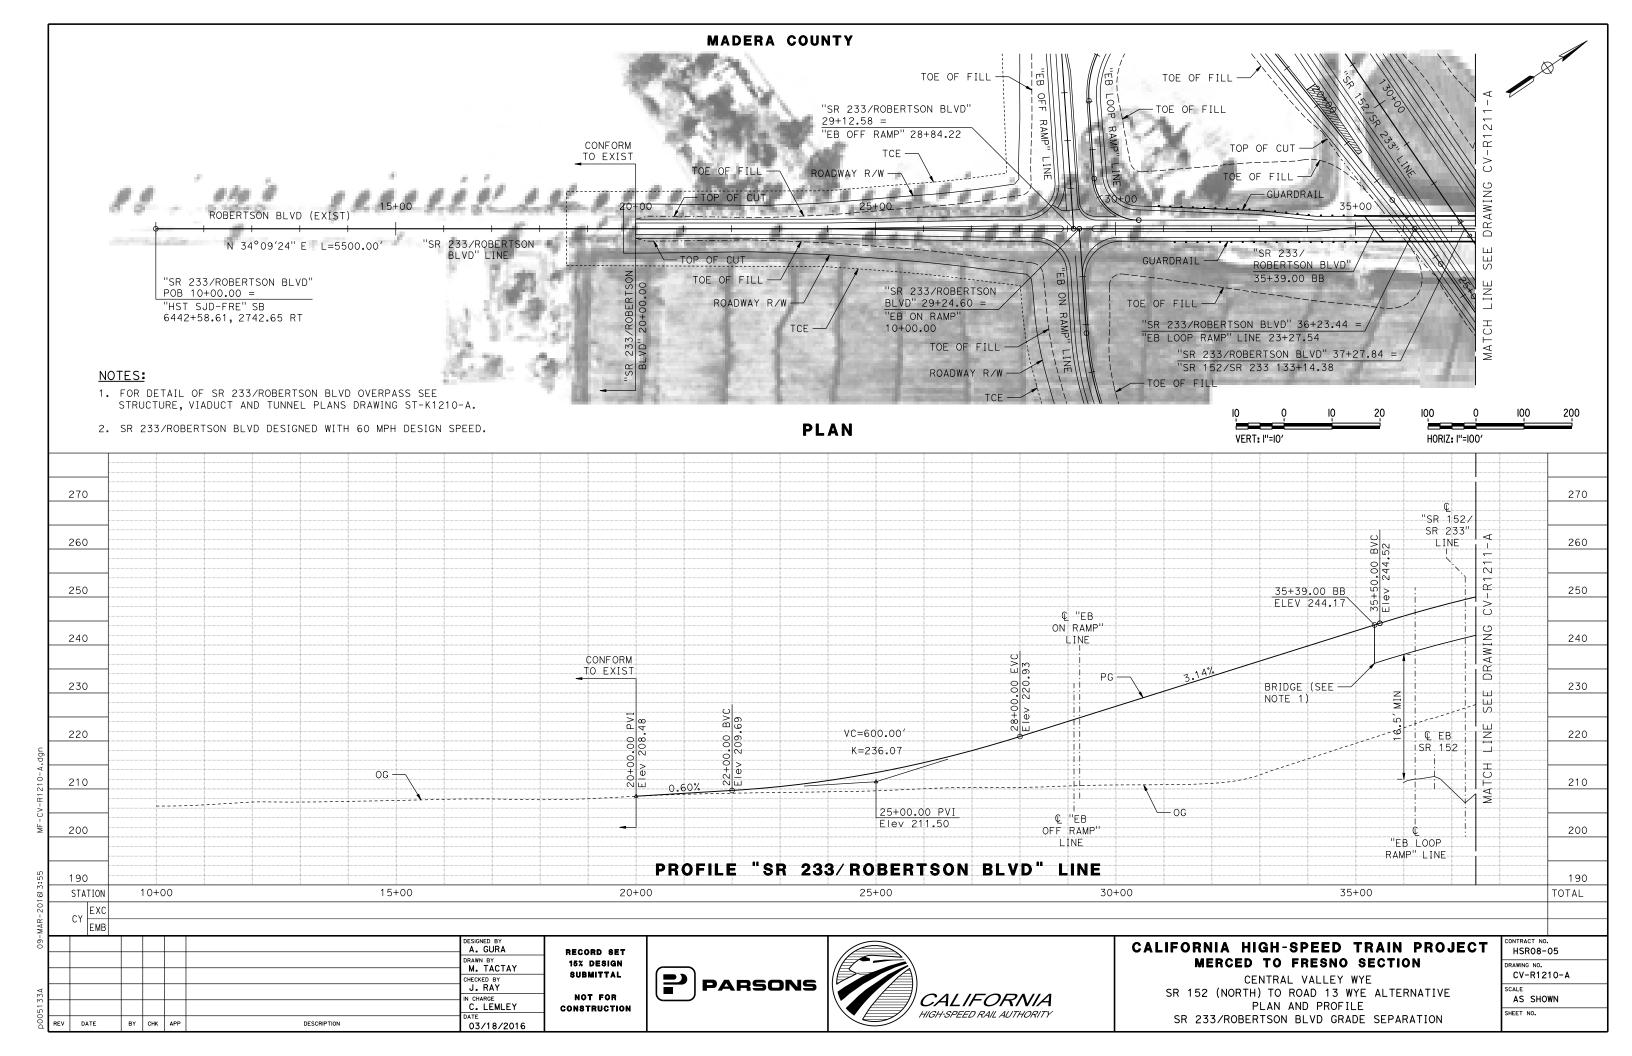


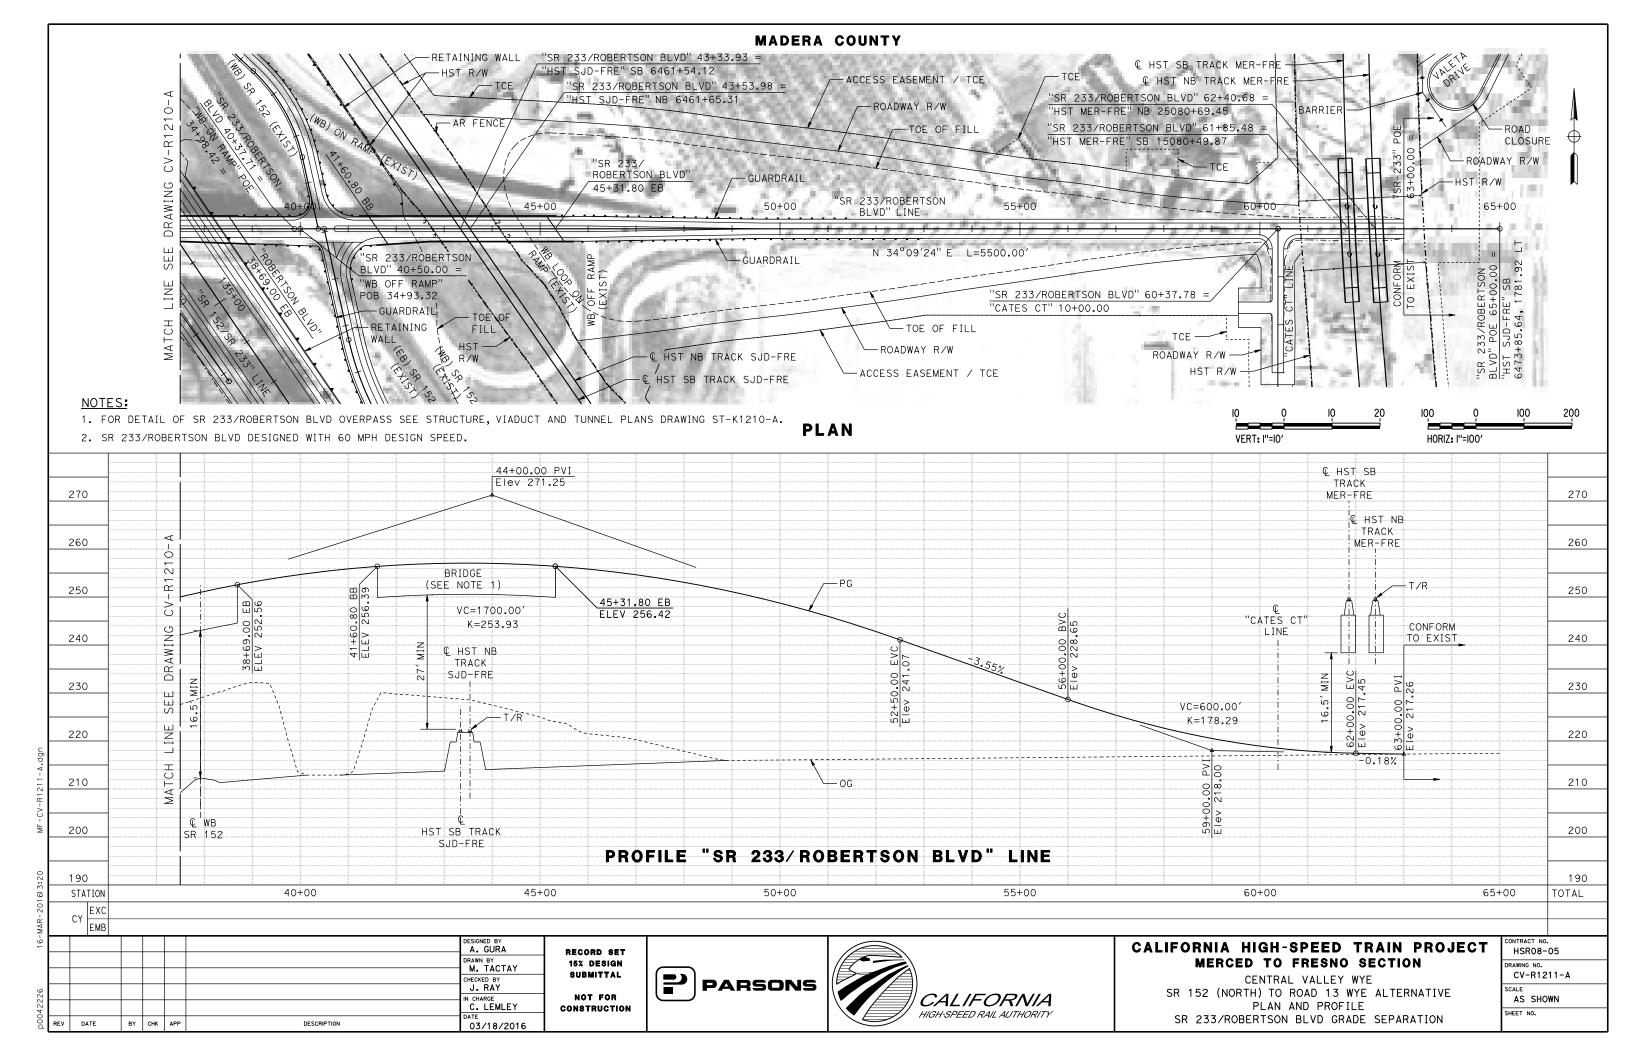


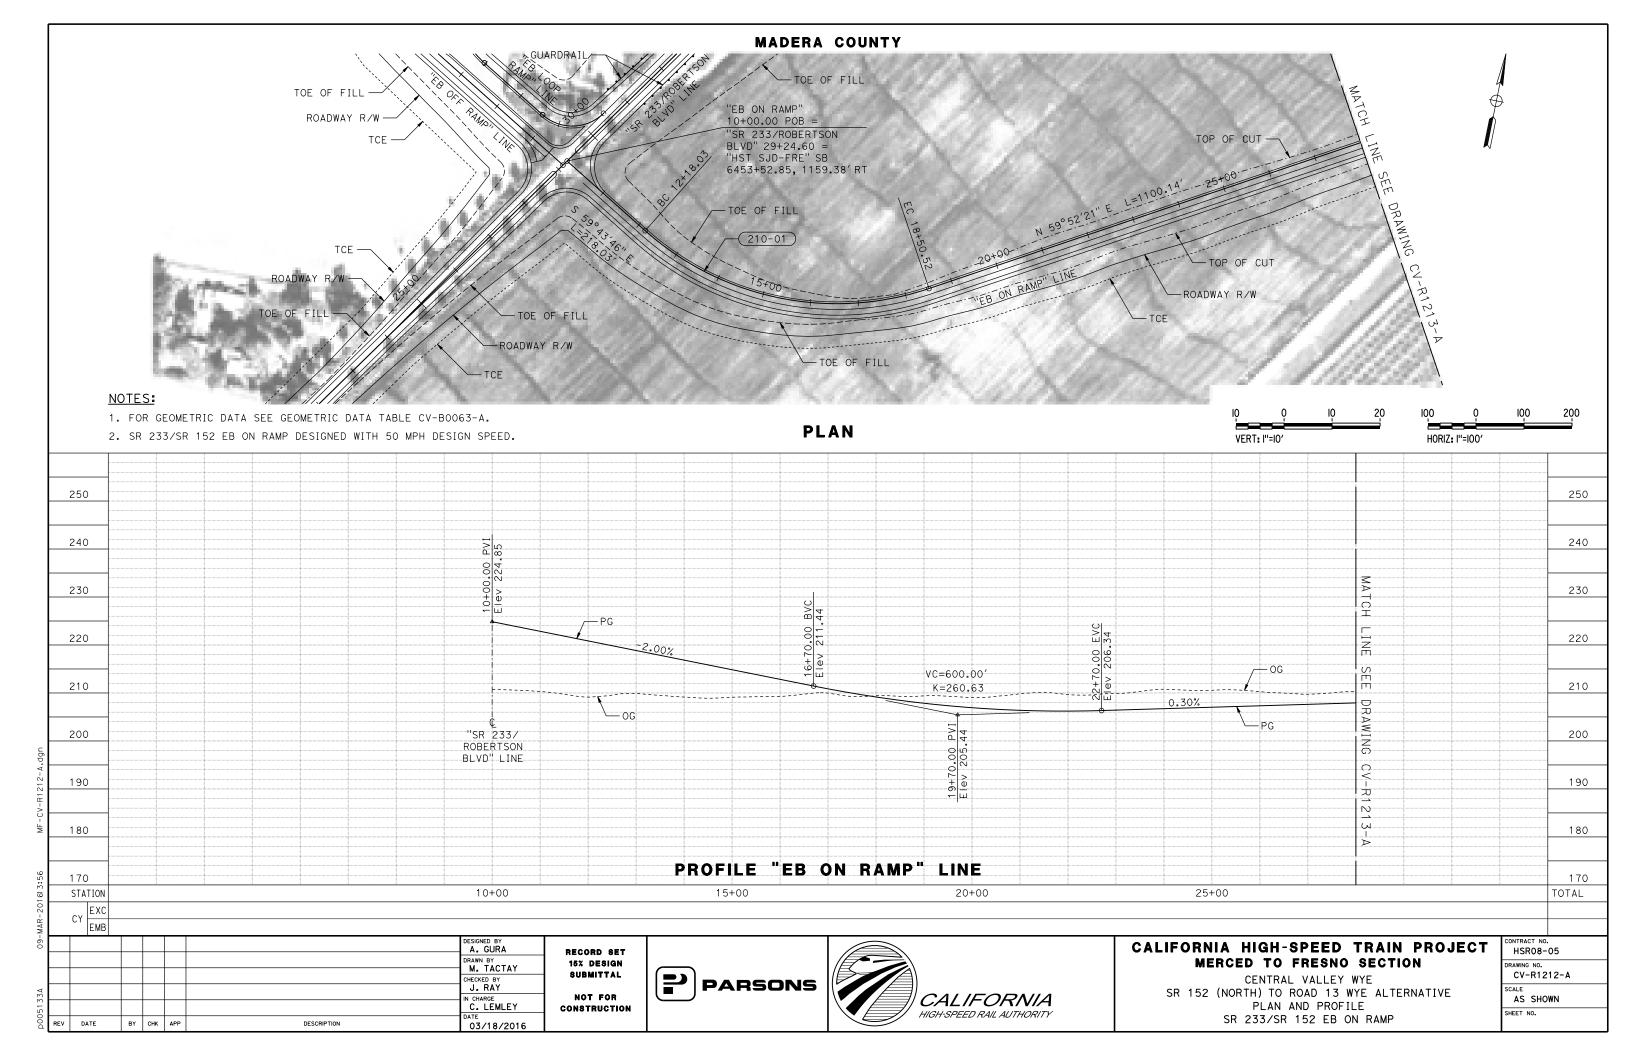


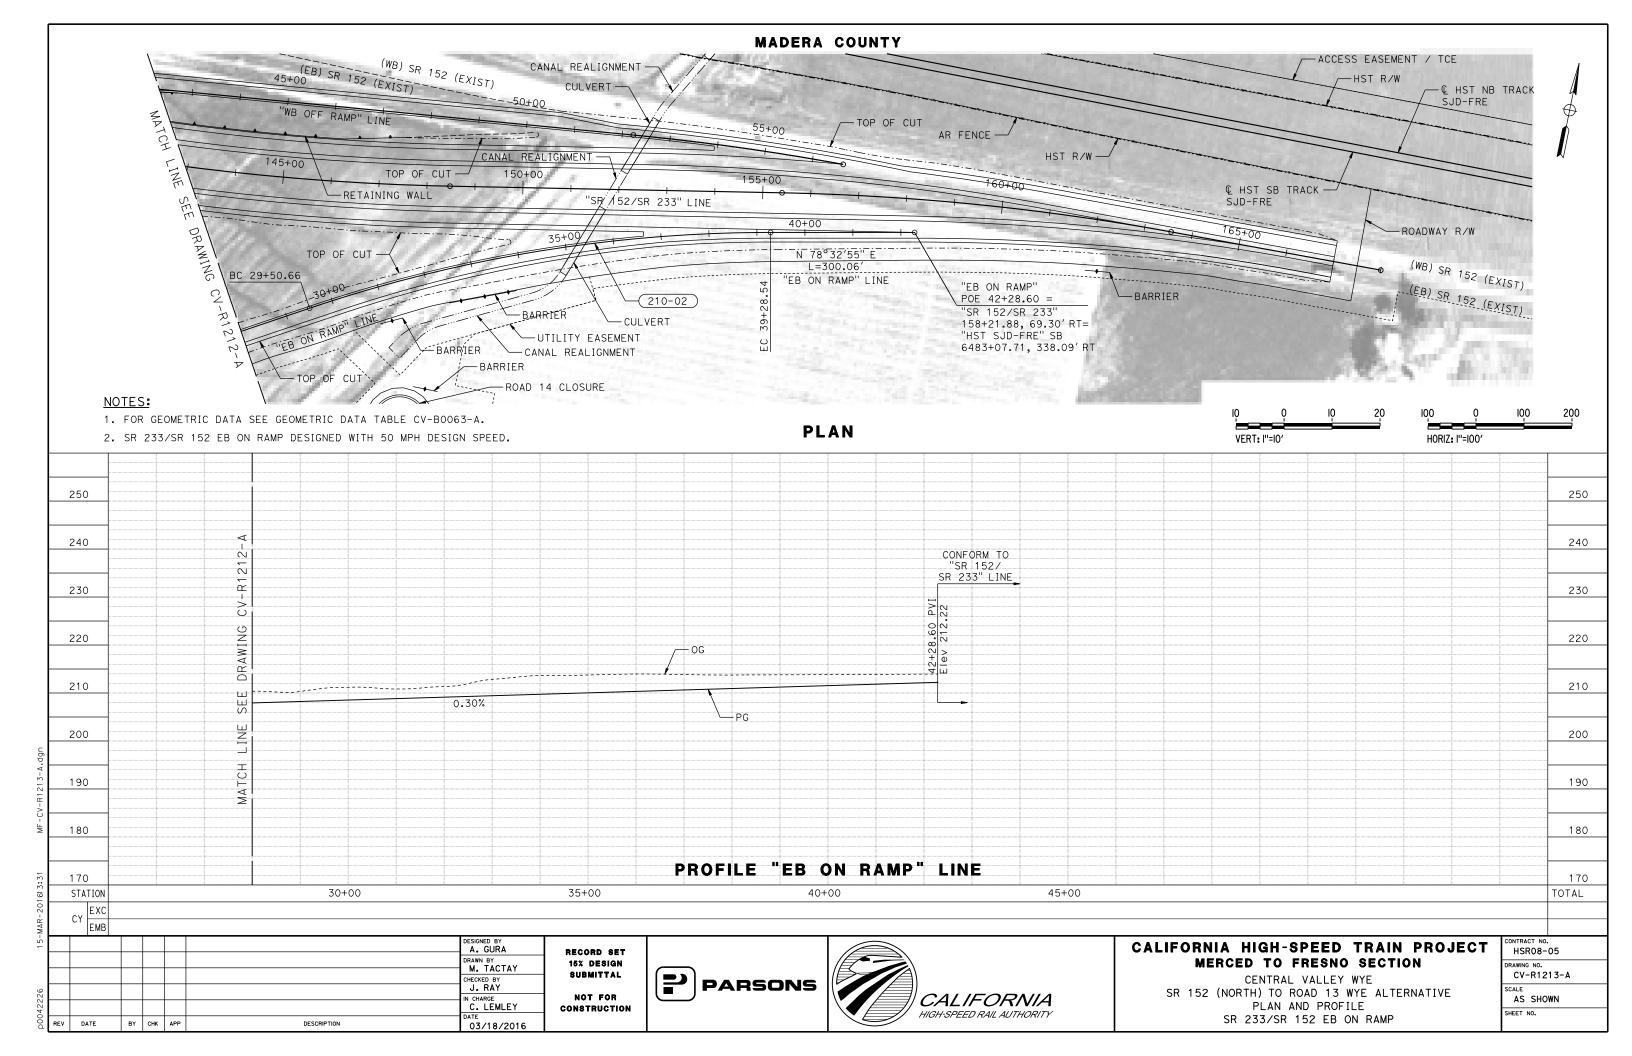


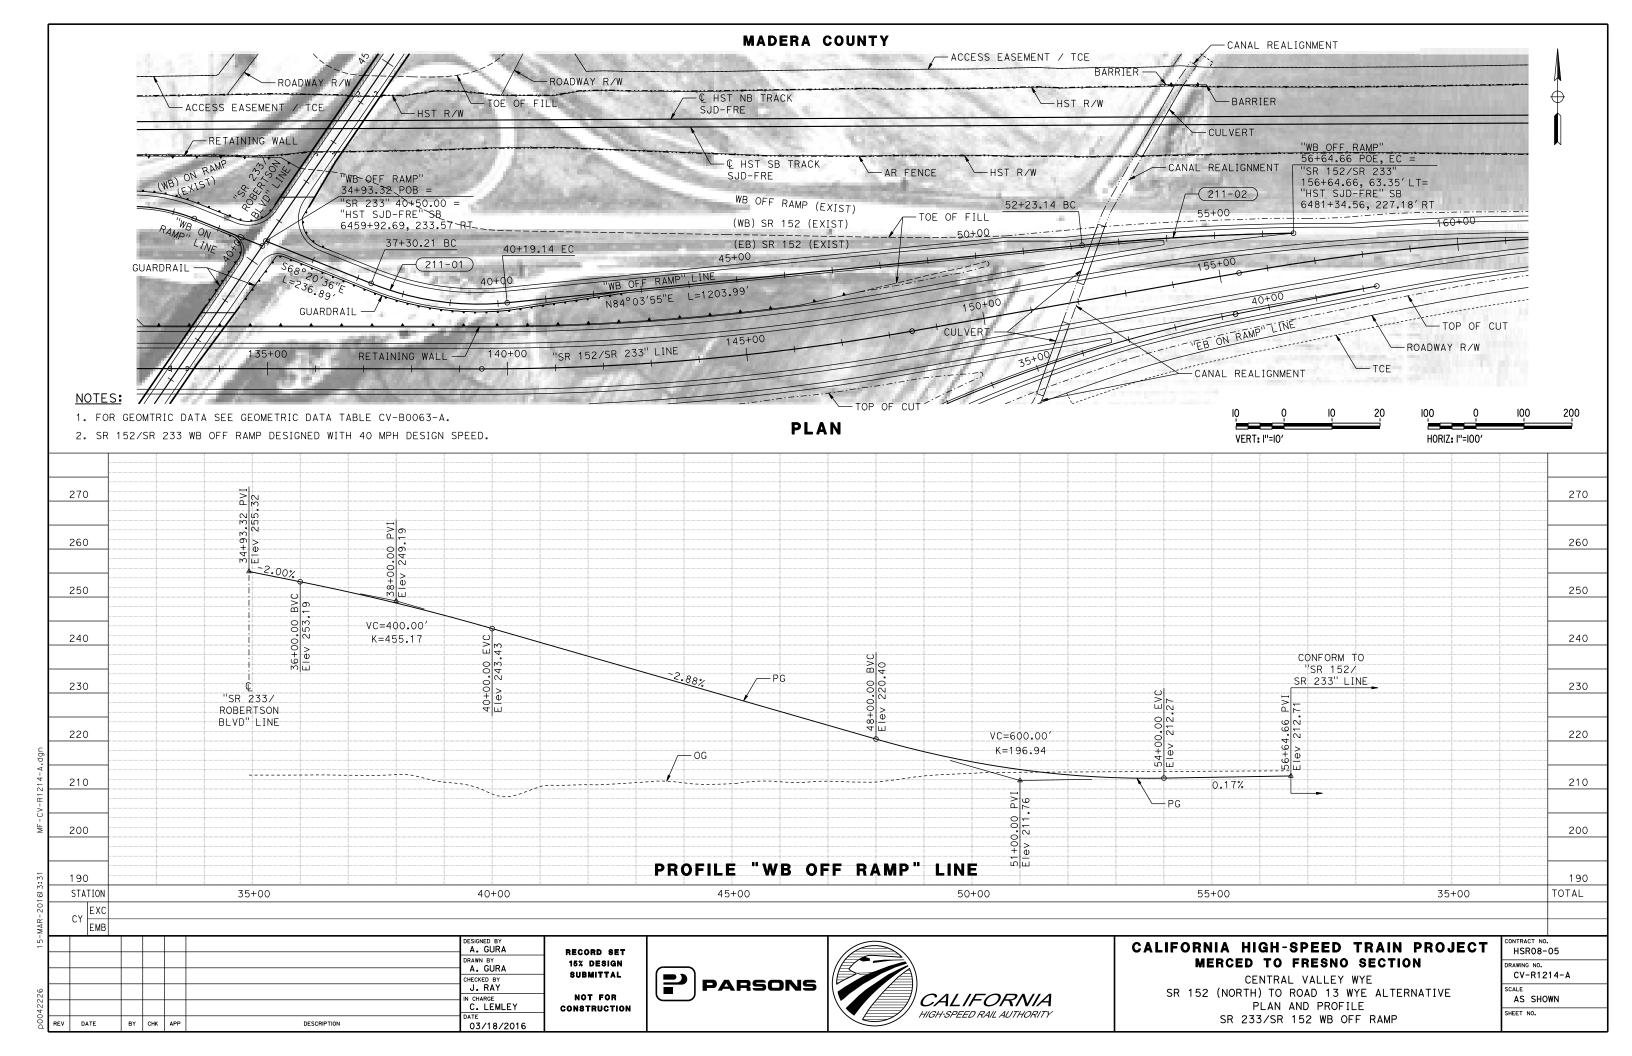


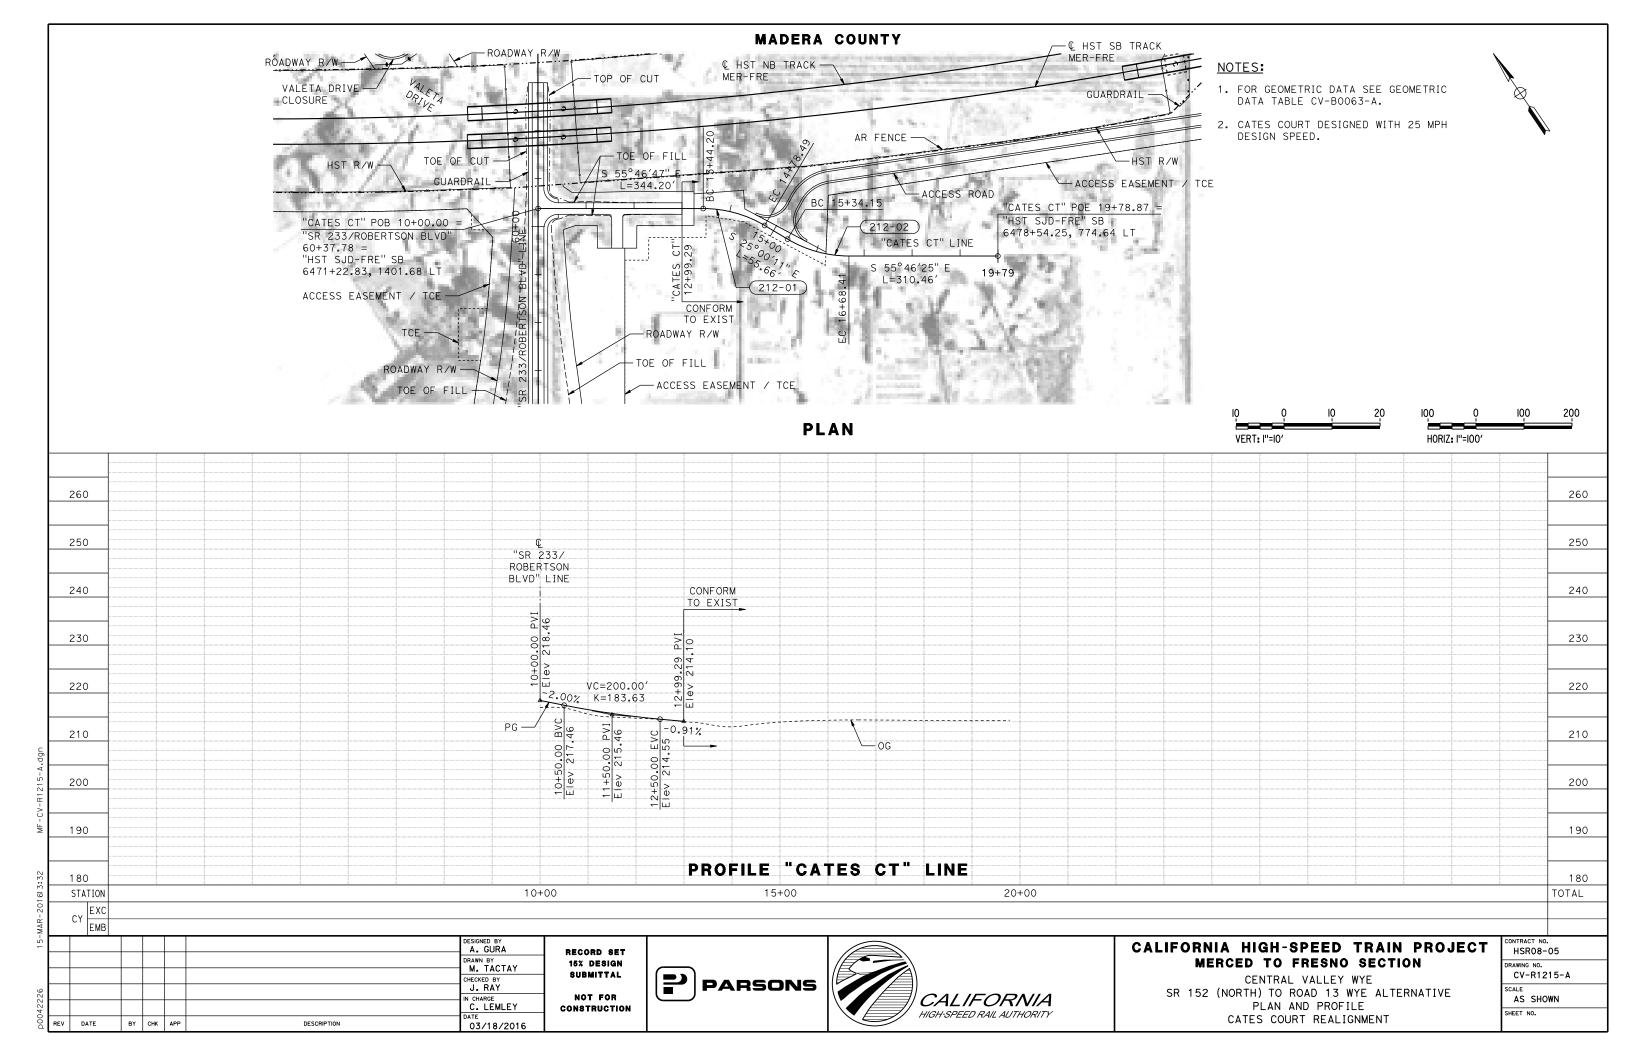


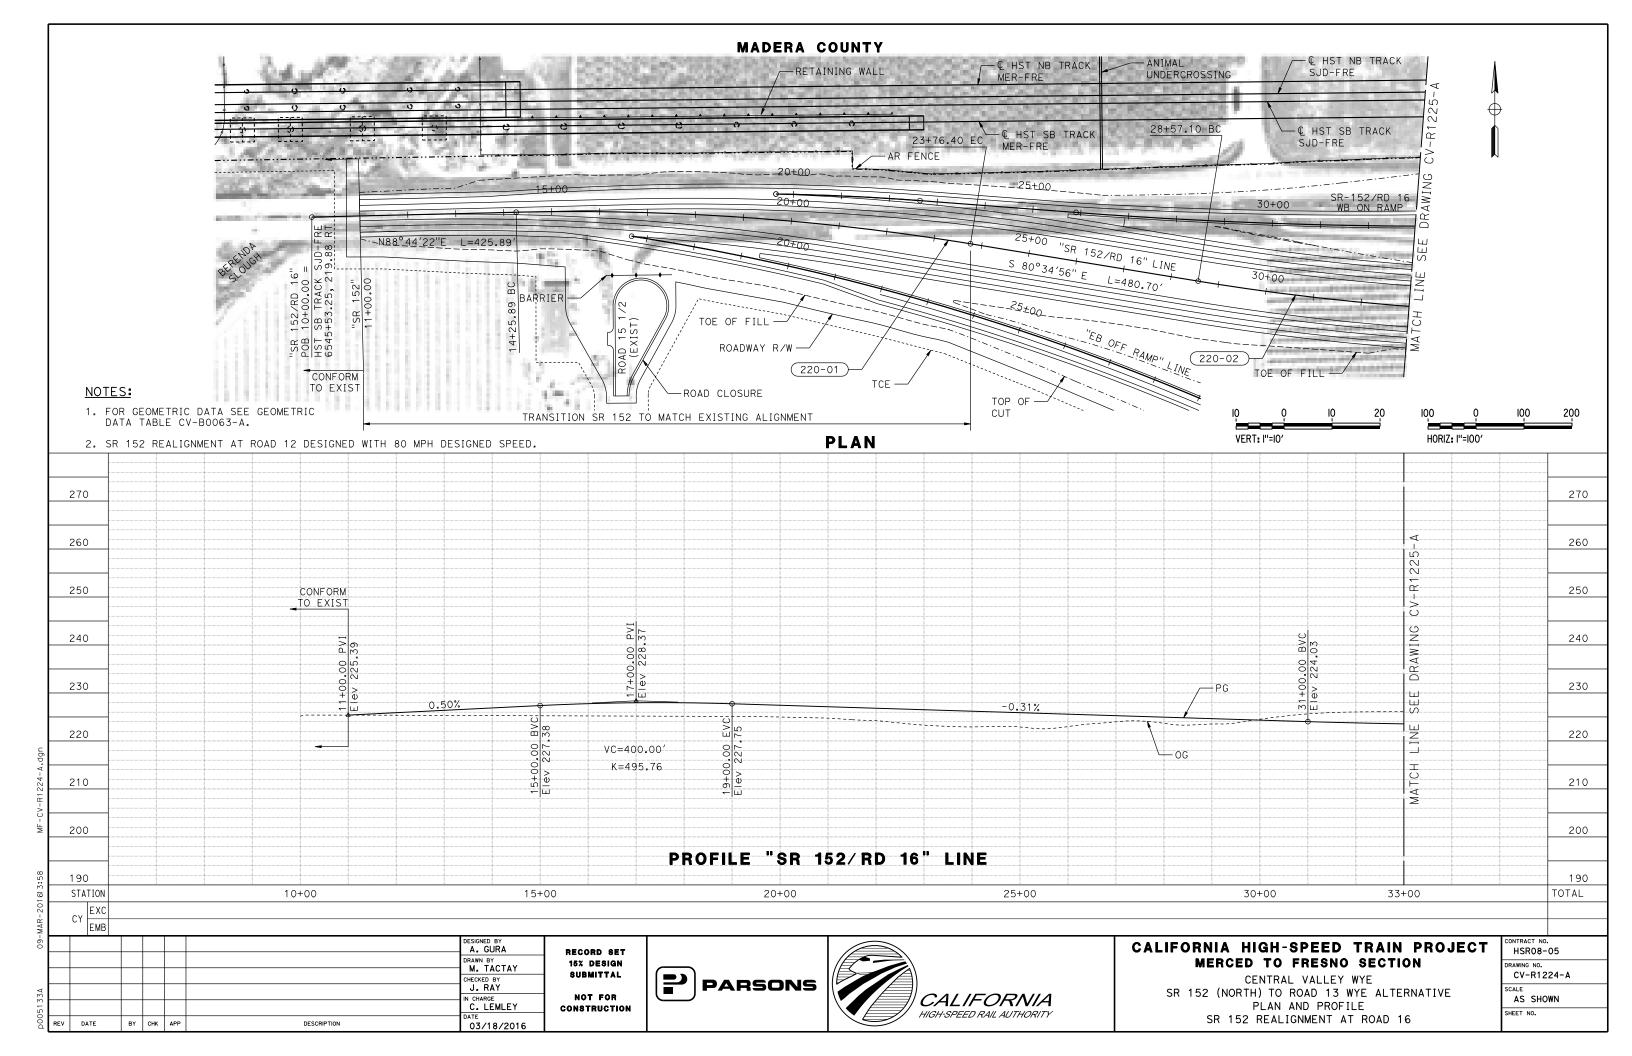


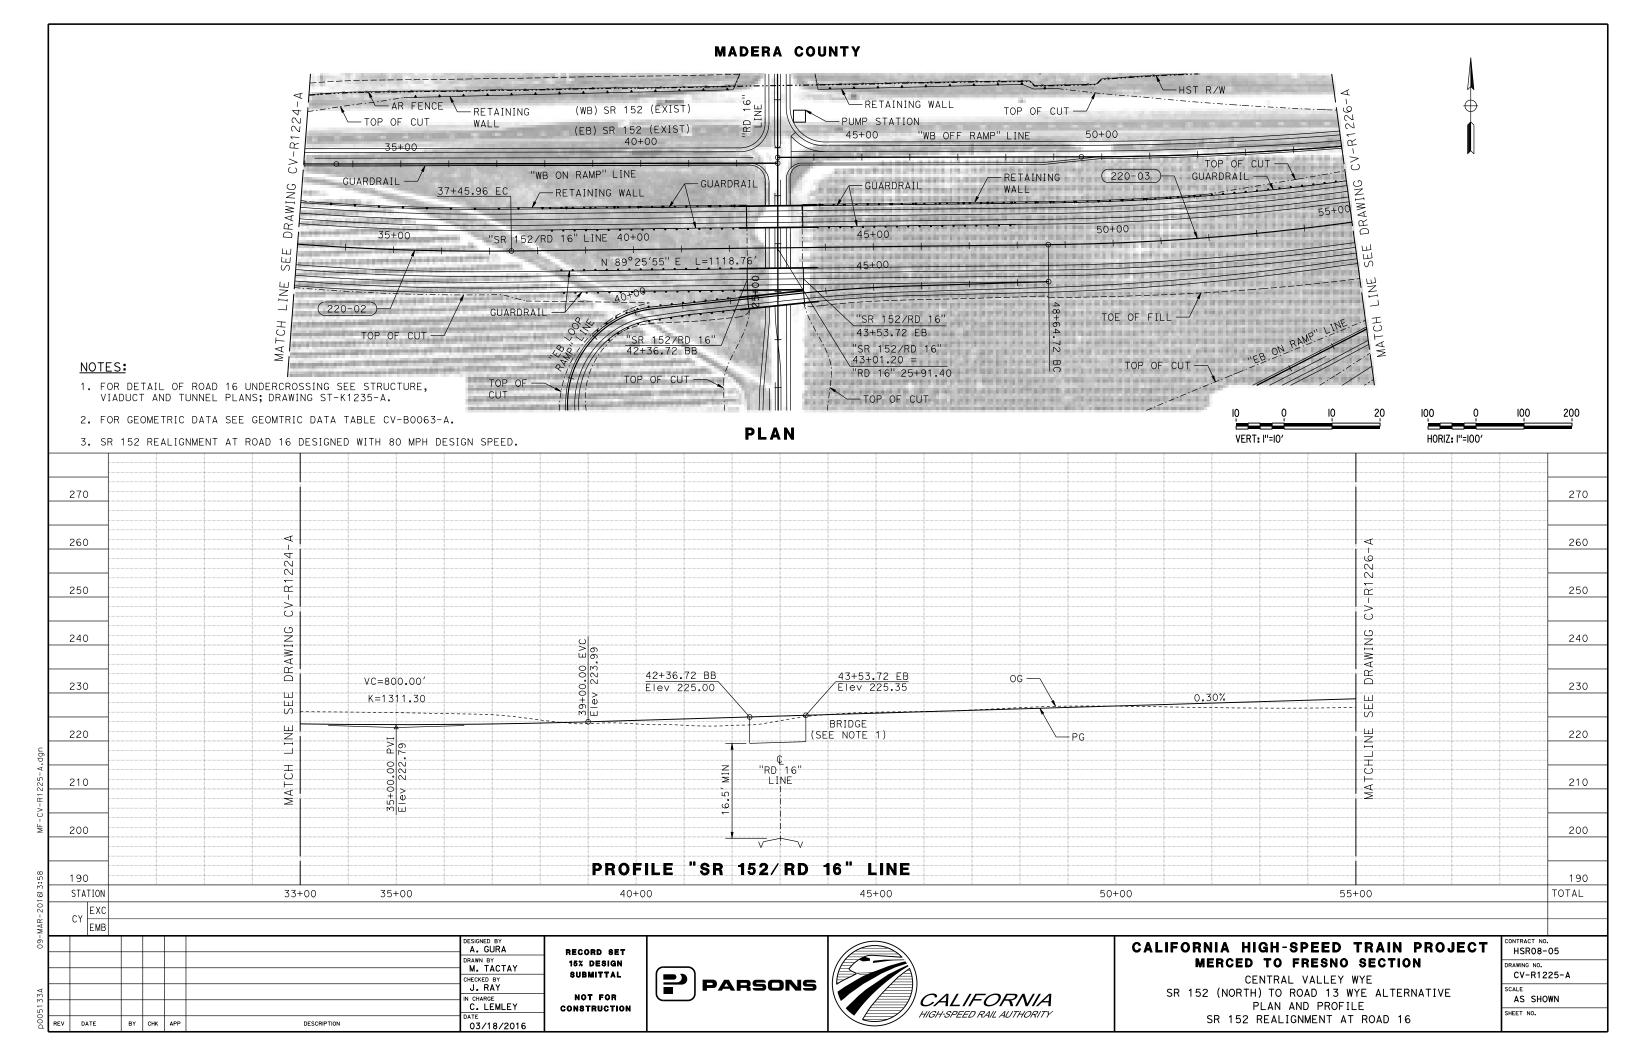


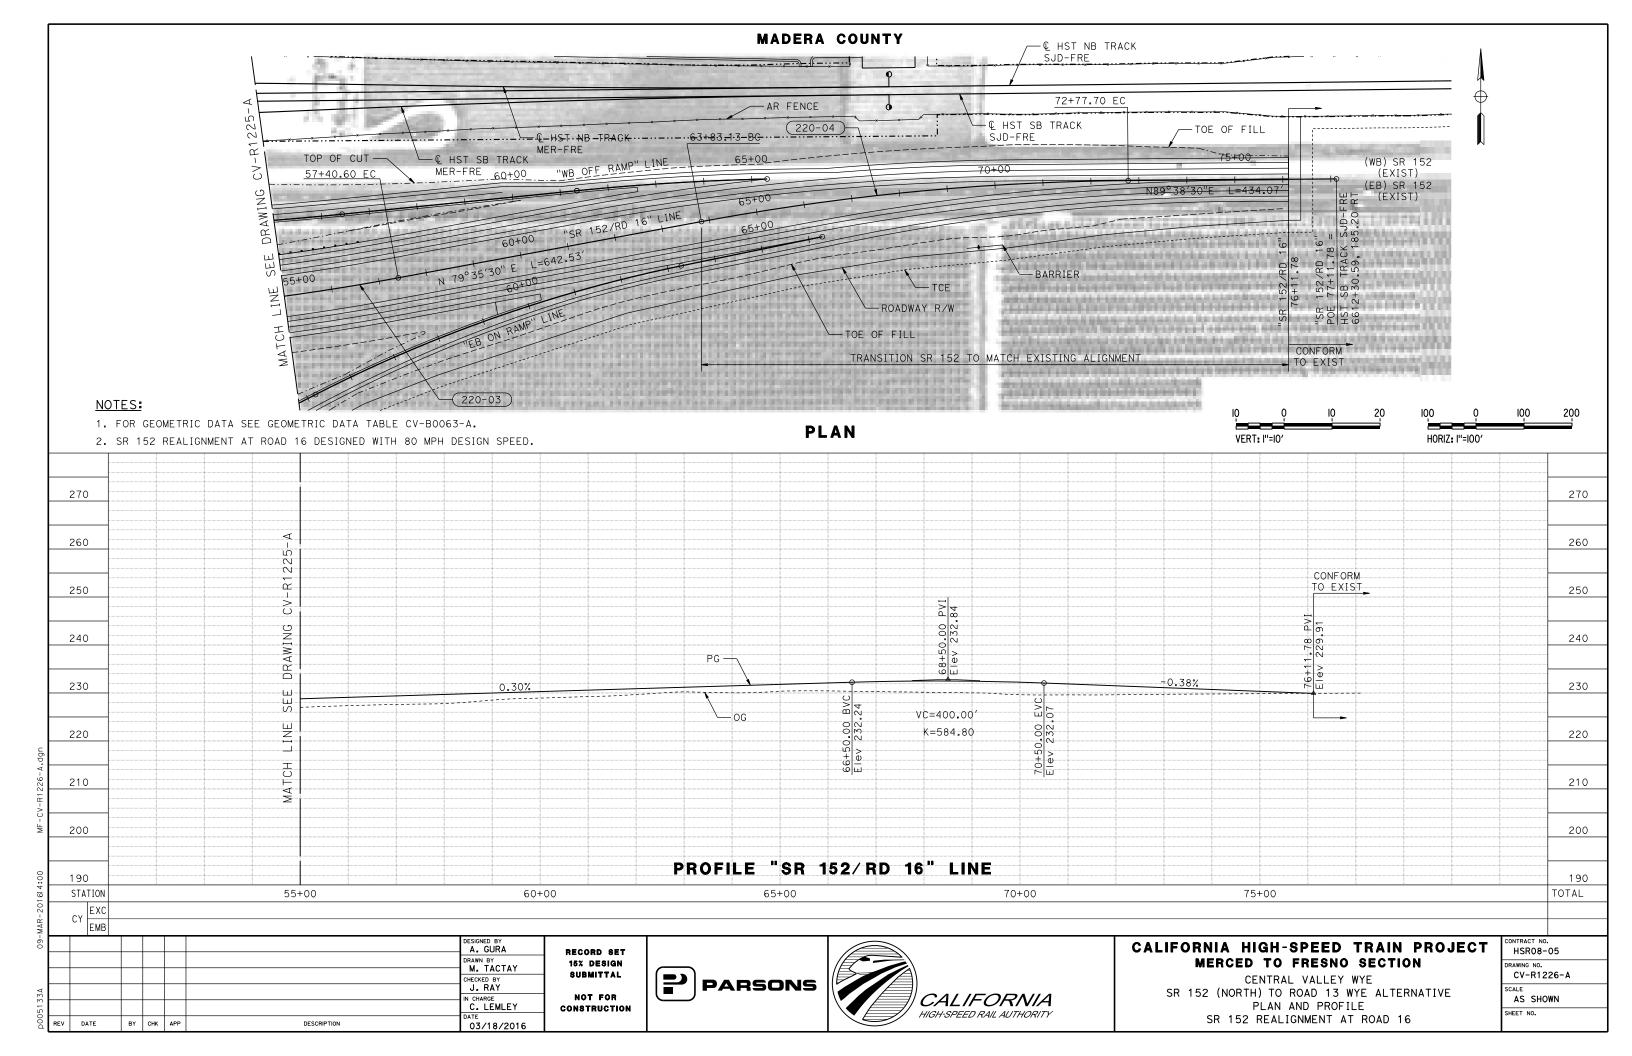


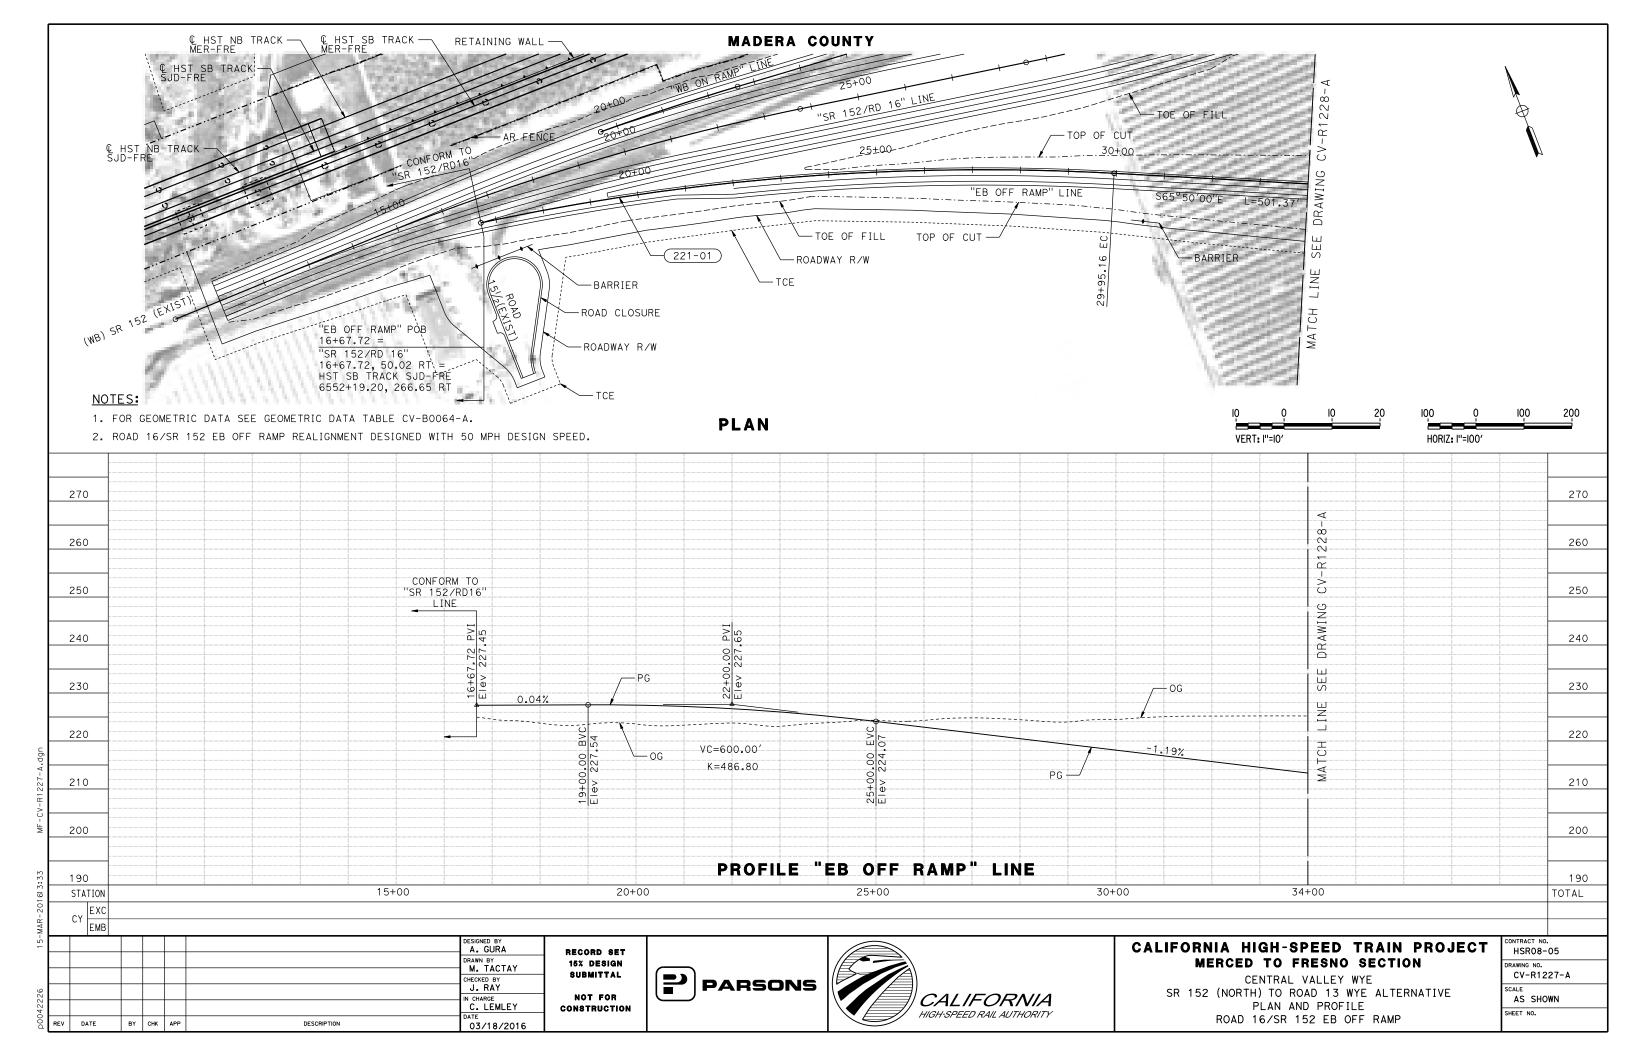


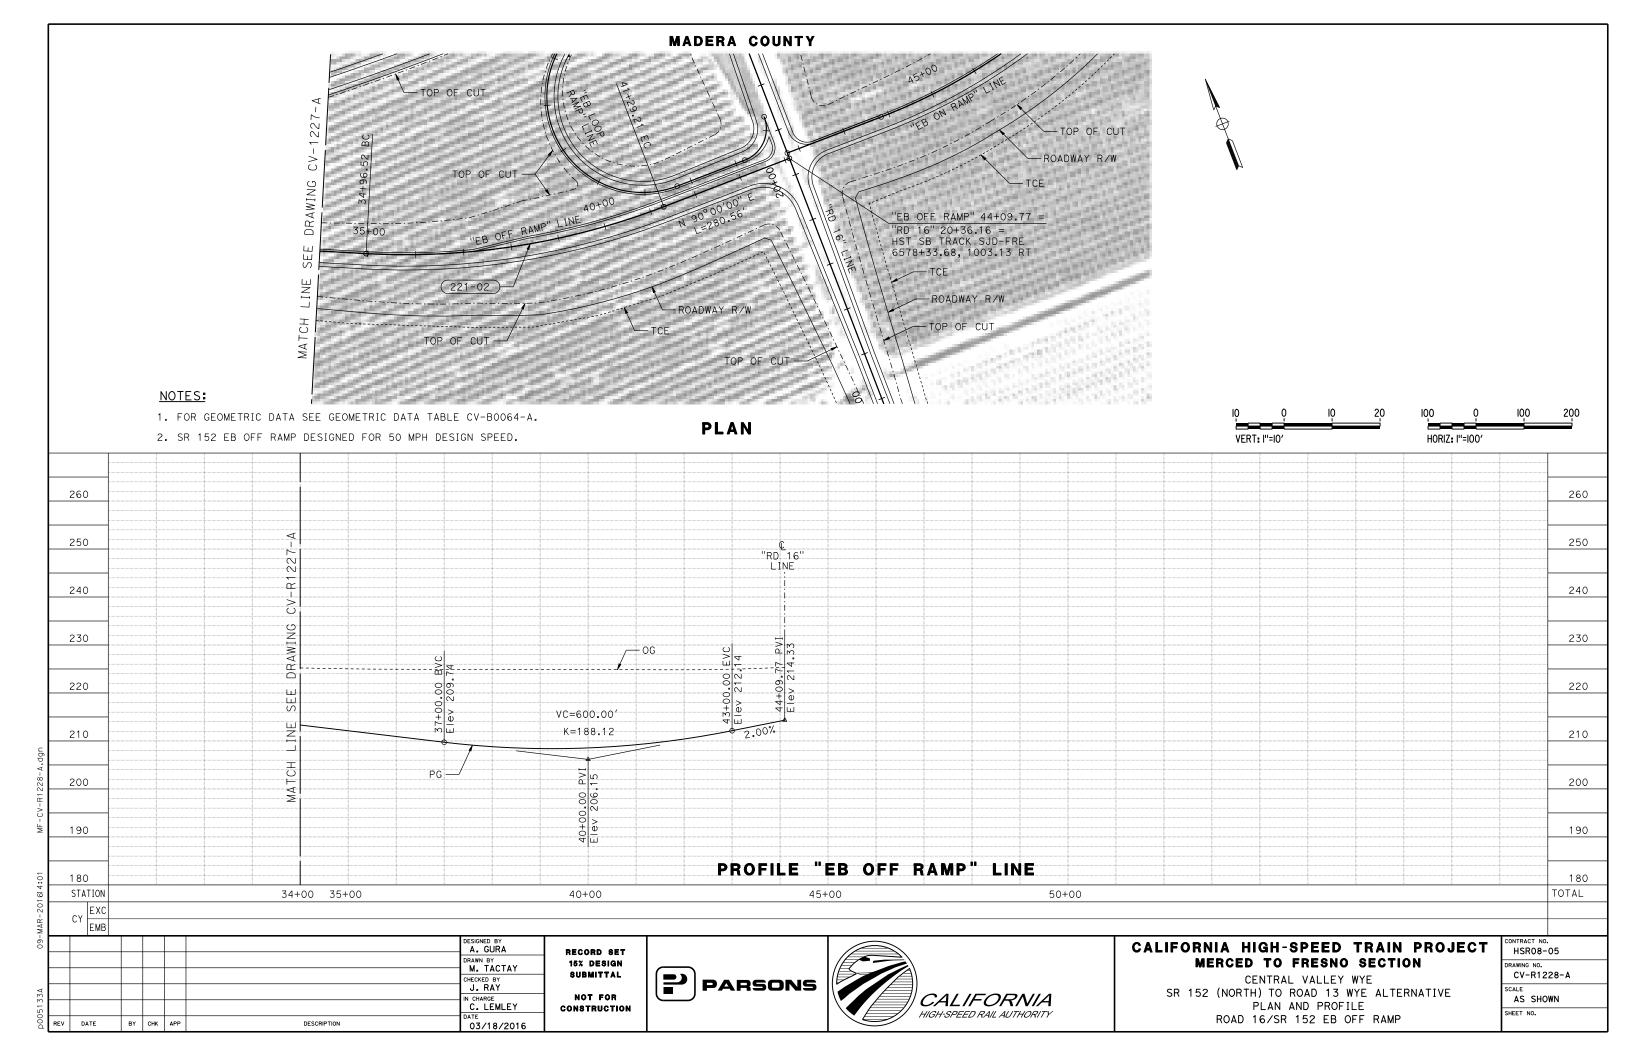


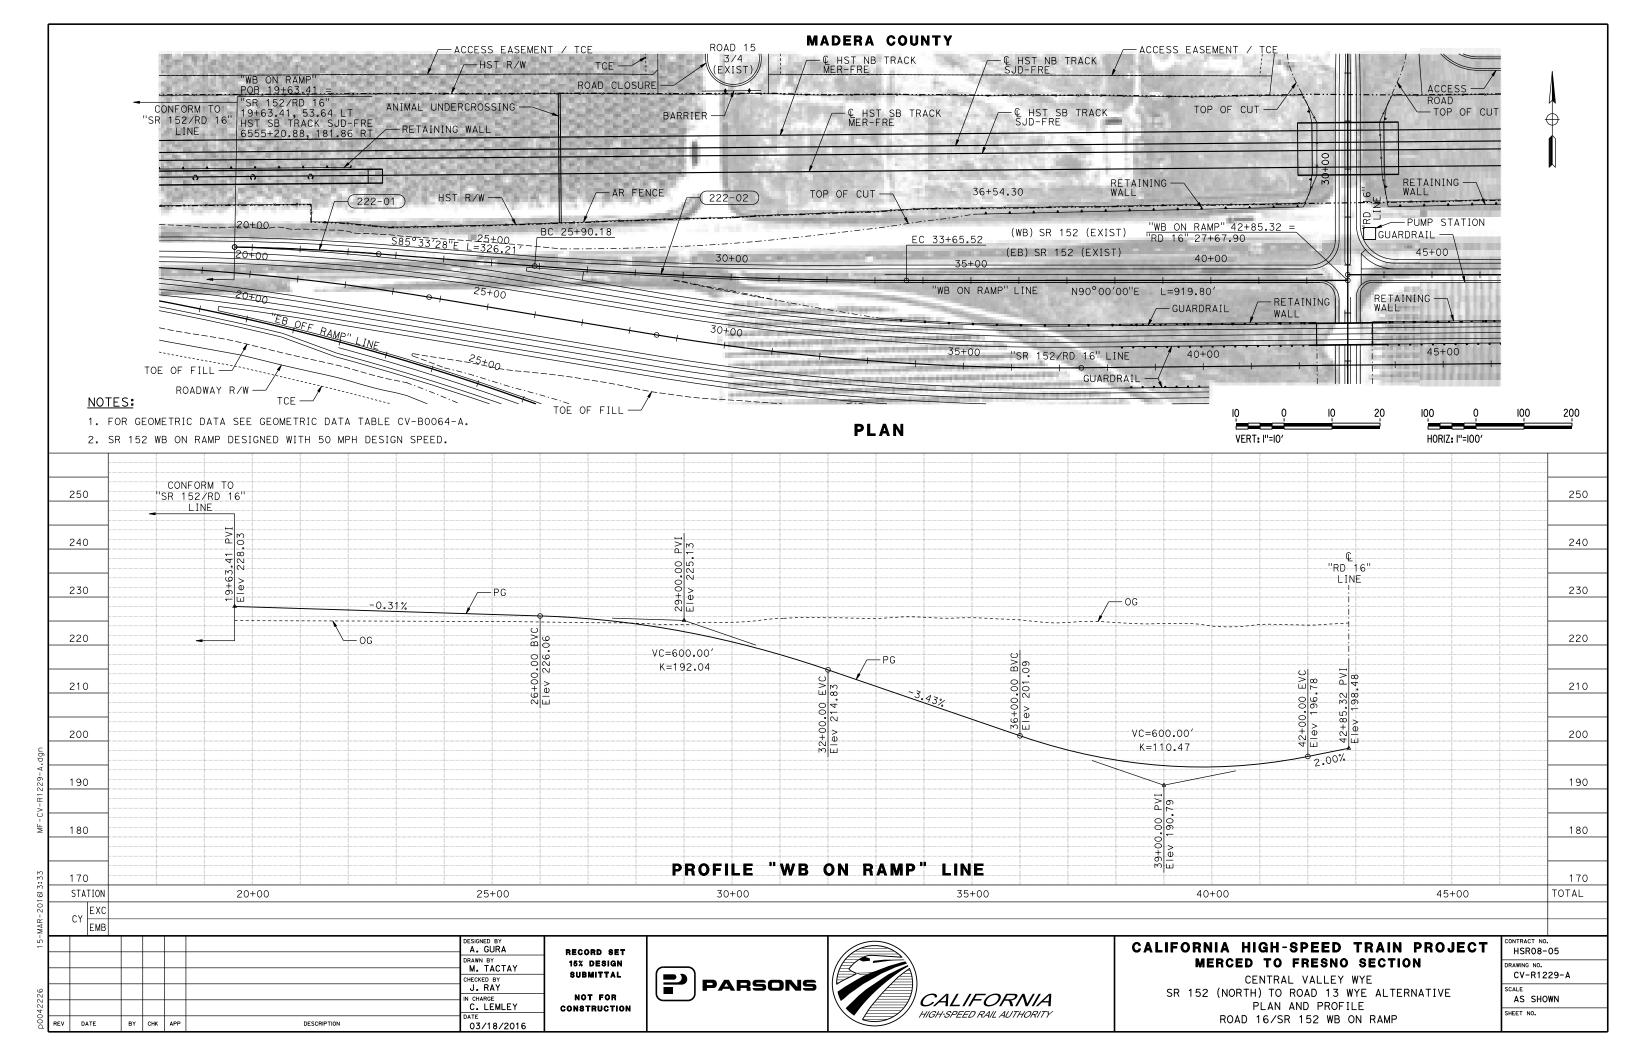


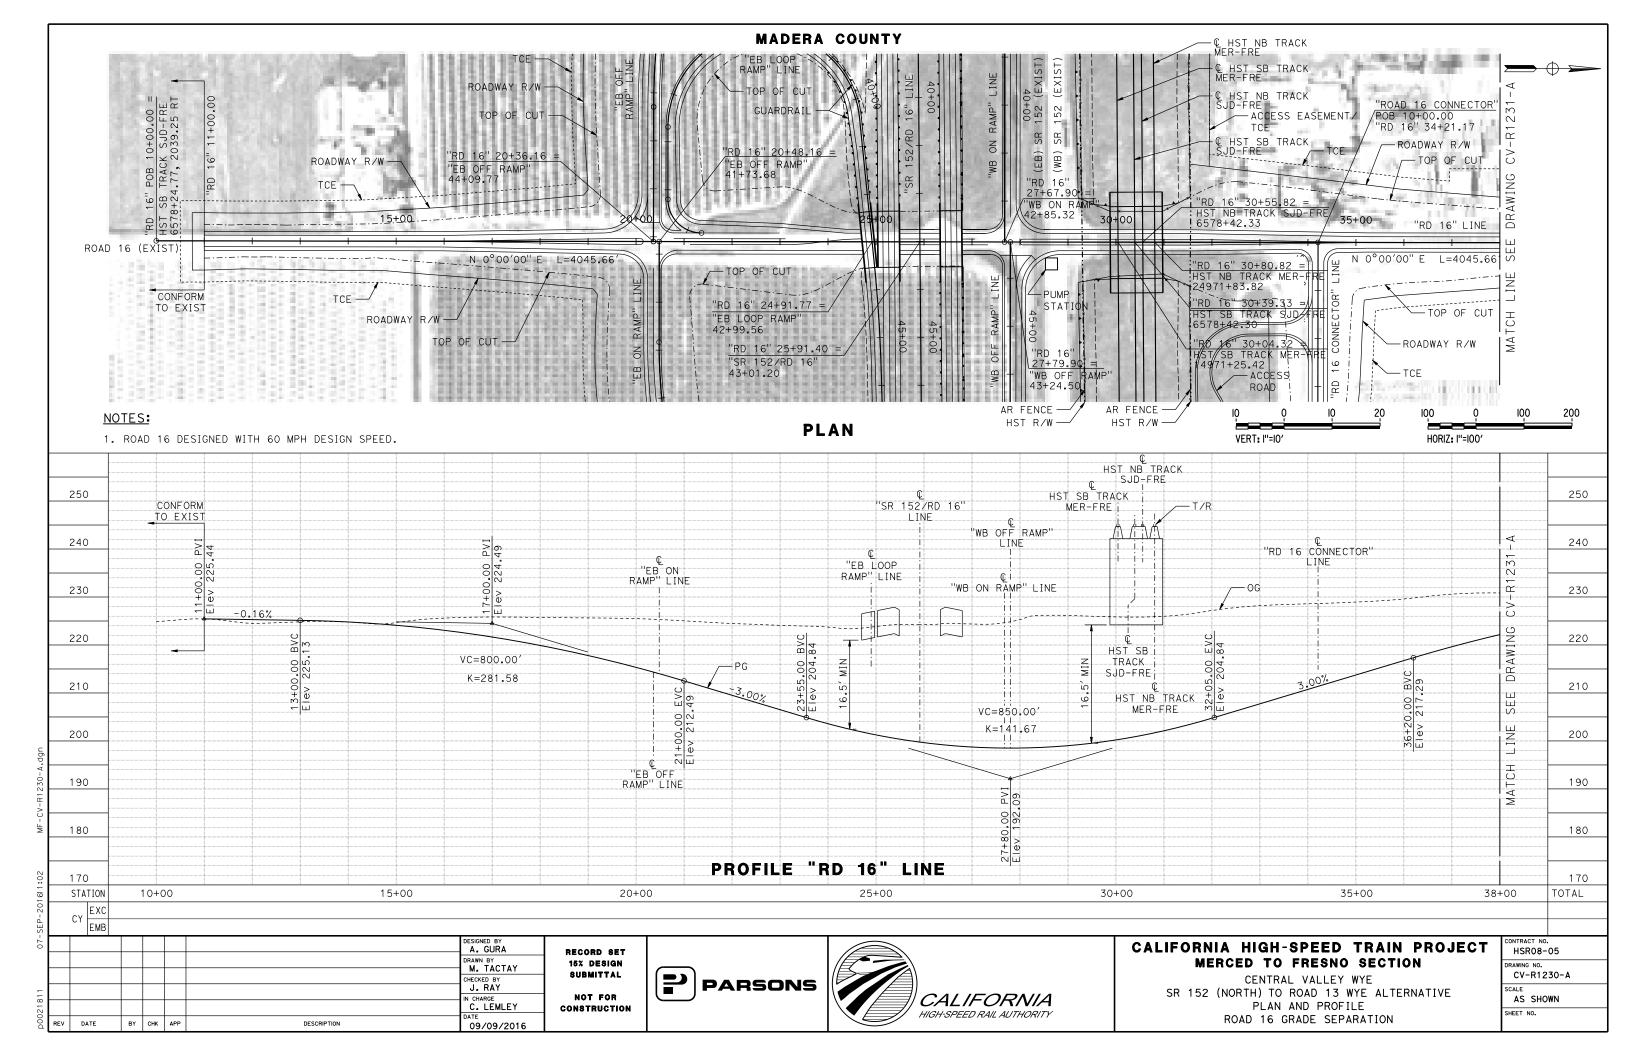


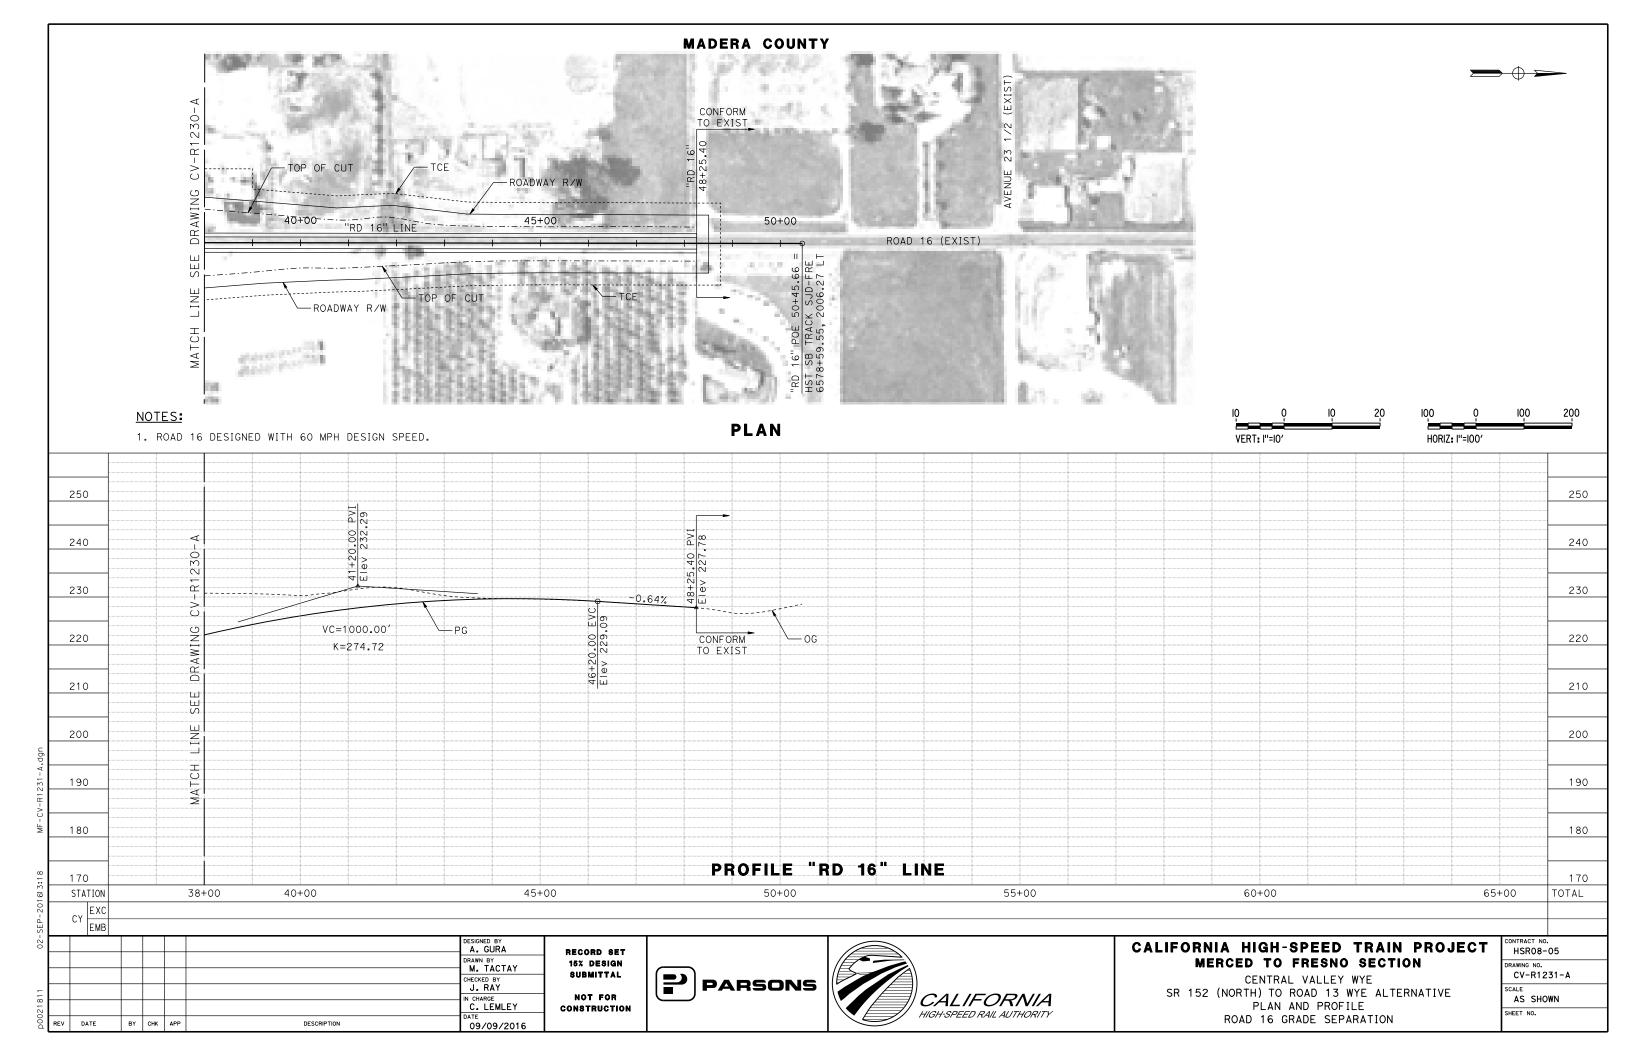


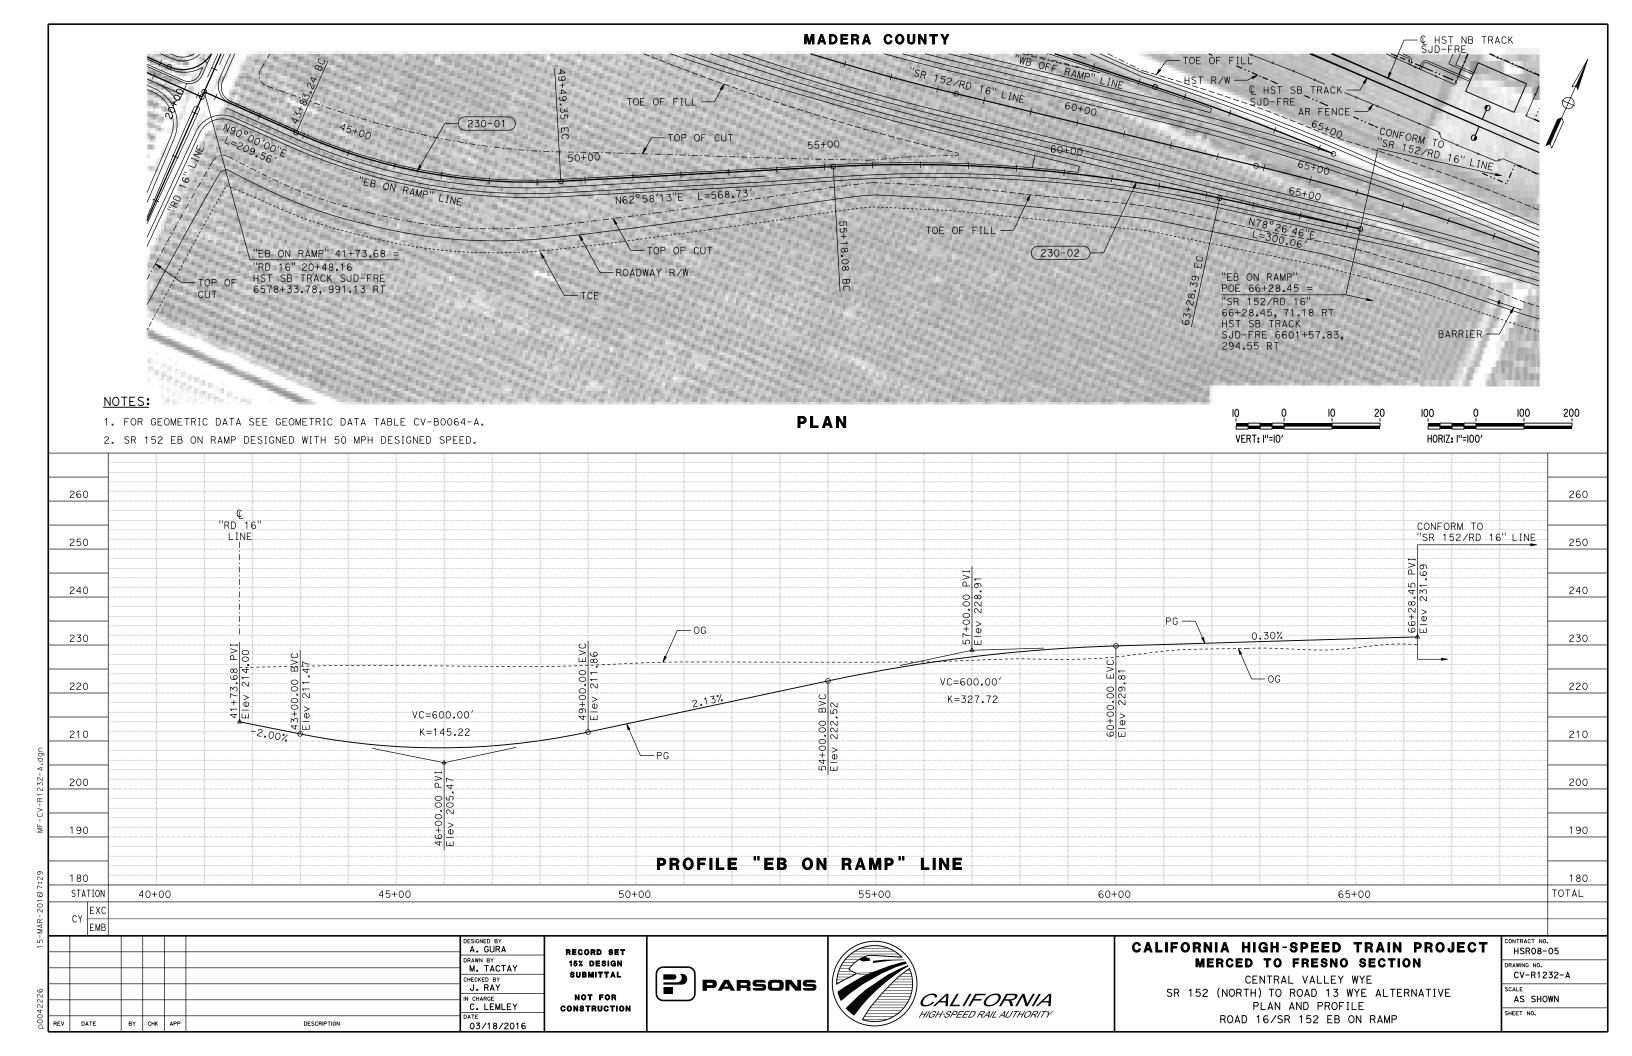


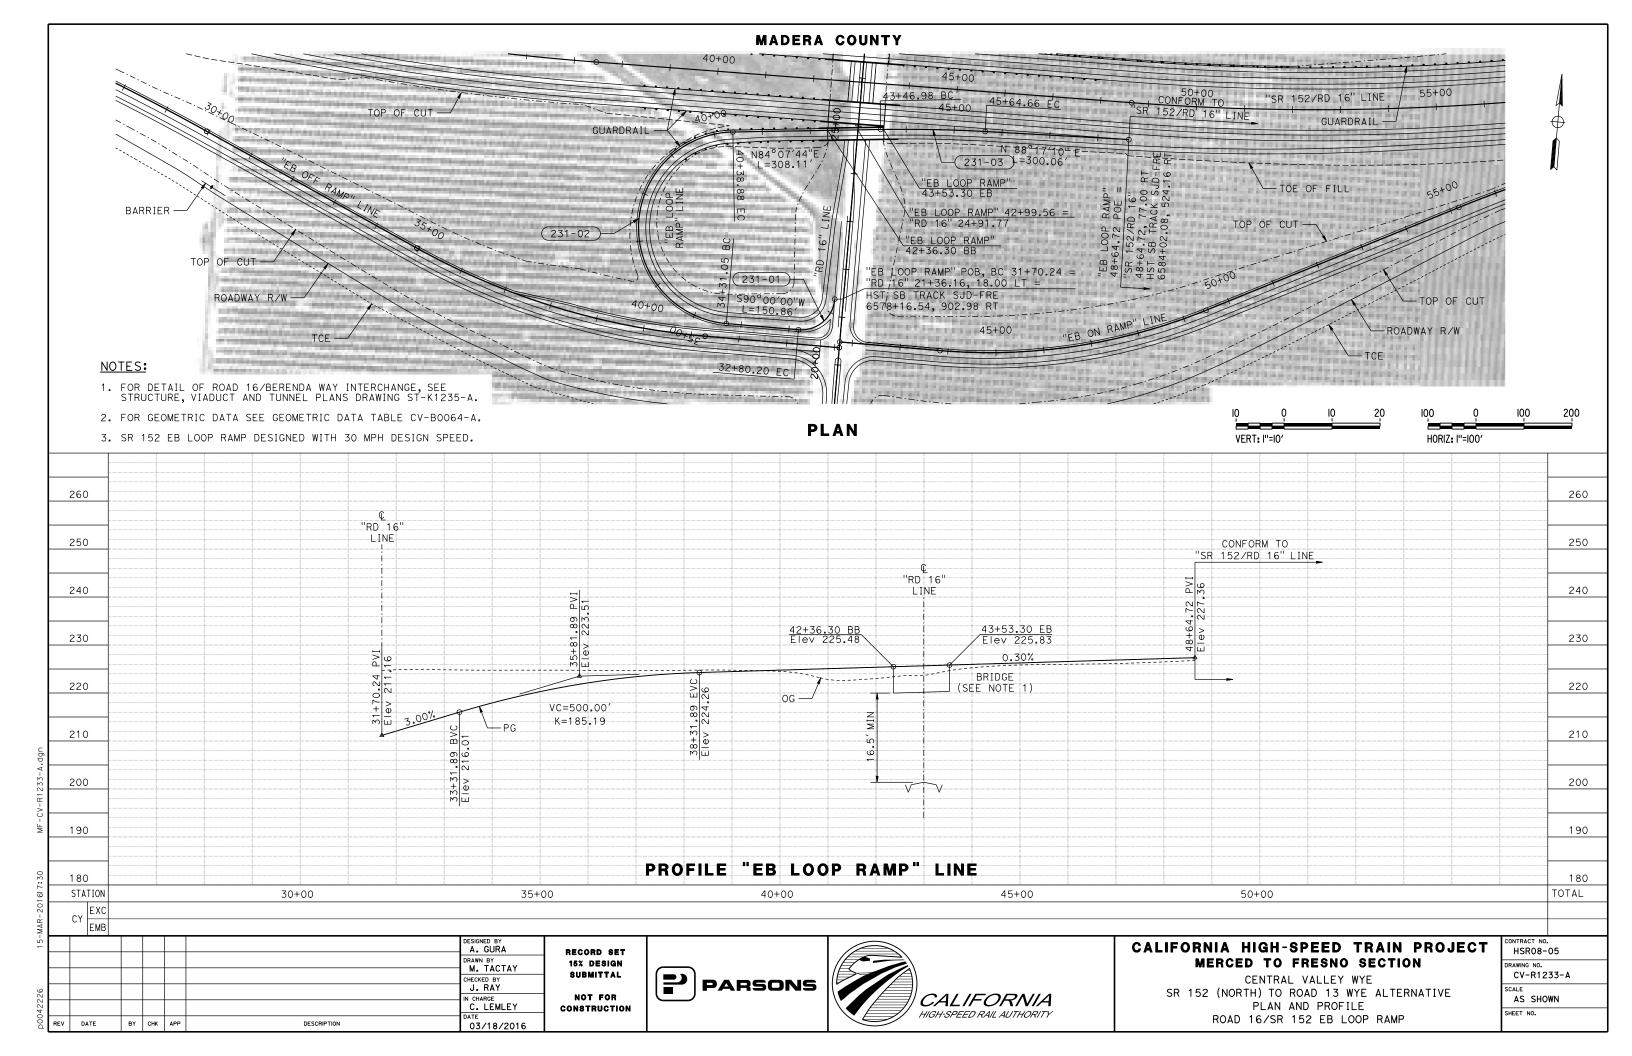


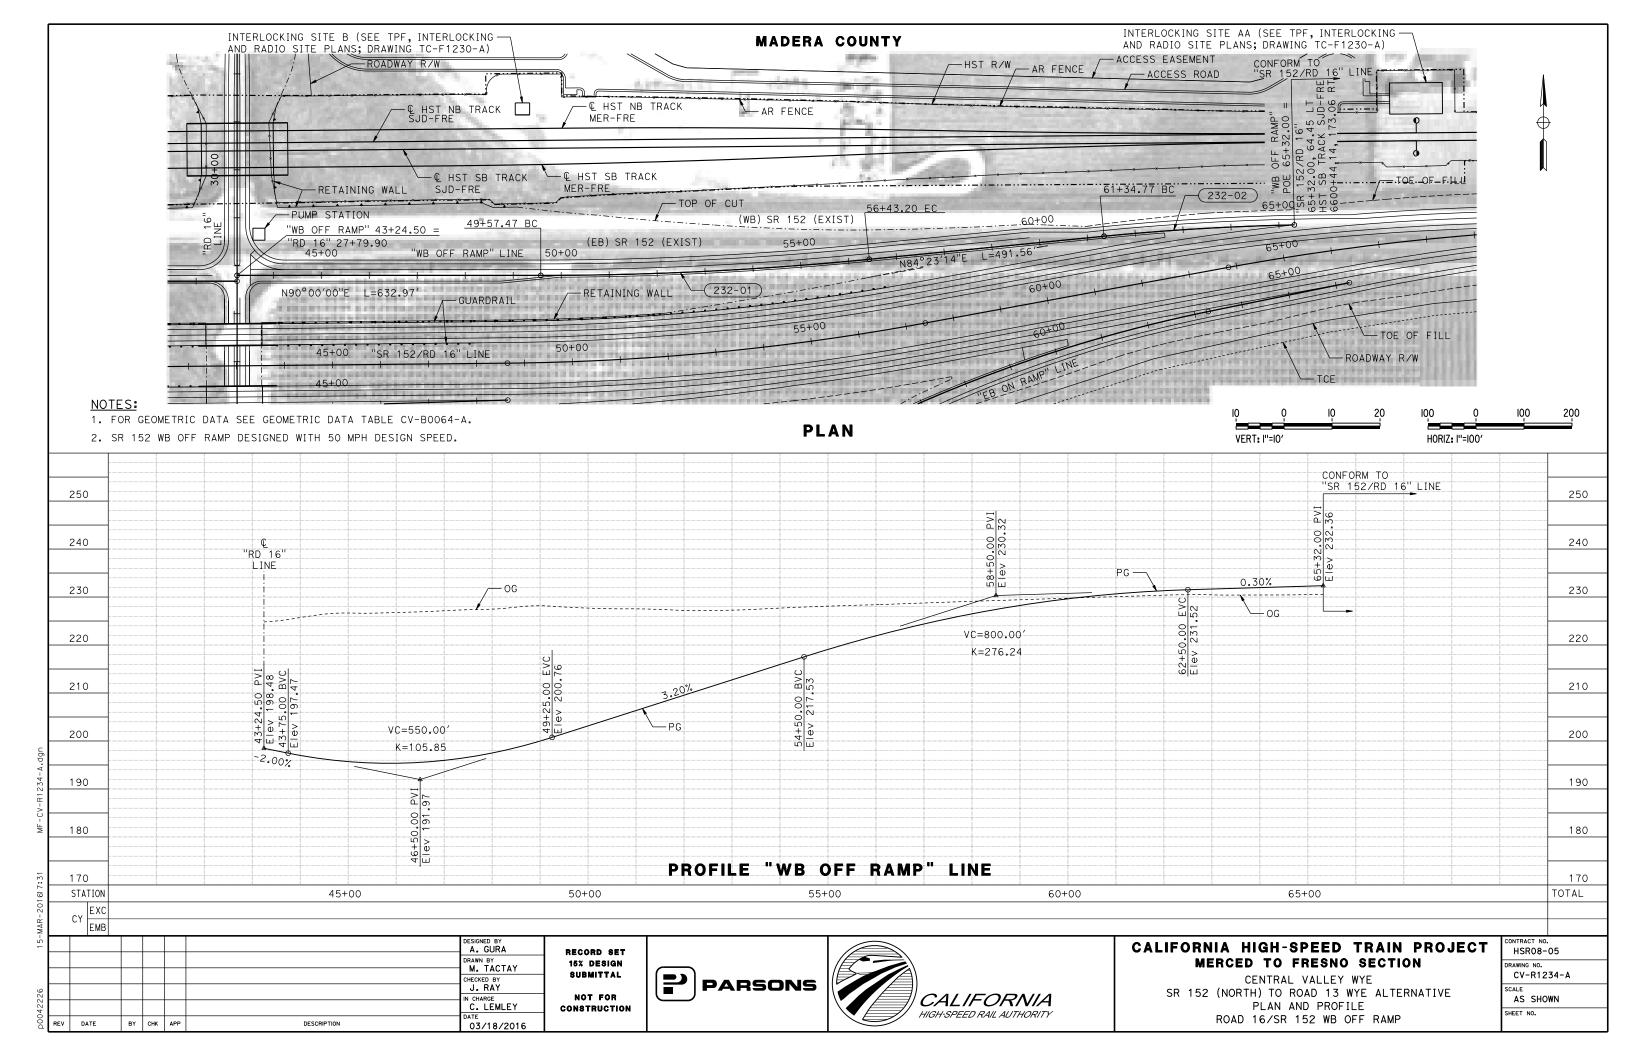


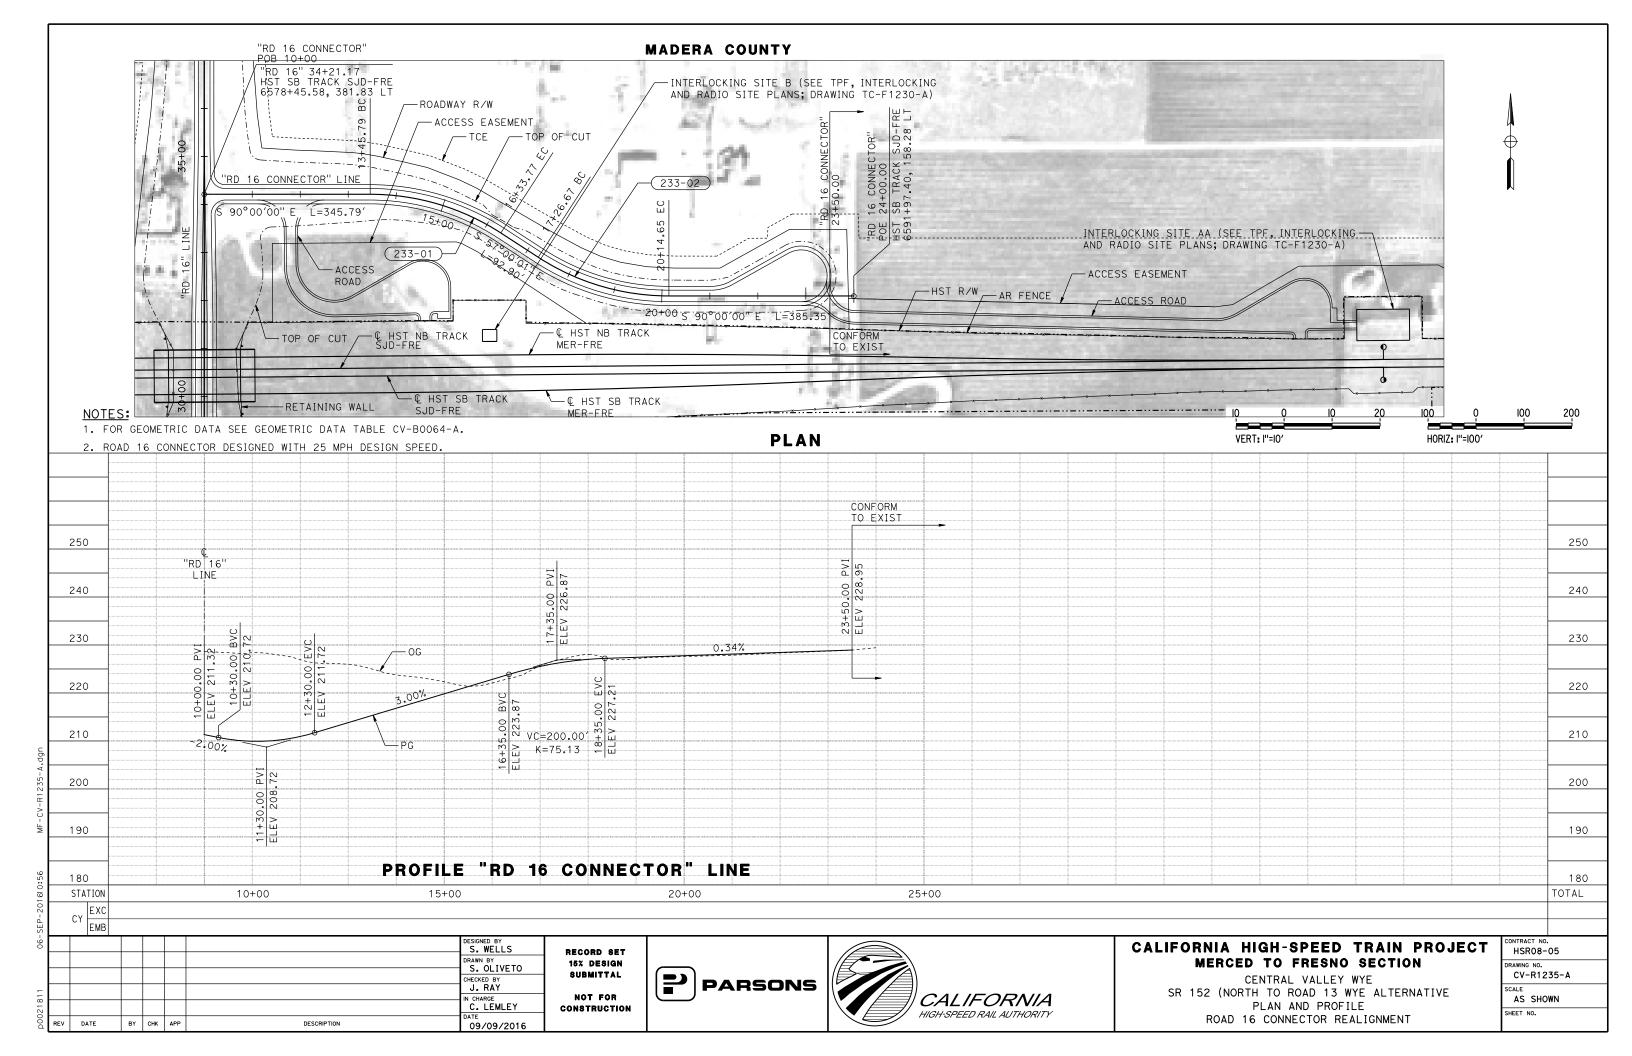


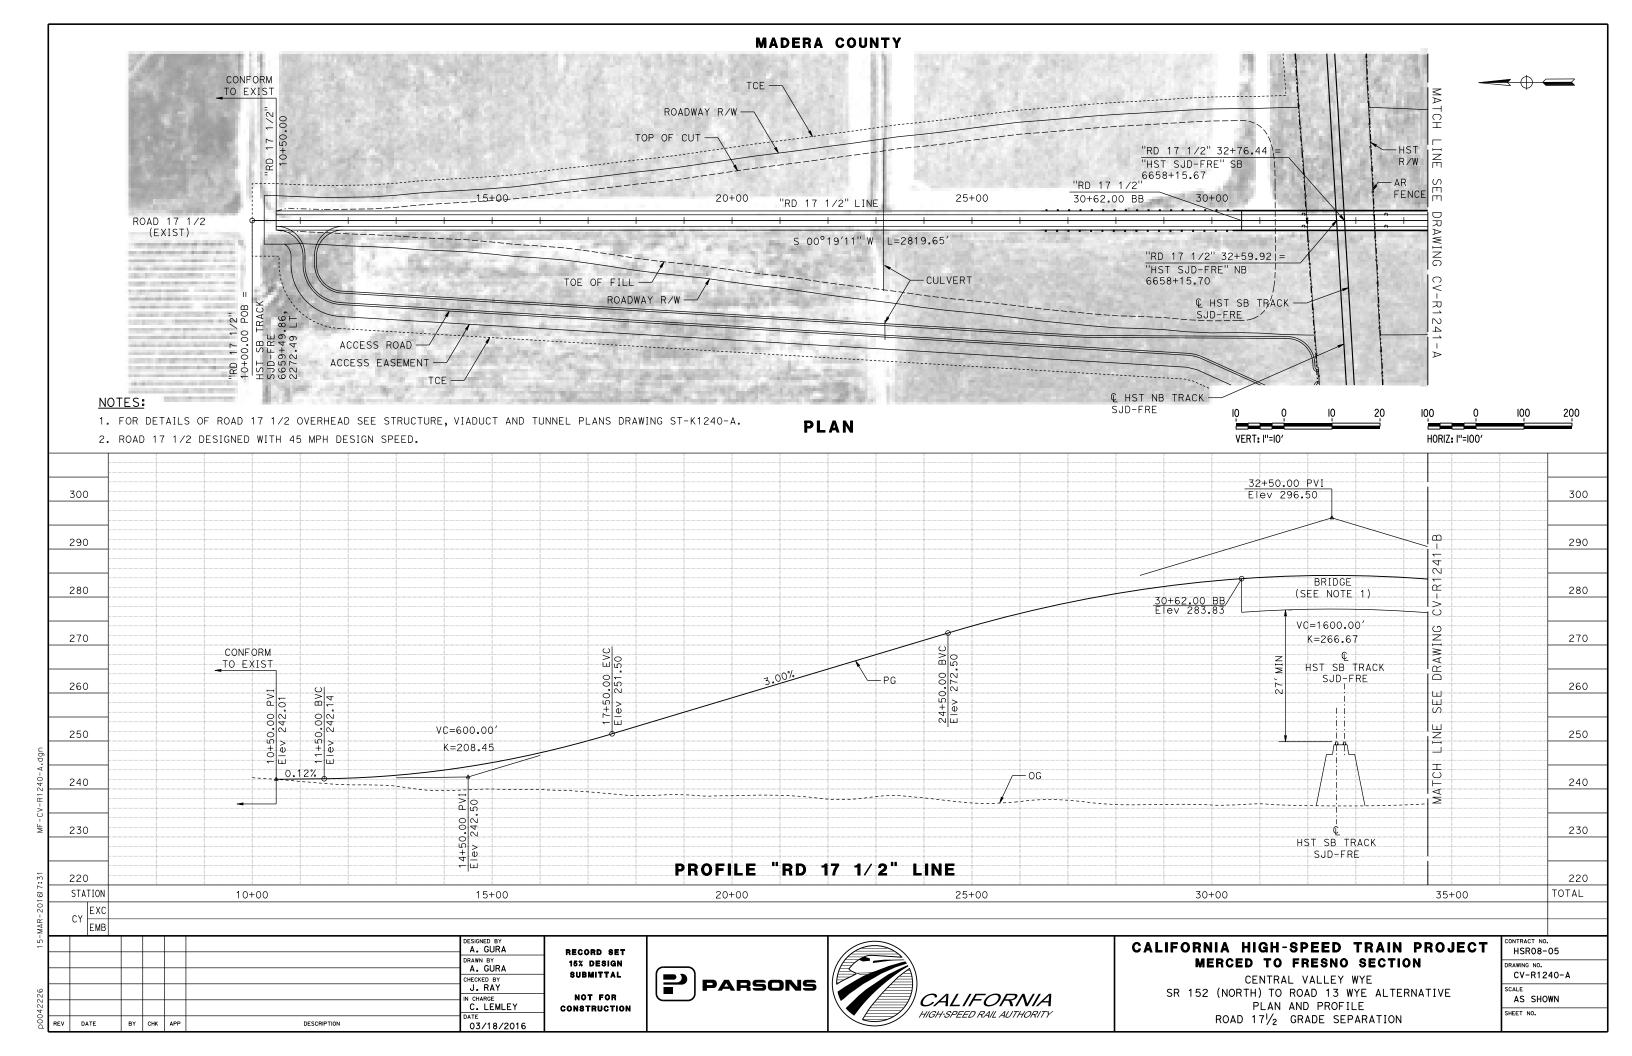


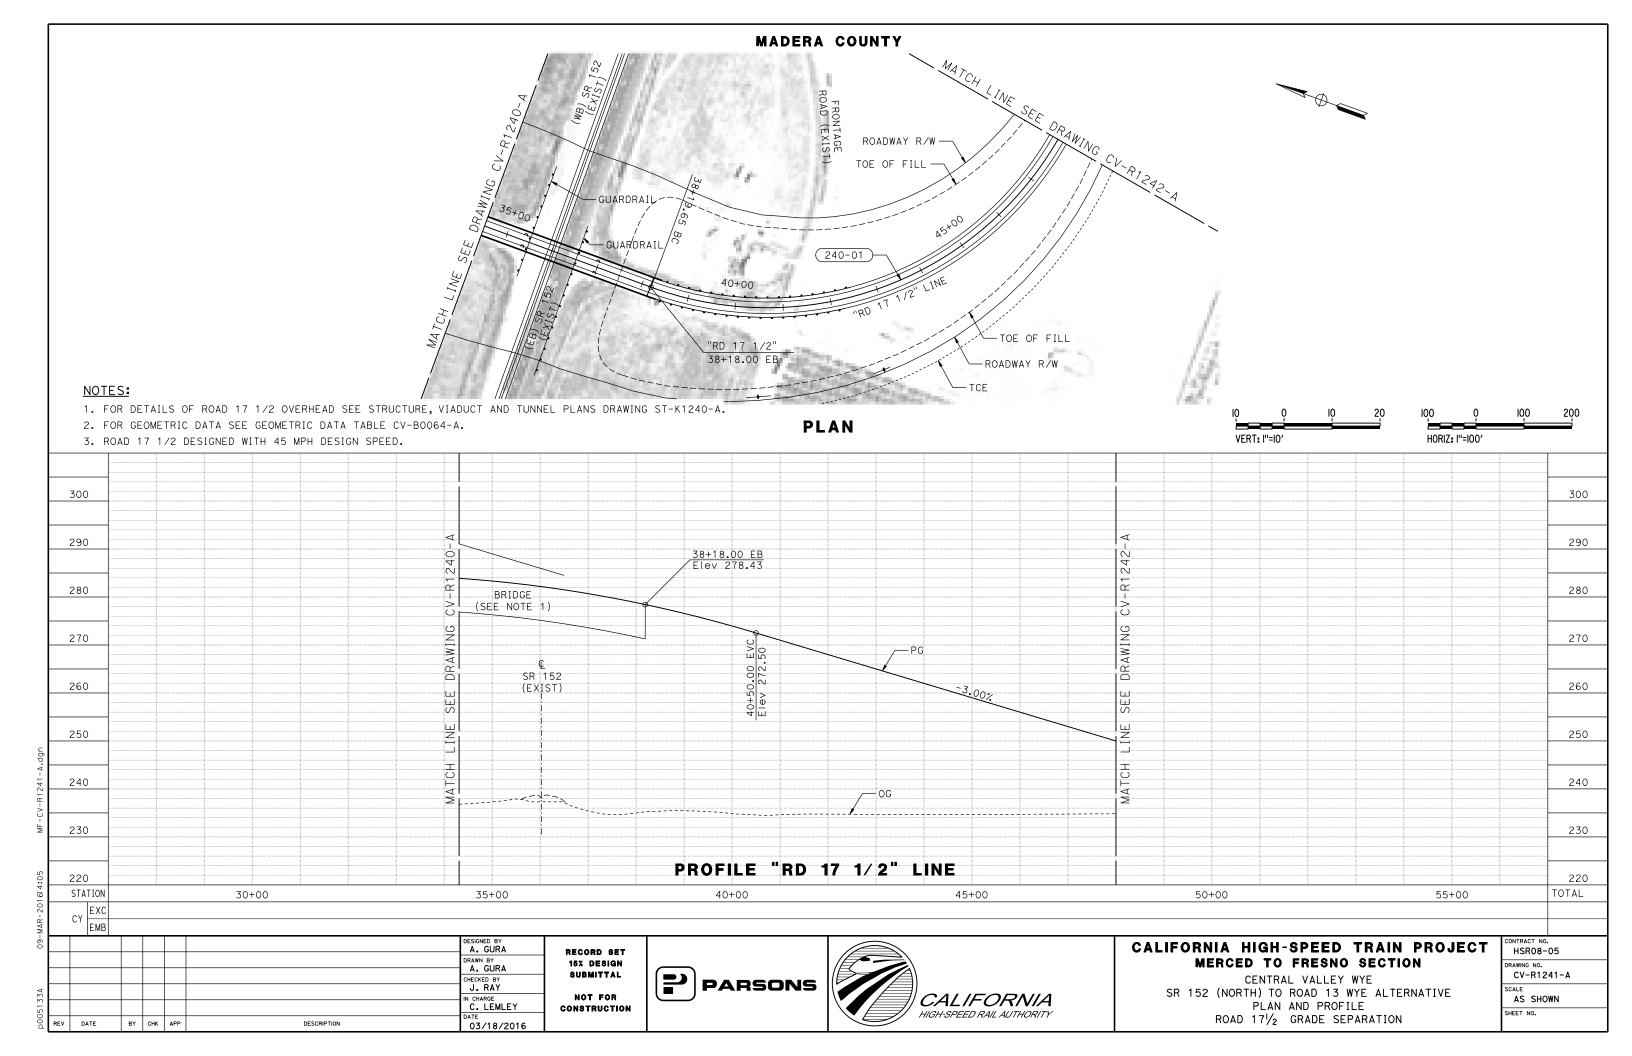


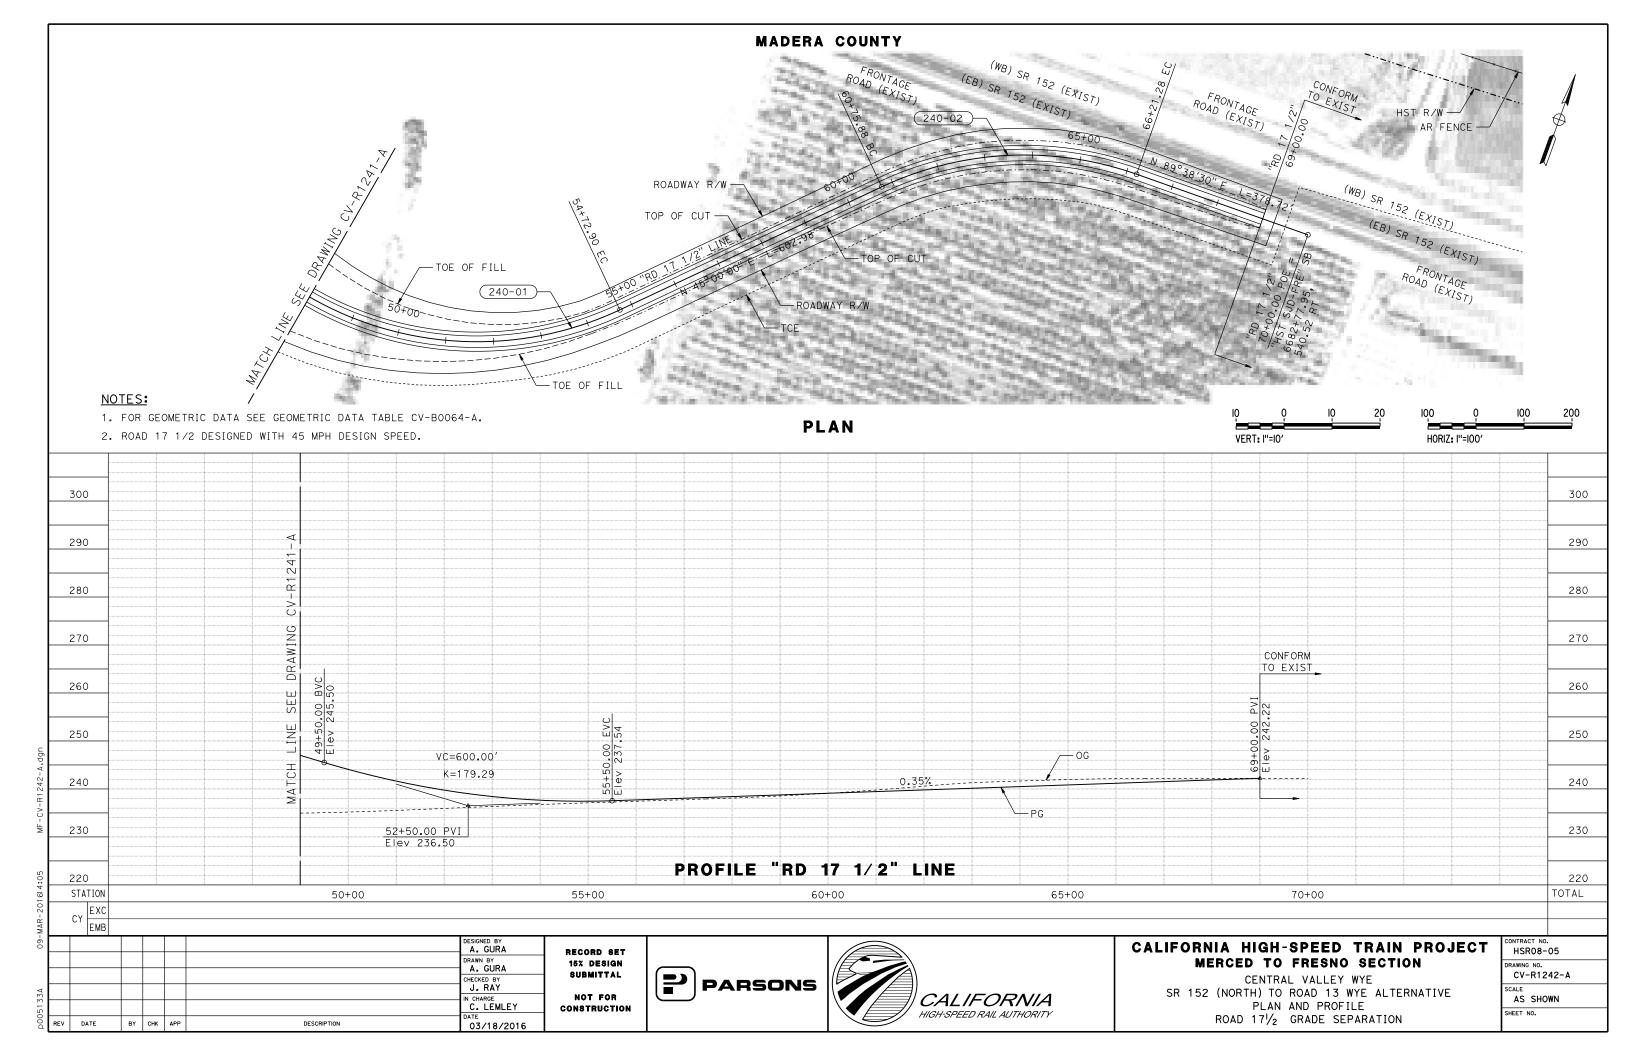


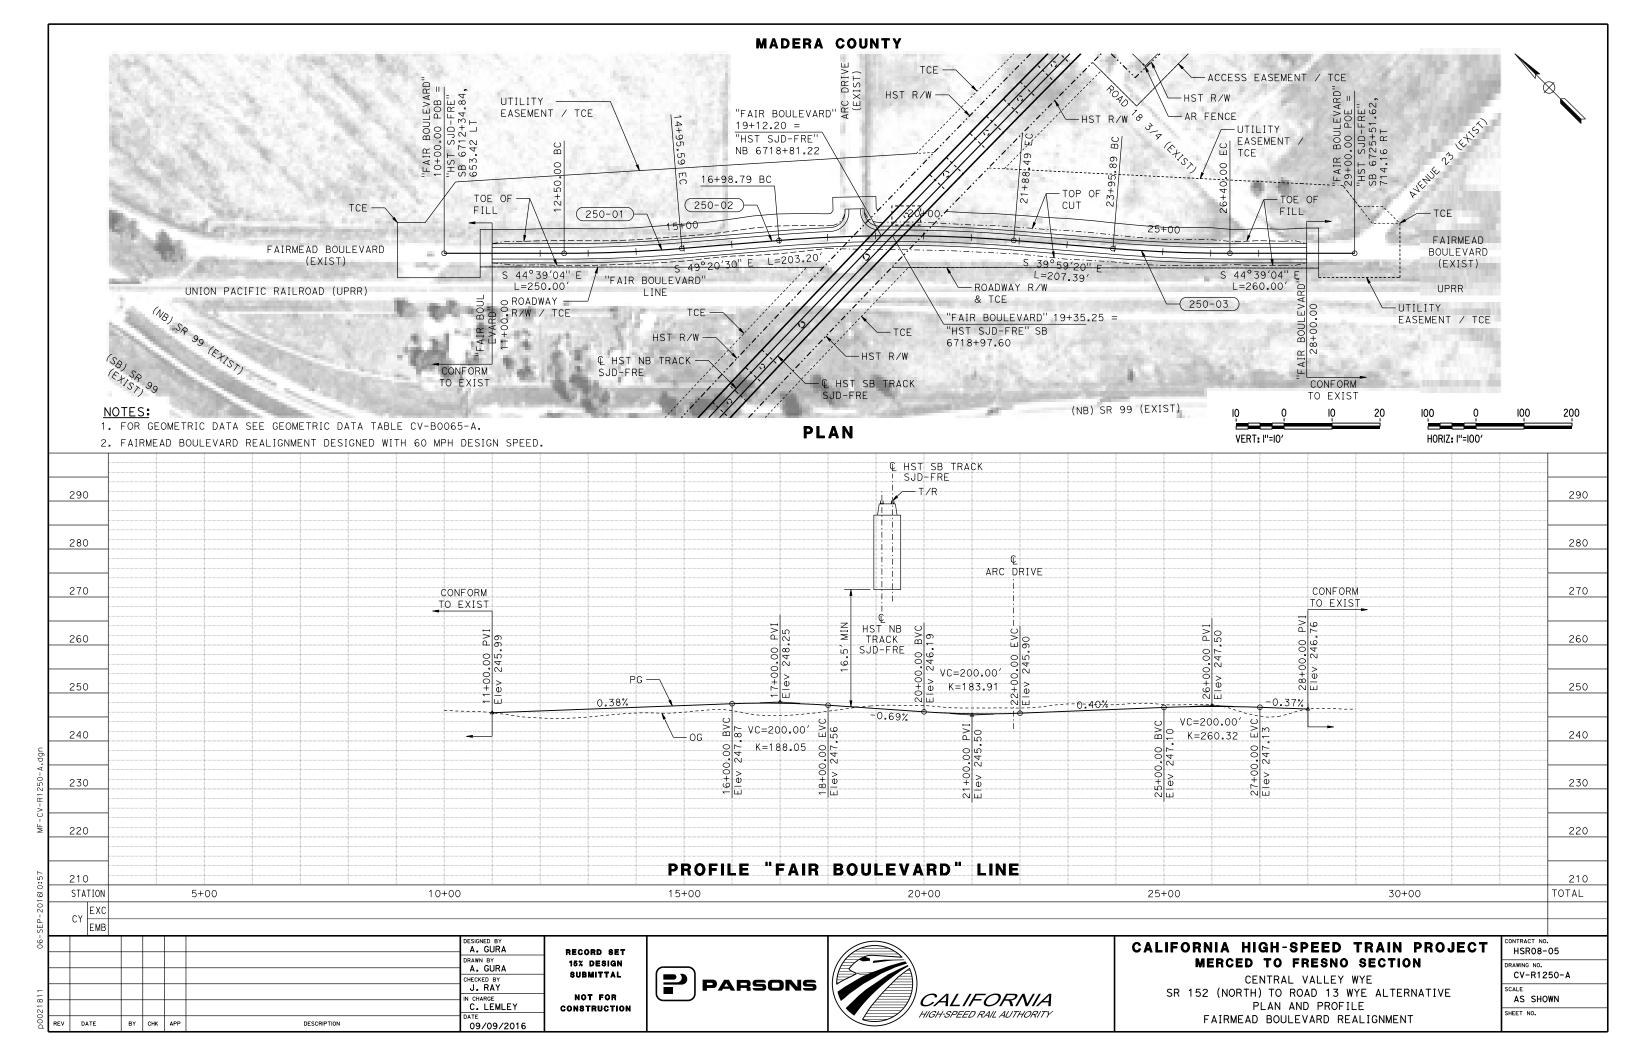


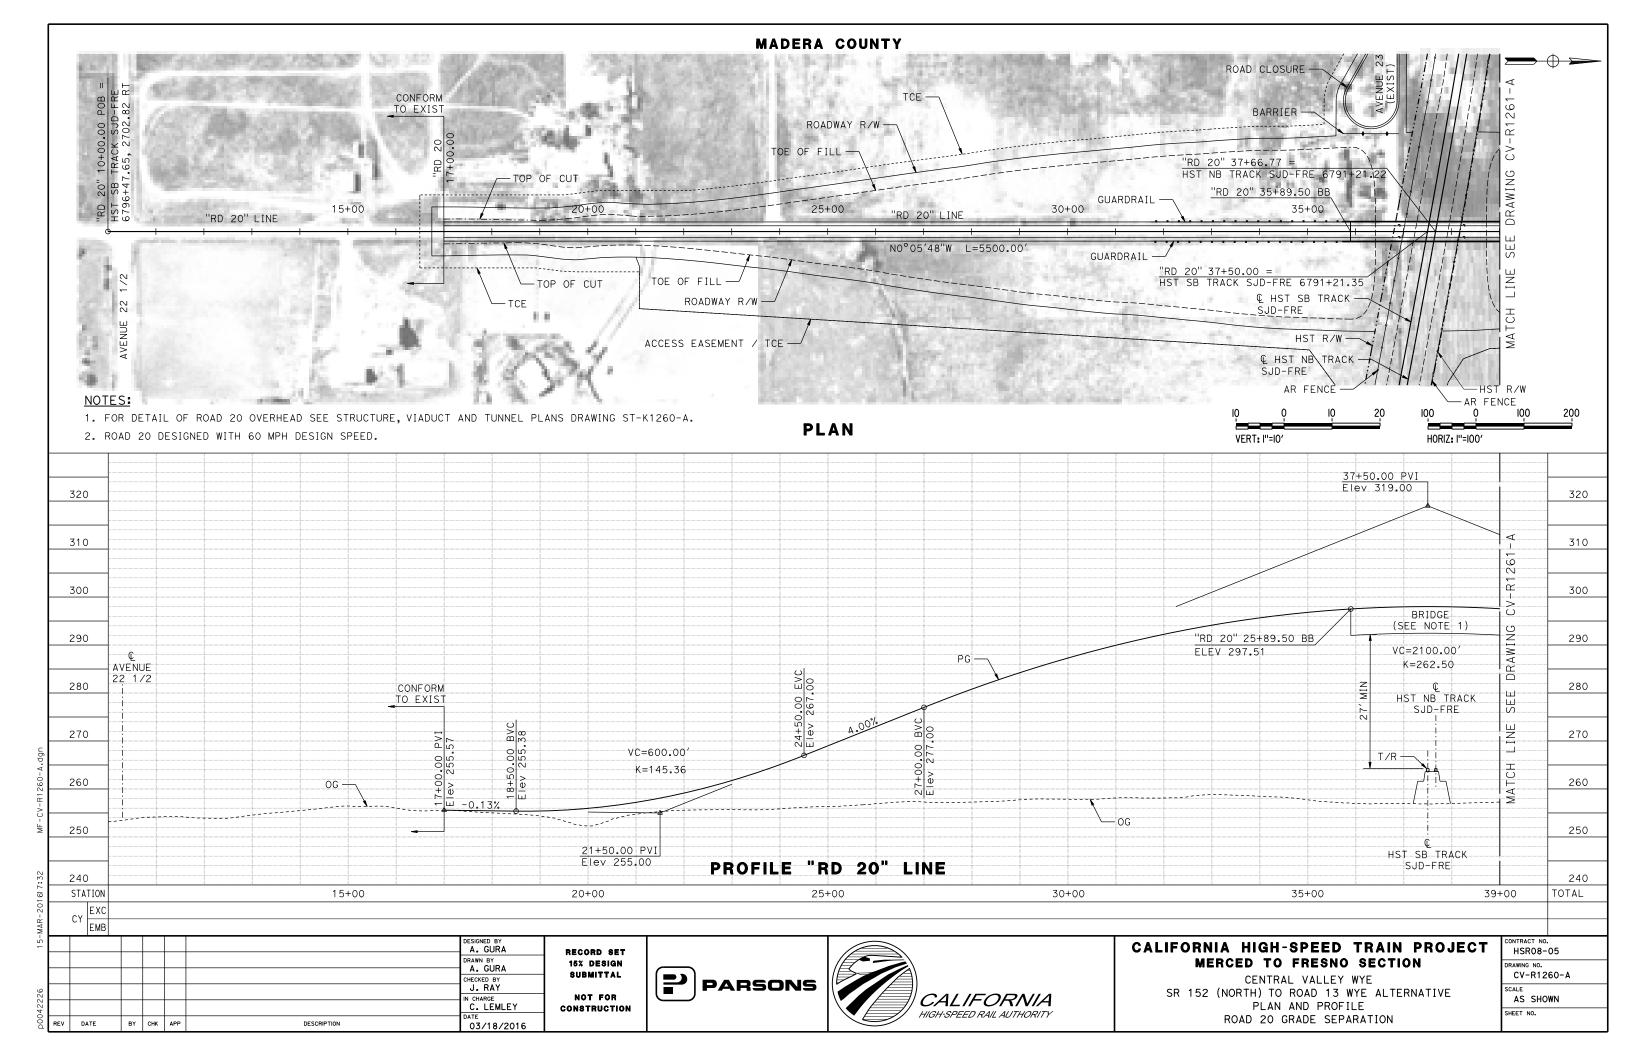


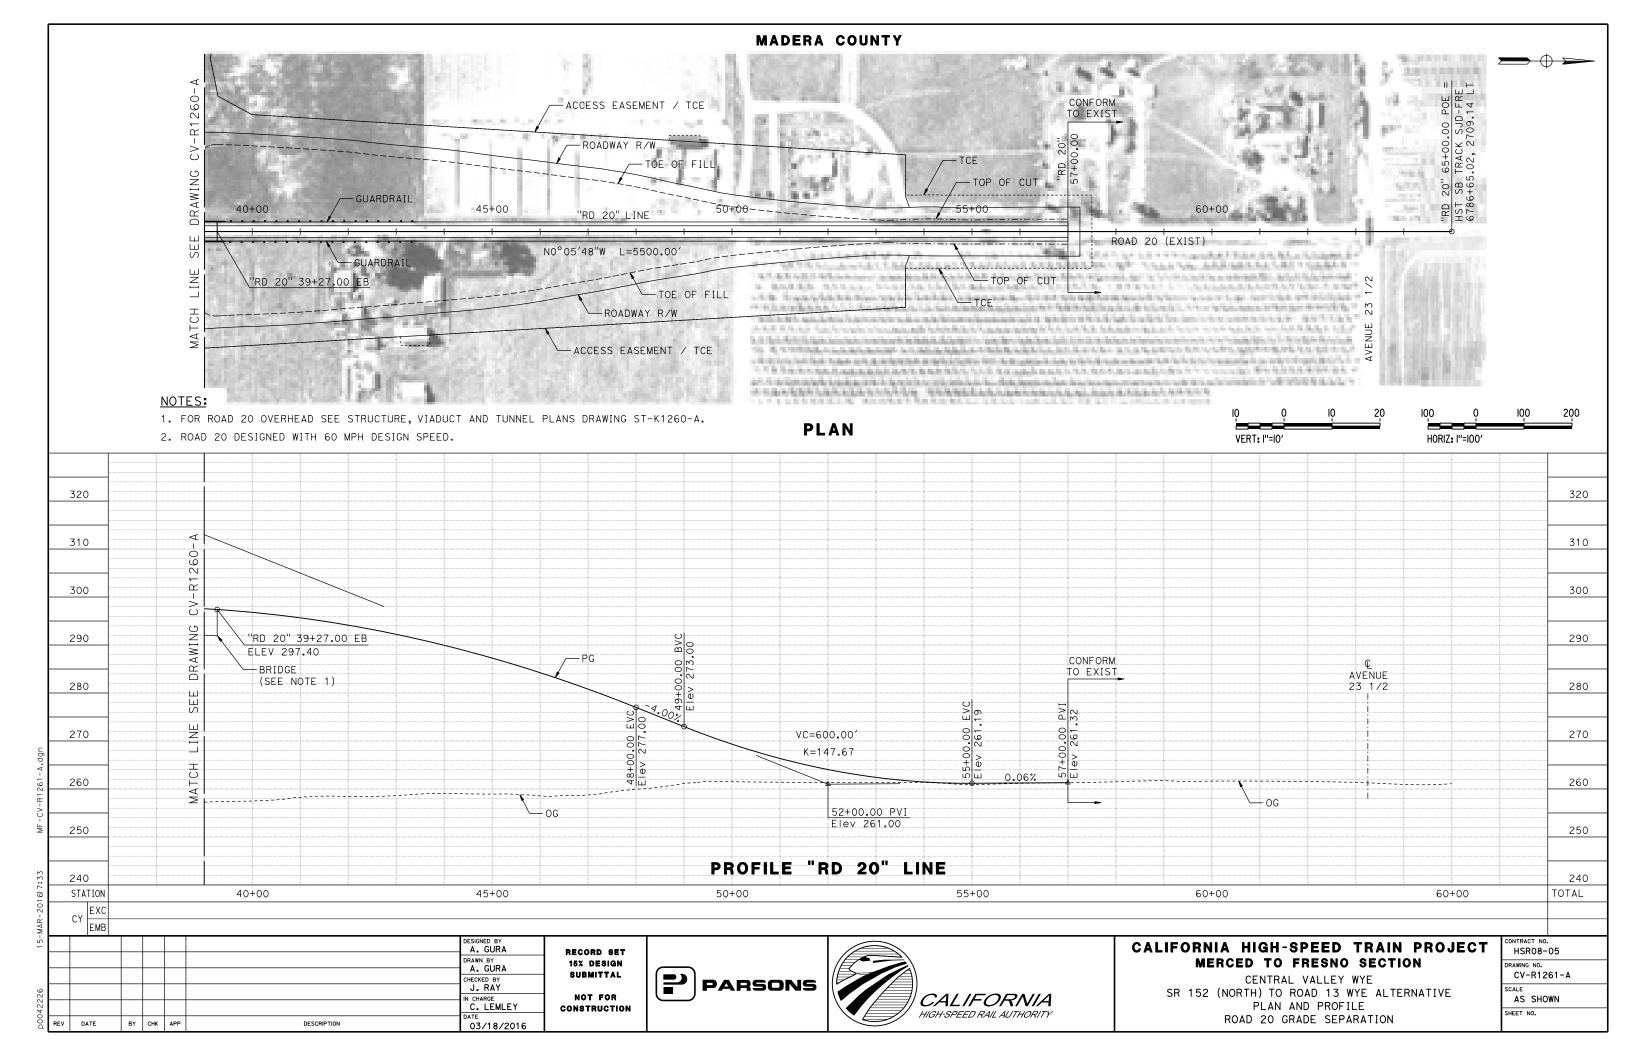


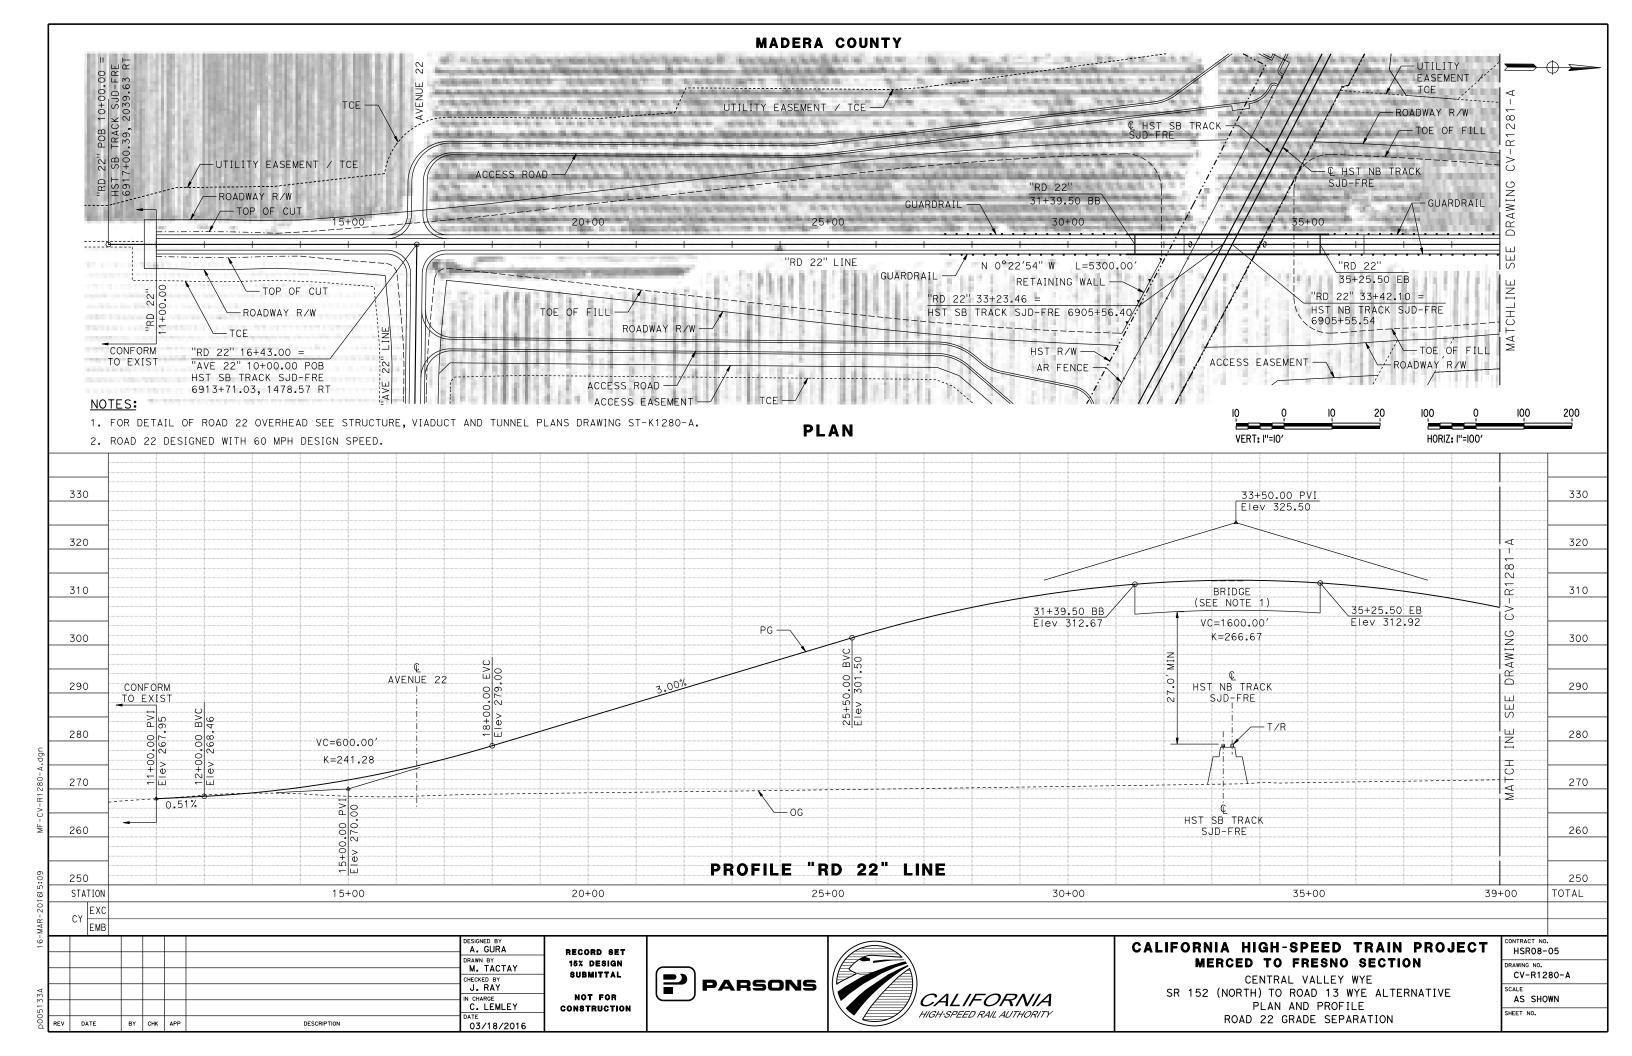


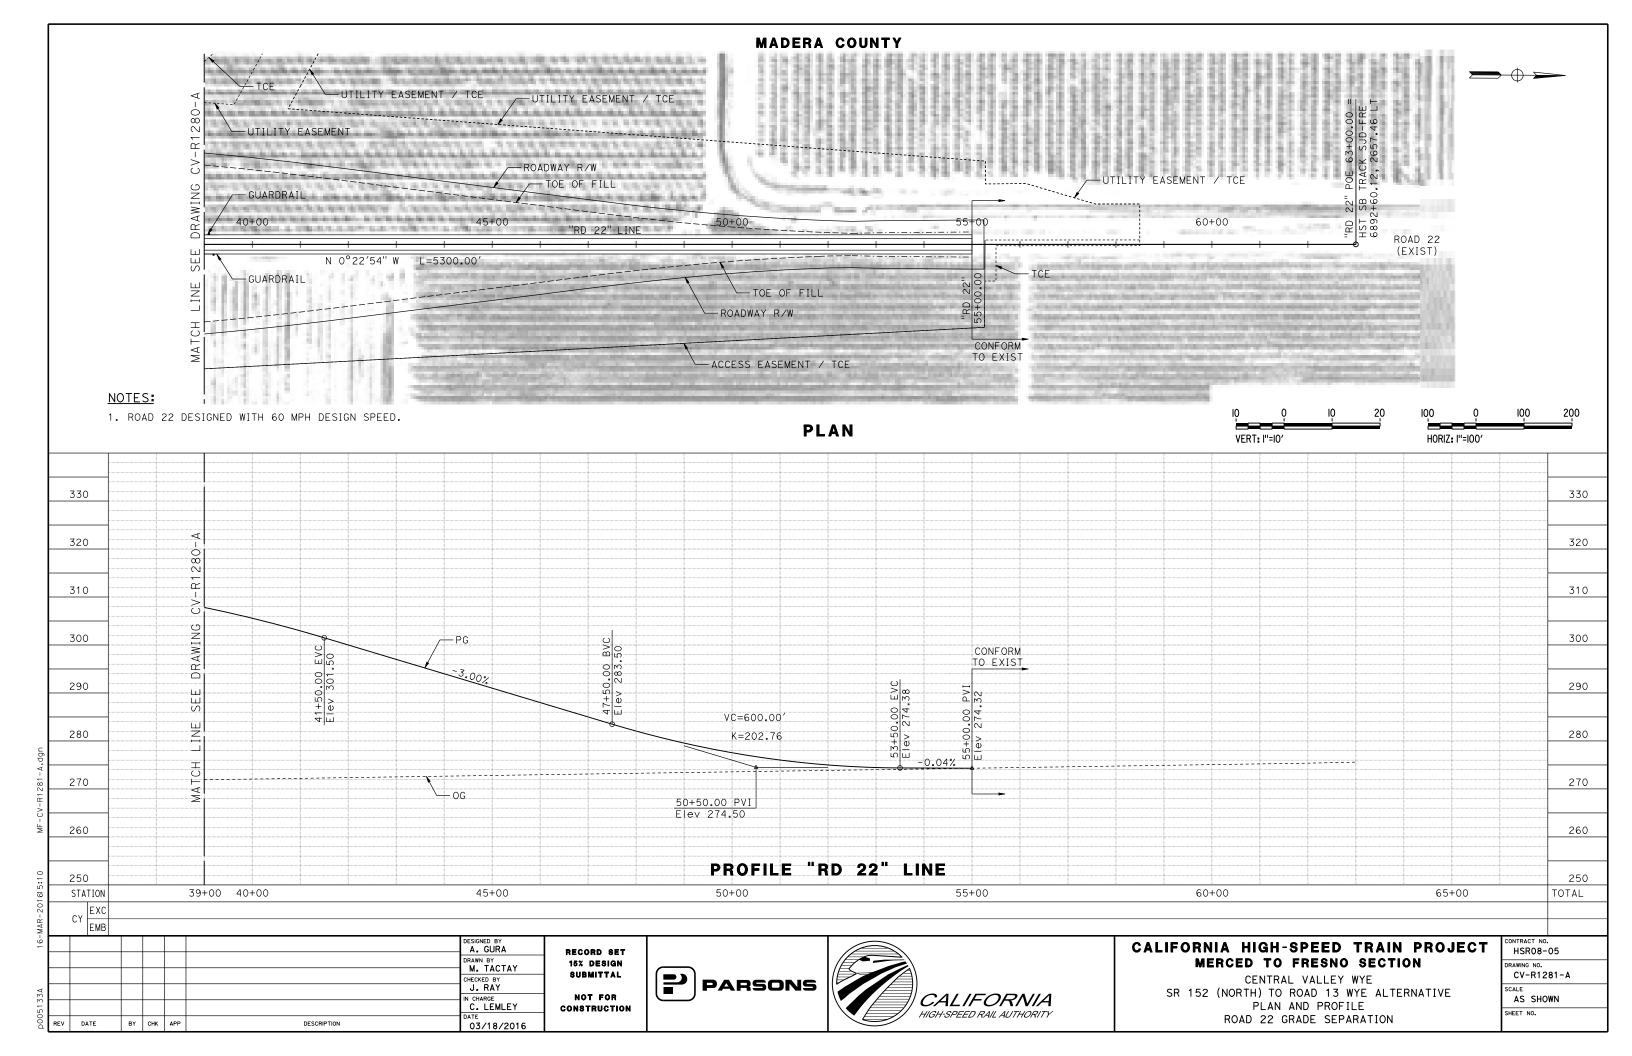


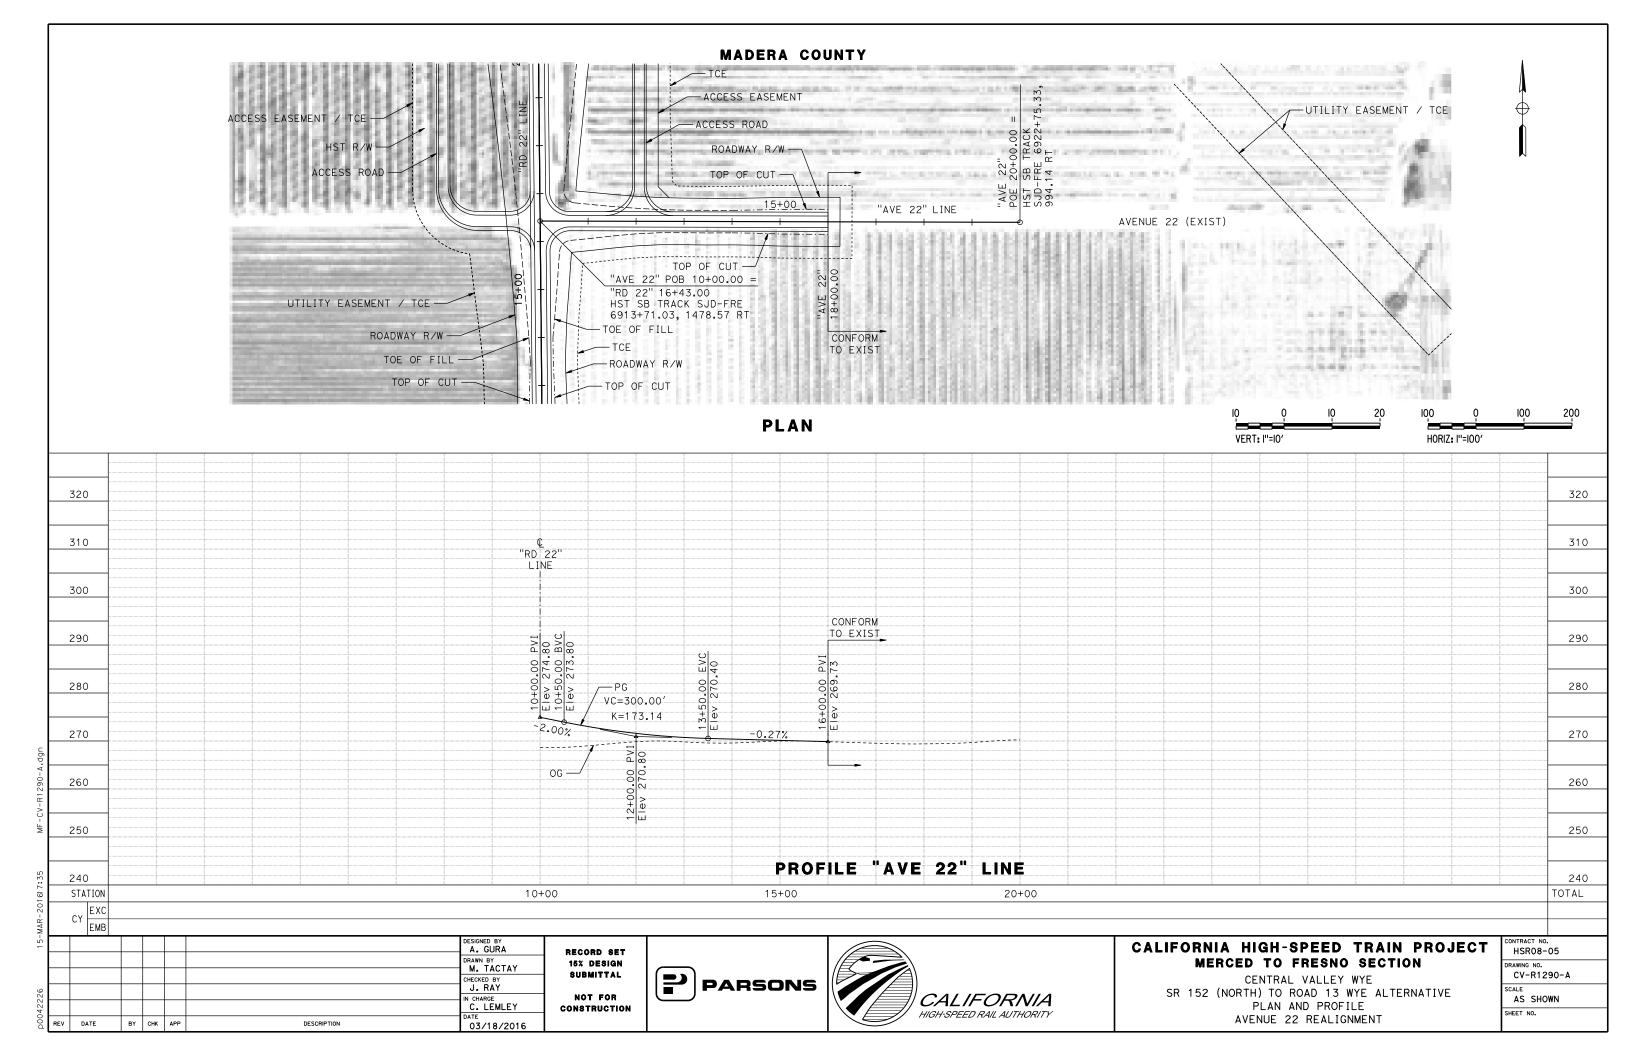


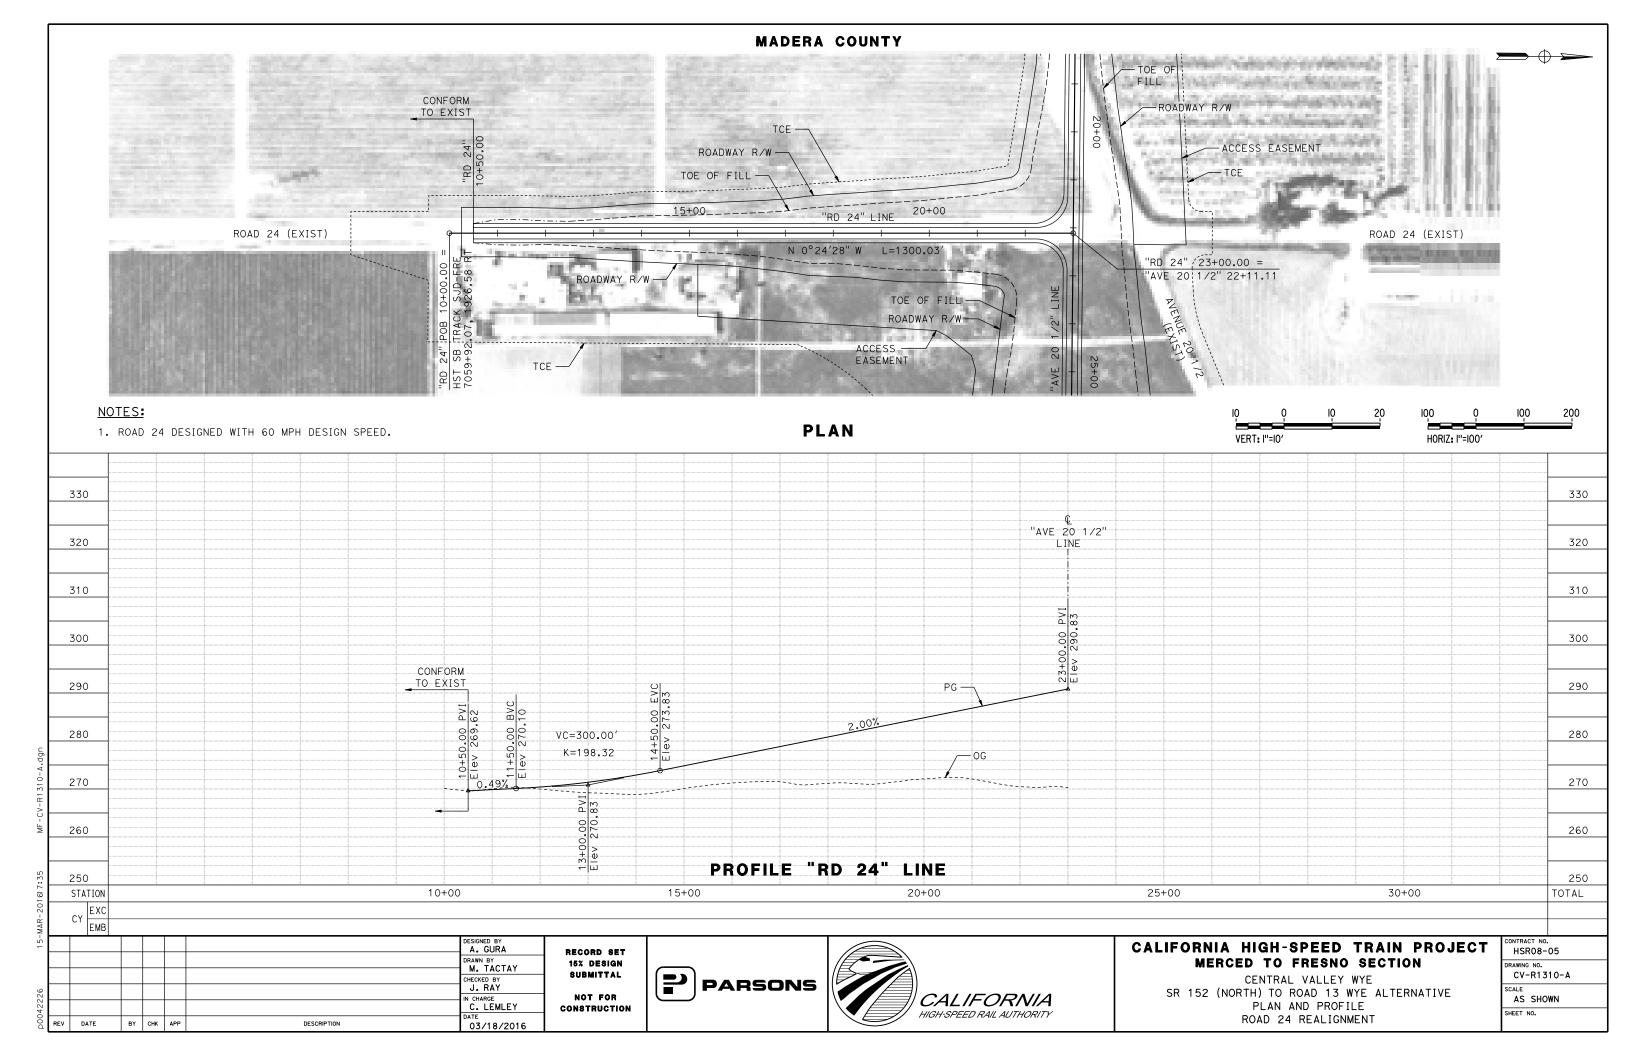


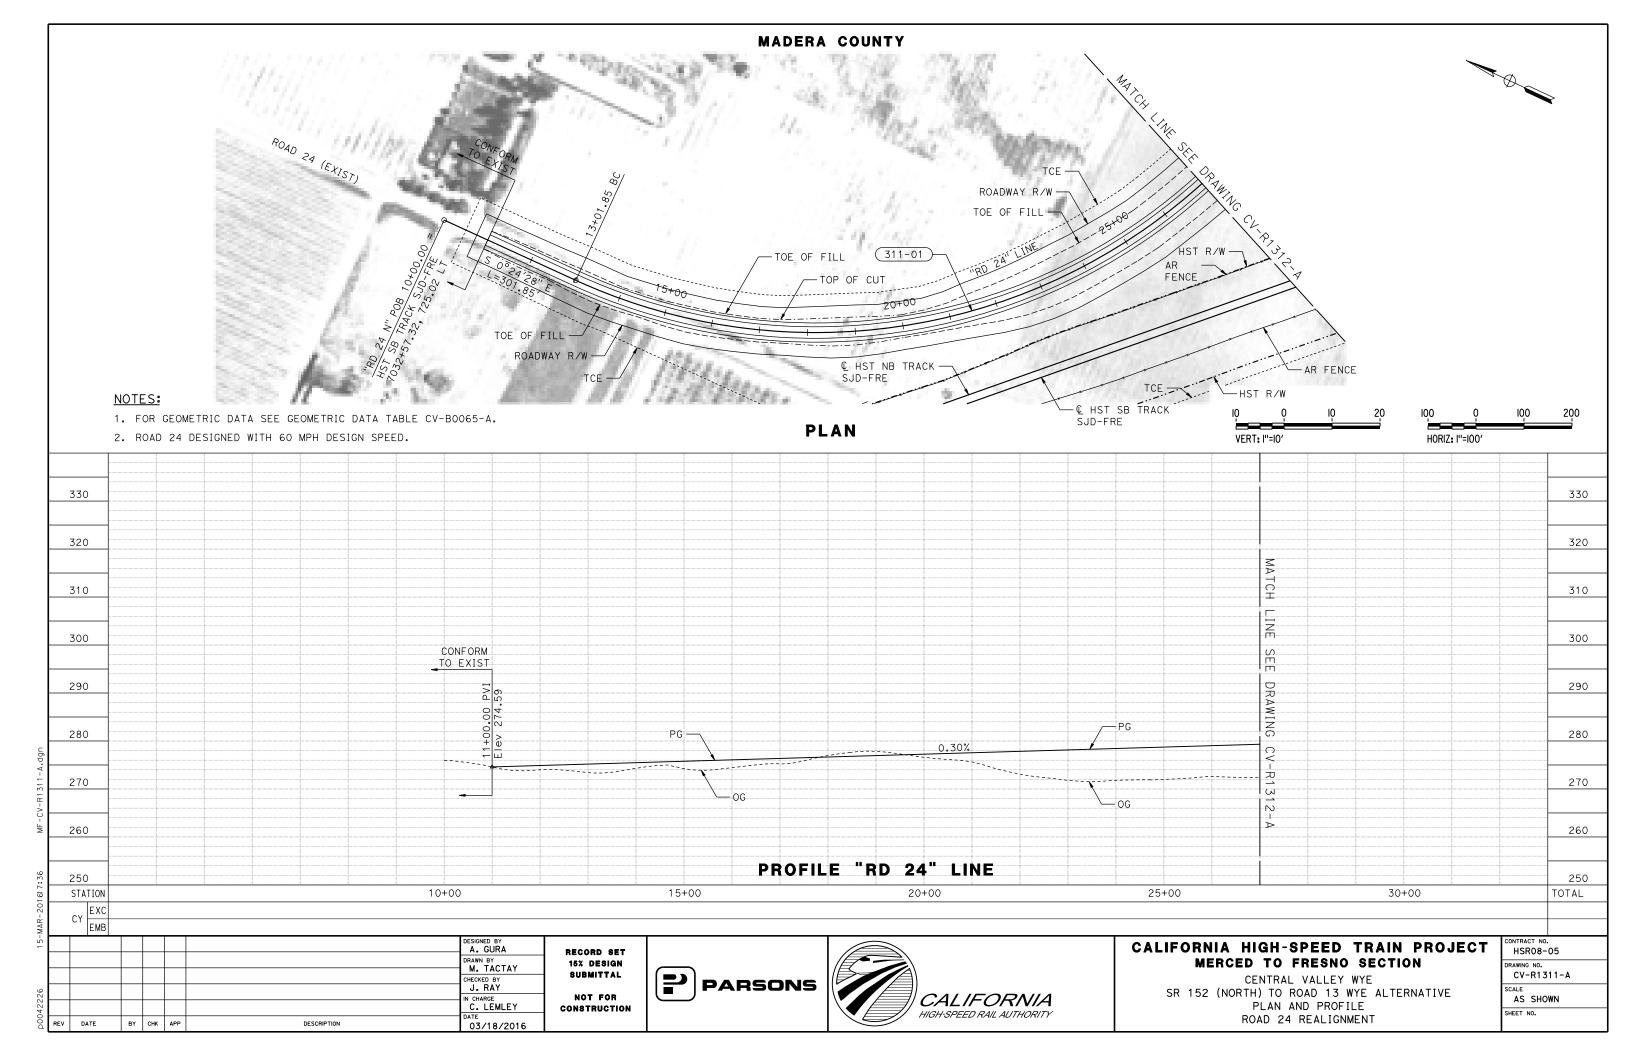


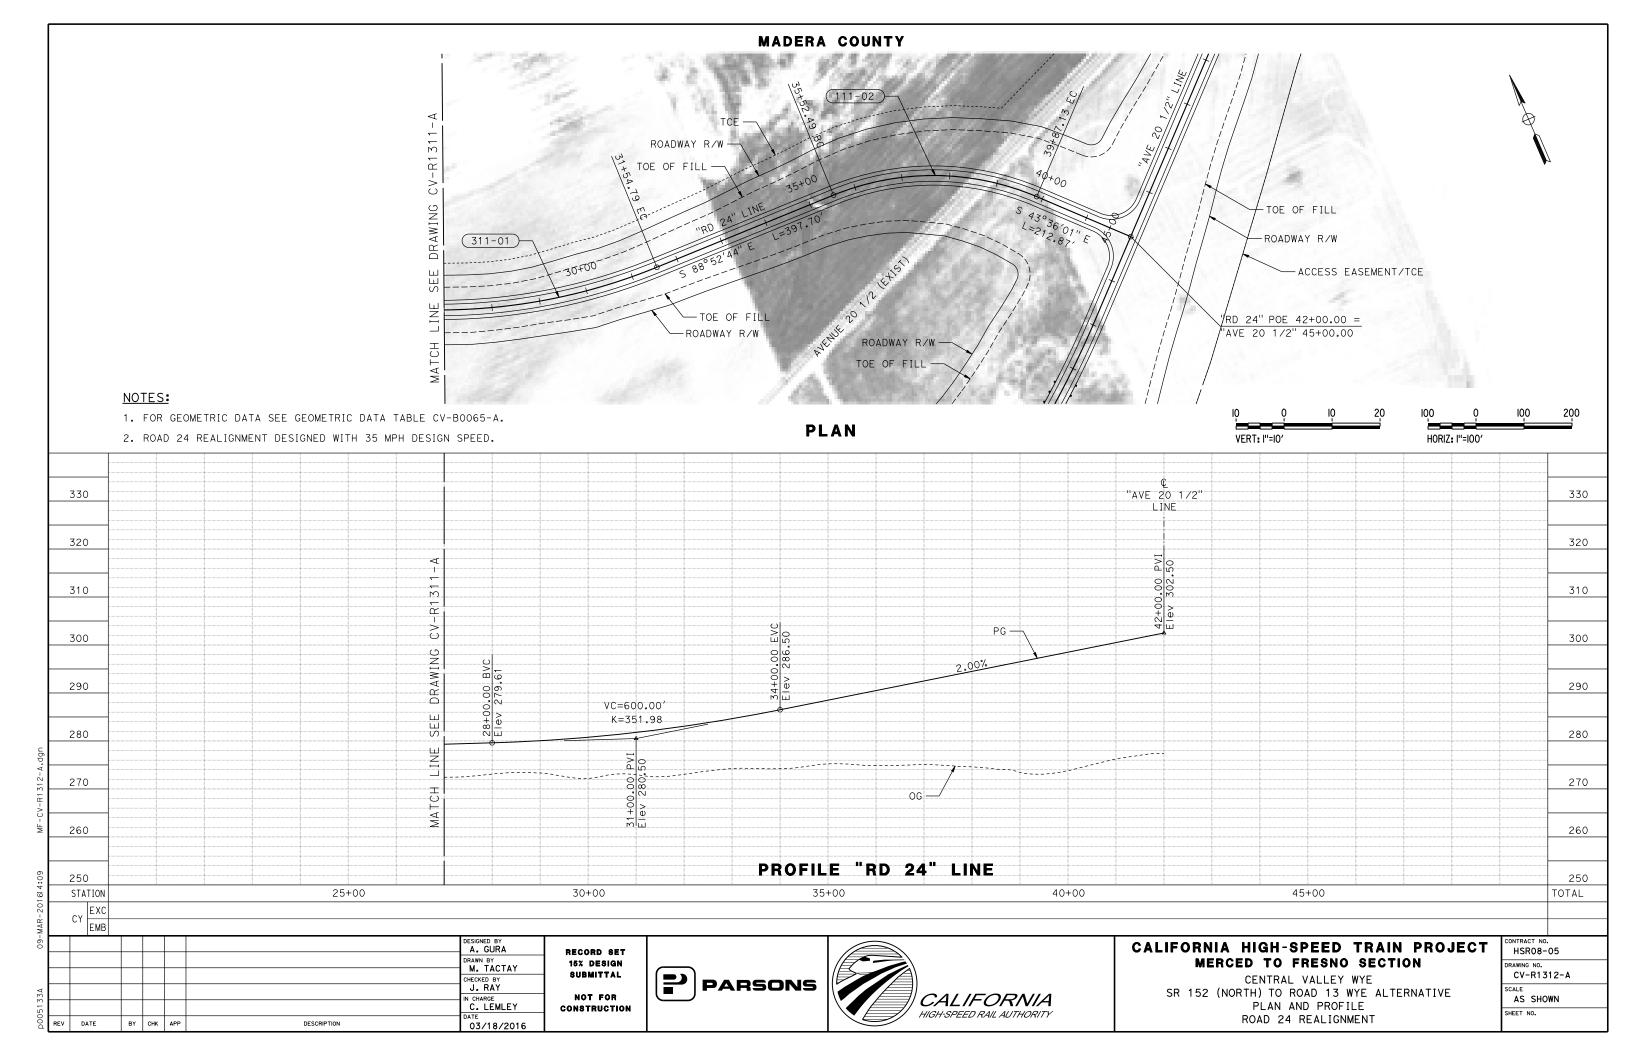


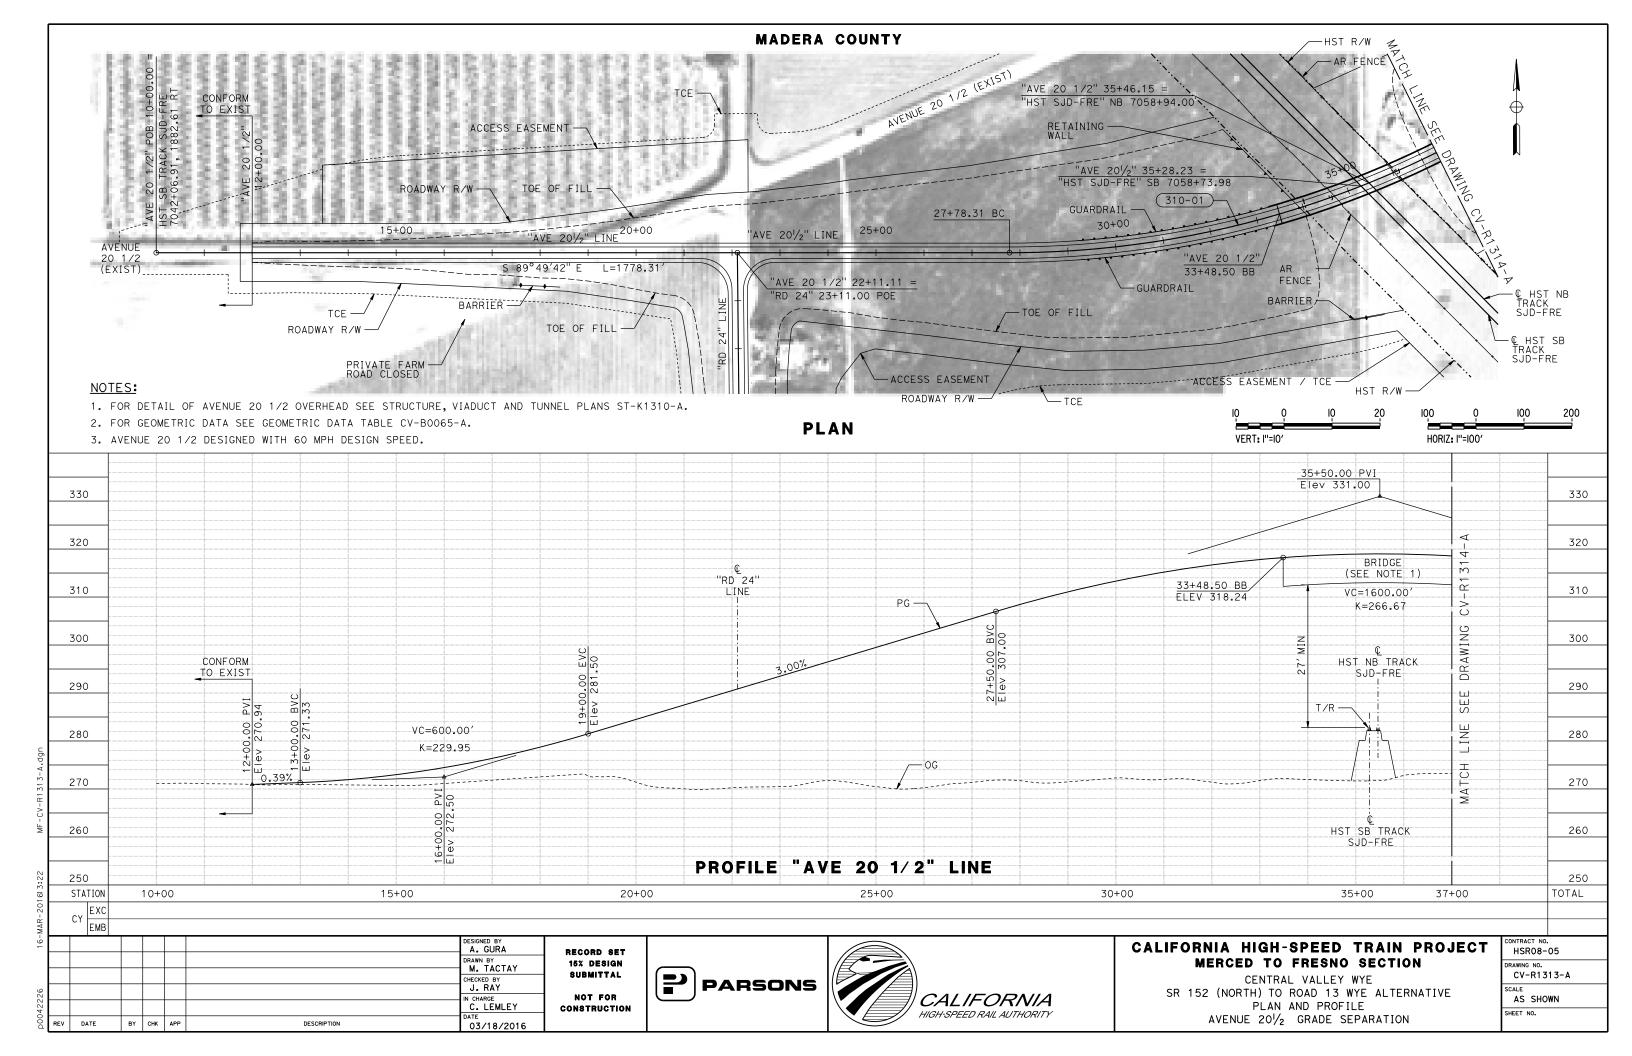


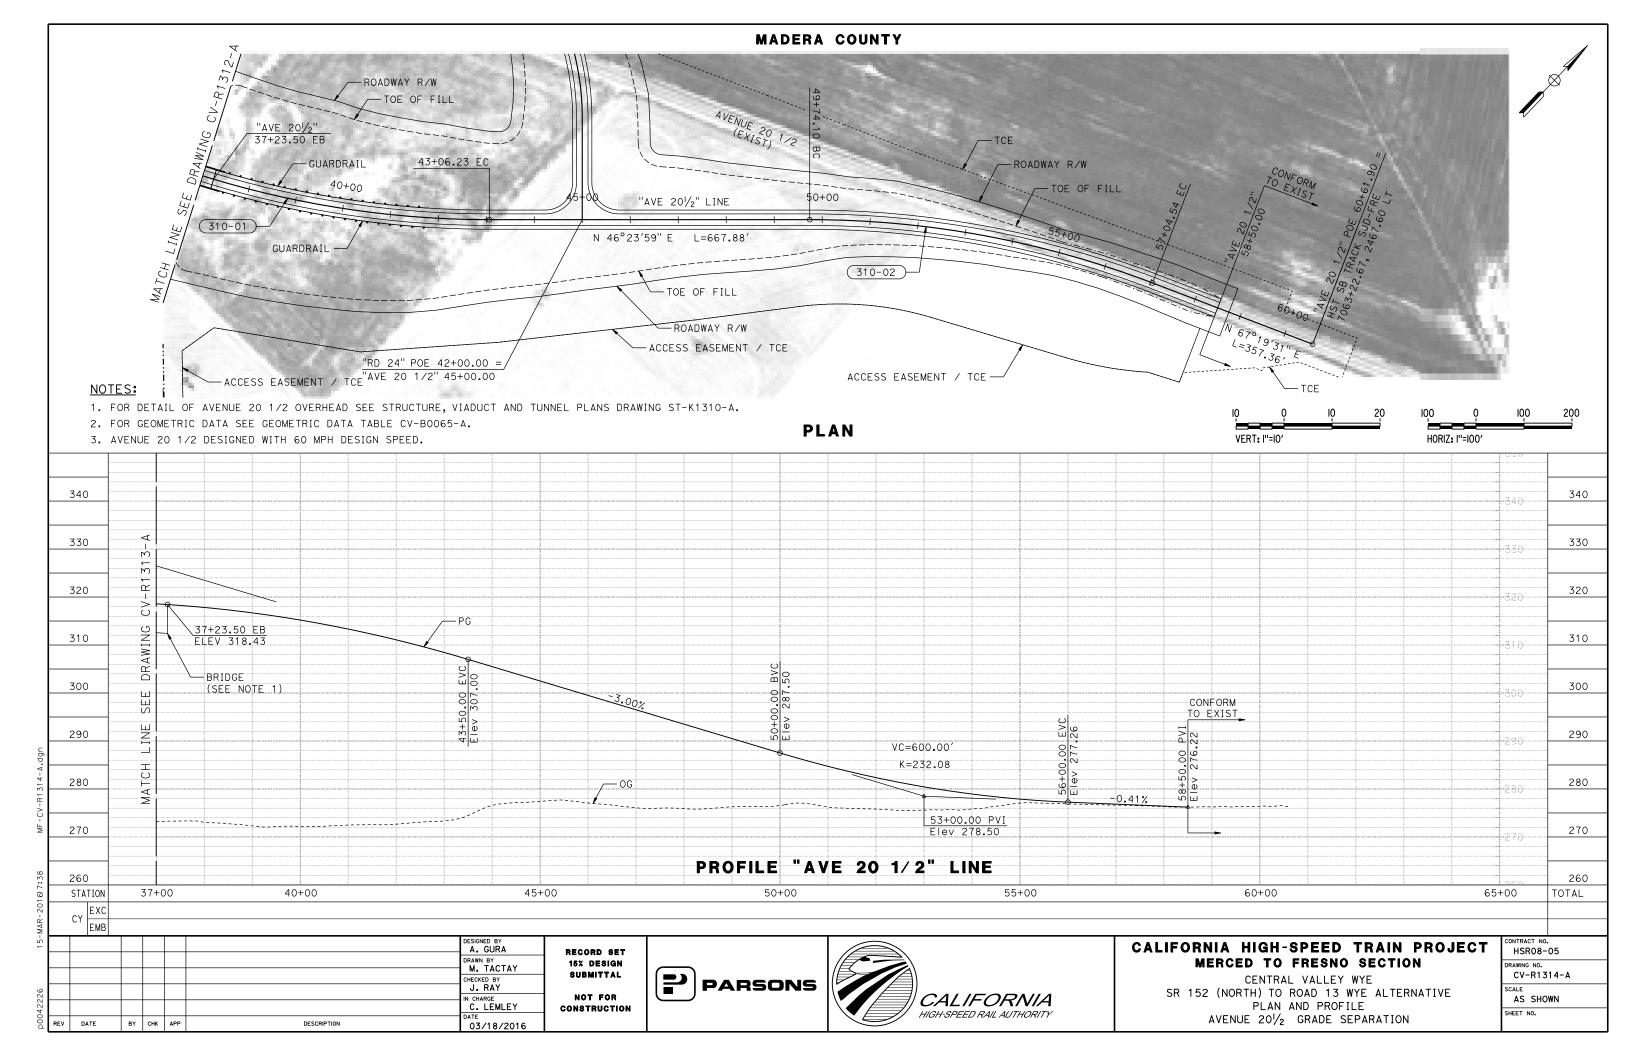


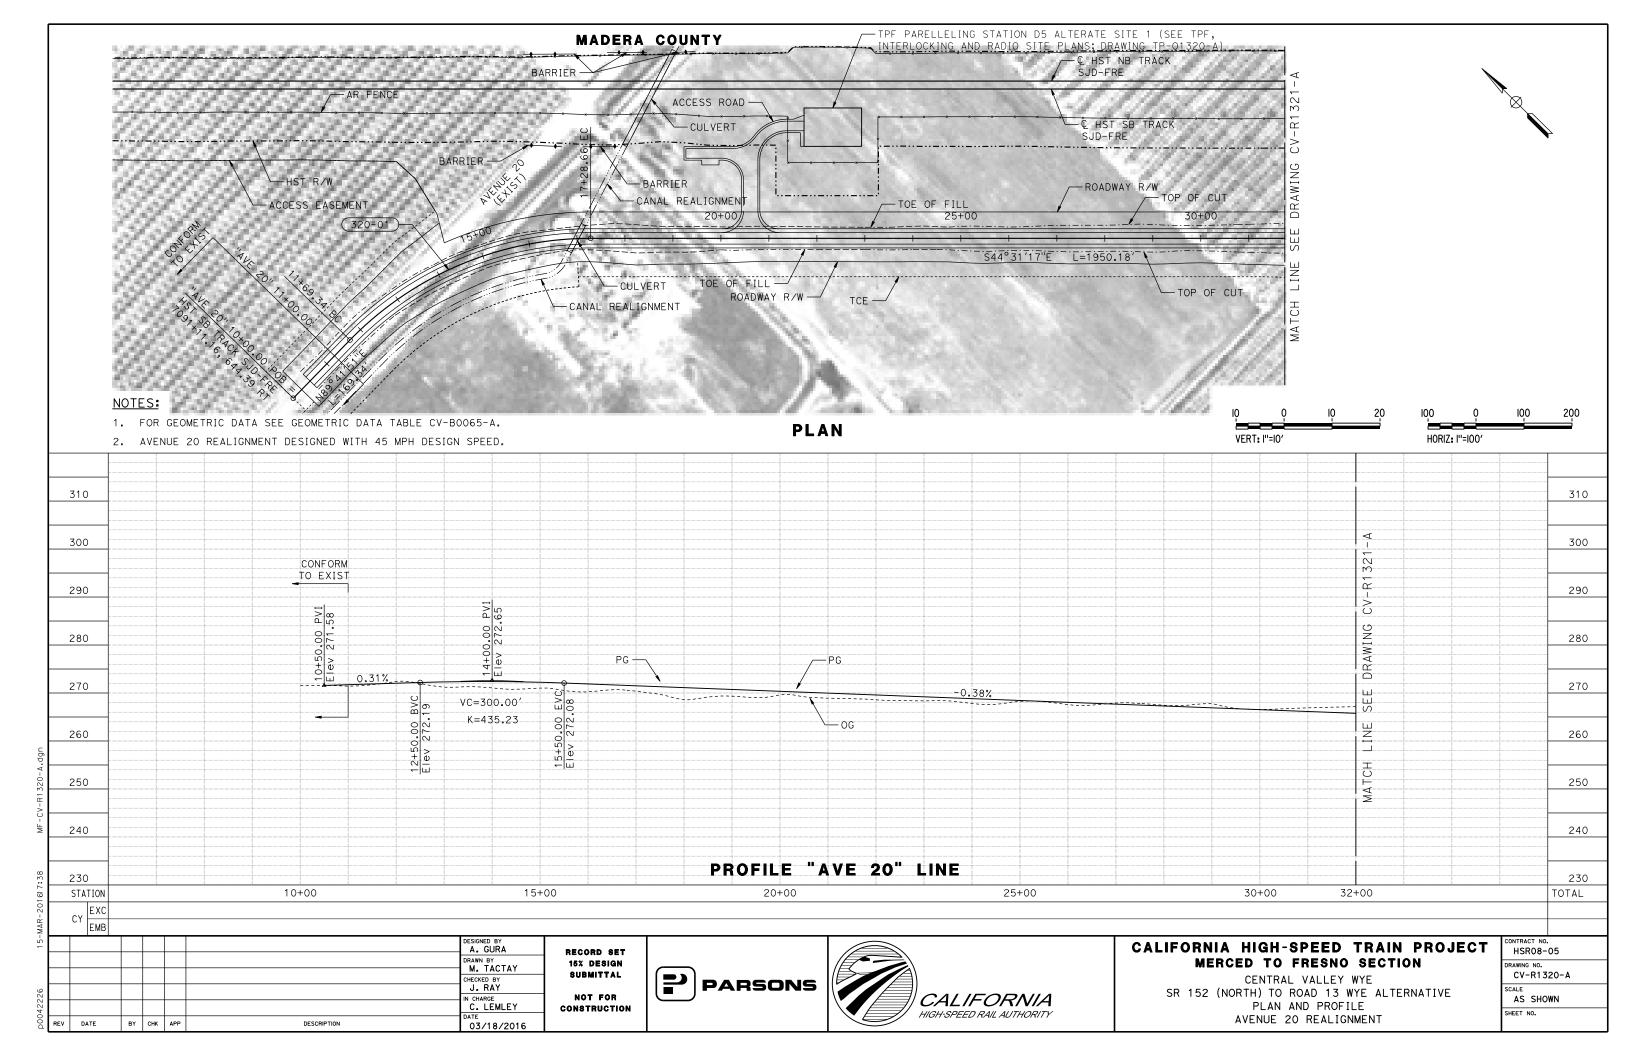


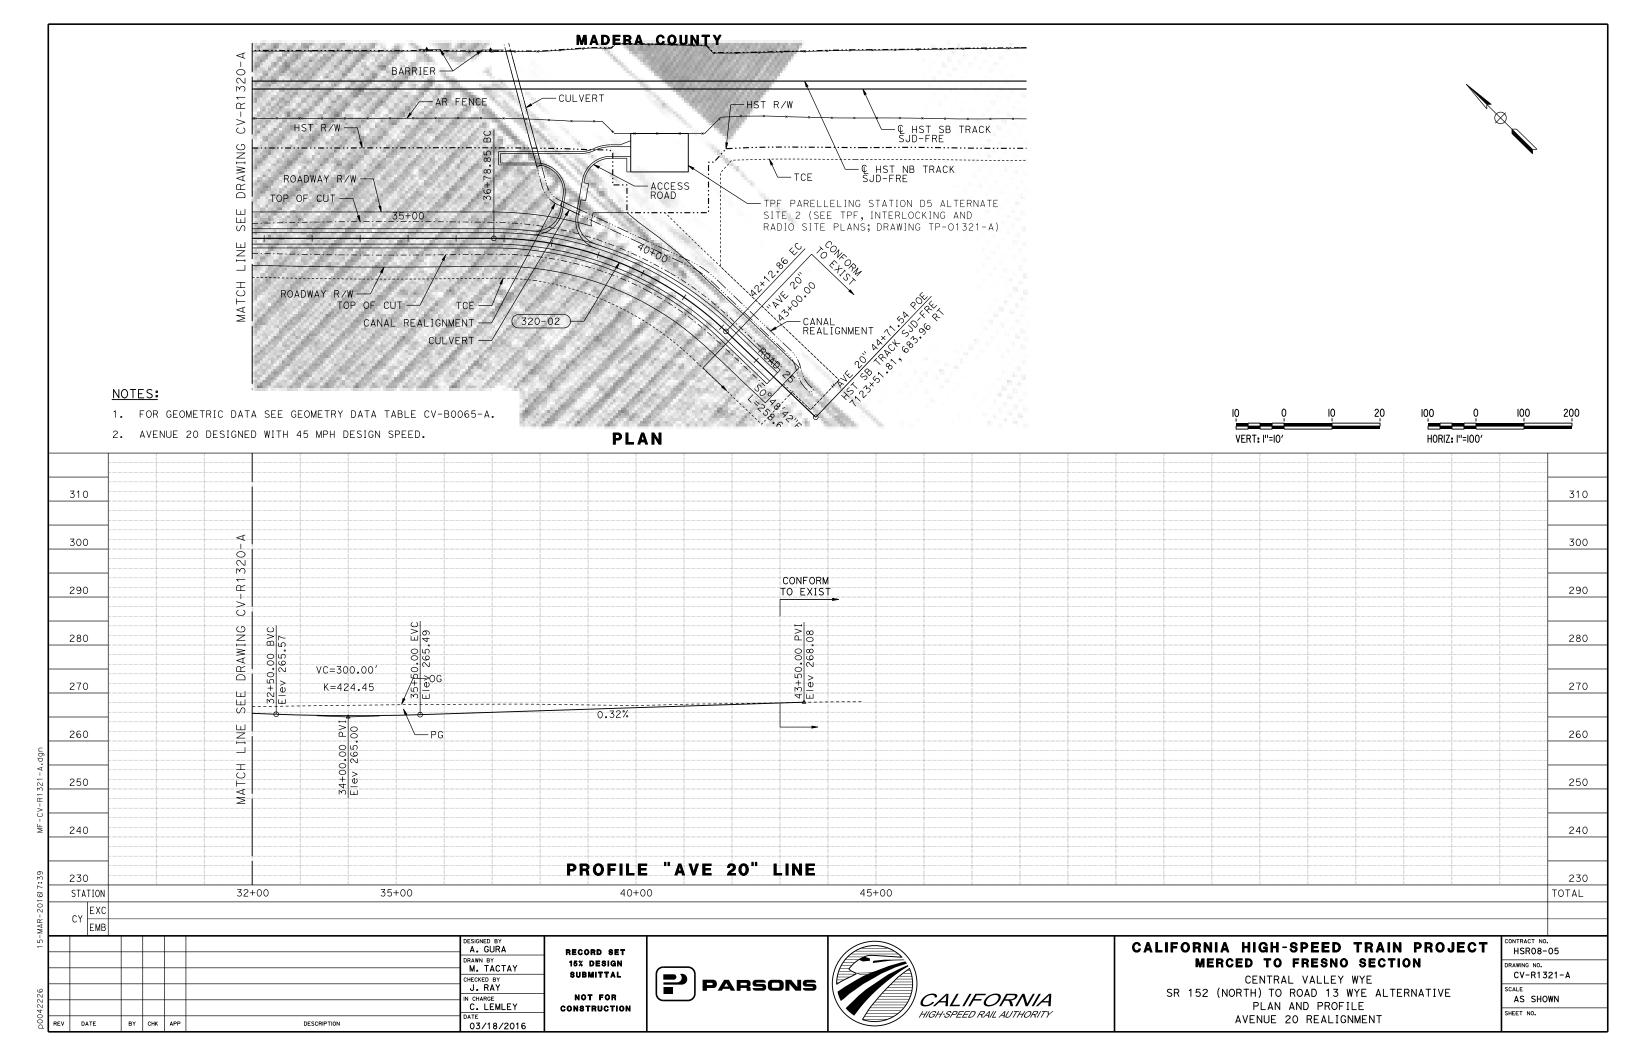


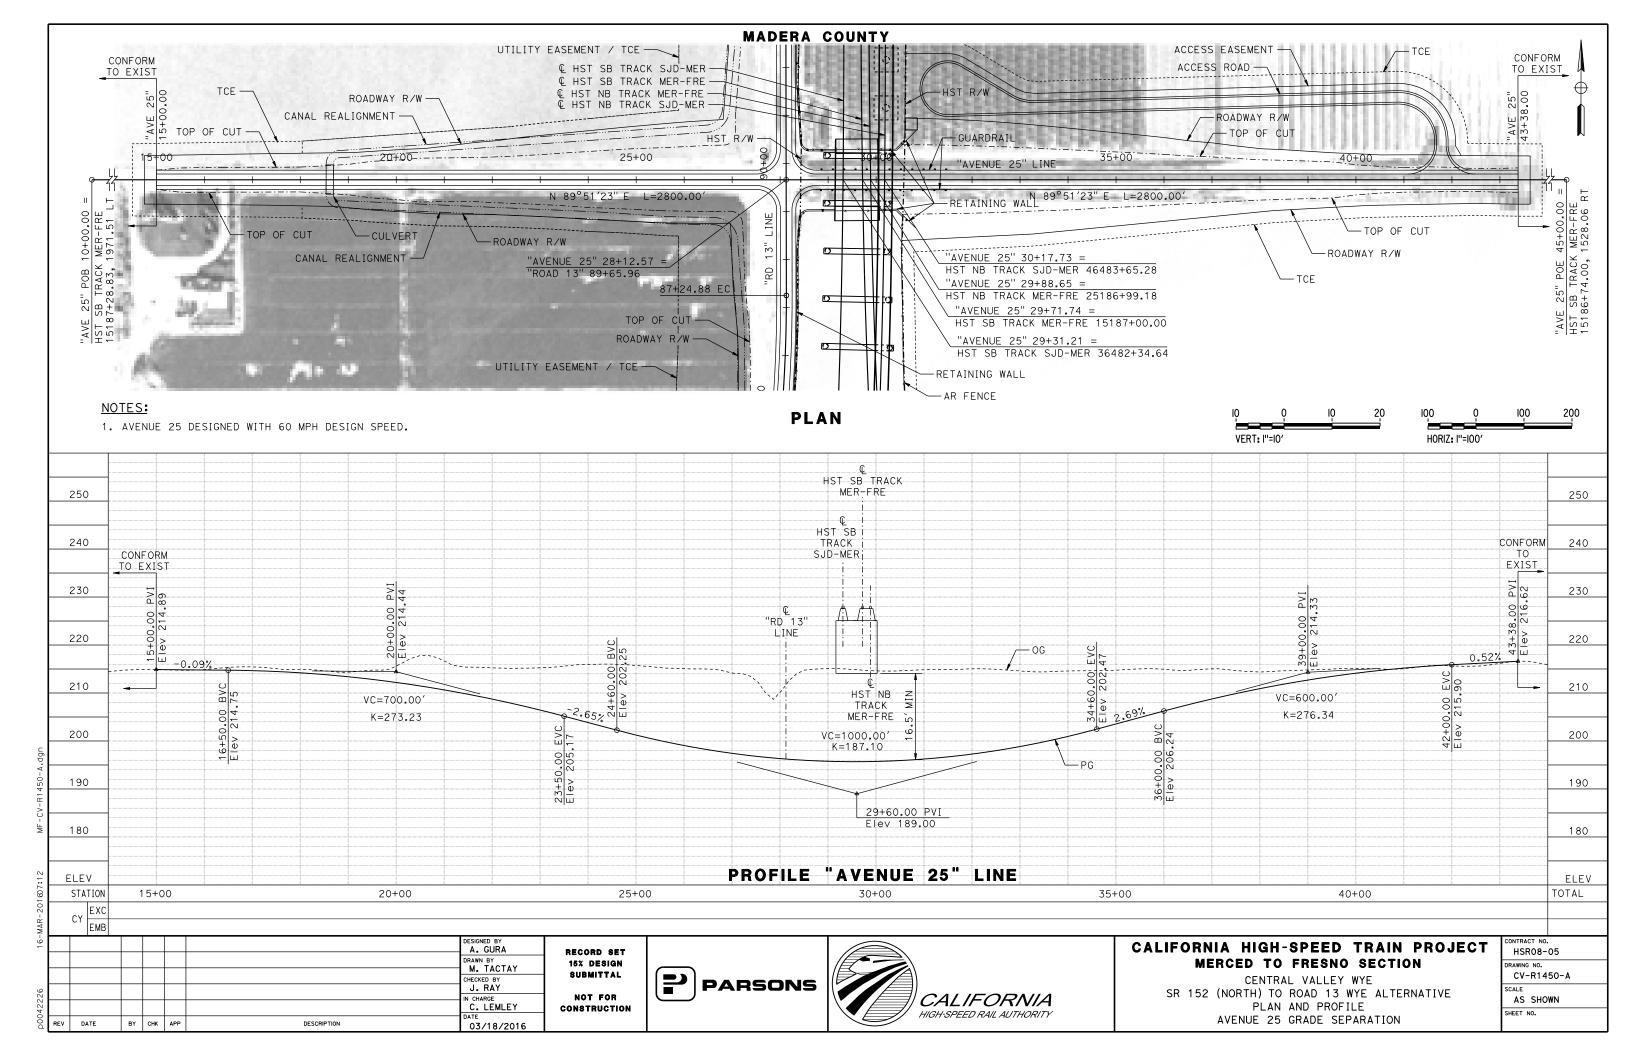


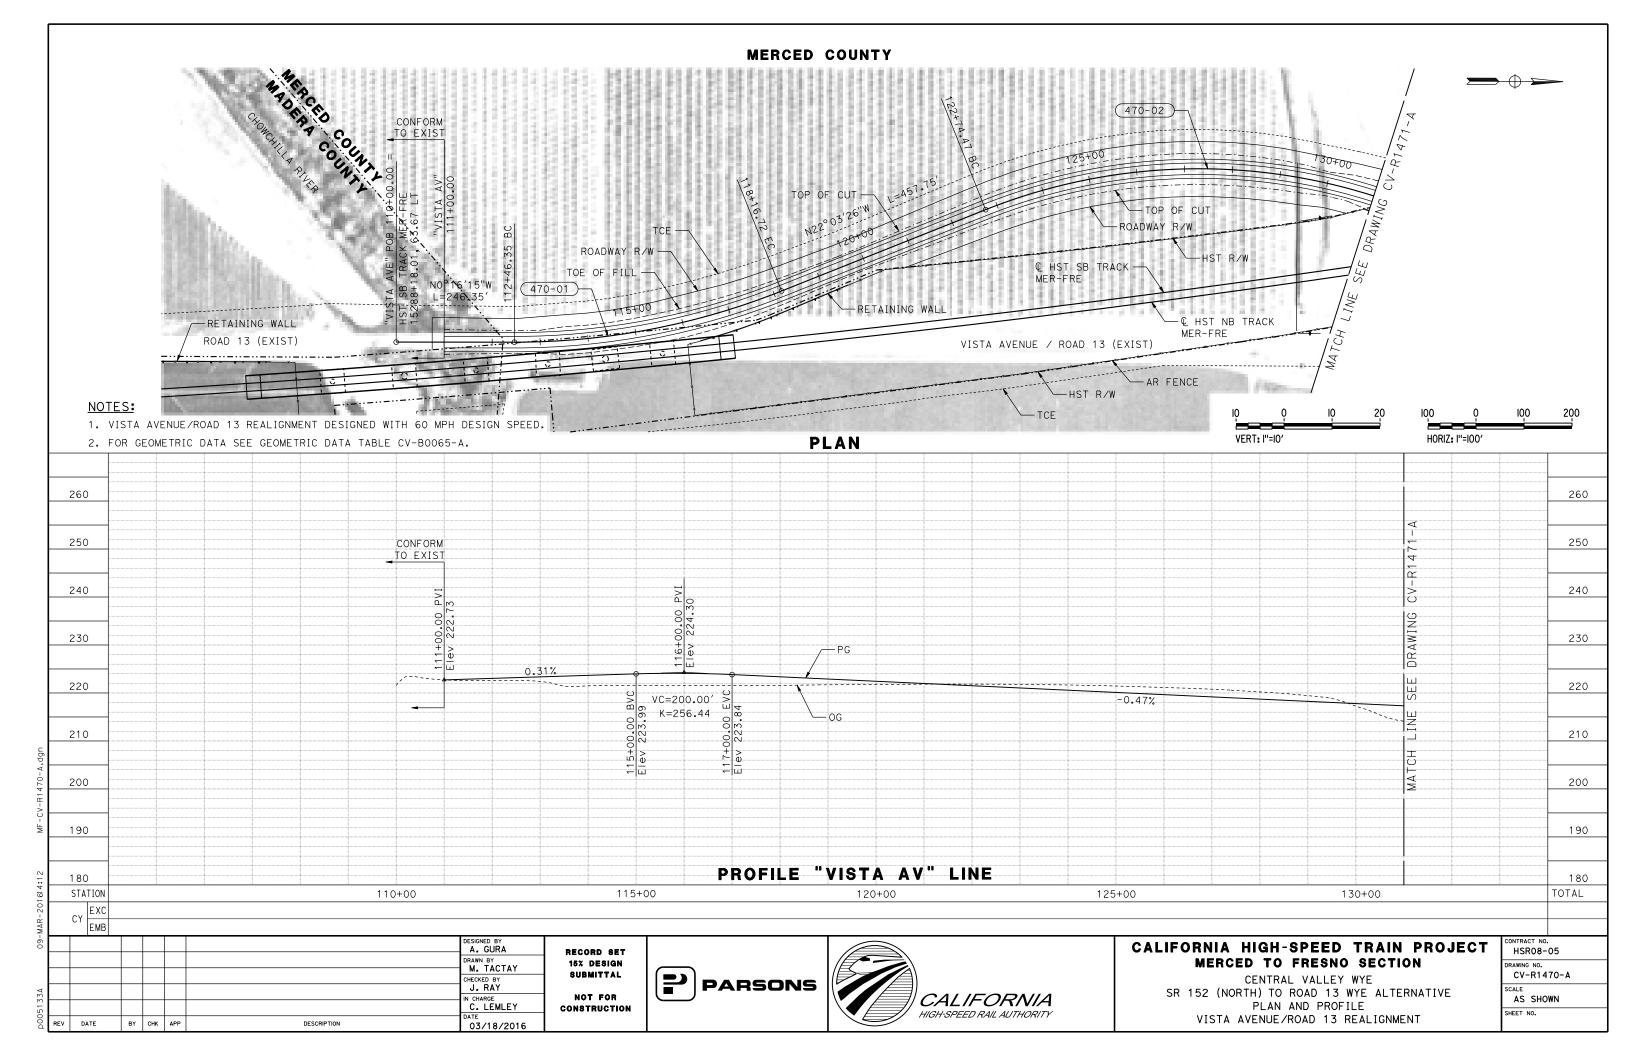


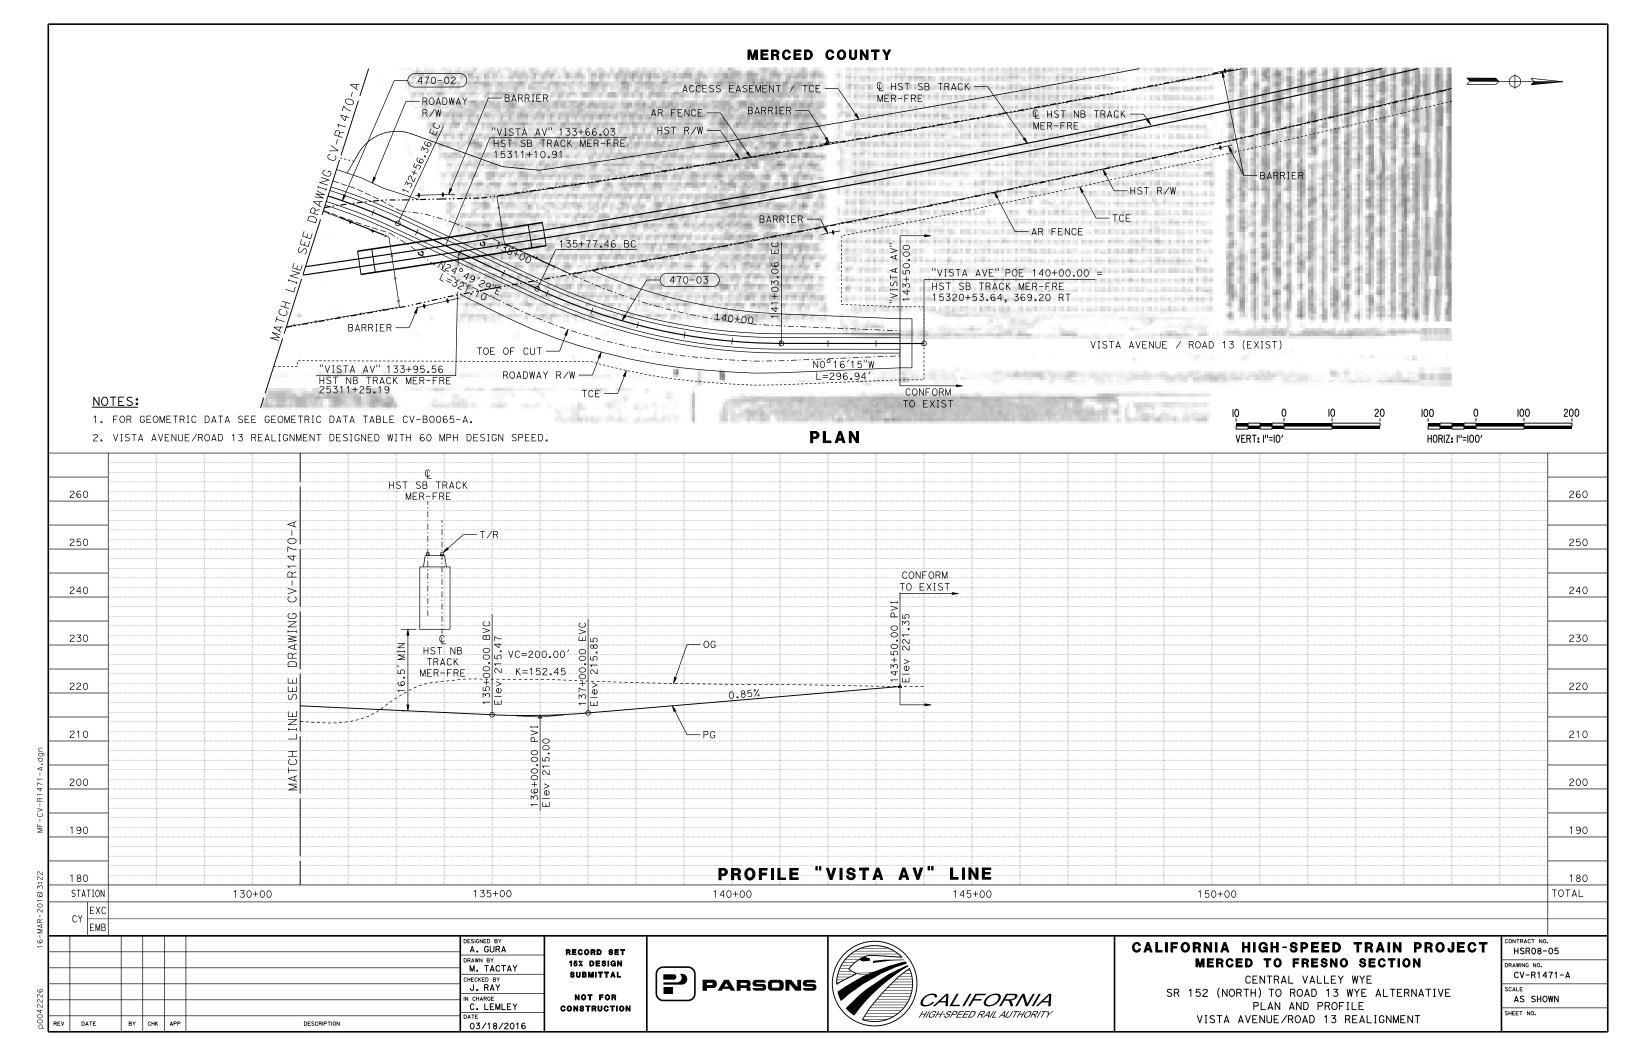


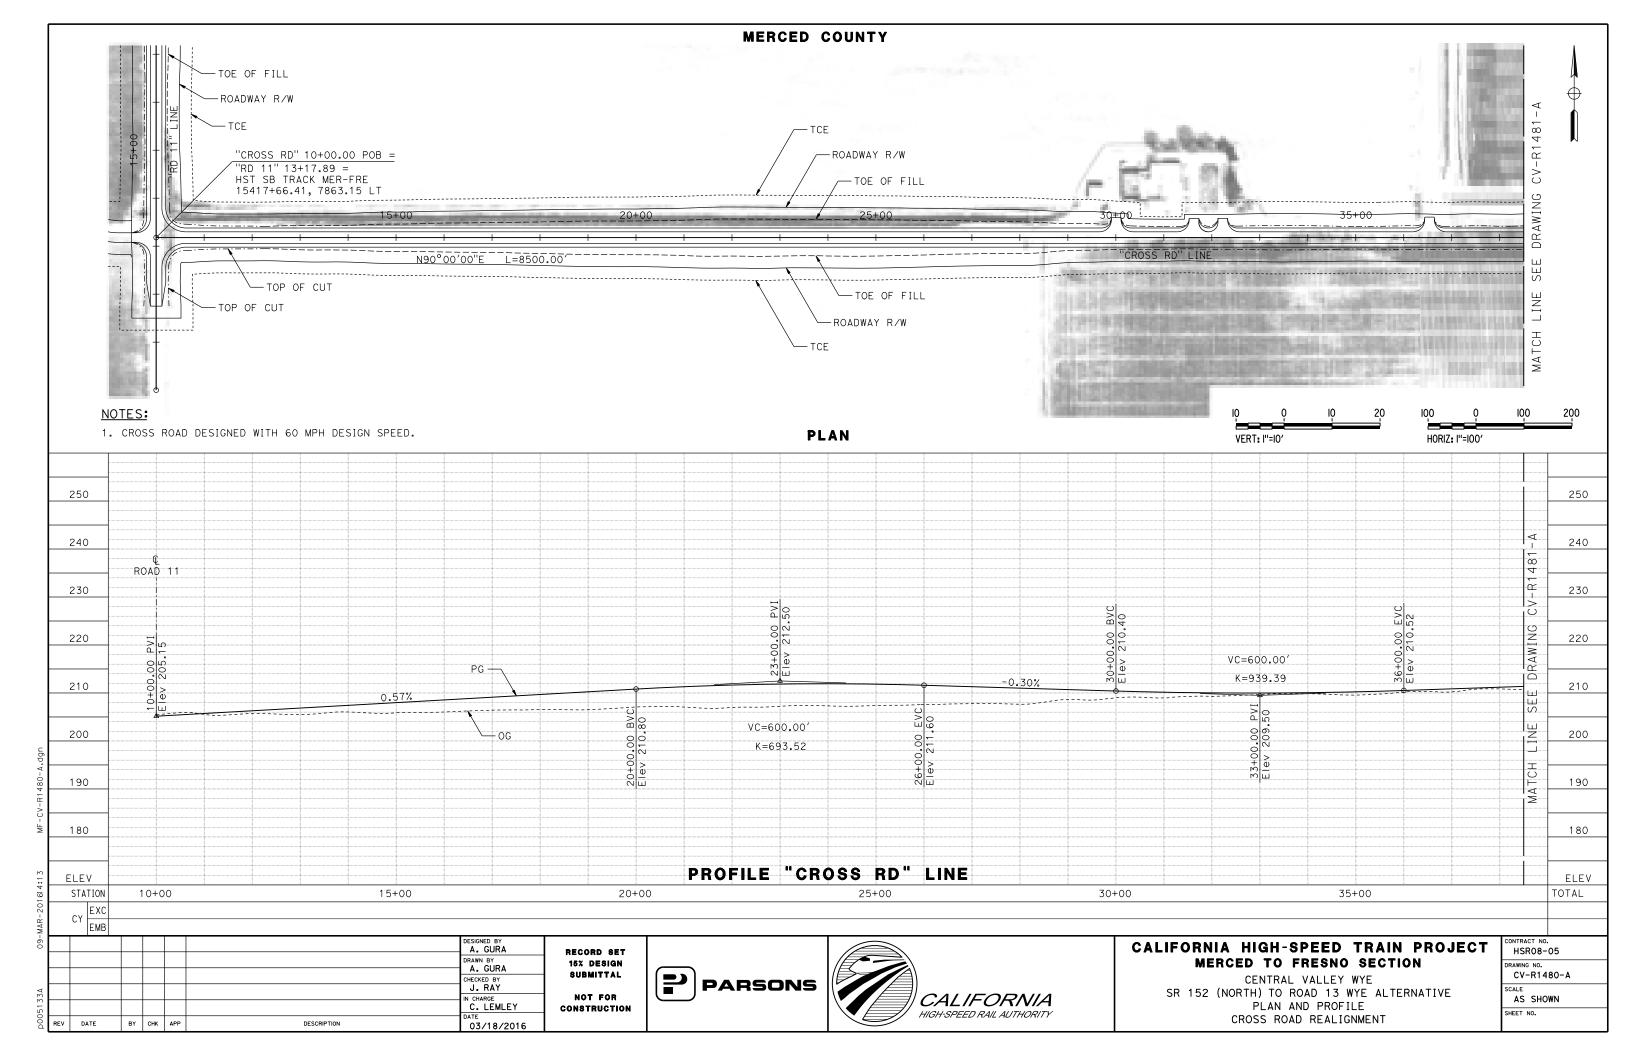


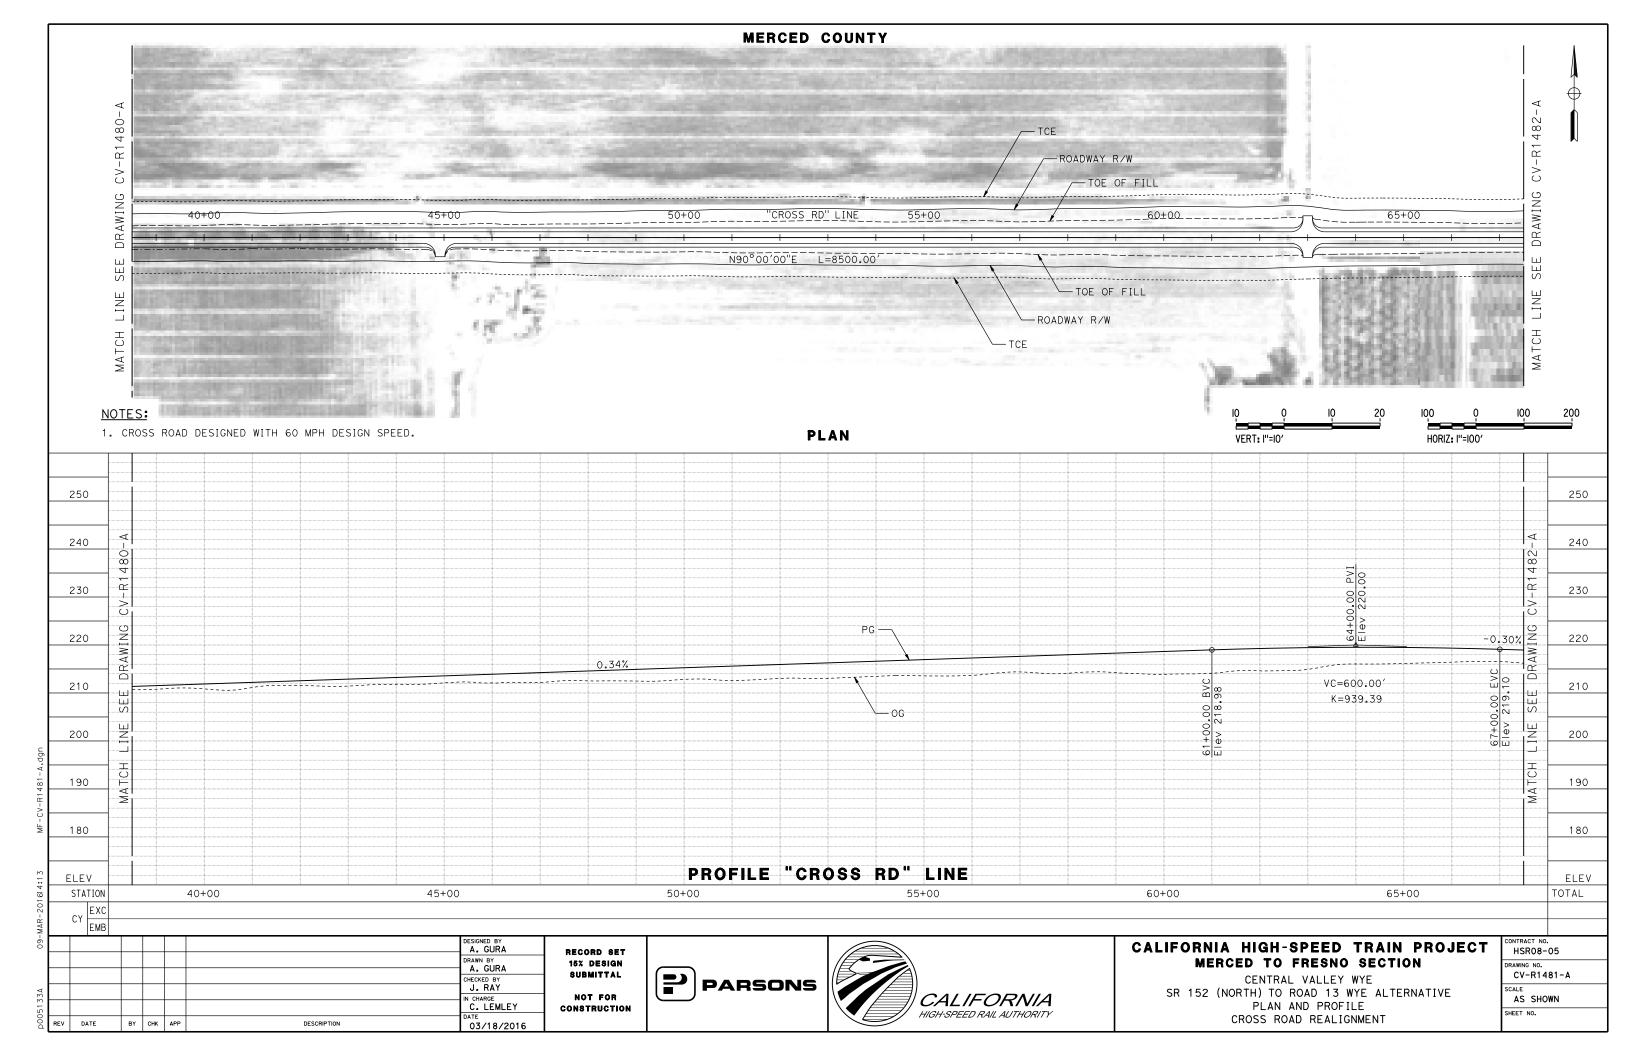


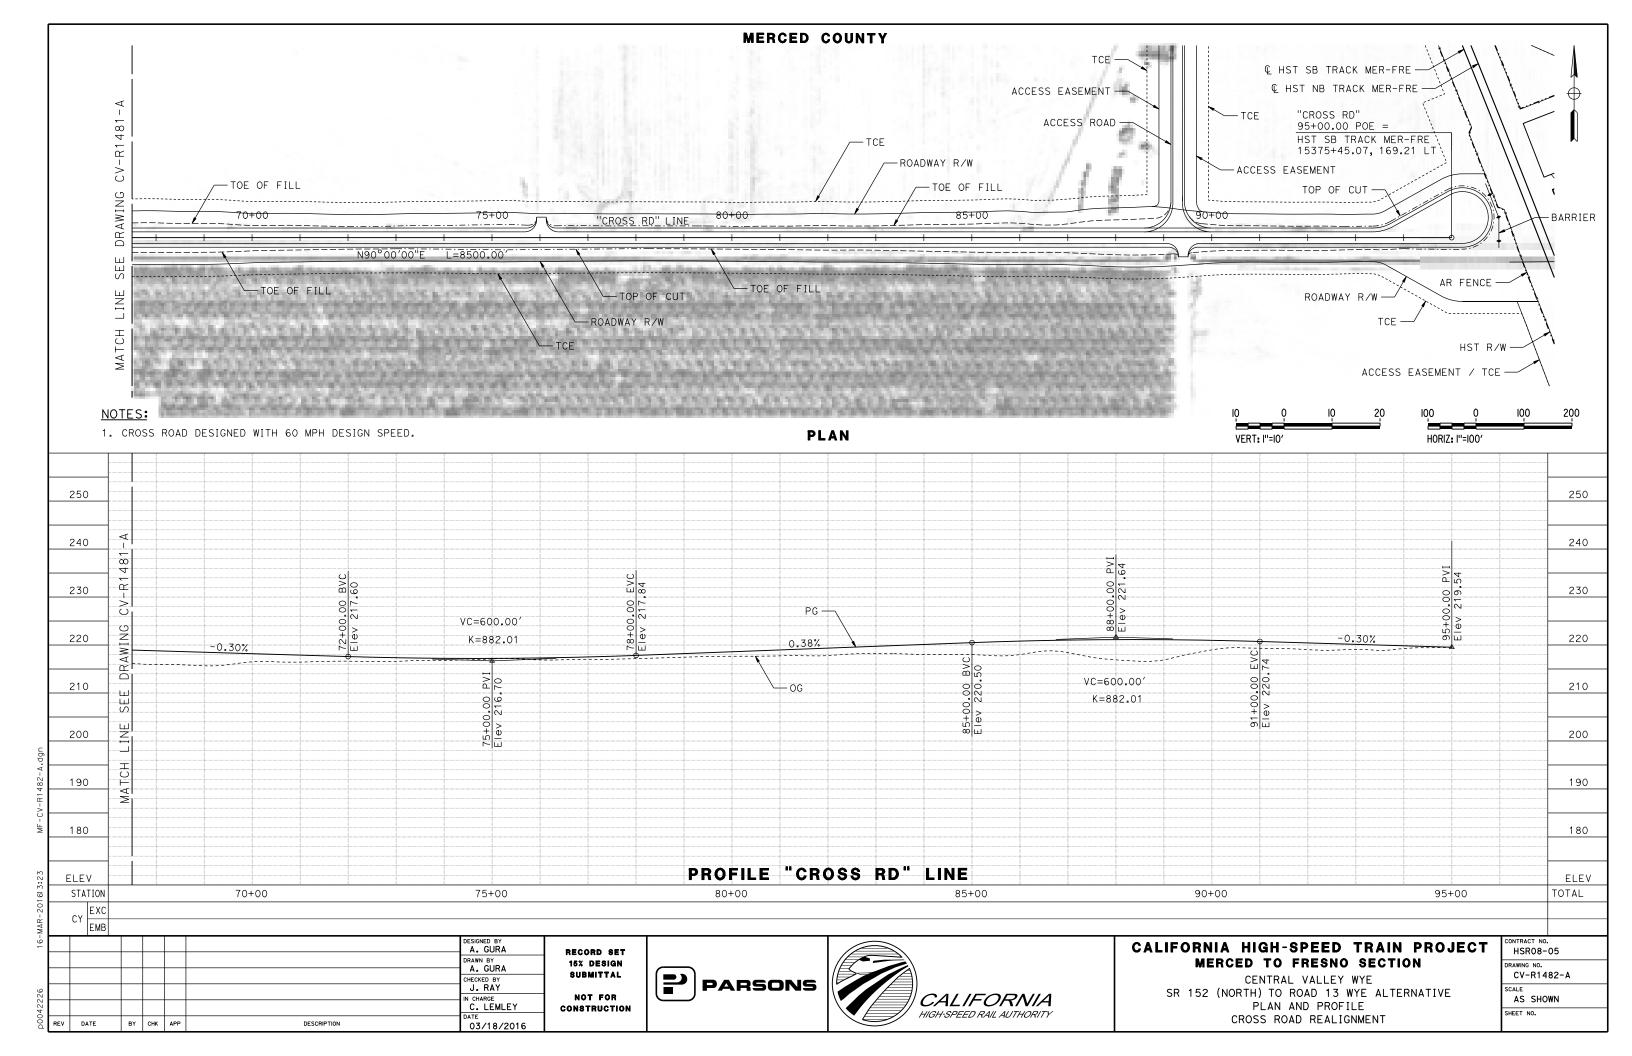


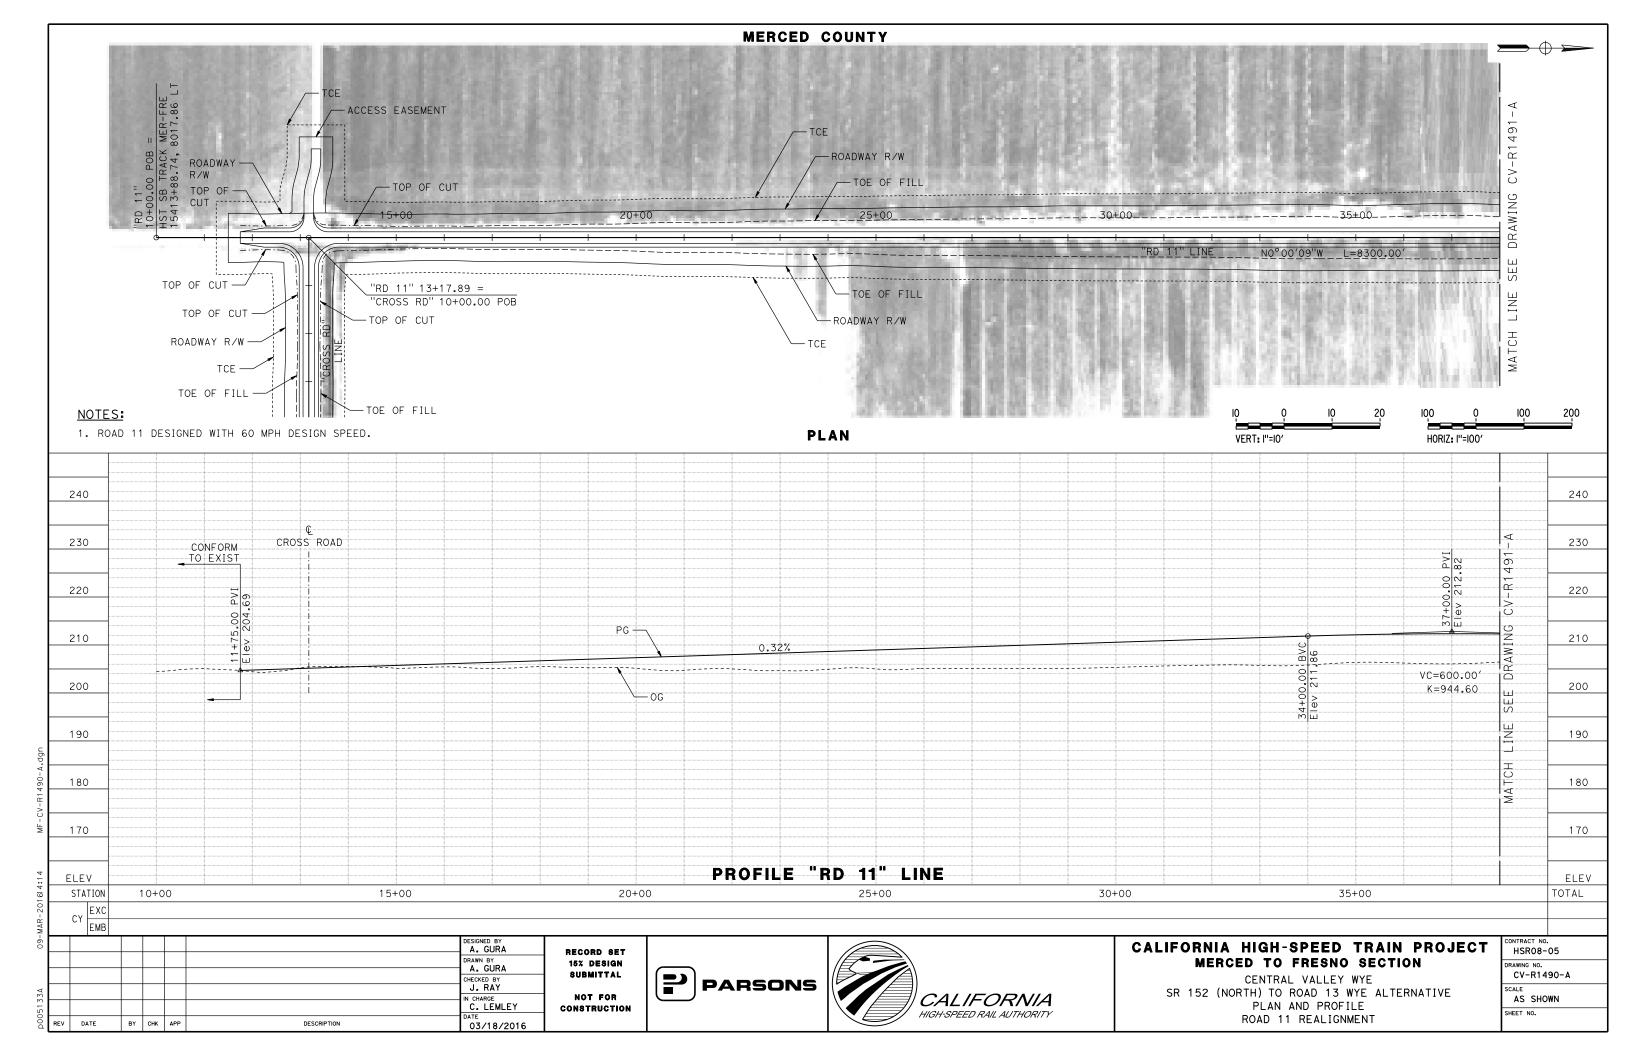


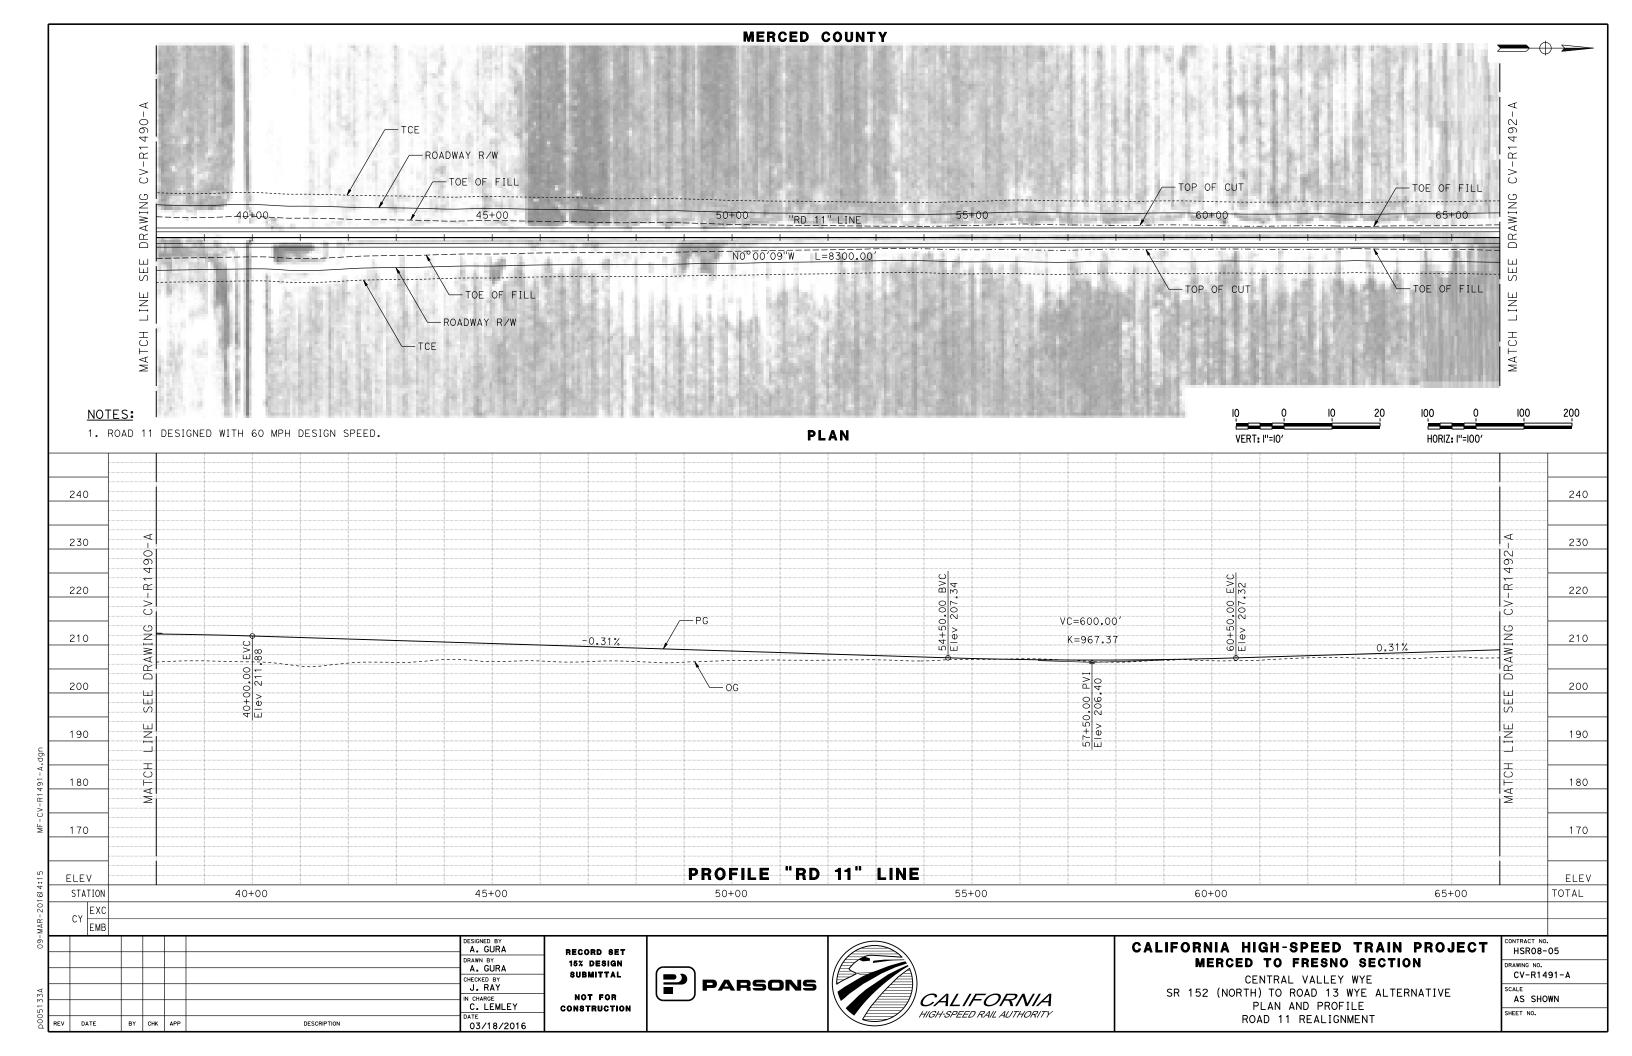


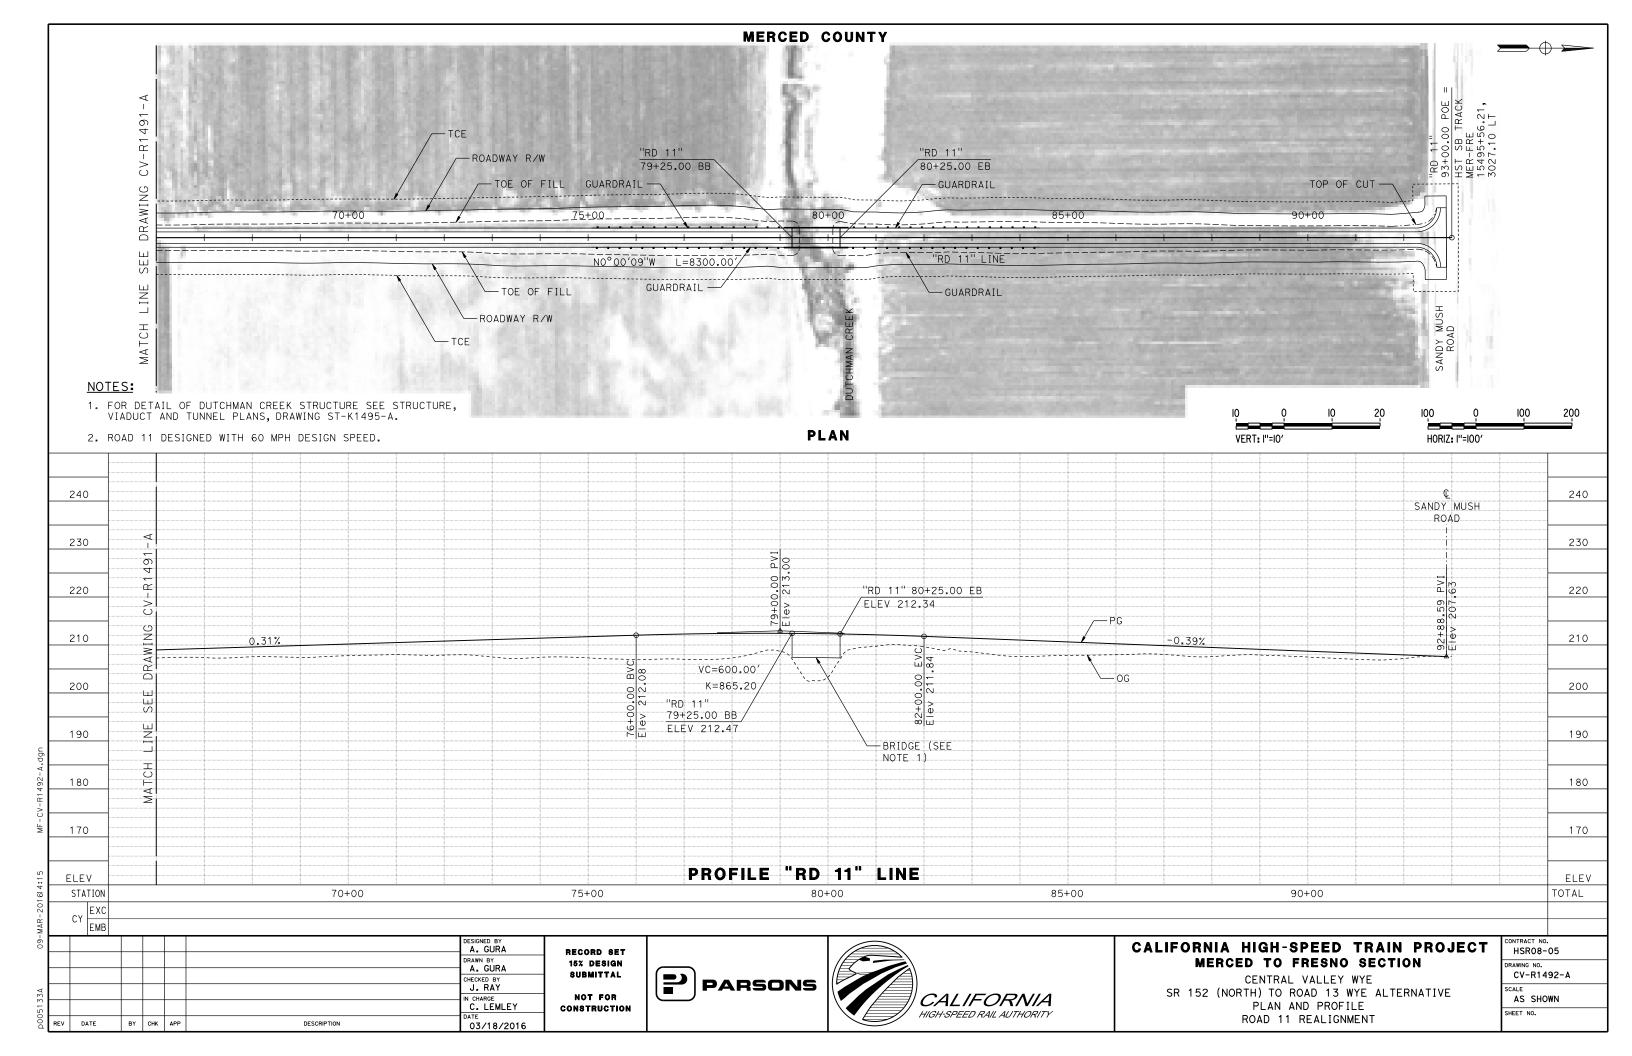

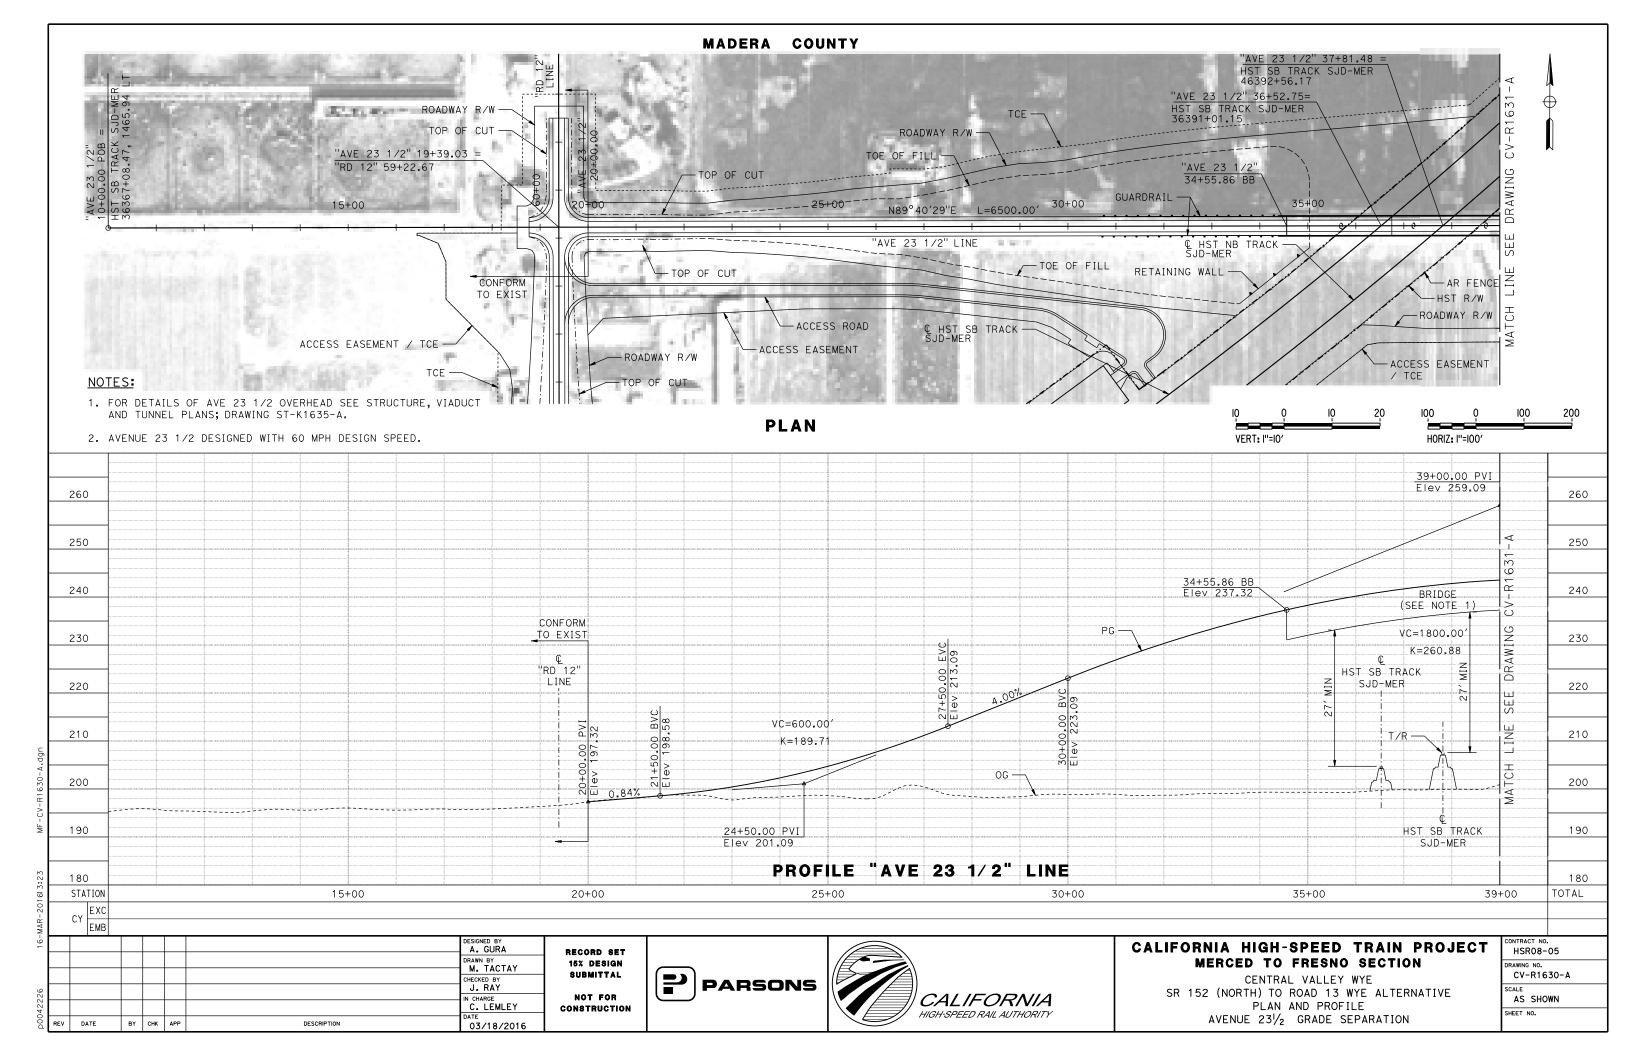

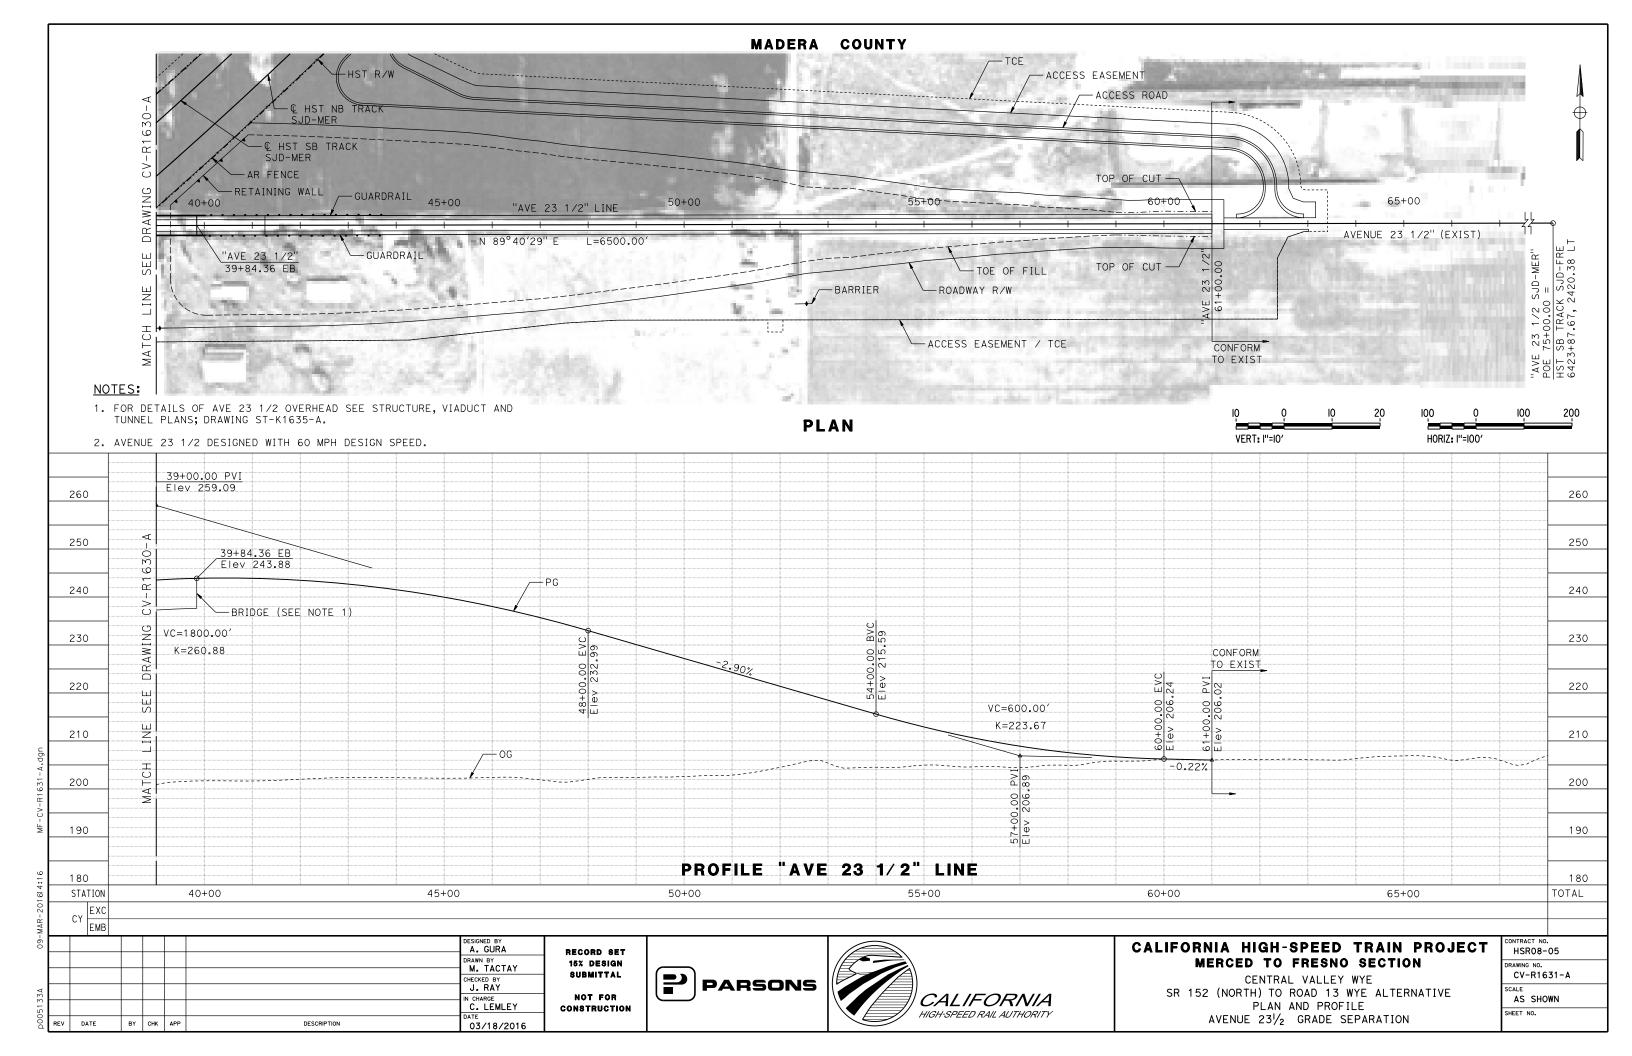

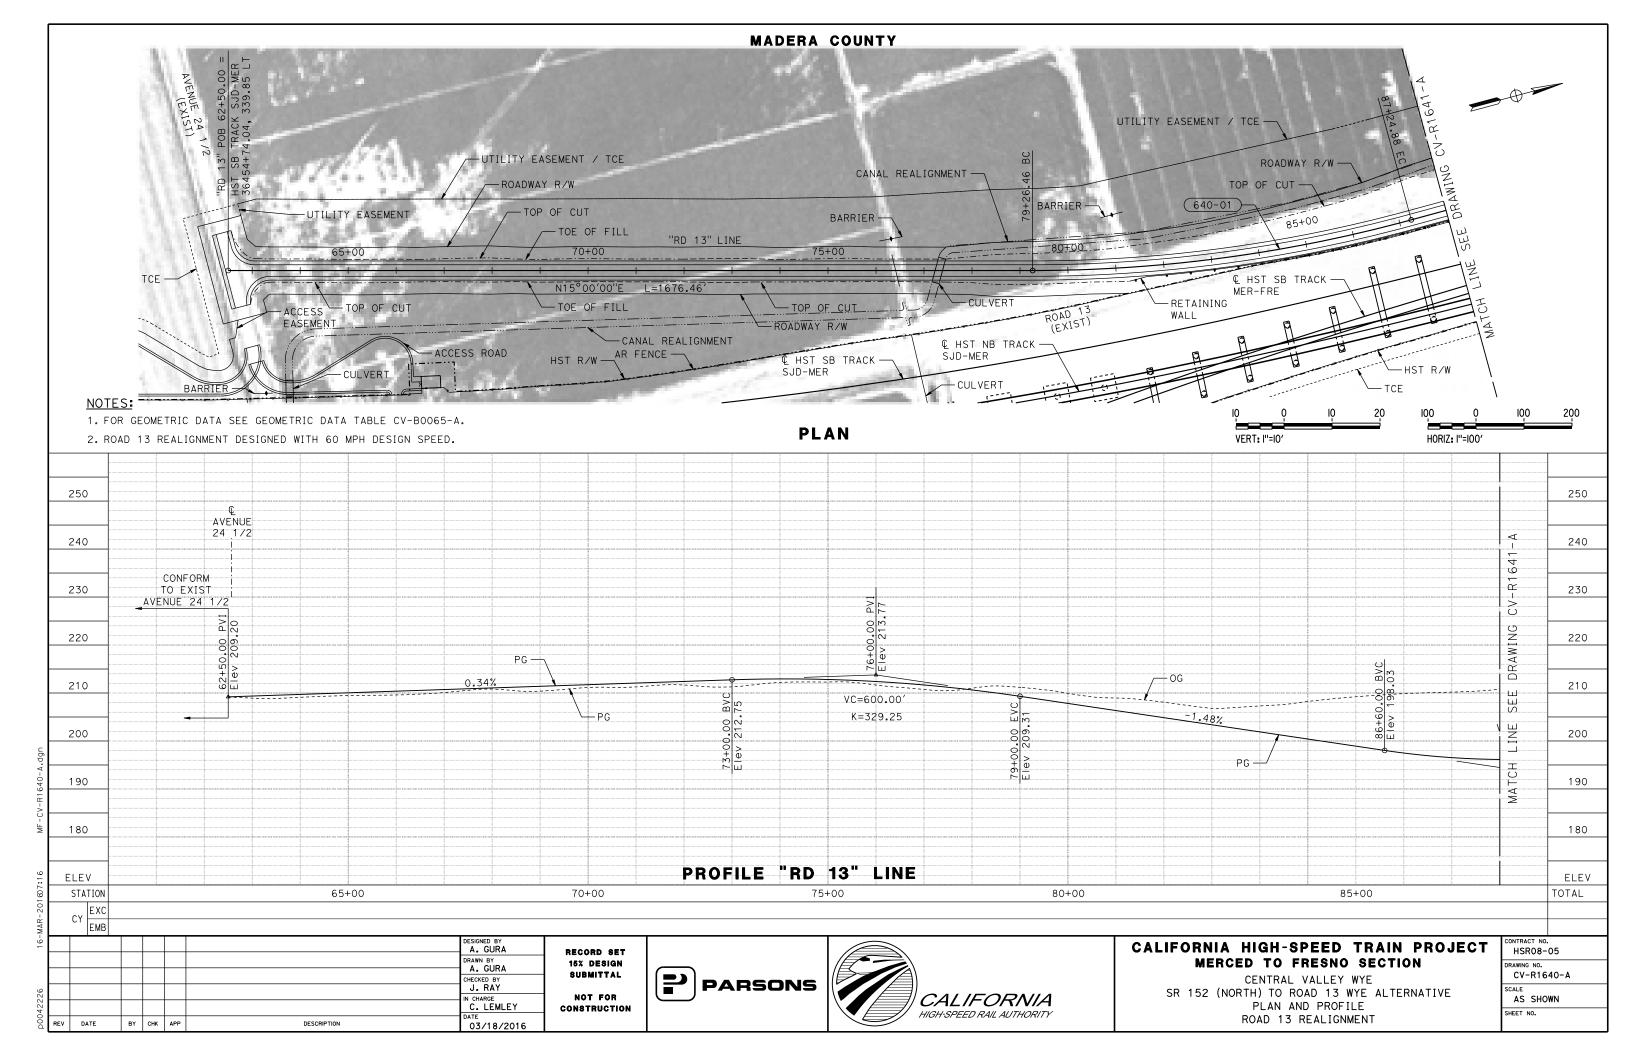

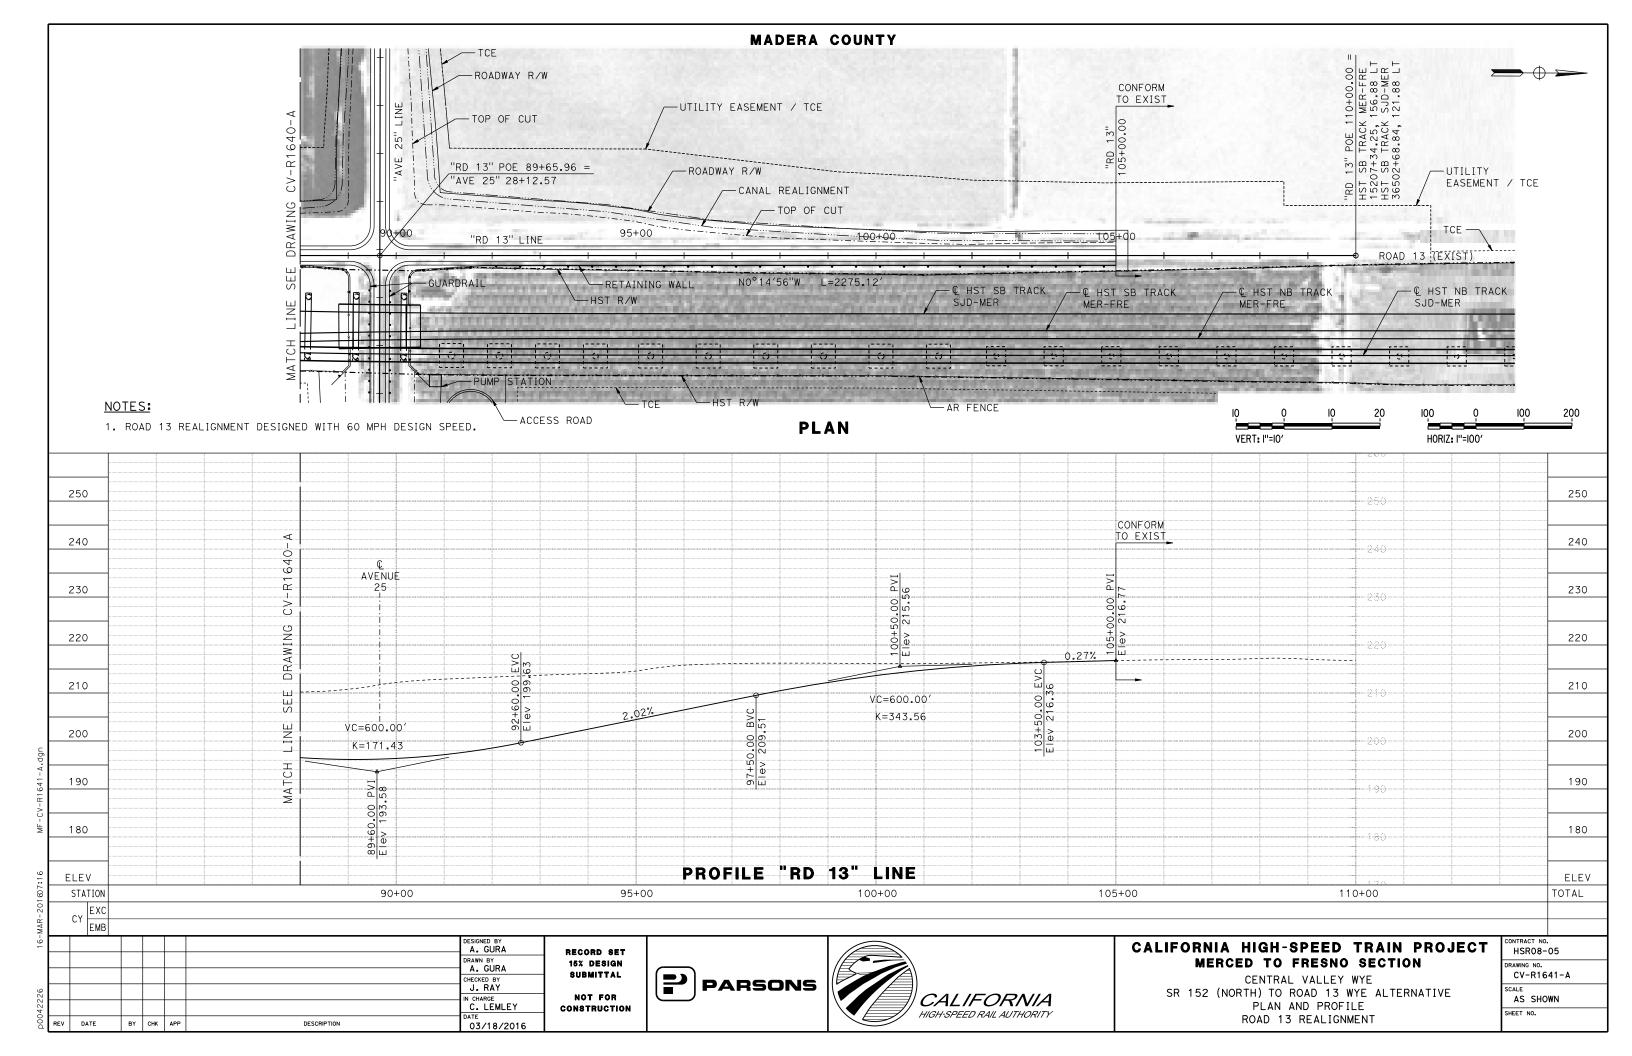

### INDIANA ROAD DETOUR:

- 1. CONSTRUCT TEMPORARY ROAD ON WEST SIDE OF INDIANA ROAD.
- DURING CONSTRUCTION OF INDIANA ROAD GRADE SEPARATION, DIRECT TRAFFIC ONTO TEMPORARY ROADWAY.
- RESTORE TRAFFIC TO INDIANA ROAD UPON COMPLETION OF ROADWAY REALIGNMENT WORK.
- 4. REMOVE TEMPORARY ROADWAY.

# SR 59 DETOUR:

FOR STAGE CONSTRUCTION DETAIL OF SR 59 SEE DRAWINGS CV-I4100-A TO CV-I4103-A.

### ROAD 4 / LINCOLN ROAD DETOUR:

- DURING CONSTRUCTION OF ROAD 4 / LINCOLN ROAD GRADE SEPARATION, DETOUR NB TRAFFIC TO EB AVE 21, NB ROAD 6, WB SR 152, NB RD 5 THEN WB AVENUE 23 1/2.
- 2. DETOUR SB TRAFFIC TO EB AVENUE 23 1/2, SB RD 5. EB SR 152. SB ROAD 6. THEN WB AVE 21.
- RESTORE TRAFFIC TO ROAD 4 / LINCOLN RD UPON COMPLETION OF GRADE SEPARATION WORK.

# ROAD 9 / HEMLOCK ROAD DETOUR:

 FOR STAGE CONSTRUCTION DETAIL OF RD 9 / HEMLOCK RD SEE DRAWINGS CV-I4160-A TO CV-I4163-A.

### ROAD 12 DETOUR:

- DURING CONSTRUCTION OF RD 12 GRADE SEPARATION, DETOUR NB TRAFFIC TO EB AVE 22 1/2, NB RD 13, THEN WB AVE 24.
- 2. DETOUR SB TRAFFIC TO EB AVE 24, SB RD 13, THEN WB AVE 22 1/2.
- RESTORE TRAFFIC TO RD 12 UPON COMPLETION OF GRADE SEPARATION WORK.

# SR 152 AT ROAD 12 DETOUR:

- CONSTRUCT PROPOSED EASTBOUND AND WESTBOUND LANES OF SR 152.
- 2. SHIFT EASTBOUND AND WESTBOUND SR 152 TRAFFIC ONTO PROPOSED SR 152 REALIGNMENT.
- 3. DEMOLISH EXISTING SR 152.

# SR 233 / ROBERTSON BOULEVARD DETOUR:

 FOR STAGE CONSTRUCTION DETAIL OF SR 233 / ROBERTSON BLVD SEE DRAWINGS CV-I4210-A TO CV-I4214-A.

## ROAD 16 DETOUR:

1. FOR STAGE CONSTRUCTION DETAIL OF ROAD 16 SEE DRAWINGS CV-I4230-A TO CV-I4233-A.

#### ROAD 17 1/2 DETOUR:

- DURING CONSTRUCTION OF ROAD 17 1/2 GRADE SEPARATION, DETOUR SB TRAFFIC TO WB AVENUE 23 1/2, SB ROAD 17, EB SR 152, SB SR 99, SB AVENUE 21 1/2, THEN NB RD 19.
- DETOUR NB TRAFFIC TO SB RD 19, NB AVE 21 1/2, NB SR 99, WB SR 152, NB RD 17, THEN EB AVE 23 1/2.
- 3. RESTORE TRAFFIC TO RD 17 1/2 UPON COMPLETION OF GRADE SEPARATION.

# ROAD 20 DETOUR:

- 1. DURING CONSTRUCTION OF RD 20 GRADE SEPARATION, DETOUR NB TRAFFIC TO WB AVE 22 1/2, THEN NB RD 19 1/2, THEN TO EB AVE 23 1/2.
- 2. DETOUR SB TRAFFIC TO WB AVE 23 1/2, THEN SB RD 19 1/2, THEN EB AVE 22 1/2.
- 3. RESTORE TRAFFIC TO RD 20 UPON COMPLETION OF GRADE SEPARATION WORK.

# ROAD 22 DETOUR:

- DURING CONSTRUCTION OF RD 22 GRADE SEPARATION, DETOUR NB TRAFFIC TO NB FAIRMEAD BLVD, EB AVE 22, NB RD 20, THEN EB AVE 24.
- 2. DETOUR SB TRAFFIC TO WB AVE 24, SB RD 20, WB AVE 22, THEN SB FAIRMEAD BLVD.
- 3. BUILD TEMPORARY ROADWAY ON SOUTH SIDE OF AVE 22, CONNECTING AVE 22 TRAFFIC TO ROAD 22.
- 4. RESTORE TRAFFIC TO RD 22 AND AVE 22 UPON COMPLETION OF GRADE SEPARATION WORK.

# ROAD 24 AND AVENUE 20 1/2 DETOUR:

- 1. CONSTRUCT TEMPORARY ROADS ON WEST SIDE OF ROAD 24 AND SOUTH SIDE OF AVENUE 20 1/2
- 2. DURING CONSTRUCTION OF ROAD 24 AND AVENUE 20 1/2 REALIGNMENT, DIRECT TRAFFIC ONTO TEMPORARY ROADWAYS.
- 3. RESTORE TRAFFIC TO ROAD 24 AND AVENUE 20 1/2 UPON COMPLETION OF ROADWAY REALIGNMENT WORK.
- 4. REMOVE TEMPORARY ROADWAYS.

### AVENUE 23 1/2 DETOUR:

- 1. DURING CONSTRUCTION OF AVE 23 1/2 GRADE SEPARATION, DETOUR EB TRAFFIC TO SB RD 11, EB SR 152, THEN NB ROBERTSON BLVD.
- 2. DETOUR WB TRAFFIC TO SB ROBERTSON BLVD, WB SR 152, THEN NB RD 11.
- 3. RESTORE TRAFFIC TO AVE 23 1/2 UPON COMPLETION OF GRADE SEPARATION WORK.

#### ROAD 13 DETOUR

- NO CONCURRENT CONSTRUCTION OF ROAD 13 AND AVENUE 25 IS ALLOWED.
- DURING CONSTRUCTION OF RD 13 GRADE SEPARATION, DETOUR NB TRAFFIC TO EB AVENUE 23 1/2, NB RD 14, THEN WB AVE 25 1/2.
- 3. DETOUR SB TRAFFIC TO EB AVENUE 25 1/2, SB ROAD 14, THEN WB AVENUE 23 1/2.
- 4. RESTORE TRAFFIC TO ROAD 13 UPON COMPLETION OF GRADE SEPARATION WORK.

#### AVENUE 25 DETOUR:

- DURING CONSTRUCTION OF AVE 25 GRADE SEPARATION, DETOUR EB TRAFFIC TO NB RD 12, EB AVE 26, SB RD 13, THEN EB AVE 25 1/2.
- 2. DETOUR WB TRAFFIC TO NB ROAD 14, WB AVENUE 25 1/2, NB RD 13, WB AVENUE 26, THEN SB ROAD 12.
- 3. RESTORE TRAFFIC TO AVENUE 25 UPON COMPLETION OF GRADE SEPARATION WORK.

# CUT-AND-COVER TUNNEL AT SANDY MUSH STAGING:

 MAINTAIN ONE LANE IN EACH DIRECTION AT ALL TIMES DURING CONSTRUCTION OF CUT-AND-COVER TIMES

| DESIGNED BY | A. GURA | DRAWN BY | A. GURA | CHECKED BY | J. RAY | IN CHARGE | C. LEMLEY | DATE | BY | CHK | APP | DESCRIPTION | DATE | 10/30/2015

RECORD SET 15% DESIGN Submittal Not for

CONSTRUCTION





# CALIFORNIA HIGH-SPEED TRAIN PROJECT MERCED TO FRESNO SECTION

CENTRAL VALLEY WYE
SR 152 NORTH TO ROAD 13 WYE
STAGE CONSTRUCTION PLAN
GENERAL NOTES


HSR08-05

DRAWING NO.

CV-I0001-A

SCALE

NO SCALE

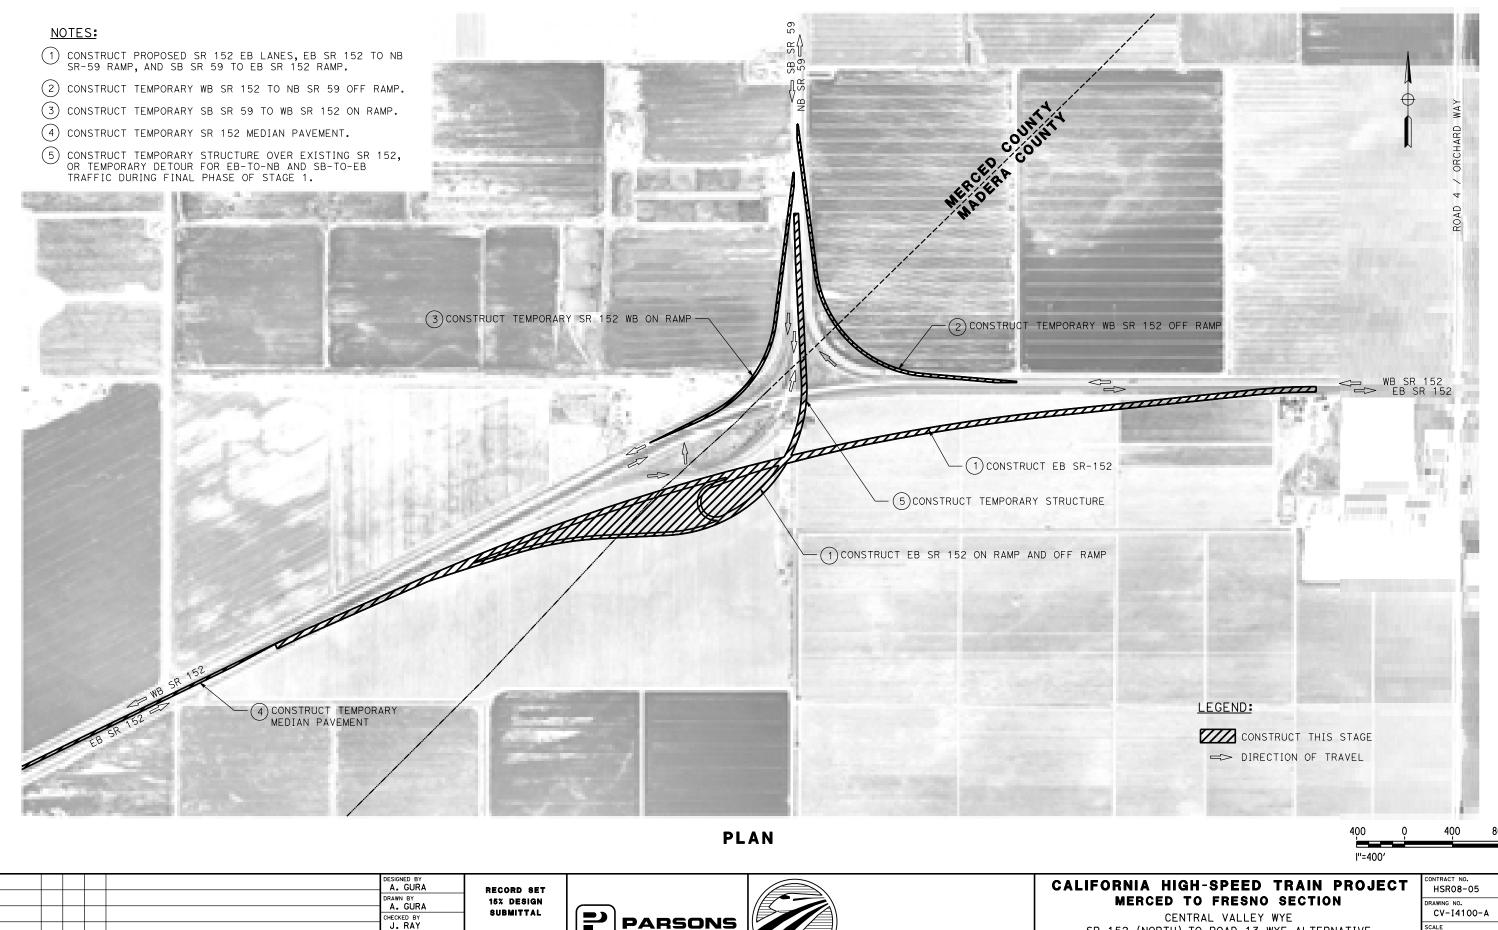

DESCRIPTION

IN CHARGE
C. LEMLEY CONSTRUCTION 10/30/2015

NOT FOR








CENTRAL VALLEY WYE SR 152 (NORTH) TO ROAD 13 WYE ALTERNATIVE STAGE CONSTRUCTION PLAN SR 59/SR 152 STAGE 1 OF 4

H3K06-05
DRAWING NO.
CV-I4100-A
SCALE
AS SHOWN

SHEET NO.

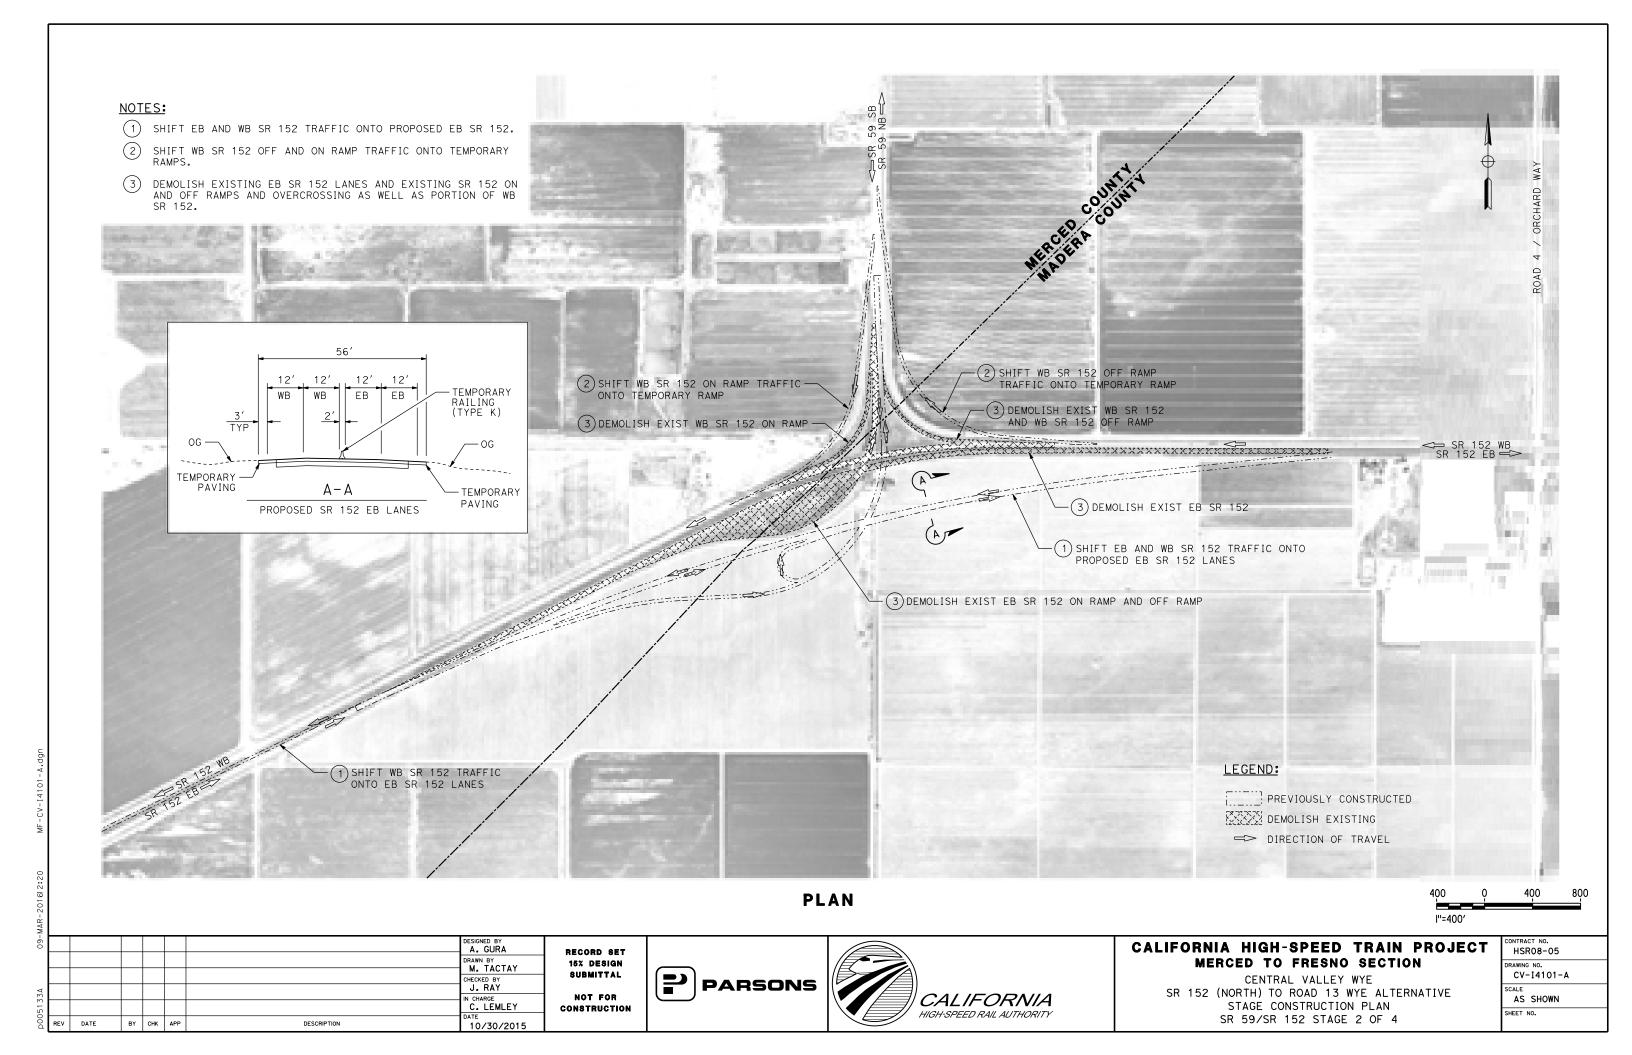

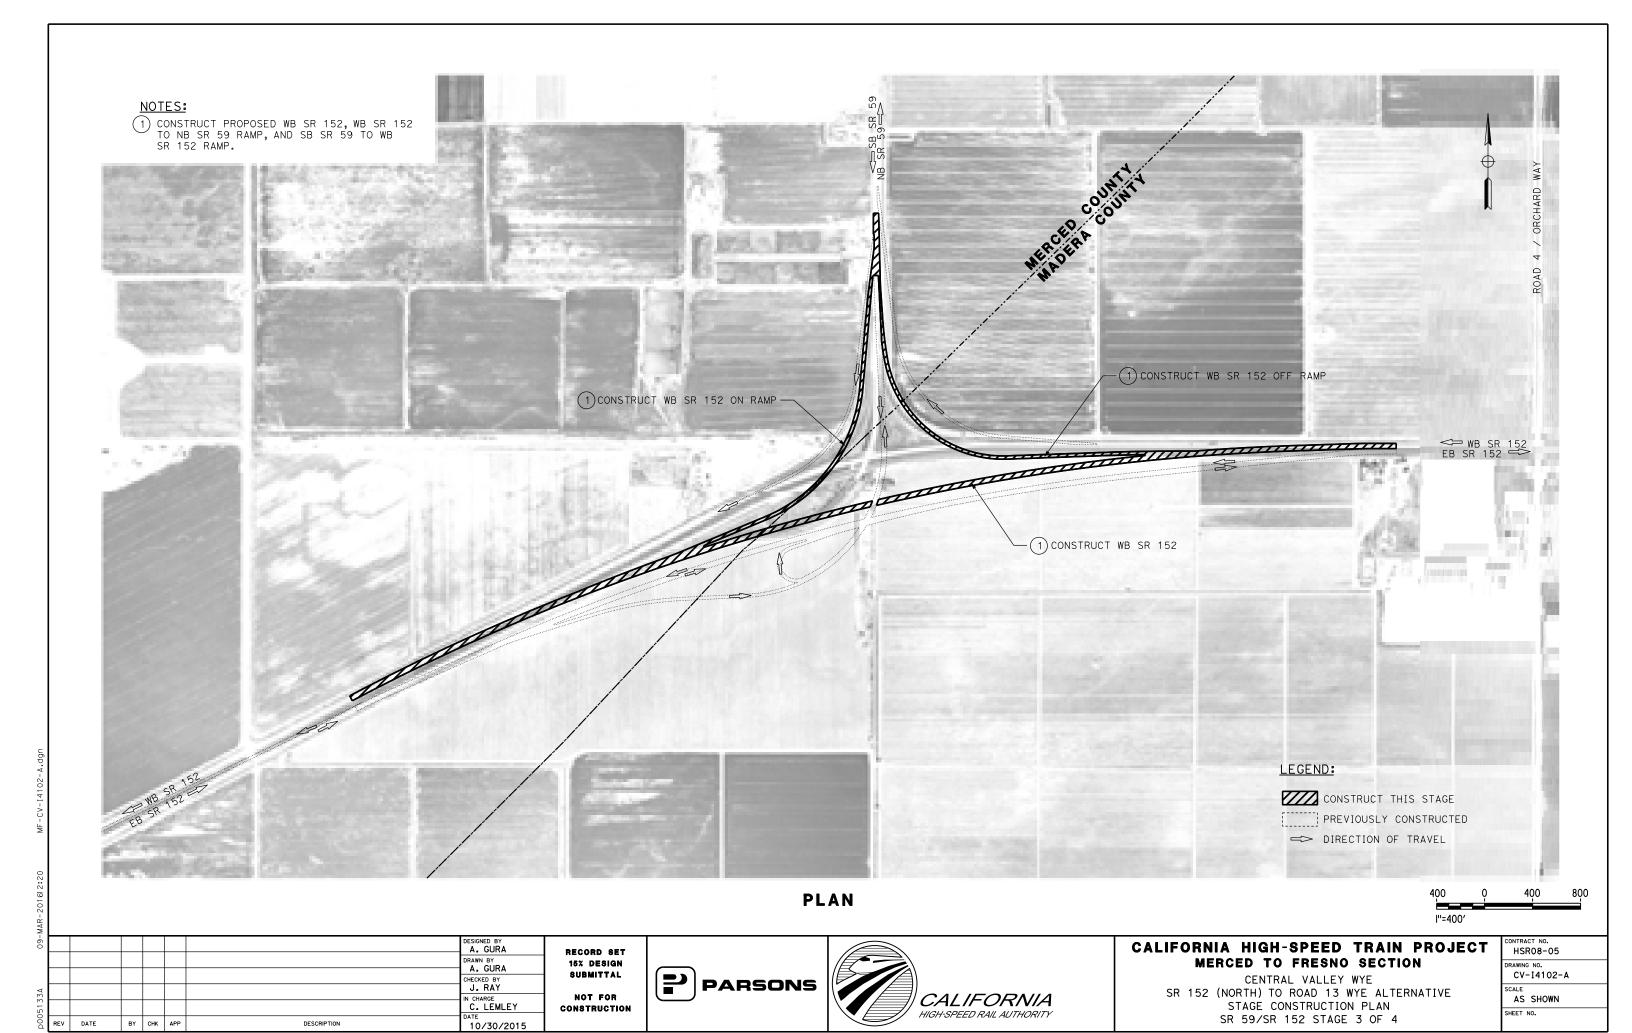

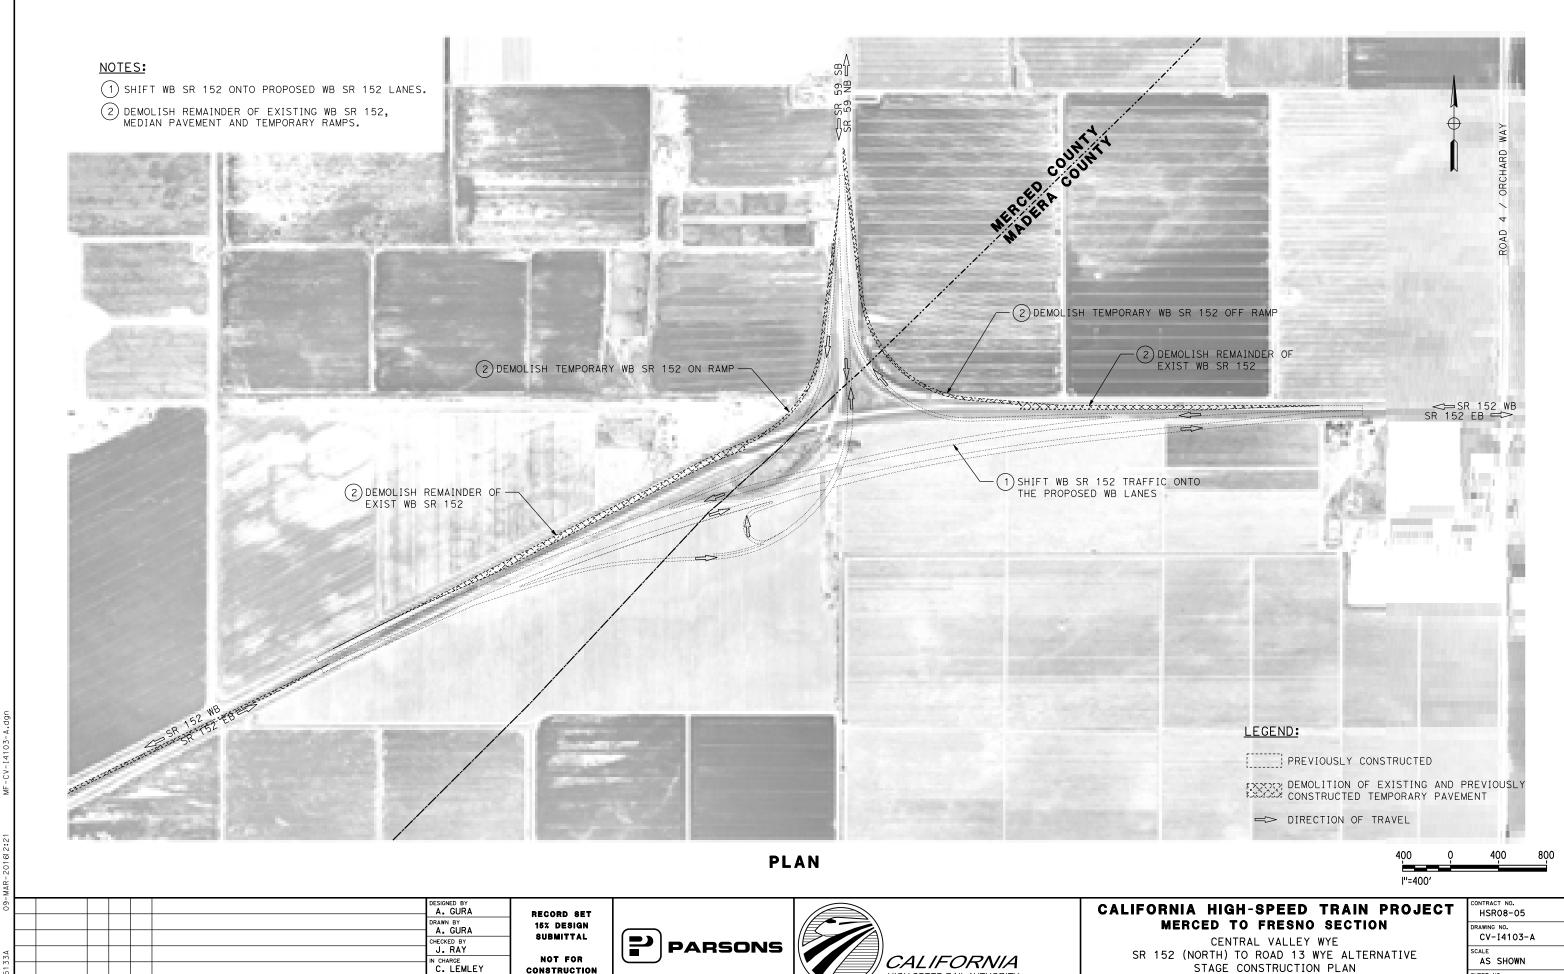

HIGH-SPEED RAIL AUTHORITY


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SR 59/SR 152 STAGE 4 OF 4

BY CHK APP

DESCRIPTION

10/30/2015

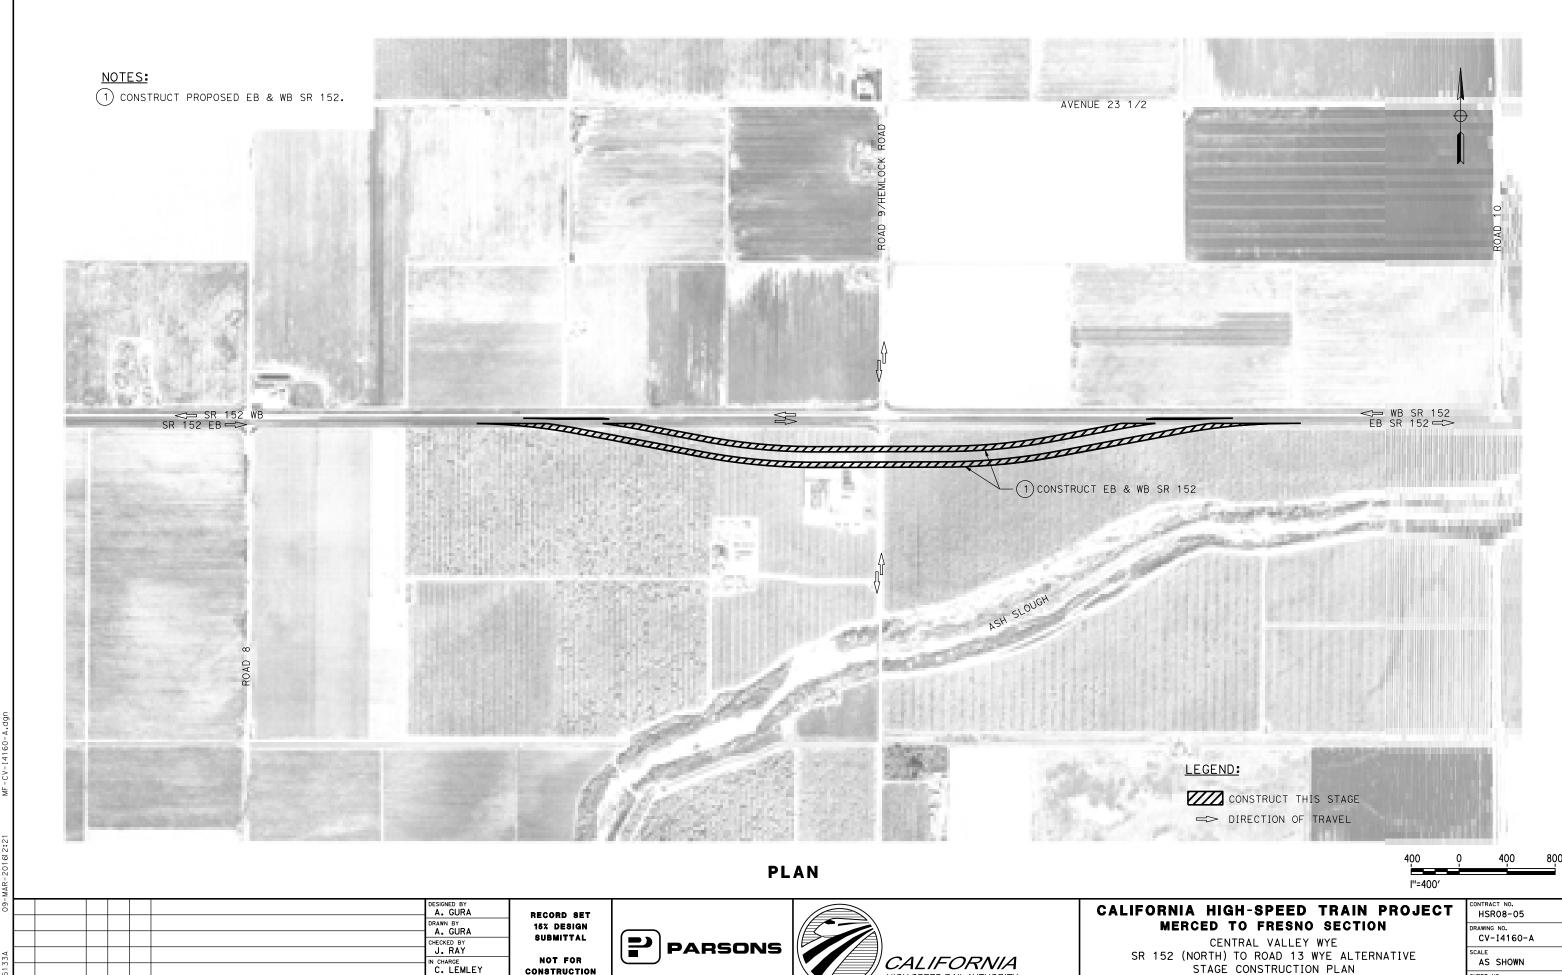

HIGH-SPEED RAIL AUTHORITY

CONSTRUCTION


10/30/2015

BY CHK APP

DESCRIPTION

ROAD 9/SR 152 STAGE 1 OF 4

SHEET NO.

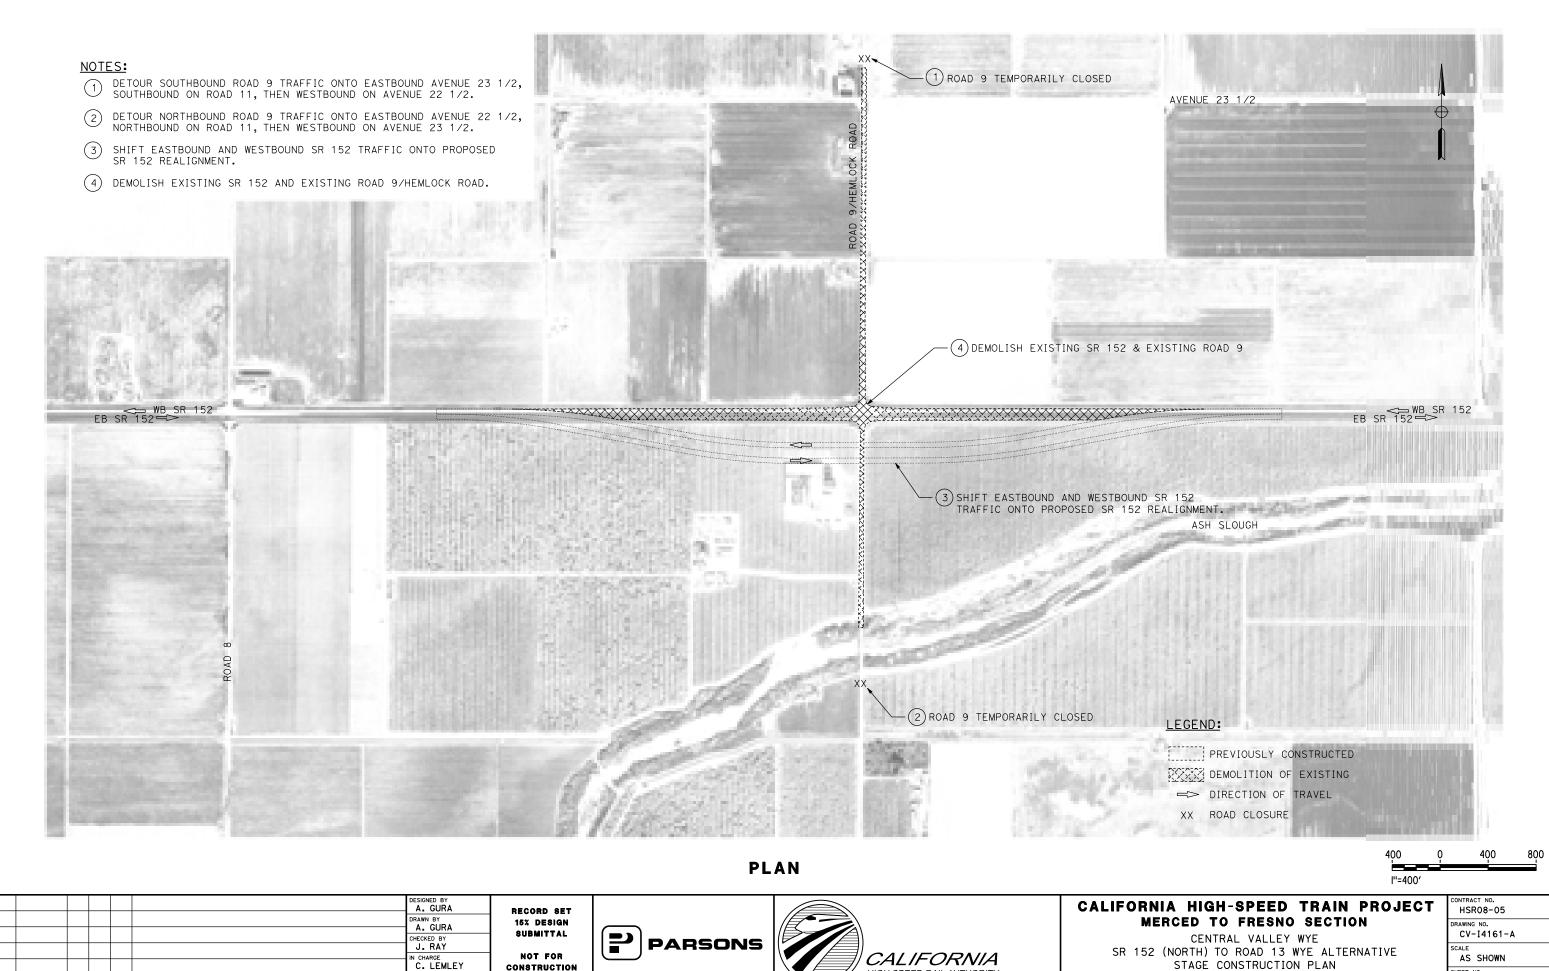


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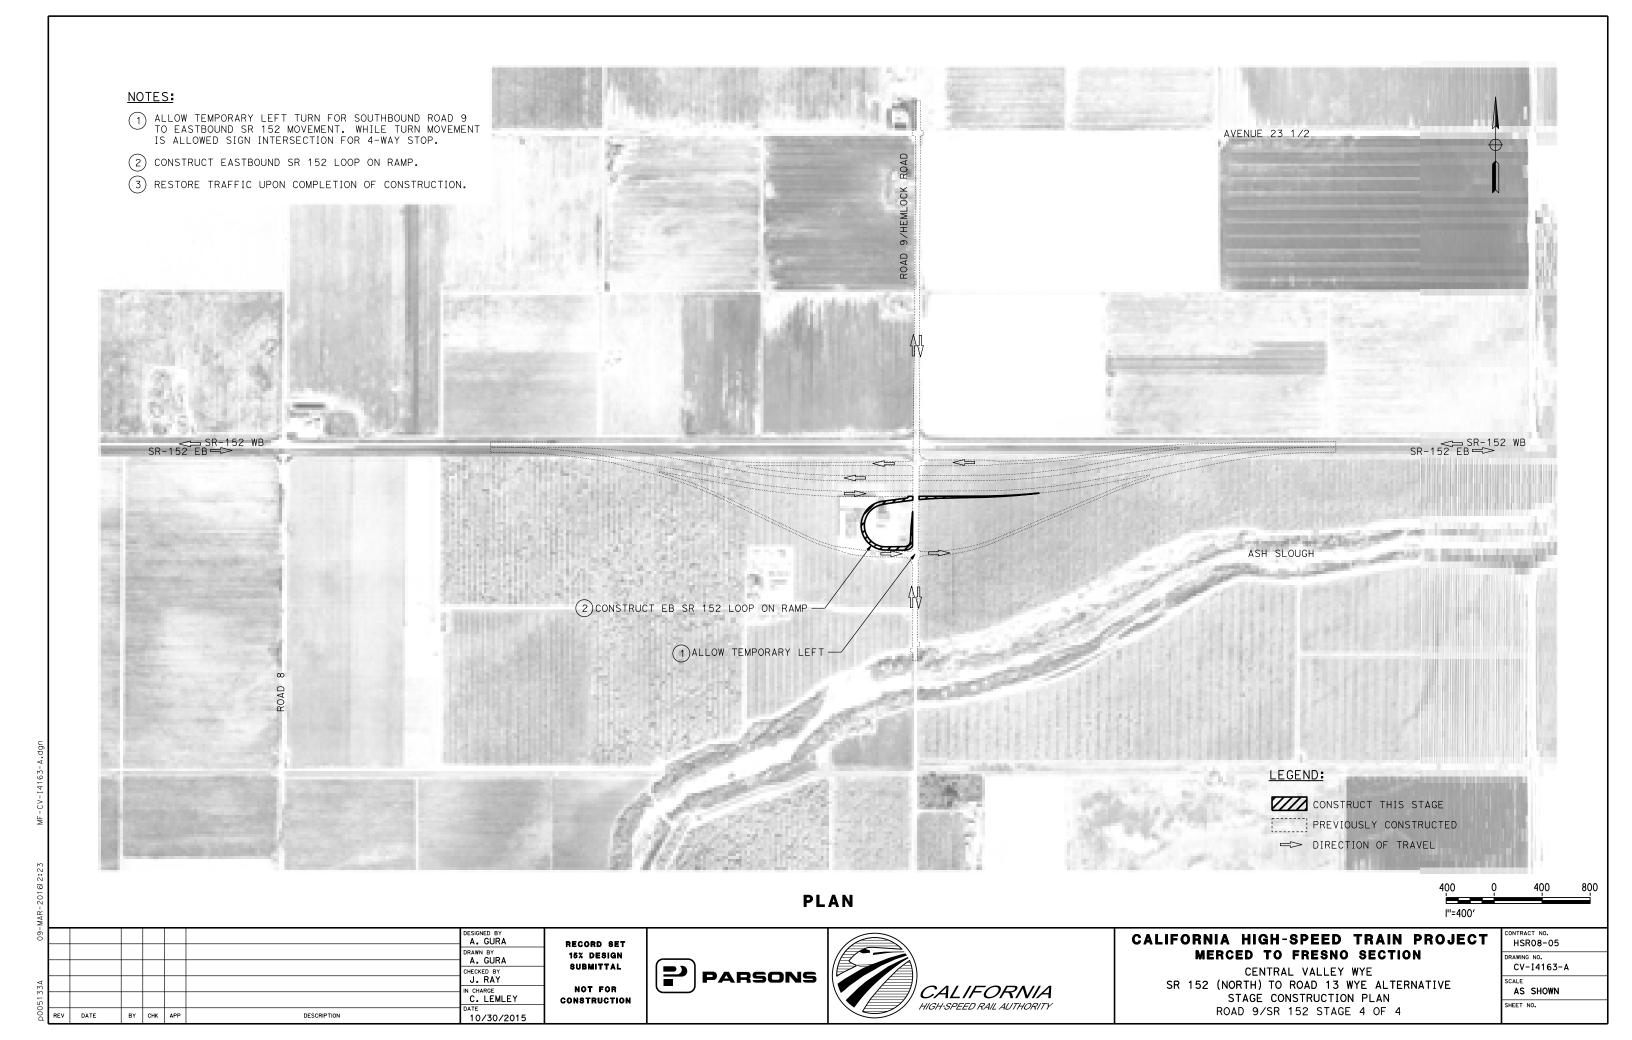
10/30/2015





STAGE CONSTRUCTION PLAN ROAD 9/SR 152 STAGE 2 OF 4


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S	CALE	
	AS SHOWN	
Sł	EET NO.	•




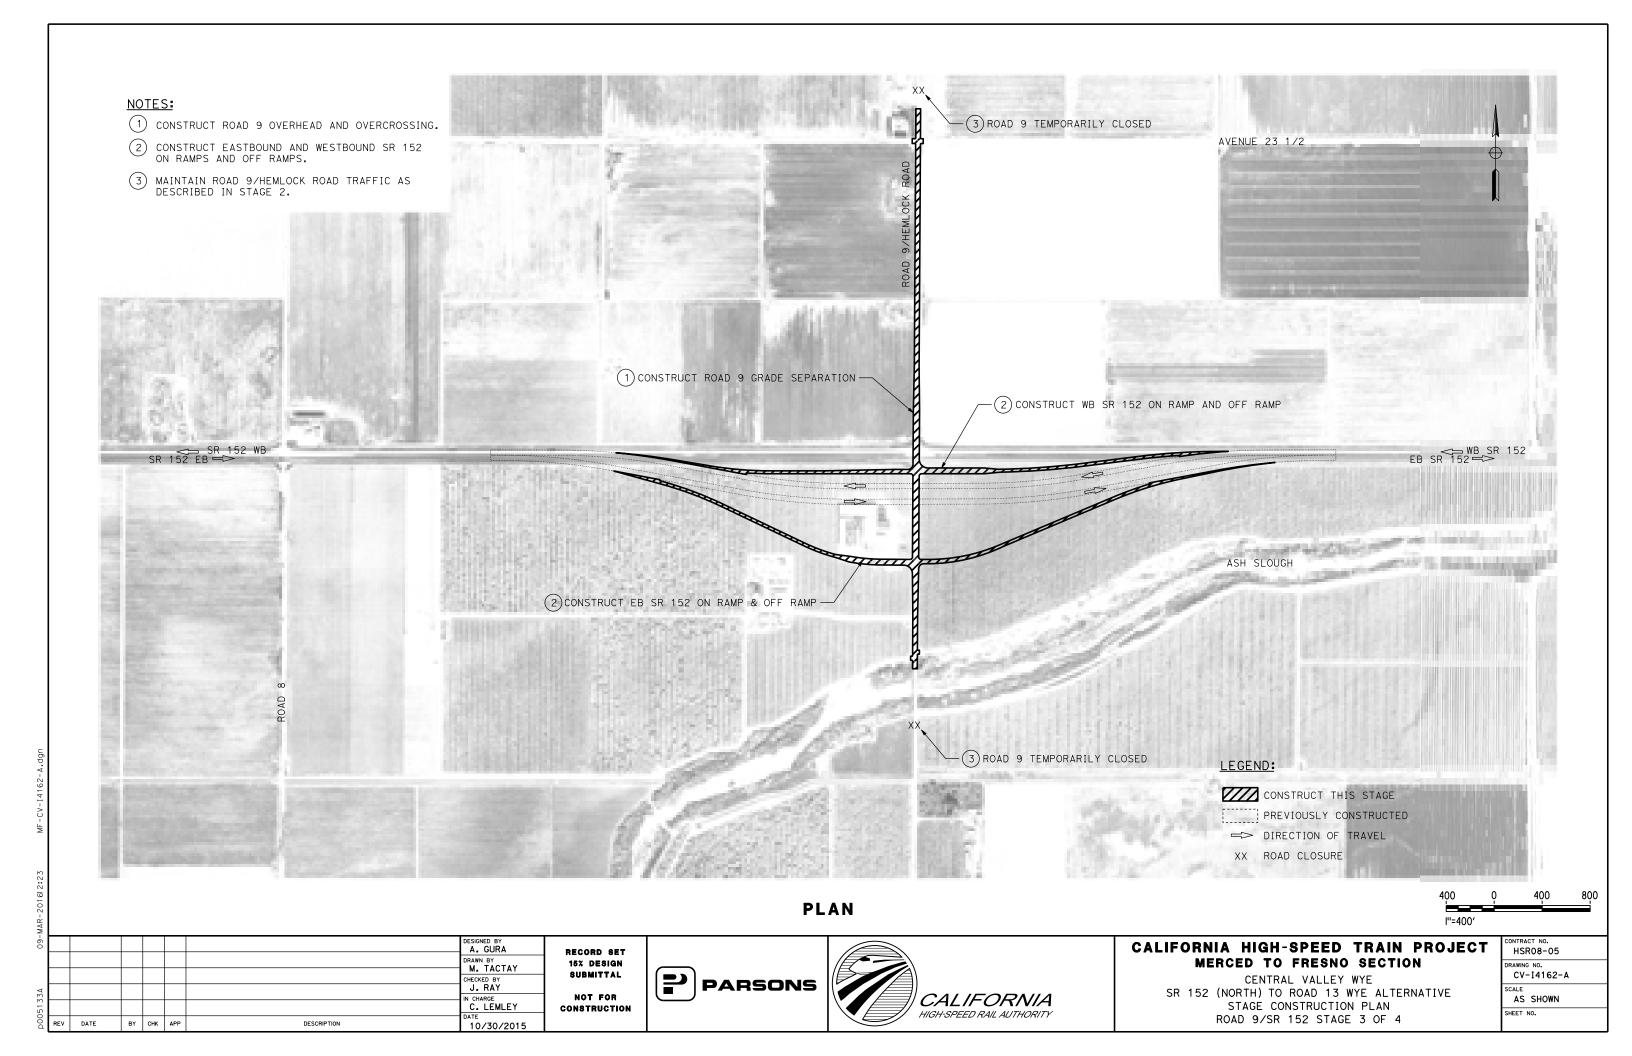


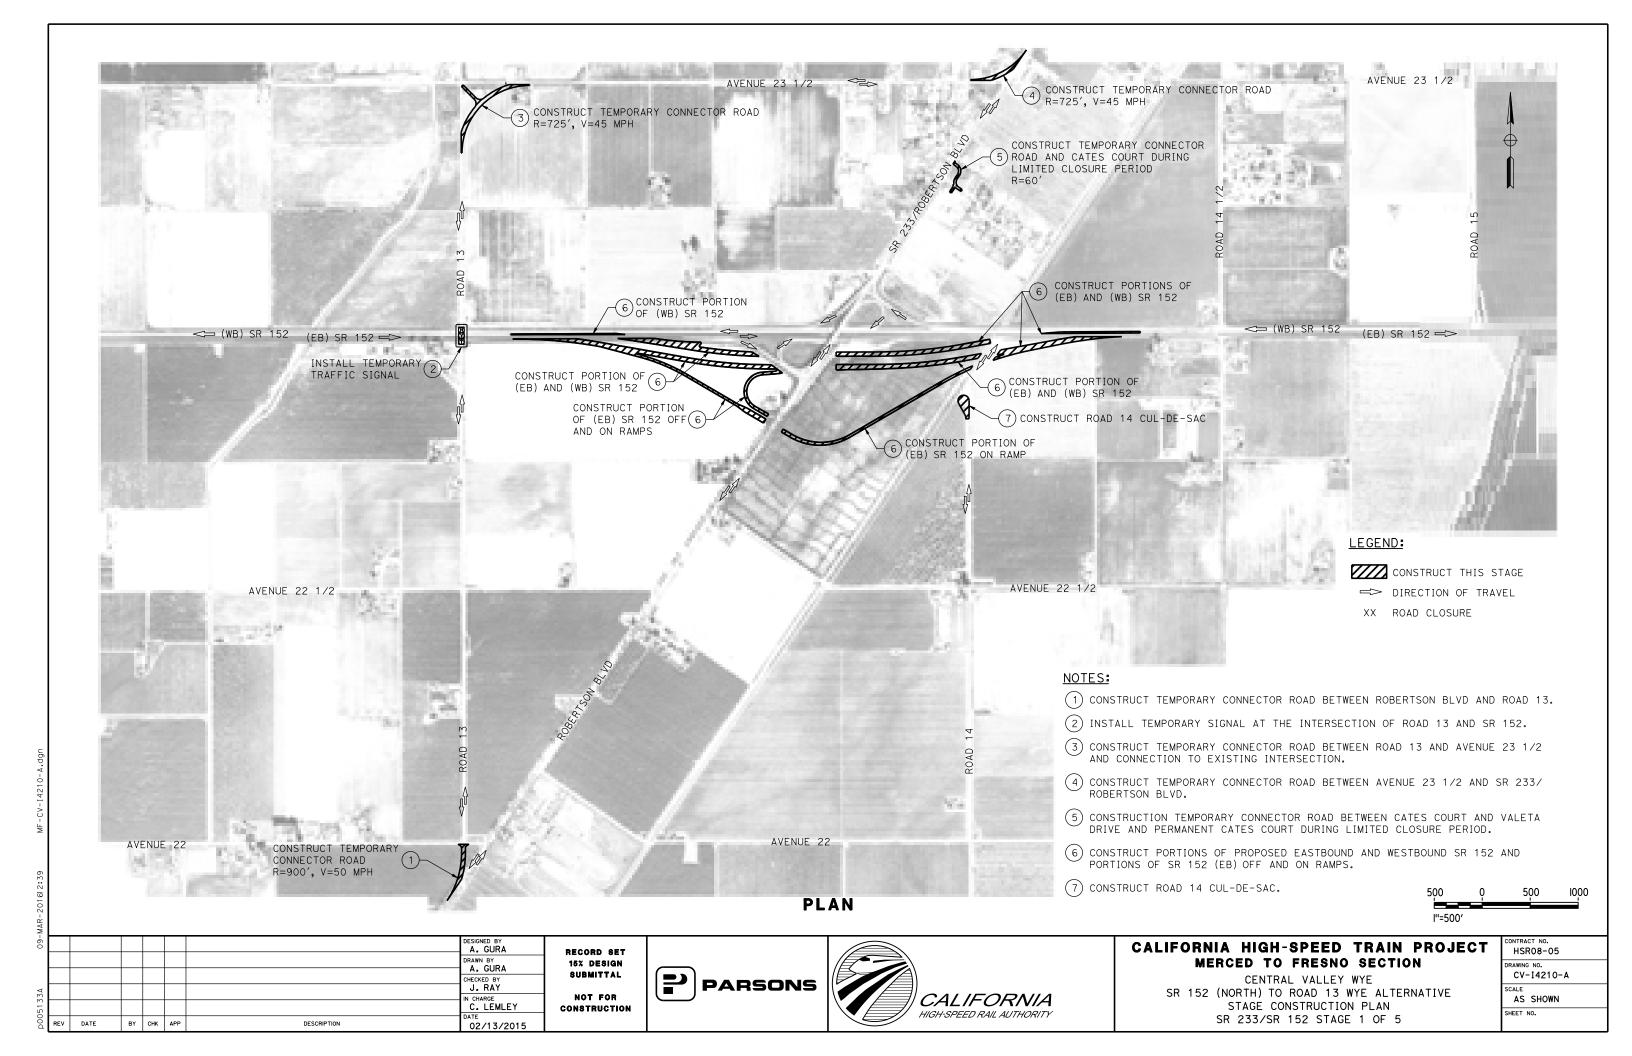


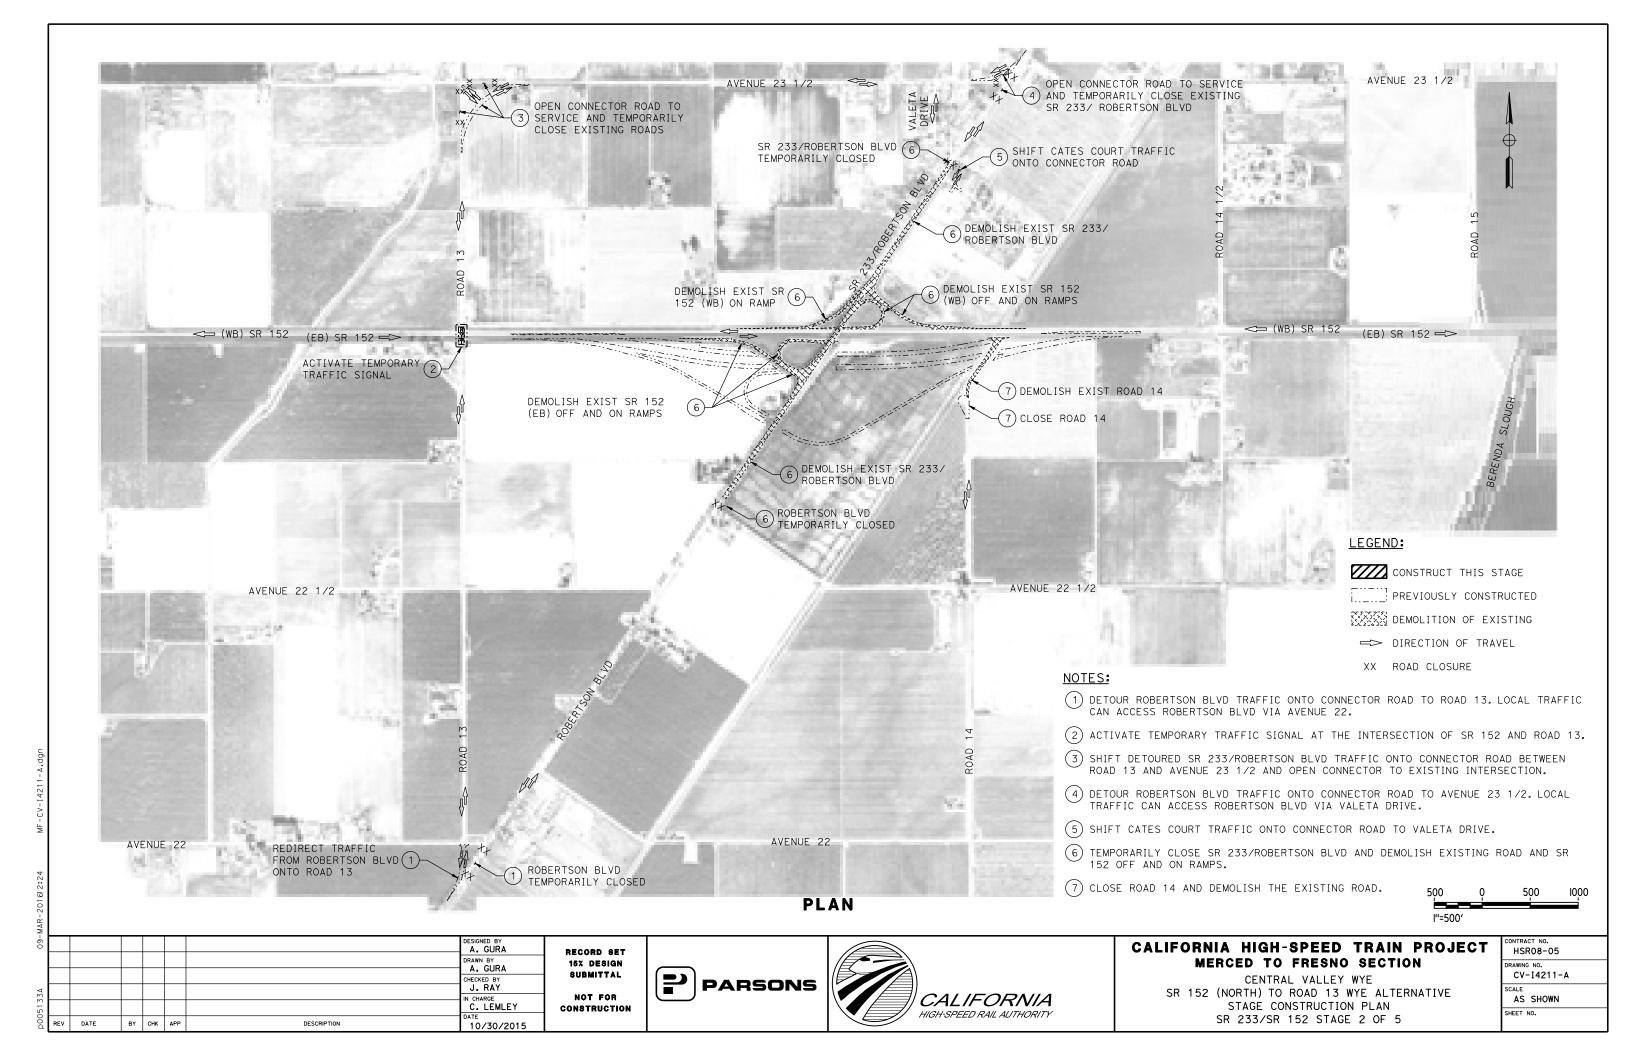

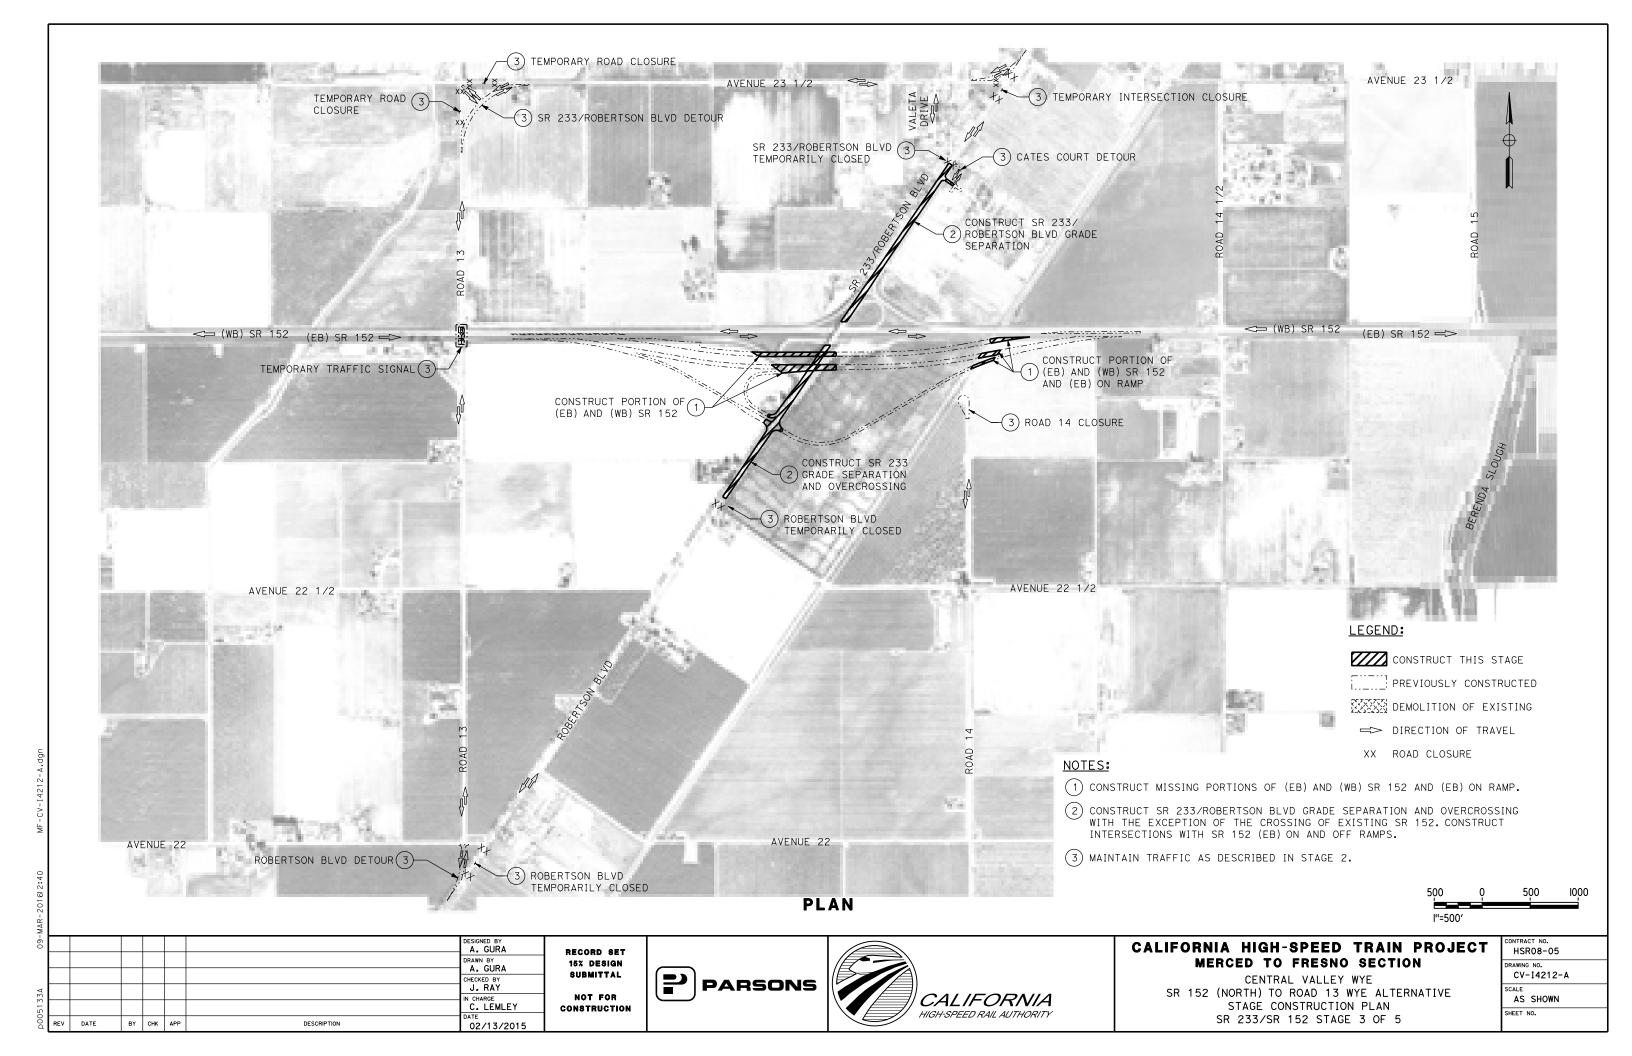

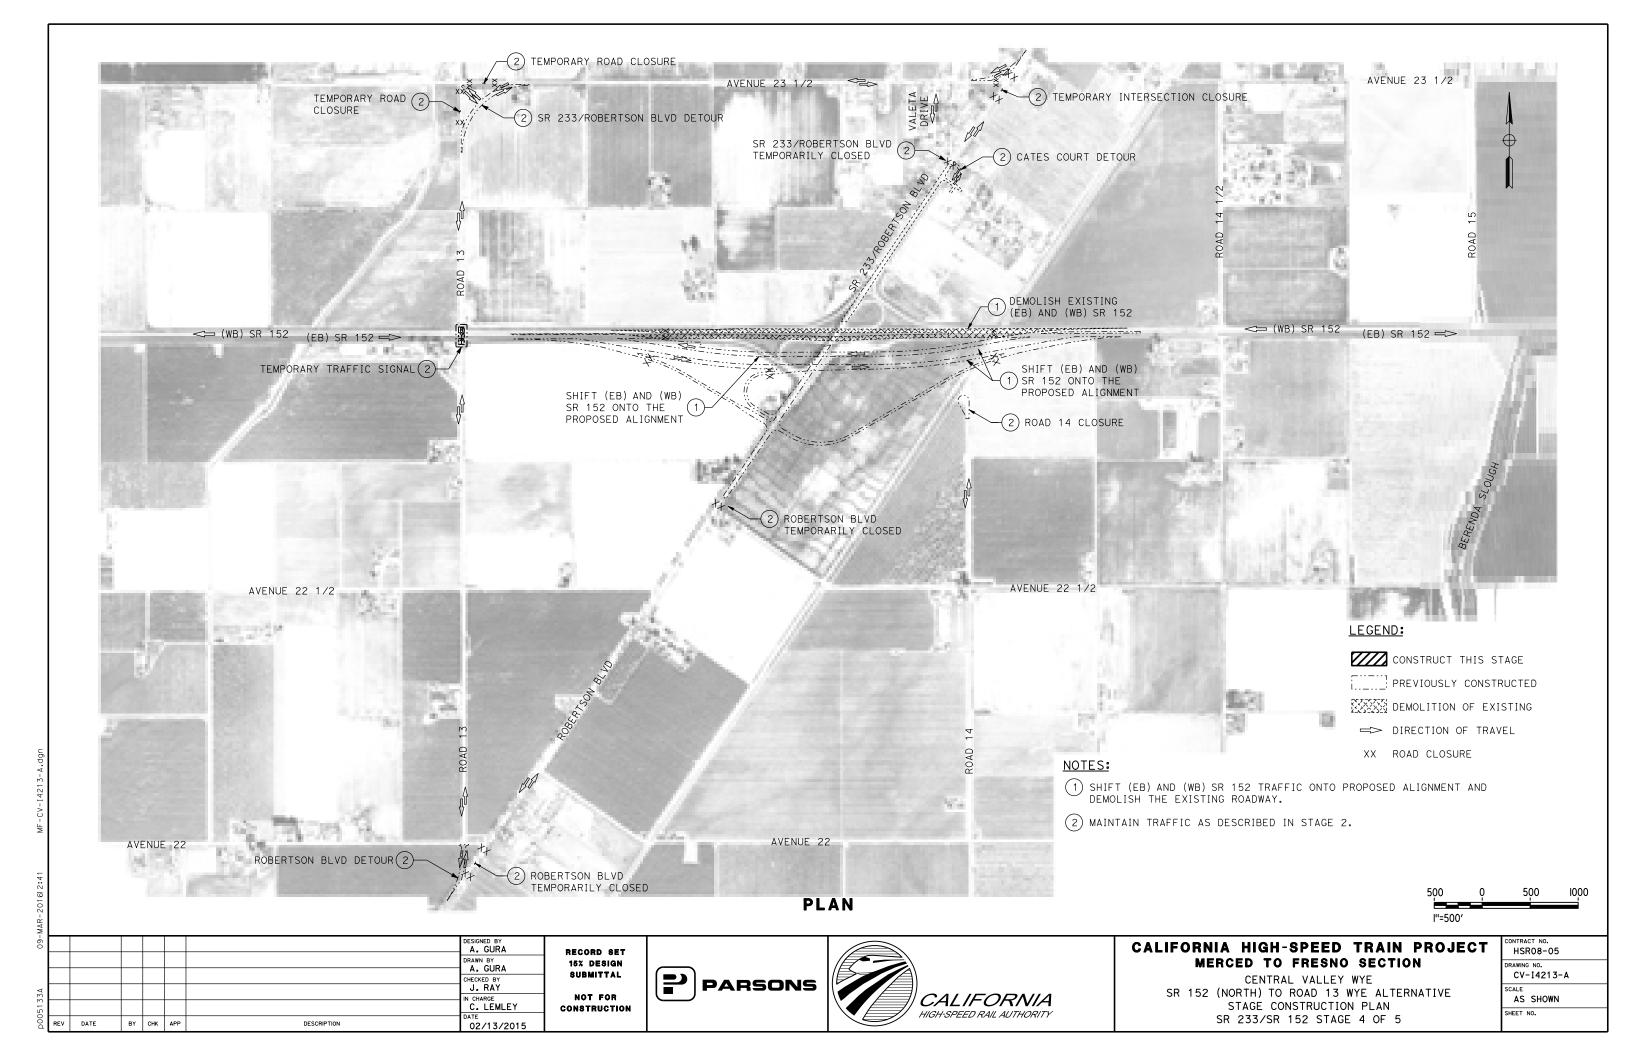

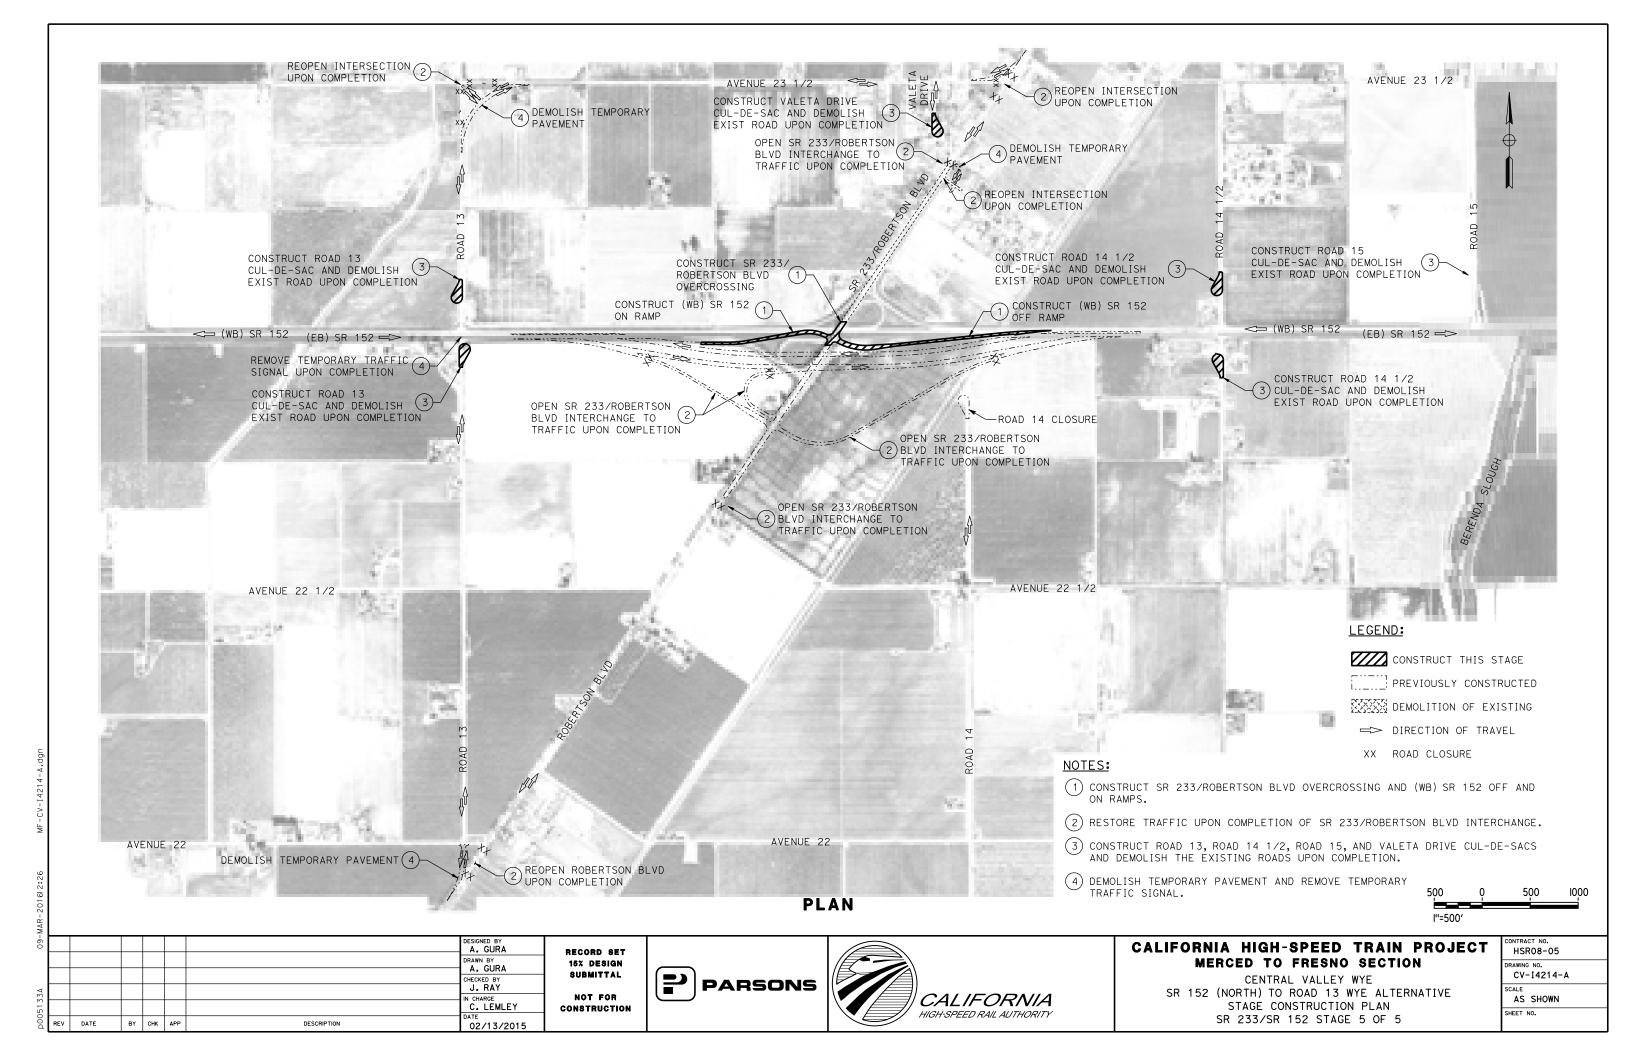

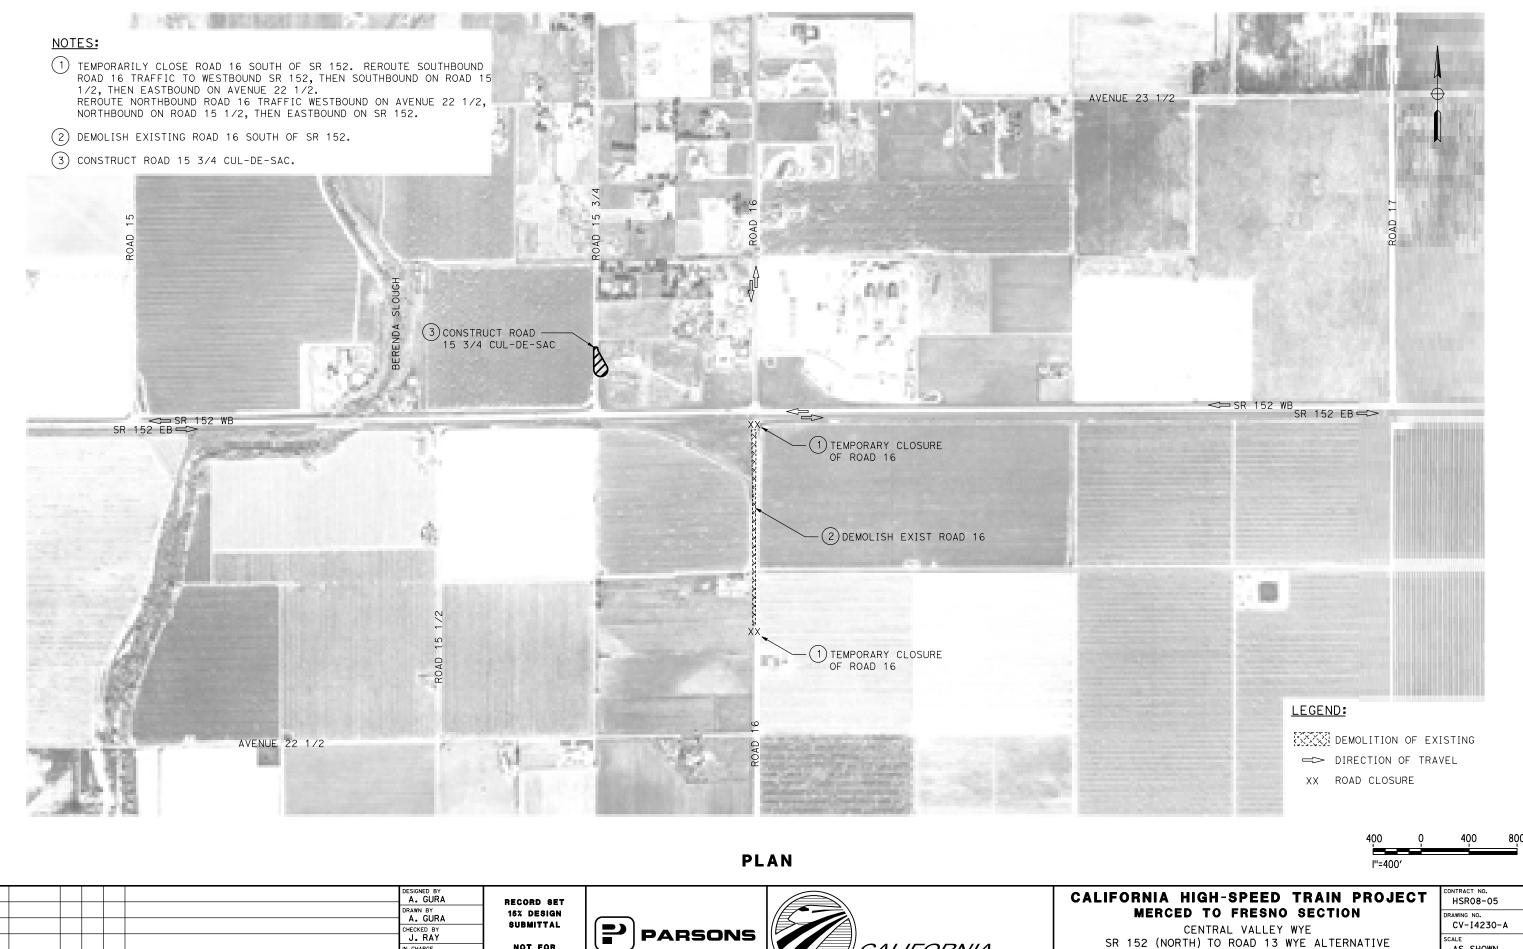

CALIFORNIA

HIGH-SPEED RAIL AUTHORITY

NOT FOR

CONSTRUCTION

IN CHARGE
C. LEMLEY

10/30/2015


BY CHK APP

DESCRIPTION

AS SHOWN SHEET NO.

STAGE CONSTRUCTION PLAN

ROAD 16/SR 152 STAGE 1 OF 4

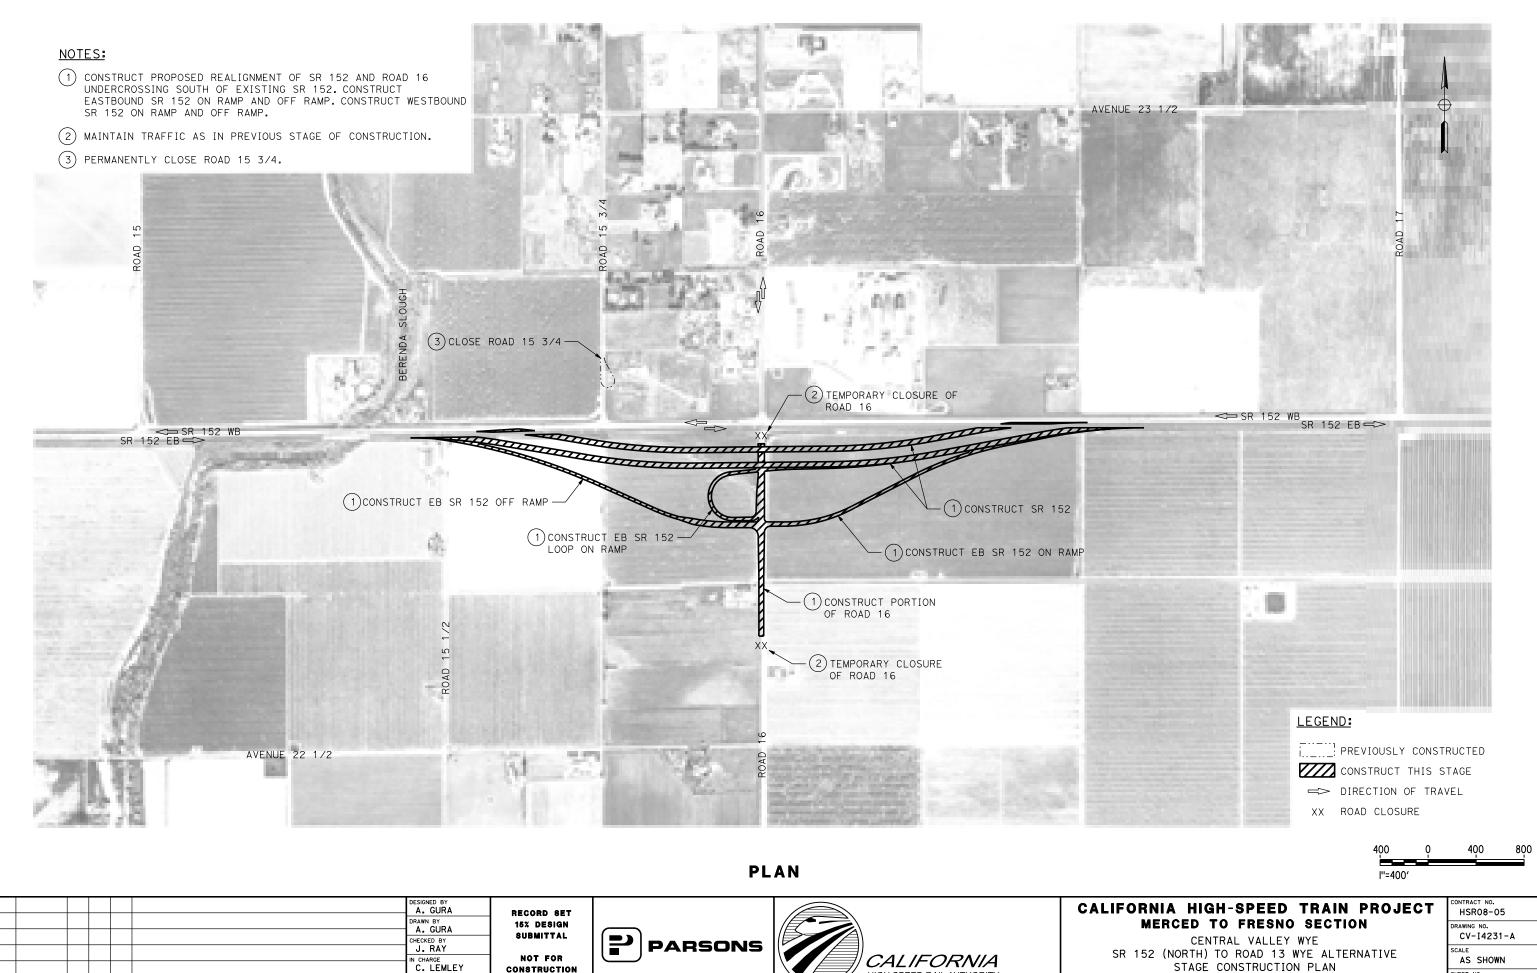


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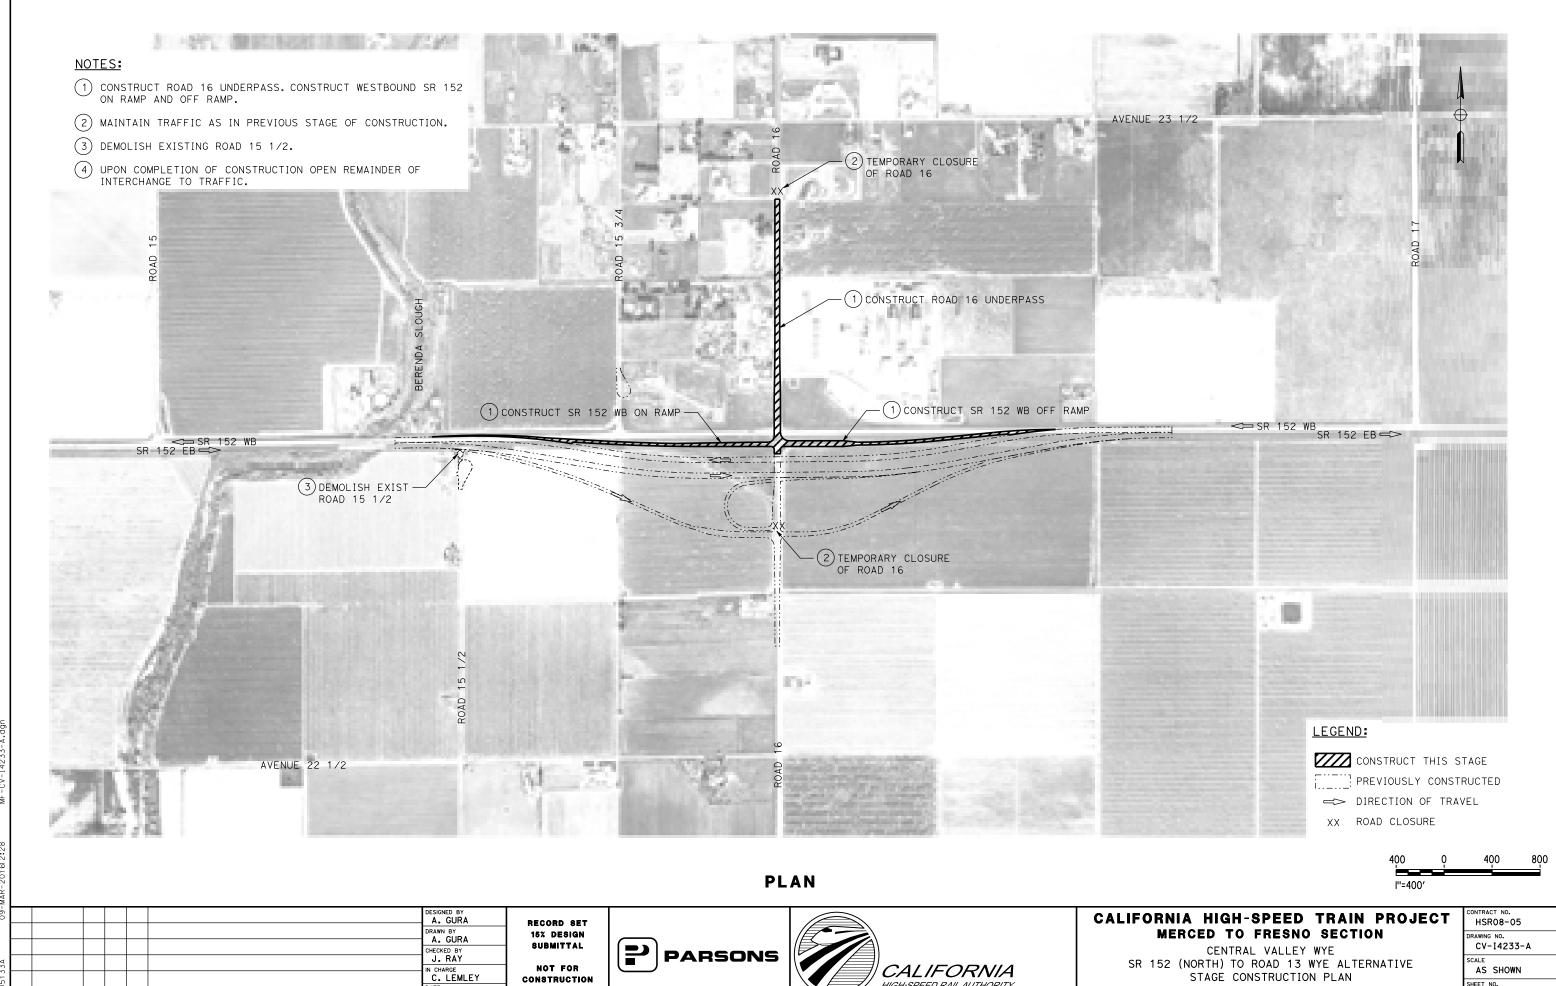
10/30/2015

HIGH-SPEED RAIL AUTHORITY

SHEET NO.

STAGE CONSTRUCTION PLAN ROAD 16/SR 152 STAGE 2 OF 4



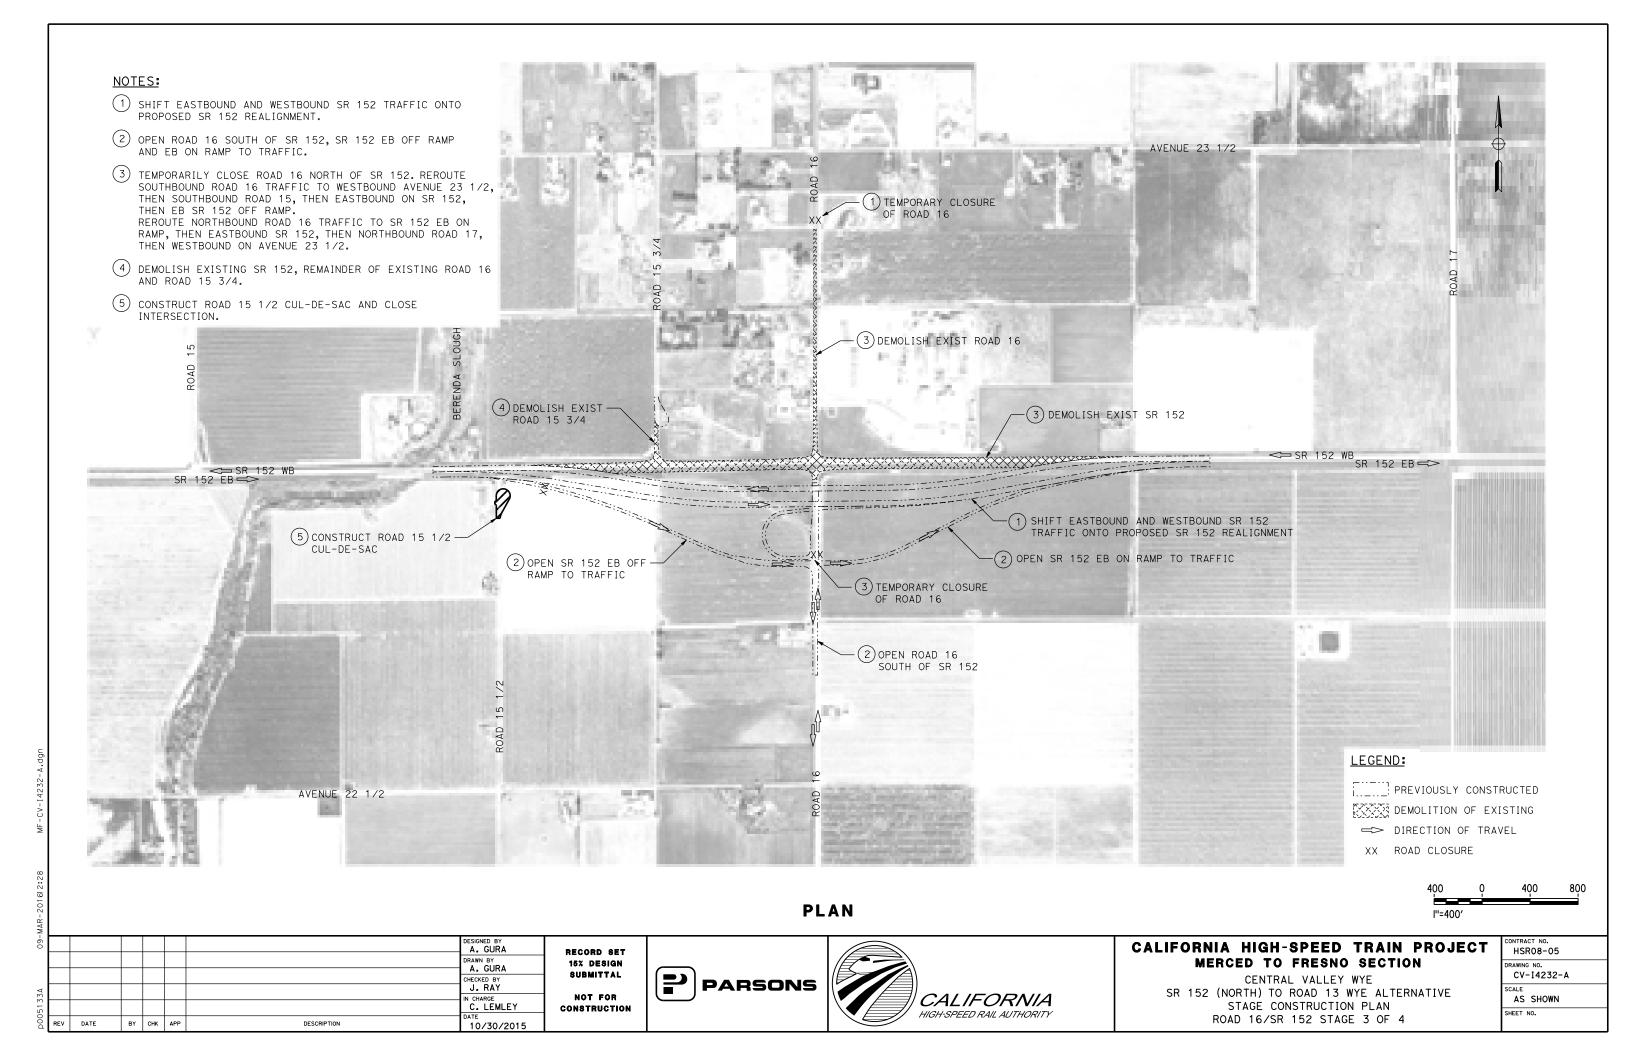

DESCRIPTION

10/30/2015



ROAD 16/SR 152 STAGE 4 OF 4

HSR08-05		
DRAWING NO.		
CV-14233-A		
SCALE		
AS SHOWN		
SHEET NO.		