


Merced to Fresno Section: Central Valley Wye

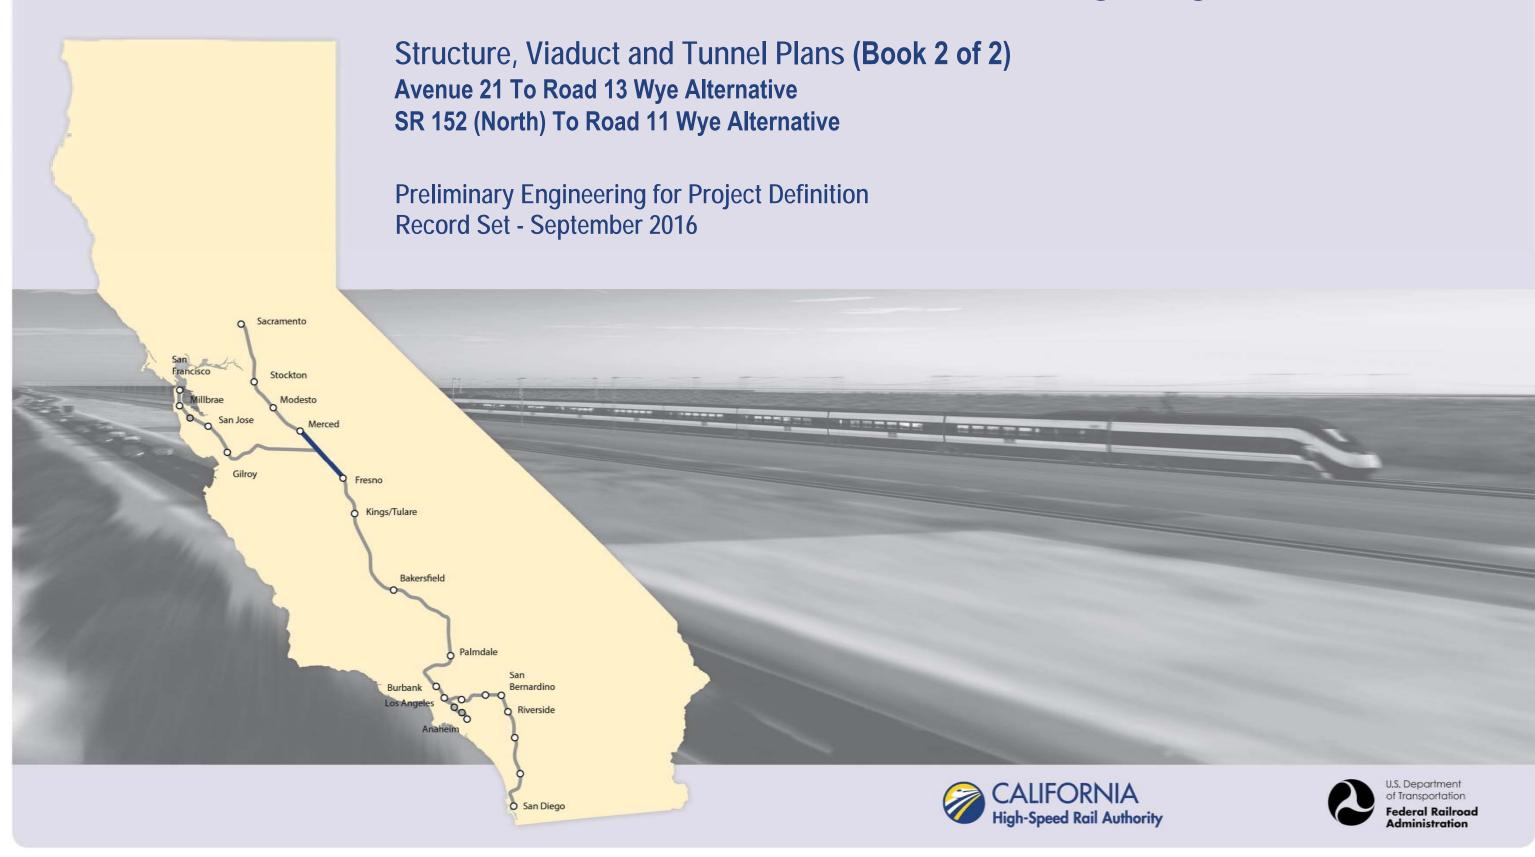

			INDEX OF DRAWINGS	
DRAWING NO.	SECTION	ALIGNMENT / PLAN SET	TITLE	DESCRIPTION
			GENERAL	
ST-B0001	CENTRAL VALLEY WYE	STRUCTURE, VIADUCT AND TUNNEL PLANS	COVER	
ST-B0002	CENTRAL VALLEY WYE	STRUCTURE, VIADUCT AND TUNNEL PLANS	INDEX OF DRAWINGS	SHEET 1 OF 8
ST-B0003	CENTRAL VALLEY WYE	STRUCTURE, VIADUCT AND TUNNEL PLANS	INDEX OF DRAWINGS	SHEET 2 OF 8
ST-B0004	CENTRAL VALLEY WYE	STRUCTURE, VIADUCT AND TUNNEL PLANS	INDEX OF DRAWINGS	SHEET 3 OF 8
ST-B0005	CENTRAL VALLEY WYE	STRUCTURE, VIADUCT AND TUNNEL PLANS	INDEX OF DRAWINGS	SHEET 4 OF 8
ST-B0006	CENTRAL VALLEY WYE	STRUCTURE, VIADUCT AND TUNNEL PLANS	INDEX OF DRAWINGS	SHEET 5 OF 8
ST-B0007	CENTRAL VALLEY WYE	STRUCTURE, VIADUCT AND TUNNEL PLANS	INDEX OF DRAWINGS	SHEET 6 OF 8
ST-B0008	CENTRAL VALLEY WYE	STRUCTURE, VIADUCT AND TUNNEL PLANS	INDEX OF DRAWINGS	SHEET 7 OF 8
ST-B0009	CENTRAL VALLEY WYE	STRUCTURE, VIADUCT AND TUNNEL PLANS	INDEX OF DRAWINGS	SHEET 8 OF 8
ST-B0010	CENTRAL VALLEY WYE	STRUCTURE, VIADUCT AND TUNNEL PLANS	ABBREVIATIONS	SHEET 1 OF 2
ST-B0011	CENTRAL VALLEY WYE	STRUCTURE, VIADUCT AND TUNNEL PLANS	ABBREVIATIONS	SHEET 2 OF 2
ST-B4000	CENTRAL VALLEY WYE	STRUCTURE, VIADUCT AND TUNNEL PLANS	LOCATION PLAN	
		SR 152	(NORTH) TO ROAD 13 WYE ALTERNATIVE	
ST-B4001-A	CENTRAL VALLEY WYE	SR 152 (NORTH) TO ROAD 13 WYE ALTERNATIVE	KEY MAP OF STRUCTURAL PLANS	SHEET 1 OF 2
ST-B4002-A	CENTRAL VALLEY WYE	SR 152 (NORTH) TO ROAD 13 WYE ALTERNATIVE	KEY MAP OF STRUCTURAL PLANS	SHEET 2 OF 2
ST-K1050-A	CENTRAL VALLEY WYE	SR 152 (NORTH) TO ROAD 13 WYE ALTERNATIVE	GENERAL PLAN (SJD-FRE)	INDIANA ROAD OVERHEAD
ST-K1060-A	CENTRAL VALLEY WYE	SR 152 (NORTH) TO ROAD 13 WYE ALTERNATIVE	GENERAL PLAN (SJD-FRE)	WILLIS ROAD UNDERPASS
ST-K1065-A	CENTRAL VALLEY WYE	SR 152 (NORTH) TO ROAD 13 WYE ALTERNATIVE	GENERAL PLAN (SJD-FRE)	SAN JOAQUIN RIVER BRIDGE - 1 OF 2
ST-K3065-A	CENTRAL VALLEY WYE	SR 152 (NORTH) TO ROAD 13 WYE ALTERNATIVE	TYPICAL SECTION (SJD-FRE)	SAN JOAQUIN RIVER BRIDGE - 2 OF 2
ST-K1070-A	CENTRAL VALLEY WYE	SR 152 (NORTH) TO ROAD 13 WYE ALTERNATIVE	GENERAL PLAN (SJD-FRE)	MARIPOSA SLOUGH BRIDGE
ST-K1075-A	CENTRAL VALLEY WYE	SR 152 (NORTH) TO ROAD 13 WYE ALTERNATIVE	GENERAL PLAN (SJD-FRE)	HARMON ROAD UNDERPASS
ST-K1080-A	CENTRAL VALLEY WYE	SR 152 (NORTH) TO ROAD 13 WYE ALTERNATIVE	GENERAL PLAN (SJD-FRE)	AERIAL #1 - EASTSIDE BYPASS IRRIGATION DITCH - 1 OF 2
ST-K3080-A	CENTRAL VALLEY WYE	SR 152 (NORTH) TO ROAD 13 WYE ALTERNATIVE	TYPICAL SECTION (SJD-FRE)	AERIAL #1 - EASTSIDE BYPASS IRRIGATION DITCH - 2 OF 2
ST-K1100-A	CENTRAL VALLEY WYE	SR 152 (NORTH) TO ROAD 13 WYE ALTERNATIVE	GENERAL PLAN (SJD-FRE)	SR 59 / SR 152 INTERCHANGE - 1 OF 4
ST-K1101-A	CENTRAL VALLEY WYE	SR 152 (NORTH) TO ROAD 13 WYE ALTERNATIVE	GENERAL PLAN (SJD-FRE)	SR 59 / SR 152 INTERCHANGE - 2 OF 4
ST-K3101-A	CENTRAL VALLEY WYE	SR 152 (NORTH) TO ROAD 13 WYE ALTERNATIVE	TYPICAL SECTIONS (SJD-FRE)	SR 59 / SR 152 INTERCHANGE - 3 OF 4
ST-K1102-A	CENTRAL VALLEY WYE	SR 152 (NORTH) TO ROAD 13 WYE ALTERNATIVE	GENERAL PLAN (SJD-FRE)	SR 59 / SR 152 INTERCHANGE - 4 OF 4
ST-K1110-A	CENTRAL VALLEY WYE	SR 152 (NORTH) TO ROAD 13 WYE ALTERNATIVE	GENERAL PLAN (SJD-FRE)	LINCOLN ROAD (ROAD 4) OVERHEAD
ST-K1160-A	CENTRAL VALLEY WYE	SR 152 (NORTH) TO ROAD 13 WYE ALTERNATIVE	GENERAL PLAN (SJD-FRE)	HEMLOCK ROAD (ROAD 9) INTERCHANGE - 1 OF 2
ST-K3160-A	CENTRAL VALLEY WYE	SR 152 (NORTH) TO ROAD 13 WYE ALTERNATIVE	TYPICAL SECTIONS (SJD-FRE)	HEMLOCK ROAD (ROAD 9) INTERCHANGE - 2 OF 2
ST-K1170-A	CENTRAL VALLEY WYE	SR 152 (NORTH) TO ROAD 13 WYE ALTERNATIVE	GENERAL PLAN (SJD-FRE)	ASH SLOUGH BRIDGE - 1 OF 2
ST-K3170-A	CENTRAL VALLEY WYE	SR 152 (NORTH) TO ROAD 13 WYE ALTERNATIVE	TYPICAL SECTION (SJD-FRE)	ASH SLOUGH BRIDGE - 2 OF 2
ST-K1190-A	CENTRAL VALLEY WYE	SR 152 (NORTH) TO ROAD 13 WYE ALTERNATIVE	GENERAL PLAN (SJD-FRE)	ELM ROAD (ROAD 12) UNDERPASS
ST-K1195-A	CENTRAL VALLEY WYE	SR 152 (NORTH) TO ROAD 13 WYE ALTERNATIVE	GENERAL PLAN (SJD-FRE)	SR 152 (ROAD 12) UNDERCROSSING
ST-K1210-A	CENTRAL VALLEY WYE	SR 152 (NORTH) TO ROAD 13 WYE ALTERNATIVE	GENERAL PLAN (SJD-FRE)	ROBERTSON BOULEVARD (SR 233) INTERCHANGE - 1 OF 2
ST-K3210-A	CENTRAL VALLEY WYE	SR 152 (NORTH) TO ROAD 13 WYE ALTERNATIVE	TYPICAL SECTIONS (SJD-FRE)	ROBERTSON BOULEVARD (SR 233) INTERCHANGE - 2 OF 2
ST-K1220-A	CENTRAL VALLEY WYE	SR 152 (NORTH) TO ROAD 13 WYE ALTERNATIVE	GENERAL PLAN (SJD-FRE)	BERENDA SLOUGH BRIDGE - 1 OF 2
ST-K3220-A	CENTRAL VALLEY WYE	SR 152 (NORTH) TO ROAD 13 WYE ALTERNATIVE	TYPICAL SECTION (SJD-FRE)	BERENDA SLOUGH BRIDGE - 2 OF 2
ST-K1230-A	CENTRAL VALLEY WYE	SR 152 (NORTH) TO ROAD 13 WYE ALTERNATIVE	GENERAL PLAN (SJD-FRE)	BERENDA WAY (ROAD 16) UNDERPASS
ST-K1235-A	CENTRAL VALLEY WYE	SR 152 (NORTH) TO ROAD 13 WYE ALTERNATIVE	GENERAL PLAN (SJD-FRE)	BERENDA WAY (ROAD 16) INTERCHANGE - 1 OF 2
ST-K3235-A	CENTRAL VALLEY WYE	SR 152 (NORTH) TO ROAD 13 WYE ALTERNATIVE	TYPICAL SECTION (SJD-FRE)	BERENDA WAY (ROAD 16) INTERCHANGE - 2 OF 2
ST-K1240-A	CENTRAL VALLEY WYE	SR 152 (NORTH) TO ROAD 13 WYE ALTERNATIVE	GENERAL PLAN (SJD-FRE)	ROAD 17 1/2 OVERHEAD
		DESIGNED BY M. BRATT DRAWN BY A. M. CHECKED BY K. CHARAN	PARSONS	CALIFORNIA HIGH-SPEED TR MERCED TO FRESNO SE CENTRAL VALLEY WYE

BY CHK APP

DESCRIPTION

A. M.
CHECKED BY
K. CHARAN NOT FOR CONSTRUCTION IN CHARGE
C. LEMLEY DATE 08/12/2016

PARSONS



AIN PROJECT MERCED TO FRESNO SECTION

CENTRAL VALLEY WYE STRUCTURE, VIADUCT AND TUNNEL PLANS INDEX OF DRAWINGS SHEET 1 OF 8

CONTRACT NO. HSR08-05
DRAWING NO. ST-B0002
NO SCALE
SHEET NO.

			INDEX OF DRAWINGS	
DRAWING NO.	SECTION	ALIGNMENT / PLAN SET	TITLE	DESCRIPTION
ST-K1250-A	CENTRAL VALLEY WYE	SR 152 (NORTH) TO ROAD 13 WYE ALTERNATIVE	GENERAL PLAN (SJD-FRE)	AERIAL #2 - SR 99 / UPRR - 1 OF 3
ST-K1251-A	CENTRAL VALLEY WYE	SR 152 (NORTH) TO ROAD 13 WYE ALTERNATIVE	GENERAL PLAN (SJD-FRE)	AERIAL #2 - SR 99 / UPRR - 2 OF 3
ST-K3250-A	CENTRAL VALLEY WYE	SR 152 (NORTH) TO ROAD 13 WYE ALTERNATIVE	TYPICAL SECTIONS (SJD-FRE)	AERIAL #2 - SR 99 / UPRR - 3 OF 3
ST-K1260-A	CENTRAL VALLEY WYE	SR 152 (NORTH) TO ROAD 13 WYE ALTERNATIVE	GENERAL PLAN (SJD-FRE)	ROAD 20 OVERHEAD
ST-K1280-A	CENTRAL VALLEY WYE	SR 152 (NORTH) TO ROAD 13 WYE ALTERNATIVE	GENERAL PLAN (SJD-FRE)	ROAD 22 OVERHEAD
ST-K1310-A	CENTRAL VALLEY WYE	SR 152 (NORTH) TO ROAD 13 WYE ALTERNATIVE	GENERAL PLAN (SJD-FRE)	AVENUE 20 1/2 OVERHEAD
ST-K1330-A	CENTRAL VALLEY WYE	SR 152 (NORTH) TO ROAD 13 WYE ALTERNATIVE	GENERAL PLAN (SJD-FRE)	DRY CREEK BRIDGE
ST-K1420-A	CENTRAL VALLEY WYE	SR 152 (NORTH) TO ROAD 13 WYE ALTERNATIVE	GENERAL PLAN (MER-FRE)	AERIAL #3 - SOUTHBOUND OVER HST MAINLINE - 1 OF 6
ST-K1421-A	CENTRAL VALLEY WYE	SR 152 (NORTH) TO ROAD 13 WYE ALTERNATIVE	GENERAL PLAN (MER-FRE)	AERIAL #3 - SOUTHBOUND OVER HST MAINLINE - 2 OF 6
ST-K1422-A	CENTRAL VALLEY WYE	SR 152 (NORTH) TO ROAD 13 WYE ALTERNATIVE	GENERAL PLAN (MER-FRE)	AERIAL #3 - SOUTHBOUND OVER HST MAINLINE - 3 OF 6
ST-K3420-A	CENTRAL VALLEY WYE	SR 152 (NORTH) TO ROAD 13 WYE ALTERNATIVE	TYPICAL SECTION (MER-FRE)	AERIAL #3 - SOUTHBOUND OVER HST MAINLINE - 4 OF 6
ST-K3421-A	CENTRAL VALLEY WYE	SR 152 (NORTH) TO ROAD 13 WYE ALTERNATIVE	TYPICAL SECTION (MER-FRE)	AERIAL #3 - SOUTHBOUND OVER HST MAINLINE - 5 OF 6
ST-K3422-A	CENTRAL VALLEY WYE	SR 152 (NORTH) TO ROAD 13 WYE ALTERNATIVE	TYPICAL SECTIONS (MER-FRE)	AERIAL #3 - SOUTHBOUND OVER HST MAINLINE - 6 OF 6
ST-K1430-A	CENTRAL VALLEY WYE	SR 152 (NORTH) TO ROAD 13 WYE ALTERNATIVE	GENERAL PLAN (MER-FRE)	RAILROAD DRIVE UNDERPASS (HST NB)
ST-K1433-A	CENTRAL VALLEY WYE	SR 152 (NORTH) TO ROAD 13 WYE ALTERNATIVE	GENERAL PLAN (MER-FRE)	ROBERTSON BOULEVARD (SR 233) UNDERPASS
ST-K1436-A	CENTRAL VALLEY WYE	SR 152 (NORTH) TO ROAD 13 WYE ALTERNATIVE	GENERAL PLAN (MER-FRE)	MADISON ROAD (AVENUE 23 1/2) UNDERPASS
ST-K1450-A	CENTRAL VALLEY WYE	SR 152 (NORTH) TO ROAD 13 WYE ALTERNATIVE	GENERAL PLAN (MER-FRE)	WASHINGTON ROAD (AVENUE 25) UNDERPASS - 1 OF 2
ST-K3450-A	CENTRAL VALLEY WYE	SR 152 (NORTH) TO ROAD 13 WYE ALTERNATIVE	TYPICAL SECTION (MER-FRE)	WASHINGTON ROAD (AVENUE 25) UNDERPASS - 2 OF 2
ST-K1455-A	CENTRAL VALLEY WYE	SR 152 (NORTH) TO ROAD 13 WYE ALTERNATIVE	GENERAL PLAN (MER-FRE)	ASH SLOUGH BRIDGE - 1 OF 2
ST-K3455-A	CENTRAL VALLEY WYE	SR 152 (NORTH) TO ROAD 13 WYE ALTERNATIVE	TYPICAL SECTION (MER-FRE)	ASH SLOUGH BRIDGE - 2 OF 2
ST-K1460-A	CENTRAL VALLEY WYE	SR 152 (NORTH) TO ROAD 13 WYE ALTERNATIVE	GENERAL PLAN (MER-FRE)	AVENUE 26 1/2 UNDERPASS
ST-K1470-A	CENTRAL VALLEY WYE	SR 152 (NORTH) TO ROAD 13 WYE ALTERNATIVE	GENERAL PLAN (MER-FRE)	CHOWCHILLA RIVER BRIDGE - 1 OF 2
ST-K3470-A	CENTRAL VALLEY WYE	SR 152 (NORTH) TO ROAD 13 WYE ALTERNATIVE	TYPICAL SECTION (MER-FRE)	CHOWCHILLA RIVER BRIDGE - 2 OF 2
ST-K1475-A	CENTRAL VALLEY WYE	SR 152 (NORTH) TO ROAD 13 WYE ALTERNATIVE	GENERAL PLAN (MER-FRE)	VISTA AVENUE (ROAD 13) UNDERPASS
ST-K1490-A	CENTRAL VALLEY WYE	SR 152 (NORTH) TO ROAD 13 WYE ALTERNATIVE	GENERAL PLAN (MER-FRE)	DUTCHMAN CREEK BRIDGE
ST-K1495-A	CENTRAL VALLEY WYE	SR 152 (NORTH) TO ROAD 13 WYE ALTERNATIVE	GENERAL PLAN (MER-FRE)	ROAD 11 BRIDGE
ST-T1500-A	CENTRAL VALLEY WYE	SR 152 (NORTH) TO ROAD 13 WYE ALTERNATIVE	GENERAL PLAN (MER-FRE)	RETAINED CUT - SANDY MUSH ROAD - 1 OF 2
ST-T3500-A	CENTRAL VALLEY WYE	SR 152 (NORTH) TO ROAD 13 WYE ALTERNATIVE	TYPICAL SECTIONS (MER-FRE)	RETAINED CUT - SANDY MUSH ROAD - 2 OF 2
ST-K1500-A	CENTRAL VALLEY WYE	SR 152 (NORTH) TO ROAD 13 WYE ALTERNATIVE	GENERAL PLAN (MER-FRE)	SANDY MUSH ROAD OVERHEAD
ST-K1620-A	CENTRAL VALLEY WYE	SR 152 (NORTH) TO ROAD 13 WYE ALTERNATIVE	GENERAL PLAN (SJD-MER)	AERIAL #4 - NORTHBOUND OVER HST MAINLINE - 1 OF 6
ST-K1621-A	CENTRAL VALLEY WYE	SR 152 (NORTH) TO ROAD 13 WYE ALTERNATIVE	GENERAL PLAN (SJD-MER)	AERIAL #4 - NORTHBOUND OVER HST MAINLINE - 2 OF 6
ST-K1622-A	CENTRAL VALLEY WYE	SR 152 (NORTH) TO ROAD 13 WYE ALTERNATIVE	GENERAL PLAN (SJD-MER)	AERIAL #4 - NORTHBOUND OVER HST MAINLINE - 3 OF 6
ST-K1623-A	CENTRAL VALLEY WYE	SR 152 (NORTH) TO ROAD 13 WYE ALTERNATIVE	GENERAL PLAN (SJD-MER)	AERIAL #4 - NORTHBOUND OVER HST MAINLINE - 4 OF 6
ST-K3620-A	CENTRAL VALLEY WYE	SR 152 (NORTH) TO ROAD 13 WYE ALTERNATIVE	TYPICAL SECTIONS (SJD-MER)	AERIAL #4 - NORTHBOUND OVER HST MAINLINE - 5 OF 6
ST-K3621-A	CENTRAL VALLEY WYE	SR 152 (NORTH) TO ROAD 13 WYE ALTERNATIVE	TYPICAL SECTIONS (SJD-MER)	AERIAL #4 - NORTHBOUND OVER HST MAINLINE - 6 OF 6
ST-K1630-A	CENTRAL VALLEY WYE	SR 152 (NORTH) TO ROAD 13 WYE ALTERNATIVE	GENERAL PLAN (SJD-MER)	ELM ROAD (ROAD 12) UNDERPASS
ST-K1635-A	CENTRAL VALLEY WYE	SR 152 (NORTH) TO ROAD 13 WYE ALTERNATIVE	GENERAL PLAN (SJD-MER)	MADISON ROAD (AVENUE 23 1/2) OVERHEAD
ST-K1650-A	CENTRAL VALLEY WYE	SR 152 (NORTH) TO ROAD 13 WYE ALTERNATIVE	GENERAL PLAN (SJD-MER)	AERIAL #5 - NORTHBOUND OVER HST MERCED TO FRESNO - 1 OF 5
ST-K1651-A	CENTRAL VALLEY WYE	SR 152 (NORTH) TO ROAD 13 WYE ALTERNATIVE	GENERAL PLAN (SJD-MER)	AERIAL #5 - NORTHBOUND OVER HST MERCED TO FRESNO - 2 OF 5
ST-K1652-A	CENTRAL VALLEY WYE	SR 152 (NORTH) TO ROAD 13 WYE ALTERNATIVE	GENERAL PLAN (SJD-MER)	AERIAL #5 - NORTHBOUND OVER HST MERCED TO FRESNO - 3 OF 5
ST-K3650-A	CENTRAL VALLEY WYE	SR 152 (NORTH) TO ROAD 13 WYE ALTERNATIVE	TYPICAL SECTIONS (SJD-MER)	AERIAL #5 - NORTHBOUND OVER HST MERCED TO FRESNO - 4 OF 5
ST-K3651-A	CENTRAL VALLEY WYE	SR 152 (NORTH) TO ROAD 13 WYE ALTERNATIVE	TYPICAL SECTIONS (SJD-MER)	AERIAL #5 - NORTHBOUND OVER HST MERCED TO FRESNO - 5 OF 5

- AU								
16-							DESIGNED BY M. BRATT	
							DRAWN BY A. M.	l
_							CHECKED BY K. CHARAN	l
133a							IN CHARGE C. LEMLEY	l
p0051	REV	DATE	BY	снк	APP	DESCRIPTION	DATE 08/12/2016	

RECORD SET 15% DESIGN SUBMITTAL NOT FOR CONSTRUCTION





CALIFORNIA HIGH-SPEED TRAIN PROJECT MERCED TO FRESNO SECTION

STRUCTURE, VIADUCT AND TUNNEL PLANS
INDEX OF DRAWINGS SHEET 2 OF 8

CONTRACT NO.
HSR08-05
DRAWING NO.
ST-B0003
SCALE
NO SCALE

CENTRAL VALLEY WYE SHEET NO.

			INDEX OF DRAWINGS	
DRAWING NO.	SECTION	ALIGNMENT / PLAN SET	TITLE	DESCRIPTION
ST-K1655-A	CENTRAL VALLEY WYE	SR 152 (NORTH) TO ROAD 13 WYE ALTERNATIVE	GENERAL PLAN (SJD-MER)	HST SB BRIDGE OVER ASH SLOUGH - 1 OF 2
ST-K3655-A	CENTRAL VALLEY WYE	SR 152 (NORTH) TO ROAD 13 WYE ALTERNATIVE	TYPICAL SECTION (SJD-MER)	HST SB BRIDGE OVER ASH SLOUGH - 2 OF 2
		SR 152 (NOF	RTH) TO ROAD 19 WYE ALTERNATIVE	
ST-B4001-B	CENTRAL VALLEY WYE	SR 152 (NORTH) TO ROAD 19 WYE ALTERNATIVE	KEY MAP OF STRUCTURAL PLANS	SHEET 1 OF 2
ST-B4002-B	CENTRAL VALLEY WYE	SR 152 (NORTH) TO ROAD 19 WYE ALTERNATIVE	KEY MAP OF STRUCTURAL PLANS	SHEET 2 OF 2
ST-K1050-B	CENTRAL VALLEY WYE	SR 152 (NORTH) TO ROAD 19 WYE ALTERNATIVE	GENERAL PLAN (SJD-FRE)	INDIANA ROAD OVERHEAD
ST-K1060-B	CENTRAL VALLEY WYE	SR 152 (NORTH) TO ROAD 19 WYE ALTERNATIVE	GENERAL PLAN (SJD-FRE)	WILLIS ROAD UNDERPASS
ST-K1065-B	CENTRAL VALLEY WYE	SR 152 (NORTH) TO ROAD 19 WYE ALTERNATIVE	GENERAL PLAN (SJD-FRE)	SAN JOAQUIN RIVER BRIDGE - 1 OF 2
ST-K3065-B	CENTRAL VALLEY WYE	SR 152 (NORTH) TO ROAD 19 WYE ALTERNATIVE	TYPICAL SECTION (SJD-FRE)	SAN JOAQUIN RIVER BRIDGE - 2 OF 2
ST-K1070-B	CENTRAL VALLEY WYE	SR 152 (NORTH) TO ROAD 19 WYE ALTERNATIVE	GENERAL PLAN (SJD-FRE)	MARIPOSA SLOUGH BRIDGE
ST-K1075-B	CENTRAL VALLEY WYE	SR 152 (NORTH) TO ROAD 19 WYE ALTERNATIVE	GENERAL PLAN (SJD-FRE)	HARMON ROAD UNDERPASS
ST-K1080-B	CENTRAL VALLEY WYE	SR 152 (NORTH) TO ROAD 19 WYE ALTERNATIVE	GENERAL PLAN (SJD-FRE)	AERIAL #1 - EASTSIDE BYPASS IRRIGATION DITCH - 1 OF 2
ST-K3080-B	CENTRAL VALLEY WYE	SR 152 (NORTH) TO ROAD 19 WYE ALTERNATIVE	TYPICAL SECTION (SJD-FRE)	AERIAL #1 - EASTSIDE BYPASS IRRIGATION DITCH - 2 OF 2
ST-K1100-B	CENTRAL VALLEY WYE	SR 152 (NORTH) TO ROAD 19 WYE ALTERNATIVE	GENERAL PLAN (SJD-FRE)	SR 59 / SR 152 INTERCHANGE - 1 OF 4
ST-K1101-B	CENTRAL VALLEY WYE	SR 152 (NORTH) TO ROAD 19 WYE ALTERNATIVE	GENERAL PLAN (SJD-FRE)	SR 59 / SR 152 INTERCHANGE - 2 OF 4
ST-K3101-B	CENTRAL VALLEY WYE	SR 152 (NORTH) TO ROAD 19 WYE ALTERNATIVE	TYPICAL SECTIONS (SJD-FRE)	SR 59 / SR 152 INTERCHANGE - 3 OF 4
ST-K1102-B	CENTRAL VALLEY WYE	SR 152 (NORTH) TO ROAD 19 WYE ALTERNATIVE	GENERAL PLAN (SJD-FRE)	SR 59 / SR 152 INTERCHANGE - 4 OF 4
ST-K1110-B	CENTRAL VALLEY WYE	SR 152 (NORTH) TO ROAD 19 WYE ALTERNATIVE	GENERAL PLAN (SJD-FRE)	LINCOLN ROAD (ROAD 4) OVERHEAD
ST-K1160-B	CENTRAL VALLEY WYE	SR 152 (NORTH) TO ROAD 19 WYE ALTERNATIVE	GENERAL PLAN (SJD-FRE)	HEMLOCK ROAD (ROAD 9) INTERCHANGE - 1 OF 2
ST-K3160-B	CENTRAL VALLEY WYE	SR 152 (NORTH) TO ROAD 19 WYE ALTERNATIVE	TYPICAL SECTIONS (SJD-FRE)	HEMLOCK ROAD (ROAD 9) INTERCHANGE - 2 OF 2
ST-K1170-B	CENTRAL VALLEY WYE	SR 152 (NORTH) TO ROAD 19 WYE ALTERNATIVE	GENERAL PLAN (SJD-FRE)	ASH SLOUGH BRIDGE
ST-K1190-B	CENTRAL VALLEY WYE	SR 152 (NORTH) TO ROAD 19 WYE ALTERNATIVE	GENERAL PLAN (SJD-FRE)	ELM ROAD (ROAD 12) OVERHEAD
ST-K1210-B	CENTRAL VALLEY WYE	SR 152 (NORTH) TO ROAD 19 WYE ALTERNATIVE	GENERAL PLAN (SJD-FRE)	ROBERTSON BOULEVARD (SR 233) INTERCHANGE - 1 OF 2
ST-K3210-B	CENTRAL VALLEY WYE	SR 152 (NORTH) TO ROAD 19 WYE ALTERNATIVE	TYPICAL SECTIONS (SJD-FRE)	ROBERTSON BOULEVARD (SR 233) INTERCHANGE - 2 OF 2
ST-K1220-B	CENTRAL VALLEY WYE	SR 152 (NORTH) TO ROAD 19 WYE ALTERNATIVE	GENERAL PLAN (SJD-FRE)	BERENDA SLOUGH BRIDGE
ST-K1230-B	CENTRAL VALLEY WYE	SR 152 (NORTH) TO ROAD 19 WYE ALTERNATIVE	GENERAL PLAN (SJD-FRE)	BERENDA WAY (ROAD 16) UNDERPASS
ST-K1235-B	CENTRAL VALLEY WYE	SR 152 (NORTH) TO ROAD 19 WYE ALTERNATIVE	GENERAL PLAN (SJD-FRE)	BERENDA WAY (ROAD 16) INTERCHANGE - 1 OF 2
ST-K3235-B	CENTRAL VALLEY WYE	SR 152 (NORTH) TO ROAD 19 WYE ALTERNATIVE	TYPICAL SECTION (SJD-FRE)	BERENDA WAY (ROAD 16) INTERCHANGE - 2 OF 2
ST-K1240-B	CENTRAL VALLEY WYE	SR 152 (NORTH) TO ROAD 19 WYE ALTERNATIVE	GENERAL PLAN (SJD-FRE)	ROAD 17 1/2 UNDERPASS
ST-K1245-B	CENTRAL VALLEY WYE	SR 152 (NORTH) TO ROAD 19 WYE ALTERNATIVE	GENERAL PLAN (SJD-FRE)	SR 152 (ROAD 17 1/2) UNDERCROSSING
ST-K1250-B	CENTRAL VALLEY WYE	SR 152 (NORTH) TO ROAD 19 WYE ALTERNATIVE	GENERAL PLAN (SJD-FRE)	AERIAL #2 - SR 99 / UPRR - 1 OF 3
ST-K1250 B	CENTRAL VALLEY WYE	SR 152 (NORTH) TO ROAD 19 WYE ALTERNATIVE	GENERAL PLAN (SJD-FRE)	AERIAL #2 - SR 99 / UPRR - 2 OF 3
ST-K3250-B	CENTRAL VALLEY WYE	SR 152 (NORTH) TO ROAD 19 WYE ALTERNATIVE	TYPICAL SECTIONS (SJD-FRE)	AERIAL #2 - SR 99 / UPRR - 3 OF 3
ST-K3250-B ST-K1260-B	CENTRAL VALLEY WYE	SR 152 (NORTH) TO ROAD 19 WYE ALTERNATIVE SR 152 (NORTH) TO ROAD 19 WYE ALTERNATIVE	GENERAL PLAN (SJD-FRE)	ROAD 20 UNDERPASS
ST-K1280-B	CENTRAL VALLEY WYE	SR 152 (NORTH) TO ROAD 19 WYE ALTERNATIVE SR 152 (NORTH) TO ROAD 19 WYE ALTERNATIVE	GENERAL PLAN (SJD-FRE)	ROAD 20 UNDERPASS ROAD 22 OVERHEAD
ST-K1260-B ST-K1310-B	CENTRAL VALLEY WYE	SR 152 (NORTH) TO ROAD 19 WYE ALTERNATIVE SR 152 (NORTH) TO ROAD 19 WYE ALTERNATIVE	GENERAL PLAN (SJD-FRE)	AVENUE 20 1/2 OVERHEAD
ST-K1310-B	CENTRAL VALLEY WYE	SR 152 (NORTH) TO ROAD 19 WYE ALTERNATIVE SR 152 (NORTH) TO ROAD 19 WYE ALTERNATIVE	GENERAL PLAN (SJD-FRE)	DRY CREEK BRIDGE
ST-K1320-B ST-K1420-B	CENTRAL VALLEY WYE	SR 152 (NORTH) TO ROAD 19 WYE ALTERNATIVE SR 152 (NORTH) TO ROAD 19 WYE ALTERNATIVE	GENERAL PLAN (MER-FRE)	AERIAL #3 - SOUTHBOUND OVER HST MAINLINE - 1 OF 5
ST-K1421-B	CENTRAL VALLEY WYE	SR 152 (NORTH) TO ROAD 19 WYE ALTERNATIVE	GENERAL PLAN (MER-FRE)	AERIAL #3 - SOUTHBOUND OVER HST MAINLINE - 2 OF 5
ST-K1422-B	CENTRAL VALLEY WYE	SR 152 (NORTH) TO ROAD 19 WYE ALTERNATIVE	GENERAL PLAN (MER-FRE)	AERIAL #3 - SOUTHBOUND OVER HST MAINLINE - 3 OF 5
ST-K3420-B	CENTRAL VALLEY WYE	SR 152 (NORTH) TO ROAD 19 WYE ALTERNATIVE	TYPICAL SECTIONS (MER-FRE)	AERIAL #3 - SOUTHBOUND OVER HST MAINLINE - 4 OF 5
ST-K3421-B	CENTRAL VALLEY WYE	SR 152 (NORTH) TO ROAD 19 WYE ALTERNATIVE	TYPICAL SECTIONS (MER-FRE)	AERIAL #3 - SOUTHBOUND OVER HST MAINLINE - 5 OF 5
ST-K1425-B	CENTRAL VALLEY WYE	SR 152 (NORTH) TO ROAD 19 WYE ALTERNATIVE	GENERAL PLAN (MER-FRE)	ROAD 20 UNDERPASS (HST NB) CALIFORNIA HIGH-SPEED T

16-AUG-201607:

| DESIGNED BY | M. BRATT | DRAWN BY | A. M. | CHECKED BY | K. CHARAN | IN CHARGE | C. LEMLEY | DATE | BY CHK | APP | DESCRIPTION | DATE | DATE

RECORD SET
15% DESIGN
SUBMITTAL
NOT FOR
CONSTRUCTION





CALIFORNIA HIGH-SPEED TRAIN PROJECT MERCED TO FRESNO SECTION

CENTRAL VALLEY WYE STRUCTURE, VIADUCT AND TUNNEL PLANS INDEX OF DRAWINGS SHEET 3 OF 8

CONTRACT NO.
HSR08-05
DRAWING NO. ST-B0004
SCALE

NO SCALE

						DESIGNED BY
						M. BRATT
						DRAWN BY A. M.
						CHECKED BY K. CHARAN
						IN CHARGE C. LEMLEY
REV	DATE	ВҮ	снк	APP	DESCRIPTION	DATE 08/12/2016

RECORD SET 15% DESIGN SUBMITTAL NOT FOR CONSTRUCTION





CALIFORNIA HIGH-SPEED TRAIN PROJECT MERCED TO FRESNO SECTION

CENTRAL VALLEY WYE STRUCTURE, VIADUCT AND TUNNEL PLANS INDEX OF DRAWINGS SHEET 4 OF 8

CONTRACT NO.
HSR08-05
DRAWING NO.
ST-B0005
SCALE
NO SCALE

SHEET NO.

		M. BRATT RECORD SE DRAWN BY 15% DESIGN A. M.		CALIFORNIA HIGH-SPEED TR MERCED TO FRESNO SE
ST-K3490-C	CENTRAL VALLEY WYE	AVENUE 21 TO ROAD 13 WYE ALTERNATIVI	TYPICAL SECTION (MER-FRE)	CALLEGRALA LICH CREED TR
ST-K1490-C	CENTRAL VALLEY WYE	AVENUE 21 TO ROAD 13 WYE ALTERNATIVE		CHOWCHILLA RIVER BRIDGE - 1 OF 2
ST-K1480-C	CENTRAL VALLEY WYE	AVENUE 21 TO ROAD 13 WYE ALTERNATIVE		AVENUE 26 1/2 UNDERPASS
ST-K3475-C	CENTRAL VALLEY WYE	AVENUE 21 TO ROAD 13 WYE ALTERNATIVE	<u> </u>	ASH SLOUGH BRIDGE - 2 OF 2
ST-K1475-C	CENTRAL VALLEY WYE	AVENUE 21 TO ROAD 13 WYE ALTERNATIVE	GENERAL PLAN (MER-FRE)	ASH SLOUGH BRIDGE - 1 OF 2
ST-K1470-C	CENTRAL VALLEY WYE	AVENUE 21 TO ROAD 13 WYE ALTERNATIVE	GENERAL PLAN (MER-FRE)	WASHINGTON ROAD (AVENUE 25) UNDERPASS
ST-K3450-C	CENTRAL VALLEY WYE	AVENUE 21 TO ROAD 13 WYE ALTERNATIVE	TYPICAL SECTION (MER-FRE)	SR 152 UNDERPASS - 2 OF 2
ST-K1450-C	CENTRAL VALLEY WYE	AVENUE 21 TO ROAD 13 WYE ALTERNATIVE	GENERAL PLAN (MER-FRE)	SR 152 UNDERPASS - 1 OF 2
ST-K1445-C	CENTRAL VALLEY WYE	AVENUE 21 TO ROAD 13 WYE ALTERNATIVE	GENERAL PLAN (MER-FRE)	AVENUE 22 1/2 UNDERPASS
ST-K1440-C	CENTRAL VALLEY WYE	AVENUE 21 TO ROAD 13 WYE ALTERNATIVE	GENERAL PLAN (MER-FRE)	ROBERTSON BOULEVARD UNDERPASS
ST-K1435-C	CENTRAL VALLEY WYE	AVENUE 21 TO ROAD 13 WYE ALTERNATIVE	GENERAL PLAN (MER-FRE)	AVENUE 21 1/2 OVERHEAD
ST-K1430-C	CENTRAL VALLEY WYE	AVENUE 21 TO ROAD 13 WYE ALTERNATIVE	GENERAL PLAN (MER-FRE)	ROAD 14 UNDERPASS (HST NB)
ST-K1426-C	CENTRAL VALLEY WYE	AVENUE 21 TO ROAD 13 WYE ALTERNATIVE	GENERAL PLAN (MER-FRE)	HST NB BRIDGE OVER BERENDA SLOUGH
ST-K3421-C	CENTRAL VALLEY WYE	AVENUE 21 TO ROAD 13 WYE ALTERNATIVE	TYPICAL SECTIONS (MER-FRE)	AERIAL #4 - SOUTHBOUND OVER HST MAINLINE - 6 OF 6
ST-K3420-C	CENTRAL VALLEY WYE	AVENUE 21 TO ROAD 13 WYE ALTERNATIVE	TYPICAL SECTIONS (MER-FRE)	AERIAL #4 - SOUTHBOUND OVER HST MAINLINE - 5 OF 6
ST-K1423-C	CENTRAL VALLEY WYE	AVENUE 21 TO ROAD 13 WYE ALTERNATIVE	GENERAL PLAN (MER-FRE)	AERIAL #4 - SOUTHBOUND OVER HST MAINLINE - 4 OF 6
ST-K1422-C	CENTRAL VALLEY WYE	AVENUE 21 TO ROAD 13 WYE ALTERNATIVE	GENERAL PLAN (MER-FRE)	AERIAL #4 - SOUTHBOUND OVER HST MAINLINE - 3 OF 6
ST-K1421-C	CENTRAL VALLEY WYE	AVENUE 21 TO ROAD 13 WYE ALTERNATIVE	GENERAL PLAN (MER-FRE)	AERIAL #4 - SOUTHBOUND OVER HST MAINLINE - 2 OF 6
ST-K1420-C	CENTRAL VALLEY WYE	AVENUE 21 TO ROAD 13 WYE ALTERNATIVE	GENERAL PLAN (MER-FRE)	AERIAL #4 - SOUTHBOUND OVER HST MAINLINE - 1 OF 6
ST-K1320-C	CENTRAL VALLEY WYE	AVENUE 21 TO ROAD 13 WYE ALTERNATIVE	GENERAL PLAN (SJD-FRE)	DRY CREEK BRIDGE
ST-K1300-C	CENTRAL VALLEY WYE	AVENUE 21 TO ROAD 13 WYE ALTERNATIVE	GENERAL PLAN (SJD-FRE)	AVENUE 20 1/2 OVERHEAD
ST-K1290-C	CENTRAL VALLEY WYE	AVENUE 21 TO ROAD 13 WYE ALTERNATIVE	GENERAL PLAN (SJD-FRE)	ROAD 22 OVERHEAD
ST-K3275-C	CENTRAL VALLEY WYE	AVENUE 21 TO ROAD 13 WYE ALTERNATIVE	TYPICAL SECTIONS (SJD-FRE)	AERIAL #3 - SR 99 / UPRR - 2 OF 2
ST-K1275-C	CENTRAL VALLEY WYE	AVENUE 21 TO ROAD 13 WYE ALTERNATIVE	GENERAL PLAN (SJD-FRE)	AERIAL #3 - SR 99 / UPRR - 1 OF 2
ST-K1270-C	CENTRAL VALLEY WYE	AVENUE 21 TO ROAD 13 WYE ALTERNATIVE	GENERAL PLAN (SJD-FRE)	ROAD 20 UNDERPASS
ST-K1260-C	CENTRAL VALLEY WYE	AVENUE 21 TO ROAD 13 WYE ALTERNATIVE	GENERAL PLAN (SJD-FRE)	ROAD 19 OVERHEAD
ST-K1230-C	CENTRAL VALLEY WYE	AVENUE 21 TO ROAD 13 WYE ALTERNATIVE	GENERAL PLAN (SJD-FRE)	BERENDA WAY (ROAD 16) OVERHEAD
ST-K1220-C	CENTRAL VALLEY WYE	AVENUE 21 TO ROAD 13 WYE ALTERNATIVE	GENERAL PLAN (SJD-FRE)	BERENDA SLOUGH BRIDGE
ST-K1210-C	CENTRAL VALLEY WYE	AVENUE 21 TO ROAD 13 WYE ALTERNATIVE	GENERAL PLAN (SJD-FRE)	ROAD 14 UNDERPASS
ST-K1200-C	CENTRAL VALLEY WYE	AVENUE 21 TO ROAD 13 WYE ALTERNATIVE	GENERAL PLAN (SJD-FRE)	ROBERTSON BOULEVARD OVERHEAD
ST-K1160-C	CENTRAL VALLEY WYE	AVENUE 21 TO ROAD 13 WYE ALTERNATIVE	GENERAL PLAN (SJD-FRE)	HEMLOCK ROAD (ROAD 9) OVERHEAD
ST-K3155-C	CENTRAL VALLEY WYE	AVENUE 21 TO ROAD 13 WYE ALTERNATIVE		ASH SLOUGH BRIDGE - 2 OF 2
ST-K1155-C	CENTRAL VALLEY WYE	AVENUE 21 TO ROAD 13 WYE ALTERNATIVE		ASH SLOUGH BRIDGE - 1 OF 2
ST-K1150-C	CENTRAL VALLEY WYE	AVENUE 21 TO ROAD 13 WYE ALTERNATIVE		JUNIPER ROAD (ROAD 7) UNDERPASS
ST-K1120-C	CENTRAL VALLEY WYE	AVENUE 21 TO ROAD 13 WYE ALTERNATIVE		LINCOLN ROAD (ROAD 4) OVERHEAD
ST-K3100-C	CENTRAL VALLEY WYE	AVENUE 21 TO ROAD 13 WYE ALTERNATIVE		AERIAL #2 - EASTSIDE BYPASS IRRIGATION DITCH - 2 OF 2
ST-K1090-C	CENTRAL VALLEY WYE	AVENUE 21 TO ROAD 13 WYE ALTERNATIVE		AERIAL #2 - EASTSIDE BYPASS IRRIGATION DITCH - 1 OF 2
ST-K1090-C	CENTRAL VALLEY WYE	AVENUE 21 TO ROAD 13 WYE ALTERNATIVE		FLANAGAN ROAD UNDERPASS
ST-K1085-C	CENTRAL VALLEY WYE	AVENUE 21 TO ROAD 13 WYE ALTERNATIVE		SR 152 UNDERPASS
ST-K1080-C ST-K3080-C	CENTRAL VALLEY WYE CENTRAL VALLEY WYE	AVENUE 21 TO ROAD 13 WYE ALTERNATIVE		AERIAL #1 - FRESNO RIVER AND MARIPOSA SLOUGH - 1 OF 2 AERIAL #1 - FRESNO RIVER AND MARIPOSA SLOUGH - 2 OF 2
ST-K3070-C ST-K1080-C	CENTRAL VALLEY WYE	AVENUE 21 TO ROAD 13 WYE ALTERNATIVI		SAN JOAQUIN RIVER BRIDGE - 2 OF 2
ST-K1070-C	CENTRAL VALLEY WYE	AVENUE 21 TO ROAD 13 WYE ALTERNATIVE		SAN JOAQUIN RIVER BRIDGE - 1 OF 2

INDEX OF DRAWINGS

A. M.

CHECKED BY

K. CHARAN IN CHARGE
C. LEMLEY DATE 08/12/2016 BY CHK APP DESCRIPTION

15% DESIGN Submittal NOT FOR CONSTRUCTION

PARSONS



AIN PROJECT CONTRACT NO. HSRO8-C MERCED TO FRESNO SECTION

CENTRAL VALLEY WYE STRUCTURE, VIADUCT AND TUNNEL PLANS INDEX OF DRAWINGS SHEET 5 OF 8

HSR08-05
DRAWING NO. ST-B0006
NO SCALE
CUEET NO

			INDEX OF DRAWINGS	
DRAWING NO.	SECTION	ALIGNMENT / PLAN SET	TITLE	DESCRIPTION
ST-K1495-C	CENTRAL VALLEY WYE	AVENUE 21 TO ROAD 13 WYE ALTERNATIVE	GENERAL PLAN (MER-FRE)	VISTA AVENUE (ROAD 13) UNDERPASS
ST-K1510-C	CENTRAL VALLEY WYE	AVENUE 21 TO ROAD 13 WYE ALTERNATIVE	GENERAL PLAN (MER-FRE)	DUTCHMAN CREEK BRIDGE
ST-K1515-C	CENTRAL VALLEY WYE	AVENUE 21 TO ROAD 13 WYE ALTERNATIVE	GENERAL PLAN (MER-FRE)	ROAD 11 BRIDGE
ST-T1520-C	CENTRAL VALLEY WYE	AVENUE 21 TO ROAD 13 WYE ALTERNATIVE	GENERAL PLAN (MER-FRE)	RETAINED CUT - SANDY MUSH ROAD - 1 OF 2
ST-T3520-C	CENTRAL VALLEY WYE	AVENUE 21 TO ROAD 13 WYE ALTERNATIVE	TYPICAL SECTIONS (MER-FRE)	RETAINED CUT - SANDY MUSH ROAD - 2 OF 2
ST-K1520-C	CENTRAL VALLEY WYE	AVENUE 21 TO ROAD 13 WYE ALTERNATIVE	GENERAL PLAN (MER-FRE)	SANDY MUSH ROAD OVERHEAD
ST-K1620-C	CENTRAL VALLEY WYE	AVENUE 21 TO ROAD 13 WYE ALTERNATIVE	GENERAL PLAN (SJD-MER)	AERIAL #5 - NORTHBOUND OVER HST MAINLINE - 1 OF 5
ST-K1621-C	CENTRAL VALLEY WYE	AVENUE 21 TO ROAD 13 WYE ALTERNATIVE	GENERAL PLAN (SJD-MER)	AERIAL #5 - NORTHBOUND OVER HST MAINLINE - 2 OF 5
ST-K1622-C	CENTRAL VALLEY WYE	AVENUE 21 TO ROAD 13 WYE ALTERNATIVE	GENERAL PLAN (SJD-MER)	AERIAL #5 - NORTHBOUND OVER HST MAINLINE - 3 OF 5
ST-K3620-C	CENTRAL VALLEY WYE	AVENUE 21 TO ROAD 13 WYE ALTERNATIVE	TYPICAL SECTIONS (SJD-MER)	AERIAL #5 - NORTHBOUND OVER HST MAINLINE - 4 OF 5
ST-K3621-C	CENTRAL VALLEY WYE	AVENUE 21 TO ROAD 13 WYE ALTERNATIVE	TYPICAL SECTIONS (SJD-MER)	AERIAL #5 - NORTHBOUND OVER HST MAINLINE - 5 OF 5
ST-K1630-C	CENTRAL VALLEY WYE	AVENUE 21 TO ROAD 13 WYE ALTERNATIVE	GENERAL PLAN (SJD-MER)	AVENUE 21 1/2 OVERHEAD
ST-K1640-C	CENTRAL VALLEY WYE	AVENUE 21 TO ROAD 13 WYE ALTERNATIVE	GENERAL PLAN (SJD-MER)	AERIAL #6 - NORTHBOUND OVER HST MERCED TO FRESNO - 1 OF 6
ST-K1641-C	CENTRAL VALLEY WYE	AVENUE 21 TO ROAD 13 WYE ALTERNATIVE	GENERAL PLAN (SJD-MER)	AERIAL #6 - NORTHBOUND OVER HST MERCED TO FRESNO - 2 OF 6
ST-K1642-C	CENTRAL VALLEY WYE	AVENUE 21 TO ROAD 13 WYE ALTERNATIVE	GENERAL PLAN (SJD-MER)	AERIAL #6 - NORTHBOUND OVER HST MERCED TO FRESNO - 3 OF 6
ST-K1643-C	CENTRAL VALLEY WYE	AVENUE 21 TO ROAD 13 WYE ALTERNATIVE	GENERAL PLAN (SJD-MER)	AERIAL #6 - NORTHBOUND OVER HST MERCED TO FRESNO - 4 OF 6
ST-K3640-C	CENTRAL VALLEY WYE	AVENUE 21 TO ROAD 13 WYE ALTERNATIVE	TYPICAL SECTIONS (SJD-MER)	AERIAL #6 - NORTHBOUND OVER HST MERCED TO FRESNO - 5 OF 6
ST-K3641-C	CENTRAL VALLEY WYE	AVENUE 21 TO ROAD 13 WYE ALTERNATIVE	TYPICAL SECTIONS (SJD-MER)	AERIAL #6 - NORTHBOUND OVER HST MERCED TO FRESNO - 6 OF 6
ST-K1646-C	CENTRAL VALLEY WYE	AVENUE 21 TO ROAD 13 WYE ALTERNATIVE	GENERAL PLAN (SJD-MER)	AVENUE 22 1/2 UNDERPASS (HST SB)
		SR 152	(NORTH) TO ROAD 11 WYE ALTERNATIVE	1
ST-B4001-D	CENTRAL VALLEY WYE	SR 152 (NORTH) TO ROAD 11 WYE ALTERNATIVE	KEY MAP OF STRUCTURAL PLANS	SHEET 1 OF 2
ST-B4002-D	CENTRAL VALLEY WYE	SR 152 (NORTH) TO ROAD 11 WYE ALTERNATIVE	KEY MAP OF STRUCTURAL PLANS	SHEET 2 OF 2
ST-K1050-D	CENTRAL VALLEY WYE	SR 152 (NORTH) TO ROAD 11 WYE ALTERNATIVE	GENERAL PLAN (SJD-FRE)	INDIANA ROAD OVERHEAD
ST-K1055-D	CENTRAL VALLEY WYE	SR 152 (NORTH) TO ROAD 11 WYE ALTERNATIVE	GENERAL PLAN (SJD-FRE)	WOOD SLOUGH BRIDGE
ST-K1060-D	CENTRAL VALLEY WYE	SR 152 (NORTH) TO ROAD 11 WYE ALTERNATIVE	GENERAL PLAN (SJD-FRE)	WILLIS ROAD UNDERPASS
ST-K1065-D	CENTRAL VALLEY WYE	SR 152 (NORTH) TO ROAD 11 WYE ALTERNATIVE	GENERAL PLAN (SJD-FRE)	SAN JOAQUIN RIVER BRIDGE - 1 OF 2
ST-K3065-D	CENTRAL VALLEY WYE	SR 152 (NORTH) TO ROAD 11 WYE ALTERNATIVE	TYPICAL SECTION (SJD-FRE)	SAN JOAQUIN RIVER BRIDGE - 2 OF 2
ST-K1070-D	CENTRAL VALLEY WYE	SR 152 (NORTH) TO ROAD 11 WYE ALTERNATIVE	GENERAL PLAN (SJD-FRE)	MARIPOSA SLOUGH BRIDGE
ST-K1075-D	CENTRAL VALLEY WYE	SR 152 (NORTH) TO ROAD 11 WYE ALTERNATIVE	GENERAL PLAN (SJD-FRE)	HARMON ROAD UNDERPASS
ST-K1080-D	CENTRAL VALLEY WYE	SR 152 (NORTH) TO ROAD 11 WYE ALTERNATIVE	GENERAL PLAN (SJD-FRE)	AERIAL #1 - EASTSIDE BYPASS IRRIGATION DITCH - 1 OF 2
ST-K3080-D	CENTRAL VALLEY WYE	SR 152 (NORTH) TO ROAD 11 WYE ALTERNATIVE	TYPICAL SECTION (SJD-FRE)	AERIAL #1 - EASTSIDE BYPASS IRRIGATION DITCH - 2 OF 2
ST-K1100-D	CENTRAL VALLEY WYE	SR 152 (NORTH) TO ROAD 11 WYE ALTERNATIVE	GENERAL PLAN (SJD-FRE)	SR 59 / SR 152 INTERCHANGE - 1 OF 4
ST-K1101-D	CENTRAL VALLEY WYE	SR 152 (NORTH) TO ROAD 11 WYE ALTERNATIVE	GENERAL PLAN (SJD-FRE)	SR 59 / SR 152 INTERCHANGE - 2 OF 4
ST-K3101-D	CENTRAL VALLEY WYE	SR 152 (NORTH) TO ROAD 11 WYE ALTERNATIVE	TYPICAL SECTIONS (SJD-FRE)	SR 59 / SR 152 INTERCHANGE - 3 OF 4
ST-K1102-D	CENTRAL VALLEY WYE	SR 152 (NORTH) TO ROAD 11 WYE ALTERNATIVE	GENERAL PLAN (SJD-FRE)	SR 59 / SR 152 INTERCHANGE - 4 OF 4
ST-K1110-D	CENTRAL VALLEY WYE	SR 152 (NORTH) TO ROAD 11 WYE ALTERNATIVE	GENERAL PLAN (SJD-FRE)	LINCOLN ROAD (ROAD 4) OVERHEAD
ST-K1160-D	CENTRAL VALLEY WYE	SR 152 (NORTH) TO ROAD 11 WYE ALTERNATIVE	GENERAL PLAN (SJD-FRE)	HEMLOCK ROAD (ROAD 9) UNDERPASS
ST-K1161-D	CENTRAL VALLEY WYE	SR 152 (NORTH) TO ROAD 11 WYE ALTERNATIVE	GENERAL PLAN (SJD-FRE)	HEMLOCK ROAD (ROAD 9) INTERCHANGE - 1 OF 2
ST-K3161-D	CENTRAL VALLEY WYE	SR 152 (NORTH) TO ROAD 11 WYE ALTERNATIVE	TYPICAL SECTIONS (SJD-FRE)	HEMLOCK ROAD (ROAD 9) INTERCHANGE - 2 OF 2
ST-K1170-D	CENTRAL VALLEY WYE	SR 152 (NORTH) TO ROAD 11 WYE ALTERNATIVE	GENERAL PLAN (SJD-FRE)	ASH SLOUGH BRIDGE - 1 OF 2
ST-K3170-D	CENTRAL VALLEY WYE	SR 152 (NORTH) TO ROAD 11 WYE ALTERNATIVE	TYPICAL SECTION (SJD-FRE)	ASH SLOUGH BRIDGE - 2 OF 2
ST-K1190-D	CENTRAL VALLEY WYE	SR 152 (NORTH) TO ROAD 11 WYE ALTERNATIVE	GENERAL PLAN (SJD-FRE)	ELM ROAD (ROAD 12) UNDERPASS
ST-K1195-D	CENTRAL VALLEY WYE	SR 152 (NORTH) TO ROAD 11 WYE ALTERNATIVE	GENERAL PLAN (SJD-FRE)	SR 152 (ROAD 12) UNDERCROSSING
		DESIGNED BY M. BRATT DRAWN BY A. M. CHECKED BY K. CHARAN IN CHARGE NOT FOR	PARSONS	CALIFORNIA HIGH-SPEED MERCED TO FRESNO CENTRAL VALLEY W STRUCTURE, VIADUCT AND THE

BY CHK APP

15% DESIGN Submittal NOT FOR CONSTRUCTION

IN CHARGE
C. LEMLEY

DATE 08/12/2016

DESCRIPTION



AIN PROJECT MERCED TO FRESNO SECTION

CENTRAL VALLEY WYE STRUCTURE, VIADUCT AND TUNNEL PLANS INDEX OF DRAWINGS SHEET 6 OF 8

CONTRACT NO. HSRO8-05
DRAWING NO. ST-B0007
NO SCALE
SHEET NO.

	INDEX OF DRAWINGS								
DRAWING NO.	SECTION	ALIGNMENT / PLAN SET	TITLE	DESCRIPTION					
ST-K1210-D	CENTRAL VALLEY WYE	SR 152 (NORTH) TO ROAD 11 WYE ALTERNATIVE	GENERAL PLAN (SJD-FRE)	ROBERTSON BOULEVARD (SR 233) INTERCHANGE - 1 OF 2					
ST-K3210-D	CENTRAL VALLEY WYE	SR 152 (NORTH) TO ROAD 11 WYE ALTERNATIVE	TYPICAL SECTIONS (SJD-FRE)	ROBERTSON BOULEVARD (SR 233) INTERCHANGE - 2 OF 2					
ST-K1220-D	CENTRAL VALLEY WYE	SR 152 (NORTH) TO ROAD 11 WYE ALTERNATIVE	GENERAL PLAN (SJD-FRE)	BERENDA SLOUGH BRIDGE - 1 OF 2					
ST-K3220-D	CENTRAL VALLEY WYE	SR 152 (NORTH) TO ROAD 11 WYE ALTERNATIVE	TYPICAL SECTION (SJD-FRE)	BERENDA SLOUGH BRIDGE - 2 OF 2					
ST-K1230-D	CENTRAL VALLEY WYE	SR 152 (NORTH) TO ROAD 11 WYE ALTERNATIVE	GENERAL PLAN (SJD-FRE)	BERENDA WAY (ROAD 16) UNDERPASS					
ST-K1235-D	CENTRAL VALLEY WYE	SR 152 (NORTH) TO ROAD 11 WYE ALTERNATIVE	GENERAL PLAN (SJD-FRE)	BERENDA WAY (ROAD 16) INTERCHANGE - 1 OF 2					
ST-K3235-D	CENTRAL VALLEY WYE	SR 152 (NORTH) TO ROAD 11 WYE ALTERNATIVE	TYPICAL SECTION (SJD-FRE)	BERENDA WAY (ROAD 16) INTERCHANGE - 2 OF 2					
ST-K1240-D	CENTRAL VALLEY WYE	SR 152 (NORTH) TO ROAD 11 WYE ALTERNATIVE	GENERAL PLAN (SJD-FRE)	ROAD 17 1/2 OVERHEAD					
ST-K1250-D	CENTRAL VALLEY WYE	SR 152 (NORTH) TO ROAD 11 WYE ALTERNATIVE	GENERAL PLAN (SJD-FRE)	AERIAL #2 - SR 99 / UPRR - 1 OF 3					
ST-K1251-D	CENTRAL VALLEY WYE	SR 152 (NORTH) TO ROAD 11 WYE ALTERNATIVE	GENERAL PLAN (SJD-FRE)	AERIAL #2 - SR 99 / UPRR - 2 OF 3					
ST-K3250-D	CENTRAL VALLEY WYE	SR 152 (NORTH) TO ROAD 11 WYE ALTERNATIVE	TYPICAL SECTIONS (SJD-FRE)	AERIAL #2 - SR 99 / UPRR - 3 OF 3					
ST-K1260-D	CENTRAL VALLEY WYE	SR 152 (NORTH) TO ROAD 11 WYE ALTERNATIVE	GENERAL PLAN (SJD-FRE)	ROAD 20 OVERHEAD					
ST-K1280-D	CENTRAL VALLEY WYE	SR 152 (NORTH) TO ROAD 11 WYE ALTERNATIVE	GENERAL PLAN (SJD-FRE)	ROAD 22 OVERHEAD					
ST-K1300-D	CENTRAL VALLEY WYE	SR 152 (NORTH) TO ROAD 11 WYE ALTERNATIVE	GENERAL PLAN (SJD-FRE)	BERENDA CREEK BRIDGE					
ST-K1310-D	CENTRAL VALLEY WYE	SR 152 (NORTH) TO ROAD 11 WYE ALTERNATIVE	GENERAL PLAN (SJD-FRE)	AVENUE 20 1/2 OVERHEAD					
ST-K1330-D	CENTRAL VALLEY WYE	SR 152 (NORTH) TO ROAD 11 WYE ALTERNATIVE	GENERAL PLAN (SJD-FRE)	DRY CREEK BRIDGE					
ST-K1410-D	CENTRAL VALLEY WYE	SR 152 (NORTH) TO ROAD 11 WYE ALTERNATIVE	GENERAL PLAN (MER-FRE)	AERIAL #3 - SOUTHBOUND OVER HST MAINLINE - 1 OF 6					
ST-K1411-D	CENTRAL VALLEY WYE	SR 152 (NORTH) TO ROAD 11 WYE ALTERNATIVE	GENERAL PLAN (MER-FRE)	AERIAL #3 - SOUTHBOUND OVER HST MAINLINE - 2 OF 6					
ST-K1412-D	CENTRAL VALLEY WYE	SR 152 (NORTH) TO ROAD 11 WYE ALTERNATIVE	GENERAL PLAN (MER-FRE)	AERIAL #3 - SOUTHBOUND OVER HST MAINLINE - 3 OF 6					
ST-K3410-D	CENTRAL VALLEY WYE	SR 152 (NORTH) TO ROAD 11 WYE ALTERNATIVE	TYPICAL SECTION (MER-FRE)	AERIAL #3 - SOUTHBOUND OVER HST MAINLINE - 4 OF 6					
ST-K3411-D	CENTRAL VALLEY WYE	SR 152 (NORTH) TO ROAD 11 WYE ALTERNATIVE	TYPICAL SECTION (MER-FRE)	AERIAL #3 - SOUTHBOUND OVER HST MAINLINE - 5 OF 6					
ST-K3412-D	CENTRAL VALLEY WYE	SR 152 (NORTH) TO ROAD 11 WYE ALTERNATIVE	TYPICAL SECTIONS (MER-FRE)	AERIAL #3 - SOUTHBOUND OVER HST MAINLINE - 6 OF 6					
ST-K1430-D	CENTRAL VALLEY WYE	SR 152 (NORTH) TO ROAD 11 WYE ALTERNATIVE	GENERAL PLAN (MER-FRE)	ROAD 12 UNDERPASS					
ST-K1435-D	CENTRAL VALLEY WYE	SR 152 (NORTH) TO ROAD 11 WYE ALTERNATIVE	GENERAL PLAN (MER-FRE)	MADISON ROAD (AVENUE 23 1/2) UNDERPASS					
ST-K1440-D	CENTRAL VALLEY WYE	SR 152 (NORTH) TO ROAD 11 WYE ALTERNATIVE	GENERAL PLAN (MER-FRE)	ASH SLOUGH BRIDGE - 1 OF 2					
ST-K3440-D	CENTRAL VALLEY WYE	SR 152 (NORTH) TO ROAD 11 WYE ALTERNATIVE	TYPICAL SECTION (MER-FRE)	ASH SLOUGH BRIDGE - 2 OF 2					
ST-K1450-D	CENTRAL VALLEY WYE	SR 152 (NORTH) TO ROAD 11 WYE ALTERNATIVE	GENERAL PLAN (MER-FRE)	WASHINGTON ROAD (AVENUE 25) UNDERPASS - 1 OF 2					
ST-K3450-D	CENTRAL VALLEY WYE	SR 152 (NORTH) TO ROAD 11 WYE ALTERNATIVE	TYPICAL SECTION (MER-FRE)	WASHINGTON ROAD (AVENUE 25) UNDERPASS - 2 OF 2					
ST-K1455-D	CENTRAL VALLEY WYE	SR 152 (NORTH) TO ROAD 11 WYE ALTERNATIVE	GENERAL PLAN (MER-FRE)	CHOWCHILLA RIVER BRIDGE					
ST-K1460-D	CENTRAL VALLEY WYE	SR 152 (NORTH) TO ROAD 11 WYE ALTERNATIVE	GENERAL PLAN (MER-FRE)	AVENUE 26 UNDERPASS					
ST-K1490-D	CENTRAL VALLEY WYE	SR 152 (NORTH) TO ROAD 11 WYE ALTERNATIVE	GENERAL PLAN (MER-FRE)	DUTCHMAN CREEK BRIDGE					
ST-K1495-D	CENTRAL VALLEY WYE	SR 152 (NORTH) TO ROAD 11 WYE ALTERNATIVE	GENERAL PLAN (MER-FRE)	SANDY MUSH ROAD UNDERPASS					
ST-K1510-D	CENTRAL VALLEY WYE	SR 152 (NORTH) TO ROAD 11 WYE ALTERNATIVE	GENERAL PLAN (MER-FRE)	DEADMAN CREEK BRIDGE No. 1					
ST-K1515-D	CENTRAL VALLEY WYE	SR 152 (NORTH) TO ROAD 11 WYE ALTERNATIVE	GENERAL PLAN (MER-FRE)	DEADMAN CREEK BRIDGE No. 2					
ST-K1610-D	CENTRAL VALLEY WYE	SR 152 (NORTH) TO ROAD 11 WYE ALTERNATIVE	GENERAL PLAN (SJD-MER)	AERIAL #4 - NORTHBOUND OVER HST MAINLINE - 1 OF 5					
ST-K1611-D	CENTRAL VALLEY WYE	SR 152 (NORTH) TO ROAD 11 WYE ALTERNATIVE	GENERAL PLAN (SJD-MER)	AERIAL #4 - NORTHBOUND OVER HST MAINLINE - 2 OF 5					
ST-K1612-D	CENTRAL VALLEY WYE	SR 152 (NORTH) TO ROAD 11 WYE ALTERNATIVE	GENERAL PLAN (SJD-MER)	AERIAL #4 - NORTHBOUND OVER HST MAINLINE - 3 OF 5					
ST-K3610-D	CENTRAL VALLEY WYE	SR 152 (NORTH) TO ROAD 11 WYE ALTERNATIVE	TYPICAL SECTIONS (SJD-MER)	AERIAL #4 - NORTHBOUND OVER HST MAINLINE - 4 OF 5					
ST-K3611-D	CENTRAL VALLEY WYE	SR 152 (NORTH) TO ROAD 11 WYE ALTERNATIVE	TYPICAL SECTIONS (SJD-MER)	AERIAL #4 - NORTHBOUND OVER HST MAINLINE - 5 OF 5					
ST-K1620-D	CENTRAL VALLEY WYE	SR 152 (NORTH) TO ROAD 11 WYE ALTERNATIVE	GENERAL PLAN (SJD-FRE)	HEMLOCK ROAD (ROAD 9) UNDERPASS					
ST-K1630-D	CENTRAL VALLEY WYE	SR 152 (NORTH) TO ROAD 11 WYE ALTERNATIVE	GENERAL PLAN (SJD-MER)	MADISON ROAD (AVENUE 23 1/2) OVERHEAD					

M. BRATT DRAWN BY
A. M. CHECKED BY
K. CHARAN IN CHARGE
C. LEMLEY DATE 08/12/2016 BY CHK APP DESCRIPTION

RECORD SET 15% DESIGN SUBMITTAL NOT FOR CONSTRUCTION





CALIFORNIA HIGH-SPEED TRAIN PROJECT MERCED TO FRESNO SECTION

CENTRAL VALLEY WYE STRUCTURE, VIADUCT AND TUNNEL PLANS INDEX OF DRAWINGS SHEET 7 OF 8

CONTRACT NO. HSRO8-05
DRAWING NO. ST-B0008
SCALE

NO SCALE

SHEET NO.

			INDEX OF DRAWINGS	
DRAWING NO.	SECTION	ALIGNMENT / PLAN SET	TITLE	DESCRIPTION
ST-K1641-D	CENTRAL VALLEY WYE	SR 152 (NORTH) TO ROAD 11 WYE ALTERNATIVE	GENERAL PLAN (SJD-MER)	AERIAL #5 - NORTHBOUND OVER HST MERCED TO FRESNO - 2 OF 6
ST-K1642-D	CENTRAL VALLEY WYE	SR 152 (NORTH) TO ROAD 11 WYE ALTERNATIVE	GENERAL PLAN (SJD-MER)	AERIAL #5 - NORTHBOUND OVER HST MERCED TO FRESNO - 3 OF 6
ST-K1643-D	CENTRAL VALLEY WYE	SR 152 (NORTH) TO ROAD 11 WYE ALTERNATIVE	GENERAL PLAN (SJD-MER)	AERIAL #5 - NORTHBOUND OVER HST MERCED TO FRESNO - 4 OF 6
ST-K3640-D	CENTRAL VALLEY WYE	SR 152 (NORTH) TO ROAD 11 WYE ALTERNATIVE	TYPICAL SECTIONS (SJD-MER)	AERIAL #5 - NORTHBOUND OVER HST MERCED TO FRESNO - 5 OF 6
ST-K3641-D	CENTRAL VALLEY WYE	SR 152 (NORTH) TO ROAD 11 WYE ALTERNATIVE	TYPICAL SECTIONS (SJD-MER)	AERIAL #5 - NORTHBOUND OVER HST MERCED TO FRESNO - 6 OF 6
ST-K1650-D	CENTRAL VALLEY WYE	SR 152 (NORTH) TO ROAD 11 WYE ALTERNATIVE	GENERAL PLAN (SJD-MER)	ROAD 11 UNDERPASS
ST-K1653-D	CENTRAL VALLEY WYE	SR 152 (NORTH) TO ROAD 11 WYE ALTERNATIVE	GENERAL PLAN (SJD-MER)	WASHINGTON ROAD (AVENUE 25) UNDERPASS
ST-K1656-D	CENTRAL VALLEY WYE	SR 152 (NORTH) TO ROAD 11 WYF ALTERNATIVE	GENERAL PLAN (S.ID-MER)	CHOWCHILLA RIVER BRIDGE

DESIGNED BY
M. BRATT DRAWN BY
A. M. CHECKED BY IN CHARGE
C. LEMLEY DATE 08/12/2016 BY CHK APP DESCRIPTION

RECORD SET 15% DESIGN SUBMITTAL NOT FOR





CALIFORNIA HIGH-SPEED TRAIN PROJECT MERCED TO FRESNO SECTION

CENTRAL VALLEY WYE STRUCTURE, VIADUCT AND TUNNEL PLANS INDEX OF DRAWINGS SHEET 8 OF 8

CONTRACT NO.
HSR08-05
DRAWING NO.
ST-B0009
SCALE
NO SCALE
SHEET NO.

		(A)				(D CONTINUED)		(F CONTINUED)		(J CONTINUED)
	1.0		0.4.4	OARLE MISUER ASSEMBLY	DET		ENTO		1.0	
	AB	AGGREGATE BASE	CAA	CABLE ANCHOR ASSEMBLY	DET	DETAIL, DETOUR	FNTB	FACING NORTHBOUND TRAFFIC	JS	JUNCTION STRUCTURE
	ABBC	ASBESTOS BONDED BITUMINOUS COATED	CAP	CORRUGATED ALUMINUM PIPE	DF	DOUGLAS FIR, DIRECT FIXATION	FOB	FREE ON BOARD	JT	JOINT
	ABM	AIR-BLOWN MORTAR	CAPA	CORRUGATED ALUMINUM PIPE ARCH	DI	DRAINAGE INLET, DROP INLET	FOC FR RD	FACE OF CONCRETE		
	ABN ABUT	ABANDON ABUTMENT	CAS CB	CONSTRUCTION AREA SIGN CONCRETE BARRIER	DIA DIAPH	DIAMETER DIAPHRAGM	FRE RD	FRONTAGE ROAD FRESNO	1	LENGTH
		ASPHALT CONCRETE	CBW	CONCRETE BARRIER CONCRETE BLOCK WALL			FS		L LAT	LATITUDE
	AC				DIST DMBB	DISTANCE, DISTRICT DOUBLE METAL BEAM BARRIER		FAR SIDE, FINISHED SURFACE		
	ACB	ASPHALT CONCRETE BASE ASBESTOS CEMENT PIPE	C-C CHSRA	CENTER TO CENTER CALIFORNIA HIGH-SPEED RAIL	DR	DRIVE	FSBT FTG	FACING SOUTHBOUND TRAFFIC FOOTING	LCB LLT	LEAN CONCRETE BASE LAST LONG TIE
	ACP ADL	ADDED DEAD LOAD	CHSRA	AUTHORITY (SEE AUTHORITY)	DTBB	DOUBLE THRIE BEAM BARRIER	FWBT	FACING WESTBOUND TRAFFIC	LLI	LAST LONG TIE
	ADJ	ADJUST	CHSR	CALIFORNIA HIGH-SPEED RAIL	DWY	DRIVEWAY	FWY	FREEWAY	LOC	LOCATION
	AFES	ALTERNATIVE FLARED END SECTION	CHST	CALIFORNIA HIGH-SPEED TRAIN	DWI	DRIVEWAT	F W I		LOC	LAYOUT LINE
	AHD	AHEAD	CG	CENTER OF GRAVITY		(E)		G	LONG	LONGITUDE
	ALT	ALTERNATE	CHNL	CHANNEL	F	EAST	G	GRADE, ACCELERATION DUE TO	LONGIT	LONGITUDINAL
	AM	TIME FROM MIDNIGHT TO NOON	CI	CAST IRON	EA	ACTUAL SUPERELEVATION	G	GRAVITY	LS	LUMP SUM, LENGTH OF SPIRAL
	AP	ALTERNATIVE PIPE	CIDH	CAST-IN-ON CAST-IN-DRILLED-HOLE	EASE	EASEMENT	GA	GAGE	LT	LEFT
	APC	ALTERNATIVE PIPE CULVERT	CIP	CAST IN DRIELLD HOLL CAST-IN-PLACE, CAST IRON PIPE	EB	END OF BRIDGE, EASTBOUND	GALV	GALVANIZED	LVC	LENGTH OF VERTICAL CURVE
		APPROXIMATE	CIPCP	CAST-IN-PLACE CONCRETE PIPE	EC	END HORIZONTAL CURVE	GP GP	GRADING PLANE	LVC	
	APU	ALTERNATIVE PIPE UNDERDRAIN	CISS	CAST-IN-FLACE CONCRETE FIFE CAST-IN-STEEL SHELL	ECR	END CURB RETURN	GR	GUARD RAILING		M
	AR	ACCESS RESTRICTION	CISS	COMPLETE JOINT PENETRATION	ED	EDGE DRAIN	GRDR	GIRDER	MAINT	MAINTENANCE
	ARS	ACCELERATION RESPONSE SPECTRUM	CL	CHAIN LINK, CLASS	EDC	EDGE DRAIN CLEANOUT	GSP	GALVANIZED STEEL PIPE	MAX	MAXIMUM
	AS	AGGREGATE SUBBASE	CL-6	CHAIN LINK FENCE (6 FT)	EDO	EDGE DRAIN CULLANGOT	GTR	GUTTER	MB	METAL BEAM
	ASRP	ALUMINUM SPIRAL RIB PIPE	CLR	CLEAR, CLEARANCE	EDV	EDGE DRAIN VENT	J 111		MBB	METAL BEAM BARRIER
	ASSY	ASSEMBLY	CM	CORRUGATED METAL	ELEC	ELECTROLIER		(H)	MBGR	METAL BEAM GUARD RAILING
	ATC	AUTOMATIC TRAIN CONTROL	CMP	CORRUGATED METAL PIPE	ELECT	ELECTRIC	Н	HEIGHT	MED	MEDIAN
	ATPB	ASPHALT TREATED PERMEABLE BASE	CO	COUNTY	ELEV	ELEVATION	H, HR	HOUR	MER	MERCED
	ATPM	ASPHALT TREATED PERMEABLE MATERIAL	COL	COLUMN	EMB	EMBANKMENT	HD	HORIZONTAL DRAIN	MF	MERCED TO FRESNO
	AUTHORITY	CALIFORNIA HIGH-SPEED RAIL AUTHORITY	CONC	CONCRETE	ENGR	ENGINEER	HDWL	HEADWALL	MH	MANHOLE
	AVE	AVENUE	COND	CONDUIT	EOD	EDGE OF DECK	HEX HD	HEXAGONAL HEAD	MIN	MINIMUM
	AVG	AVERAGE	CONN	CONNECTOR	EP	EDGE OF PAVEMENT	НМА	HOT MIXED ASPHALT	MISC	MISCELLANEOUS
	@	AT	CONST	CONSTRUCT, CONSTRUCTION	EQ	EQUATION	HORIZ	HORIZONTAL		S MISCELLANEOUS IRON AND STEEL
		В	CONT	CONTINUOUS	ES	EDGE OF SHOULDER	HP	HINGE POINT, HORSEPOWER	MKR	MARKER
		В	COORD	COORDINATE	ET	END TUNNEL	HPS	HIGH PERFORMANCE STEEL	MOD	MODIFIED, MODIFY
	BAGR	BRIDGE APPROACH GUARD RAILING	CP	CANDLEPOWER	ETW	EDGE OF TRAVELED WAY	HS	HIGH STRENGTH	MON	MONUMENT
	ВВ	BEGINNING OF BRIDGE	CP1	CONSTRUCTION PACKAGE 1	EU	UNBALANCED SUPERELEVATION	HSR	HIGH-SPEED RAIL	MOW	MAINTENANCE-OF-WAY FACILITY
	В-В	BACK-TO-BACK	CR	CREEK	EVC	END VERTICAL CURVE	HST	HIGH-SPEED TRAIN	MP	METAL PLATE
	ВС	BEGIN HORIZONTAL CURVE	CRCP	CONTINUOUS REINFORCED CONCRETE PAVEMENT	EW	ENDWALL	HW	HEADWALL,	MPGR	METAL PLATE GUARD RAILING
	BCR	BEGIN CURB RETURN	CRSP	CONCRETED ROCK SLOPE PROTECTION	EXC	EXCAVATION		100-YR HIGH WATER (UNLESS NOTED	MPH	MILES PER HOUR
	BEG	BEGIN	CRZ	CLEAR RECOVERY ZONE	EXIST, (E)	EXISTING		OTHERWISE)	MR	MOVEMENT RATING
	BIT CTD	BITUMINOUS COATED	CS	CURVE SPIRAL POINT	EXP	EXPANSION, EXPRESSWAY	HWM	HIGH WATER MARK	MSE	MECHANICALLY STABILIZED EARTH
	ВК	BACK	CSP	CORRUGATED STEEL PIPE	EXP JT	EXPANSION JOINT	HWY	HIGHWAY	MTL	MATERIAL
	BKF	BACKFILL	CSPA	CORRUGATED STEEL PIPE ARCH	EXT	EXTERIOR		T		N
	BLDG	BUILDING	СТВ	CEMENT TREATED BASE						(N)
	BLM	BRIDGE-LOG MILE	CTPB	CEMENT TREATED PERMEABLE BASE		(F)	IB	IMPORTED BORROW	N	NORTH
Lg J	BLVD	BOULEVARD	CTPM	CEMENT TREATED PERMEABLE MATERIAL	F & C	FRAME AND COVER	ID	INSIDE DIAMETER	NB	NORTHBOUND
0.01	ВМ	BENCH MARK	CTRS	CENTERS	F & G	FRAME AND GRATE	IF	INSIDE FACE	NC	NORMAL CROWN
B00	BOT	BOTTOM	CULV	CULVERT	FB	FLOOR BEAM	INT	INTERIOR	NIC	NOT IN CONTRACT
-TS	BNSF	BNSF RAILWAY	<u>C</u>	CENTERLINE	FDN	FOUNDATION	INV	INVERT	NO.	NUMBER (MUST HAVE PERIOD)
_ ⊢ H	BR	BRIDGE			FEBT	FACING EASTBOUND TRAFFIC	IRR	IRRIGATION	NOS.	NUMBERS (MUST HAVE PERIOD)
	BRG	BEARING			FES	FLARED END SECTION	IS	INTERLOCKING SITE	NPS	NOMINAL PIPE SIZE
	BT	BEGIN TUNNEL	D	DEPTH	FF	FILTER FABRIC			NS	NEAR SIDE
1.16	BTU	BRITISH THERMAL UNIT	DD	DOWNDRAIN	FG	FINISHED GRADE			NTS	NOT TO SCALE
1611	BVC	BEGIN VERTICAL CURVE	DBL	DOUBLE	FH	FIRE HYDRANT	JCT	JUNCTION		0
-20.	BW	BARBED WIRE	DEG	DEGREE	FIG	FIGURE	JP	JOINT POLE		
AUG.			DEL	DELINEATOR	FL	FLOW LINE	JPCP	JOINTED PLAIN CONCRETE PAVEMENT	OBLR	OBLITERATE
16-				DESIGNED BY C. LEMLEY RECORD SET				CALIFORNIA HIGH-SPI	EED TRA	IN PROJECT CONTRACT NO. HSR08-05
				DRAWN BY 15% DESIGN				MERCED TO FRI		TION DRAWING NO.
				SUBMITTAL I (-> >)	RSONS			CENTRAL VA		ST-B0010
330				IN CHARGE NOT FOR	C143	CALIFOR	2Λ//Δ	STRUCTURE, VIADUCT		. PLANS SCALE NO SCALE
051				C. LEMLEY CONSTRUCTION		HIGH-SPEED RAIL AU		ABBREVI SHEET 1		SHEET NO.
≥ REV	DATE BY	CHK APP DESCRIPTION		08/12/2016				SHEET	O1 Z	

	(O CONTINUED)		(P CONTINUED)		(S CONTINUED)		(T CONTINUED)
OC	OVERCROSSING	PVI	POINT OF VERTICAL INTERSECTION	SJM	SAN JOSE TO MERCED	TS	TRANSVERSE, TRAFFIC SIGNAL,
ocs	OVERHEAD CONTACT SYSTEM	PVMT	PAVEMENT	SJV	SAN JOAQUIN VALLEY		TUBULAR STEEL, TANGENT SPIRAL POINT
OD	OUTSIDE DIAMETER	PVT	POINT OF VERTICAL TANGENT	S	STATION LINE	TYP	TYPICAL
OF	OUTSIDE FACE			SM	SELECTED MATERIAL		
OG	ORIGINAL GROUND		(Q)	SPEC	SPECIAL, SPECIFICATIONS		
OGAC	OPEN GRADED ASPHALT CONCRETE	QTY	QUANTITY	SPP	SLOTTED PLASTIC PIPE	UC	UNDERCROSSING
ОН	OVERHEAD		R	SR	STATE ROUTE	UD	UNDERDRAIN
0-0	OUT TO OUT			SRS	STANDALONE RADIO SITE	UON	UNLESS OTHERWISE NOTED
OPP	OPPOSITE	R	RADIUS	SS	SLOPE STAKE, SUBSTATION	UP	UNDERPASS
	P	R & D	REMOVE AND DISPOSE	SSBM	STRAP AND SADDLE BRACKET METHOD	UPRR	UNION PACIFIC RAILROAD
		R & S	REMOVE AND SALVAGE	SSD	STRUCTURAL SECTION DRAIN	UXO	UNIVERSAL CROSSOVER
Р	PAGE	R/C	RATE OF CHANGE	SSPA	STRUCTURAL STEEL PLATE ARCH		V
PAP	PERFORATED ALUMINUM PIPE	RCA	REINFORCED CONCRETE ARCH	SSPP	STRUCTURAL STEEL PLATE PIPE		V
РВ	PULL BOX, PHASE BREAK	RCB	REINFORCED CONCRETE BOX	SSPPA	STRUCTURAL STEEL PLATE PIPE ARCH	V	DESIGN SPEED, VALVE
PC	POINT OF CURVATURE, PRECAST	RCP	REINFORCED CONCRETE PIPE	SSRP	STEEL SPIRAL RIB PIPE	VAR	VARIABLE
PCC	POINT OF COMPOUND CURVE,	RCPA	REINFORCED CONCRETE PIPE ARCH	ST	STREET, SPIRAL TANGENT POINT	VC	VERTICAL CURVE
	PORTLAND CEMENT CONCRETE	RD	ROAD	STA	STATION	VCP	VITRIFIED CLAY PIPE
PCP	PERFORATED CONCRETE PIPE,	REINF	REINFORCED, REINFORCEMENT,	STBB	SINGLE THRIE BEAM BARRIER	VERT	VERTICAL
	PRESTRESSED CONCRETE PIPE		REINFORCING	STD	STANDARD	AIV	VIADUCT
PCVC	POINT OF COMPOUND VERTICAL CURVE	REL	RELOCATE	STR	STRUCTURE	VOL	VOLUME
PED	PEDESTRIAN	REPL	REPLACEMENT	SURF	SURFACING		W
PED OC	PEDESTRIAN OVERCROSSING	RET	RETAINING	SW	SIDEWALK, SOUND WALL		
PED UC	PEDESTRIAN UNDERCROSSING	REV	REVISED	SWR	SEWER	W	WEST, WIDTH
PERM MTL		RDWY	ROADWAY	SWS	SWITCHING STATION	WB	WESTBOUND
PG	PROFILE GRADE	RM 	ROAD-MIXED	SYM	SYMMETRICAL	WCB	WORLD COORDINATE BEARING
PG&E	PACIFIC GAS AND ELECTRIC	RP	RADIUS POINT,	S4S	SURFACE 4 SIDES	WH	WEEP HOLE
PI	POINT OF INTERSECTION		REFERENCE POINT		T	WM	WIRE MESH
PITO	POINT OF INTERSECTION TURNOUT	RR	RAILROAD	_		WS	WATER SURFACE
PJP	PARTIAL JOINT PENETRATION	RSP	ROCK SLOPE PROTECTION	T	SEMI-TANGENT	WSP	WELDED STEEL PIPE
P, PL	PLATE	RT	RIGHT	TAB	TABLET	WT	WEIGHT
P/L	PROPERTY LINE	RTE	ROUTE	TAN	TANGENT	WV	WATER VALVE
РМ	POST MILE,	RW	REDWOOD,	TBB	THRIE BEAM BARRIER	WW	WINGWALL
5.1	TIME FROM NOON TO MIDNIGHT	5 44	RETAINING WALL	TBD	TO BE DETERMINED	WWLOL	WINGWALL LAYOUT LINE
PN	PAVING NOTCH	R/W	RIGHT-OF-WAY	TBR	TIMBER		X
POB	POINT OF HORIZONIAL CHRVE	RWY	RAILWAY	TC	TOP OF CURB, TRAIN CONTROL	V 656	CDOCC CECTION
POC	POINT OF HORIZONTAL CURVE		S	TCB	TRAFFIC CONTROL BOX	X SEC	CROSS SECTION
POE	POINT OF TANCENT	C	COUTH CURRIENT	TCE	TEMPORARY CONSTRUCTION EASEMENT	XING	CROSSING
POT	POINT OF VERTICAL CURVE	S	SOUTH, SUPPLEMENT	TEL	TELEPHONE TEMPORARY	XO	CROSSOVER
POVC	POINT OF VERTICAL CURVE	SAE	STRUCTURE APPROACH EMBANKMENT	TEMP			Y
PP	PIPE PILE, PLASTIC PIPE, POWER POLE	SALV SAPP	SALVAGE STRUCTURAL ALUMINUM PLATE PIPE	TG TM	TOP OF GRADE TECHNICAL MEMORANDUM	YR	YEAR
PDI	PREFORMED PERMEABLE LINER	SAPP	SOUTHBOUND	TO	TURNOUT	YRS	YEARS
PPL PPP	PERFORATED PLASTIC PIPE	SC SB	SAND CUSHION, SPIRAL CURVE POINT	TOT	TOTAL	671	ILMI/3
PRC	POINT OF REVERSE CURVE	SCSP	SLOTTED CORRUGATED STEEL PIPE	TP	TELEPHONE POLE		
PRF	PAVEMENT REINFORCING FABRIC	SD	STORM DRAIN	TPB	TREATED PERMEABLE BASE		
PRVC	POINT OF REVERSE VERTICAL CURVE	SEC	SECOND, SECTION	TPF	TRACTION POWER FACILITY		
PS&E	PLANS, SPECIFICATIONS AND ESTIMATES	SEP	SEPARATION	TPM	TREATED PERMEABLE MATERIAL		
PS, P/S	POINT OF SWITCH, PRESTRESSED,	SG	SUBGRADE	TPSS	TRACTION POWER SUBSTATION		
'3, '/3	PARALLELING STATION	SHLD	SHOULDER	T/R	TOP OF RAIL		
PSP	PERFORATED STEEL PIPE	SHT	SHEET	TRANS	TRANSITION		
PT	POINT OF TANGENCY	SIM	SIMILAR	TRK	TRACK		
PVC	POLYVINYL CHLORIDE,	SJD	SAN JOSE DIRIDON STATION				
	POINT OF VERTICAL CURVE	305	2 332 31M33M 31M13M				
			DESIGNED BY				CALIEODNIA HIGH-SDEED TRAIN DROJE
			C. LEMLEY RECORD SET DRAWN BY 15% DESIGN				CALIFORNIA HIGH-SPEED TRAIN PROJECTION
			J. KIDWELL)			CENTRAL VALLEY WYE
			A. M.	PARSC	INS I	a	STRUCTURE, VIADUCT AND TUNNEL PLANS
			IN CHARGE NOT FOR C. LEMLEY CONSTRUCTION	•	CALIFORN	1A	ABBREVIATIONS

CONSTRUCTION

DATE 08/12/2016

BY CHK APP

DESCRIPTION


MERCED TO FRESNO SECTION


CENTRAL VALLEY WYE STRUCTURE, VIADUCT AND TUNNEL PLANS
ABBREVIATIONS


ECT	CONTRACT NO. HSRO8-05
	ST-B0011
	NO SCALE

SHEET NO.

SHEET 2 OF 2

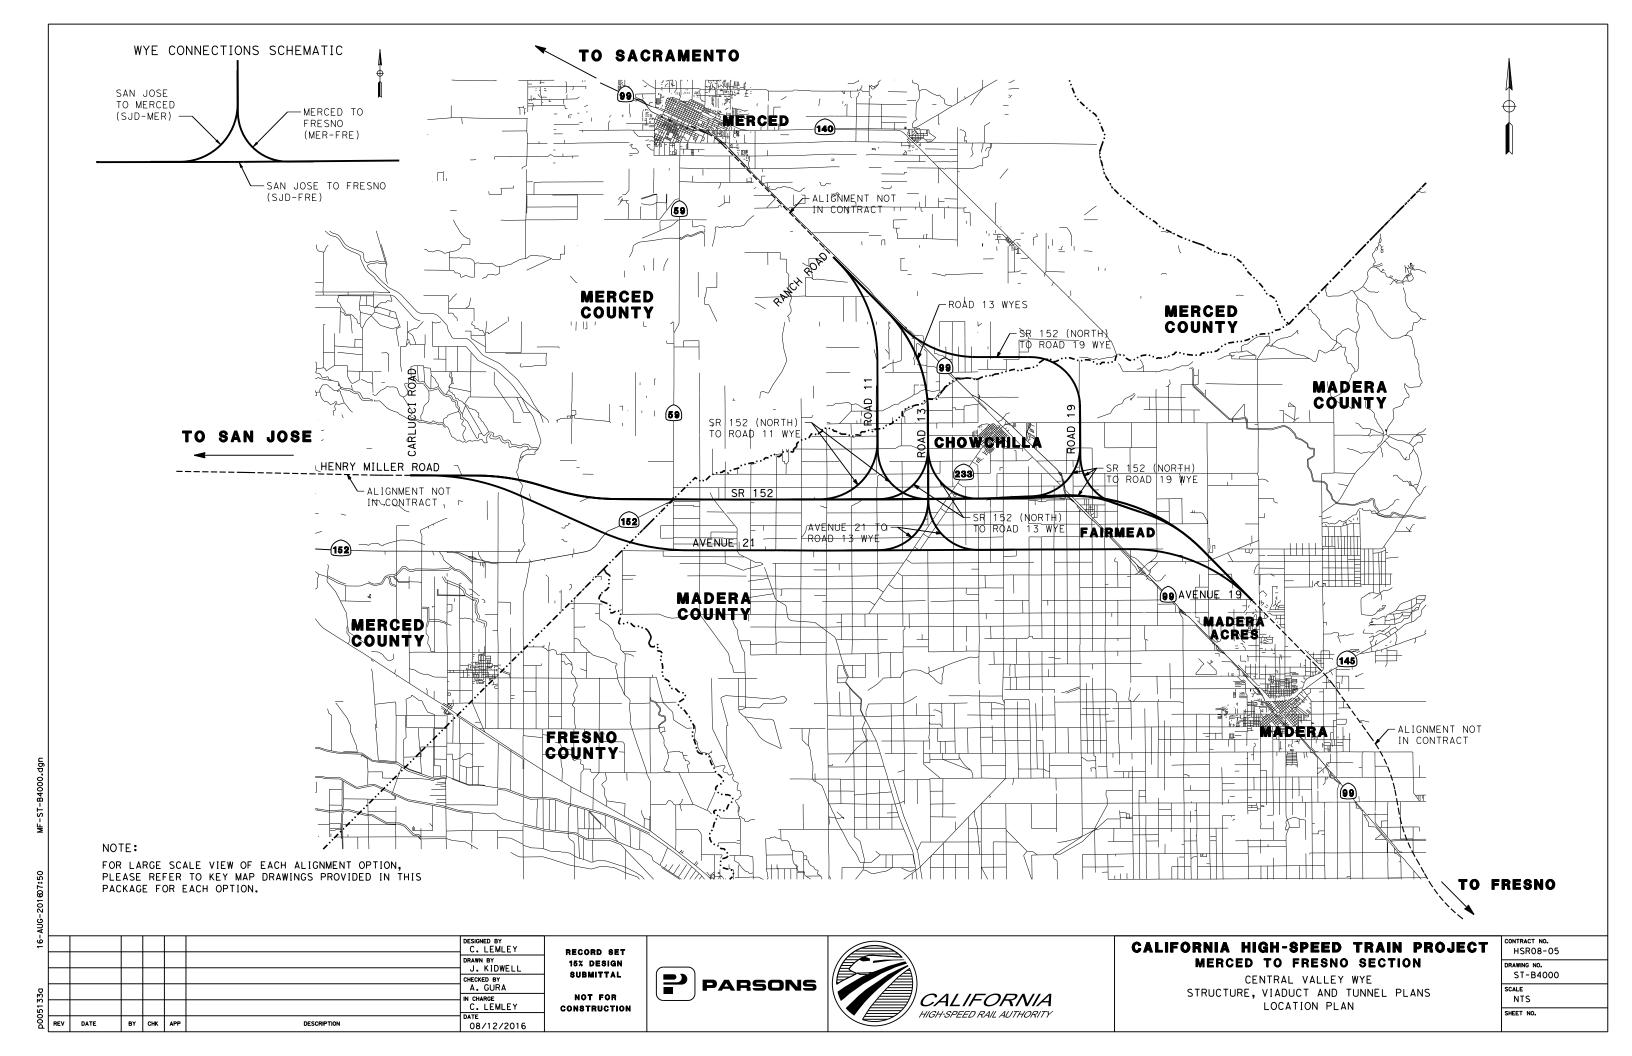

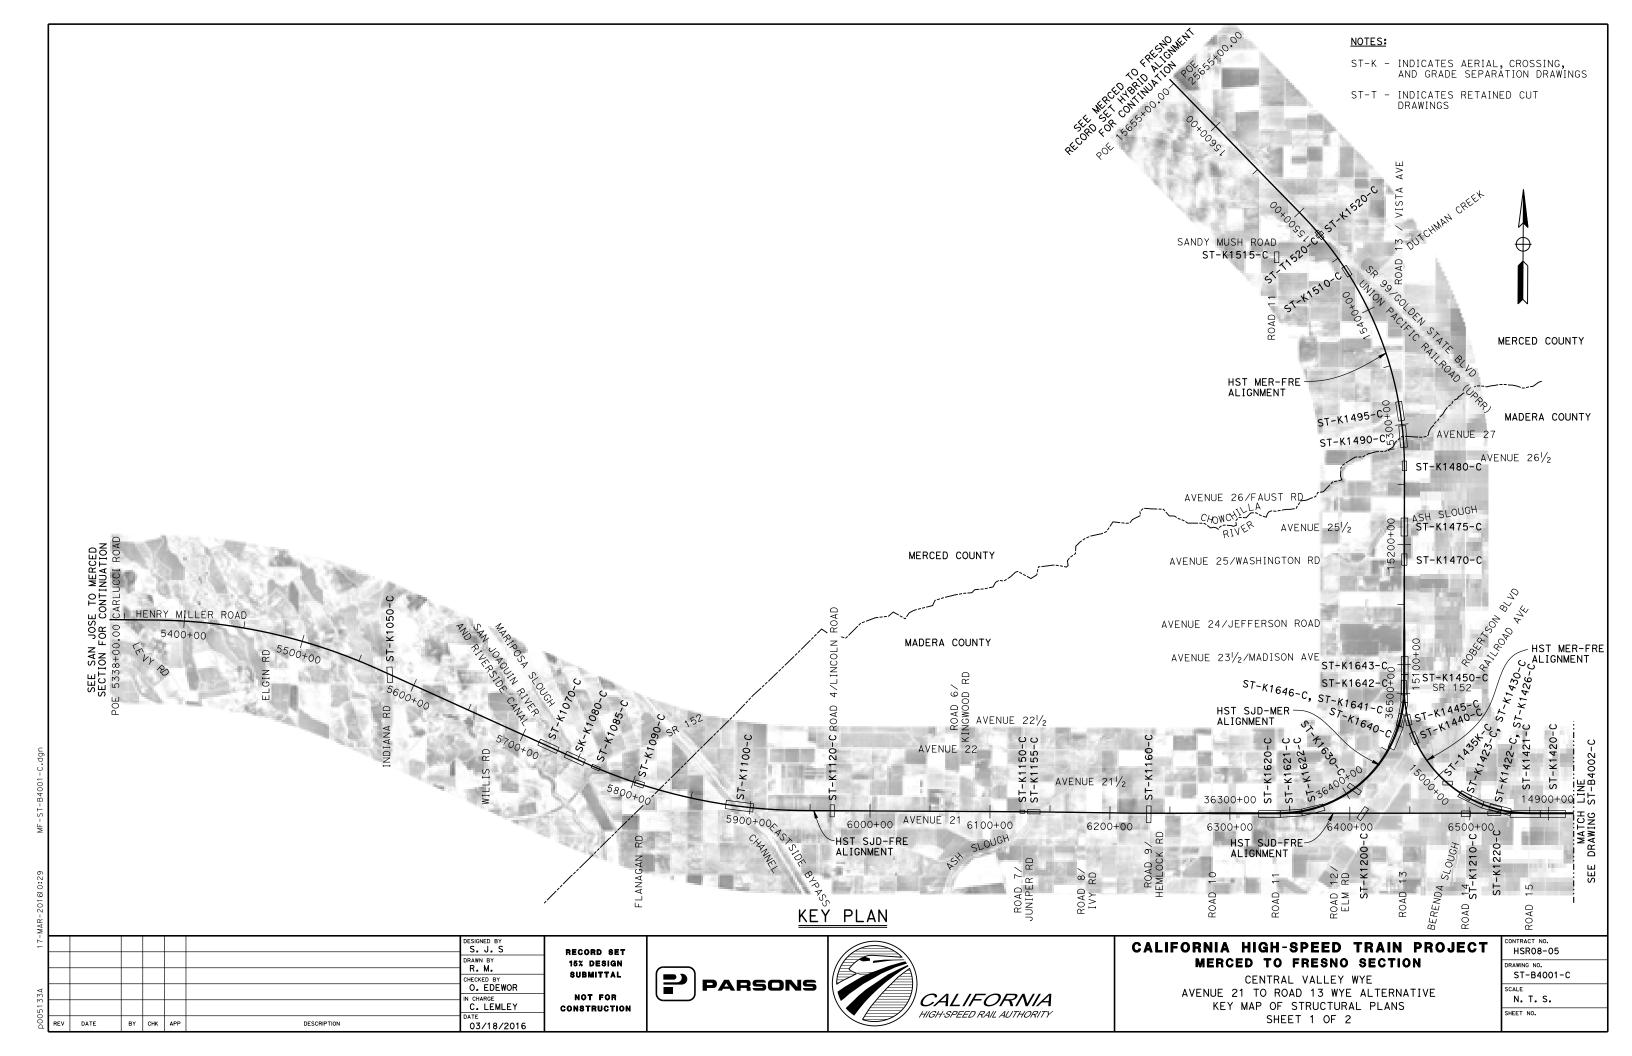

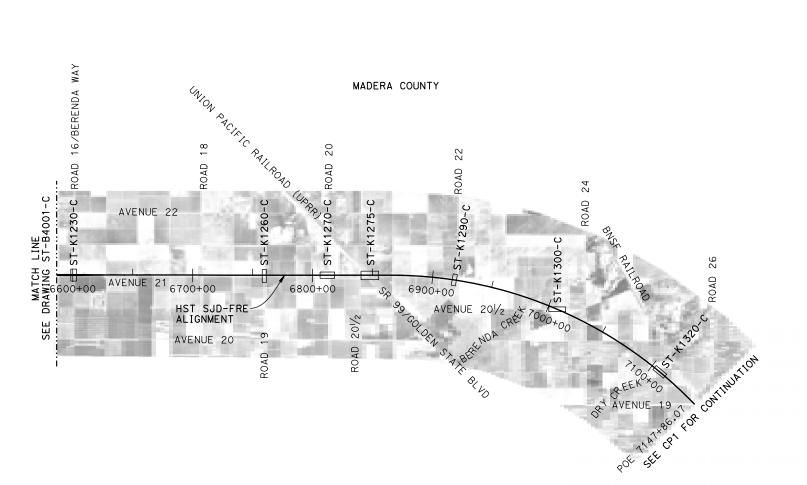

KEY PLAN

NOTES:

ST-K - INDICATES AERIAL, CROSSING, AND GRADE SEPARATION DRAWINGS

MA								
17-							DESIGNED BY S. J. S	
							DRAWN BY R. M.	
56							CHECKED BY A. GURA	
422							IN CHARGE C. LEMLEY	C
D00	REV	DATE	BY	снк	APP	DESCRIPTION	03/18/2016	

RECORD SET
15% DESIGN
SUBMITTAL
NOT FOR
CONSTRUCTION








CALIFORNIA HIGH-SPEED TRAIN PROJECT MERCED TO FRESNO SECTION

CENTRAL VALLEY WYE
AVENUE 21 TO ROAD 13 WYE ALTERNATIVE
KEY MAP OF STRUCTURAL PLANS
SHEET 2 OF 2

CONTRACT NO.
HSR08-05
DRAWING NO.
ST-B4002-C
SCALE
N. T. S.
SHEET NO.

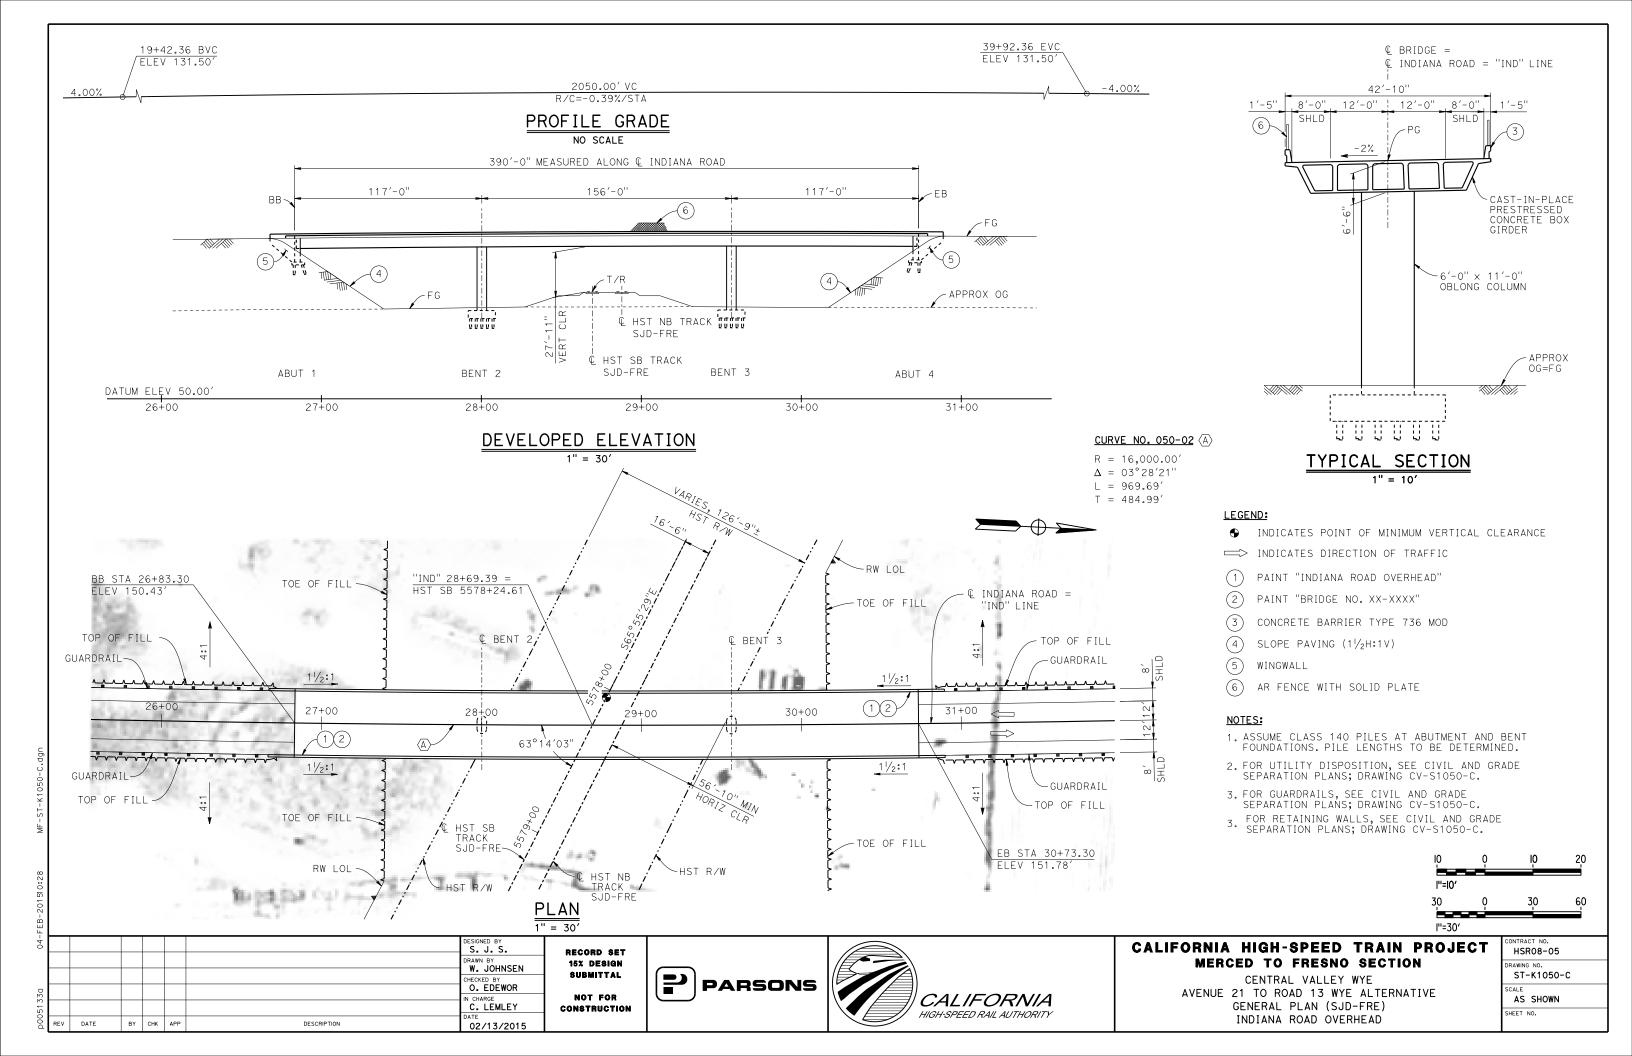

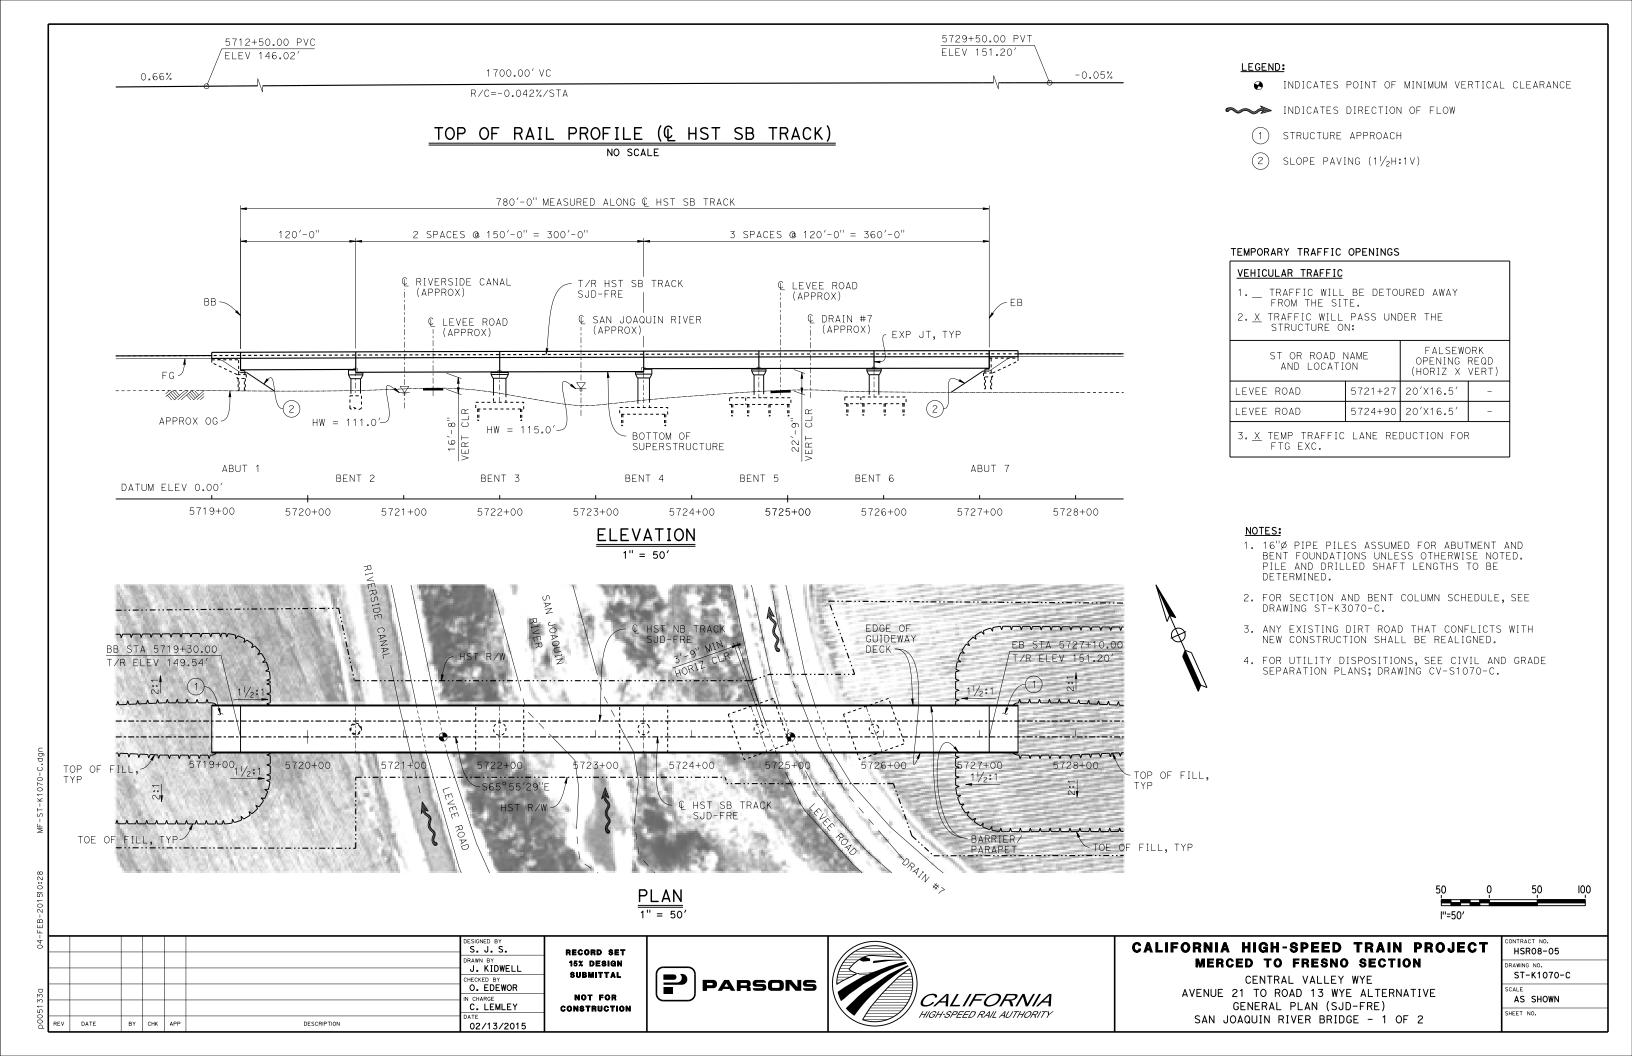


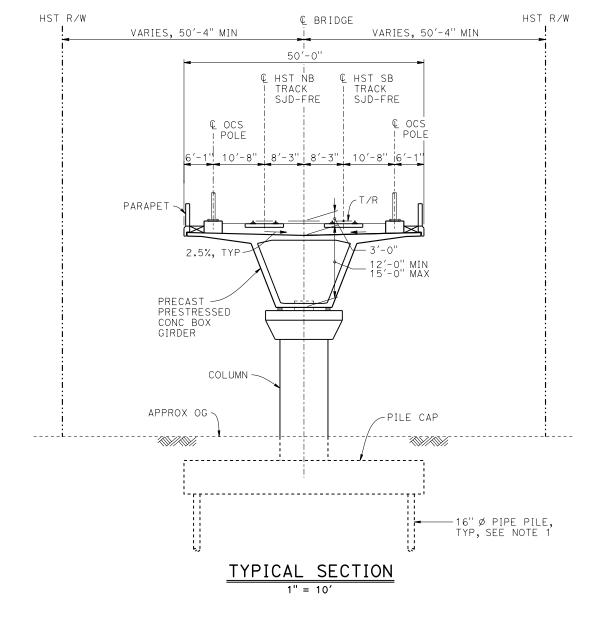

	BENT COLUMN SCHE	DULE
BENT	COLUMN TYPE	CIDH TYPE
2	10'-0''Ø	12′-0''ø
3	13'-0''ø	
4	12'-0"ø	
5 - 6	10'-0"Ø	

NOTES

1. PILE AND DRILLED SHAFT LENGTHS TO BE DETERMINED.

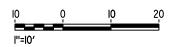

Щ								
-50							DESIGNED BY S. J. S.	
							J. KIDWELL	1
0							CHECKED BY O. EDEWOR	l
51330							IN CHARGE C. LEMLEY	, ا
00d	REV	DATE	BY	СНК	APP	DESCRIPTION	DATE 02/13/2015	

RECORD SET
15% DESIGN
SUBMITTAL
NOT FOR
CONSTRUCTION






CALIFORNIA HIGH-SPEED TRAIN PROJECT MERCED TO FRESNO SECTION


CENTRAL VALLEY WYE
AVENUE 21 TO ROAD 13 WYE ALTERNATIVE
TYPICAL SECTION (SJD-FRE)
SAN JOAQUIN RIVER BRIDGE - 2 OF 2

CONTRACT NO.	
HSR08-05	
DRAWING NO.	
ST-K3070-C	
SCALE	
AS SHOWN	
SHEET NO.	

TOP OF RAIL PROFILE (& HST SB TRACK) NO SCALE

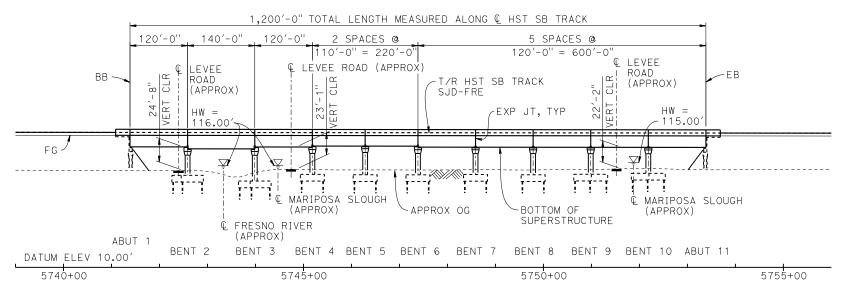

DEVELOPED ELEVATION

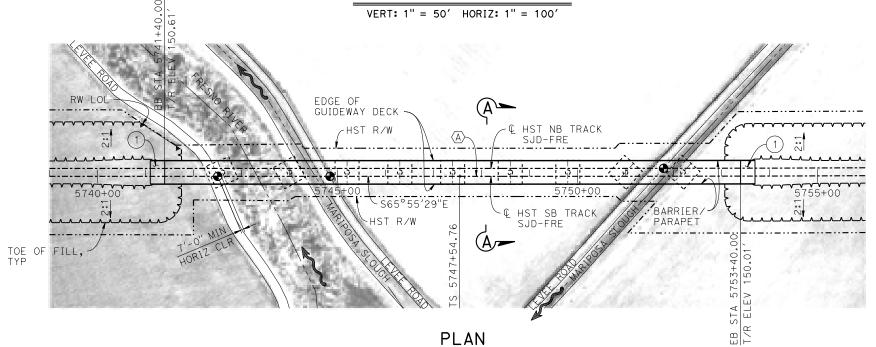

TEMPORARY TRAFFIC OPENINGS

VEHICULAR TRAFFIC

- 1. __ TRAFFIC WILL BE DETOURED AWAY FROM THE SITE.
- 2. X TRAFFIC WILL PASS UNDER THE STRUCTURE ON:

ST OR ROAD NAME AND LOCATION				
5742+40	20'X16.5'	-		
5744+72	20'X16.5'	-		
5751+52	20′X16.5′	-		
	5742+40 5744+72			

3. \underline{X} TEMP TRAFFIC LANE REDUCTION FOR FTG EXC.

NOTES:

- 1. 16"Ø PIPE PILES ASSUMED FOR ABUTMENT AND BENT FOUNDATIONS. PILE LENGTHS TO BE DETERMINED.
- 2. FOR SECTION, SEE DRAWING ST-K3080-C.
- 3. ANY EXISTING DIRT ROAD THAT CONFLICTS WITH NEW CONSTRUCTION SHALL BE REALIGNED.
- 4. FOR UTILITY DISPOSITIONS, SEE CIVIL AND GRADE SEPARATION PLANS; DRAWING CV-S1080-C.
- 5. FOR RETAINING WALLS, SEE CIVIL AND GRADE SEPARATION PLANS; DRAWING CV-S1080-C.

LEGEND:

INDICATES DIRECTION OF FLOW

- (1) STRUCTURE APPROACH
- (2) SLOPE PAVING $(1\frac{1}{2}H:1V)$

CURVE SJD-FRE 2 SB (A)

R = 45,016.50'LS = 1,650.00'



DESIGNED BY
S. J. S.

DRAWN BY
J. KIDWELL
CHECKED BY
O. EDEWOR
IN CHARGE
C. LEMLEY
DATE
REV DATE BY CHK APP
DESCRIPTION
DATE
02/13/2015

RECORD SET
15% DESIGN
SUBMITTAL
NOT FOR
CONSTRUCTION

1" = 100'





CALIFORNIA HIGH-SPEED TRAIN PROJECT MERCED TO FRESNO SECTION

CENTRAL VALLEY WYE

AVENUE 21 TO ROAD 13 WYE ALTERNATIVE


GENERAL PLAN (SJD-FRE)

AERIAL #1 - FRESNO RIVER AND MARIPOSA SLOUGH - 1 OF 2

HSR08-05
DRAWING NO.
ST-K1080-C

AS SHOWN



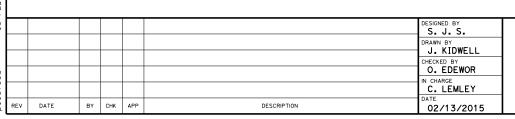

RECORD SET
15% DESIGN
SUBMITTAL
NOT FOR
CONSTRUCTION

HST R/W

VARIES, 50'-4" MIN

PARAPET ~

PRECAST -PRESTRESSED CONC BOX GIRDER

APPROX OG

© OCS ! POLE

2.5%, TYP

10'-0" Ø COLUMN ⋅

10'-8"





HST R/W

€ BRIDGE

€ HST SB | TRACK | SJD-FRE

10'-8"

© HST NB I TRACK I SJD-FRE

SECTION A-A

VARIES, 50'-4" MIN

€ ocs ! Pole

-PILE CAP

-16" Ø PIPE PILE, TYP, SEE NOTE 1

NOTES:

- 1. PILE LENGTHS TO BE DETERMINED.
- 2. FOR TRACK SUPERELEVATION DETAILS, SEE ALIGNMENT AND TYPICAL SECTION PLANS; DRAWING TT-B0050-C.



CALIFORNIA HIGH-SPEED TRAIN PROJECT MERCED TO FRESNO SECTION


CENTRAL VALLEY WYE


AVENUE 21 TO ROAD 13 WYE ALTERNATIVE


TYPICAL SECTION (SJD-FRE)

AERIAL #1 - FRESNO RIVER AND MARIPOSA SLOUGH - 2 OF 2

T	HSR08-05
	DRAWING NO. ST-K3080-C
	AS SHOWN

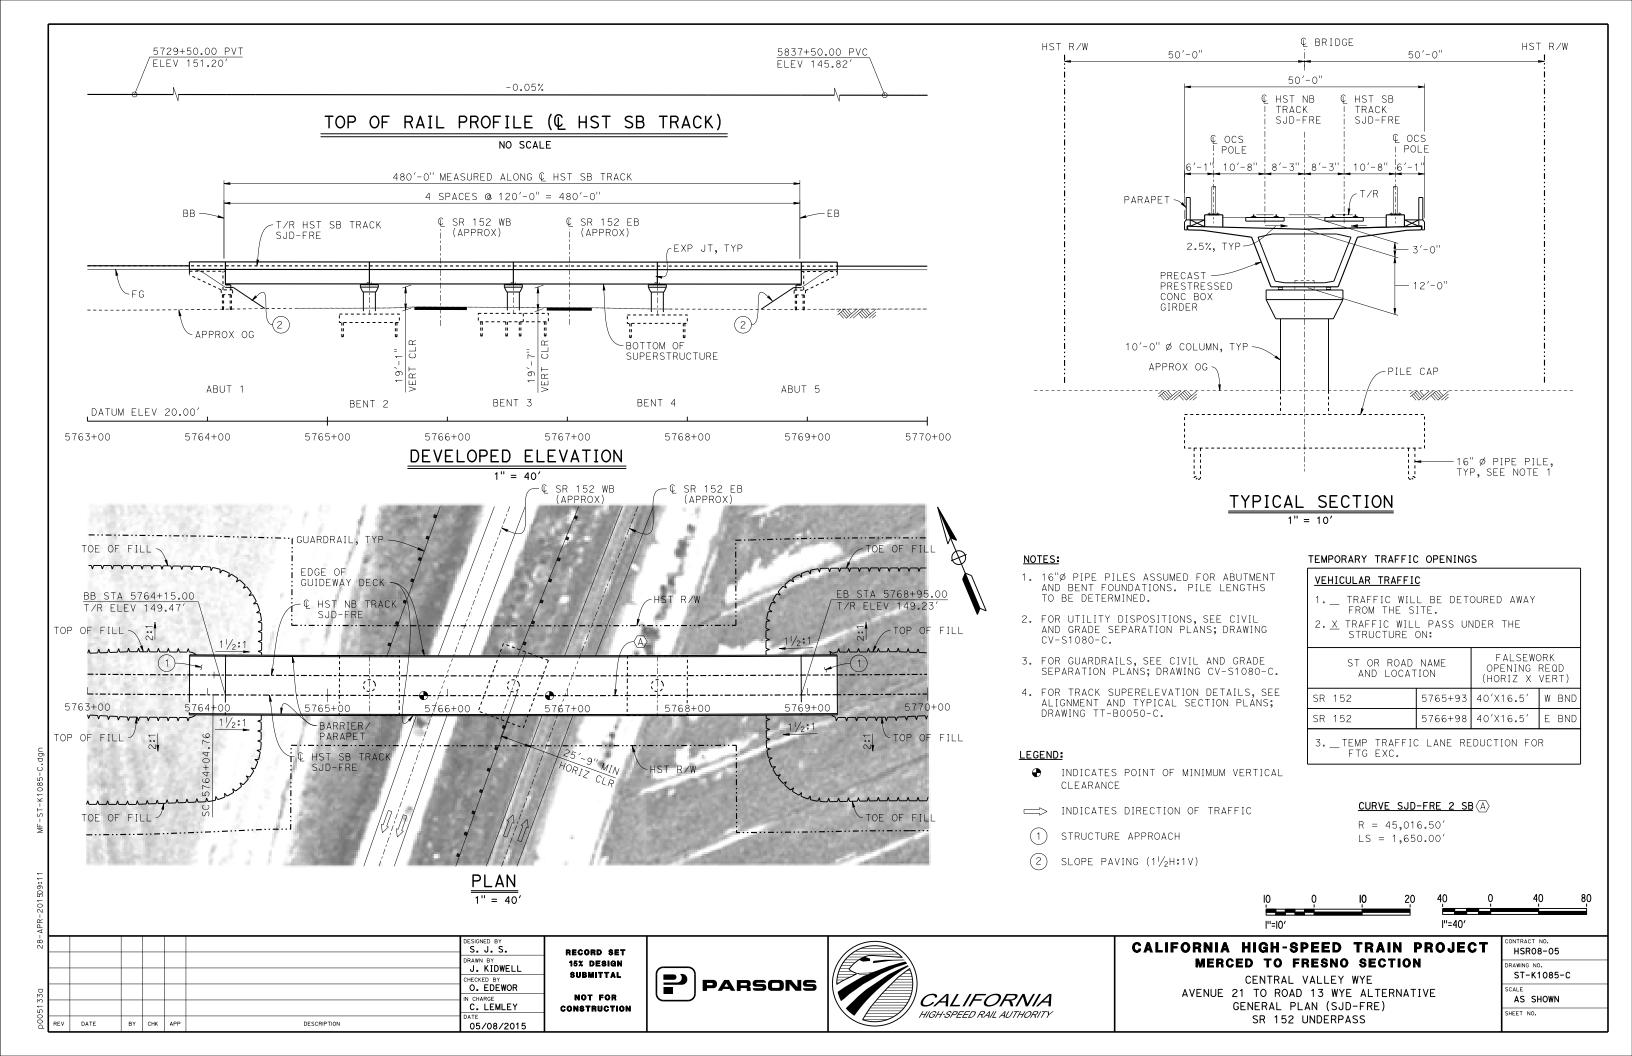

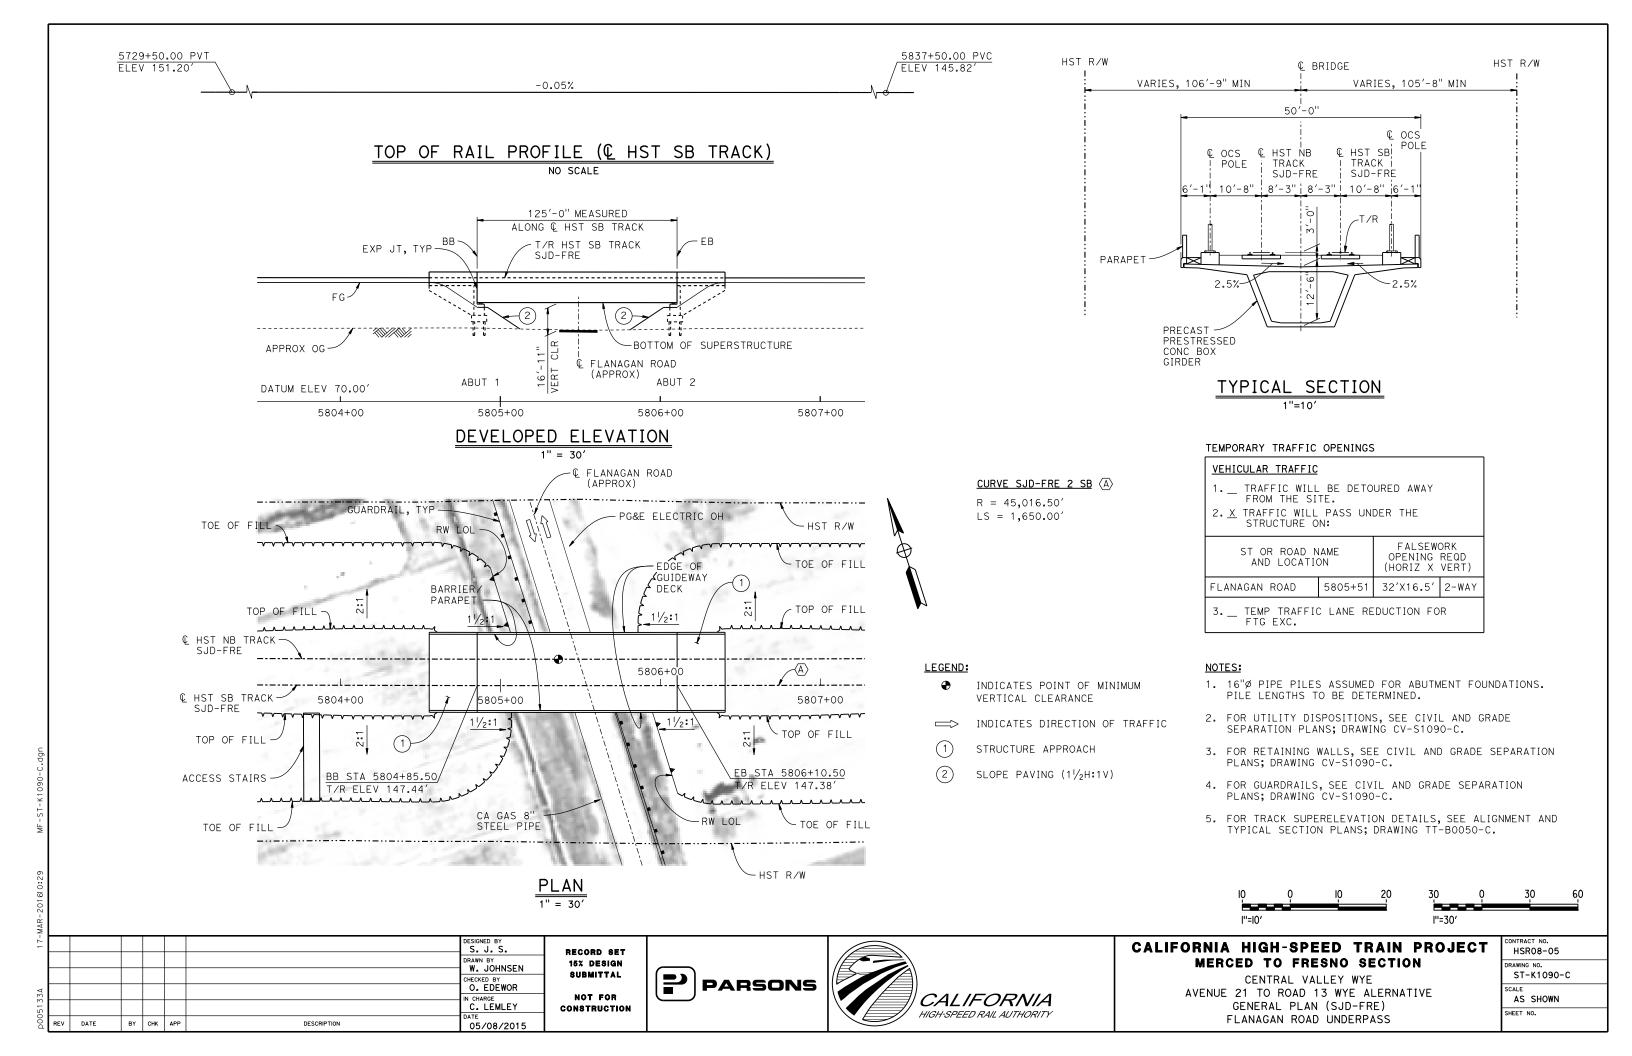

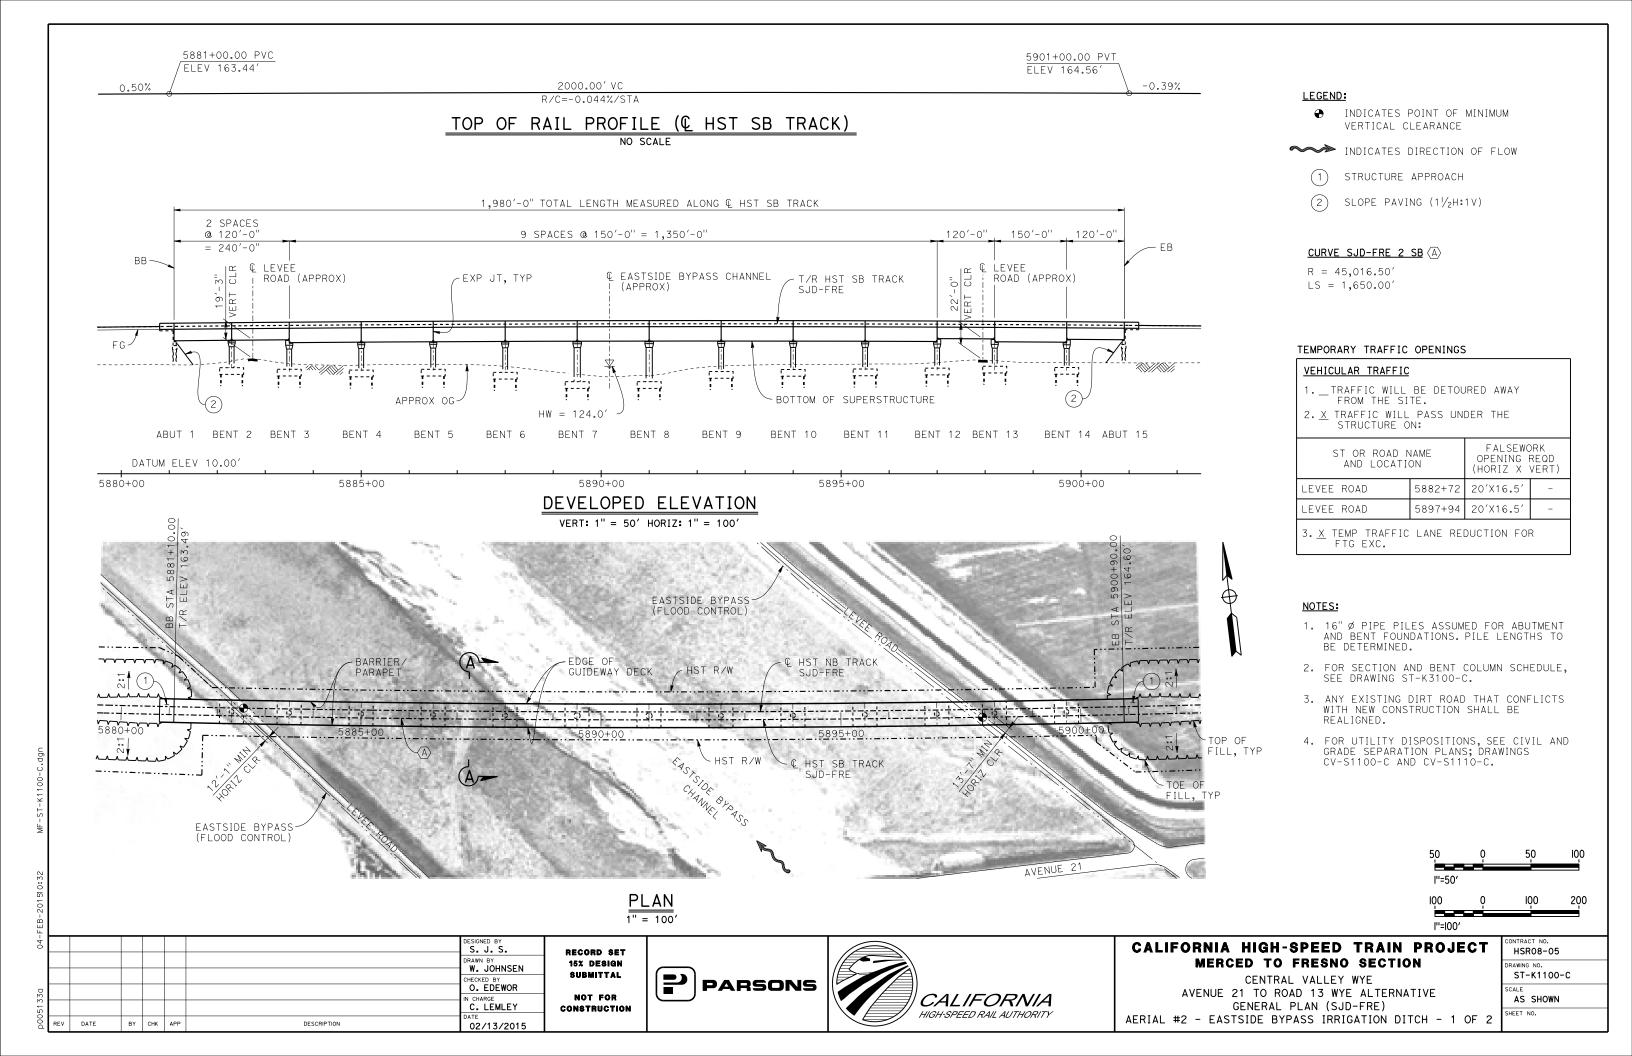


€ BRIDGE

BENT CO	LUMN SCHEDULE
BENT	COLUMN TYPE
2 - 6	10'-0"Ø
7 - 8	13′-0"ø
9 - 14	10'-0"ø

NOTES

- 1. PILE LENGTHS TO BE DETERMINED.
- 2. FOR TRACK SUPERELEVATION DETAILS, SEE ALIGNMENT AND TYPICAL SECTION PLANS; DRAWING TT-B0050-C.

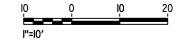

ij.								
-60							DESIGNED BY S. J. S.	
							DRAWN BY W. JOHNSEN	'
0							CHECKED BY O. EDEWOR	
51330							IN CHARGE C. LEMLEY	c
00d	REV	DATE	BY	СНК	APP	DESCRIPTION	DATE 02/13/2015	l

RECORD SET
15% DESIGN
SUBMITTAL
NOT FOR
CONSTRUCTION





CALIFORNIA HIGH-SPEED TRAIN PROJECT MERCED TO FRESNO SECTION


CENTRAL VALLEY WYE


AVENUE 21 TO ROAD 13 WYE ALTERNATIVE

TYPICAL SECTION (SJD-FRE)

AERIAL #2 - EASTSIDE BYPASS IRRIGATION DITCH - 2 OF 2

CONTRACT NO. HSR08-05
DRAWING NO. ST-K3100-C
AS SHOWN
SHEET NO.

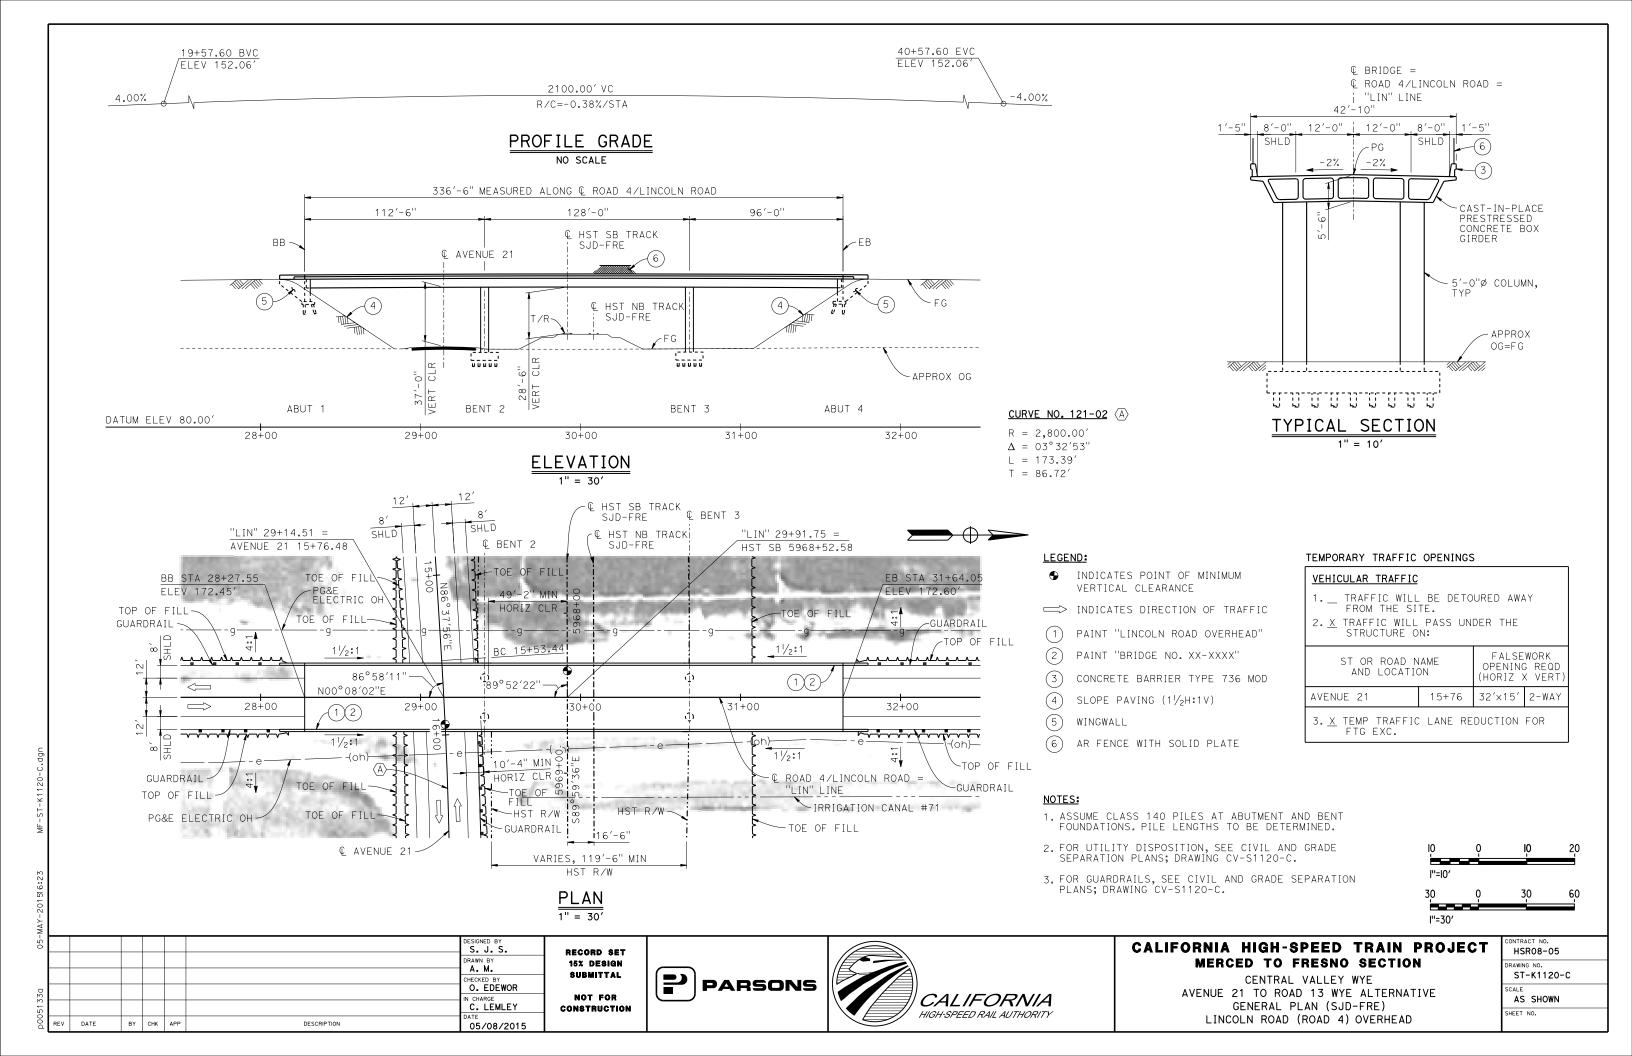

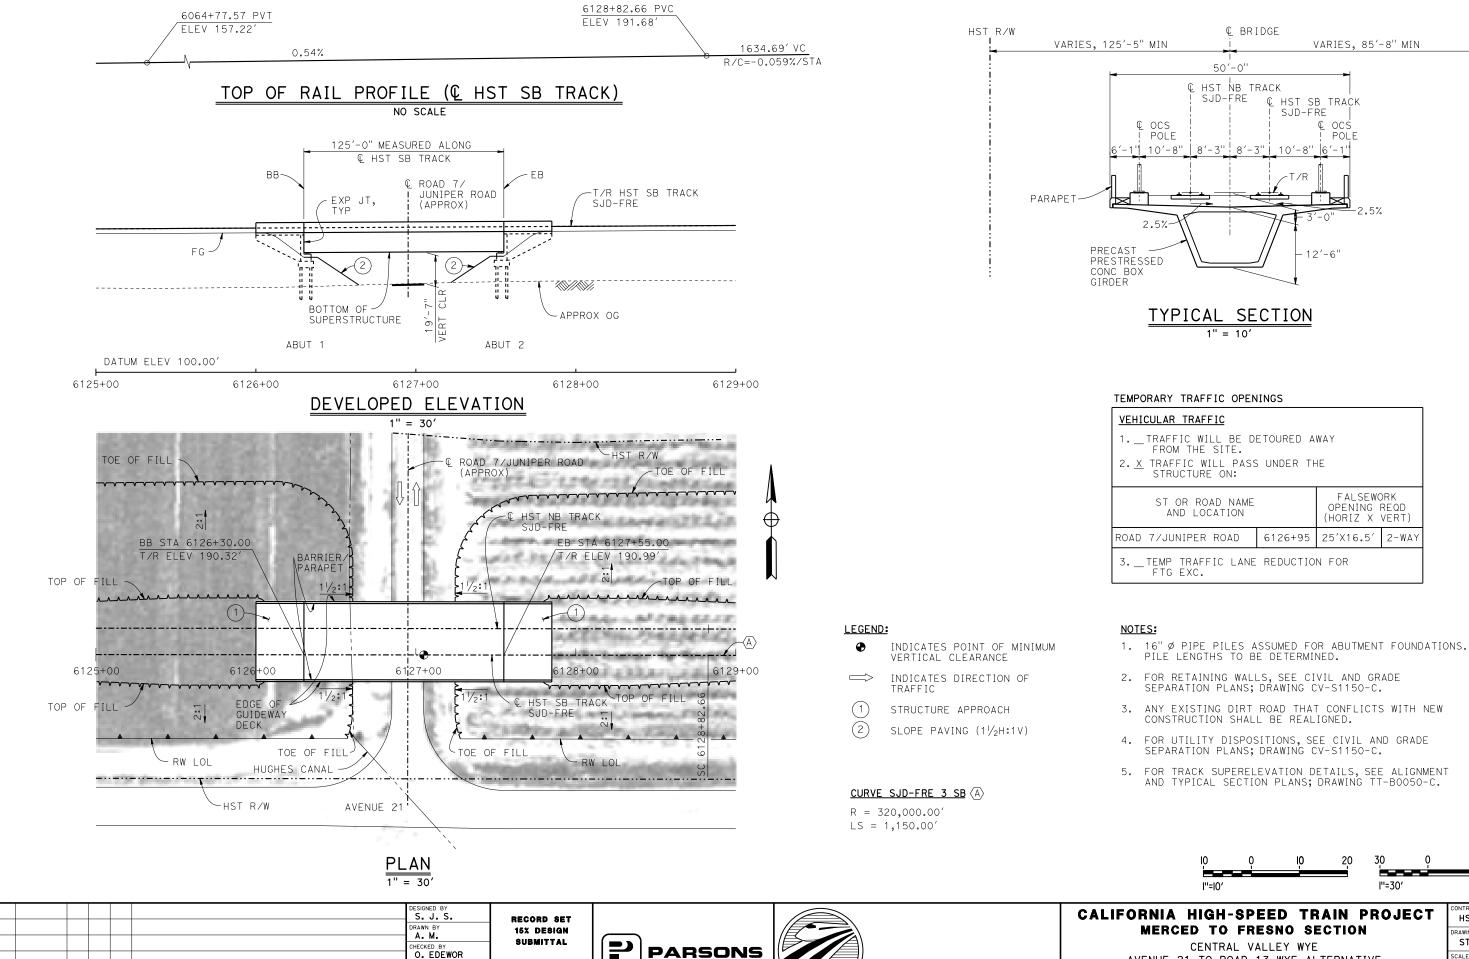

NOT FOR

CONSTRUCTION

n charge C. LEMLEY

05/08/2015

DATE

BY CHK APP

DESCRIPTION

CALIFORNIA HIGH-SPEED TRAIN PROJECT

CENTRAL VALLEY WYE AVENUE 21 TO ROAD 13 WYE ALTERNATIVE GENERAL PLAN (SJD-FRE) JUNIPER ROAD (ROAD 7) UNDERPASS


CALIFORNIA


HIGH-SPEED RAIL AUTHORITY

HSR08-05 ST-K1150-C AS SHOWN

60


HST_R/W

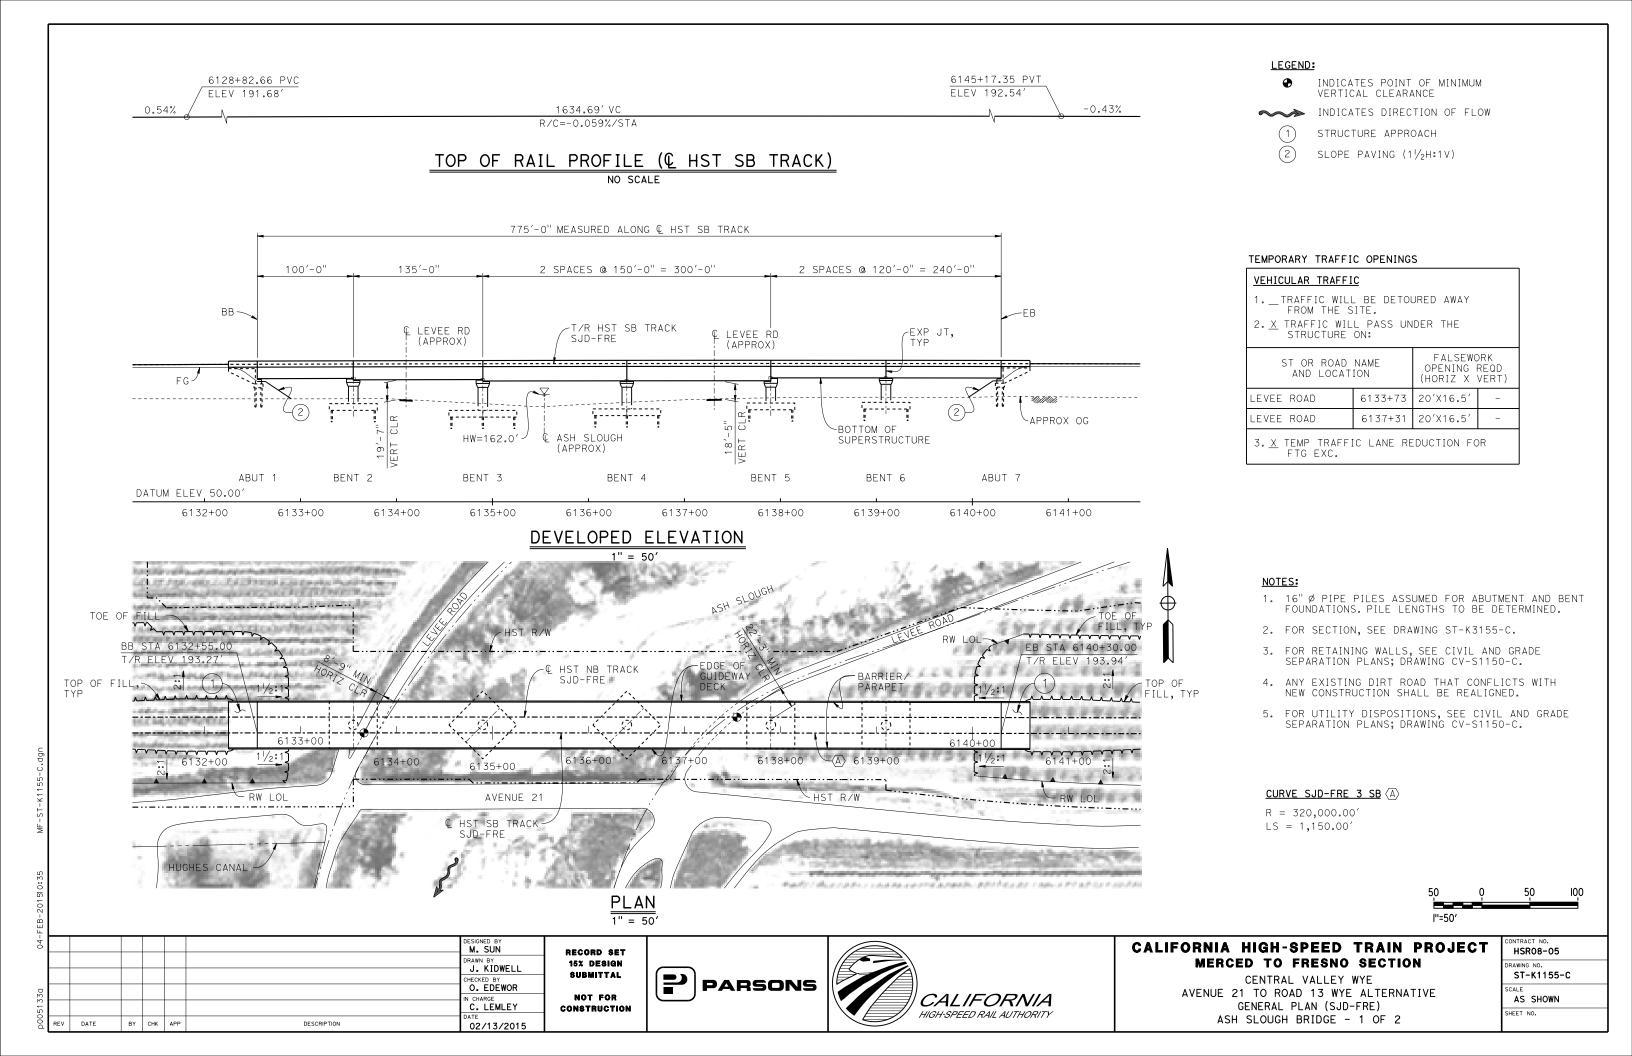

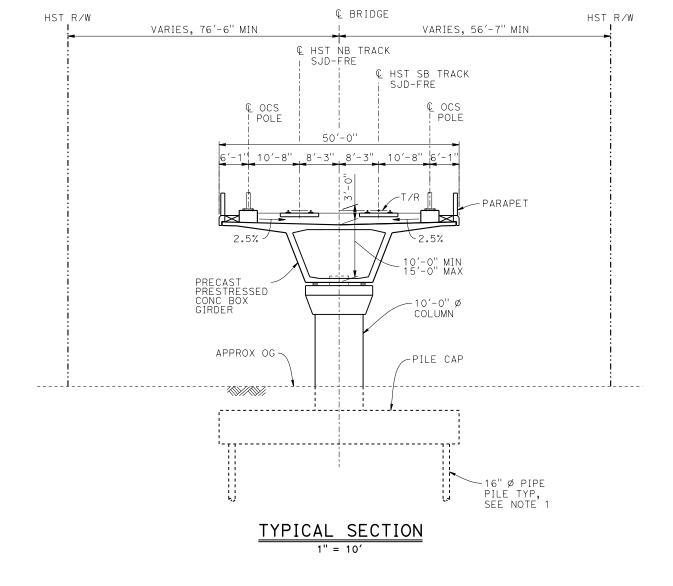

NOTES:

- 1. PILE LENGTHS TO BE DETERMINED.
- 2. FOR TRACK SUPERELEVATION DETAILS, SEE ALIGNMENT AND TYPICAL SECTION PLANS; DRAWING TT-B0050-C.

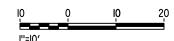

Ц								
000							DESIGNED BY M. SUN	RI
							DRAWN BY J. KIDWELL	1
_							CHECKED BY O. EDEWOR	
0							IN CHARGE C. LEMLEY	co
200	REV	DATE	BY	СНК	APP	DESCRIPTION	DATE 02/13/2015	

RECORD SET
15% DESIGN
SUBMITTAL
NOT FOR
CONSTRUCTION





CALIFORNIA HIGH-SPEED TRAIN PROJECT MERCED TO FRESNO SECTION

CENTRAL VALLEY WYE


AVENUE 21 TO ROAD 13 WYE ALTERNATIVE


TYPICAL SECTION (SJD-FRE)


ASH SLOUGH BRIDGE - 2 OF 2

T	HSR08-05
	DRAWING NO. ST-K3155-C
	SCALE AS SHOWN

AS SHOWN
SHEET NO.

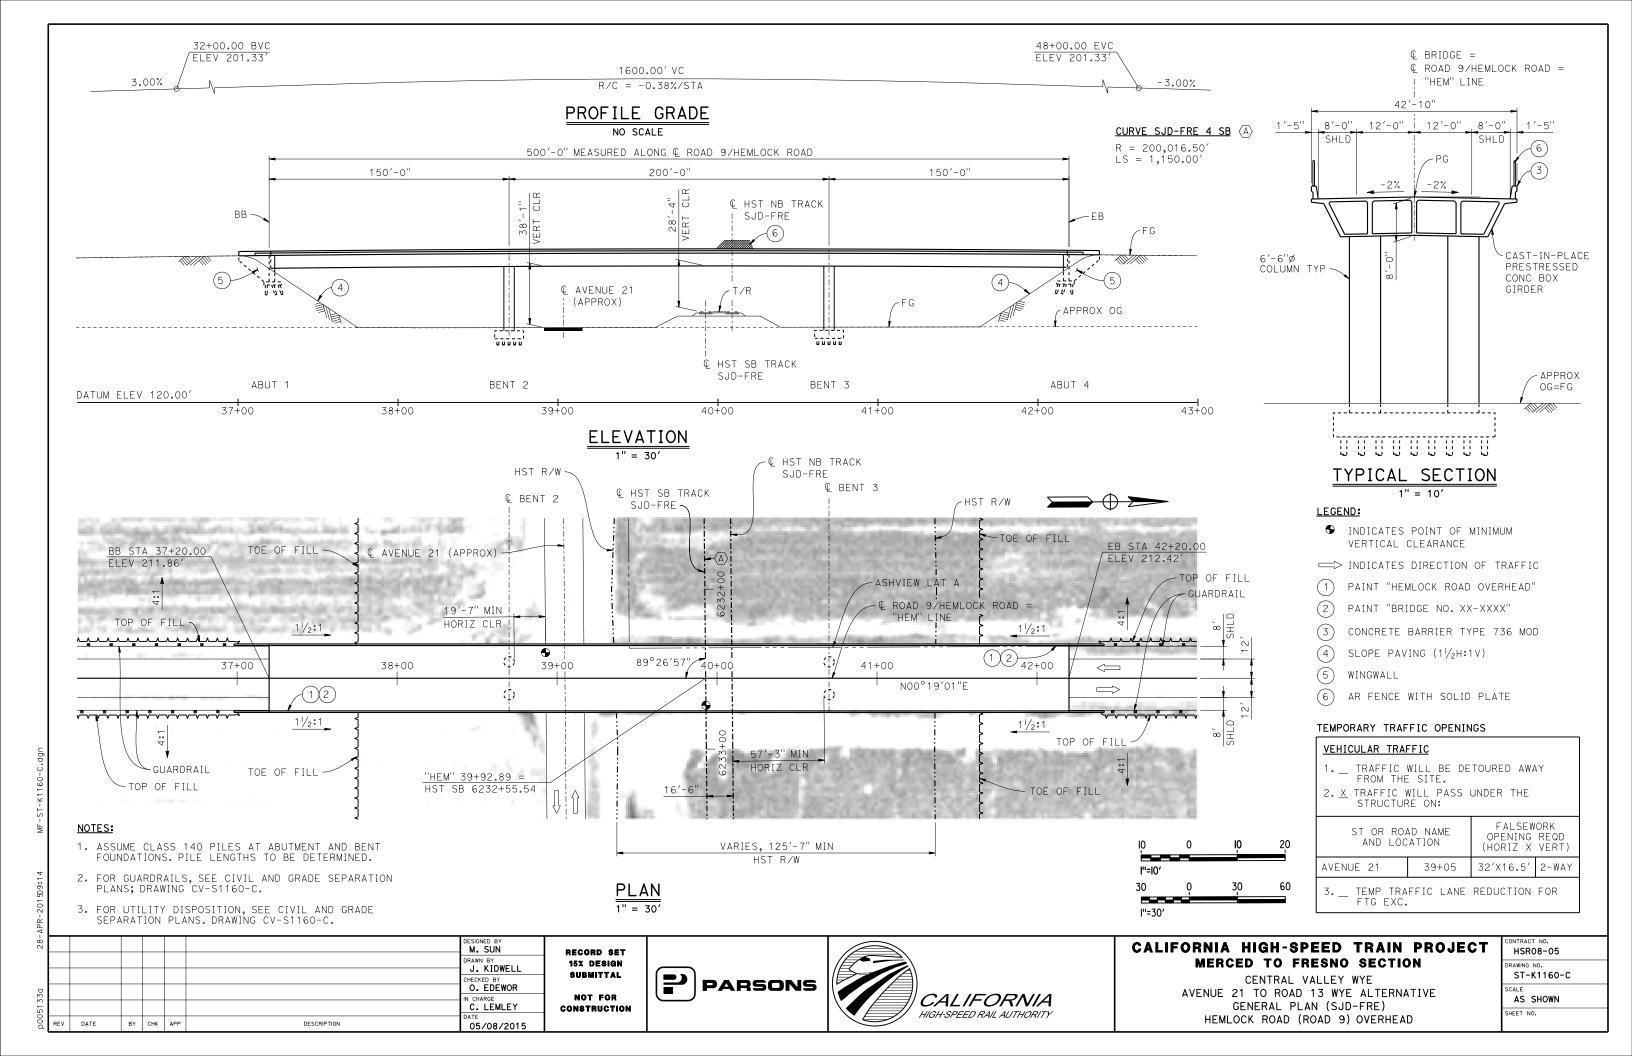

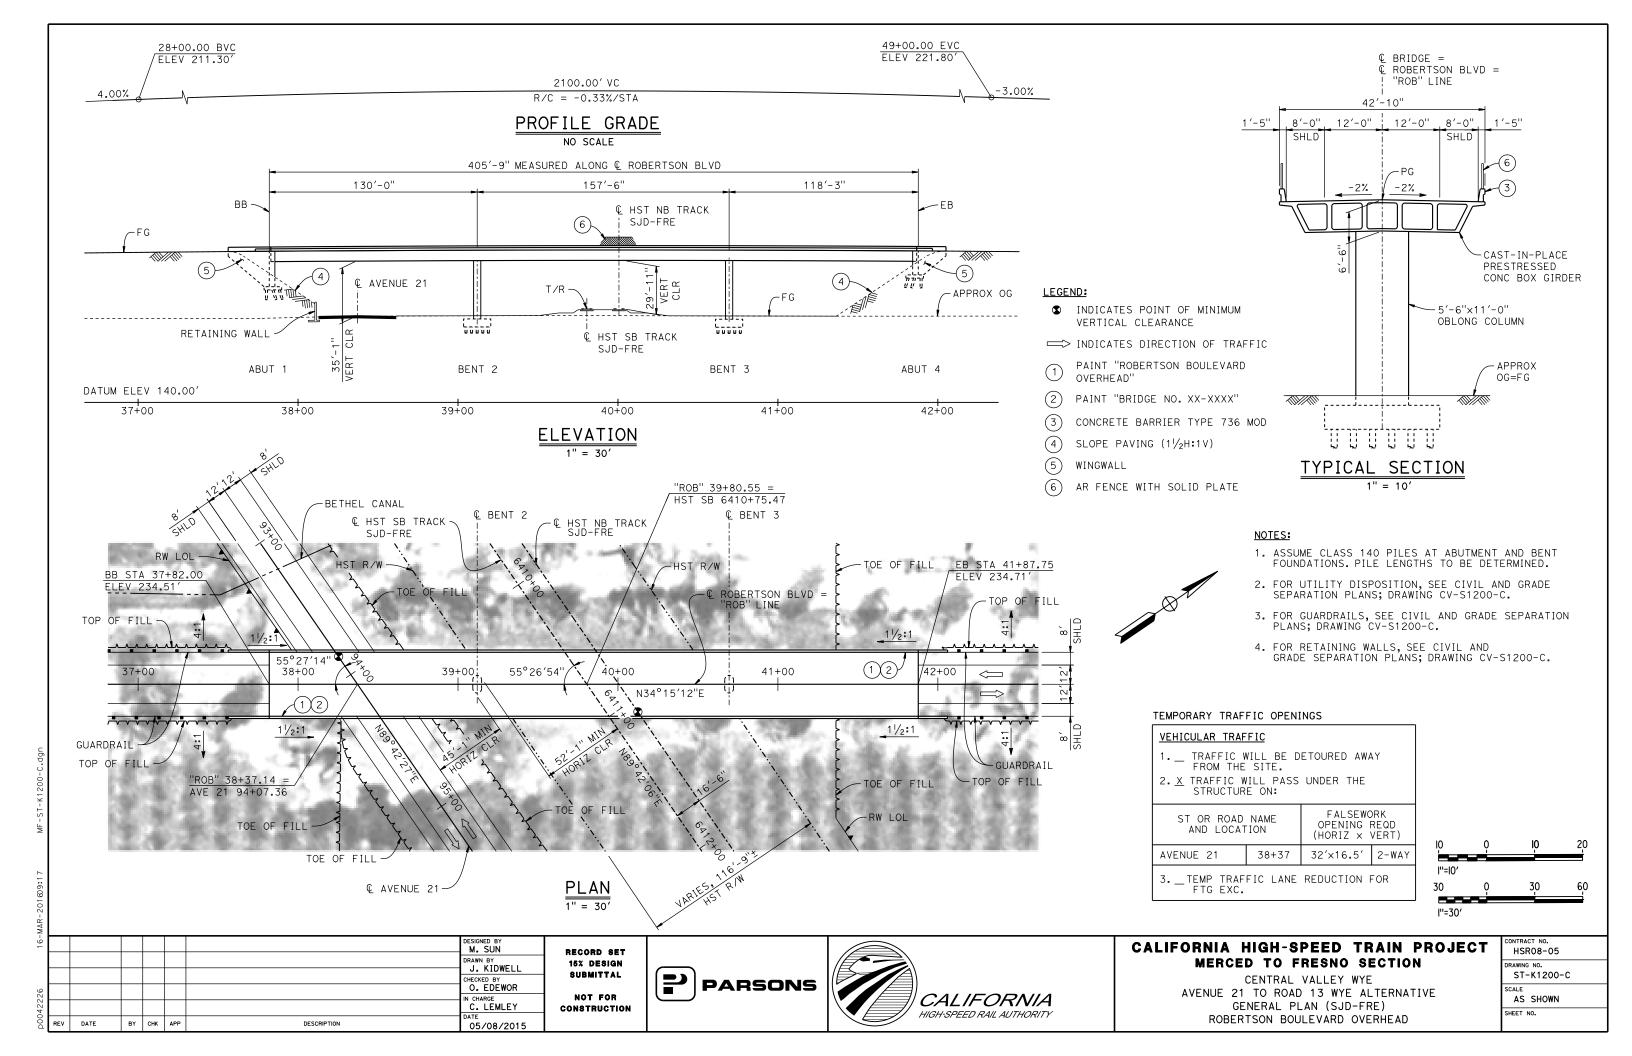

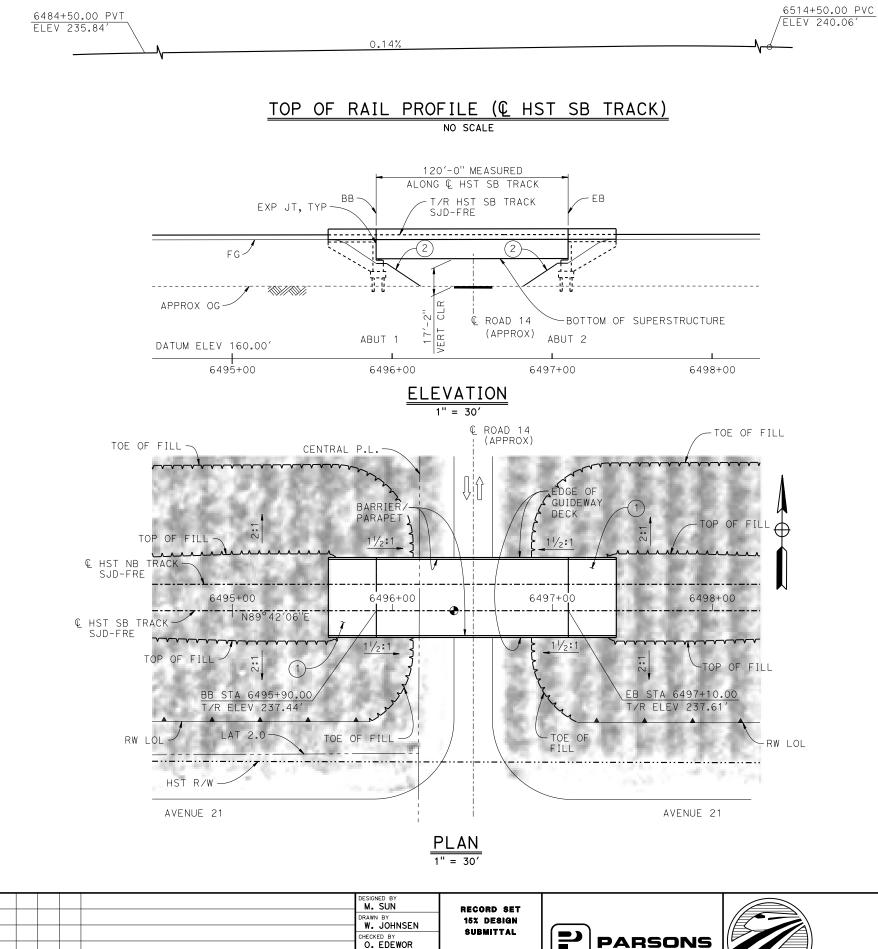

NOT FOR

CONSTRUCTION


C. LEMLEY

05/08/2015

DATE

BY CHK APP

DESCRIPTION

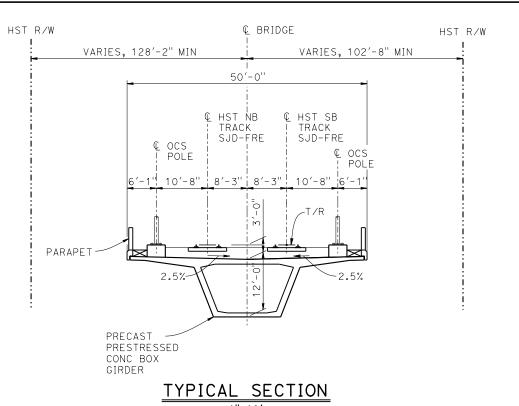

TEMPORARY TRAFFIC OPENINGS

	0. 2	<i>*</i>				
VEHICULAR TRAFFIC						
1 TRAFFIC WILL BE DETOURED AWAY FROM THE SITE.						
2. X TRAFFIC WILL PASS UNDER THE STRUCTURE ON:						
ST OR ROAD N AND LOCATIO	FALSEWOPENING (HORIZ X	REQD				
ROAD 14	6496+50	32′X16.5′	2-WAY			
3 TEMP TRAFFIC LANE REDUCTION FOR						

LEGEND:

INDICATES POINT OF MINIMUM VERTICAL CLEARANCE

INDICATES DIRECTION OF TRAFFIC

STRUCTURE APPROACH


SLOPE PAVING (1/2H:1V)

NOTES:

CALIFORNIA

HIGH-SPEED RAIL AUTHORITY

- 1. 16" Ø PIPE PILES ASSUMED FOR ABUTMENT FOUNDATIONS. PILE LENGTHS TO BE DETERMINED.
- 2. FOR UTILITY DISPOSITIONS, SEE CIVIL AND GRADE SEPARATION PLANS; DRAWING CV-S1210-C.
- 3. FOR RETAINING WALLS, SEE CIVIL AND GRADE SEPARATION PLANS; DRAWING CV-S1210-C.

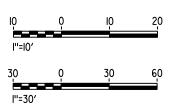



MERCED TO FRESNO SECTION


CENTRAL VALLEY WYE AVENUE 21 TO ROAD 13 WYE ALTERNATIVE GENERAL PLAN (SJD-FRE) ROAD 14 UNDERPASS


CALIFORNIA HIGH-SPEED TRAIN PROJECT

CONTRACT NO. HSR08-05
DRAWING NO. ST-K1210-C
0, 11,2,0
SCALE
AS SHOWN
SHEET NO.

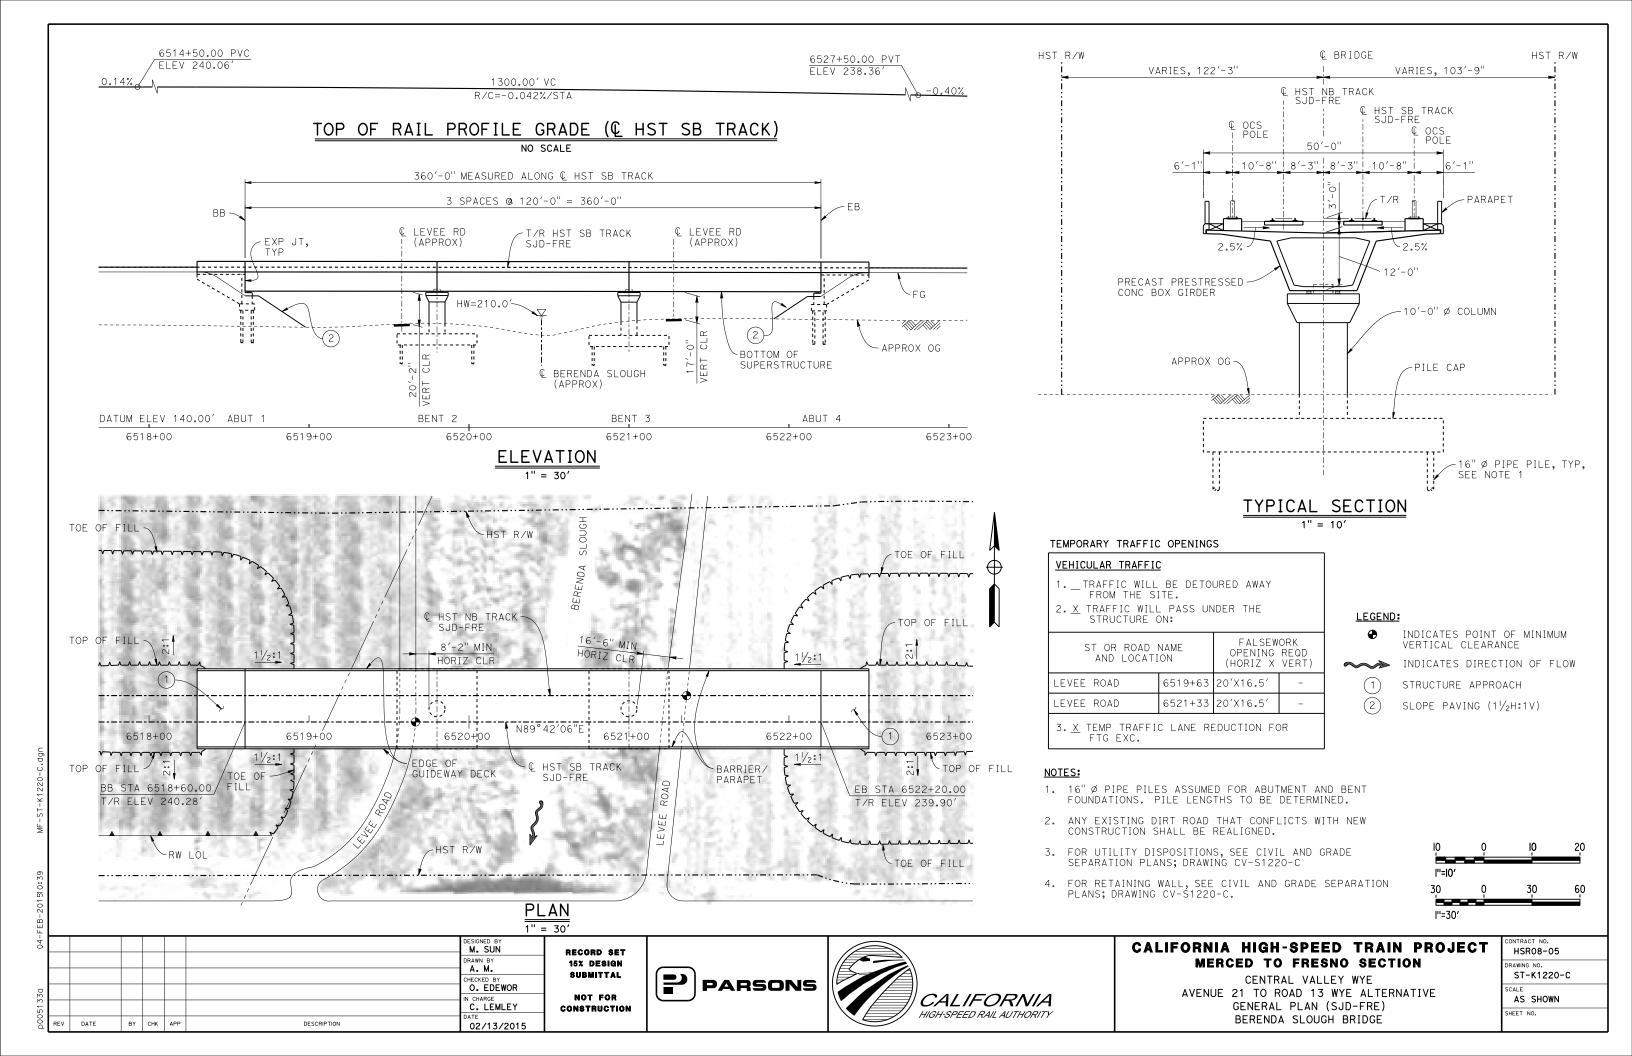

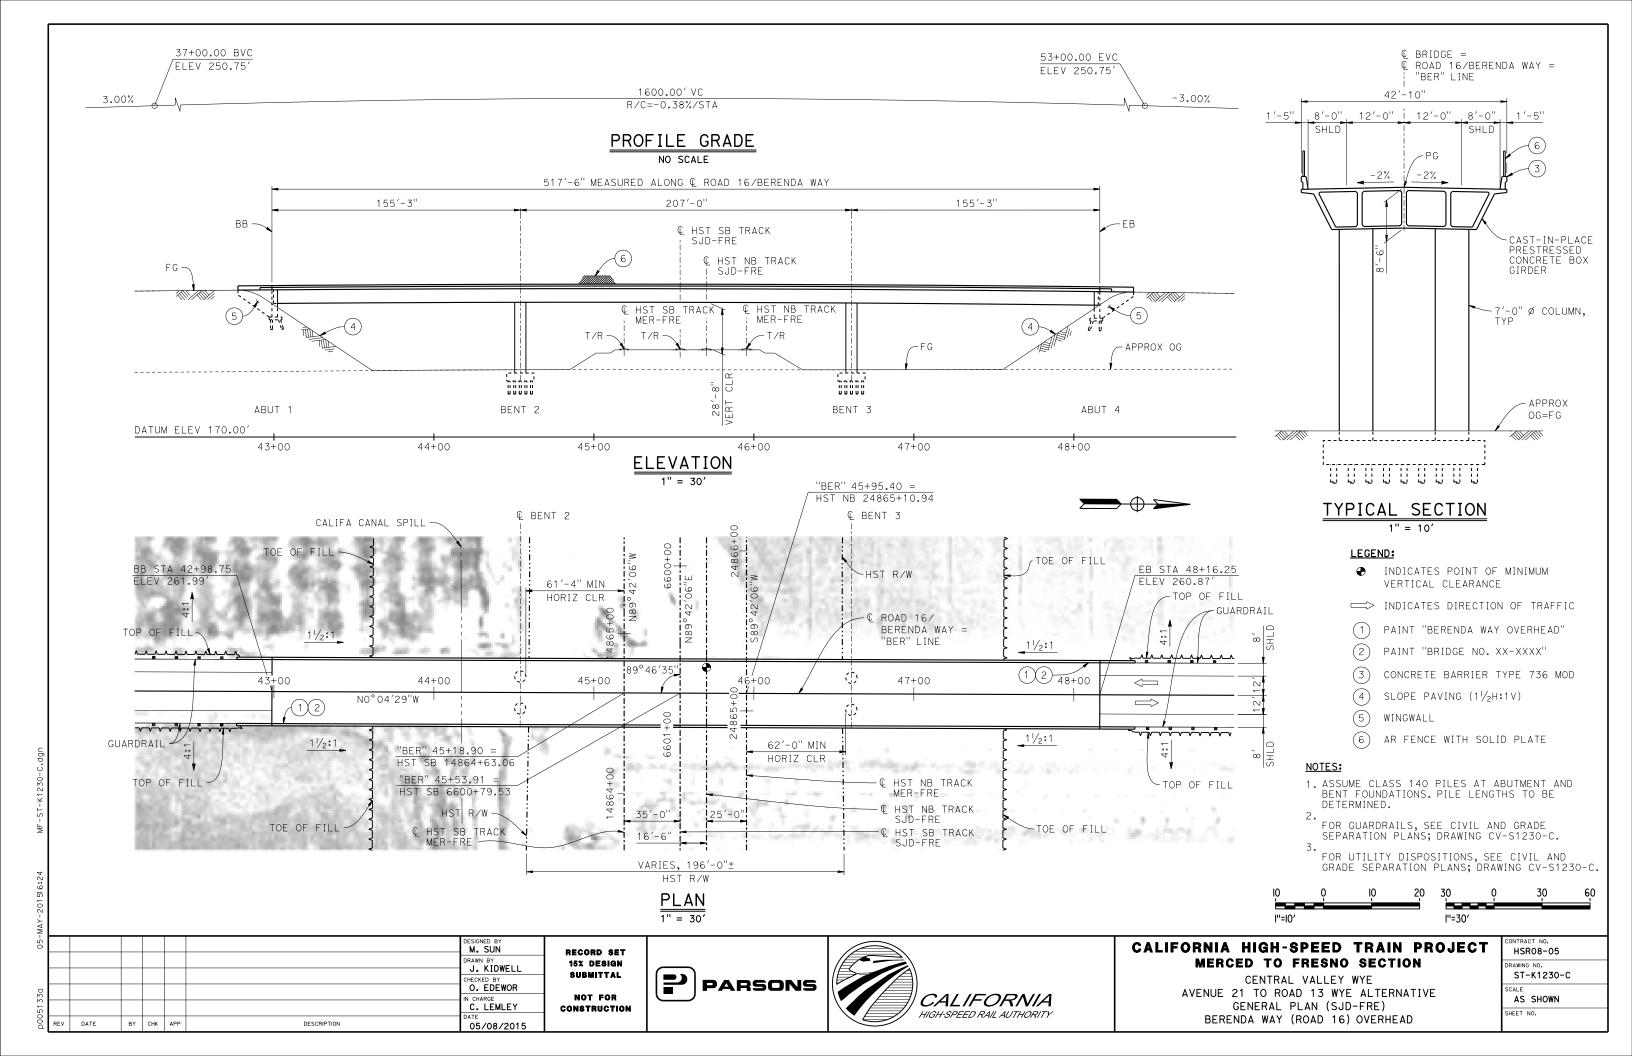


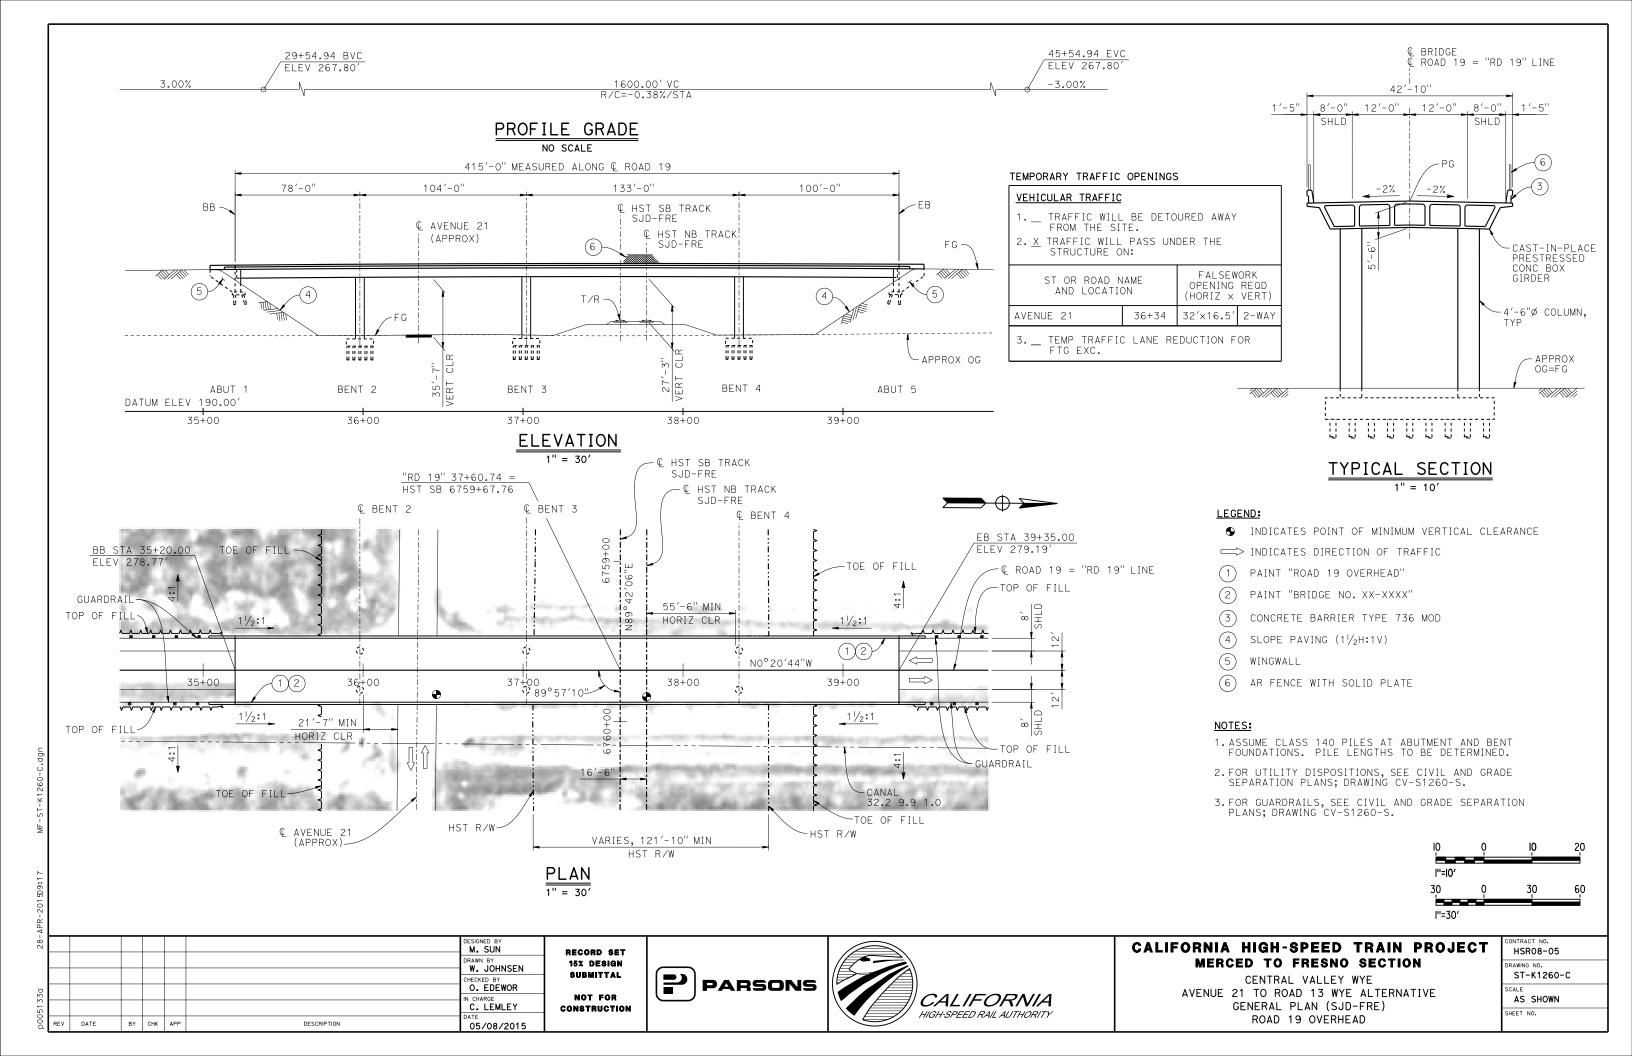


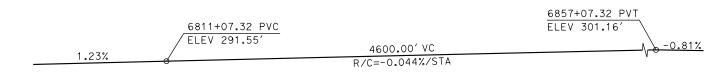

TOP OF RAIL PROFILE (& HST SB TRACK)

NO SCALE

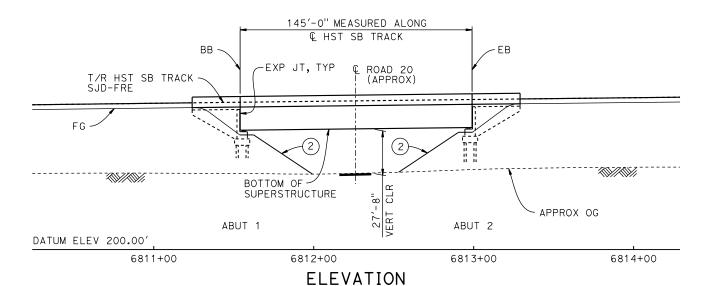

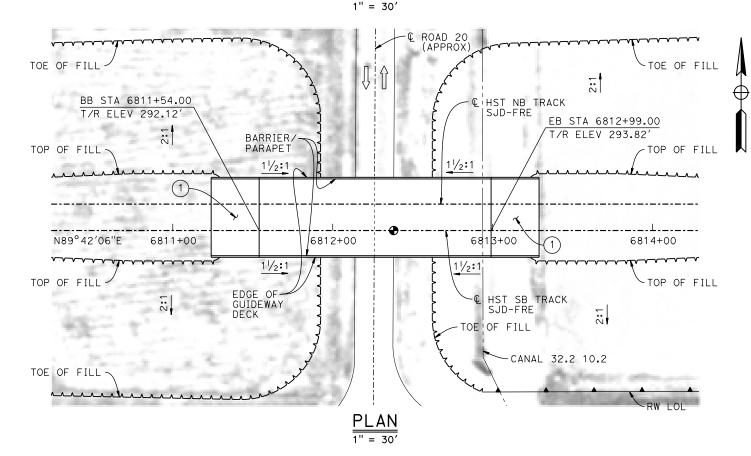

HST R/W HST R/W € BRIDGE VARIES, 122'-8" MIN VARIES, 160'-5" MIN © HST NB € HST SB TRACK | SJD-FRE TRACK SJD-FRE OCS POLE POLE 10'-8" | 8'-3" | 8'-3" | 10'-8" -PARAPET 2.5% PRECAST PRESTRESSED CONC BOX GIRDER

TYPICAL SECTION

TEMPORARY TRAFFIC OPENINGS

VEHICULAR TRAFFIC

- 1. __TRAFFIC WILL BE DETOURED AWAY FROM THE SITE.
- 2. \underline{X} TRAFFIC WILL PASS UNDER THE STRUCTURE ON:

ST OR AND	FALSEW OPENING (HORIZ X	REQD	
ROAD 20	6812+26	32′X16.5′	2-WAY


3. __ TEMP_TRAFFIC LANE REDUCTION FOR FTG EXC.

LEGEND:

- INDICATES POINT OF MINIMUM VERTICAL CLEARANCE
- INDICATES DIRECTION OF TRAFFIC
- STRUCTURE APPROACH
- SLOPE PAVING (1/2H:1V)

NOTES:

- 1. 16" Ø PIPE PILES ASSUMED FOR ABUTMENT FOUNDATIONS. PILE LENGTHS TO BE DETERMINED.
- 2. ANY EXISTING DIRT ROAD THAT CONFLICTS WITH NEW CONSTRUCTION SHALL BE REALIGNED.
- 3. FOR UTILITY DISPOSITIONS, SEE CIVIL AND GRADE SEPARATION PLANS; DRAWING CV-S1270-C.
- 4. FOR RETAINING WALL, SEE CIVIL AND GRADE SEPARATION PLANS; DRAWING CV-S1270-C.

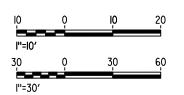

É								
<u> </u>							DESIGNED BY	
							DRAWN BY J. C.	
ِ ا							CHECKED BY O. EDEWOR	
2777							IN CHARGE C. LEMLEY	
200	REV	DATE	BY	СНК	APP	DESCRIPTION	DATE 05/08/2015	

RECORD SET 15% DESIGN SUBMITTAL NOT FOR CONSTRUCTION






CALIFORNIA HIGH-SPEED TRAIN PROJECT MERCED TO FRESNO SECTION

CENTRAL VALLEY WYE AVENUE 21 TO ROAD 13 WYE ALTERNATIVE GENERAL PLAN (SJD-FRE) ROAD 20 UNDERPASS

HSR08-05
DRAWING NO. ST-K1270-C
AS SHOWN
SHEET NO.

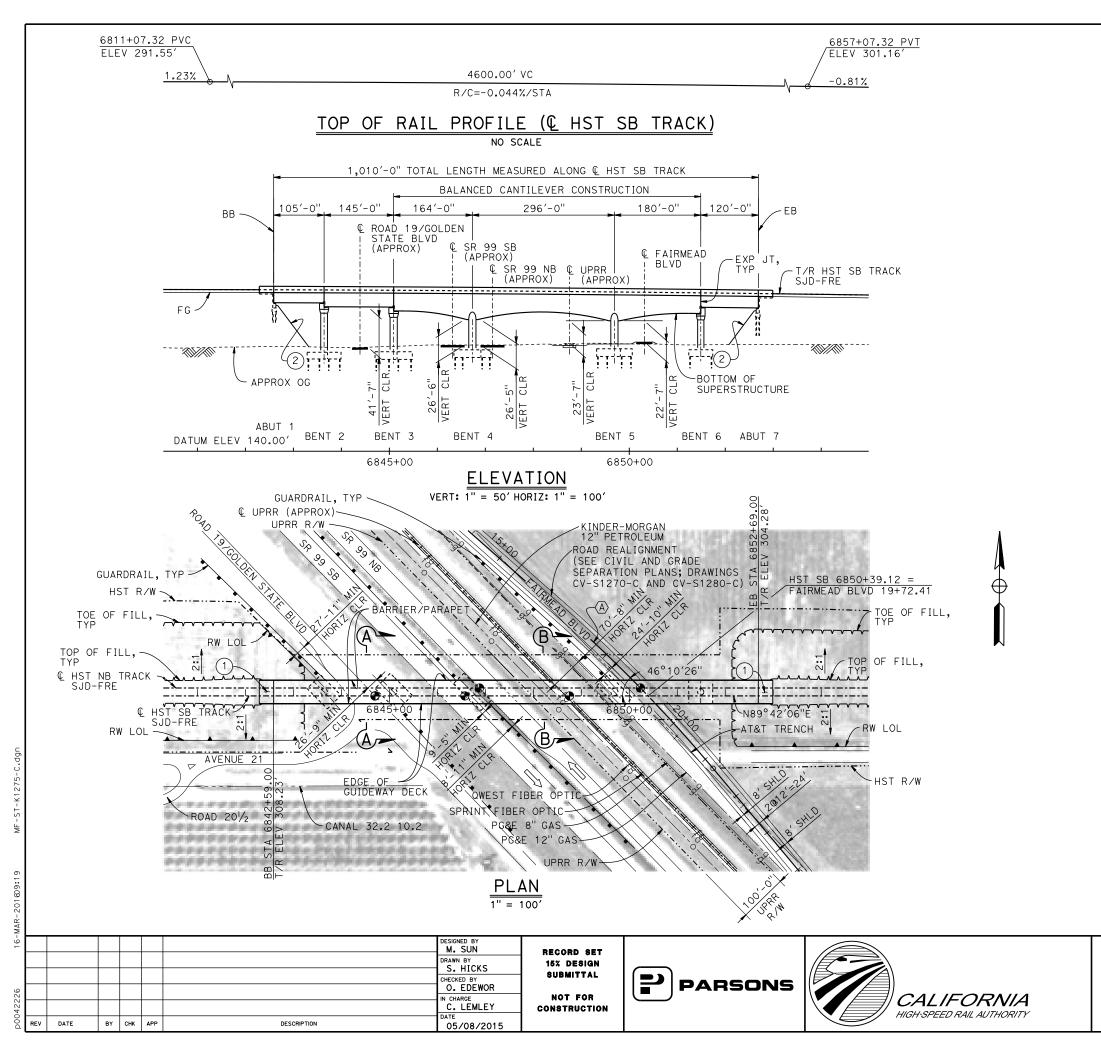

LEGEND:

- ◆ INDICATES POINT OF MINIMUM VERTICAL CLEARANCE
- □ INDICATES DIRECTION OF TRAFFIC
 □
- (1) STRUCTURE APPROACH
- 2) SLOPE PAVING $(1\frac{1}{2}H:1V)$

TEMPORARY TRAFFIC OPENINGS

VEHICULAR TRAFFIC

- 1. _ TRAFFIC WILL BE DETOURED AWAY
- FROM THE SITE.
- 2. \underline{X} TRAFFIC WILL PASS UNDER THE STRUCTURE ON:

ST OR ROAD NAME AND LOCATION	FALSEWO OPENING (HORIZ X	REQD	
ROAD 19/GOLDEN STATE BLVD	6844+40	40′×16.5′	2-WAY
SR 99	6846+35	52′x16.5′	S BND
SR 99	6847+30	52′x16.5′	N BND
FAIRMEAD BLVD	6850+39	32′x16.5′	2-WAY

3. \underline{X} TEMP TRAFFIC LANE REDUCTION FOR FTG EXC.

TEMPORARY TRAFFIC OPENINGS

RAILROAD TRAFFIC FALSEWORK OPENING REQUIRED ON:				
NAME OF RR AND L	OCATION	FALSEWORK OPENING REQD (HORIZ X VERT)		
UPRR	6848+68	24′×21′		

<u>NOTES</u>

- 1.16" Ø PIPE PILES ASSUMED FOR ABUTMENT AND BENT FOUNDATIONS. PILE LENGTHS TO BE DETERMINED.
- 2. FOR SECTIONS AND BENT COLUMN SCHEDULE, SEE DRAWING ST-K3275-C.
- 3. ANY EXISTING DIRT ROAD THAT CONFLICTS WITH NEW CONSTRUCTION SHALL BE REALIGNED.
- 4. FOR UTILITY DISPOSITIONS, SEE CIVIL AND GRADE SEPARATION PLANS; DRAWINGS CV-S1270-C AND CV-S1280-C.
- 5. FOR GUARDRAILS, SEE CIVIL AND GRADE SEPARATION PLANS; DRAWINGS CV-S1270-C AND CV-S1280-C.
- 6. FOR RETAINING WALLS, SEE CIVIL AND GRADE SEPARATION PLANS; DRAWINGS CV-S1270-C AND CV-S2180-C.


CURVE NO. 270-02 (A)

R = 3,000.00'

 $\Delta = 1°54'35'$

L = 454.11'


T = 227.49'

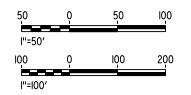



CALIFORNIA HIGH-SPEED TRAIN PROJECT MERCED TO FRESNO SECTION


CENTRAL VALLEY WYE
AVENUE 21 TO ROAD 13 WYE ALTERNATIVE
GENERAL PLAN (SJD-FRE)
AERIAL #3 - SR 99 / UPRR - 1 OF 2


CONTRACT NO. HSR08-05
DRAWING NO. ST-K1275-C
SCALE
AS SHOWN
SHEET NO.

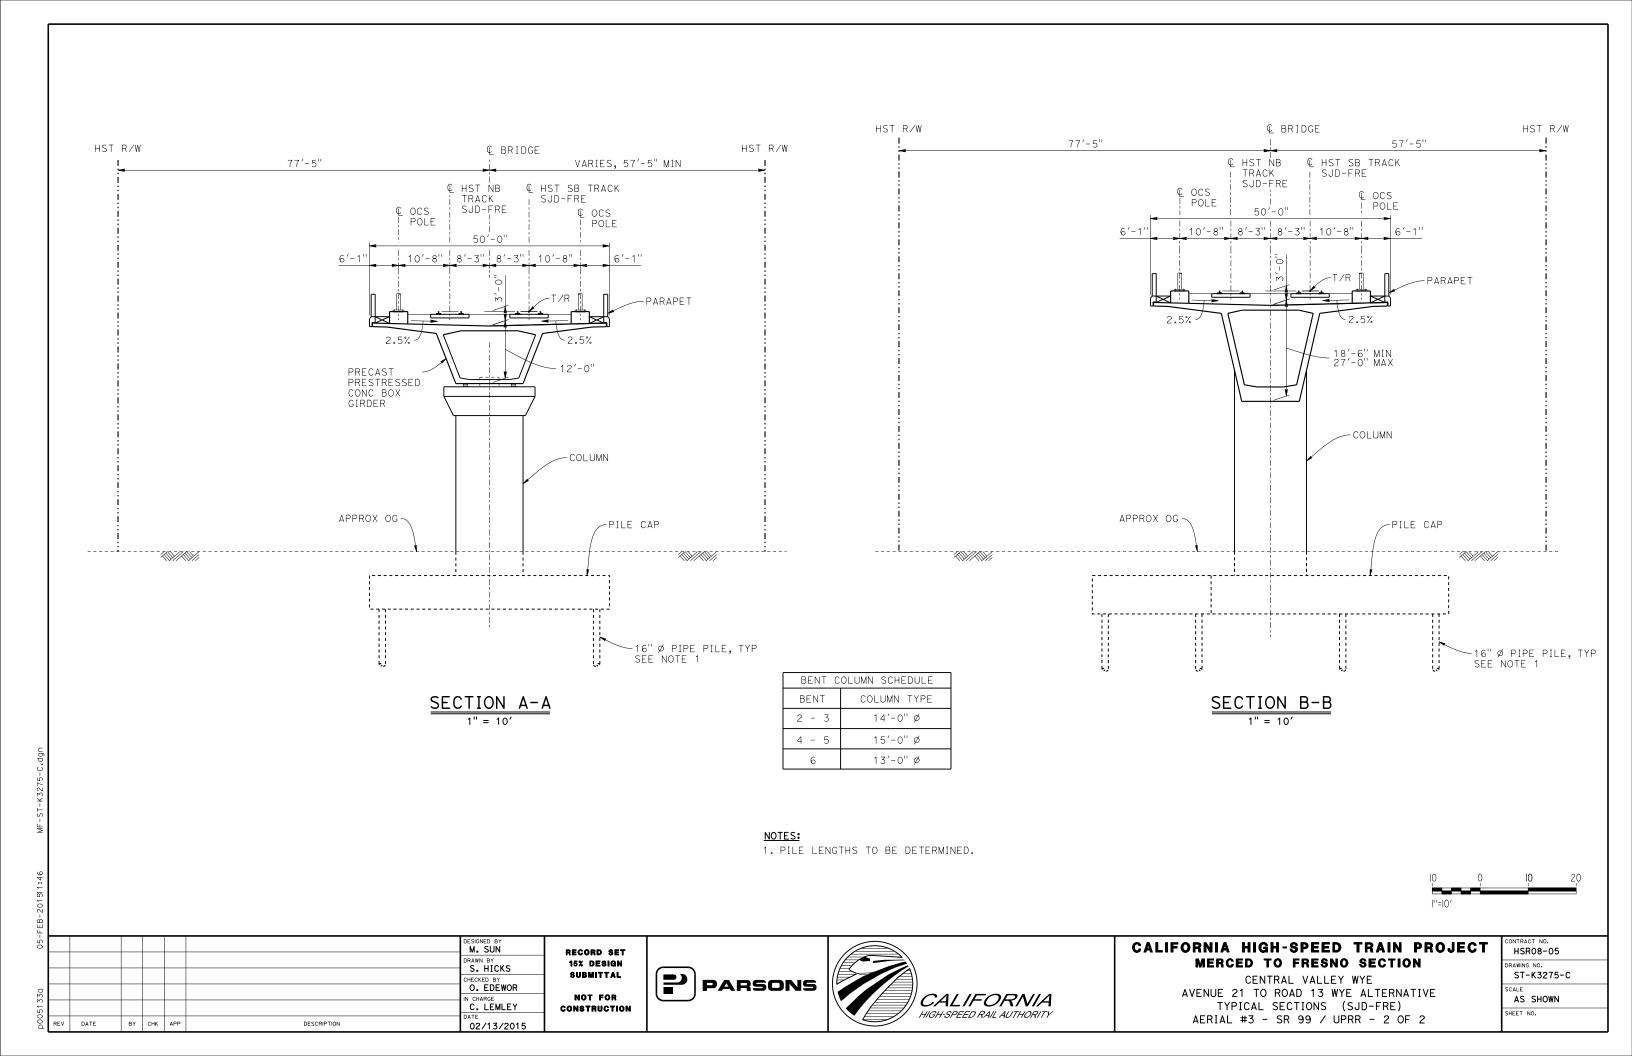


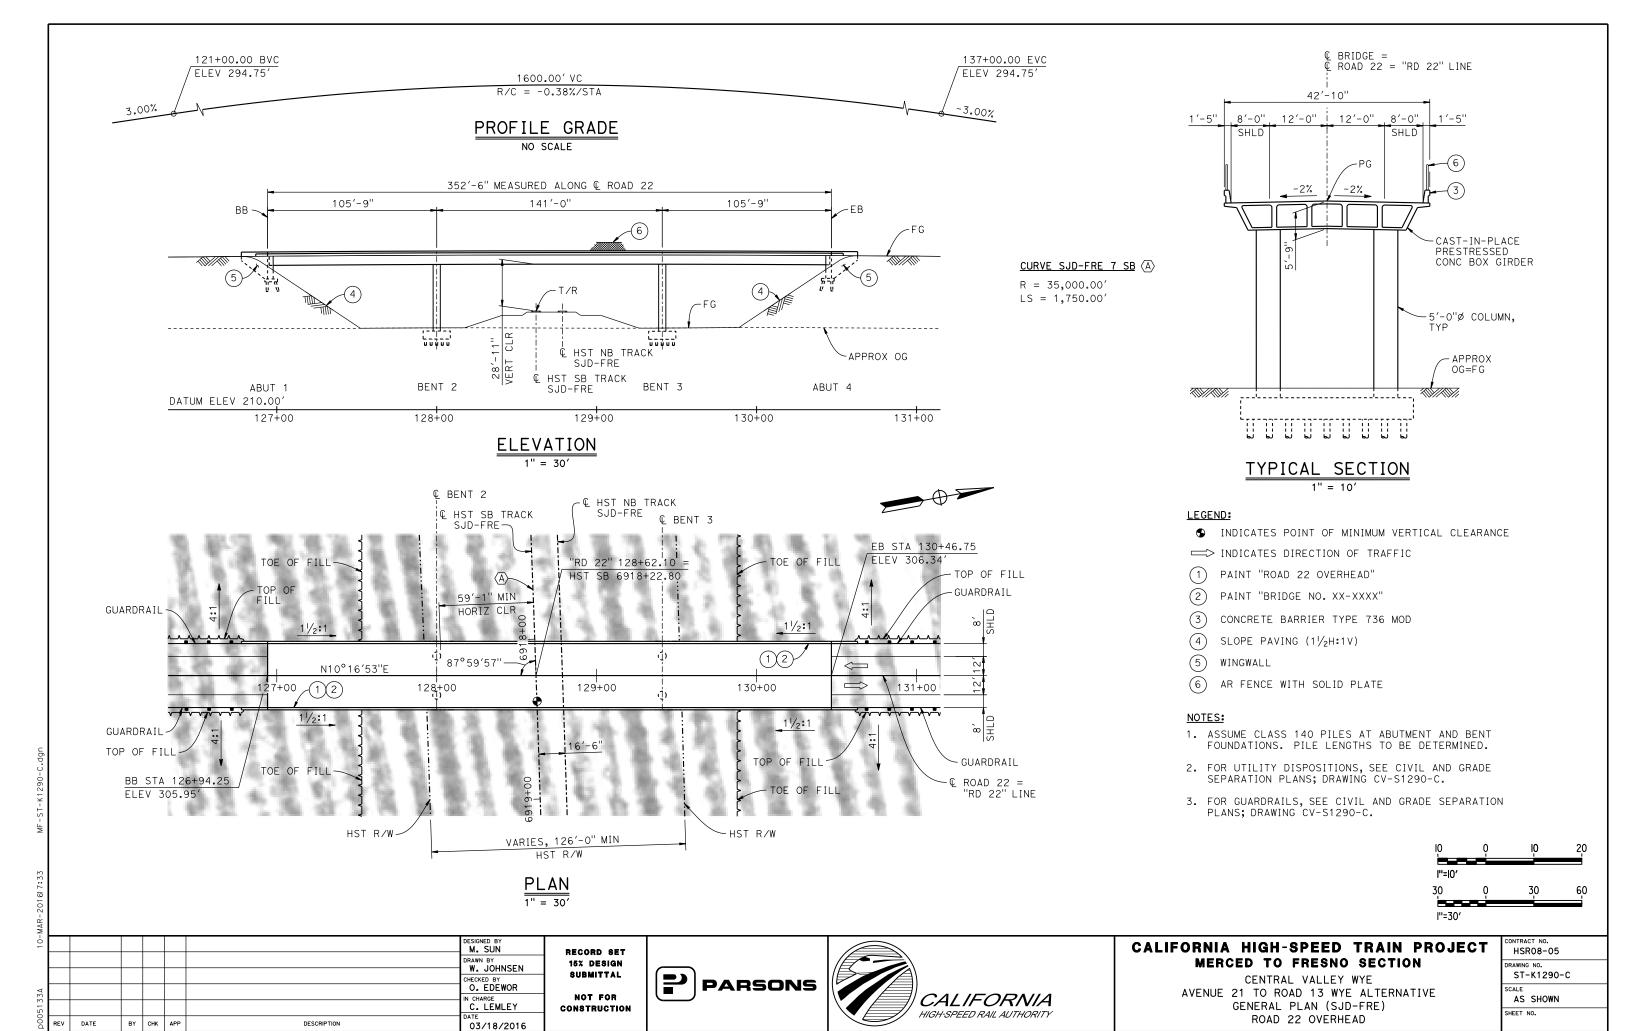

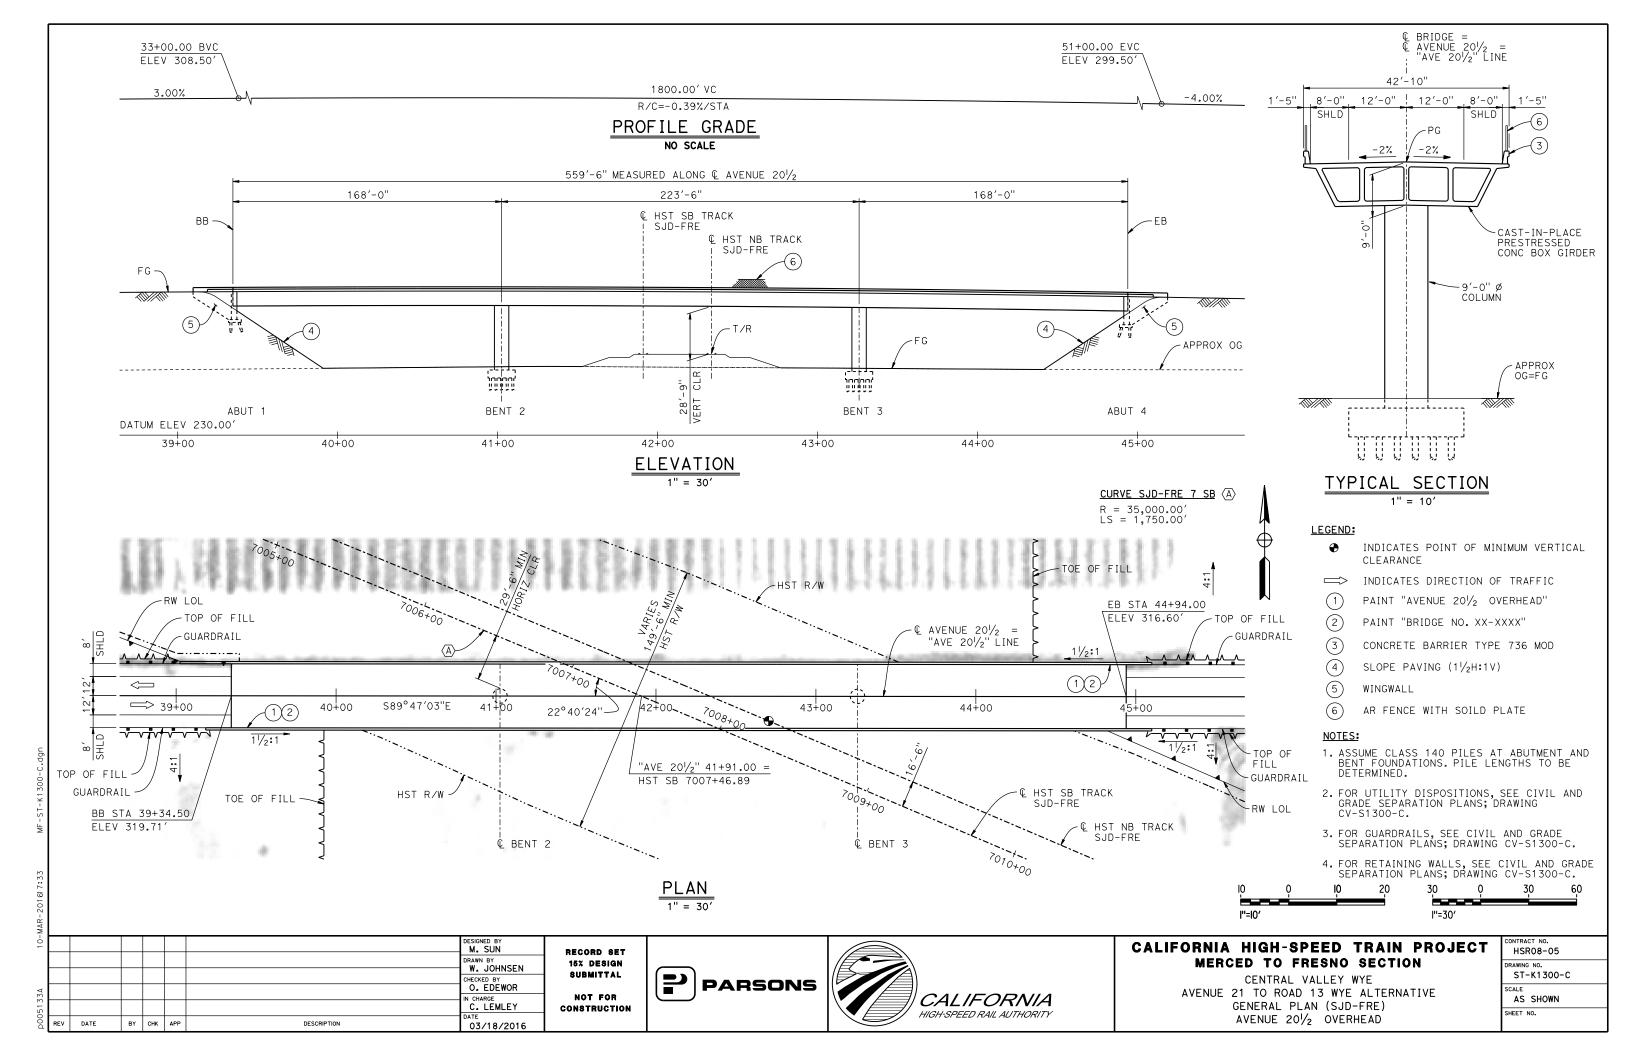

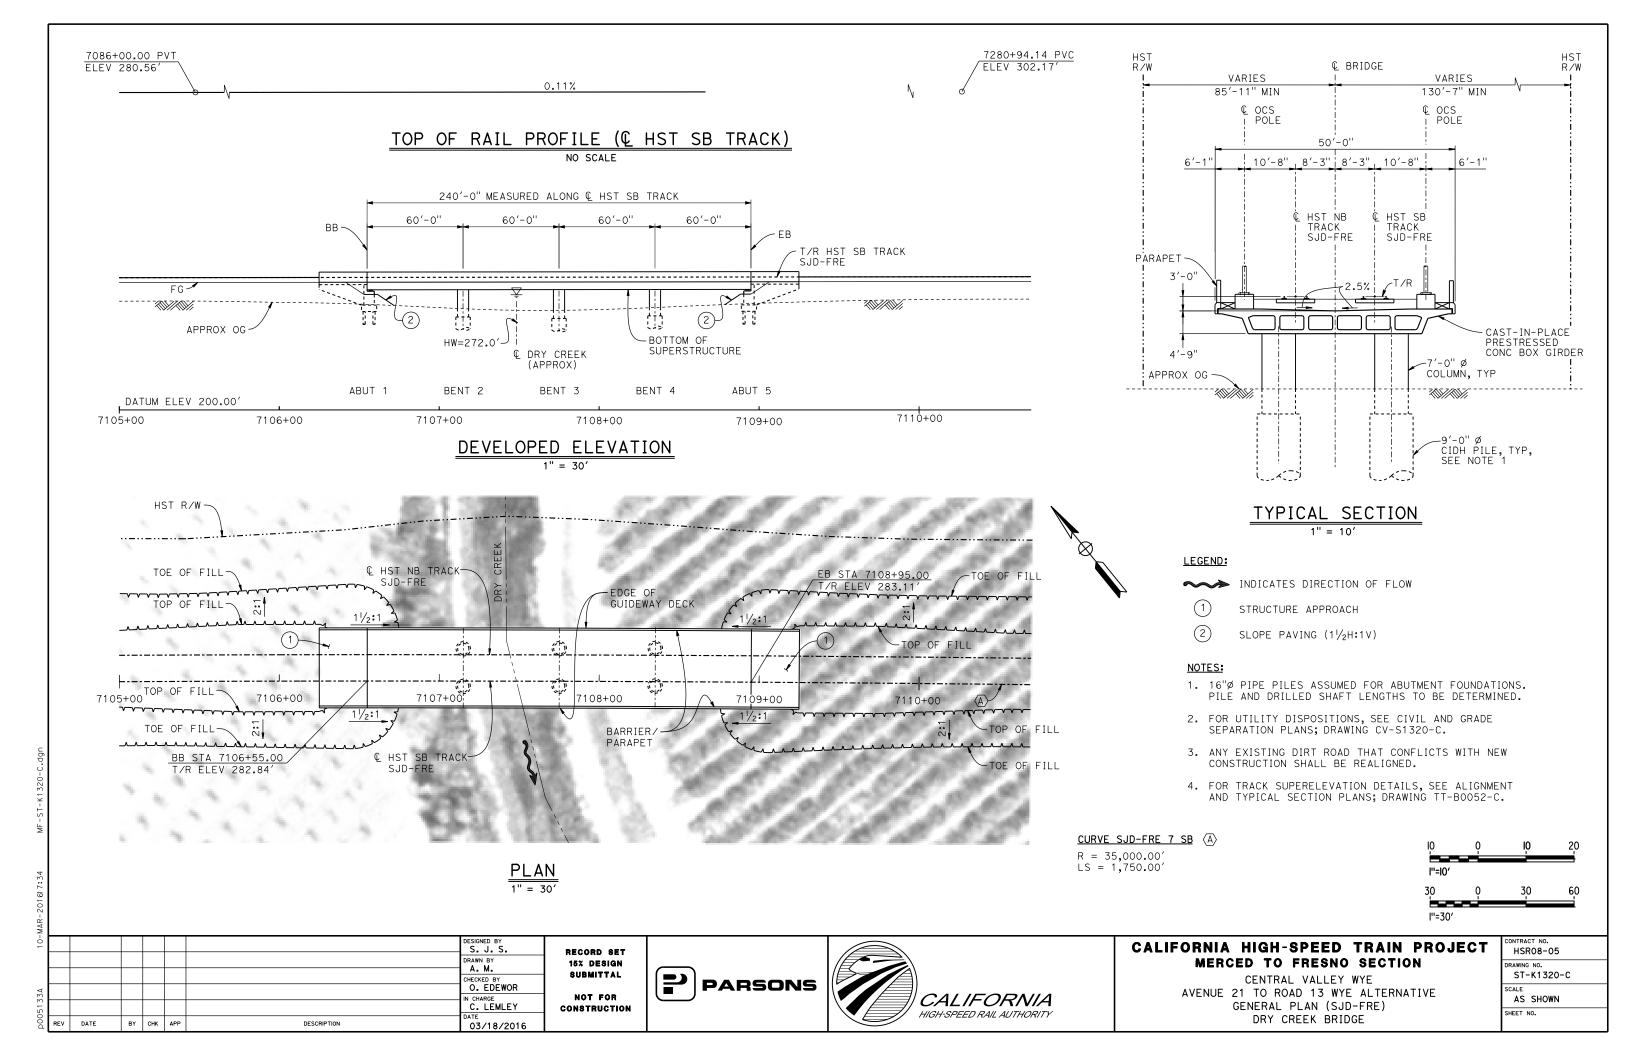


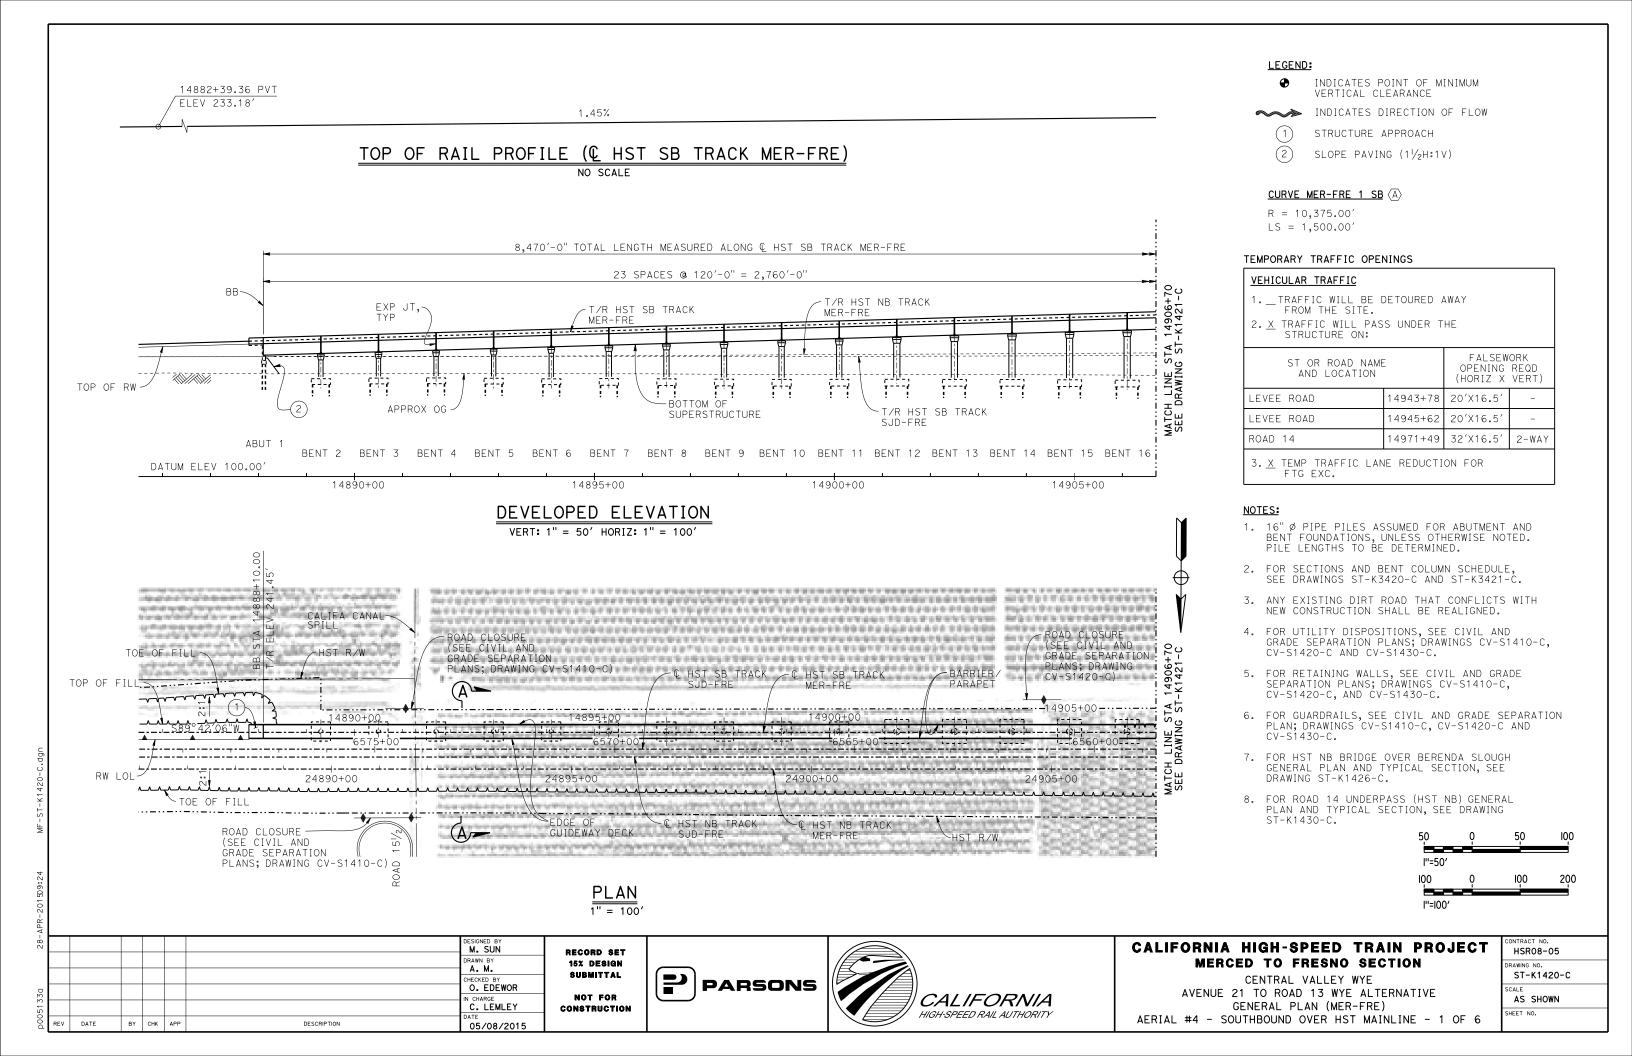

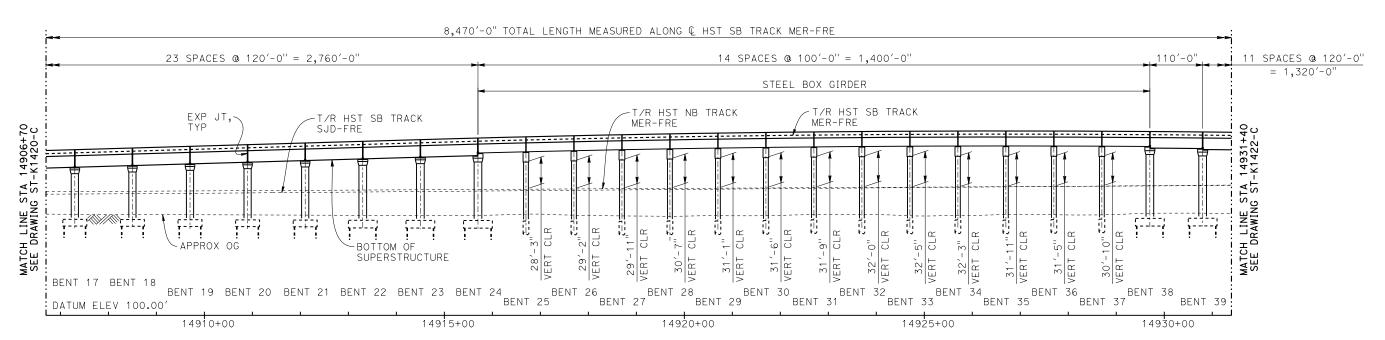

DEVELOPED ELEVATION

VERT: 1" = 50' HORIZ: 1" = 100'

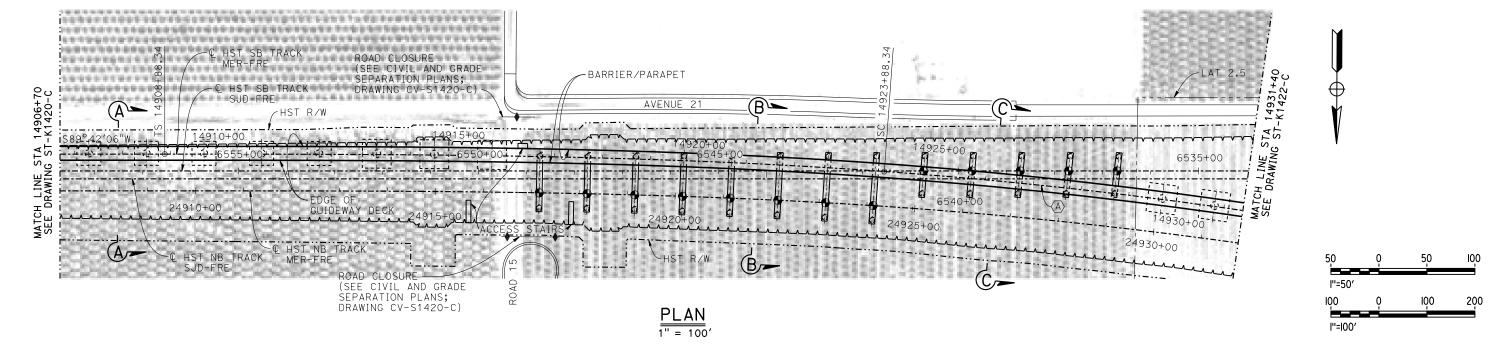

Ā								
8							DESIGNED BY M. SUN	
							DRAWN BY A. M.	
30							CHECKED BY O. EDEWOR	
3							IN CHARGE C. LEMLEY] ,
poopl	REV	DATE	BY	CHK	APP	DESCRIPTION	05/08/2015	

RECORD SET
15% DESIGN
SUBMITTAL
NOT FOR
CONSTRUCTION





CALIFORNIA HIGH-SPEED TRAIN PROJECT MERCED TO FRESNO SECTION

CENTRAL VALLEY WYE

AVENUE 21 TO ROAD 13 WYE ALTERNATIVE


GENERAL PLAN (MER-FRE)

AERIAL #4 - SOUTHBOUND OVER HST MAINLINE - 2 OF 6


CONTRACT NO. HSR08-05
DRAWING NO.
ST-K1421-C
SCALE
AS SHOWN
SHEET NO.


2250.00' VC R/C = -0.121%/STA

TOP OF RAIL PROFILE (HST SB TRACK MER-FRE) NO SCALE

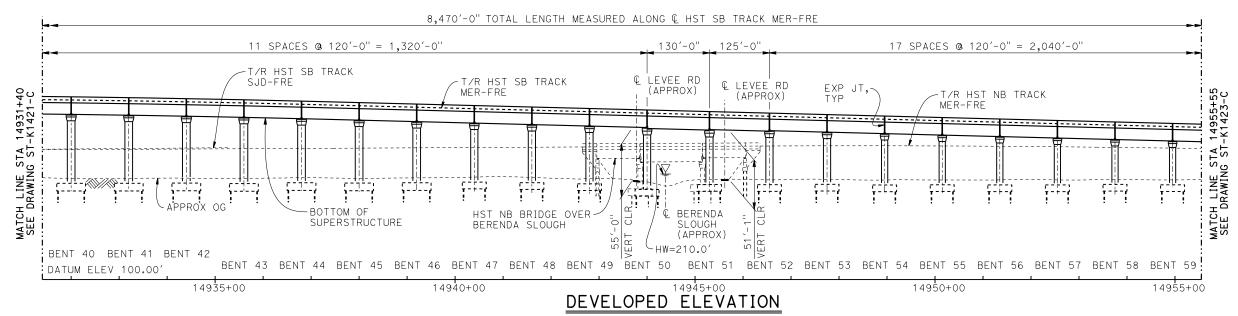

VERT: 1" = 50' HORIZ: 1" = 100' HST SB TRACK HST NB TRACK LAT 2.5

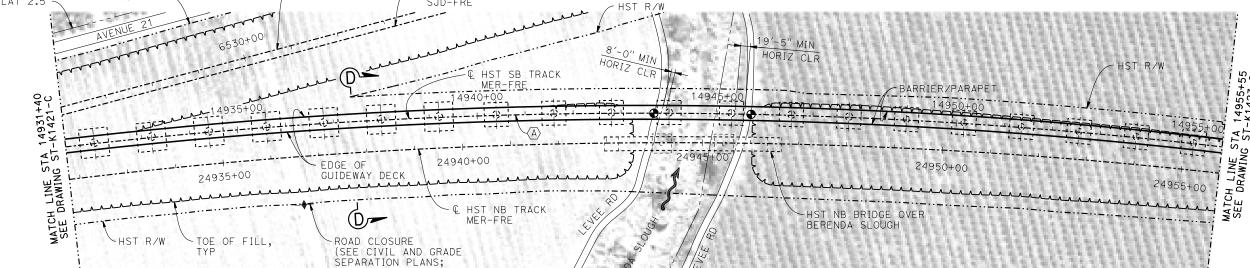

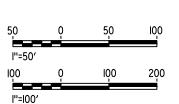

						DESIGNED BY M. SUN	
						DRAWN BY	•
						CHECKED BY O. EDEWOR	
						IN CHARGE C. LEMLEY	c
REV	DATE	BY	СНК	APP	DESCRIPTION	DATE 05/08/2015	

DRAWING CV-S1420-C)

RECORD SET 15% DESIGN CONSTRUCTION

SUBMITTAL

NOT FOR



PLAN

1" = 100'




CALIFORNIA HIGH-SPEED TRAIN PROJECT MERCED TO FRESNO SECTION


CENTRAL VALLEY WYE AVENUE 21 TO ROAD 13 WYE ALTERNATIVE GENERAL PLAN (MER-FRE) AERIAL #4 - SOUTHBOUND OVER HST MAINLINE - 3 OF 6

CONTRACT NO. HSR08-05							
DRAWING NO. ST-K1422-C							
AS SHOWN							
SHEET NO.							

TOP OF RAIL PROFILE (@ HST SB TRACK MER-FRE) NO SCALE

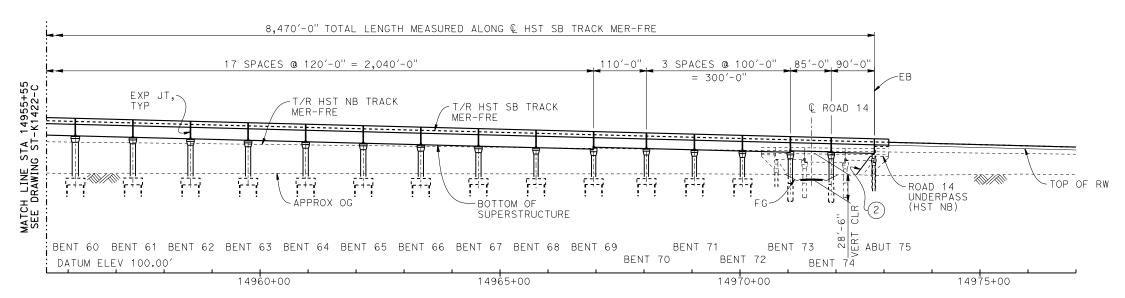

DEVELOPED ELEVATION

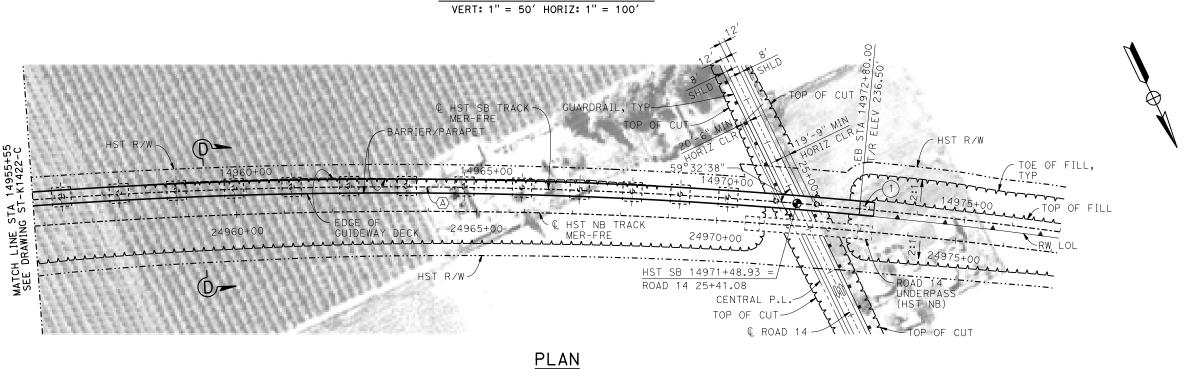

_	 -

50	Q	50	100
l''=50'			
100	Q	IOO	200
l''=l00′			

L								
ſ							DESIGNED BY M. SUN	
l							DRAWN BY A. M.	1
ļ							CHECKED BY O. EDEWOR	1
l							IN CHARGE	ł
l							C. LEMLEY DATE	'
٠Į	REV	DATE	BY	CHK	APP	DESCRIPTION	05/08/2015	

RECORD SET 15% DESIGN SUBMITTAL NOT FOR CONSTRUCTION




1" = 100'





CALIFORNIA HIGH-SPEED TRAIN PROJECT MERCED TO FRESNO SECTION


CENTRAL VALLEY WYE AVENUE 21 TO ROAD 13 WYE ALTERNATIVE GENERAL PLAN (MER-FRE) AERIAL #4 - SOUTHBOUND OVER HST MAINLINE - 4 OF 6


CONTRACT NO. HSR08-05
DRAWING NO. ST-K1423-C
SCALE AS SHOWN
SHEET NO.

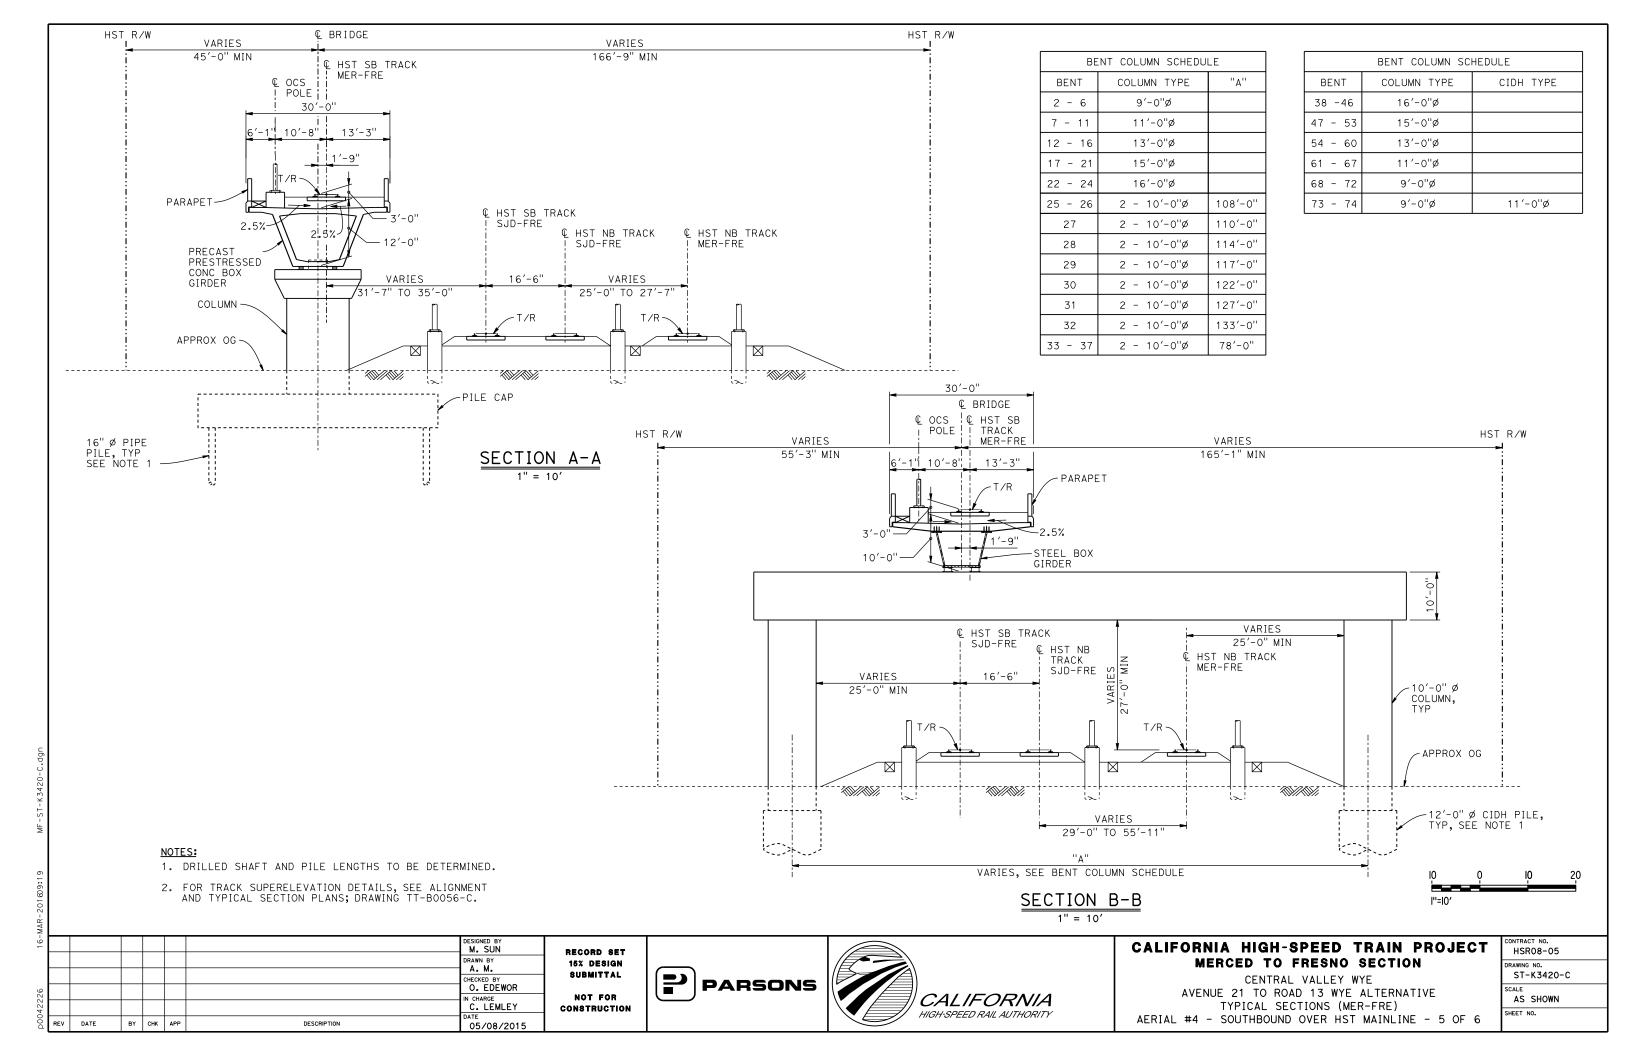


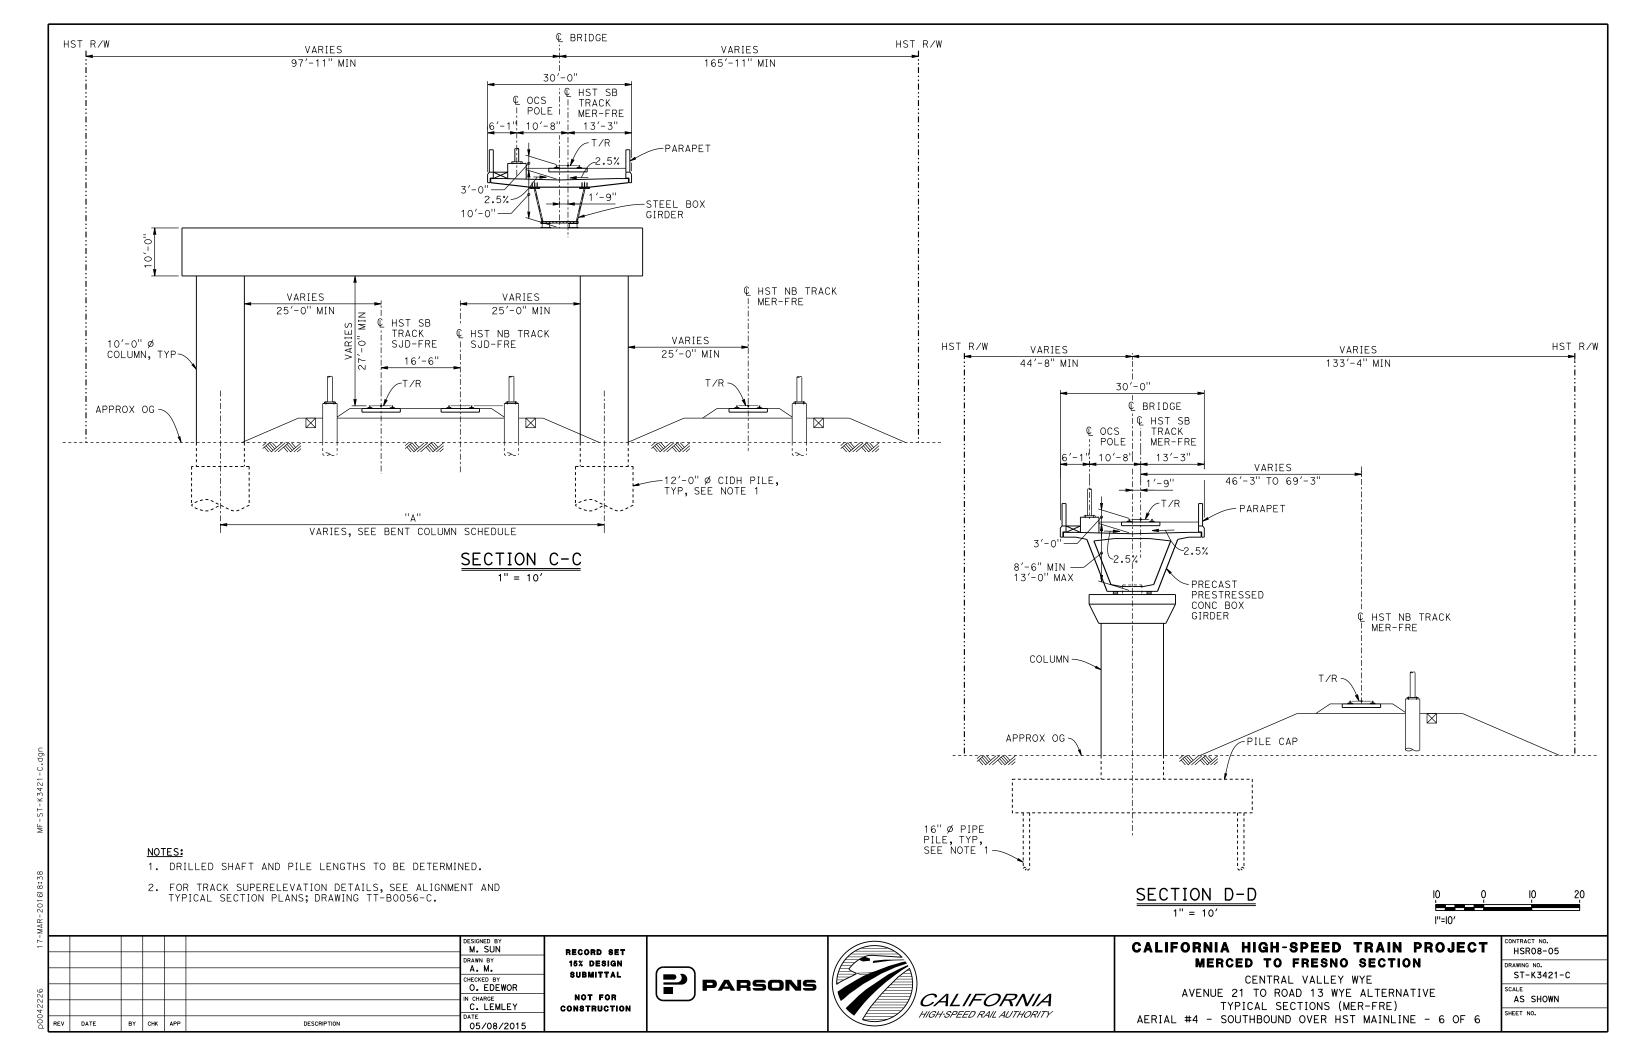


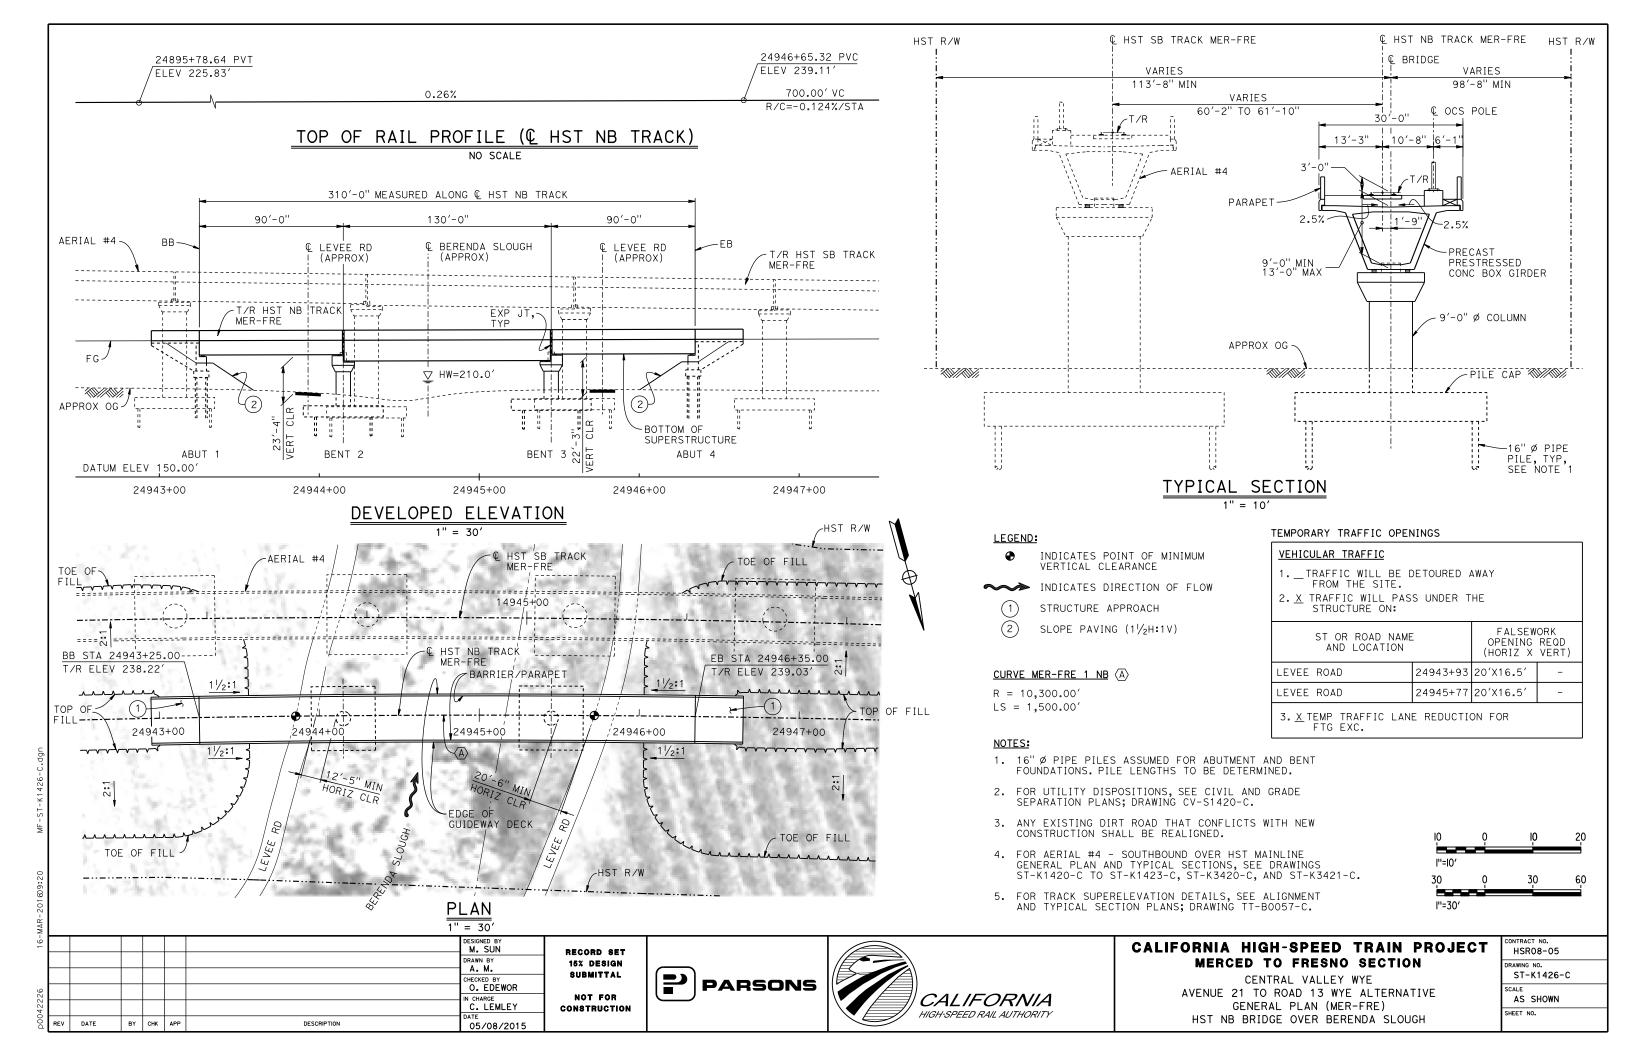


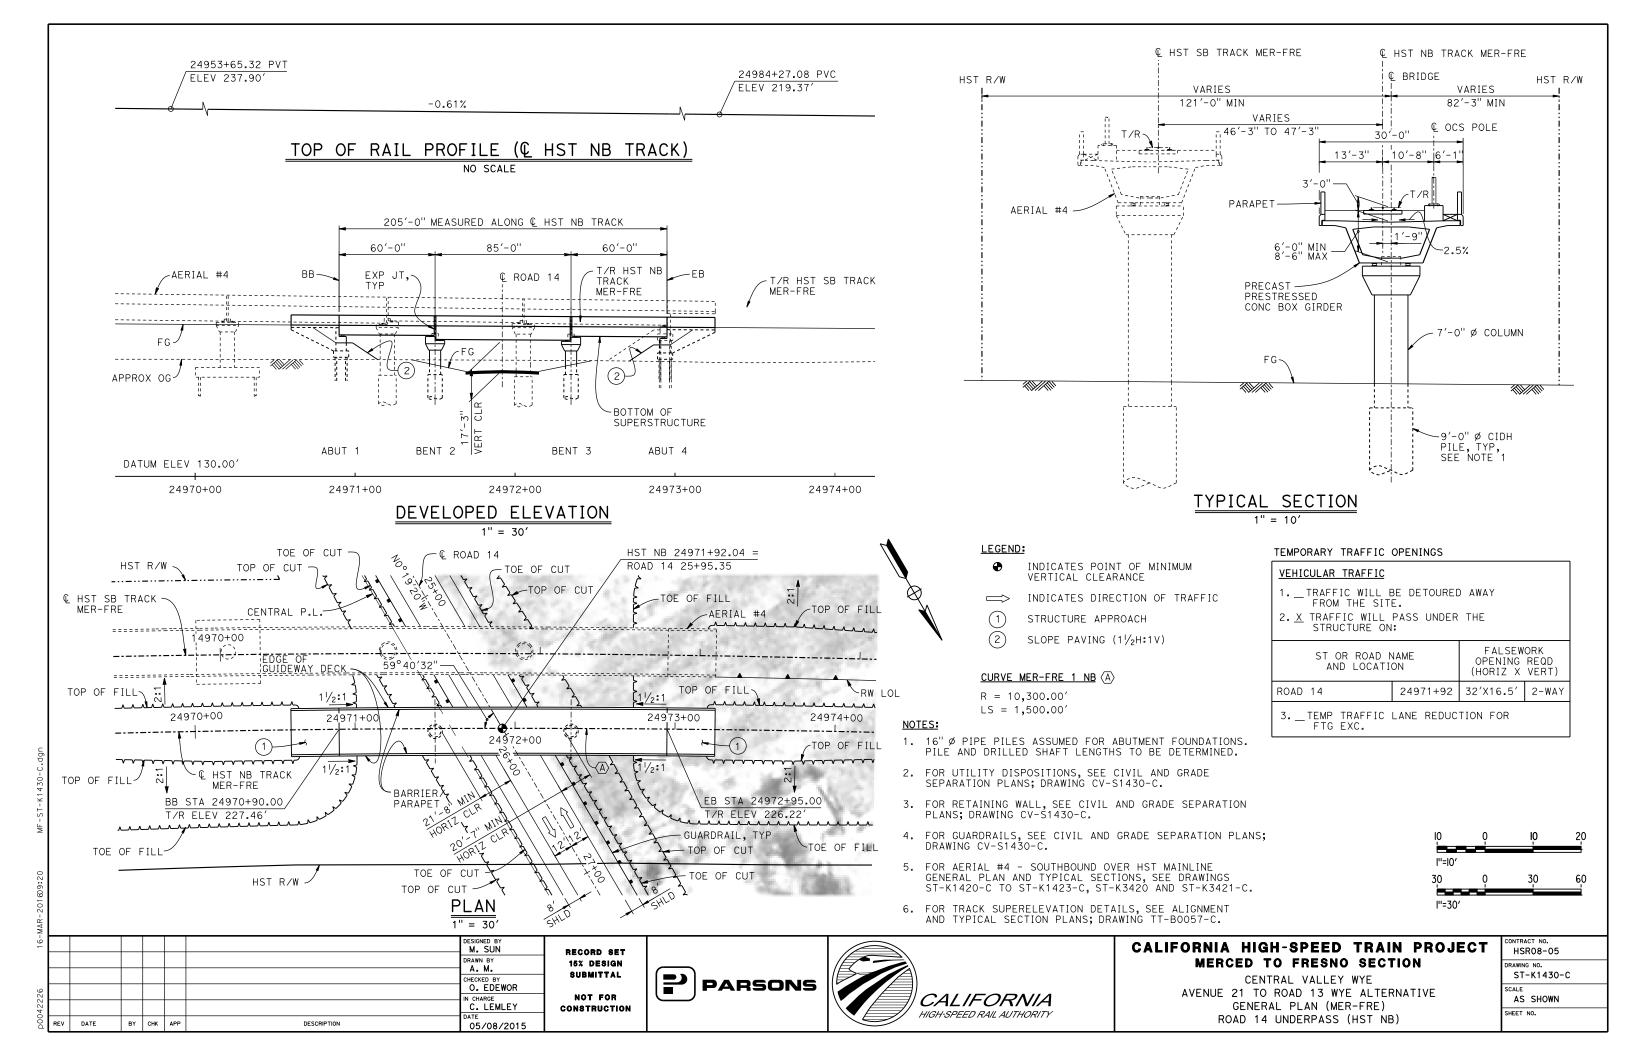


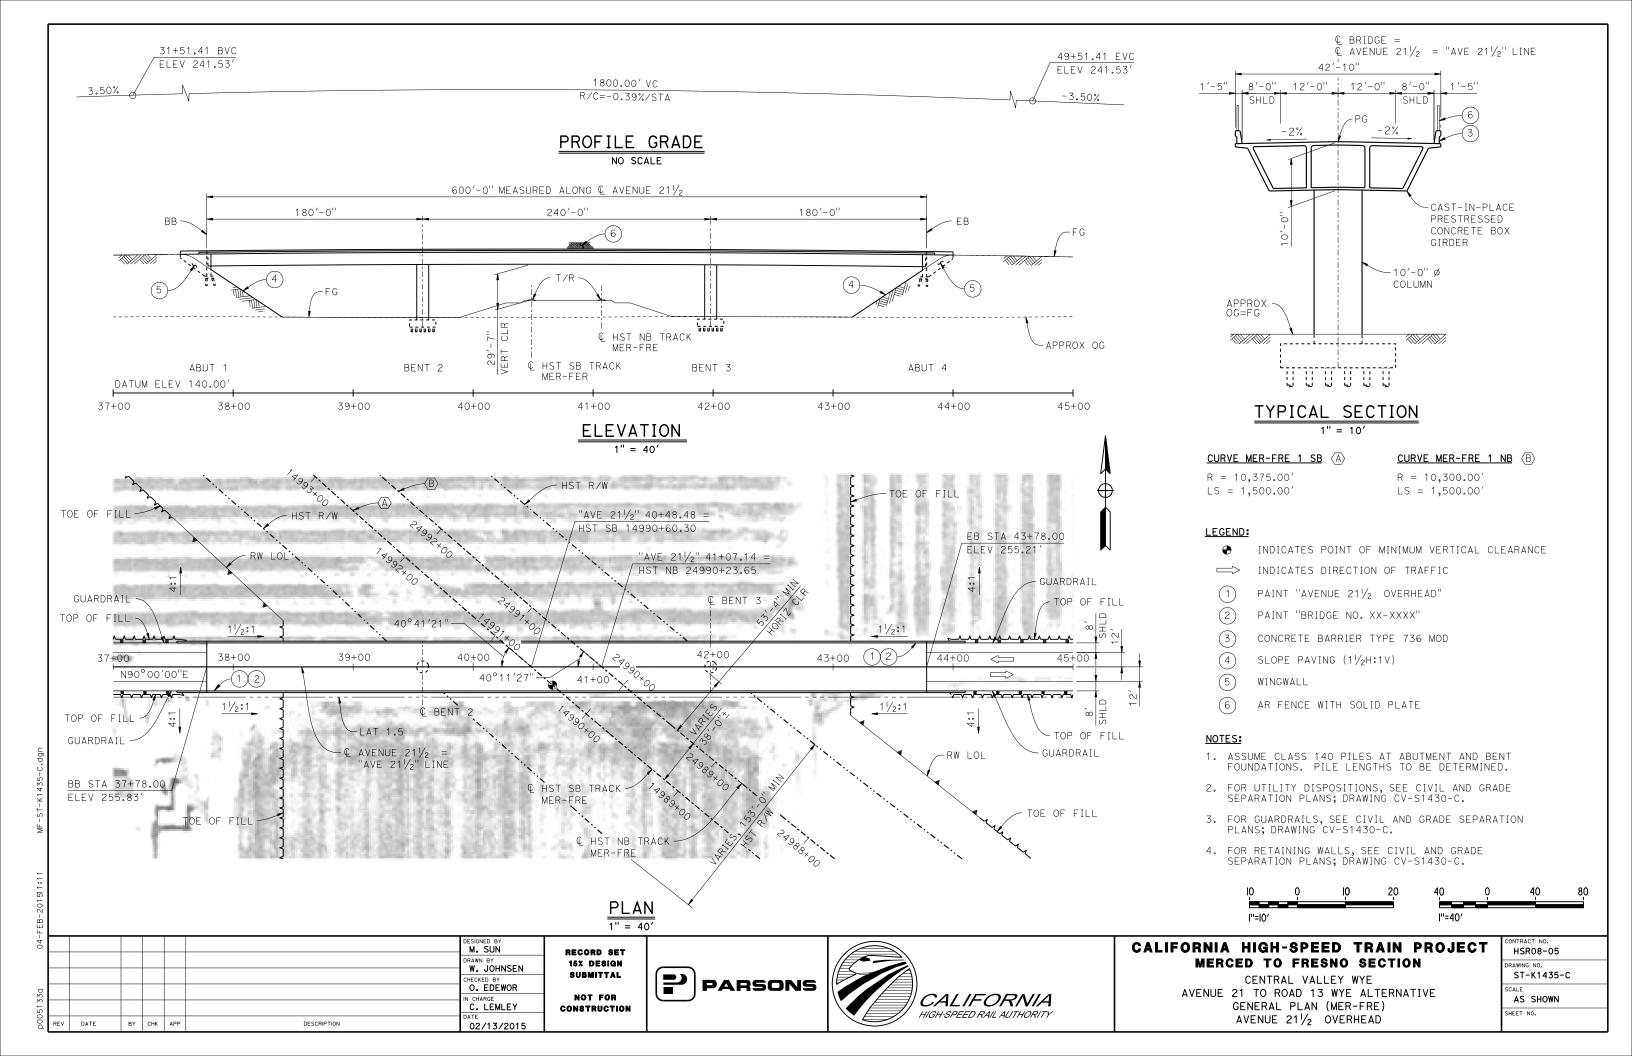

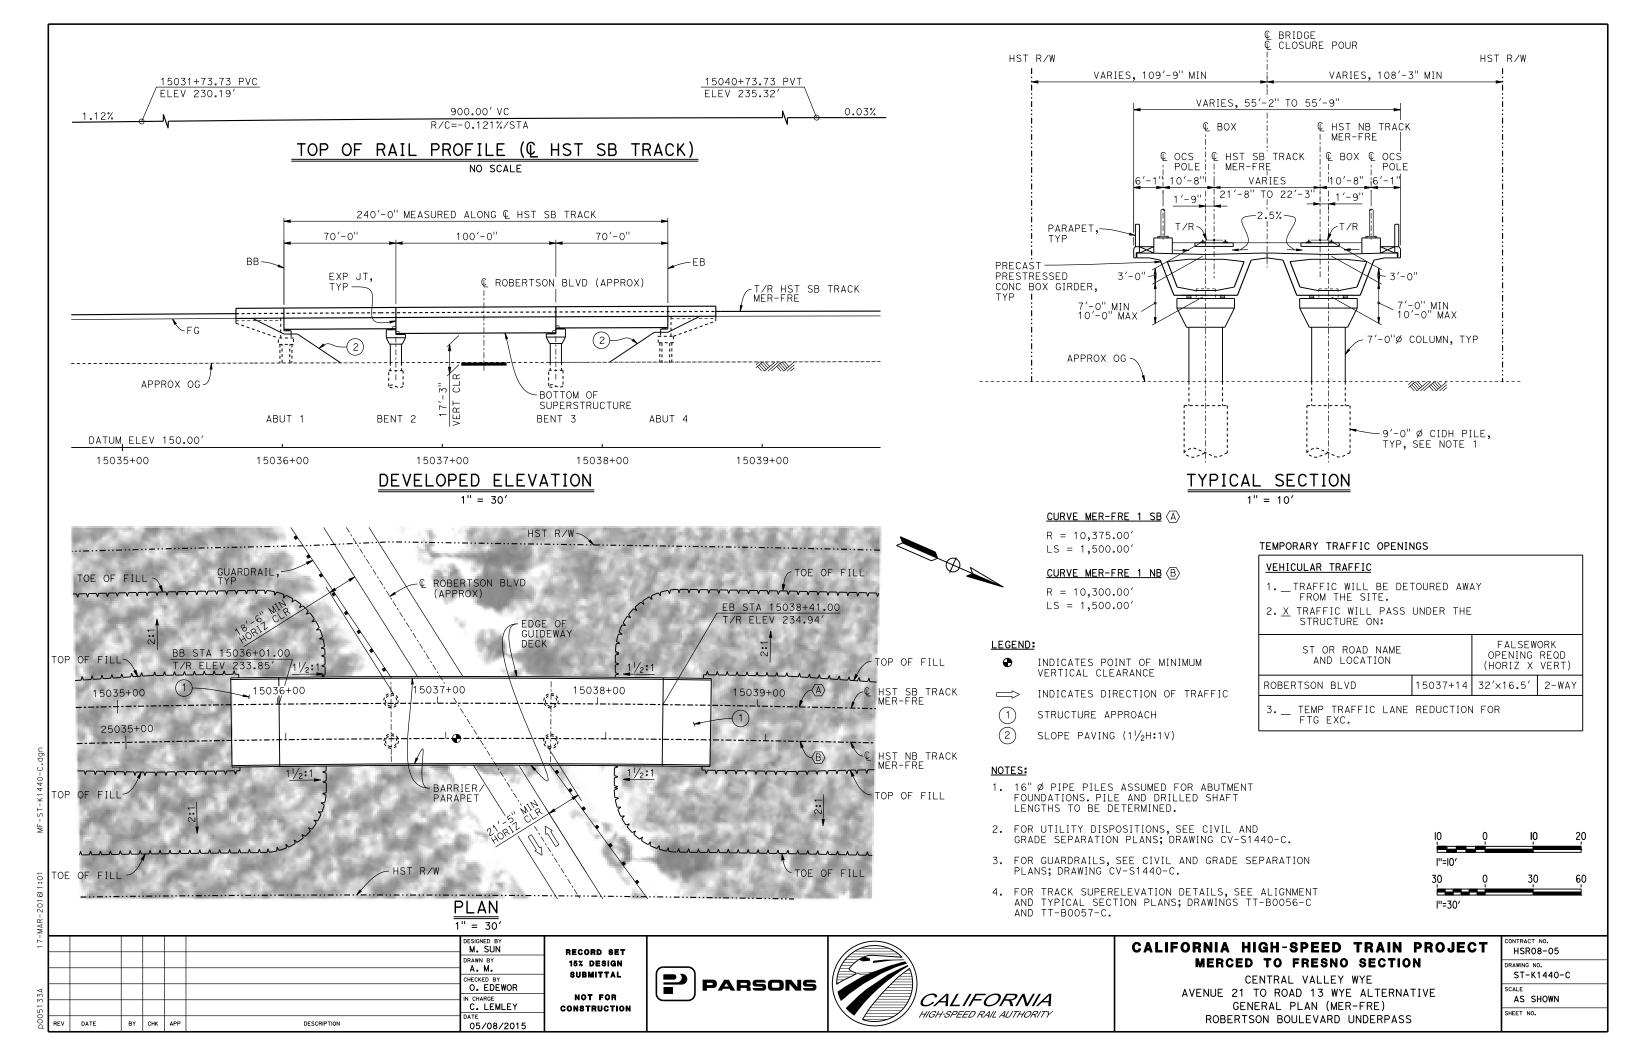

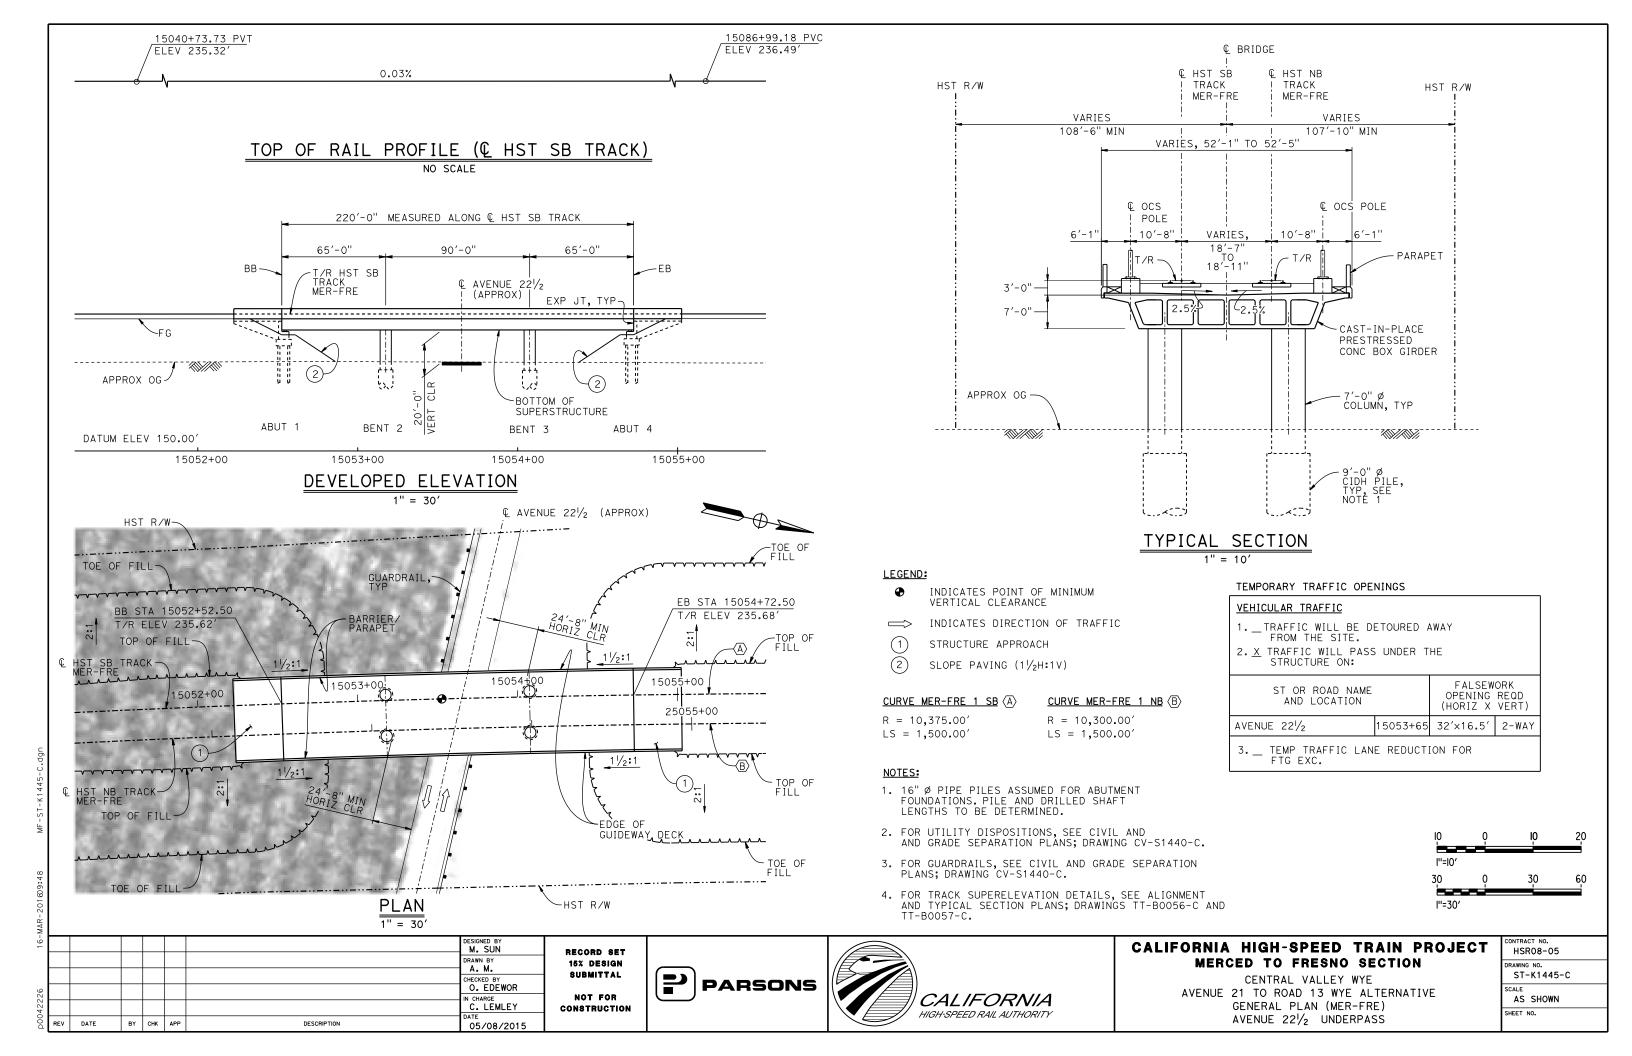

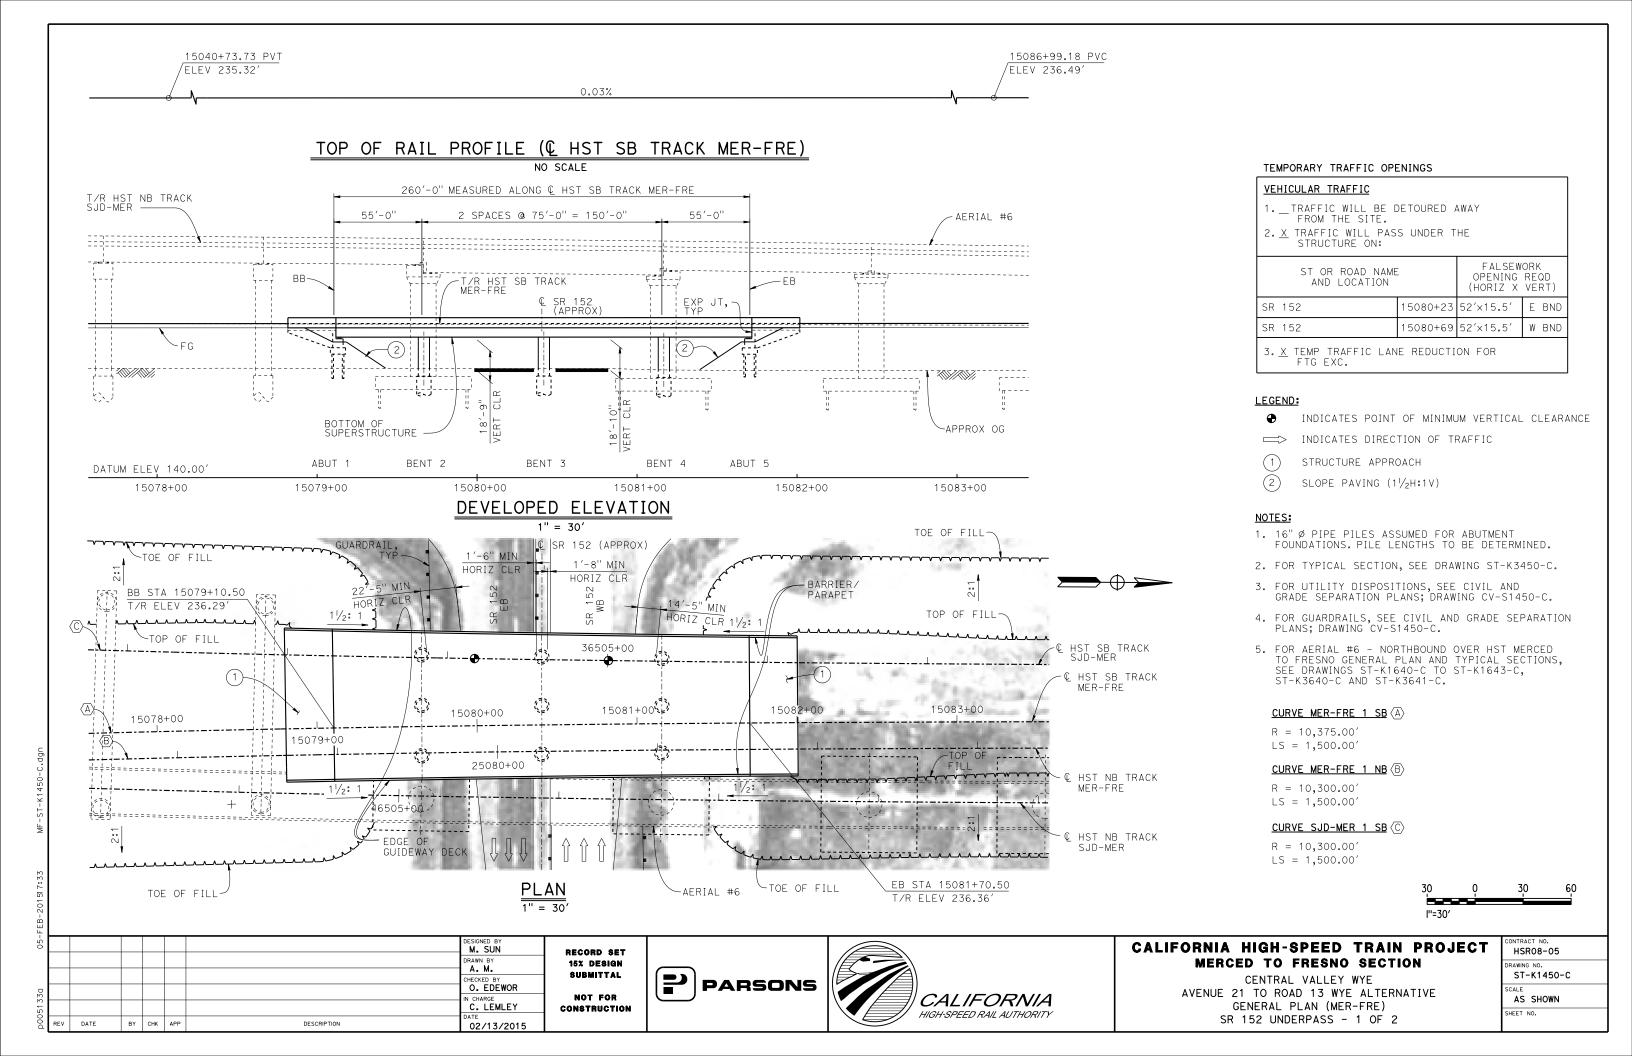

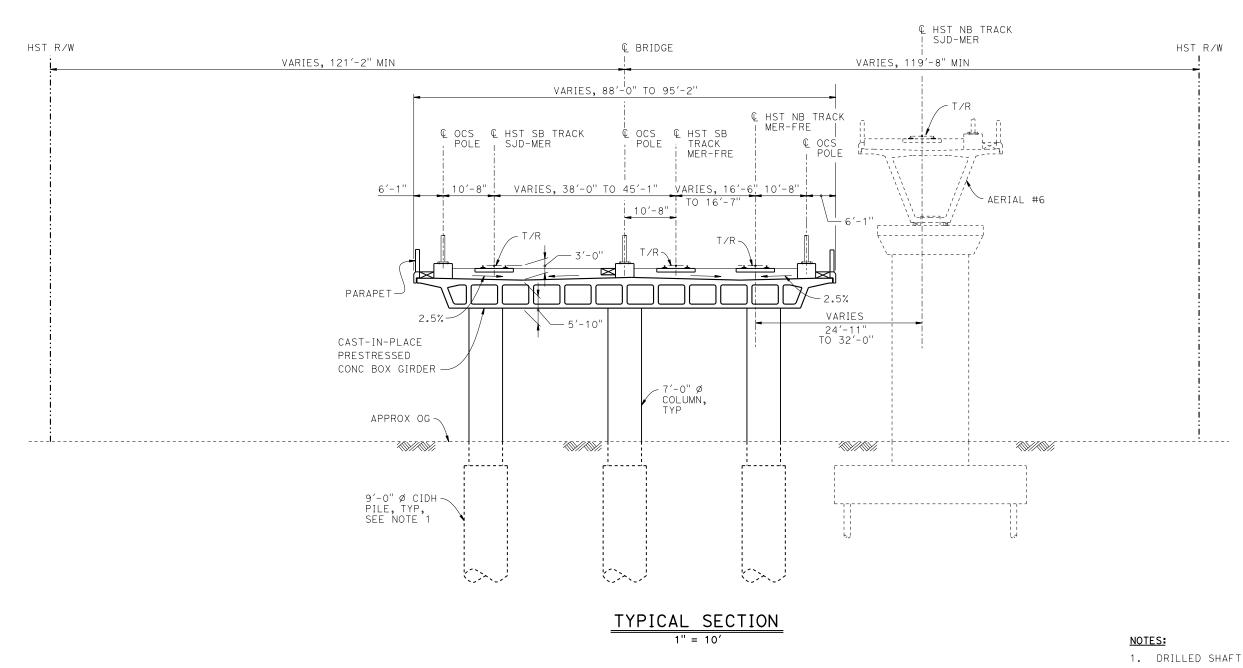

- 1. DRILLED SHAFT LENGTHS TO BE DETERMINED.
- 2. FOR TRACK SUPERELEVATION DETAILS, SEE ALIGNMENT AND TYPICAL SECTION PLANS; DRAWINGS TT-B0056-C AND TT-B0057-C.



⋖								
28-							DESIGNED BY M. SUN	
							DRAWN BY	l '
							CHECKED BY	İ
330							O. EDEWOR	l
21							C. LEMLEY	c
00d	REV	DATE	BY	CHK	APP	DESCRIPTION	05/08/2015	

RECORD SET 15% DESIGN SUBMITTAL NOT FOR CONSTRUCTION








CALIFORNIA HIGH-SPEED TRAIN PROJECT MERCED TO FRESNO SECTION

CENTRAL VALLEY WYE
AVENUE 21 TO ROAD 13 WYE ALTERNATIVE
TYPICAL SECTION (MER-FRE)
SR 152 UNDERPASS - 2 OF 2

CONTRACT NO.
HSR08-05
DRAWING NO.
ST-K3450-C
SCALE
AS SHOWN
SHEET NO.

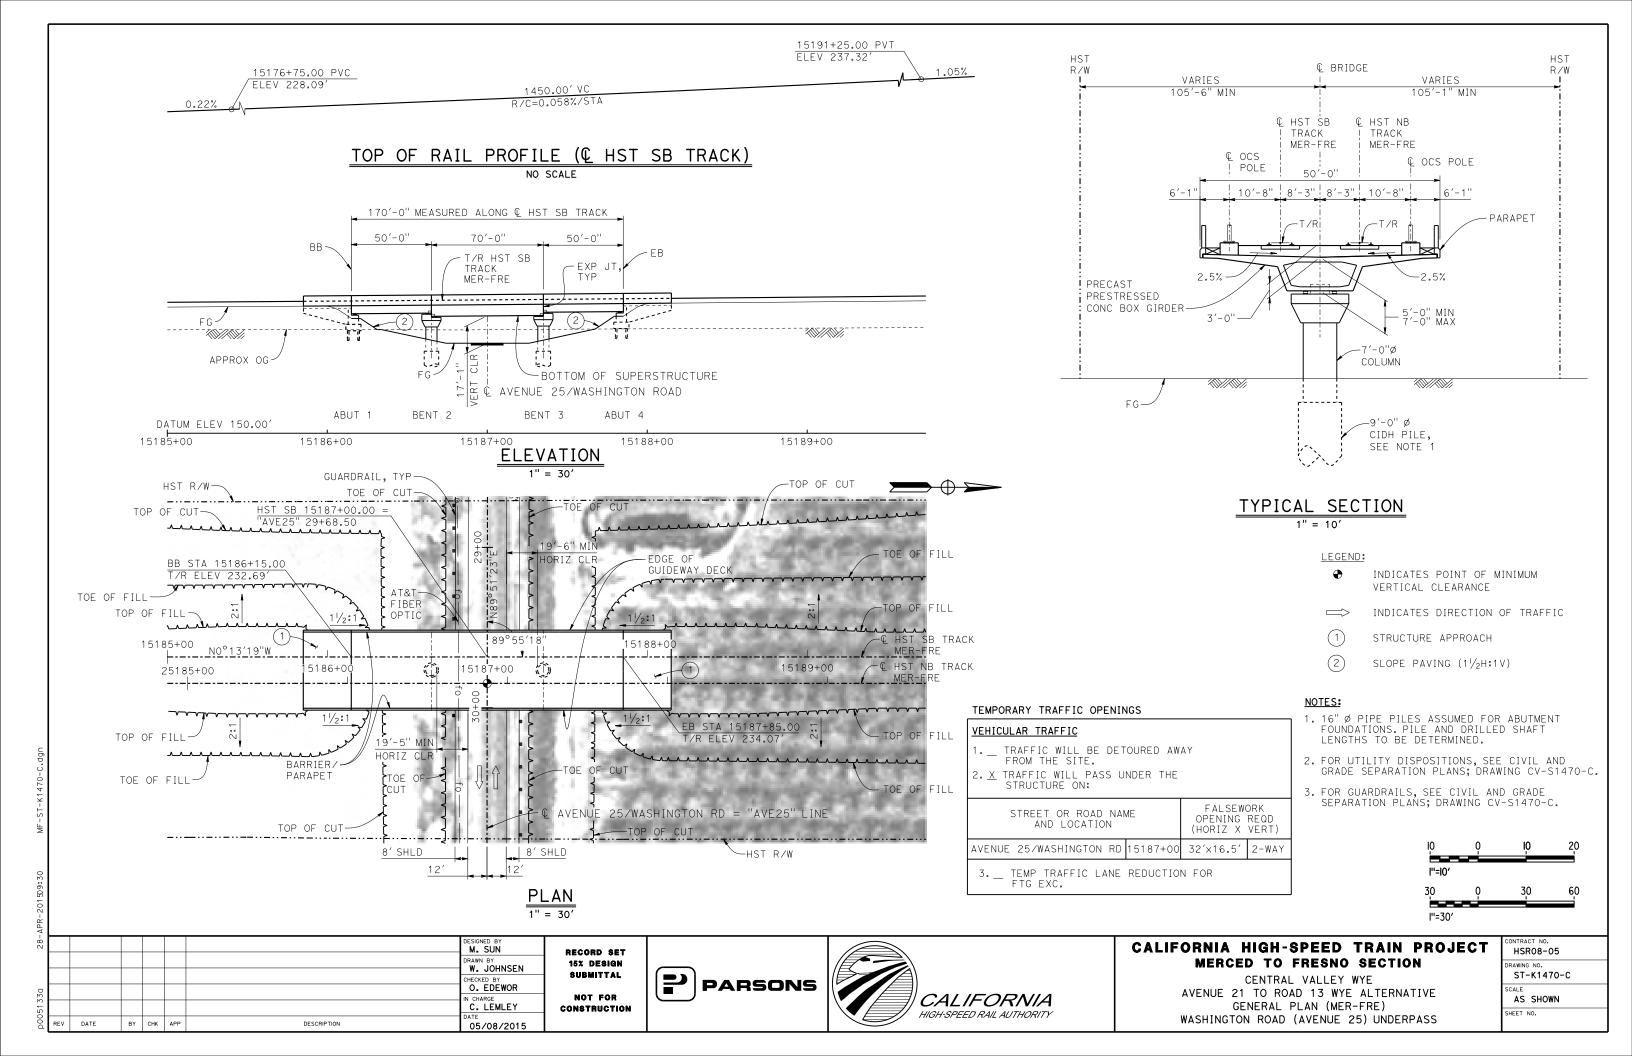

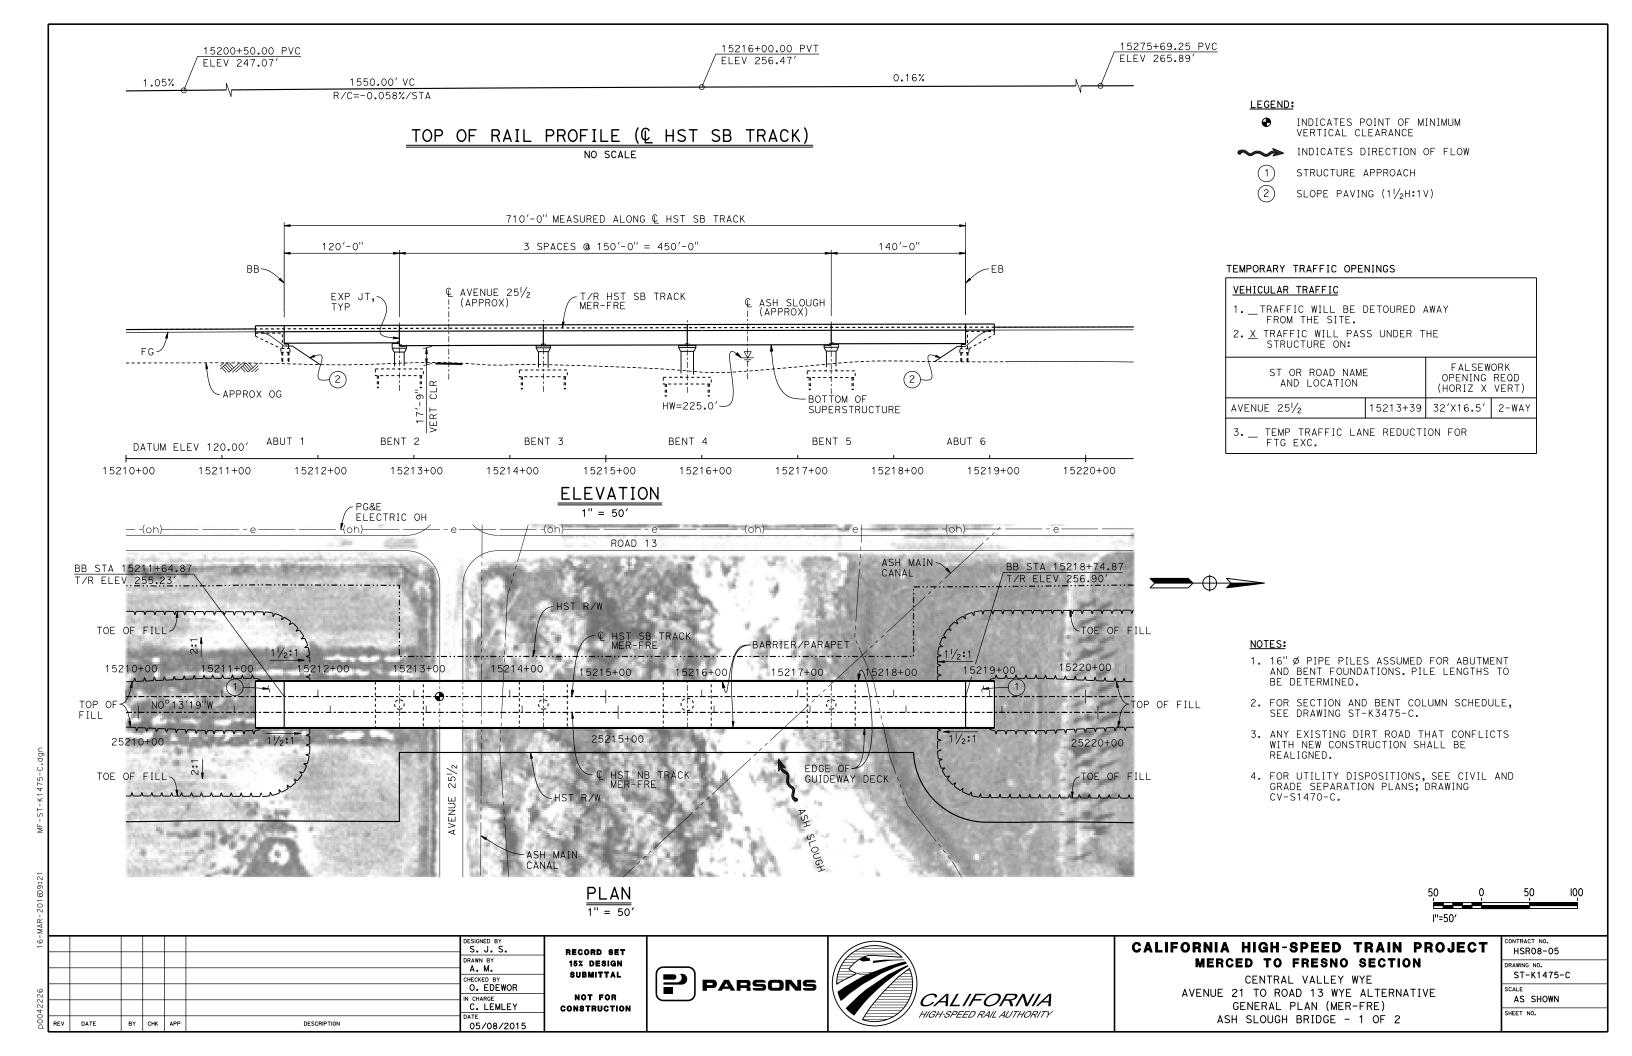

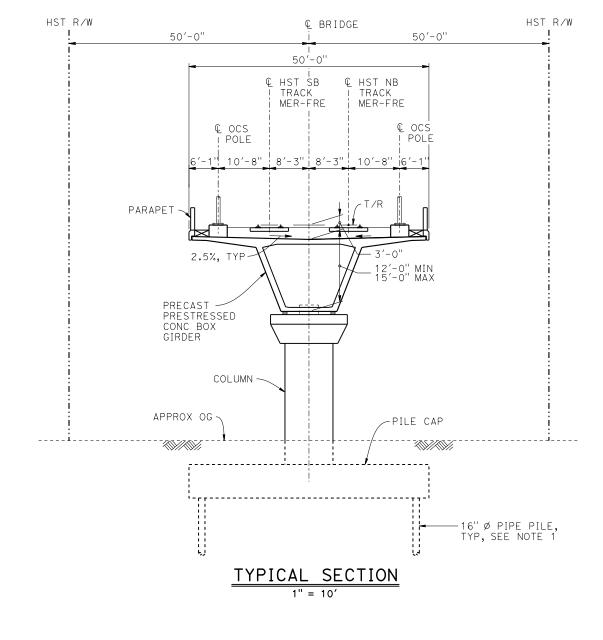

BENT C	OLUMN SCHEDULE
BENT	COLUMN TYPE
2 - 3	10'-0"Ø
4	13'-0"Ø
5	10'-0"Ø

NOTES:

1. PILE LENGTHS TO BE DETERMINED.



Щ								
-50							DESIGNED BY S. J. S.	
							DRAWN BY A. M.	
П							CHECKED BY O. EDEWOR	
51330							IN CHARGE C. LEMLEY	١,
00d	REV	DATE	BY	СНК	APP	DESCRIPTION	DATE 02/13/2015	

RECORD SET
15% DESIGN
SUBMITTAL
NOT FOR
CONSTRUCTION






CALIFORNIA HIGH-SPEED TRAIN PROJECT MERCED TO FRESNO SECTION

CENTRAL VALLEY WYE
AVENUE 21 TO ROAD 13 WYE ALTERNATIVE
TYPICAL SECTION (MER-FRE)
ASH SLOUGH BRIDGE - 2 OF 2

CONTRACT NO. HSR08-05						
DRAWING NO. ST-K3475-C						
AS SHOWN						
SHEET NO.						

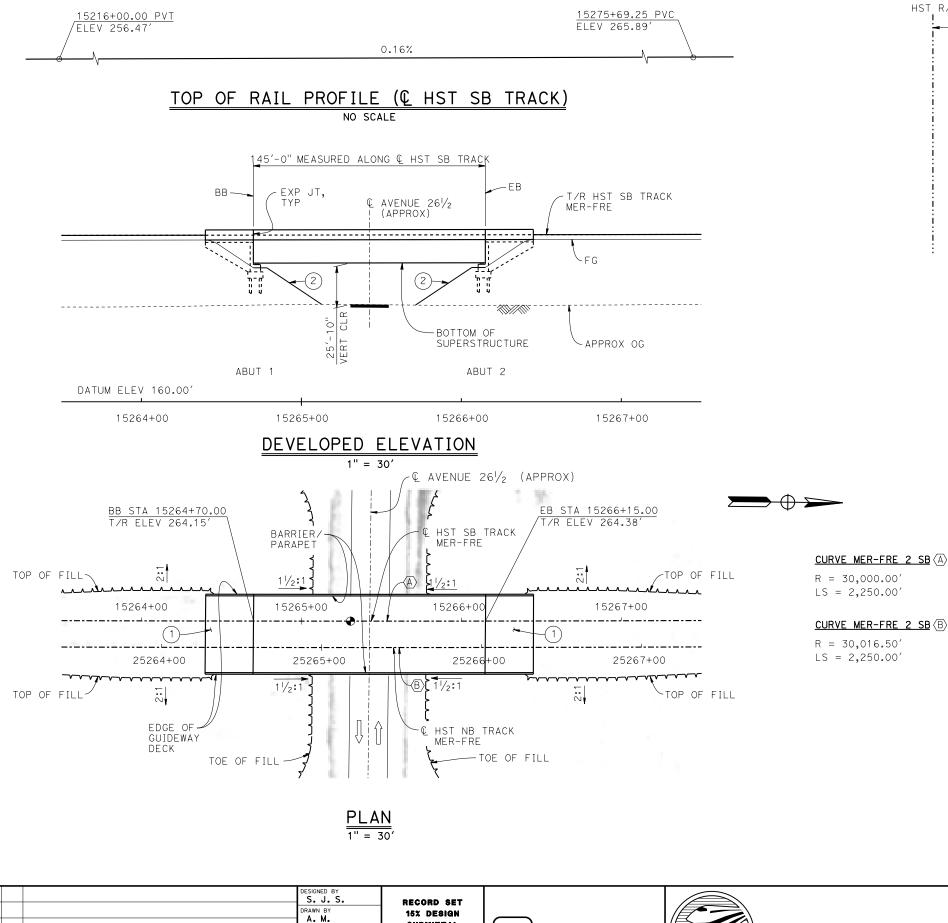

SUBMITTAL

NOT FOR

CONSTRUCTION

O. EDEWOR


n charge C. LEMLEY

05/08/2015

DATE

BY CHK APP

DESCRIPTION

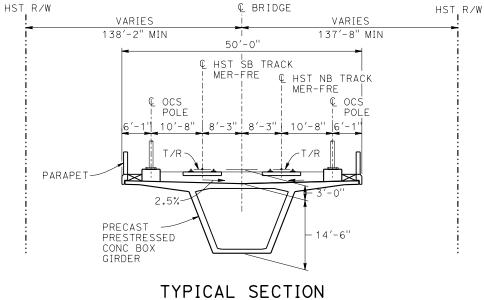

LEGEND:


- INDICATES POINT OF MINIMUM VERTICAL CLEARANCE
- (1) STRUCTURE APPROACH
- (2) SLOPE PAVING $(1\frac{1}{2}H:1V)$

TEMPORARY TRAFFIC OPENINGS

VEHICULAR TRAFFIC 1. _ TRAFFIC WILL BE DETOURED AWAY FROM THE SITE. 2. X TRAFFIC WILL PASS UNDER THE STRUCTURE ON: ST OR ROAD NAME OPENING REQUIRED (HORIZ X VERT) AVENUE 261/2 15265+43 32'X16.5' 2-WAY 3. _ TEMP TRAFFIC LANE REDUCTION FOR FTG EXC.

NOTES:

- 1. 16" Ø PIPE PILES ASSUMED FOR ABUTMENT FOUNDATIONS. PILE LENGTHS TO BE DETERMINED.
- 2. ANY EXISTING DIRT ROAD THAT CONFLICTS WITH NEW CONSTRUCTION SHALL BE REALIGNED.
- 3. FOR UTILITY DISPOSITIONS, SEE CIVIL AND GRADE SEPARATION PLANS; DRAWING CV-S1480-C.
- 4. FOR TRACK SUPERELEVATION DETAILS, SEE ALIGNMENT AND TYPICAL SECTION PLANS; DRAWINGS TT-B0056-C AND TT-B0057-C.

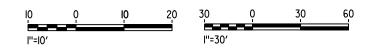

PARSONS

CALIFORNIA


HIGH-SPEED RAIL AUTHORITY


CALIFORNIA HIGH-SPEED TRAIN PROJECT MERCED TO FRESNO SECTION CENTRAL VALLEY WYF

CENTRAL VALLEY WYE

AVENUE 21 TO ROAD 13 WYE ALTERNATIVE
GENERAL PLAN (MER-FRE)
AVENUE 26½ UNDERPASS

CONTRACT NO. HSR08-05					
DRAWING NO. ST-K1480-C					
AS SHOWN					
SHEET NO.					

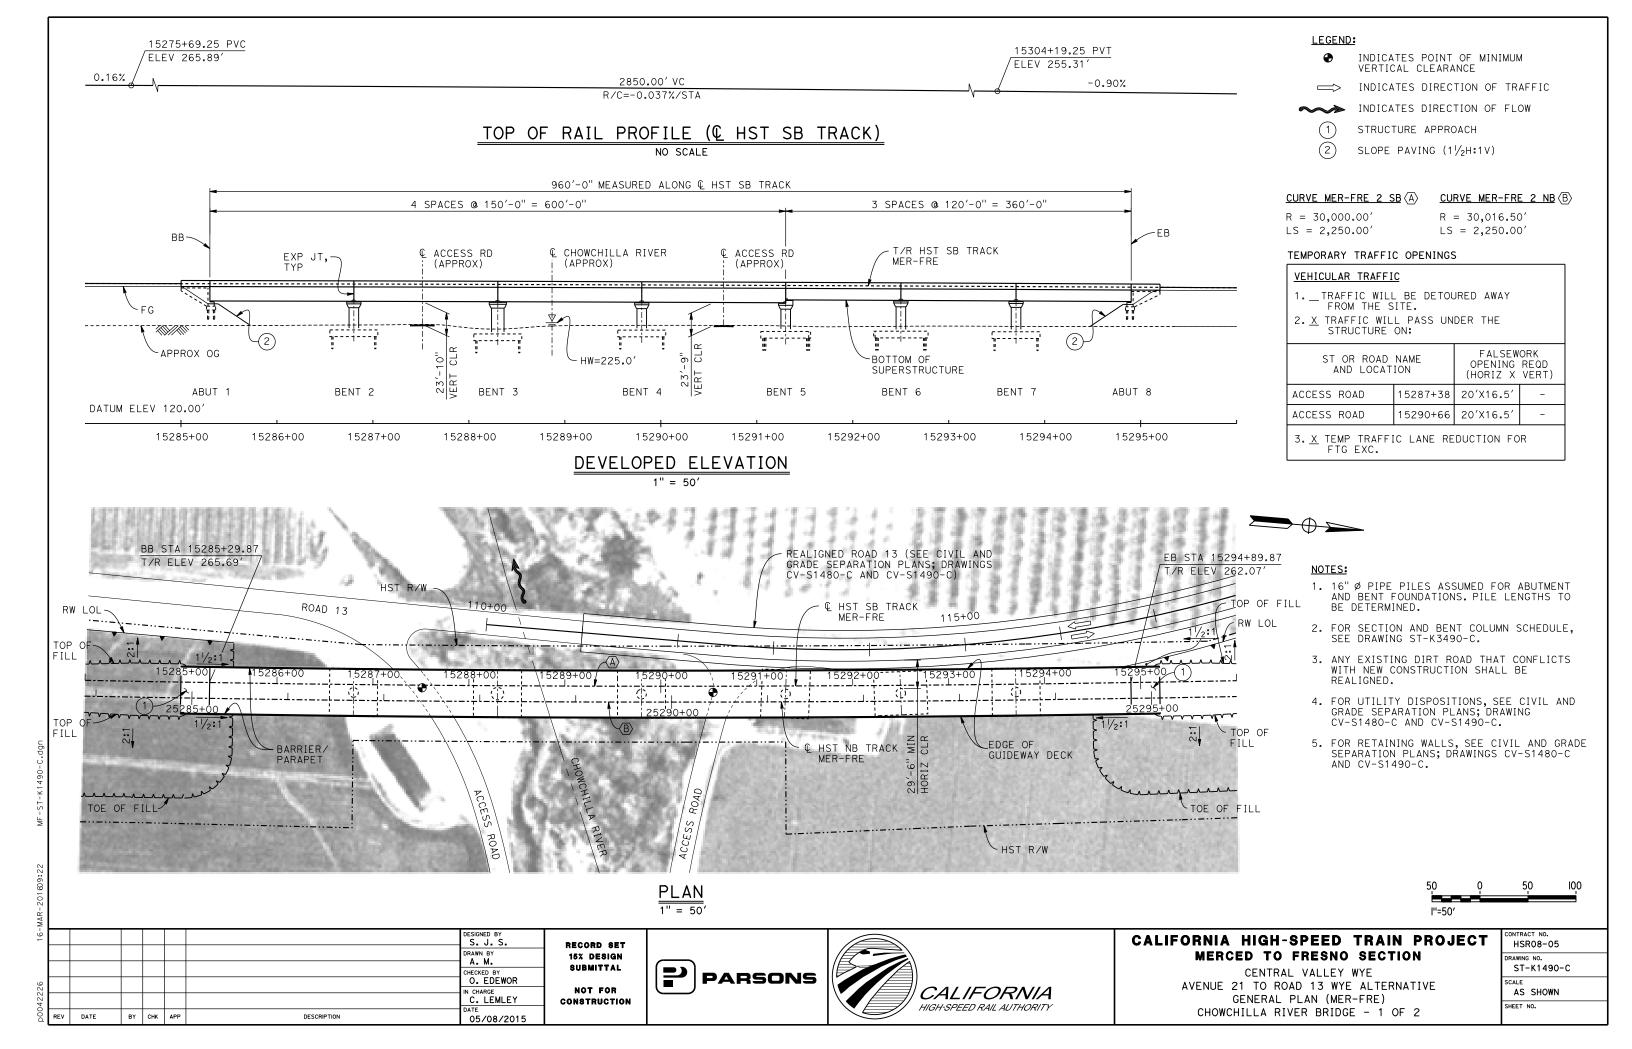

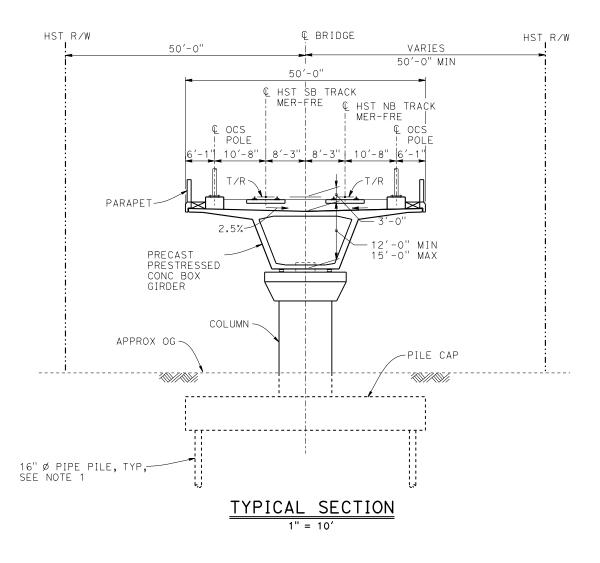

NOTES:

- 1. PILE LENGTHS TO BE DETERMINED.
- 2. FOR TRACK SUPERELEVATION DETAILS, SEE ALIGNMENT AND TYPICAL SECTION PLANS; DRAWINGS TT-B0056-C AND TT-B0057-C.



믭								
-50							DESIGNED BY S. J. S.	
							DRAWN BY A. M.	'
							CHECKED BY O. EDEWOR	
5133a							IN CHARGE C. LEMLEY	C
00d	REV	DATE	BY	снк	APP	DESCRIPTION	02/13/2015	

RECORD SET
15% DESIGN
SUBMITTAL
NOT FOR
CONSTRUCTION





CALIFORNIA HIGH-SPEED TRAIN PROJECT MERCED TO FRESNO SECTION


CENTRAL VALLEY WYE

AVENUE 21 TO ROAD 13 WYE ALTERNATIVE

TYPICAL SECTION (MER-FRE)

CHOWCHILLA RIVER BRIDGE - 2 OF 2

CONTRACT NO. HSR08-05
DRAWING NO. ST-K3490-C
AS SHOWN
SHEET NO.

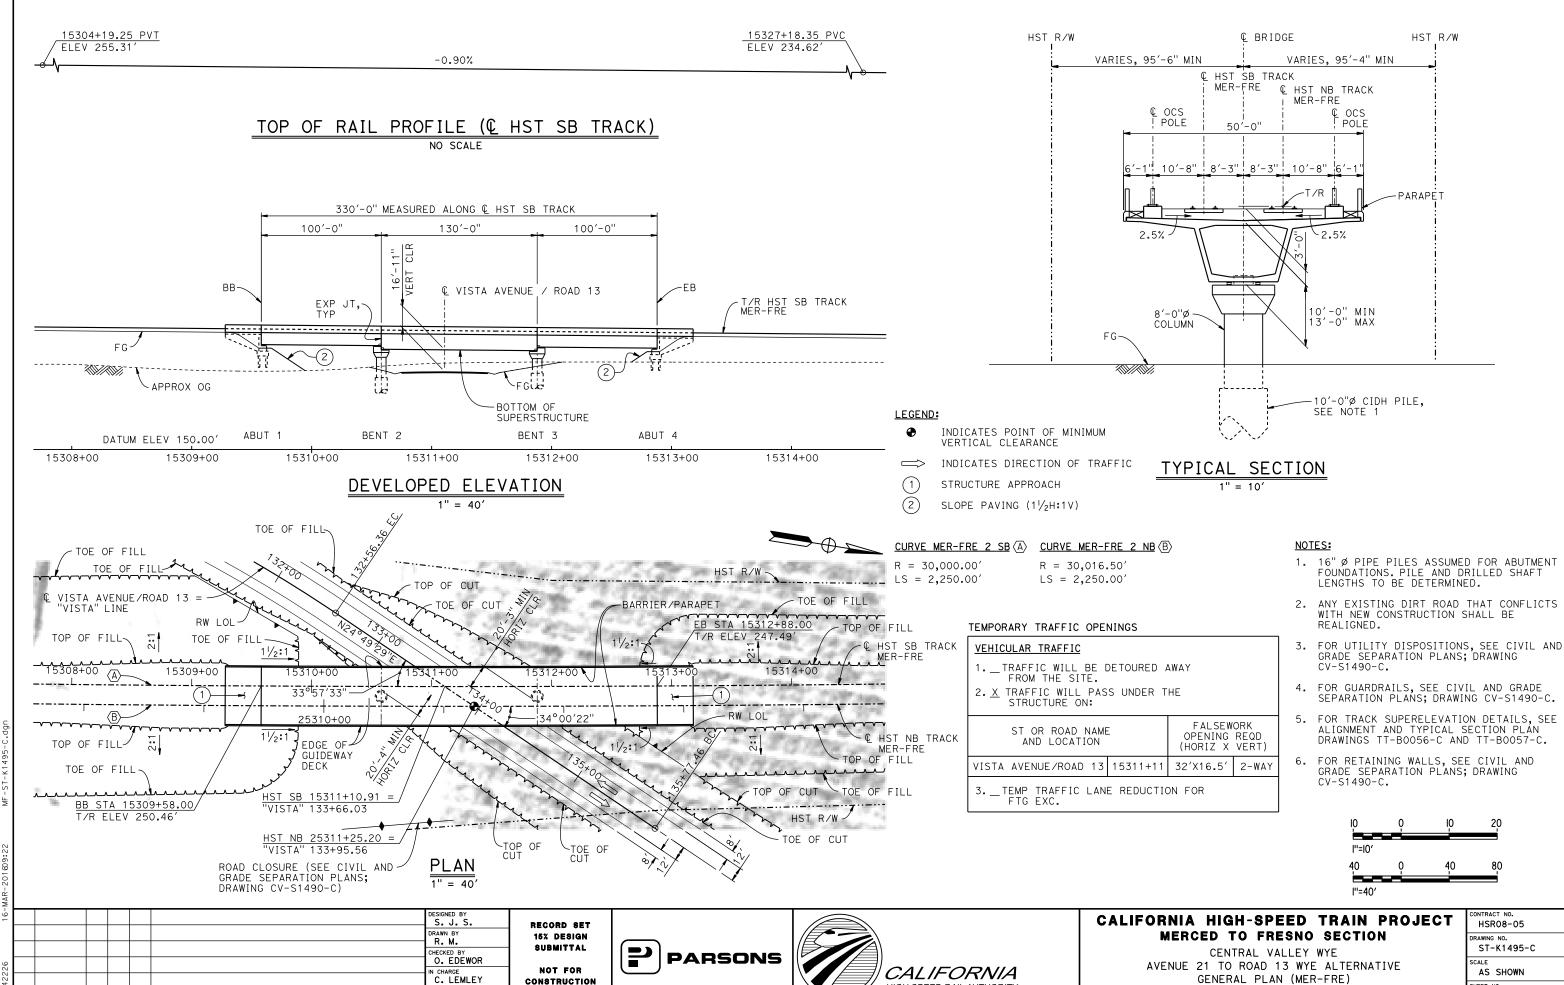

HIGH-SPEED RAIL AUTHORITY

CONSTRUCTION

05/08/2015


DATE

BY CHK APP

DESCRIPTION


GENERAL PLAN (MER-FRE) VISTA AVENUE (ROAD 13) UNDERPASS

AS SHOWN SHEET NO.

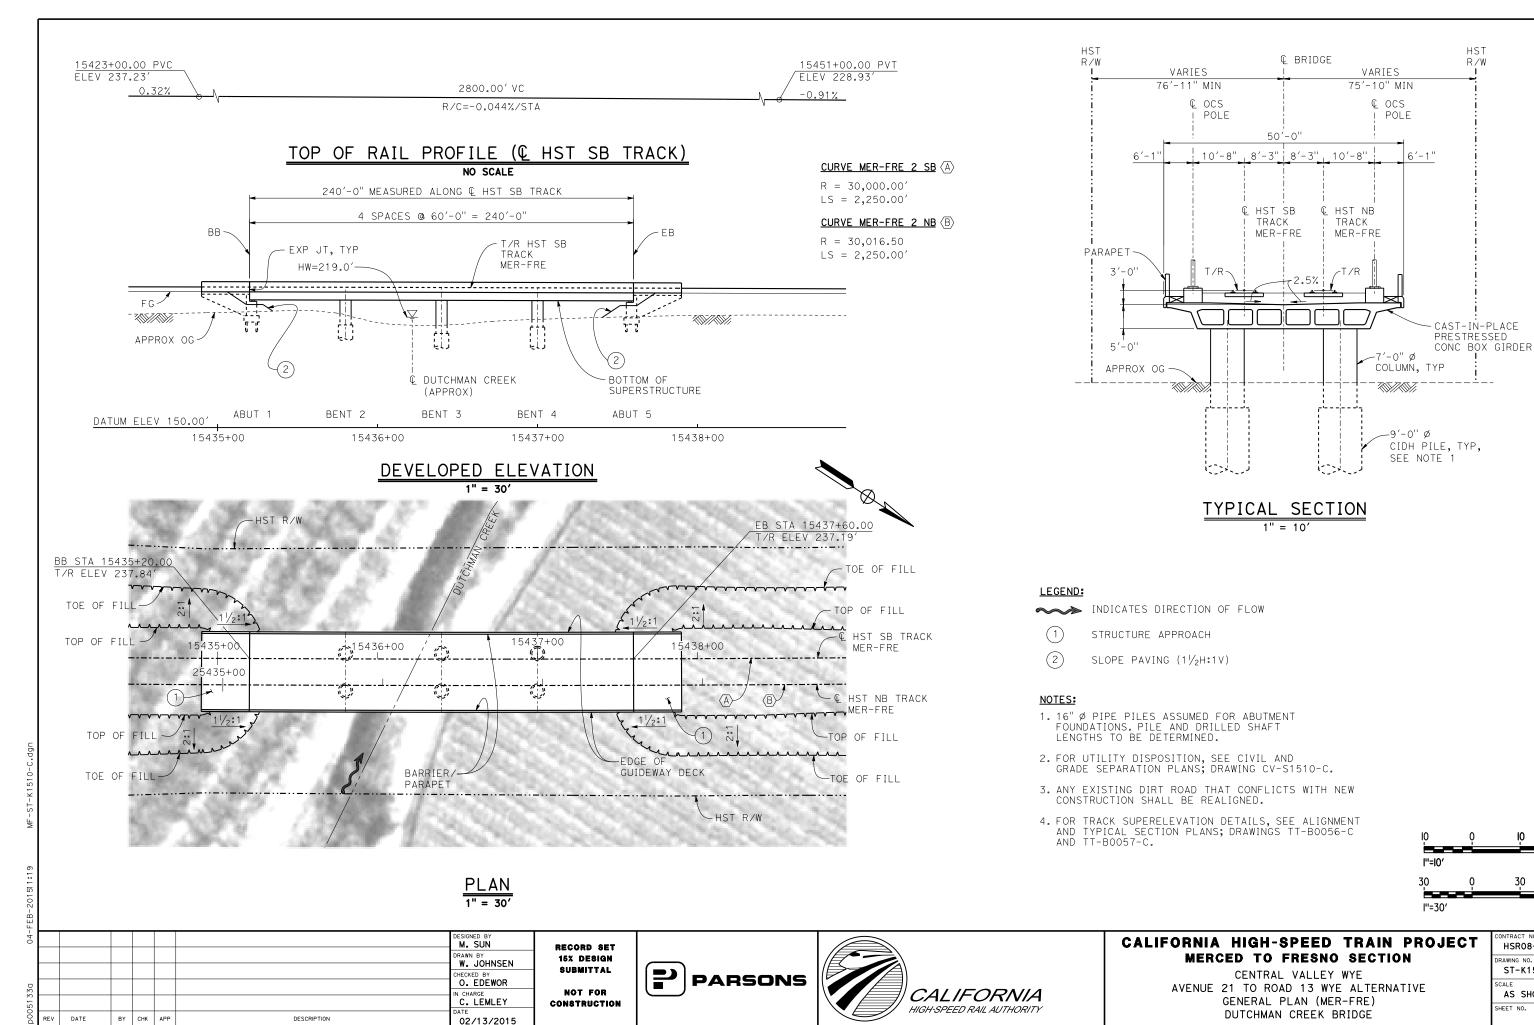



HSR08-05 ST-K1510-C AS SHOWN SHEET NO.


30

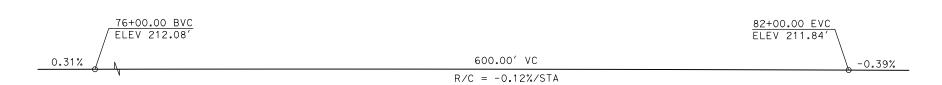

PROFILE GRADE NO SCALE

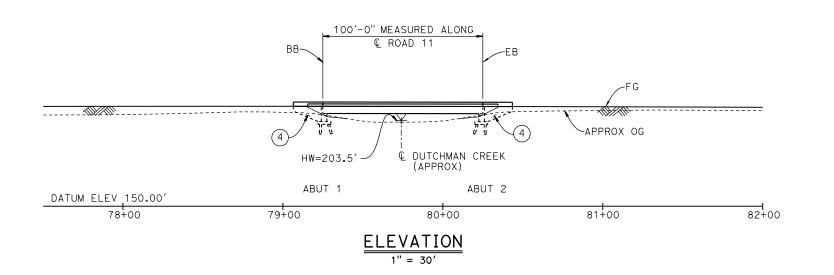

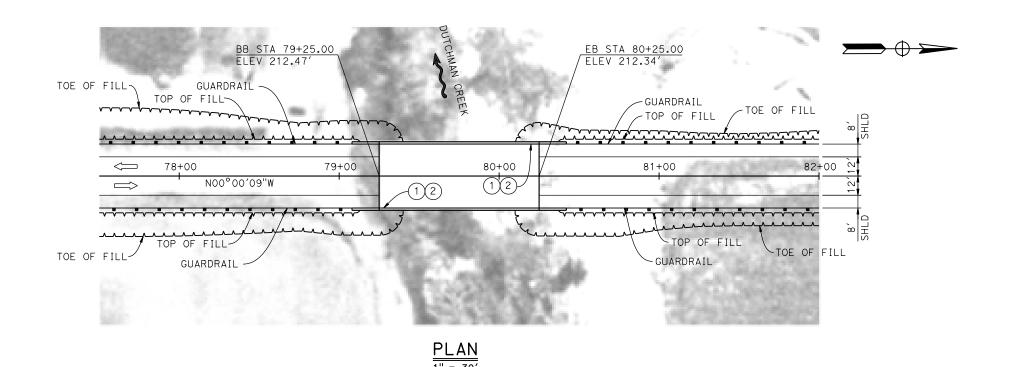

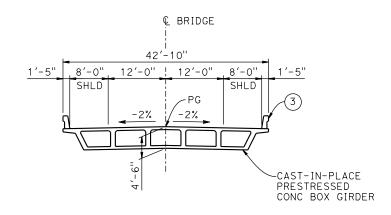

TYPICAL SECTION

LEGEND:

➤ INDICATES DIRECTION OF FLOW

(1) PAINT "ROAD 11 BRIDGE"


2 PAINT "BRIDGE NO. XX-XXXX"

(3) CONCRETE BARRIER TYPE 732

(4) WINGWALL

NOTES:

- 1. ASSUME CLASS 140 PILES AT ABUTMENT AND BENT FOUNDATIONS. PILE LENGTHS TO BE DETERMINED.
- 2. FOR UTILITY DISPOSITIONS, SEE CIVIL AND GRADE SEPARATION PLANS; DRAWING CV-R1512-C.
- 3. FOR GUARDRAILS, SEE CIVIL AND GRADE SEPARATION PLANS; DRAWING CV-R1512-C.

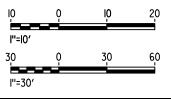

MA								
10-							DESIGNED BY	
							DRAWN BY	ı
3A							CHECKED BY K. CHARAN	
3							IN CHARGE C. LEMLEY	C
,500d	REV	DATE	BY	СНК	APP	DESCRIPTION	DATE 03/18/2016	

RECORD SET
15% DESIGN
SUBMITTAL
NOT FOR
CONSTRUCTION








CALIFORNIA HIGH-SPEED TRAIN PROJECT MERCED TO FRESNO SECTION

CENTRAL VALLEY WYE
AVENUE 21 TO ROAD 13 WYE ALTERNATIVE
GENERAL PLAN (MER-FRE)
ROAD 11 BRIDGE

CONTRACT NO.
HSR08-05
DRAWING NO.
ST-K1515-C
SCALE
AS SHOWN
SHEET NO.

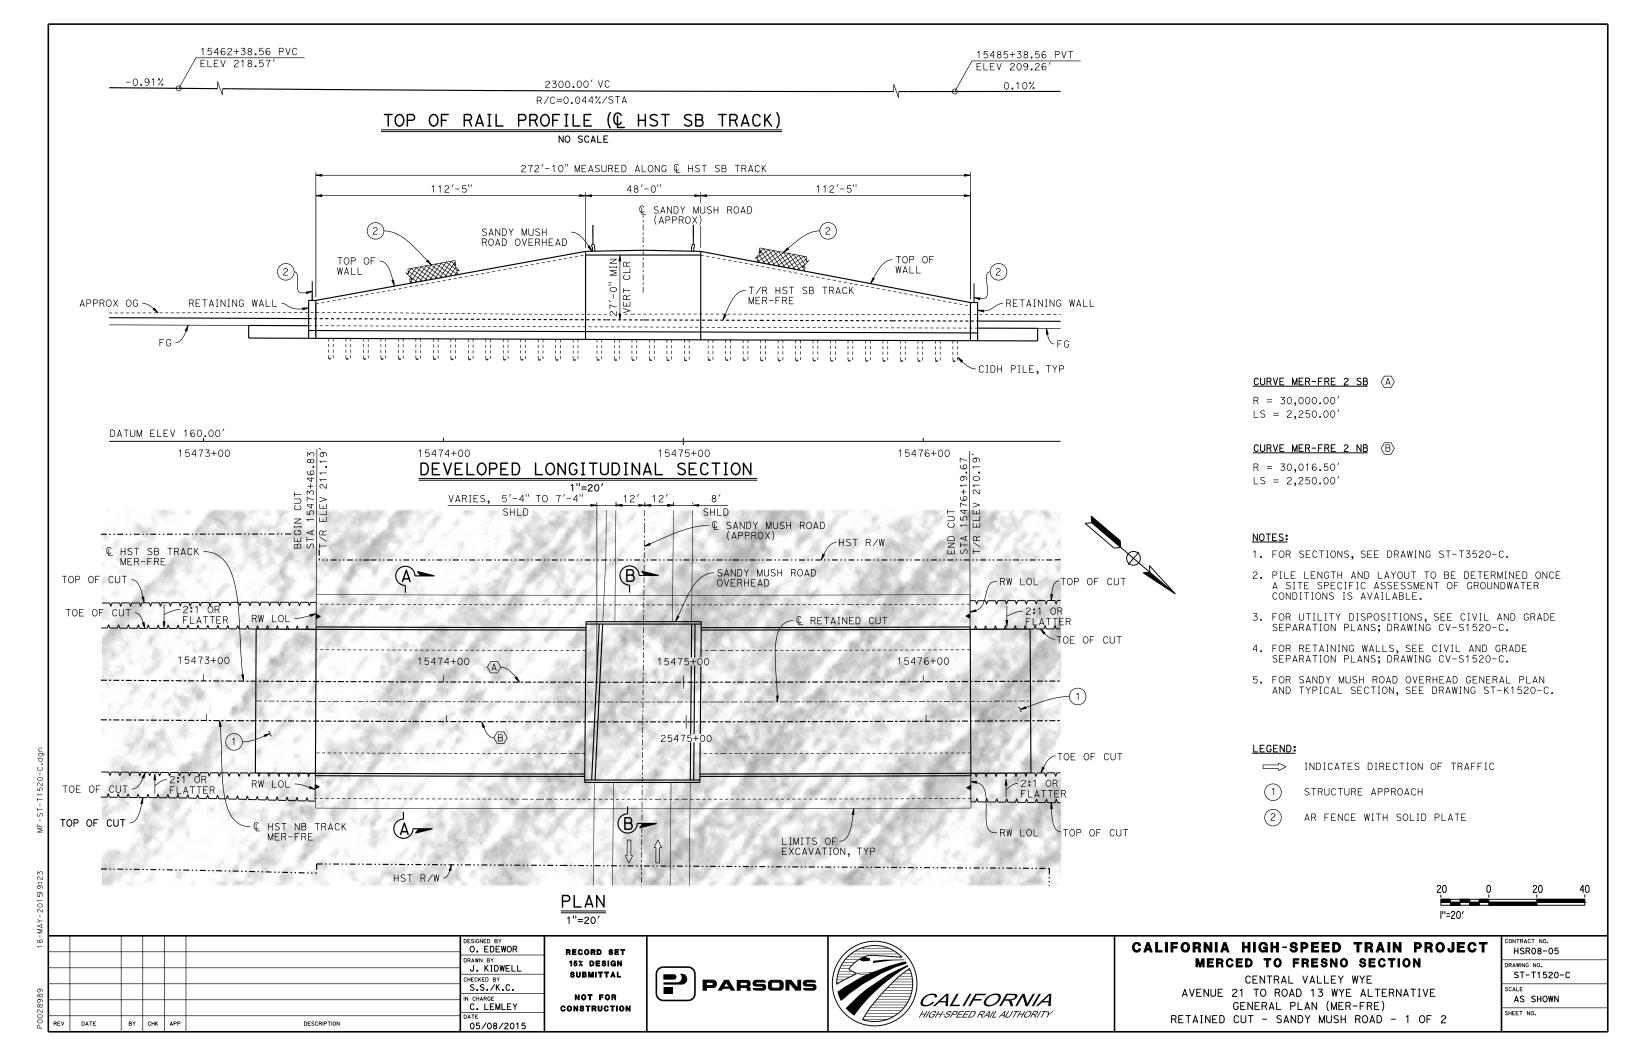

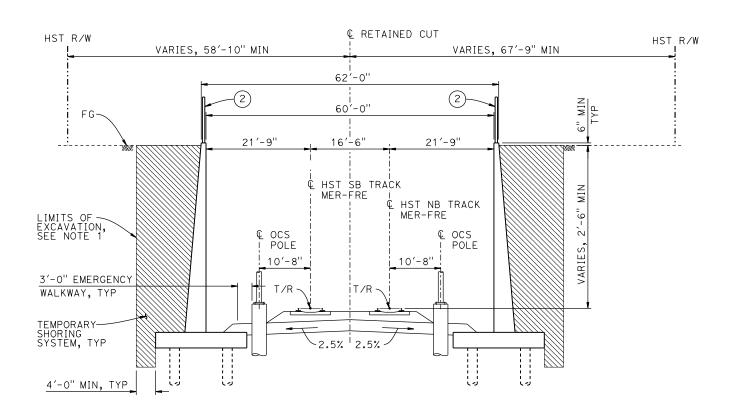

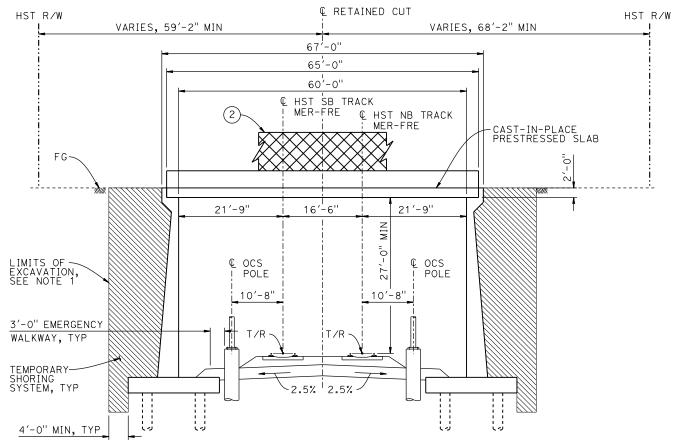


 $\frac{\text{SECTION } A-A}{1" = 10'}$

 $\frac{\text{SECTION B-B}}{1" = 10'}$

NOTES:

- 1. LIMITS OF EXCAVATION SHALL NOT EXTEND BEYOND HST $\ensuremath{\mathsf{R/W}}\xspace.$
- 2. PILE LENGTH AND LAYOUT TO BE DETERMINED ONCE A SITE SPECIFIC ASSESSMENT OF GROUNDWATER CONDITIONS IS AVAILABLE.
- 3. FOR TRACK SUPERELEVATION DETAILS, SEE ALIGNMENT AND TYPICAL SECTION PLANS; DRAWINGS TT-B0056-C AND TT-B0057-C.

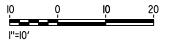

-							DESIGNED BY O. EDEWOR	RE
							DRAWN BY J. KIDWELL	15
							CHECKED BY	81
							S.S./K.C. IN CHARGE	,
,							C. LEMLEY	CON
	REV	DATE	BY	СНК	APP	DESCRIPTION	05/08/2015	

RECORD SET
15% DESIGN
SUBMITTAL
NOT FOR
DNSTRUCTION







CALIFORNIA HIGH-SPEED TRAIN PROJECT MERCED TO FRESNO SECTION

CENTRAL VALLEY WYE
AVENUE 21 TO ROAD 13 WYE ALTERNATIVE
TYPICAL SECTIONS (MER-FRE)
RETAINED CUT - SANDY MUSH ROAD - 2 OF 2


CONTRACT NO.
HSR08-05
DRAWING NO.
ST-T3520-C
SCALE
AS SHOWN
SHEET NO.

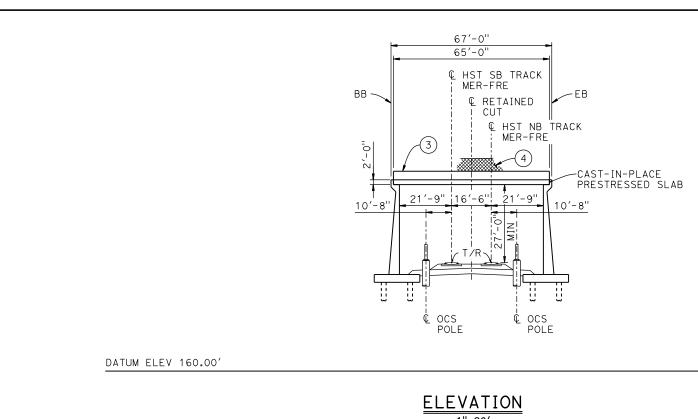

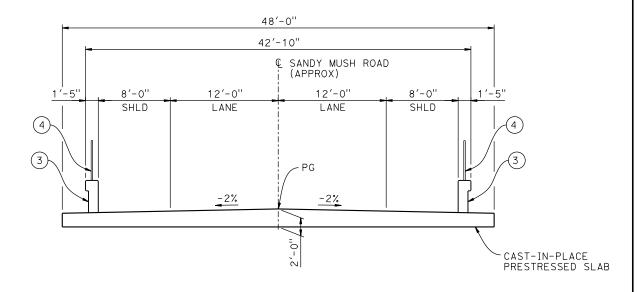

TYPICAL SECTION

1"=20'

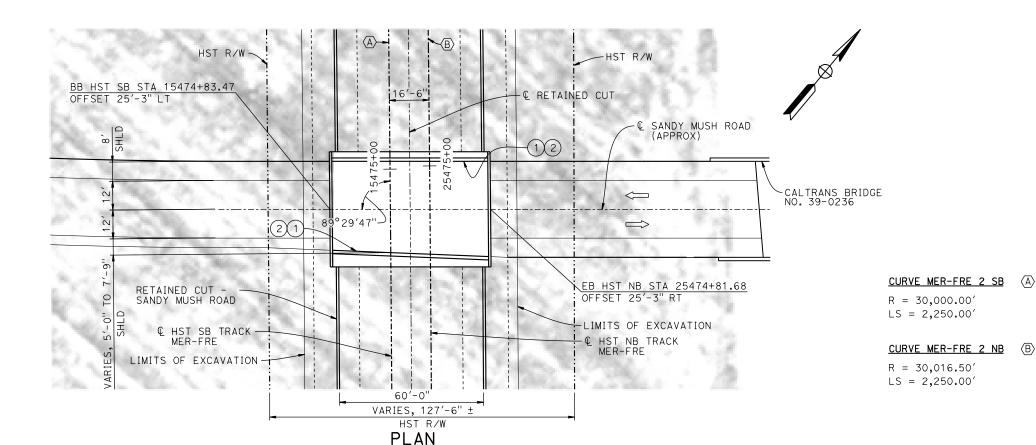


LEGEND:

- PAINT "SANDY MUSH ROAD OVERHEAD"
- (2) PAINT "BRIDGE NO. XX-XXXX"
- CONCRETE BARRIER TYPE 736 MOD
- AR FENCE WITH SOLID PLATE

NOTES:

- 1. FOR UTILITY DISPOSITIONS, SEE CIVIL AND GRADE SEPARATION PLANS; DRAWING CV-S1520-C.
- 2. PILE LENGTH AND LAYOUT TO BE DETERMINED ONCE A SITE SPECIFIC ASSESSMENT OF GROUNDWATER CONDITIONS IS AVAILABLE.
- 3. FOR RETAINED CUT SANDY MUSH ROAD GENERAL PLAN AND TYPICAL SECTIONS, SEE DRAWINGS ST-T1520-C AND ST-T3520-C.

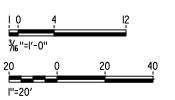

1"=20' DESIGNED BY
O. EDEWOR RECORD SET DRAWN BY
J. KIDWELL 15% DESIGN SUBMITTAL CHECKED BY

IN CHARGE
C. LEMLEY

05/08/2015

DATE

BY CHK APP

DESCRIPTION

NOT FOR






CALIFORNIA HIGH-SPEED TRAIN PROJECT MERCED TO FRESNO SECTION


CENTRAL VALLEY WYE AVENUE 21 TO ROAD 13 WYE ALTERNATIVE GENERAL PLAN (MER-FRE) SANDY MUSH ROAD OVERHEAD

CONTRACT NO.
HSR08-05
DRAWING NO.
ST-K1520-C
SCALE
AS SHOWN
SHEET NO.

TOP OF RAIL PROFILE (HST NB TRACK SJD-MER) NO SCALE

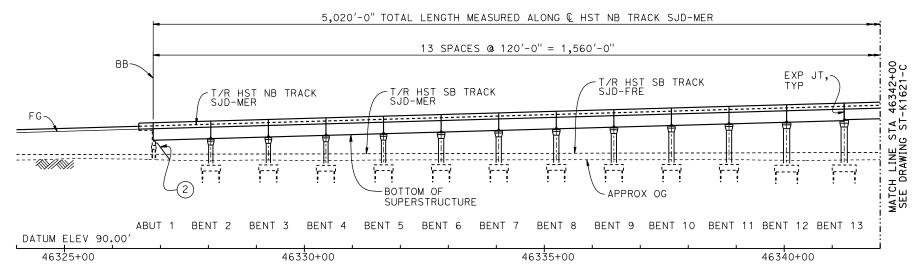

DEVELOPED ELEVATION

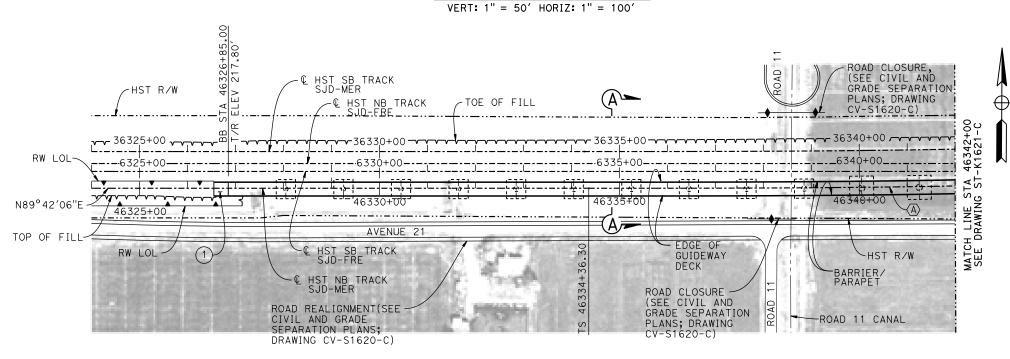

PLAN 1" = 100'

RECORD SET
15% DESIGN
SUBMITTAL
NOT FOR
CONSTRUCTION



LEGEND:


- INDICATES POINT OF MINIMUM VERTICAL CLEARANCE
- (1) STRUCTURE APPROACH
- 2) SLOPE PAVING $(1\frac{1}{2}H:1V)$

CURVE SJD-MER 1 NB (A)

R = 10,376.50'LS = 1,500.00'

NOTES:

- 1. 16" Ø PIPE PILES ASSUMED FOR ABUTMENT AND BENT FOUNDATIONS, UNLESS OTHERWISE NOTED. PILE LENGTHS TO BE DETERMINED.
- 2. FOR SECTIONS AND BENT COLUMN SCHEDULE, SEE DRAWINGS ST-K3620-C AND ST-K3621-C.
- 3. FOR RETAINING WALLS, SEE CIVIL AND GRADE SEPARATION PLANS; DRAWING CV-S1620-C.
- 4. FOR UTILITY DISPOSITIONS, SEE CIVIL AND GRADE SEPARATION PLANS; DRAWING CV-S1620-C.
- 5. ANY EXISTING DIRT ROAD THAT CONFLICTS WITH NEW CONSTRUCTION SHALL BE REALIGNED.

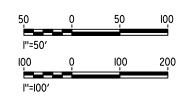

CALIFORNIA HIGH-SPEED TRAIN PROJECT MERCED TO FRESNO SECTION

CENTRAL VALLEY WYE

AVENUE 21 TO ROAD 13 WYE ALTERNATIVE


GENERAL PLAN (SJD-MER)

AERIAL #5 - NORTHBOUND OVER HST MAINLINE - 1 OF 5


CONTRACT NO.
HSR08-05
DRAWING NO. ST-K1620-C
AS SHOWN

R/C=-0.122%/STA

TOP OF RAIL PROFILE (HST NB TRACK SJD-MER)

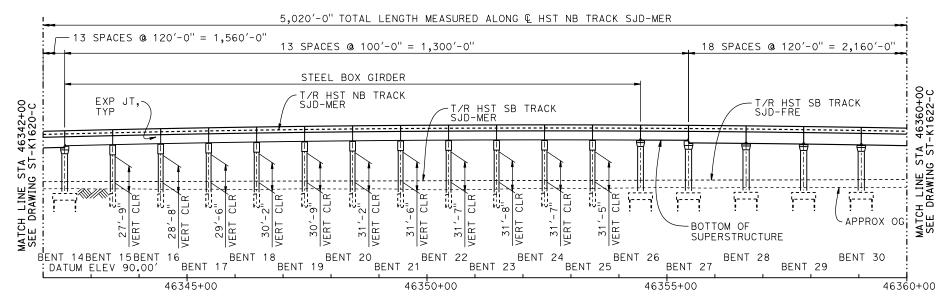

DEVELOPED ELEVATION

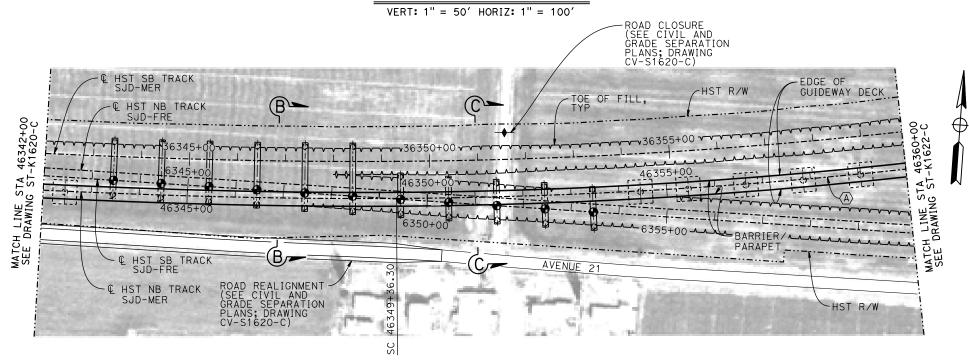

Ρ	L	AN
1'''	=	100′

50	Q	50	100
l''=50′			
100	Q	100	200
l''=l00′			

È								
-							DESIGNED BY M. SUN	RECORD SET
							DRAWN BY	15% DESIGN
							CHECKED BY O. EDEWOR	SUBMITTAL
42226	-						IN CHARGE C. LEMLEY	NOT FOR CONSTRUCTION
000		DATE	BY	СНК	APP	DESCRIPTION	05/08/2015	

PARSONS



CALIFORNIA HIGH-SPEED TRAIN PROJECT MERCED TO FRESNO SECTION

CENTRAL VALLEY WYE AVENUE 21 TO ROAD 13 WYE ALTERNATIVE GENERAL PLAN (SJD-MER) AERIAL #5 - NORTHBOUND OVER HST MAINLINE - 2 OF 5

CONTRACT NO.
HSR08-05
DRAWING NO.
ST-K1621-C
SCALE
AS SHOWN

50	Q	50	10,0
l"=50′ l00	Ō.	IÓO	200
l''=l00′			


-								
16-							DESIGNED BY M. SUN	
							DRAWN BY A. M.	1
							CHECKED BY	l
56							O. EDEWOR IN CHARGE	1
p00422							C. LEMLEY	c
D00	REV	DATE	BY	СНК	APP	DESCRIPTION	05/08/2015	





CALIFORNIA HIGH-SPEED TRAIN PROJECT MERCED TO FRESNO SECTION

CENTRAL VALLEY WYE AVENUE 21 TO ROAD 13 WYE ALTERNATIVE GENERAL PLAN (SJD-MER) AERIAL #5 - NORTHBOUND OVER HST MAINLINE - 3 OF 5

CONTRACT NO.
HSR08-05
DRAWING NO.
ST-K1622-C
SCALE
AS SHOWN
SHEET NO.

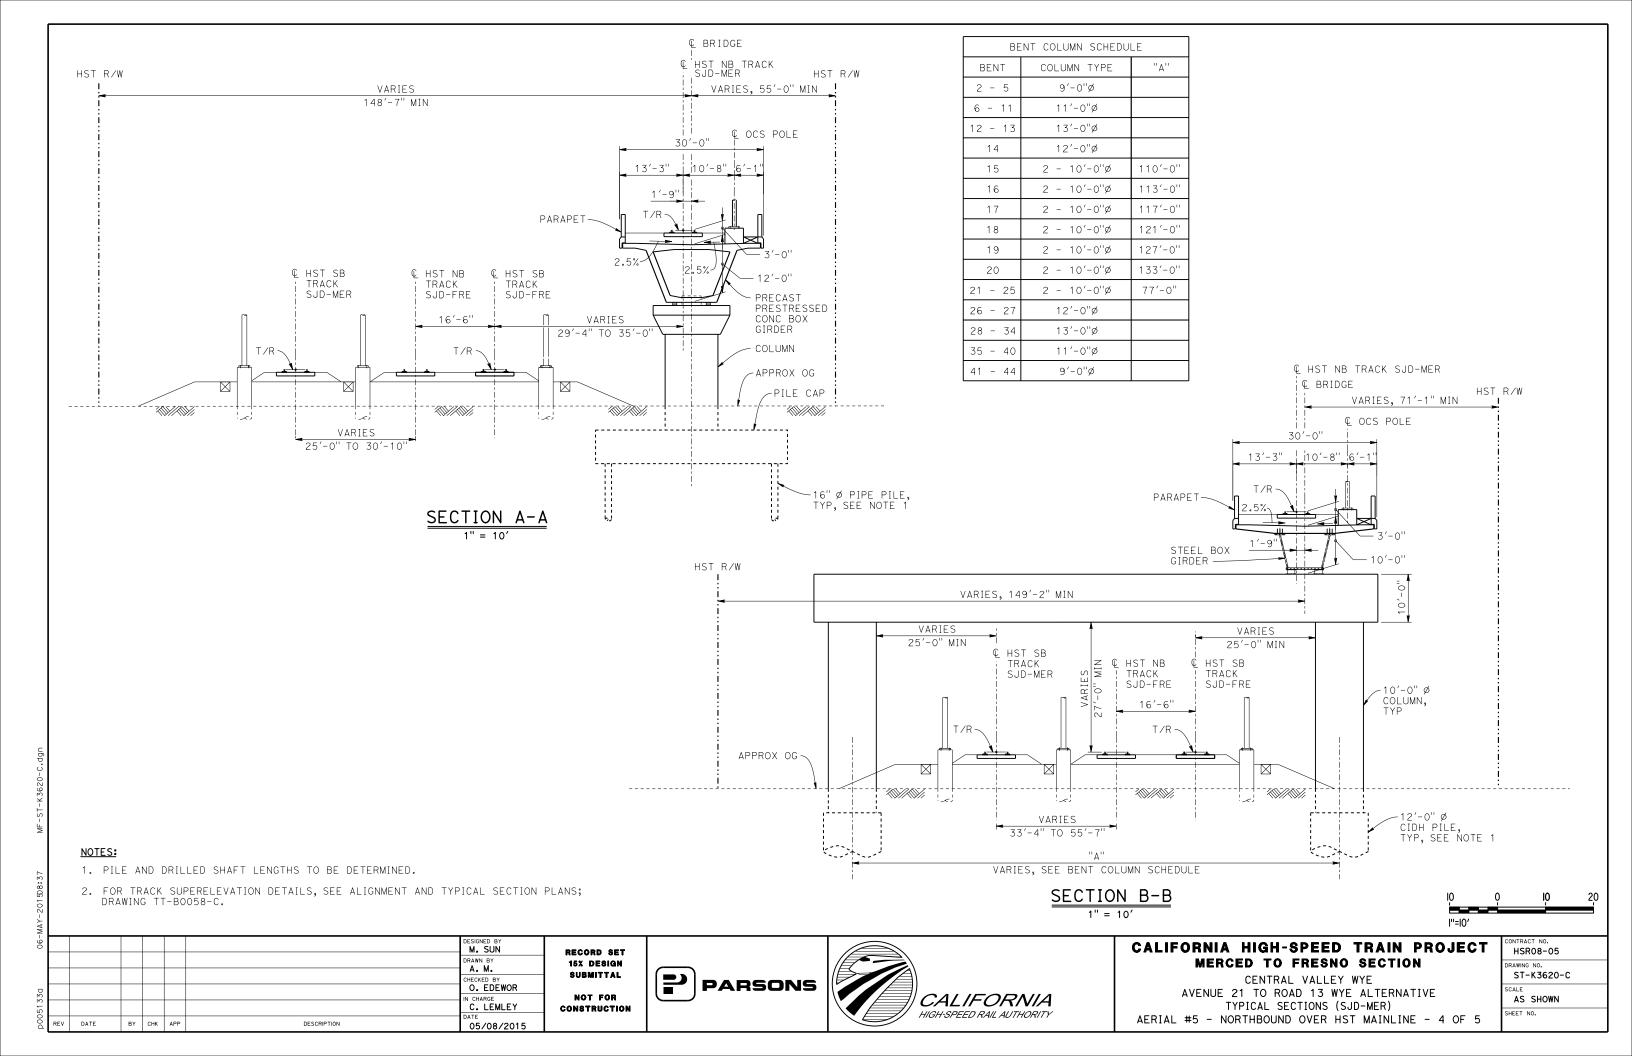


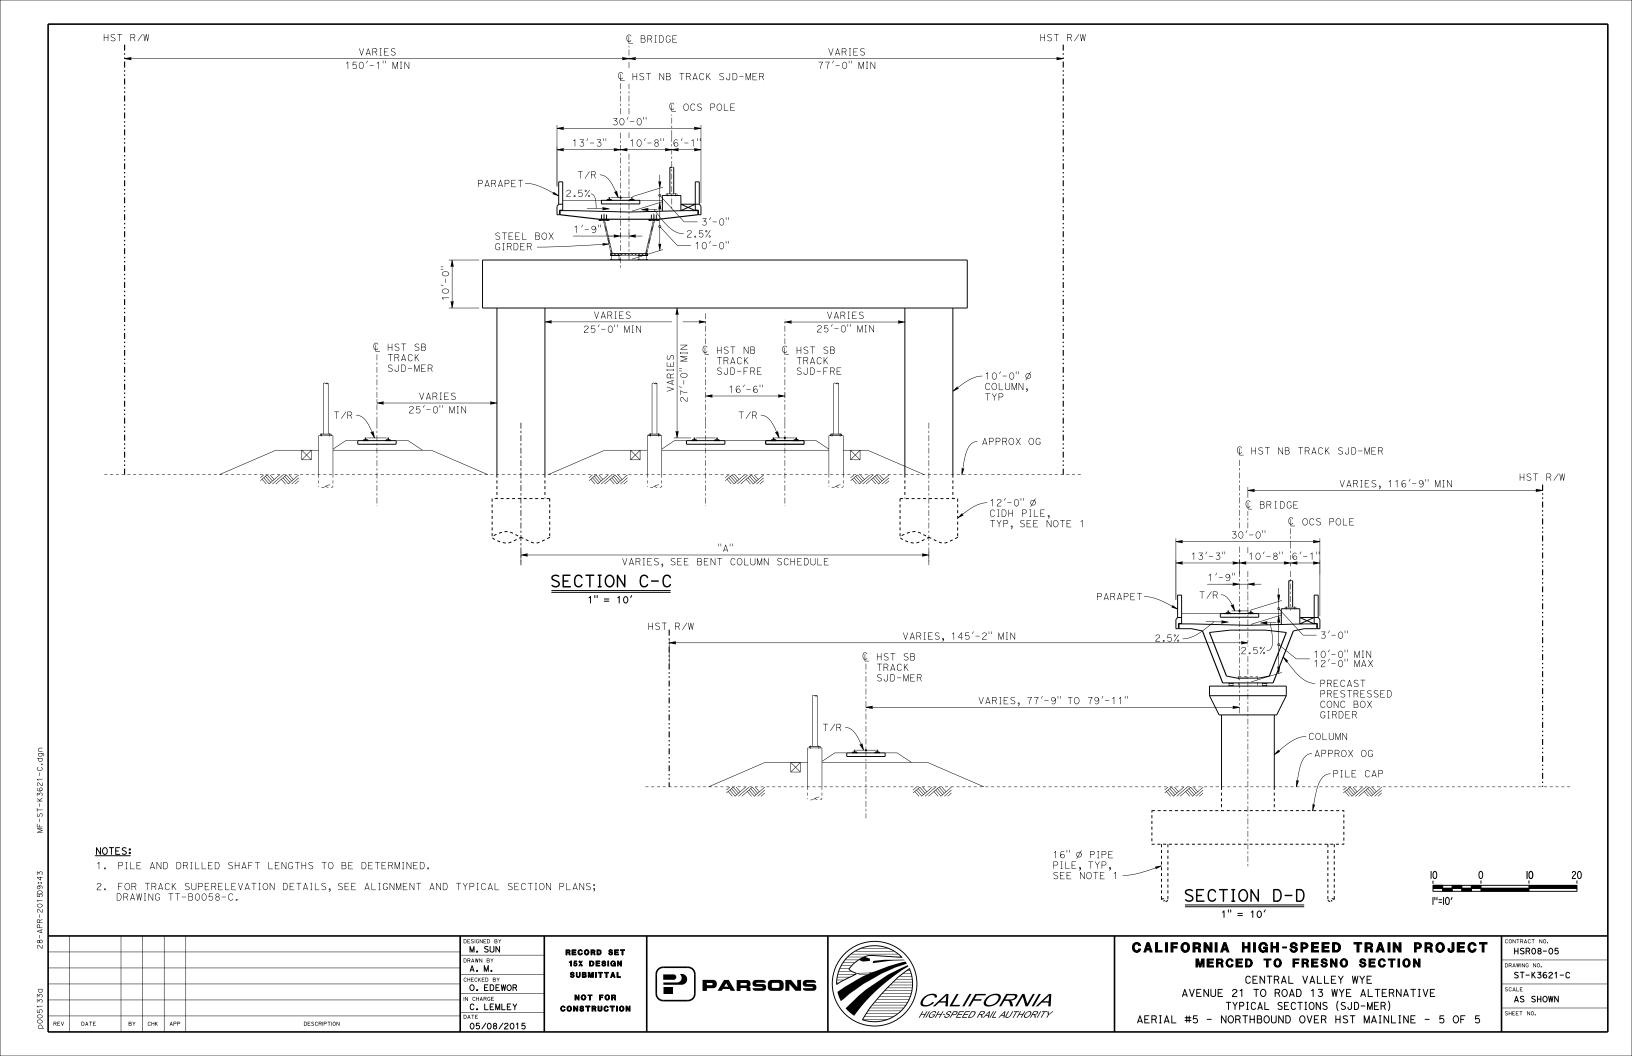

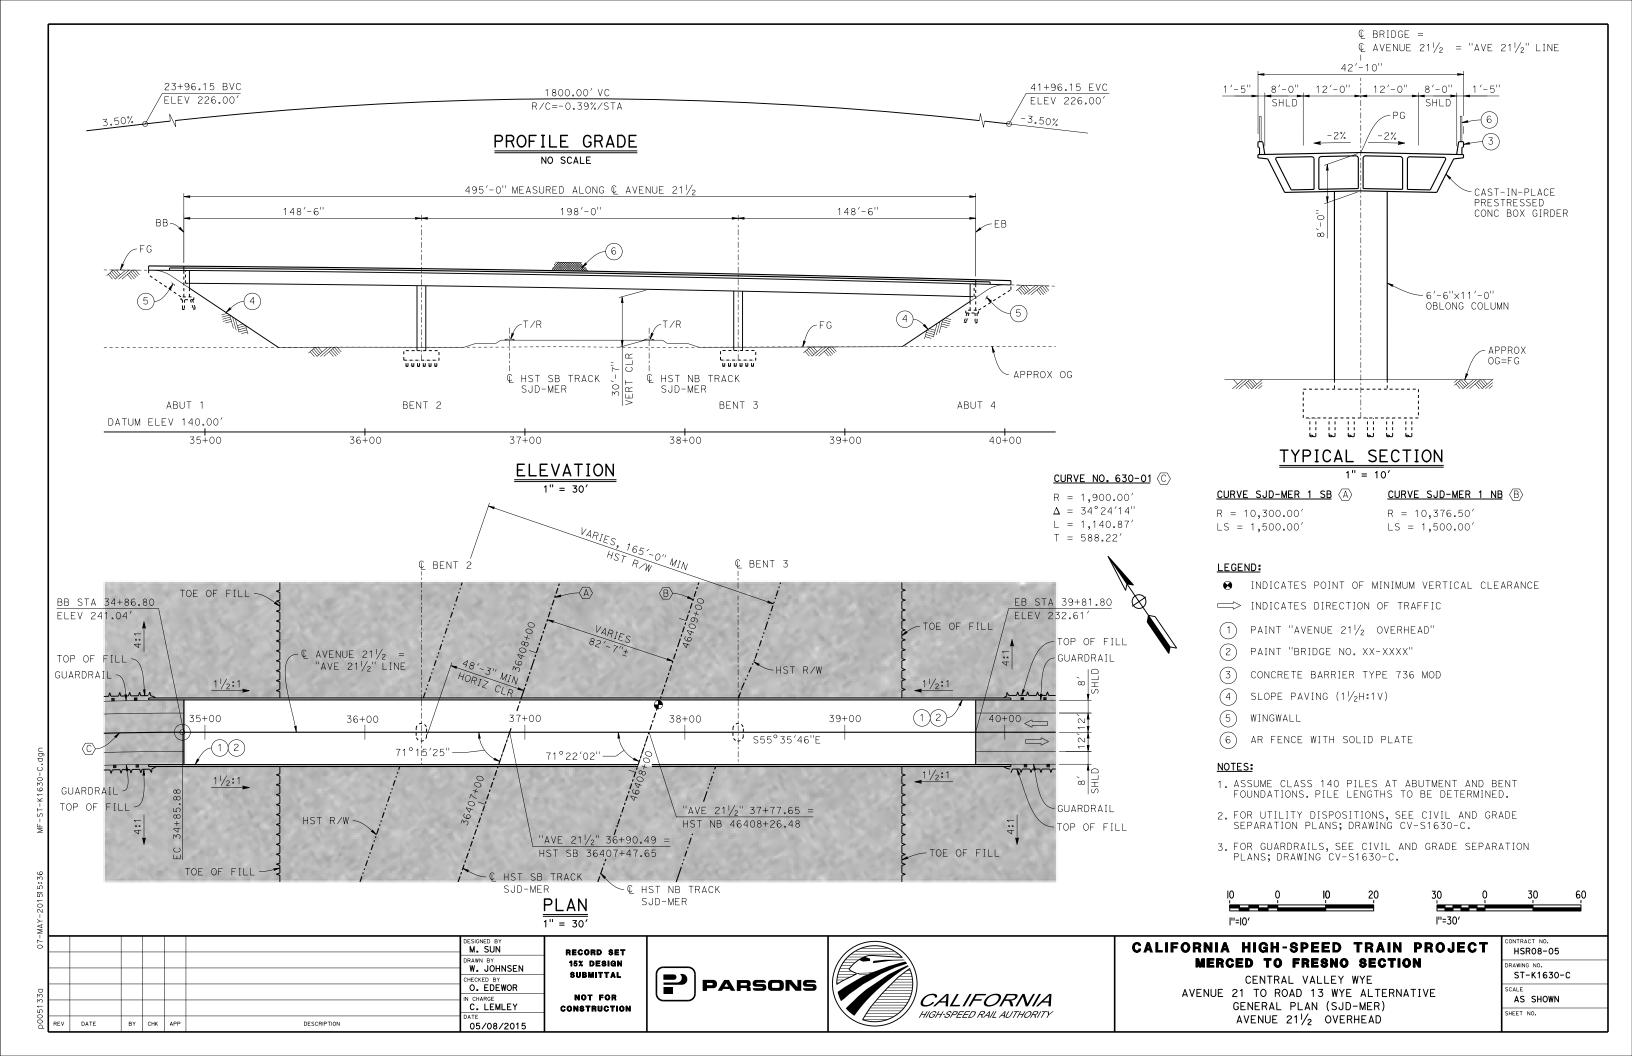


1.45%

TOP OF RAIL PROFILE (& HST NB TRACK SJD-MER)

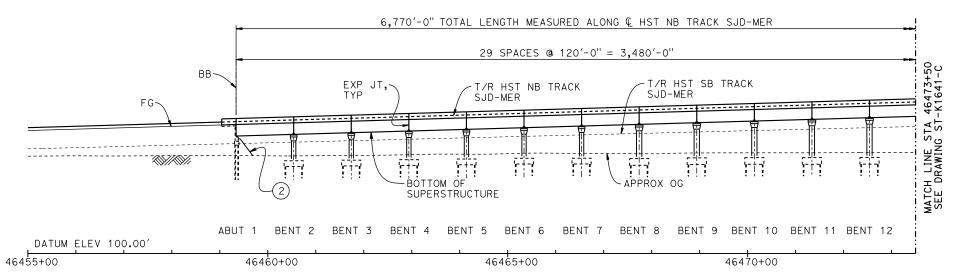

DEVELOPED ELEVATION

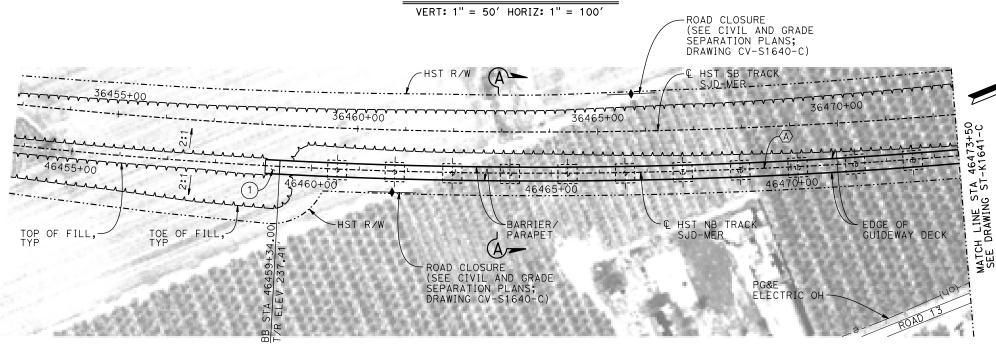

PLAN 1" = 100'

RECORD SET 15% DESIGN SUBMITTAL NOT FOR CONSTRUCTION

M. SUN

CHECKED BY
O. EDEWOR

N CHARGE C. LEMLEY

05/08/2015

DRAWN BY





LEGEND:

- INDICATES POINT OF MINIMUM VERTICAL CLEARANCE
- INDICATES DIRECTION OF TRAFFIC
- STRUCTURE APPROACH
- SLOPE PAVING (11/2H:1V)

CURVE SJD-MER 1 NB (A)

R = 10,376.50'LS = 1,500.00'

TEMPORARY TRAFFIC OPENINGS

VEHICULAR TRAFFIC


- 1. __TRAFFIC WILL BE DETOURED AWAY FROM THE SITE.
- 2. X TRAFFIC WILL PASS UNDER THE STRUCTURE ON:

01110010112 0111			
ST OR ROAD NAME AND LOCATION	FALSEWORK OPENING REQD (HORIZ X VERT)		
AVENUE 221/2	46479+15	32′X16.5′	2-WAY
SR 152	46505+72	52′X16.5′	E BND
SR 152	46506+18	52′x16.5′	W BND
3. X TEMP TRAFFIC LAN	E REDUCTI	ON FOR	

FTG EXC.

NOTES:

- 1. 16" Ø PIPE PILES ASSUMED FOR ABUTMENT AND BENT FOUNDATIONS, UNLESS OTHERWISE NOTED. PILE LENGTHS TO BE DETERMINED.
- 2. FOR SECTIONS AND BENT COLUMN SCHEDULE, SEE DRAWINGS ST-K3640-C AND ST-K3641-C.
- 3. ANY EXISTING DIRT ROAD THAT CONFLICTS WITH NEW CONSTRUCTION SHALL BE REALIGNED.
- 4. FOR UTILITY DISPOSITIONS, SEE CIVIL AND GRADE SEPARATION PLANS; DRAWINGS CV-S1640-C AND CV-S1650-C.
- 5. FOR GUARDRAILS, SEE CIVIL AND GRADE SEPARATION PLANS; DRAWINGS CV-S1640-C AND CV-S1650-C.
- 6. FOR RETAINING WALL, SEE CIVIL AND GRADE SEPARATION PLNAS; DRAWINGS CV-S1640-C AND CV-S1650-C.
- 7. FOR AVENUE 22 $^{\prime}\!\!/_2$ UNDERPASS (HST SB) GENERAL PLAN AND TYPICAL SECTION, SEE DRAWING ST-K1646-C.
- 8. FOR SR 152 UNDERPASS GENERAL PLAN AND TYPICAL SECTION, SEE DRAWINGS ST-K1450-C AND ST-K3450-C.

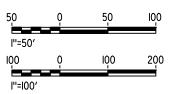

CALIFORNIA HIGH-SPEED TRAIN PROJECT MERCED TO FRESNO SECTION

CENTRAL VALLEY WYE AVENUE 21 TO ROAD 13 WYE ALTERNATIVE GENERAL PLAN (SJD-MER) AERIAL #6 - NORTHBOUND OVER HST MERCED TO FRESNO - 1 OF 6

HSR08-05 ST-K1640-C AS SHOWN SHEET NO.


DATE

BY CHK APP

DESCRIPTION


TOP OF RAIL PROFILE (& HST NB TRACK SJD-MER)

NO SCALE

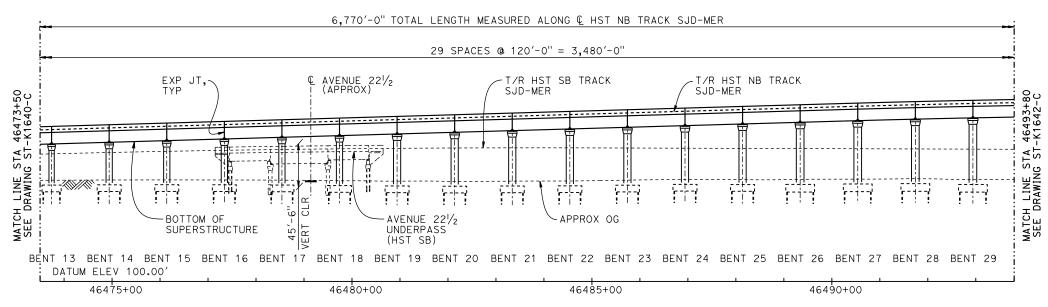

DEVELOPED ELEVATION

VERT: 1" = 50' HORIZ: 1" = 100'

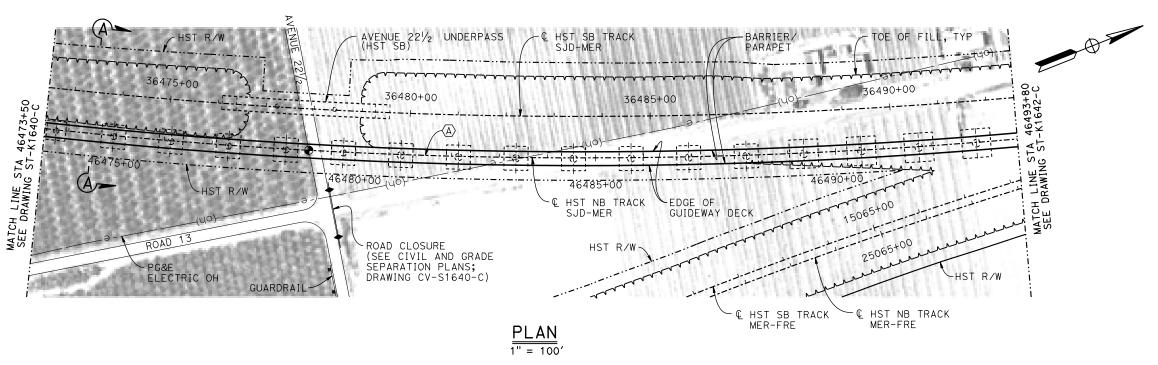

50	0	50	100
l''=50′			
100	Q	IQ0	200
l''=l00′			

Σ								
9							DESIGNED BY M. SUN	
							DRAWN BY A. M.	
92							CHECKED BY O. EDEWOR	
422							IN CHARGE C. LEMLEY	C
000	REV	DATE	BY	снк	APP	DESCRIPTION	05/08/2015	

RECORD SET
15% DESIGN
SUBMITTAL
NOT FOR
CONSTRUCTION






CALIFORNIA HIGH-SPEED TRAIN PROJECT MERCED TO FRESNO SECTION

CENTRAL VALLEY WYE
AVENUE 21 TO ROAD 13 WYE ALTERNATIVE
GENERAL PLAN (SJD-MER)
AERIAL #6 - NORTHBOUND OVER HST MERCED TO FRESNO - 2 OF 6

	CONTRACT NO.
	HSR08-05
	DRAWING NO.
	ST-K1641-C
	SCALE
	AS SHOWN
ŝ	SHEET NO.
_	


46531+81.57 PVC ELEV 231.12'

TOP OF RAIL PROFILE (HST NB TRACK SJD-MER)

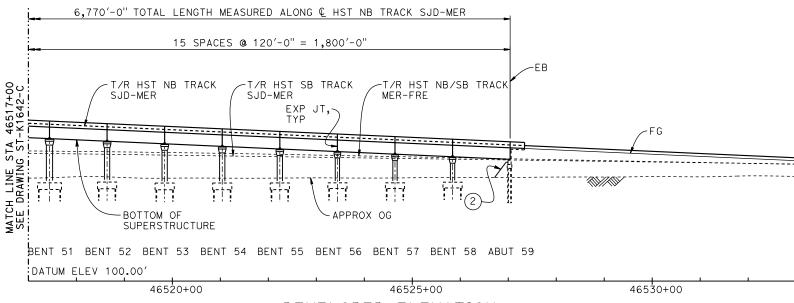

DEVELOPED ELEVATION

VERT: 1" = 50' HORIZ: 1" = 100'

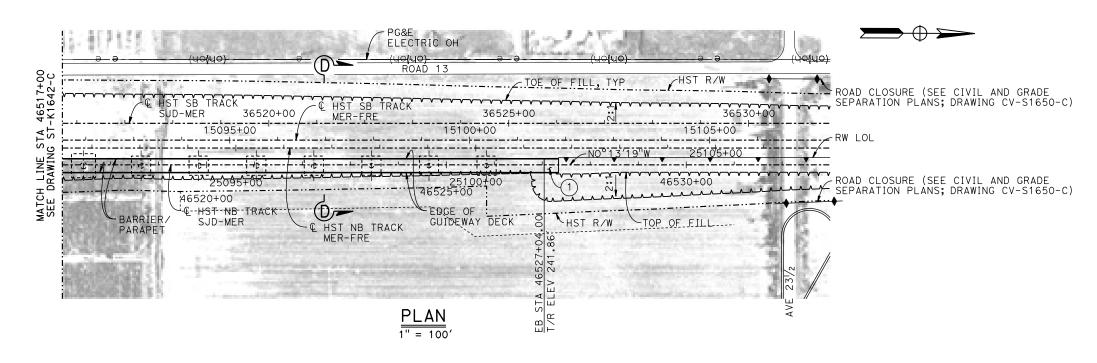

50	Q	50	100
l''=50'			
100	Q	ΙŌΟ	200
l''=l00'			

Σ								
2							DESIGNED BY M. SUN	
١							DRAWN BY A. M.	1
							CHECKED BY	ł
2							O. EDEWOR IN CHARGE	l
771							C. LEMLEY	0
3	REV	DATE	BY	снк	APP	DESCRIPTION	05/08/2015	

RECORD SET
15% DESIGN
SUBMITTAL
NOT FOR
CONSTRUCTION








CALIFORNIA HIGH-SPEED TRAIN PROJECT MERCED TO FRESNO SECTION


CENTRAL VALLEY WYE
AVENUE 21 TO ROAD 13 WYE ALTERNATIVE
GENERAL PLAN (SJD-MER)
AERIAL #6 - NORTHBOUND OVER HST MERCED TO FRESNO - 4 OF 6

CONTRACT NO.
HSR08-05
DRAWING NO.
ST-K1643-C
SCALE
AS SHOWN
SHEET NO.

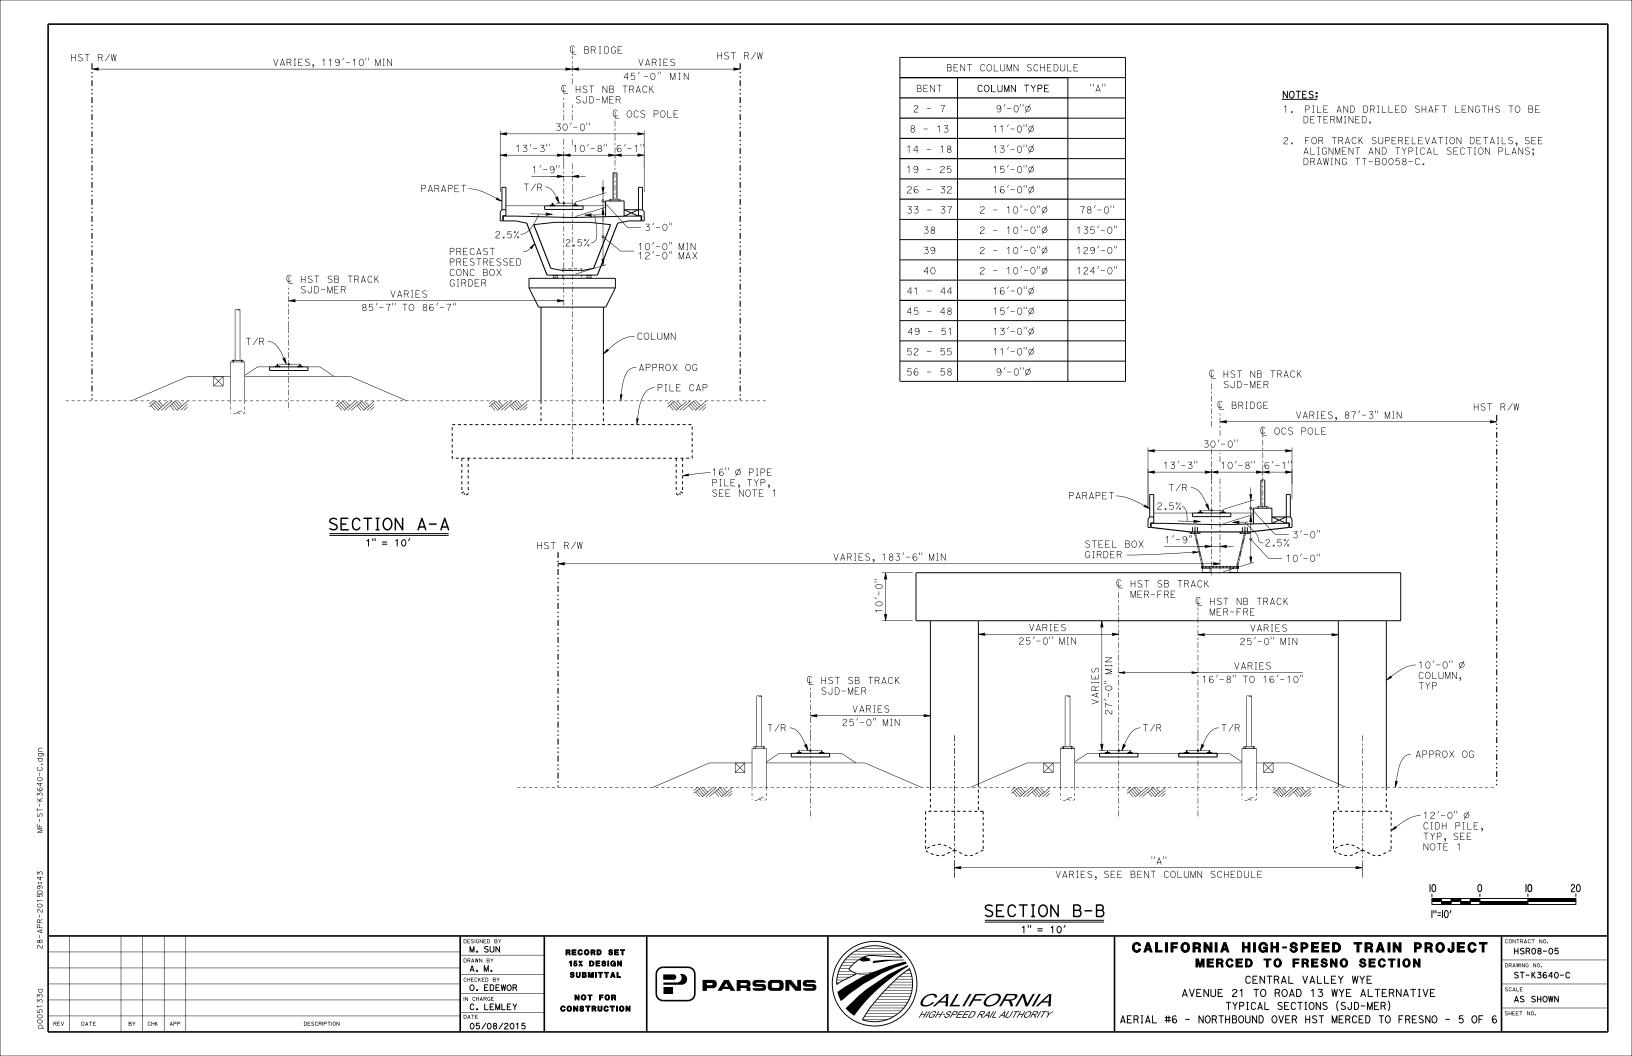

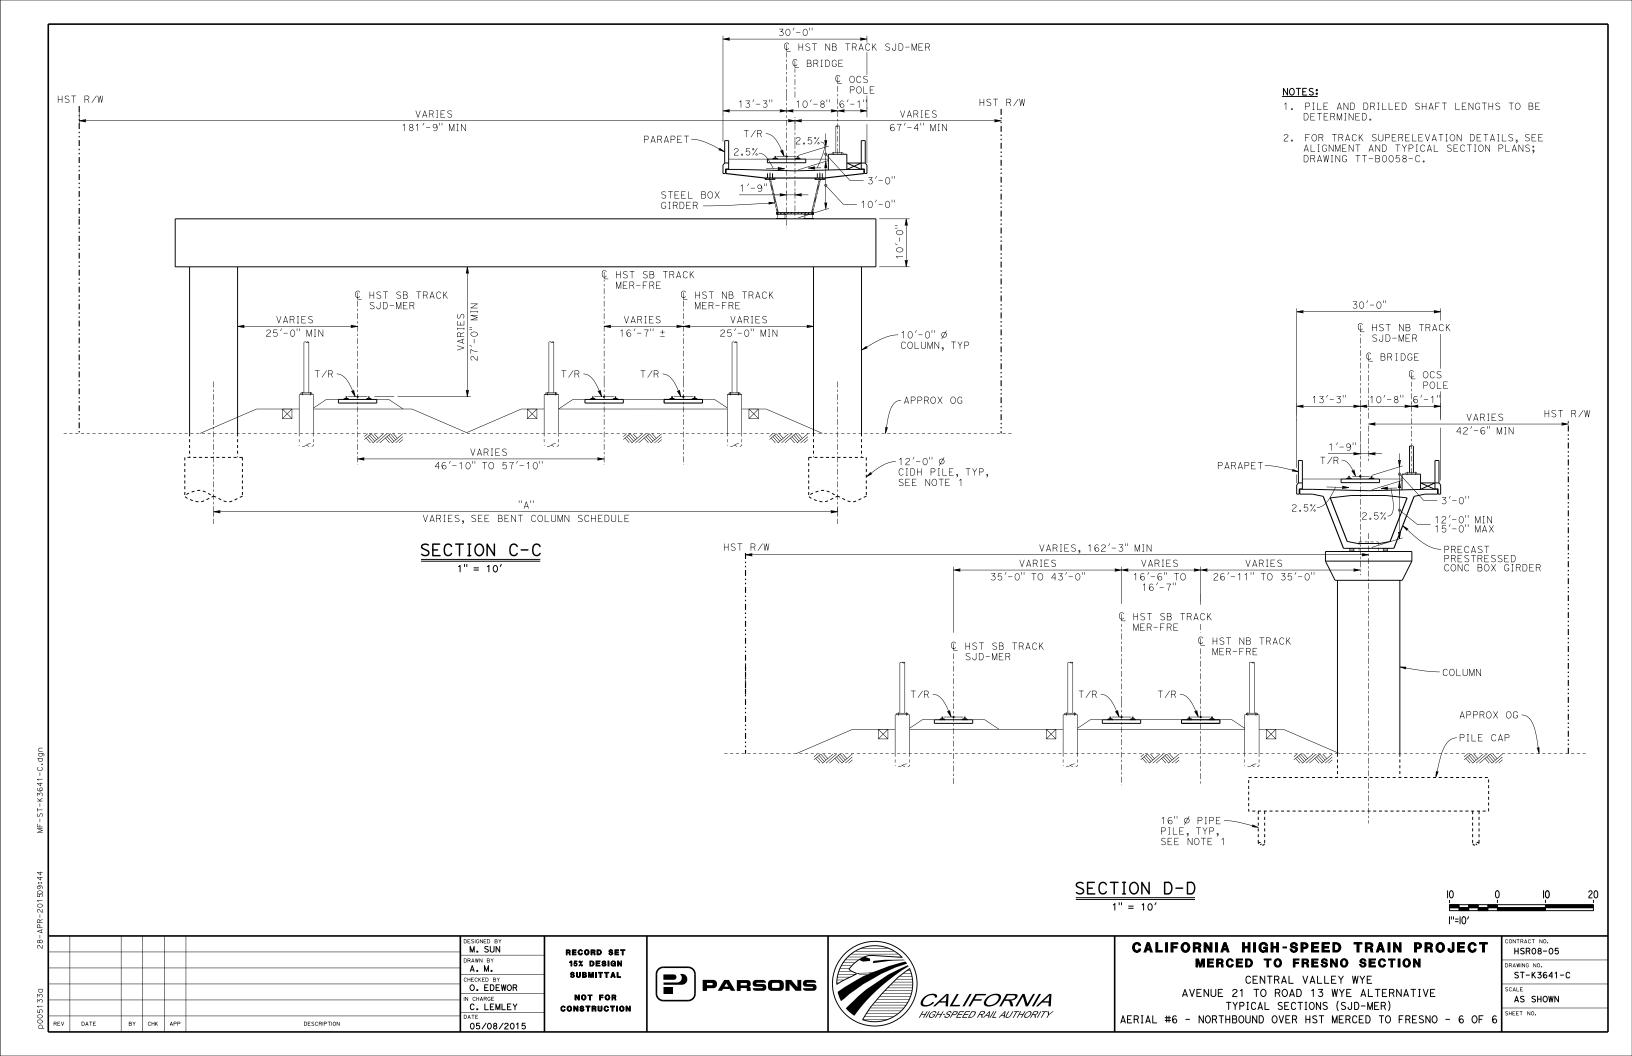


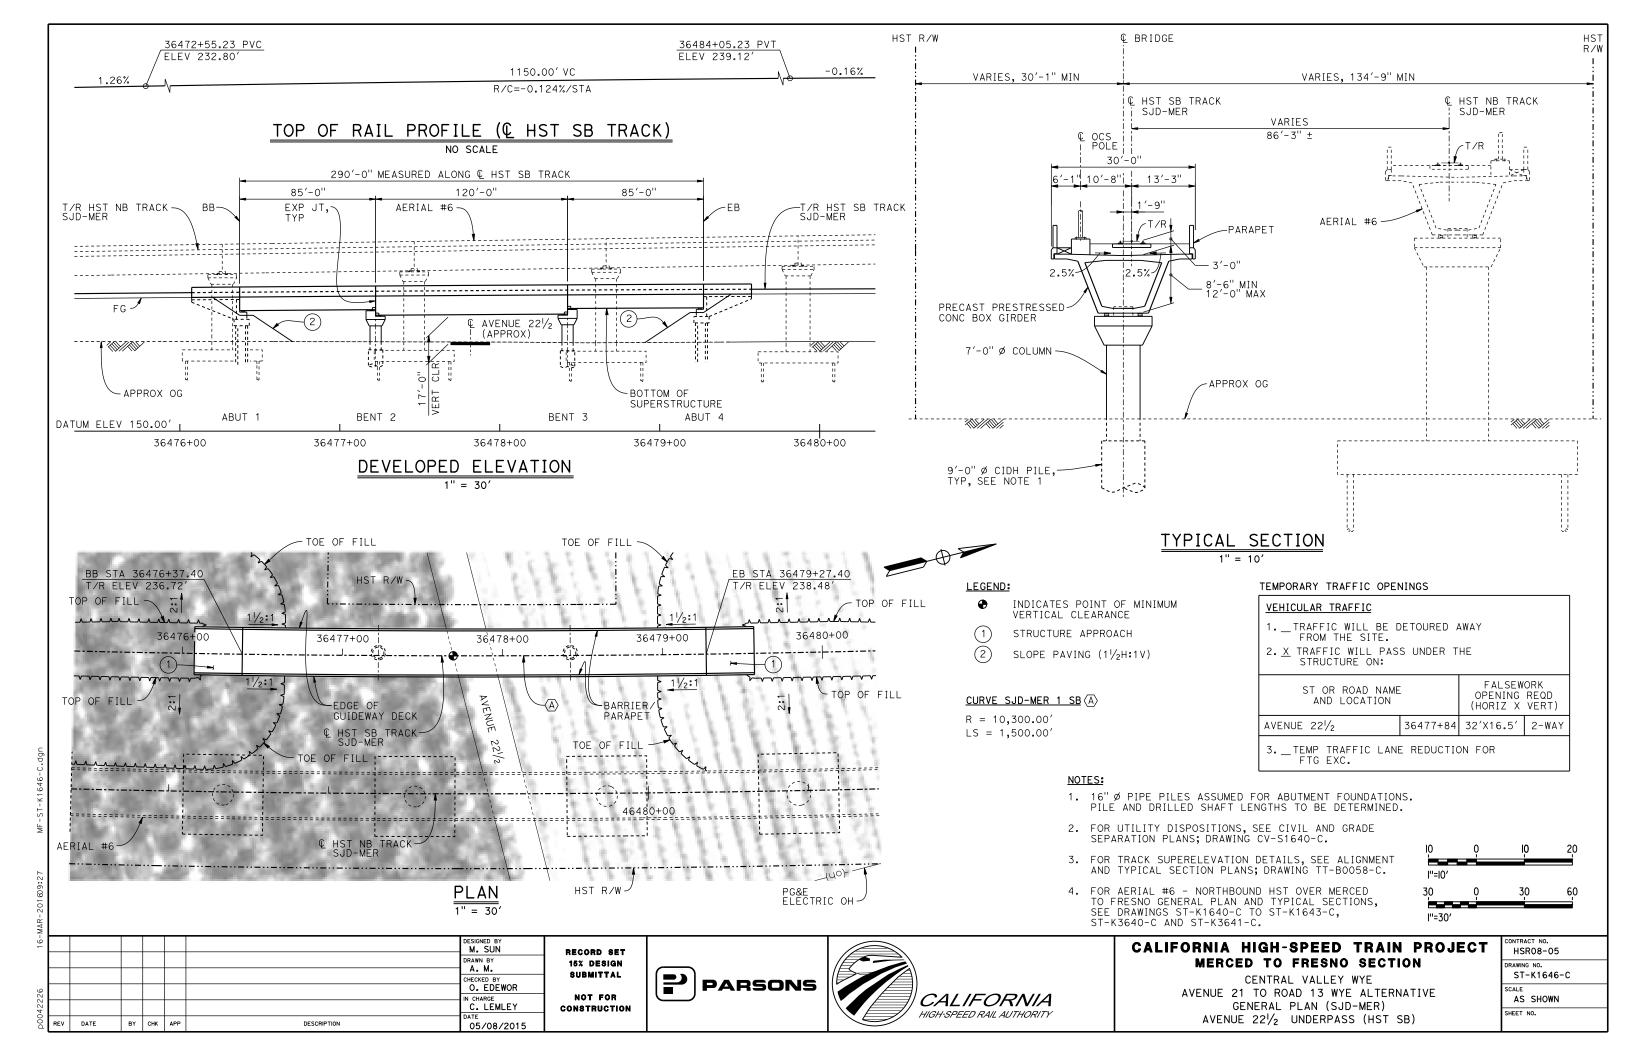

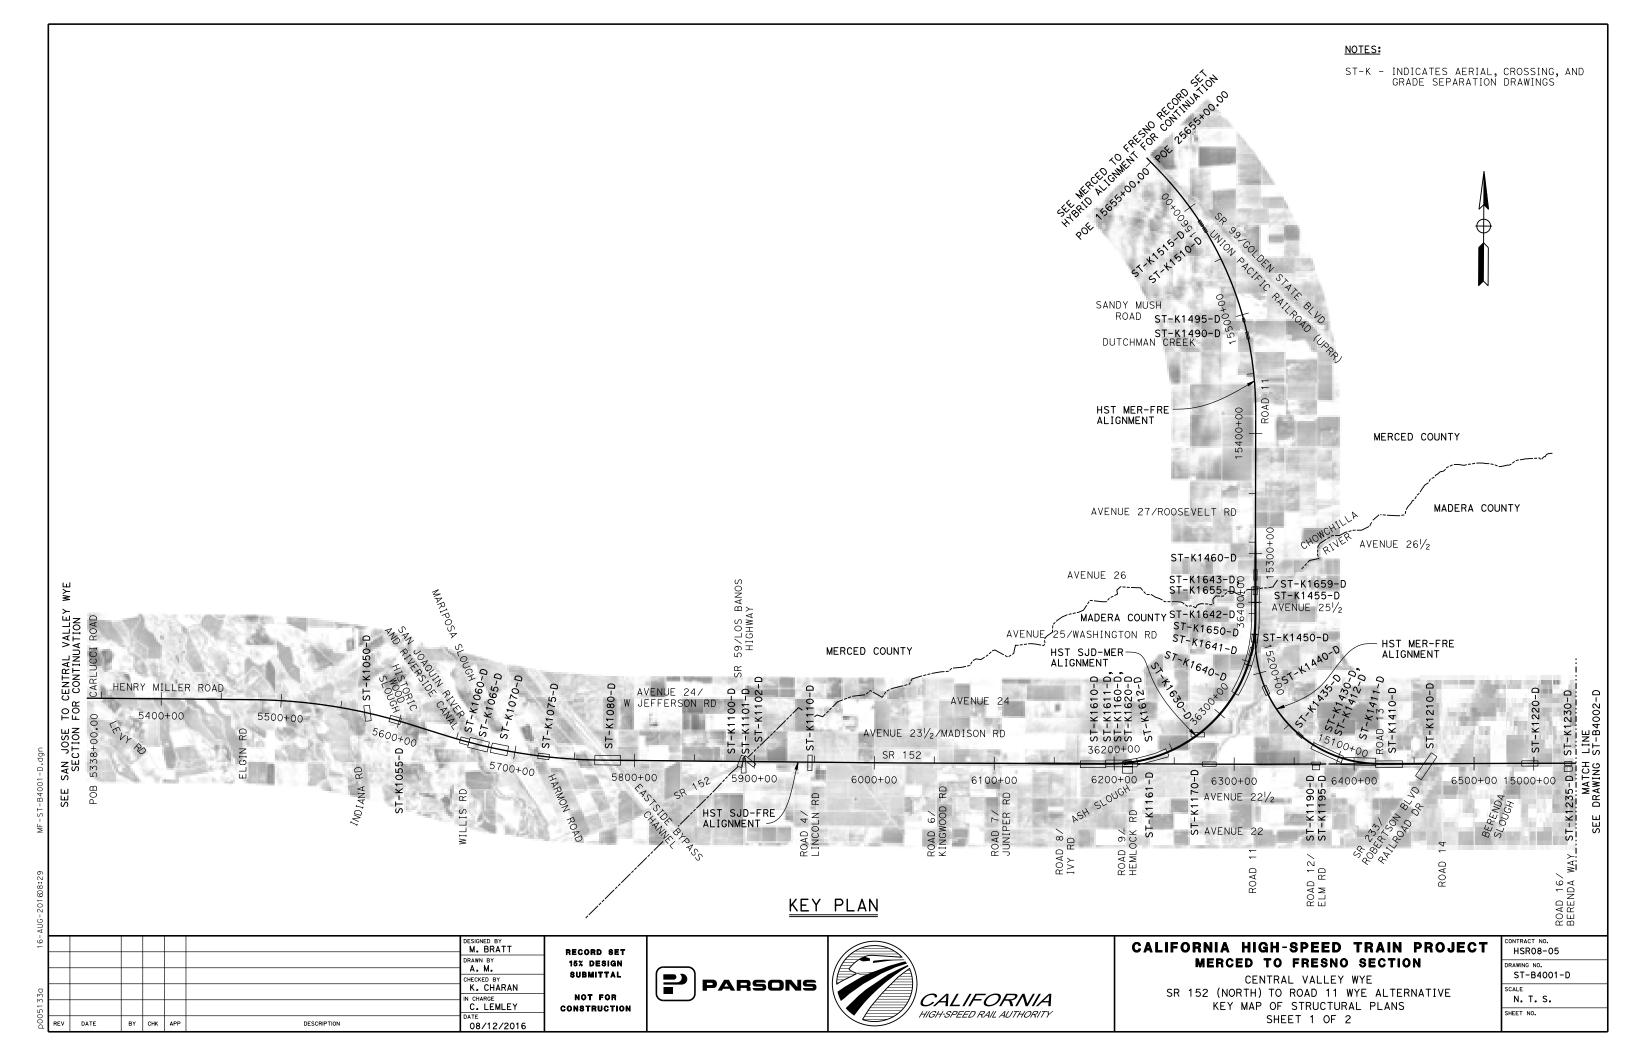

NOTES:

ST-K - INDICATES AERIAL, CROSSING, AND GRADE SEPARATION DRAWINGS

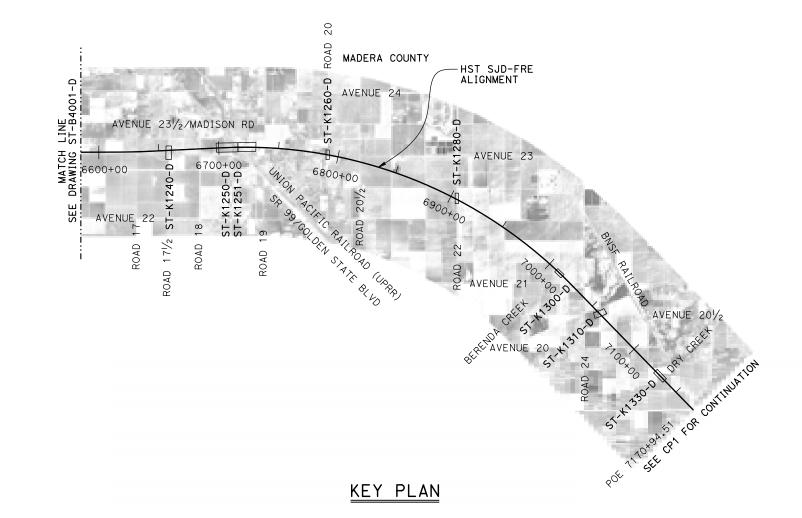

₹								
15-							DESIGNED BY M. BRATT	
							DRAWN BY	
							CHECKED BY	
330							K. CHARAN IN CHARGE	
p0051							C. LEMLEY	
õ	REV	DATE	BY	снк	APP	DESCRIPTION	08/12/2016	

RECORD SET 15% DESIGN SUBMITTAL NOT FOR CONSTRUCTION







CALIFORNIA HIGH-SPEED TRAIN PROJECT MERCED TO FRESNO SECTION

CENTRAL VALLEY WYE SR 152 (NORTH) TO ROAD 11 WYE ALTERNATIVE KEY MAP OF STRUCTURAL PLANS SHEET 2 OF 2

CONTRACT NO.						
HSR08-05						
DRAWING NO.						
ST-B4002-D						
SCALE						
N. T. S.						

SHEET NO.

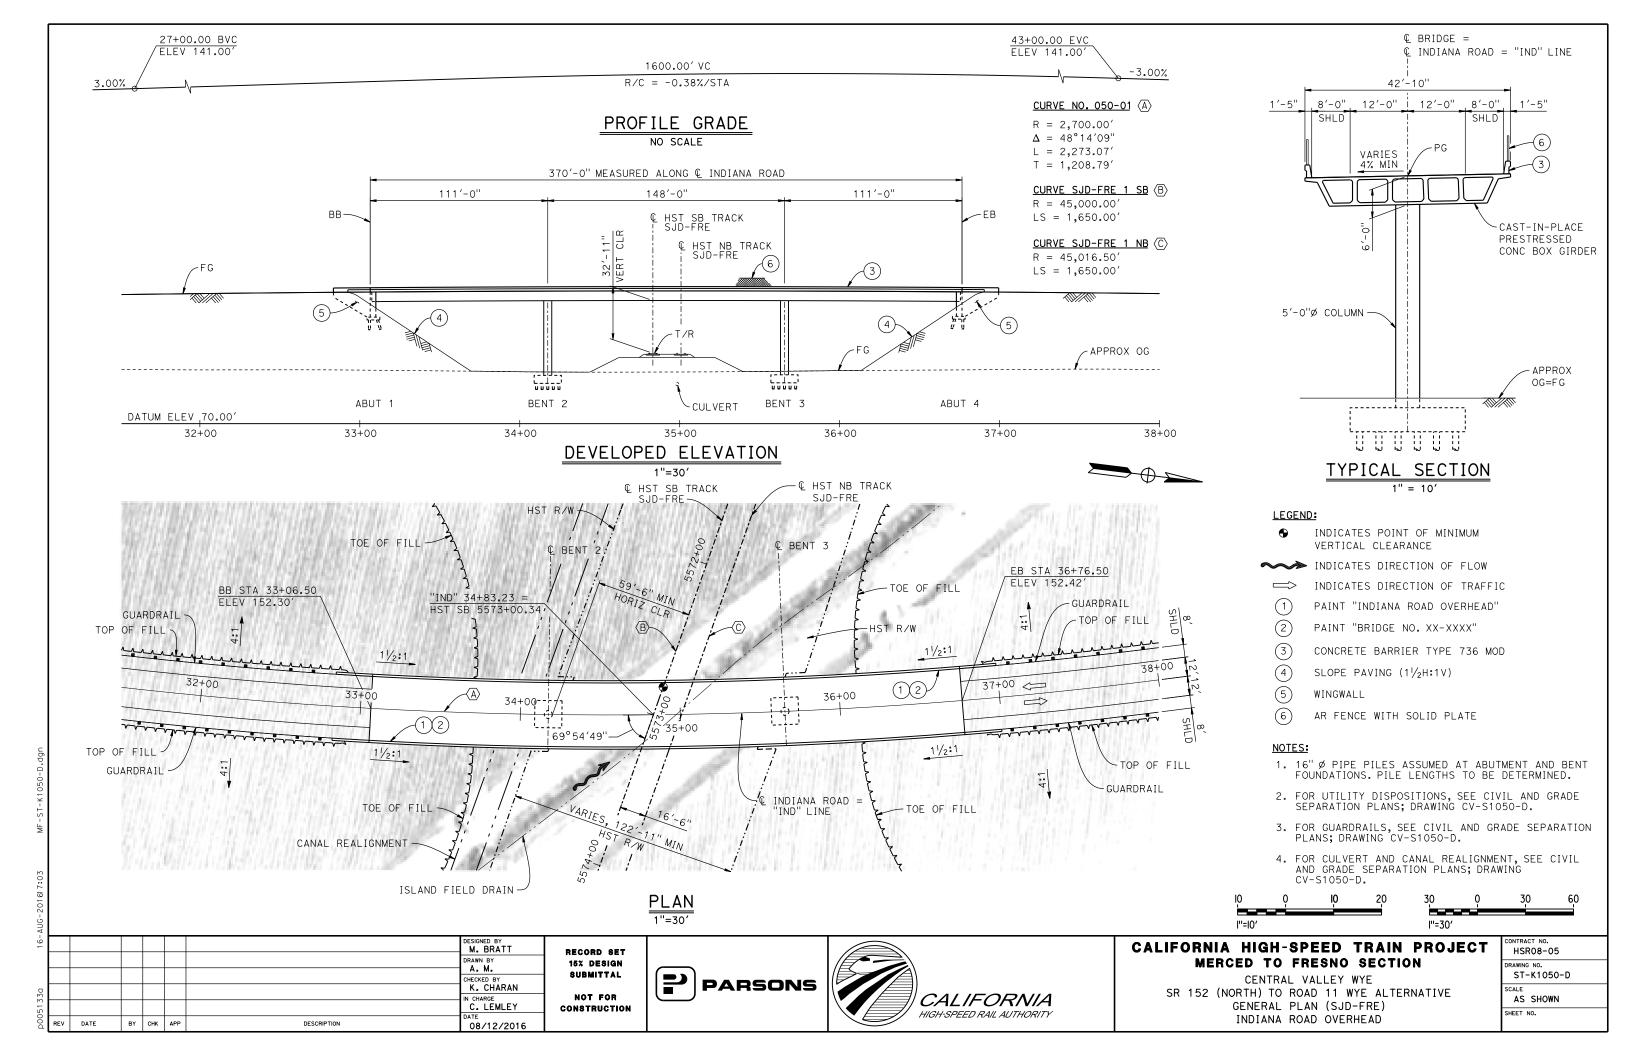

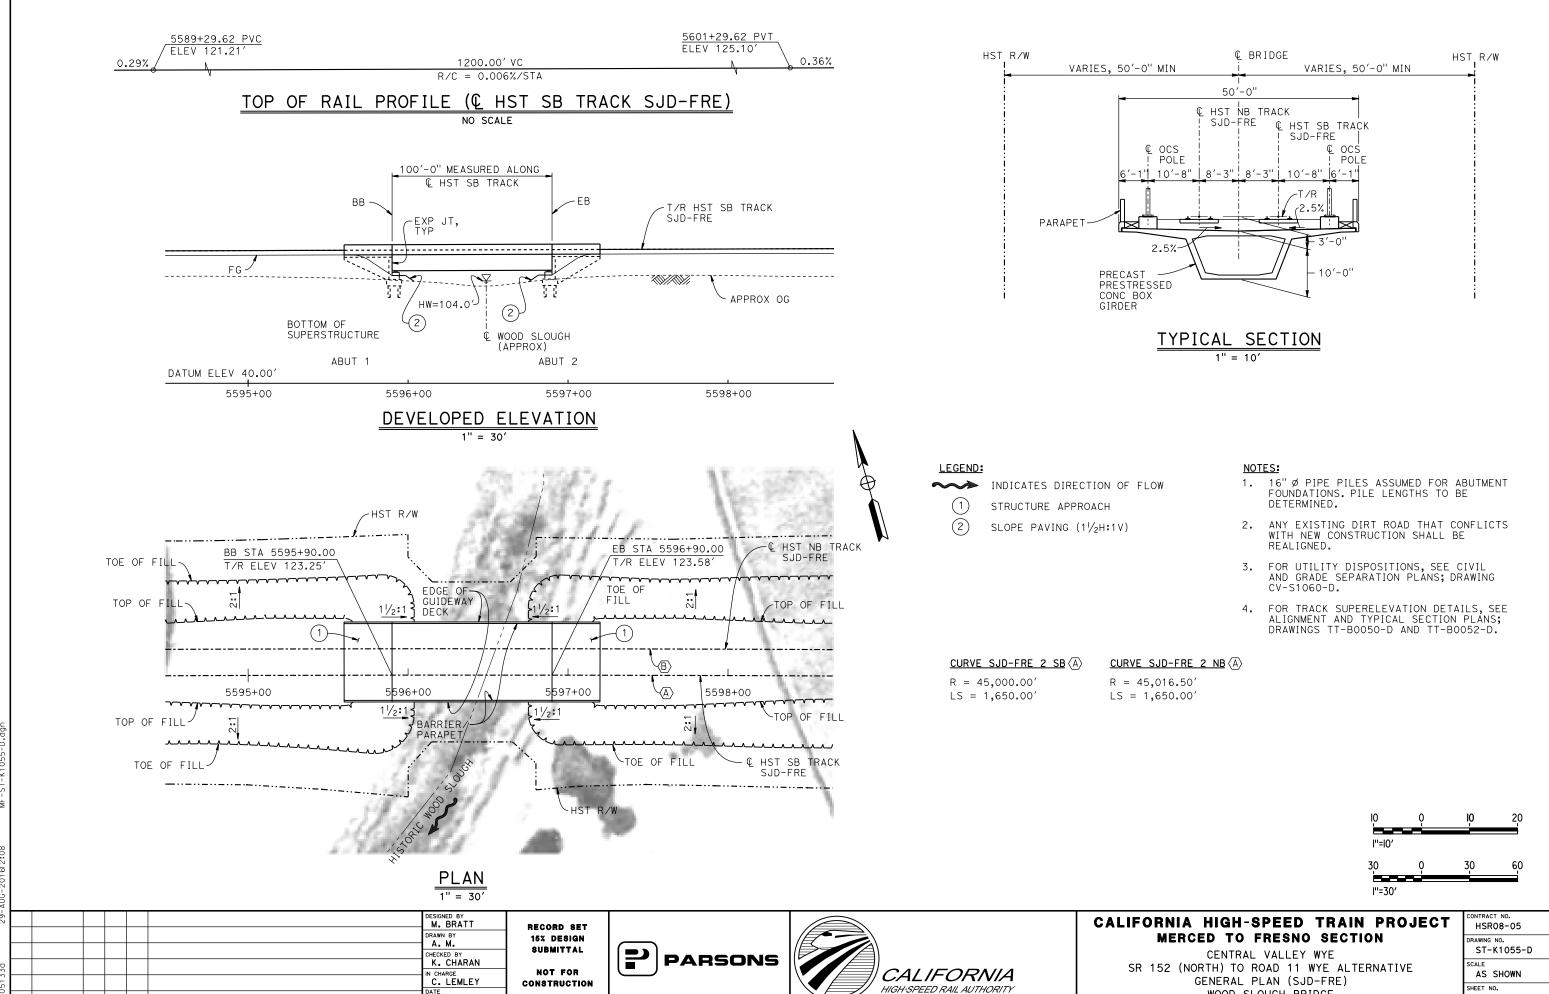

DATE


BY CHK APP


DESCRIPTION

09/02/2016

SHEET NO.

WOOD SLOUGH BRIDGE

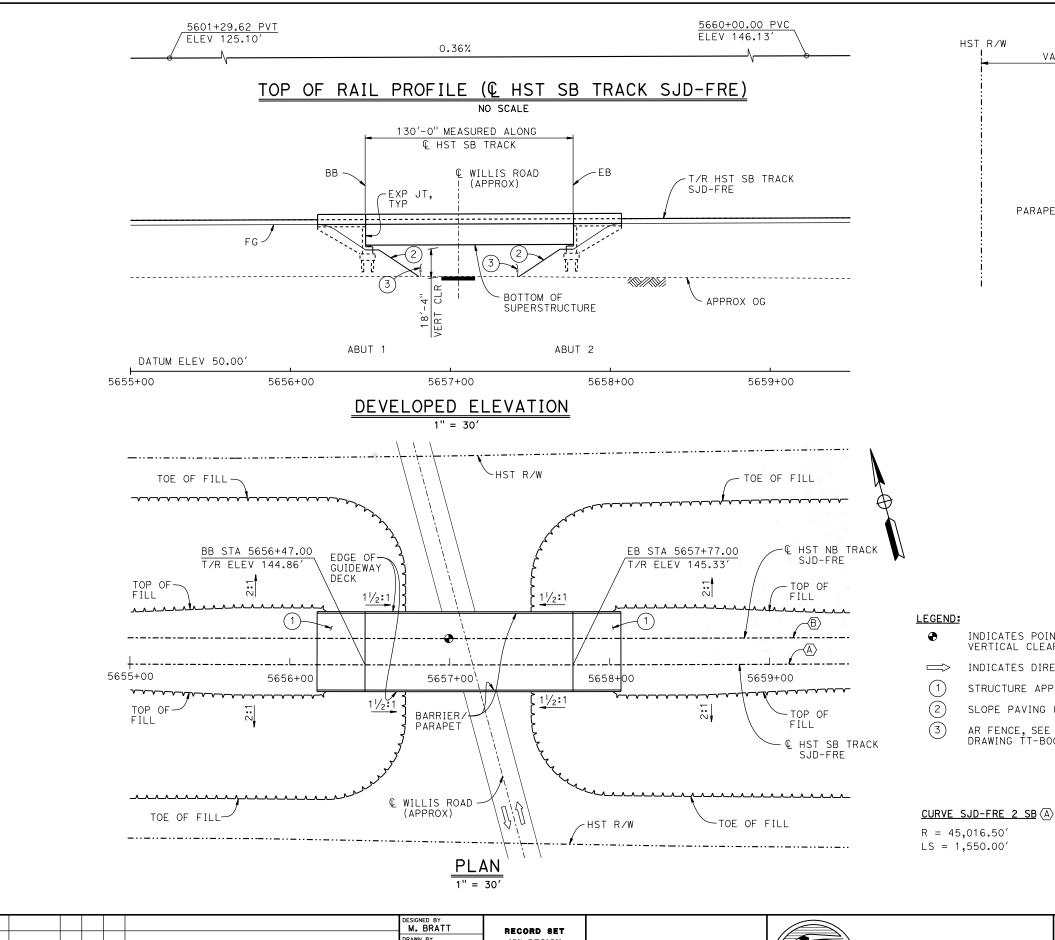

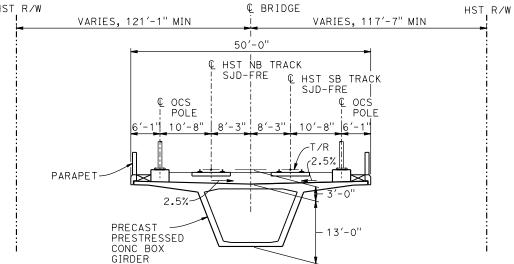

TYPICAL SECTION

TEMPORARY TRAFFIC OPENINGS


VEHICULAR TRAFFIC							
1 TRAFFIC WILL BE DETOURED AWAY FROM THE SITE.							
	2. X TRAFFIC WILL PASS UNDER THE STRUCTURE ON:						
ST OR ROAD AND LOCAT	FALSEW OPENING (HORIZ X	REQD					
WILLIS ROAD	5657+14	32′X16.5′	2-WAY				
3TEMP TRAFFIC LANE REDUCTION FOR FTG EXC.							

- INDICATES POINT OF MINIMUM VERTICAL CLEARANCE
- INDICATES DIRECTION OF TRAFFIC
- STRUCTURE APPROACH
- SLOPE PAVING $(1\frac{1}{2}H:1V)$
- AR FENCE, SEE TRACK PLANS; DRAWING TT-B0020-D

- 16" Ø PIPE PILES ASSUMED FOR ABUTMENT FOUNDATIONS. PILE LENGTHS TO BE DETERMINED.
- 2. ANY EXISTING DIRT ROAD THAT CONFLICTS WITH NEW CONSTRUCTION SHALL BE REALIGNED.
- 3. FOR UTILITY DISPOSITIONS, SEE CIVIL AND GRADE SEPARATION PLANS; DRAWING CV-S1060-D.
- 4. FOR TRACK SUPERELEVATION, SEE ALIGNMENT AND TYPICAL SECTION PLANS; DRAWINGS TT-B0050-D AND TT-B0052-D.

CURVE SJD-FRE 2 NB (B)

R = 45,000.00'LS = 1,550.00

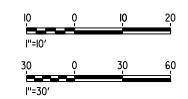

DRAWN BY K. CHARAN C. LEMLEY

DESCRIPTION

DATE

BY CHK APP

15% DESIGN SUBMITTAL NOT FOR CONSTRUCTION

08/12/2016







CALIFORNIA HIGH-SPEED TRAIN PROJECT MERCED TO FRESNO SECTION

CENTRAL VALLEY WYE SR 152 (NORTH) TO ROAD 11 WYE ALTERNATIVE GENERAL PLAN (SJD-FRE) WILLIS ROAD UNDERPASS

CONTRACT NO. HSR08-05
DRAWING NO. ST-K1060-D
AS SHOWN
SHEET NO.

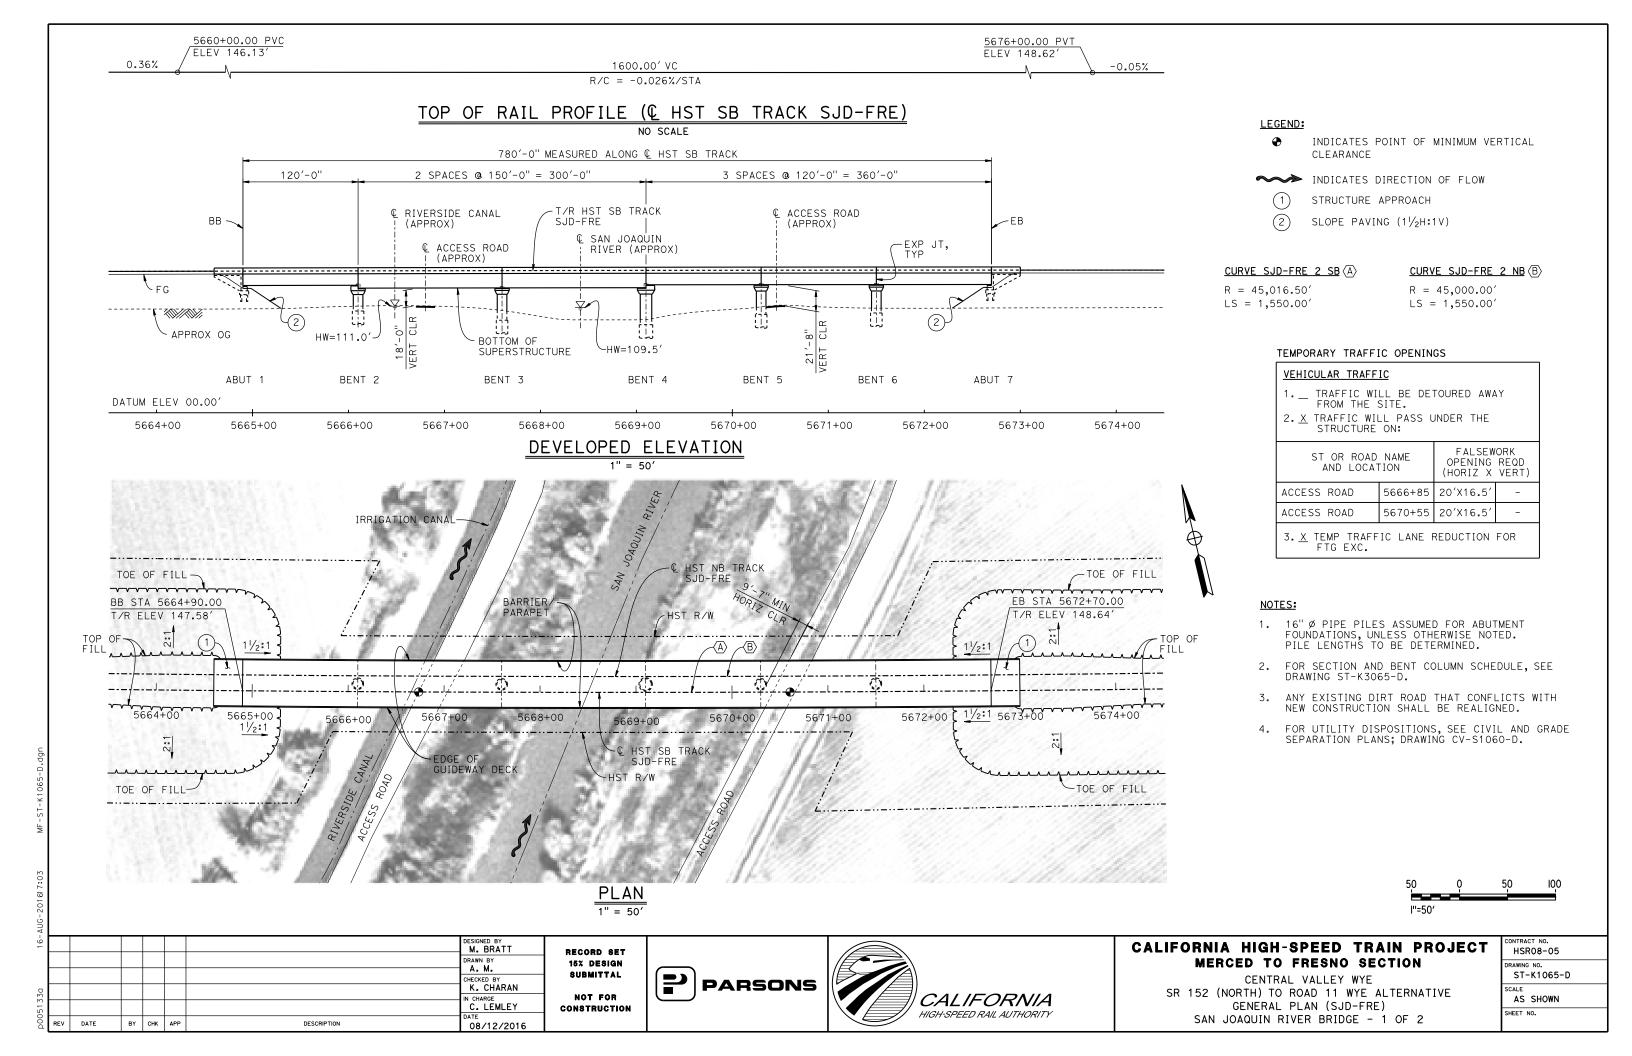

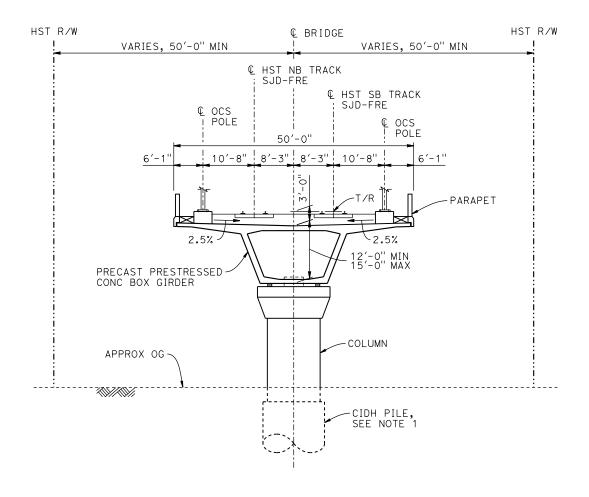

TYPICAL SECTION

		BENT COLUMN SCHED	ULE
	BENT	COLUMN TYPE	CIDH
	2	13′-0" ø	15'-0" Ø
	3	14'-0" Ø	16'-0" Ø
	4	13'-0" Ø	15'-0" Ø
	5 - 6	11'-0" Ø	13'-0" Ø

NOTES:

- 1. PILE AND DRILLED SHAFT LENGTHS TO BE DETERMINED.
- 2. FOR TRACK SUPERELEVATION DETAILS, SEE ALIGNMENT AND TYPICAL SECTION PLANS; DRAWING TT-B0050-D AND TT-B0052-D.



ΑŬ								
15-							DESIGNED BY M. BRATT	
							DRAWN BY A. M.	
_							CHECKED BY K. CHARAN	
5133a							IN CHARGE C. LEMLEY	C.
00d	REV	DATE	BY	снк	APP	DESCRIPTION	DATE 08/12/2016	

RECORD SET
15% DESIGN
SUBMITTAL
NOT FOR
CONSTRUCTION








CALIFORNIA HIGH-SPEED TRAIN PROJECT MERCED TO FRESNO SECTION


CENTRAL VALLEY WYE
SR 152 (NORTH) TO ROAD 11 WYE ALTERNATIVE
TYPICAL SECTION (SJD-FRE)
SAN JOAQUIN RIVER BRIDGE - 2 OF 2

CONTRACT NO.
HSR08-05
DRAWING NO.
ST-K3065-D
SCALE
AS SHOWN
SHEET NO.

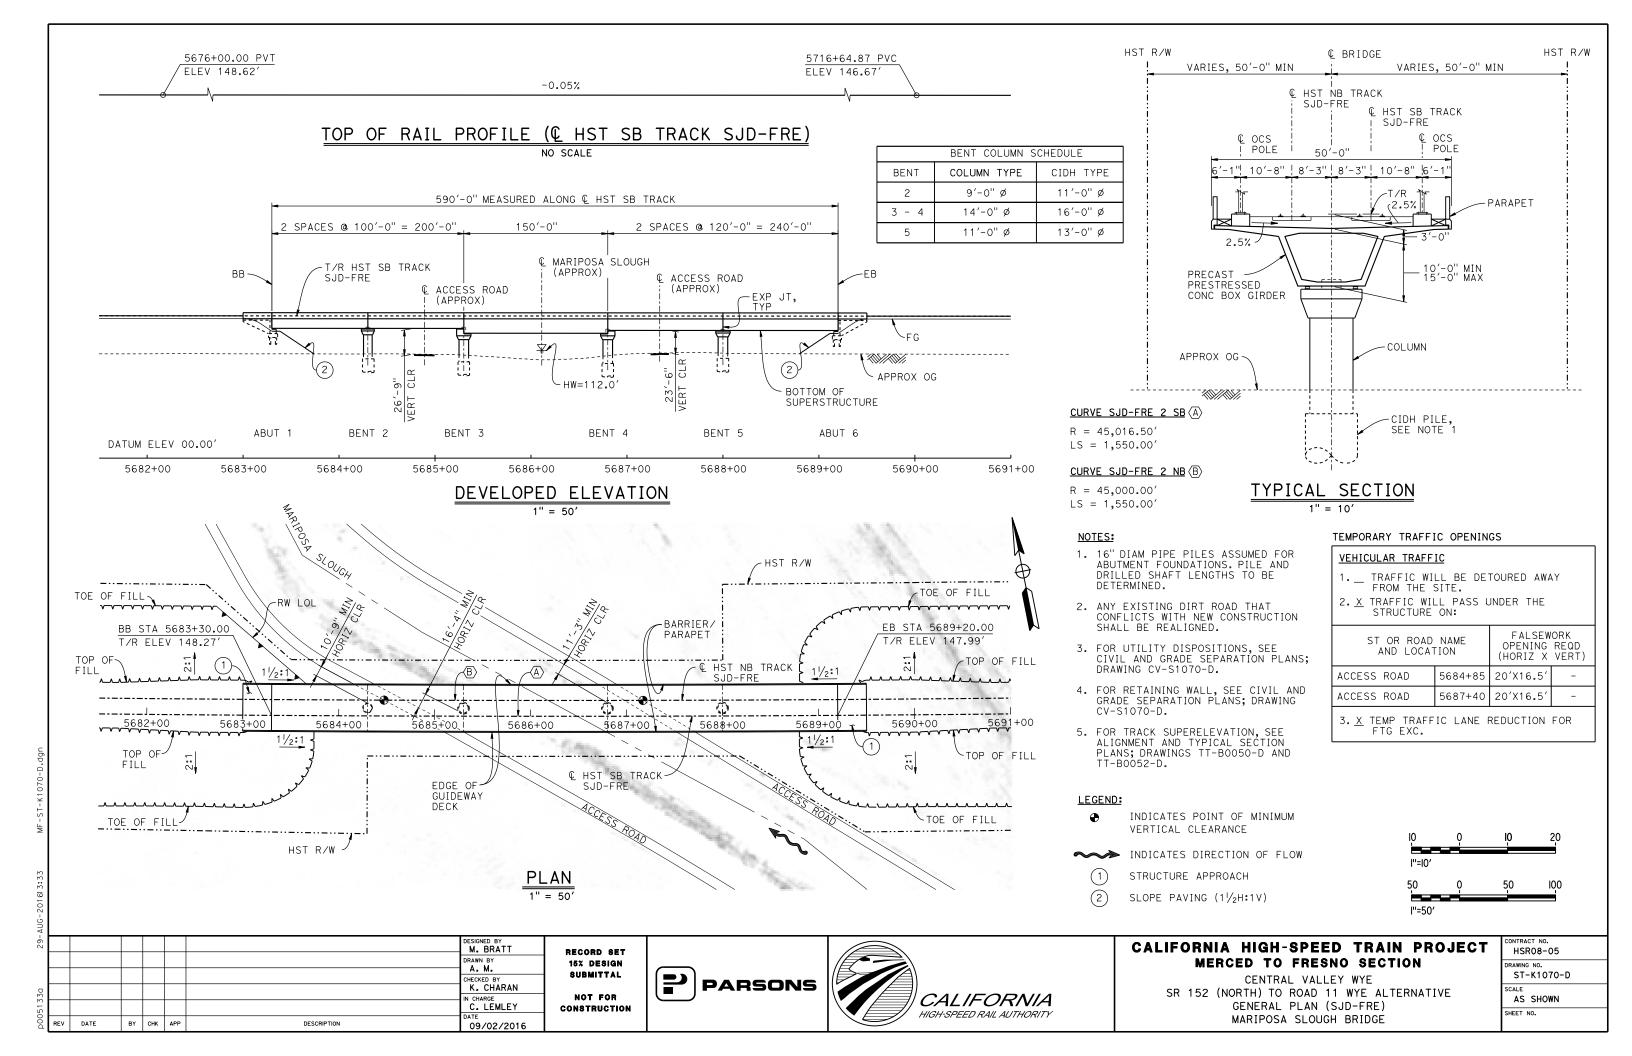

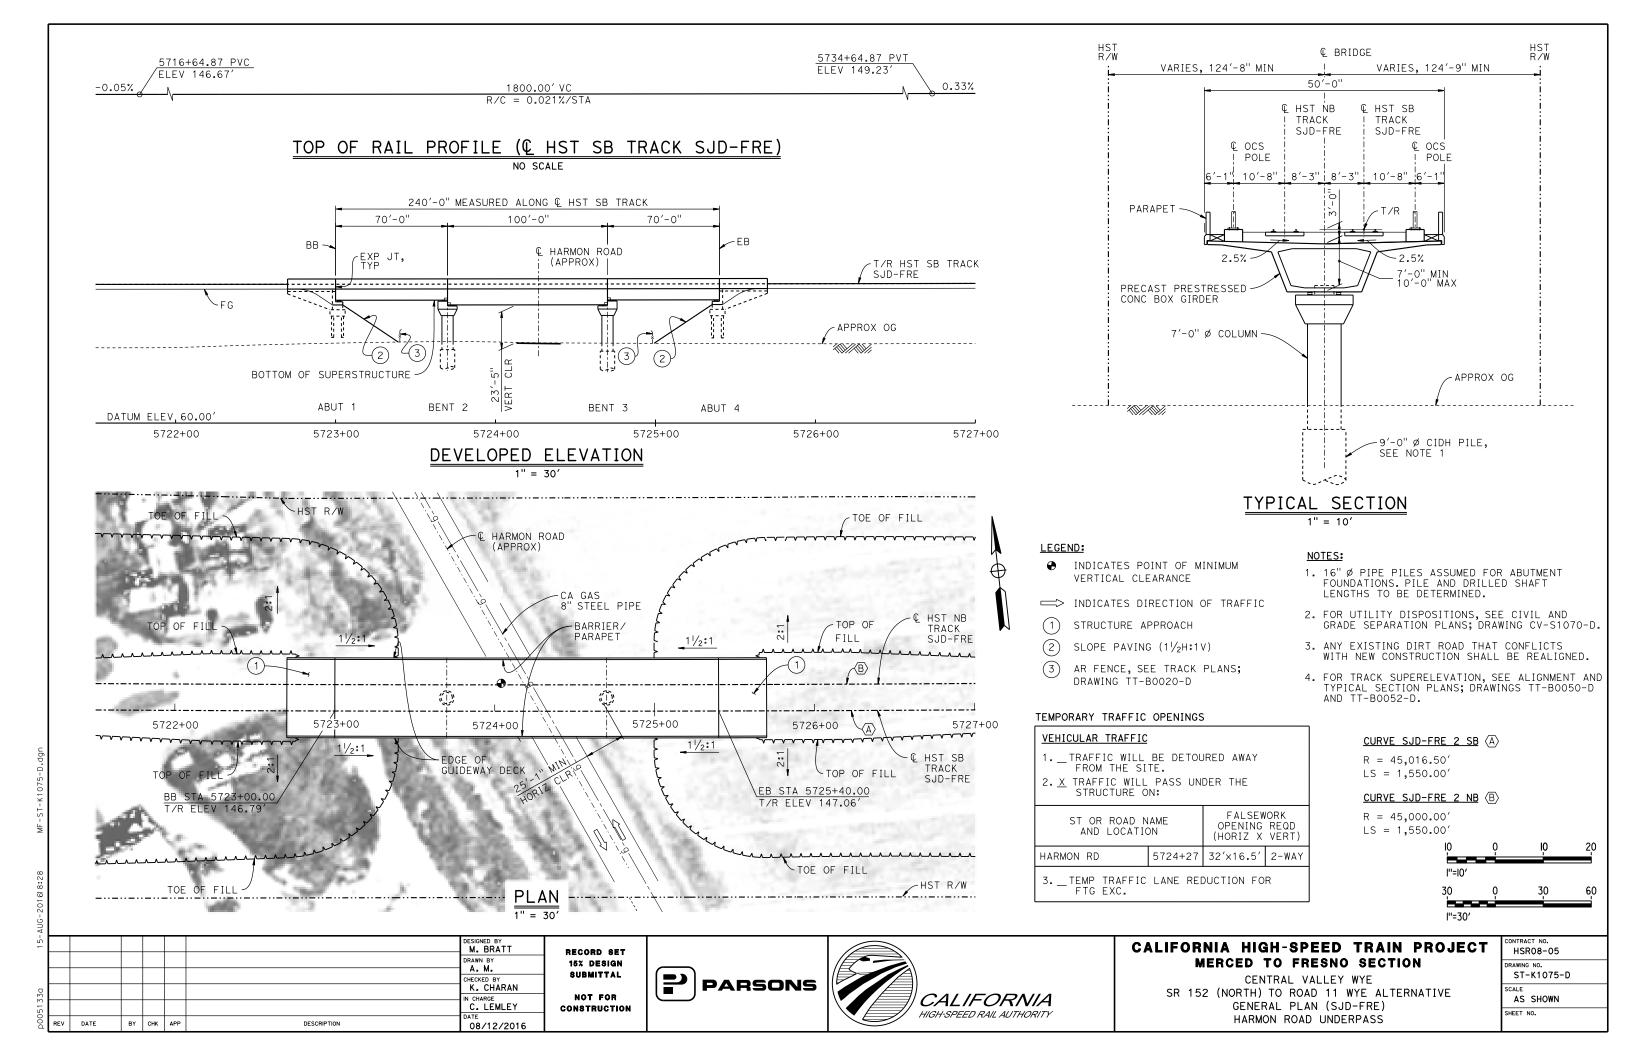

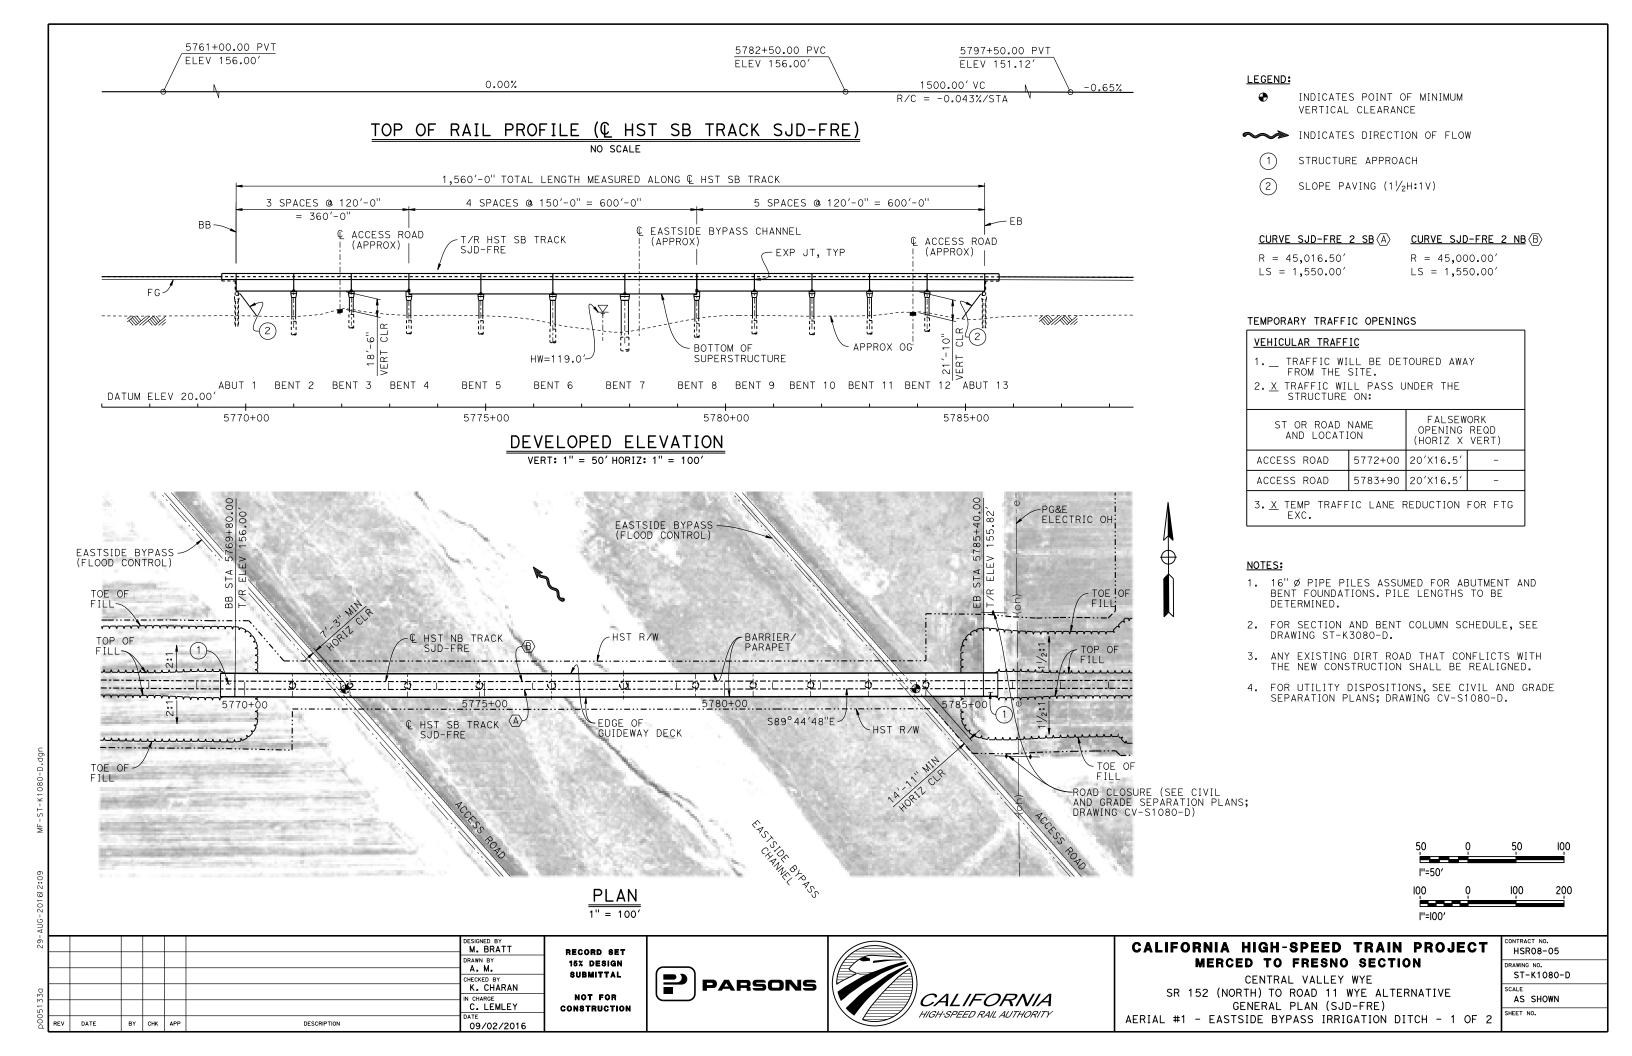

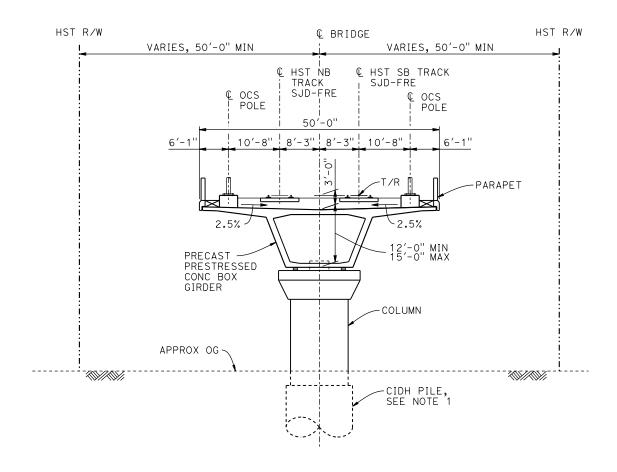

TYPICAL SECTION
1" = 10'

	ULE	
BENT	COLUMN TYPE	CIDH
2	10'-0" Ø	12'-0" Ø
3	9'-0" ø	11'-0" Ø
4-5	10'-0" Ø	12'-0" Ø
6	11'-0" Ø	13'-0" Ø
7	13'-0" Ø	15'-0" Ø
8-10	10'-0" Ø	12'-0" Ø
11-12	9'-0" ø	11'-0" Ø

NOTES:

- 1. PILE LENGTHS TO BE DETERMINED.
- 2. FOR TRACK SUPERELEVATION DETAILS, SEE ALIGNMENT AND TYPICAL SECTION PLANS; DRAWINGS TT-B0050-D AND TT-B0052-D.



AUC								
15-							DESIGNED BY M. BRATT	Ι,
							DRAWN BY A. M.	i '
							CHECKED BY	1
33a							K. CHARAN IN CHARGE	ł
051							C. LEMLEY	c
р0	REV	DATE	BY	СНК	APP	DESCRIPTION	08/12/2016	

RECORD SET
15% DESIGN
SUBMITTAL
NOT FOR
CONSTRUCTION





CALIFORNIA HIGH-SPEED TRAIN PROJECT MERCED TO FRESNO SECTION


CENTRAL VALLEY WYE


SR 152 (NORTH) TO ROAD 11 WYE ALTERNATIVE


TYPICAL SECTION (SJD-FRE)

AERIAL #1 - EASTSIDE BYPASS IRRIGATION DITCH - 2 OF 2

	CONTRACT NO.
	HSR08-05
	DRAWING NO.
	ST-K3080-D
	SCALE
	AS SHOWN
2	SHEET NO.

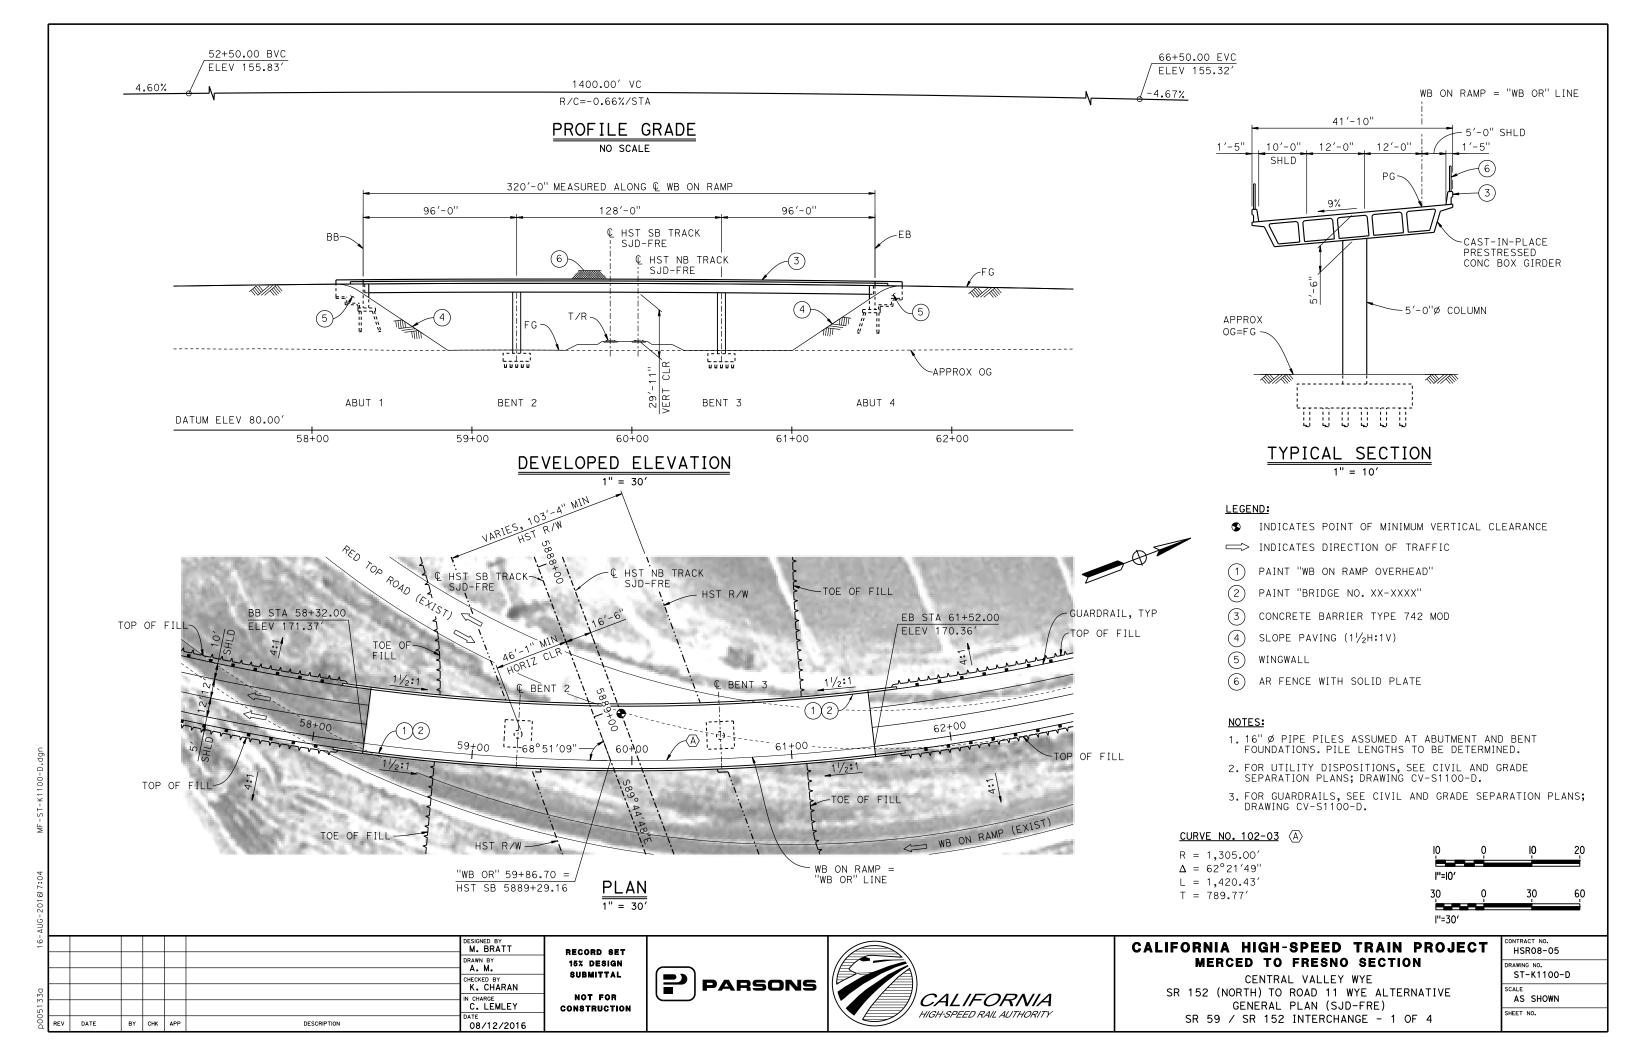

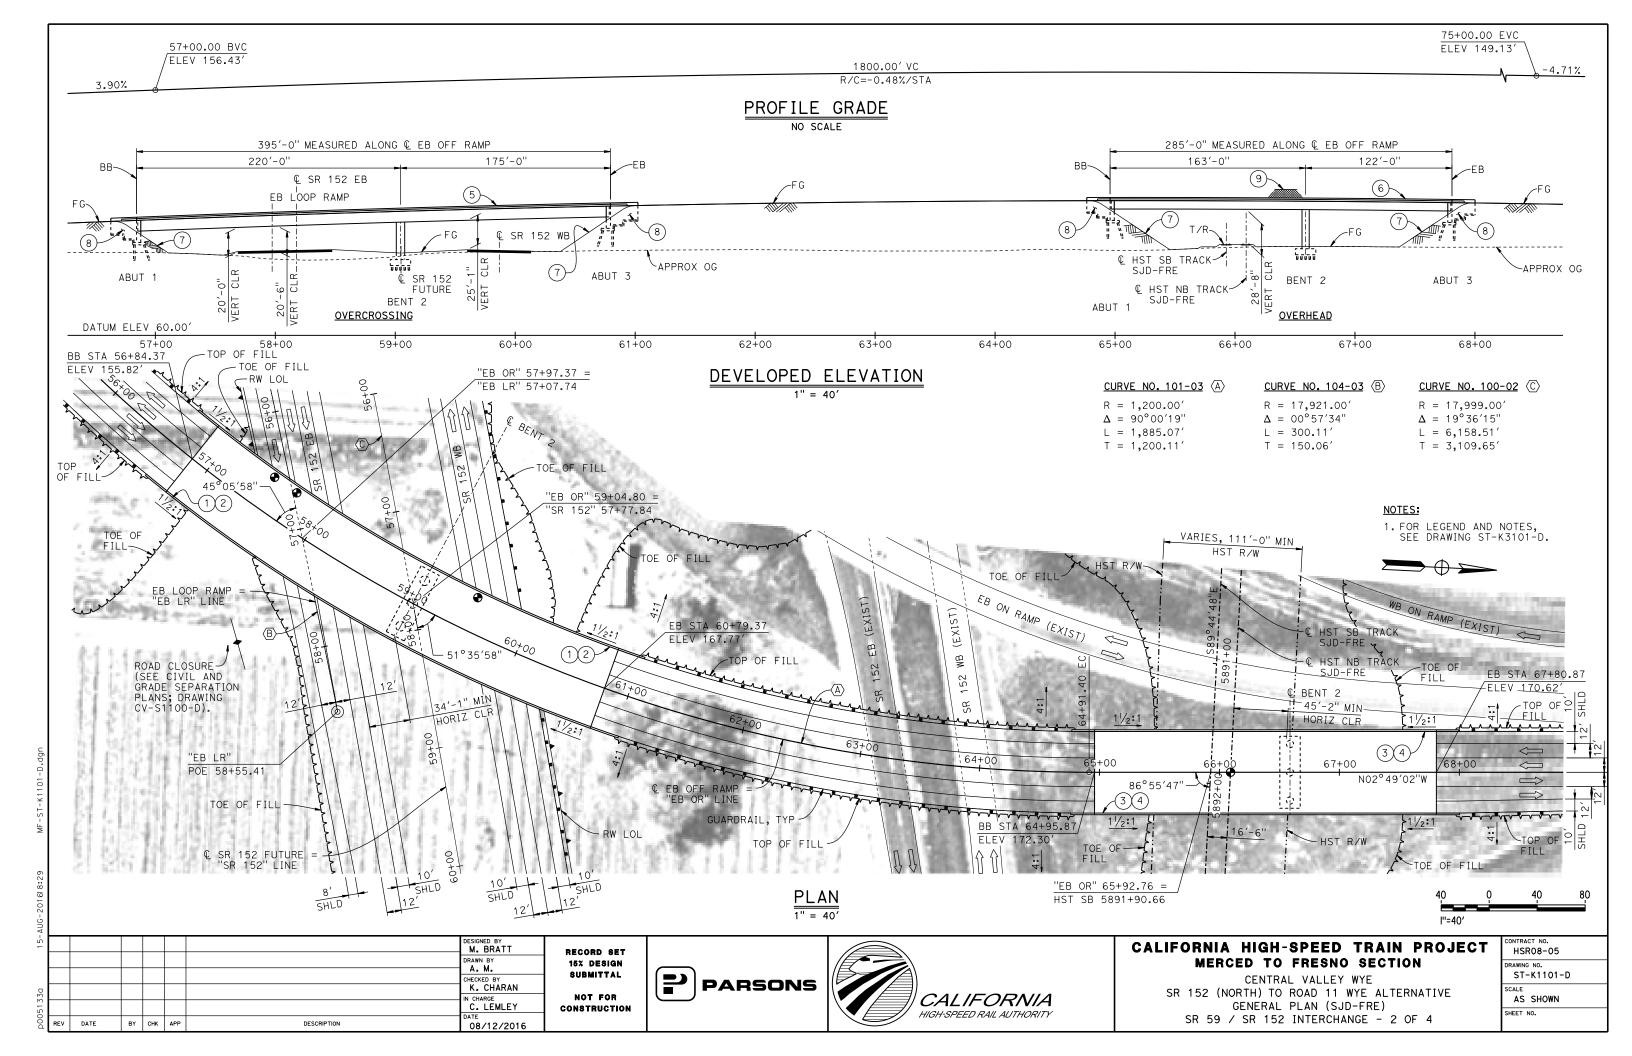

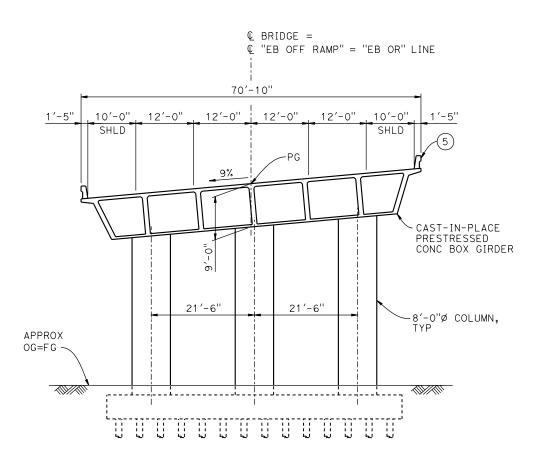


TYPICAL SECTION AT OVERCROSSING

TEMPORARY TRAFFIC OPENINGS

VEHICULAR TRAFFIC							
1 TRAFFIC WILL BE DETOURED AWAY FROM THE SITE. 2. X TRAFFIC WILL PASS UNDER THE STRUCTURE ON:							
ST OR ROAD N AND LOCATIO	FALSEW OPENING (HORIZ X	REQD					
SR 152	57+97	40′X16.5′	E BND				
SR 152	59+88	40′X16.5′	W BND				
3. — TEMP TRAFFIC LANE REDUCTION FOR FTG EXC.							

FGEND:


- ♠ INDICATES POINT OF MINIMUM VERTICAL CLEARANCE
- 1) PAINT "EB OFF RAMP OVERCROSSING"
- (2) PAINT "BRIDGE NO. XX-XXXX"
- (3) PAINT "EB OFF RAMP OVERHEAD"
- 4 PAINT "BRIDGE NO. XX-XXXX"
- (5) CONCRETE BARRIER TYPE 742
- (6) CONCRETE BARRIER TYPE 736 MOD
- (7) SLOPE PAVING $(1\frac{1}{2}H:1V)$
- (8) WINGWALL
- (9) AR FENCE WITH SOLID PLATE

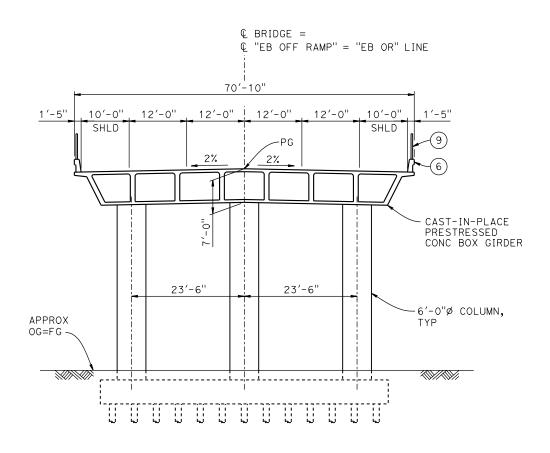

TYPICAL SECTION AT OVERHEAD

NOTES:

- 1. 16" \emptyset PIPE PILES ASSUMED AT ABUTMENT AND BENT FOUNDATIONS. PILE LENGTHS TO BE DETERMINED.
- 2. FOR UTILITY DISPOSITIONS, SEE CIVIL AND GRADE SEPARATION PLANS; DRAWING CV-S1100-D.
- 3. FOR RETAINING WALLS, SEE CIVIL AND GRADE SEPARATION PLANS; DRAWING CV-S1100-D.
- 4. FOR GUARDRAILS, SEE CIVIL AND GRADE SEPARATION PLANS; DRAWING CV-S1100-D.

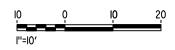

RECORD SET
15% DESIGN
SUBMITTAL
NOT FOR
CONSTRUCTION






CALIFORNIA HIGH-SPEED TRAIN PROJECT MERCED TO FRESNO SECTION


CENTRAL VALLEY WYE

SR 152 (NORTH) TO ROAD 11 WYE ALTERNATIVE
TYPICAL SECTIONS (SJD-FRE)

SR 59 / SR 152 INTERCHANGE - 3 OF 4

CONTRACT NO.							
HSR08-05							
DRAWING NO.							
ST-K3101-D							
SCALE							
AS SHOWN							
SHEET NO.							

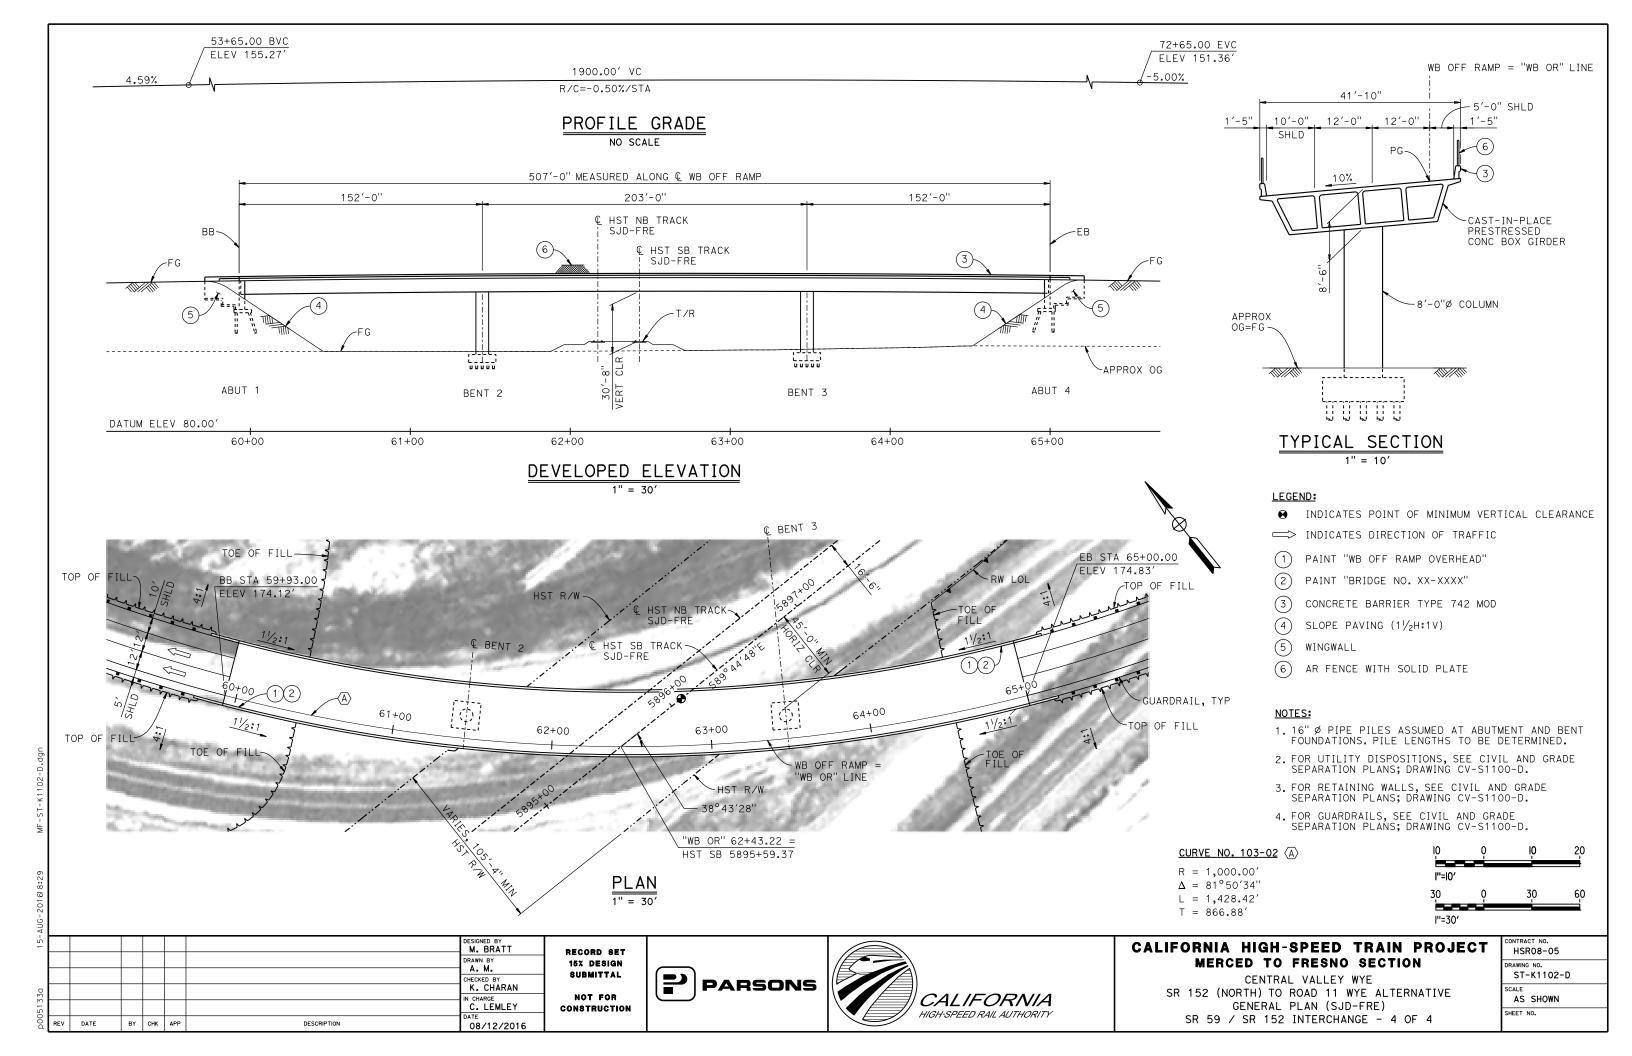

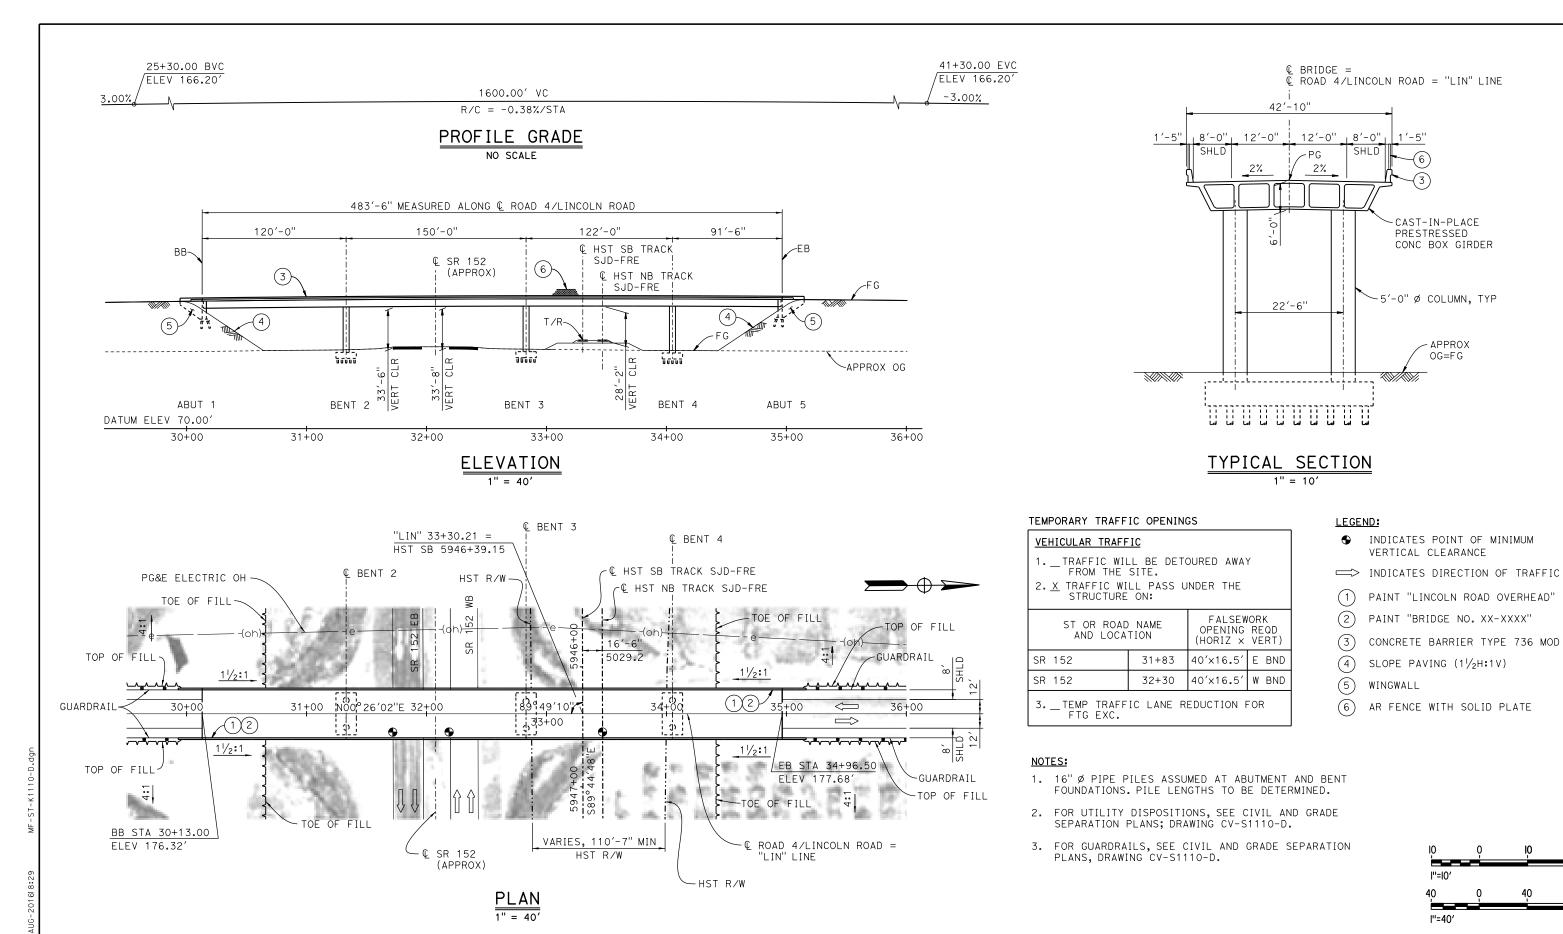

PARSONS

CALIFORNIA

HIGH-SPEED RAIL AUTHORITY

M. BRATT

K. CHARAN

IN CHARGE
C. LEMLEY

08/12/2016

DATE

BY CHK APP

DESCRIPTION

RECORD SET

15% DESIGN Submittal


NOT FOR


CONSTRUCTION


CALIFORNIA HIGH-SPEED TRAIN PROJECT MERCED TO FRESNO SECTION

CENTRAL VALLEY WYE
SR 152 (NORTH) TO ROAD 11 WYE ALTERNATIVE
GENERAL PLAN (SJD-FRE)
LINCOLN ROAD (ROAD 4) OVERHEAD

CONTRACT NO.
HSRO8-05
DRAWING NO.
ST-K1110-D
SCALE
AS SHOWN
SHEET NO.

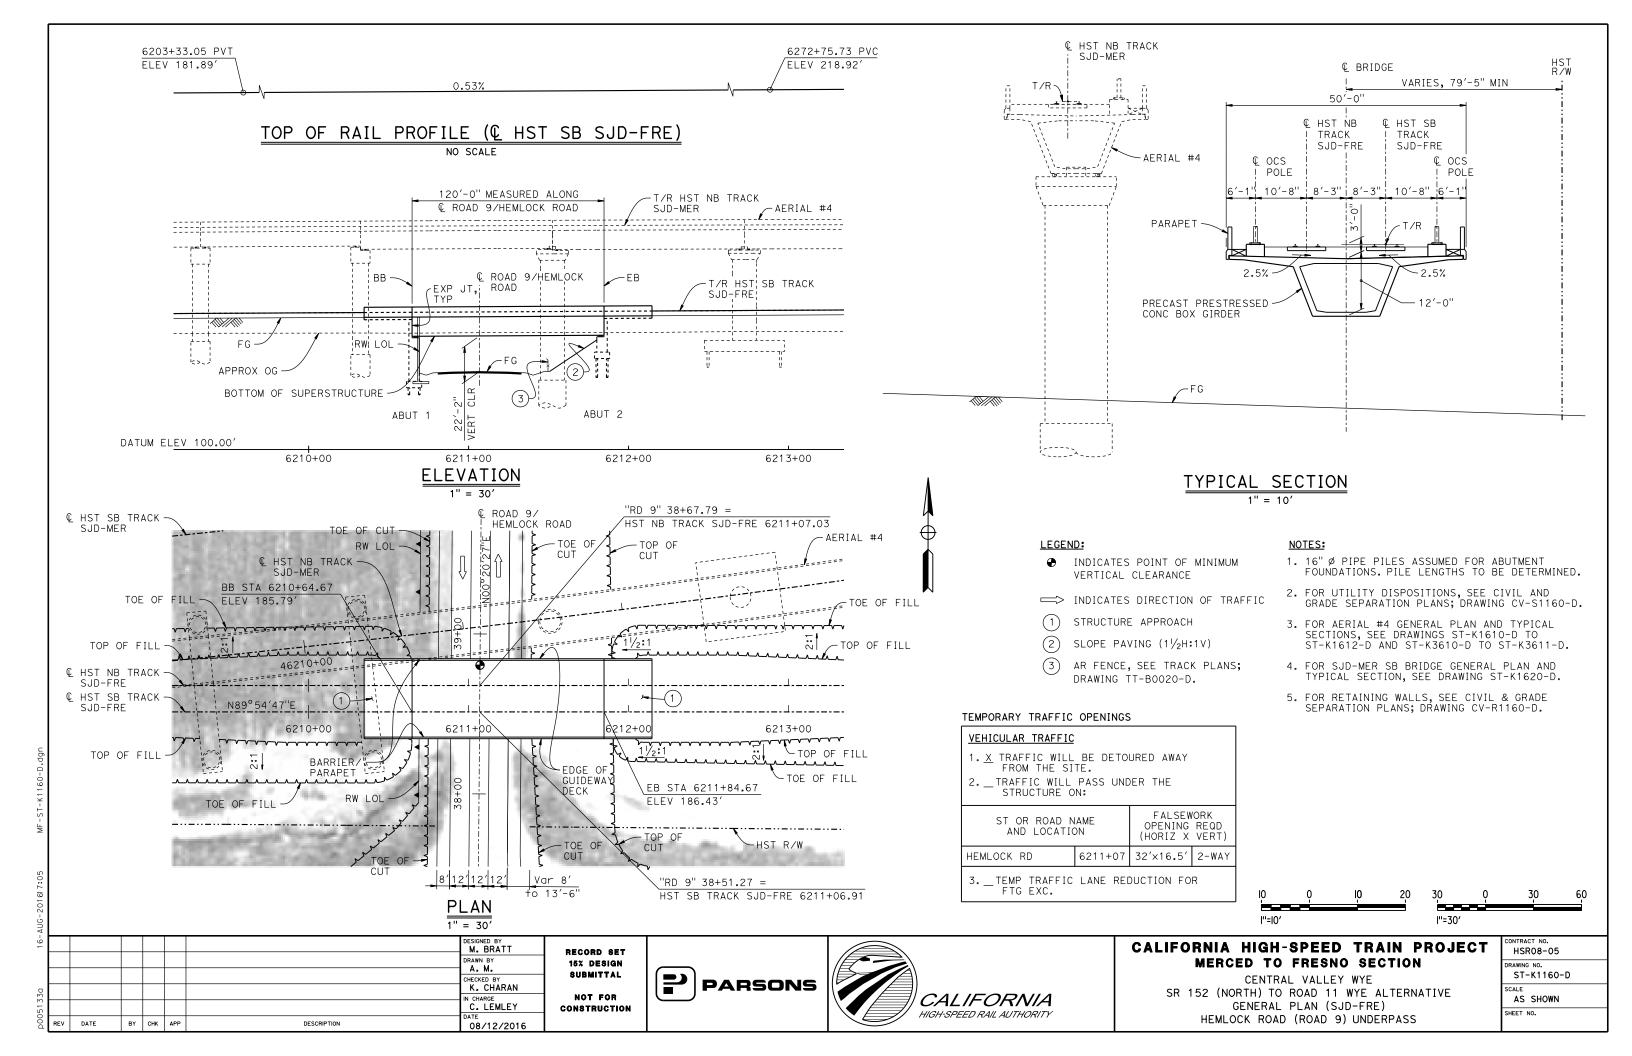

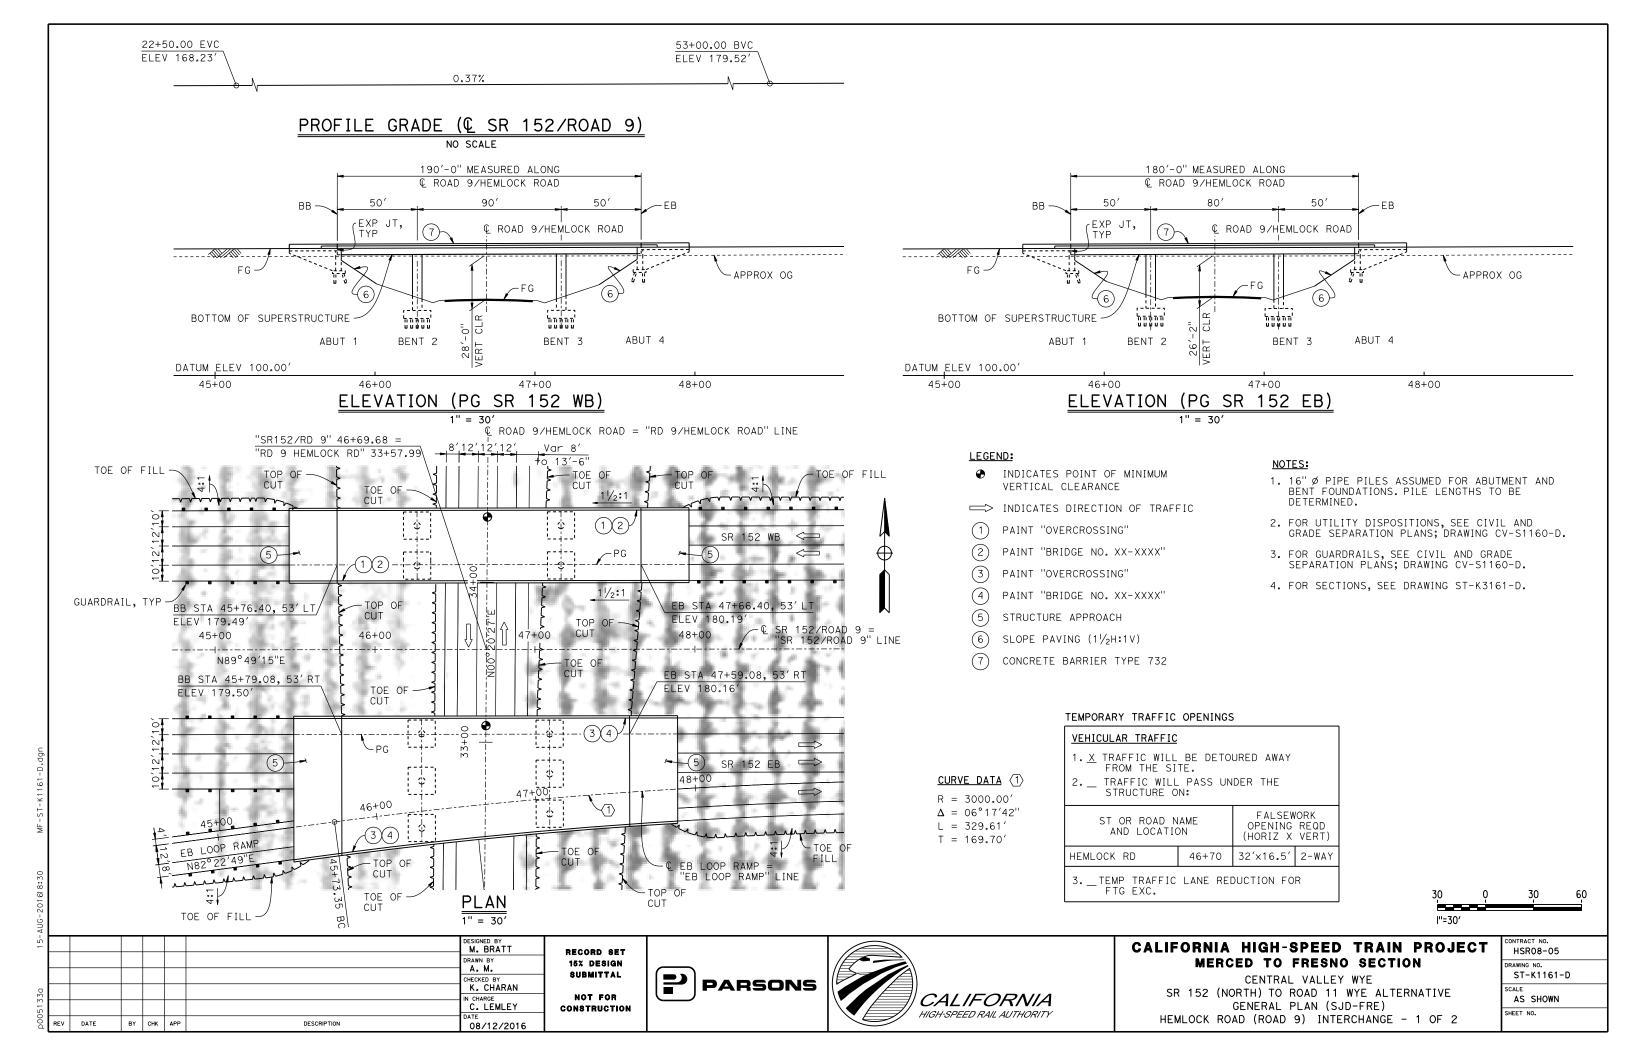

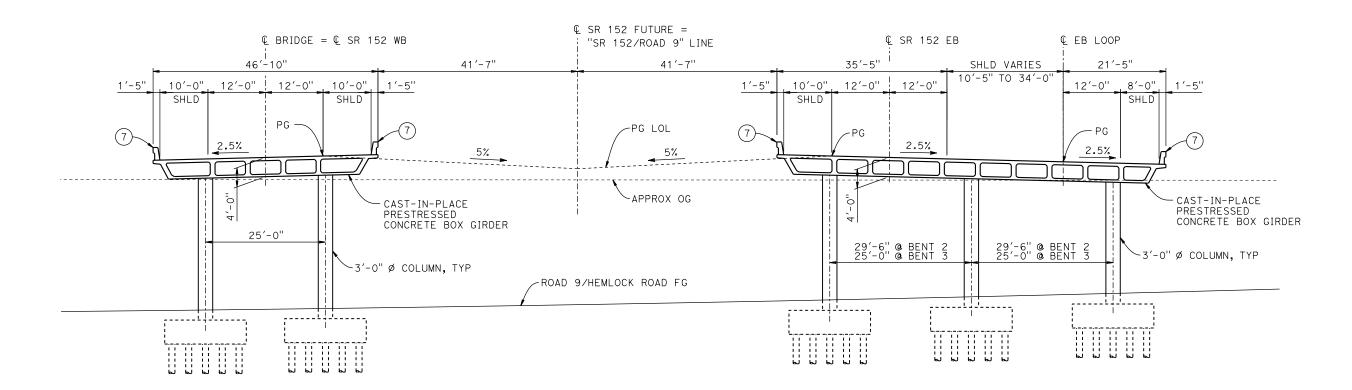

TYPICAL SECTION

1" = 10'

NOTES:

1. FOR NOTES AND LEGEND, SEE DRAWING ST-K1161-D.



Ā								
-5							DESIGNED BY M. BRATT	RE
							DRAWN BY	15
_							CHECKED BY K. CHARAN	81
1330							IN CHARGE C. LEMLEY	CON
p0051	REV	DATE	BY	СНК	APP	DESCRIPTION	DATE 08/12/2016	

RECORD SET 15% DESIGN SUBMITTAL NOT FOR CONSTRUCTION







CALIFORNIA HIGH-SPEED TRAIN PROJECT MERCED TO FRESNO SECTION

CENTRAL VALLEY WYE
SR 152 (NORTH) TO ROAD 11 WYE ALTERNATIVE
TYPICAL SECTION (SJD-FRE)
HEMLOCK ROAD (ROAD 9) INTERCHANGE - 2 OF 2

CONTRACT NO.
HSR08-05
DRAWING NO.
ST-K3161-D
SCALE
AS SHOWN
SHEET NO.

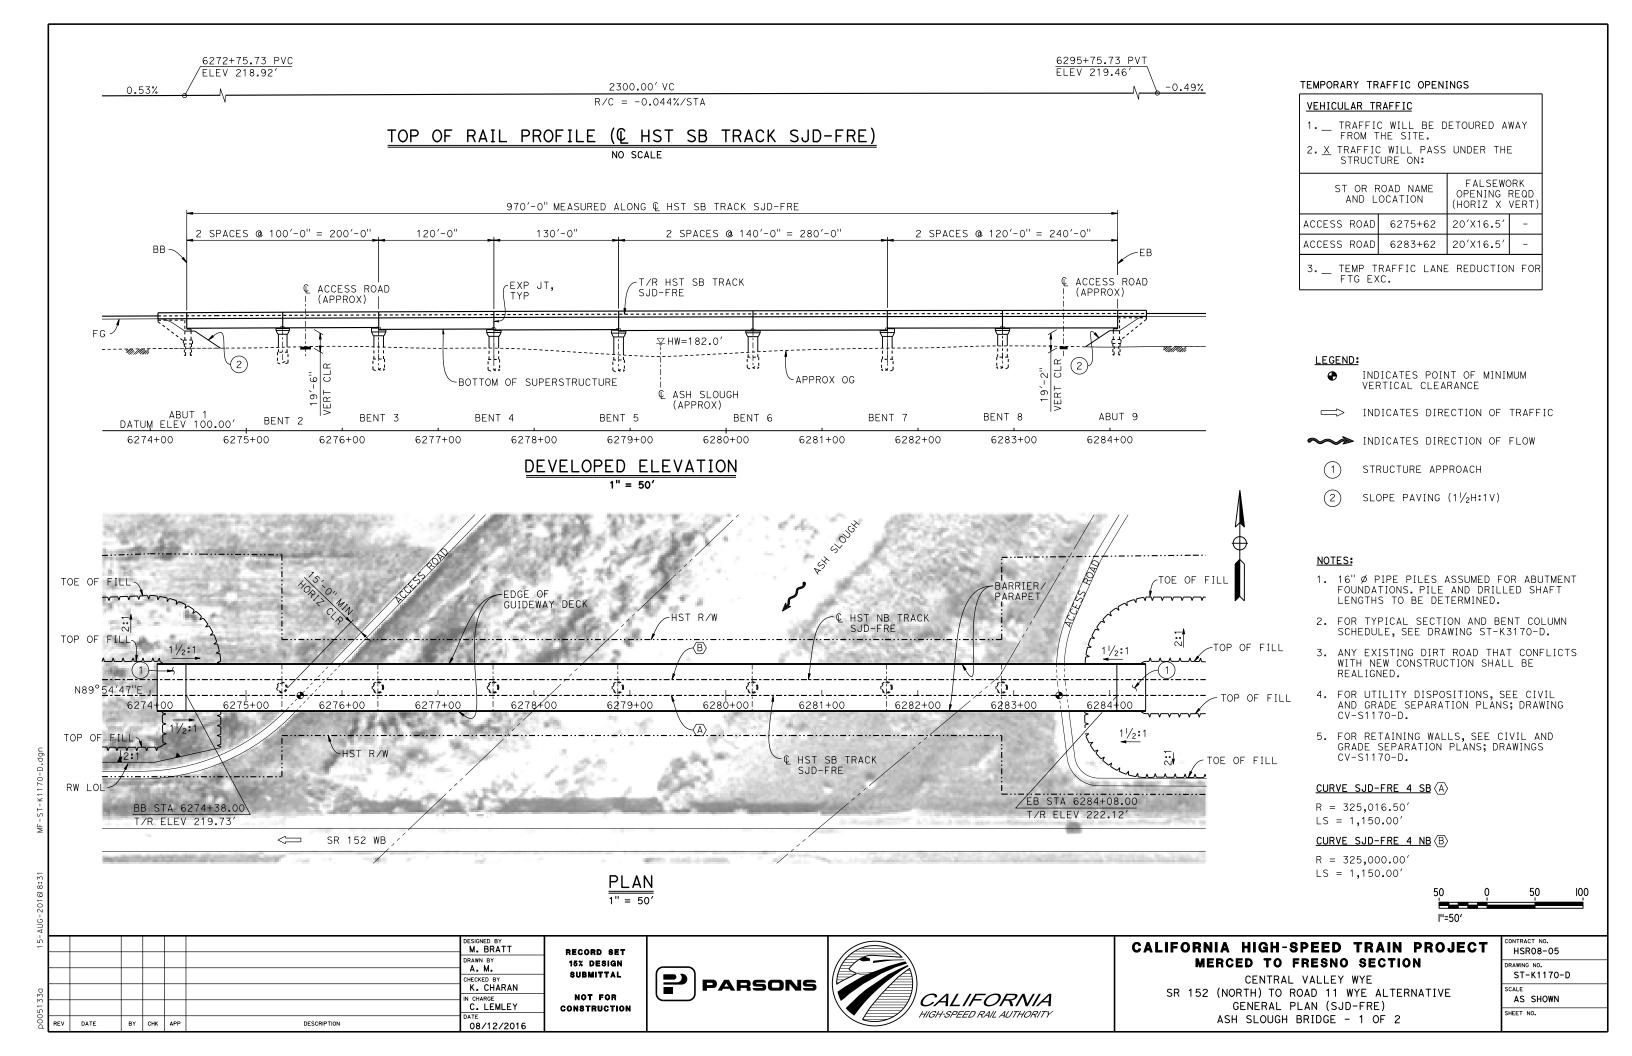

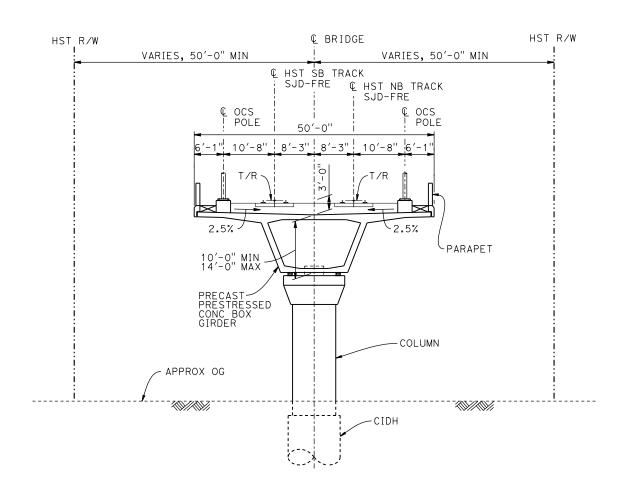

TYPICAL SECTION

BENT COLUMN SCHEDULE					
BENT	CIDH				
2	9'-0" ø	11'-0" Ø			
3 - 8	10'-0" Ø	12'-0" Ø			

NOTES:

- 1. DRILLED SHAFT LENGTHS TO BE DETERMINED.
- 2. FOR TRACK SUPERELEVATION DETAILS, SEE ALIGNMENT AND TYPICAL SECTION PLANS; DRAWINGS TT-B0051-D AND TT-B0053-D.

0 0 0 20

DESIGNED BY M. BRATT DRAWN BY A. M. CHECKED BY K. CHARAN IN CHARGE C. LEMLEY

DESCRIPTION

BY CHK APP

RECORD SET
15% DESIGN
SUBMITTAL
NOT FOR
CONSTRUCTION

08/12/2016







CALIFORNIA HIGH-SPEED TRAIN PROJECT MERCED TO FRESNO SECTION

CENTRAL VALLEY WYE
SR 152 (NORTH) TO ROAD 11 WYE ALTERNATIVE
TYPICAL SECTION (SJD-FRE)
ASH SLOUGH BRIDGE - 2 OF 2

CONTRACT NO. HSR08-05
DRAWING NO. ST-K3170-D
AS SHOWN
SHEET NO.

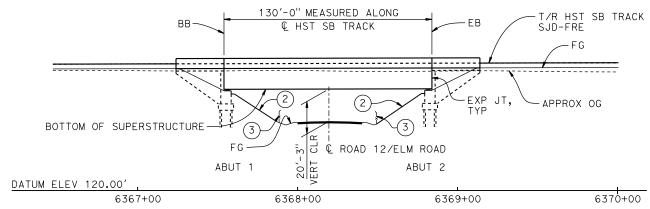


ELEVATION

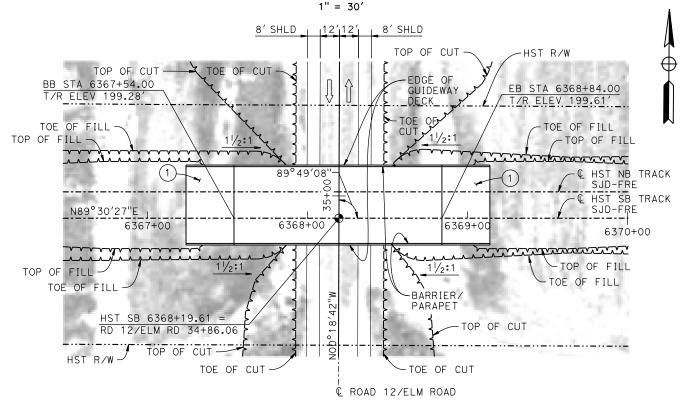

PLAN

LEGEND:

- INDICATES POINT OF MINIMUM
 VERTICAL CLEARANCE
- (1) STRUCTURE APPROACH
- 2 SLOPE PAVING $(1\frac{1}{2}H:1V)$
- AR FENCE, SEE TRACK PLANS;
 DRAWING TT-B0020-D

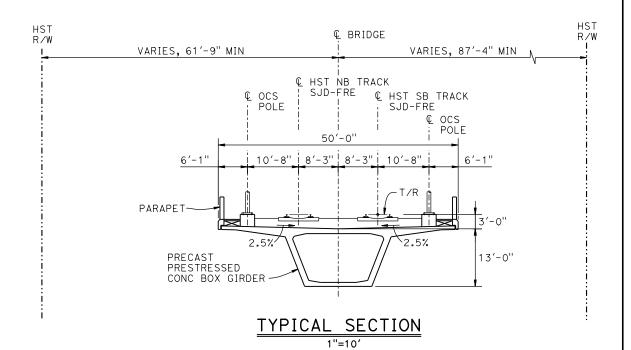

TEMPORARY TRAFFIC OPENINGS

VEHICULAR TRAFFIC

- 1. \underline{X} TRAFFIC WILL BE DETOURED AWAY FROM THE SITE.
- 2. TRAFFIC WILL PASS UNDER THE STRUCTURE ON:

STREET OR ROAD NAME
AND LOCATION

FALSEWORK
OPENING REQD
(HORIZ X VERT)

ROAD 12/ELM ROAD 6368+20 32'x16.5' 2-WAY

3. _ TEMP TRAFFIC LANE REDUCTION FOR FTG EXC.

NOTES:

- 16"Ø PIPE PILES ASSUMED FOR ABUTMENT FOUNDATIONS. PILE LENGTHS TO BE DETERMINED.
- 2. FOR UTILITY DISPOSITIONS, SEE CIVIL AND GRADE SEPARATION PLANS; DRAWING CV-S1190-D.



1								
							DESIGNED BY M. BRATT	
							DRAWN BY	1
							CHECKED BY	ł
20							K. CHARAN IN CHARGE	l
0.0							C. LEMLEY	c
DO.	REV	DATE	BY	СНК	APP	DESCRIPTION	DATE 08/12/2016	

RECORD SET
15% DESIGN
SUBMITTAL
NOT FOR
CONSTRUCTION








CALIFORNIA HIGH-SPEED TRAIN PROJECT MERCED TO FRESNO SECTION


CENTRAL VALLEY WYE
SR 152 (NORTH) TO ROAD 11 WYE ALTERNATIVE
GENERAL PLAN (SJD-FRE)
ELM ROAD (ROAD 12) UNDERPASS

CONTRACT NO.
HSR08-05
DRAWING NO.
ST-K1190-D
SCALE
AS SHOWN
SHEET NO.

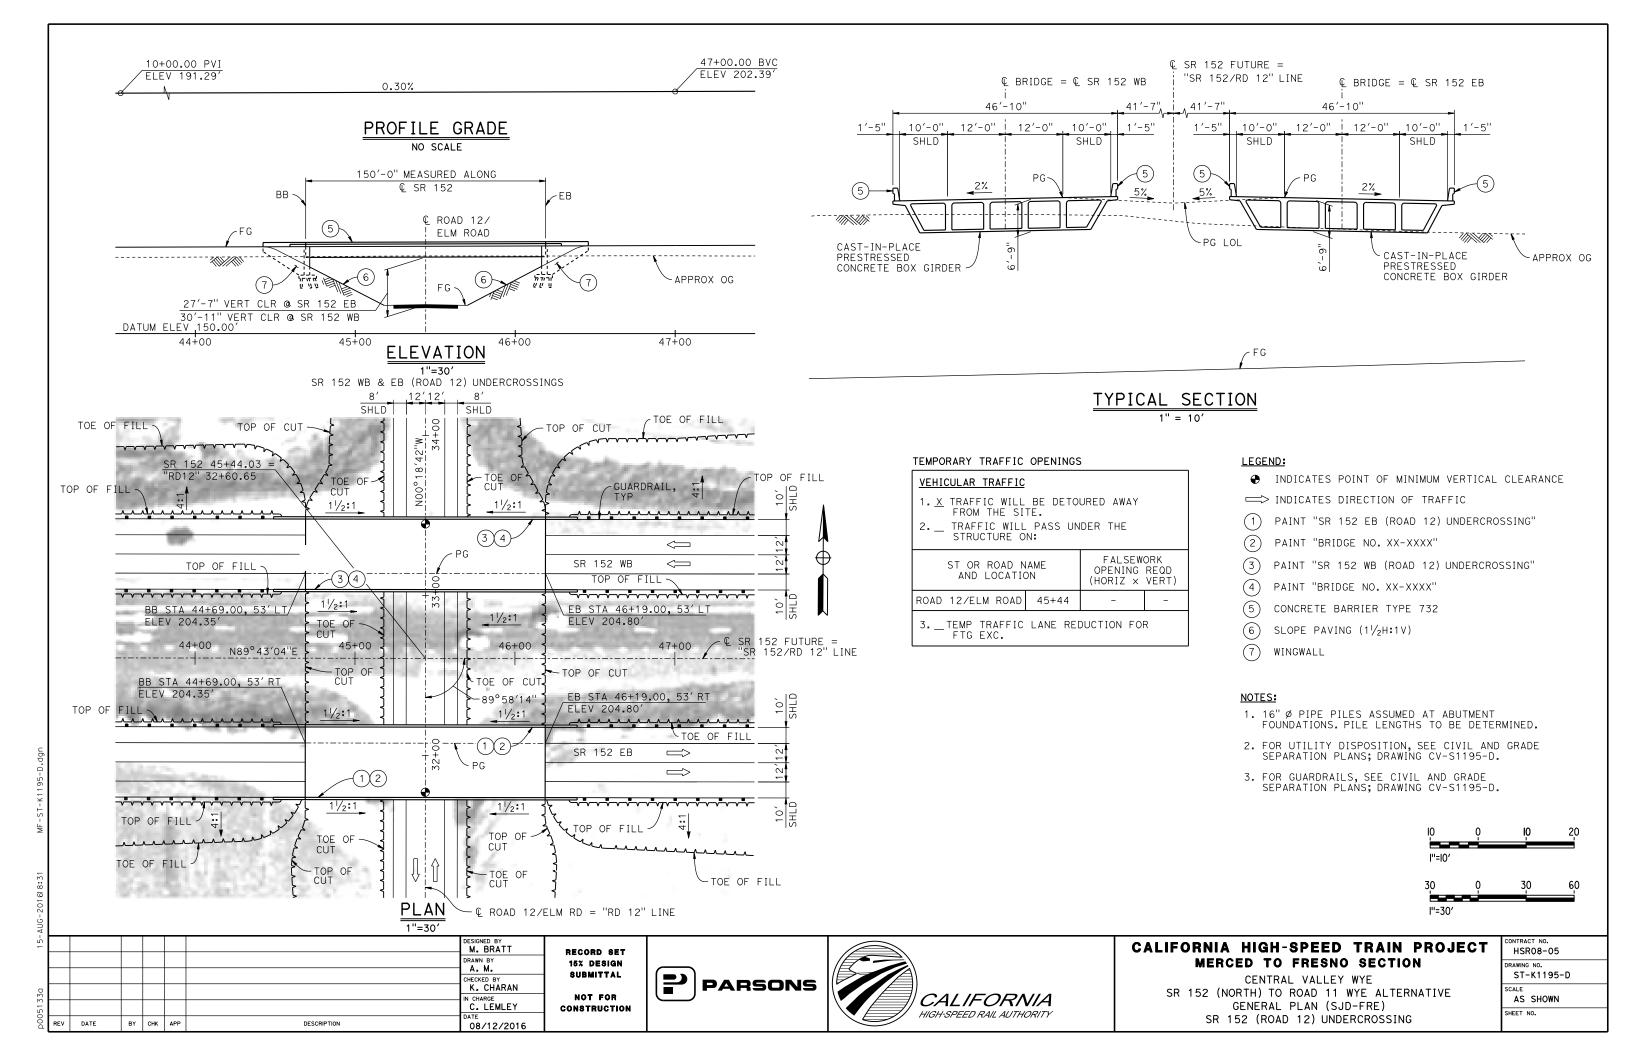

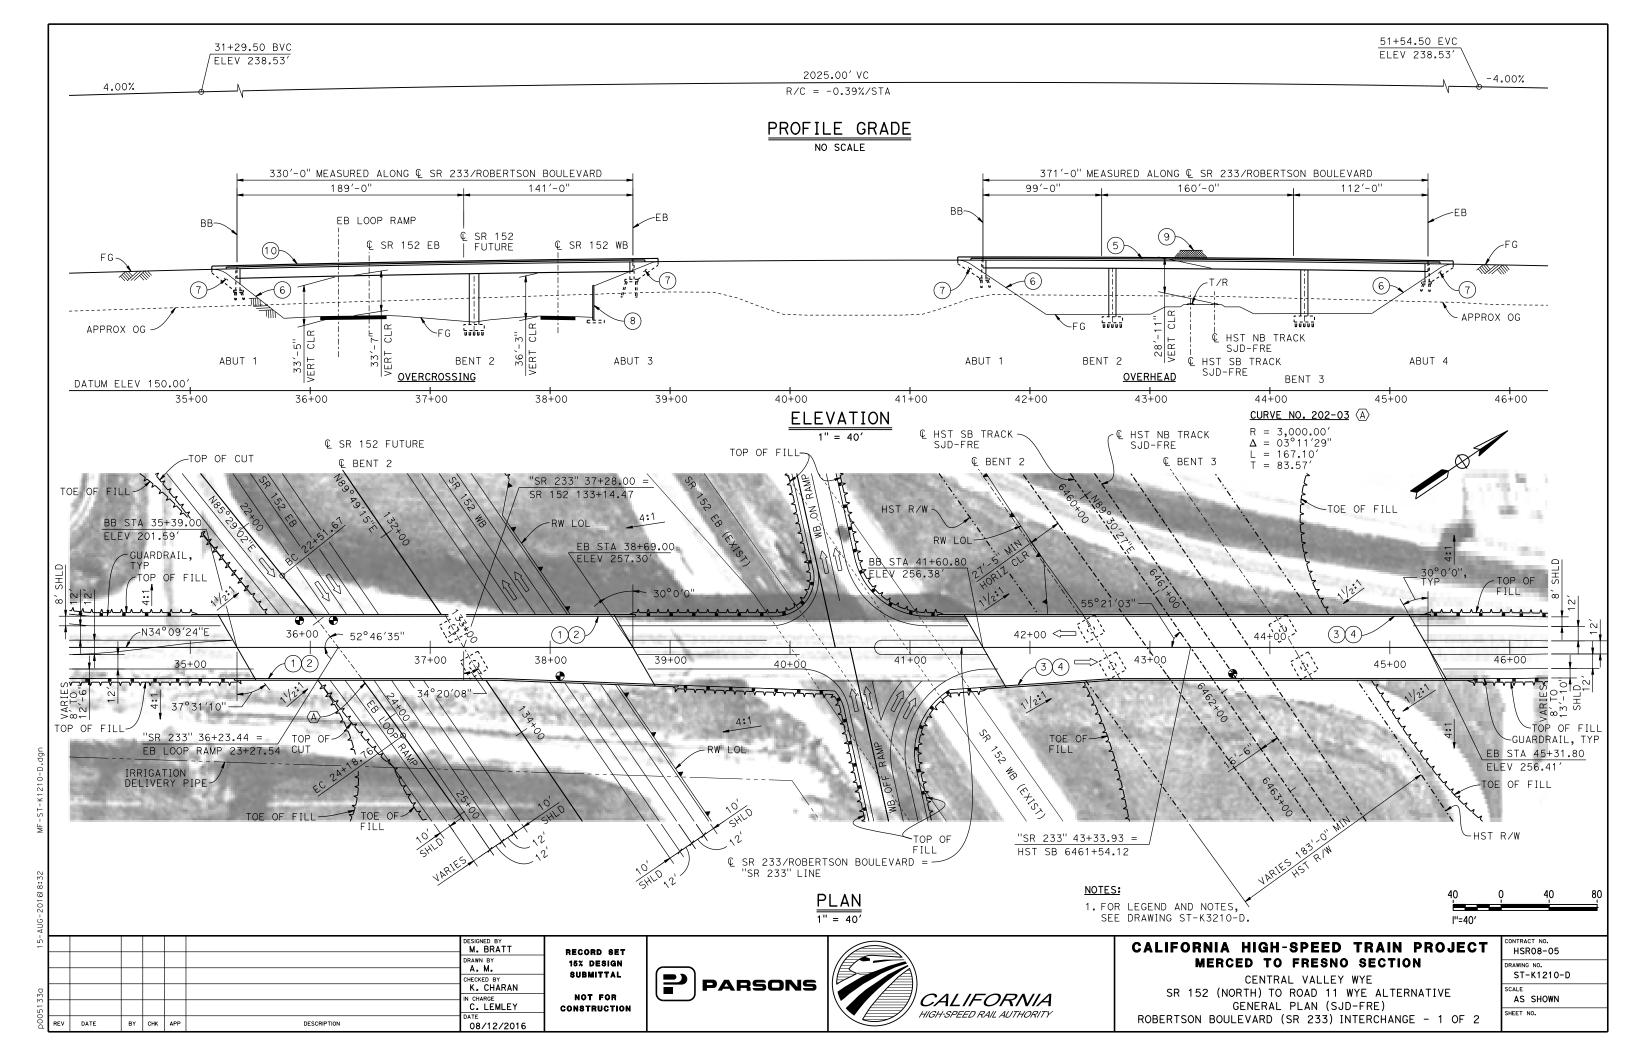

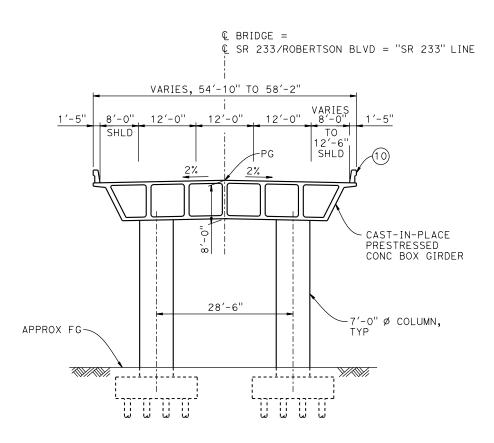

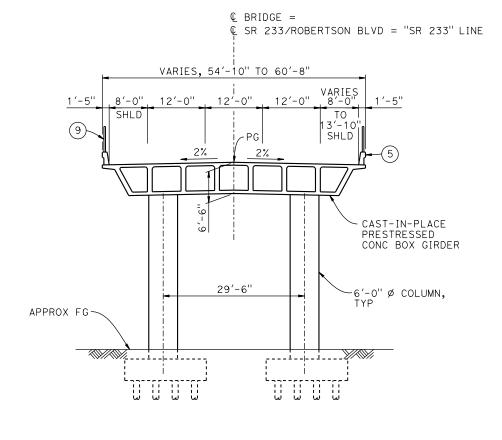

TYPICAL SECTION AT OVERCROSSING

TEMPORARY TRAFFIC OPENINGS VEHICULAR TRAFFIC

- 1. _ TRAFFIC WILL BE DETOURED AWAY FROM THE SITE.
- 2. X TRAFFIC WILL PASS UNDER THE

STRUCTURE O			
ST OR ROAD N AND LOCATIO	FALSEWORK OPENING REQD (HORIZ X VERT)		
SR 152	36+49	40′X16.5′	E BND
SR 152	38+08	40′X16.5′	W BND
Z TEMP TRACETO	, I VNE DE	DUCTION EC	\D

3. _ TEMP TRAFFIC LANE REDUCTION FOR FTG EXC.

- ◆ INDICATES POINT OF MINIMUM VERTICAL CLEARANCE
- PAINT "ROBERTSON BLVD OVERCROSSING"
- 2 PAINT "BRIDGE NO. XX-XXXX"
- (3) PAINT "ROBERTSON BLVD OVERHEAD"
- 4 PAINT "BRIDGE NO. XX-XXXX"
- CONCRETE BARRIER TYPE 736 MOD
- 6 SLOPE PAVING $(1\frac{1}{2}H:1V)$
- WINGWALL
- (8) RETAINING WALL
- AR FENCE WITH SOLID PLATE
- CONCRETE BARRIER TYPE 732 MOD

TYPICAL SECTION AT OVERHEAD

- 1.16" \not PIPE PILES ASSUMED AT ABUTMENT AND BENT FOUNDATIONS. PILE LENGTHS TO BE DETERMINED.
- 2. FOR UTILITY DISPOSITIONS, SEE CIVIL AND GRADE SEPARATION PLANS; DRAWING CV-S1210-D.
- 3. FOR RETAINING WALLS, SEE CIVIL AND GRADE SEPARATION PLANS; DRAWING CV-S1210-D.
- 4. FOR GUARDRAILS, SEE CIVIL AND GRADE SEPARATION PLANS; DRAWING CV-S1210-D.



M. BRATT DRAWN BY K. CHARAN IN CHARGE C. LEMLEY DATE BY CHK APP DESCRIPTION 08/12/2016

RECORD SET 15% DESIGN SUBMITTAL NOT FOR

CONSTRUCTION







CALIFORNIA HIGH-SPEED TRAIN PROJECT MERCED TO FRESNO SECTION

CENTRAL VALLEY WYE SR 152 (NORTH) TO ROAD 11 WYE ALTERNATIVE TYPICAL SECTIONS (SJD-FRE) ROBERTSON BOULEVARD (SR 233) INTERCHANGE - 2 OF 2


CONTRACT NO.					
HSR08-05					
DRAWING NO.					
ST-K3210-D					
SCALE					
AS SHOWN					
SHEET NO.					

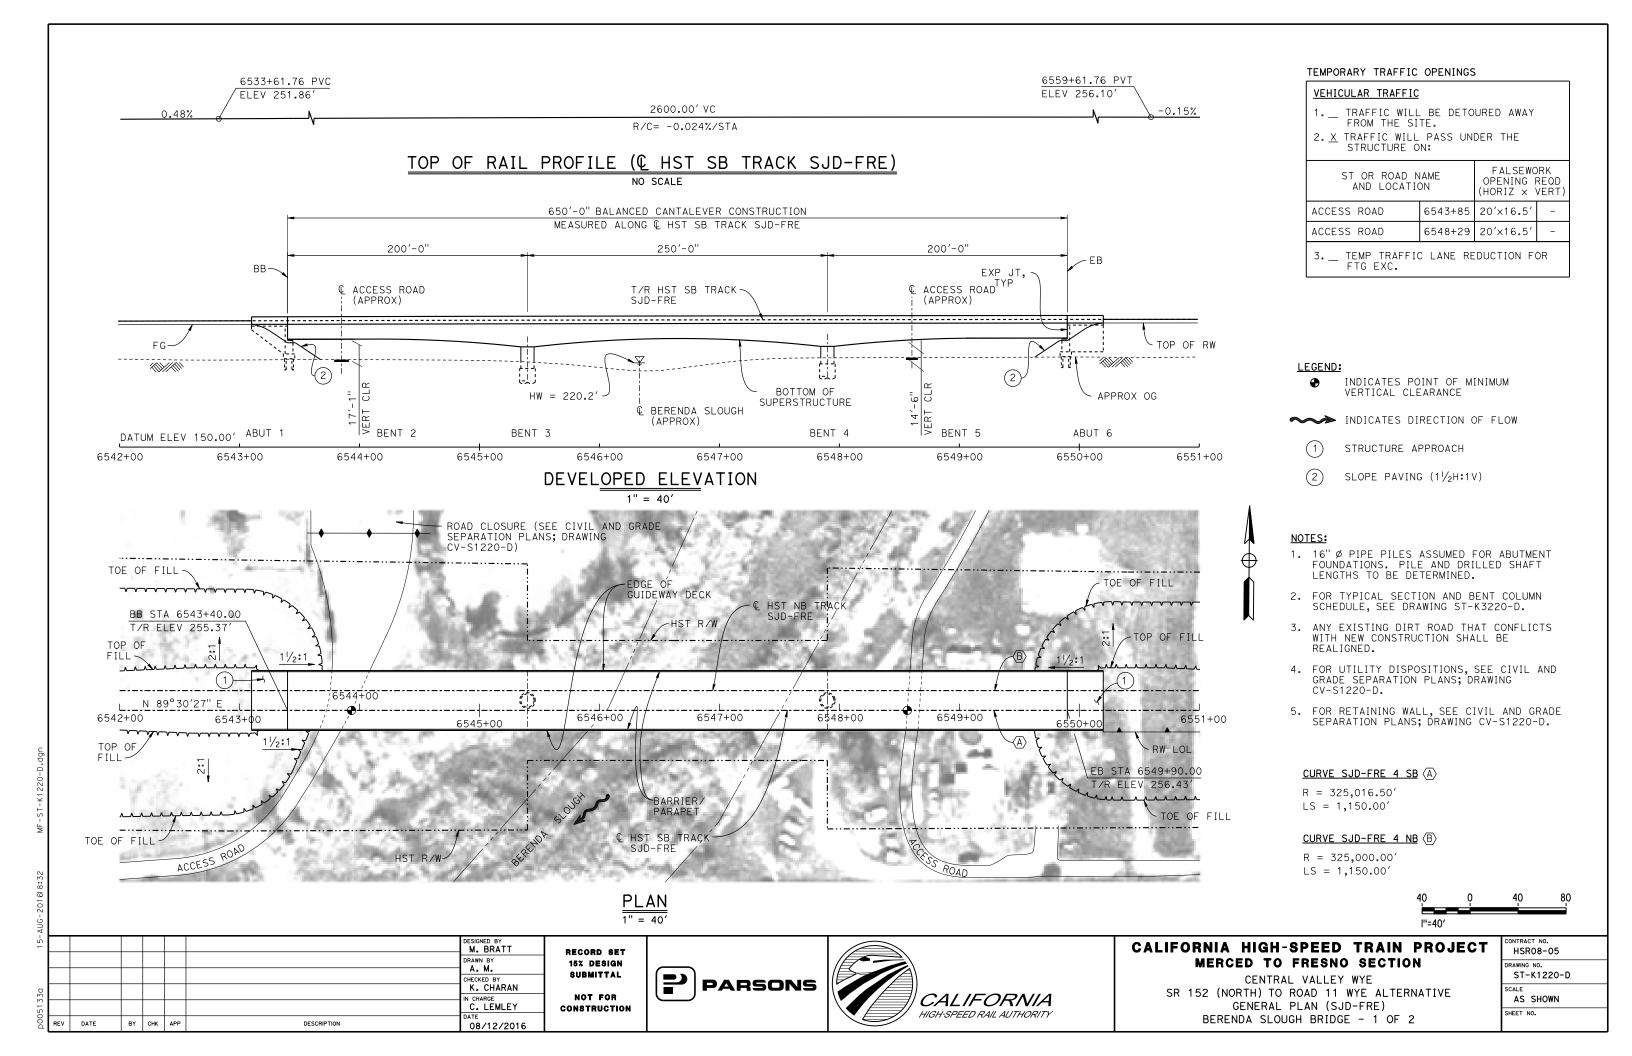

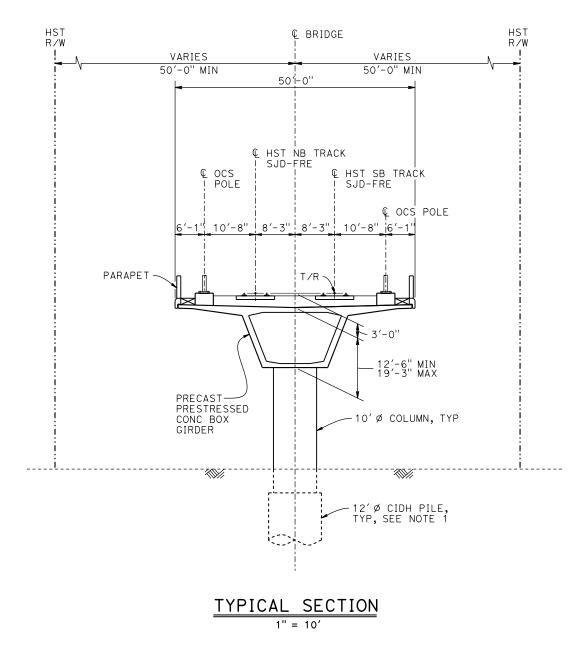

NOTE:

- 1. DRILLED SHAFT LENGTHS TO BE DETERMINED.
- 2. FOR TRACK SUPERELEVATION DETAILS, SEE ALIGNMENT AND TYPICAL SECTION PLANS; DRAWINGS TT-B0051-D AND TT-B0053-D.

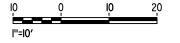

ΑU								
15-							DESIGNED BY M. BRATT	Ι,
							DRAWN BY A. M.	'
							CHECKED BY K. CHARAN	
5133a							IN CHARGE C. LEMLEY	_c
p00£	REV	DATE	BY	снк	APP	DESCRIPTION	DATE 08/12/2016	

RECORD SET
15% DESIGN
SUBMITTAL
NOT FOR
CONSTRUCTION








CALIFORNIA HIGH-SPEED TRAIN PROJECT MERCED TO FRESNO SECTION

CENTRAL VALLEY WYE
SR 152 (NORTH) TO ROAD 11 WYE ALTERNATIVE
TYPICAL SECTION (SJD-FRE)
BERENDA SLOUGH BRIDGE - 2 OF 2

CONTRACT NO. HSR08-05					
DRAWING NO. ST-K3220-D					
SCALE AS SHOWN					
SHEET NO.					

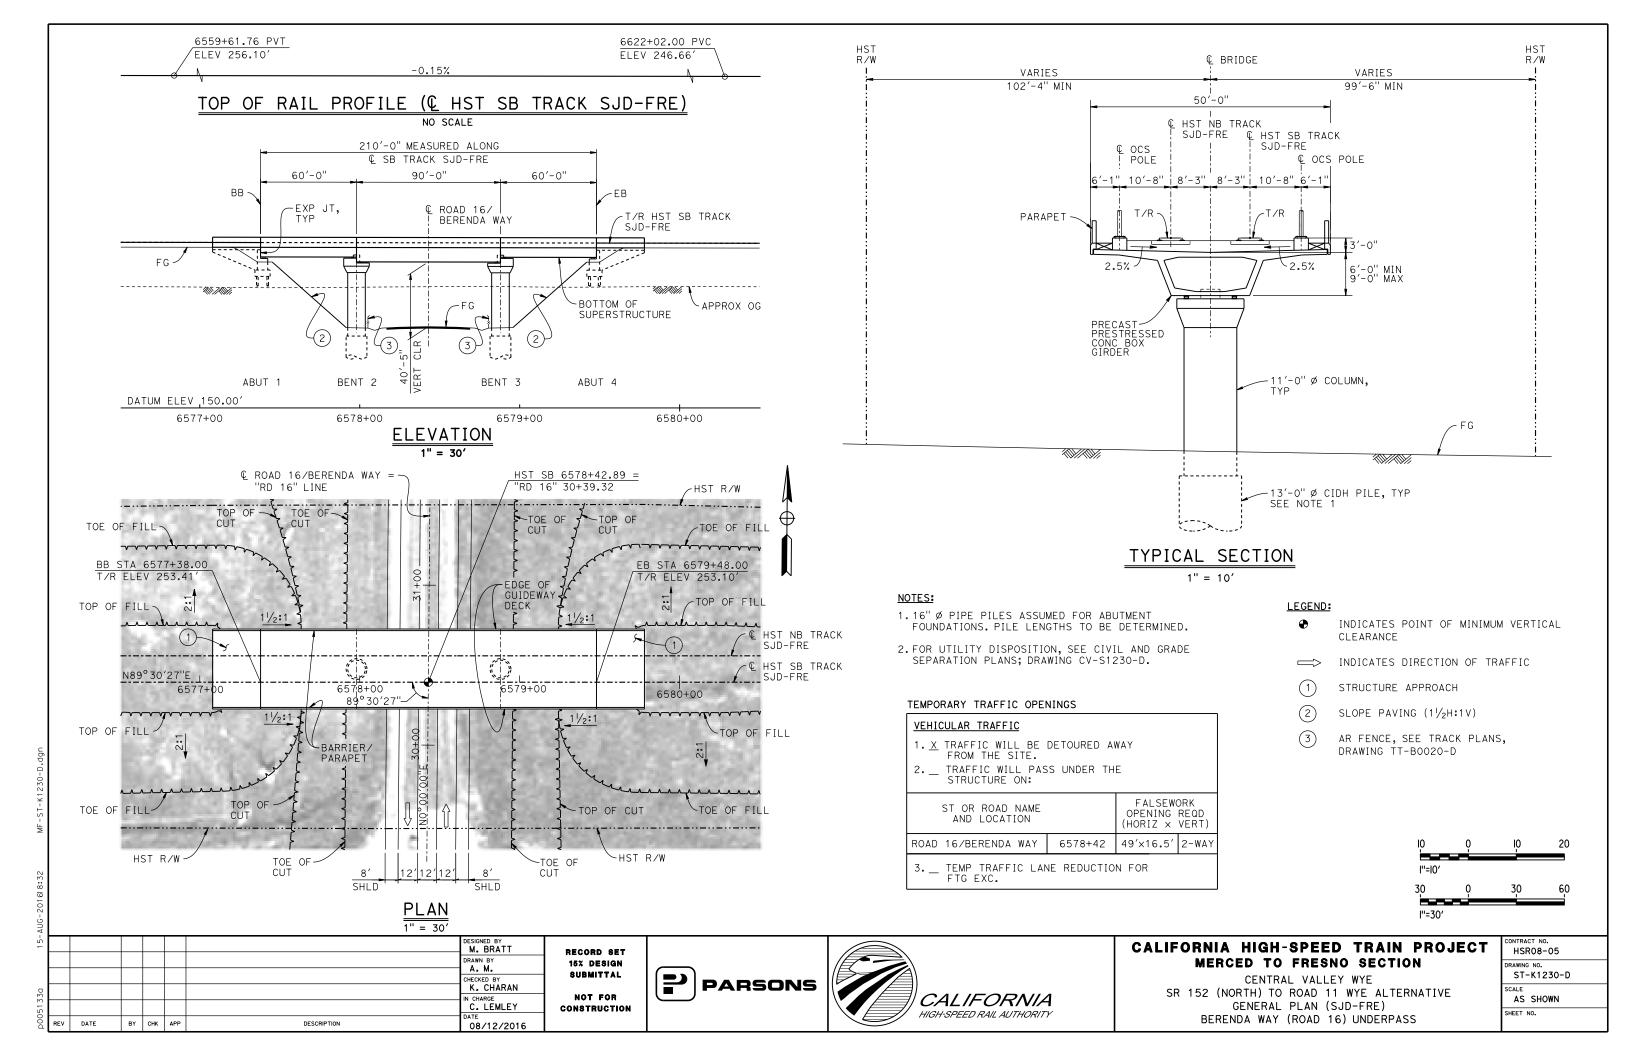

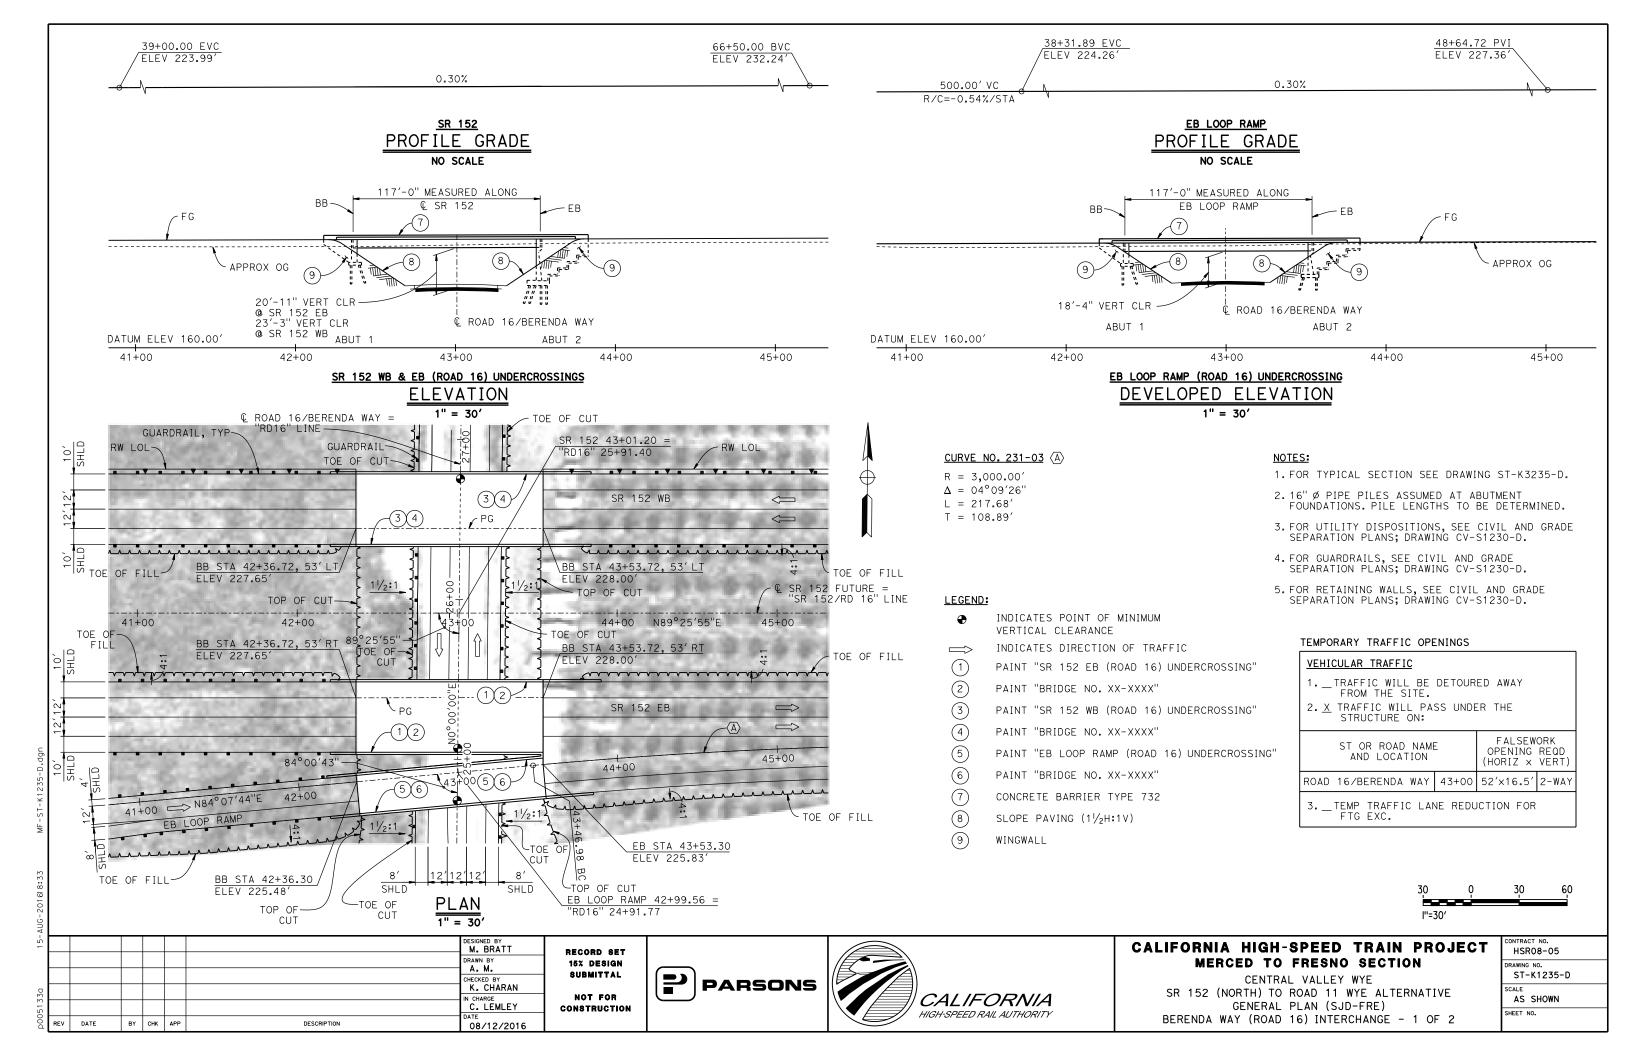

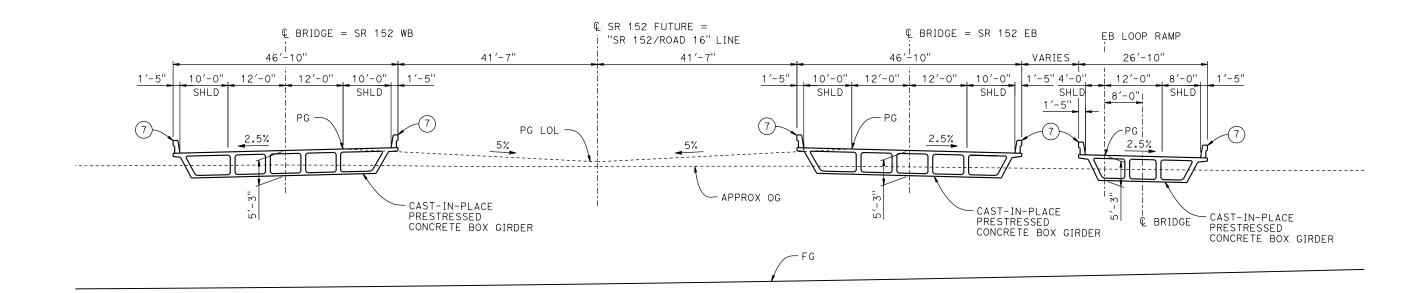

TYPICAL SECTION 1" = 10'

NOTES:

1. FOR NOTES AND LEGEND, SEE DRAWING ST-K1235-D.



-5							DESIGNED BY M. BRATT	
							DRAWN BY A. M.	
۰							CHECKED BY K. CHARAN	
5133a							IN CHARGE C. LEMLEY	
nnd	REV	DATE	BY	СНК	APP	DESCRIPTION	DATE 08/12/2016	

RECORD SET
15% DESIGN
SUBMITTAL
NOT FOR
CONSTRUCTION






CALIFORNIA HIGH-SPEED TRAIN PROJECT MERCED TO FRESNO SECTION

CENTRAL VALLEY WYE
SR 152 (NORTH) TO ROAD 11 WYE ALTERNATIVE
TYPICAL SECTION (SJD-FRE)
BERENDA WAY (ROAD 16) INTERCHANGE - 2 OF 2

CONTRACT NO.
HSR08-05
DRAWING NO.
ST-K3235-D
SCALE
AS SHOWN
SHEET NO.

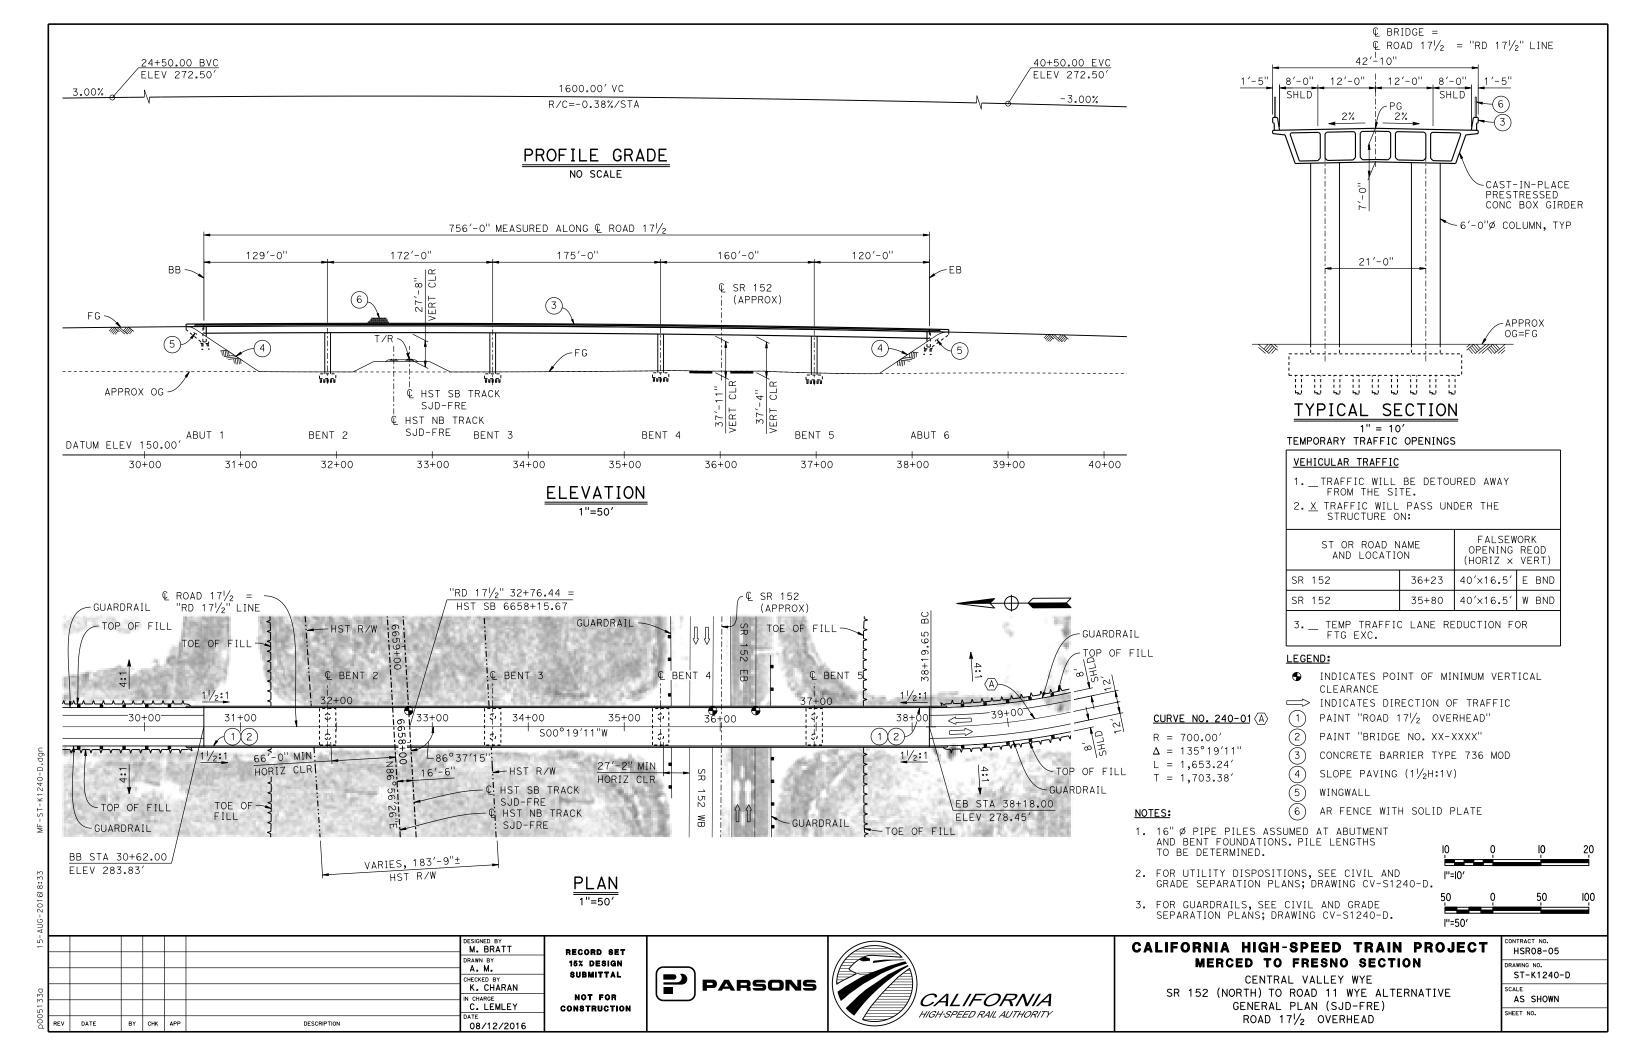

DATE

BY CHK APP


DESCRIPTION


08/12/2016

AERIAL #2 - SR 99 / UPRR - 1 OF 3

TOP OF RAIL PROFILE (@ HST SB TRACK SJD-FRE)

NO SCALE

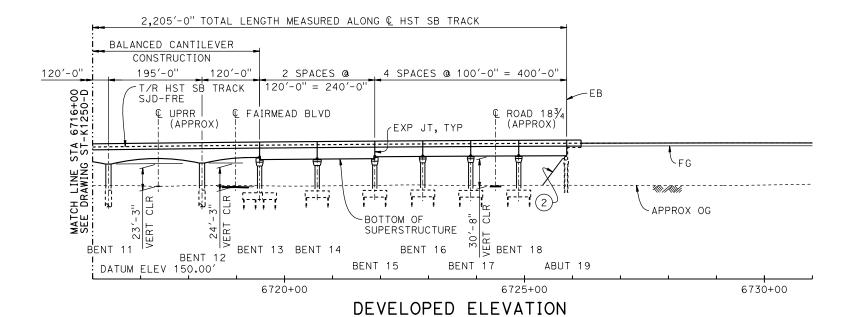

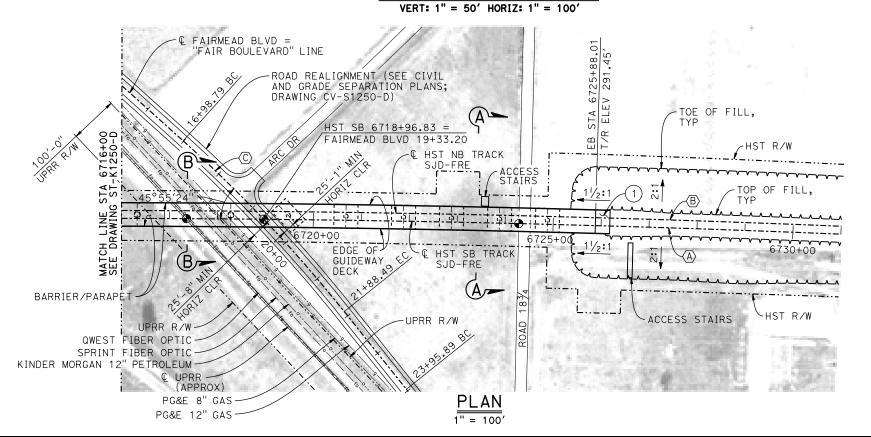

08/12/2016

TEMPORARY TRAFFIC OPENINGS

VEHICULAR TRAFFIC

- 1. __TRAFFIC WILL BE DETOURED AWAY FROM THE SITE.
- 2. X TRAFFIC WILL PASS UNDER THE STRUCTURE ON:

ST OR ROAD NAM AND LOCATION	FALSEWORK OPENING REQD (HORIZ X VERT)			
SR 152 SB ON RAMP	6709+18	25′X16.5′	S BND	
SR 99	6709+83	37′X16.5′	S BND	
SR 99	6712+48	37′X16.5′	N BND	
FAIRMEAD BLVD	6718+98	32′X16.5′	2-WAY	
ROAD 183/4	6724+40	32′X16.5′	2-WAY	
7 TEMP TRAFFICA	NE DEDUC	TION FOR		

3. __TEMP TRAFFIC LANE REDUCTION FOR FTG EXC.

TEMPORARY TRAFFIC OPENINGS

RAILROAD TRAFFIC						
FALSEWORK OPENING REQUIRED ON:						
NAME OF RR AND L	OCATION	FALSEWORK OPENING REQD (HORIZ X VERT)				
UPRR	6717+37	24′ X 21′				

LEGEND:

- INDICATES POINT OF MINIMUM VERTICAL CLEARANCE
- (1) STRUCTURE APPROACH
- 2 SLOPE PAVING (1/2H:1V)

NOTES:


CURVE NO. 250-02 (C)

R = 3,000.00' $\Delta = 9^{\circ}21'10''$

L = 489.71'

T = 245.40'

- 1. FOR GENERAL NOTES, SEE DRAWING ST-K1250-D.
- 2. FOR SECTIONS AND BENT COLUMN SCHEDULE, SEE DRAWING ST-K3250-D.

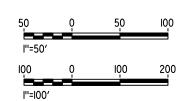

DESIGNED BY M. BRATT DRAWN BY A. M. CHECKED BY K. CHARAN IN CHARGE C. LEMLEY CO

DESCRIPTION

DATE

BY CHK APP

RECORD SET
15% DESIGN
SUBMITTAL
NOT FOR
CONSTRUCTION







CALIFORNIA HIGH-SPEED TRAIN PROJECT MERCED TO FRESNO SECTION

CENTRAL VALLEY WYE
SR 152 (NORTH) TO ROAD 11 WYE ALTERNATIVE
GENERAL PLAN (SJD-FRE)
AERIAL #2 - SR 99 / UPRR - 2 OF 3

CONTRACT NO. HSRO8-05
DRAWING NO. ST-K1251-D
SCALE AS SHOWN
SHEET NO.

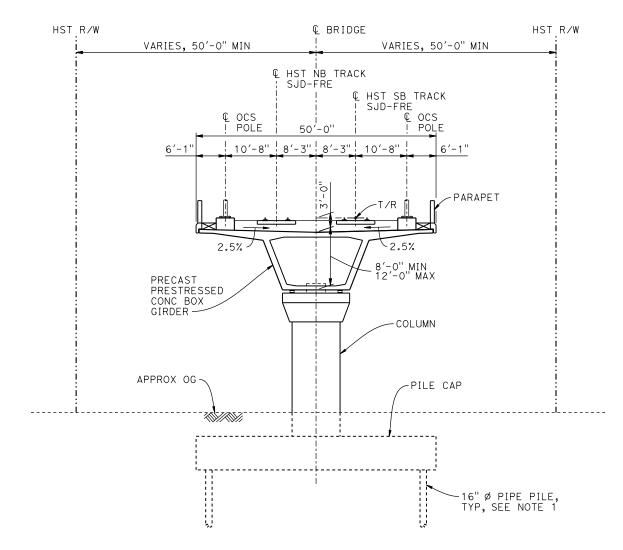

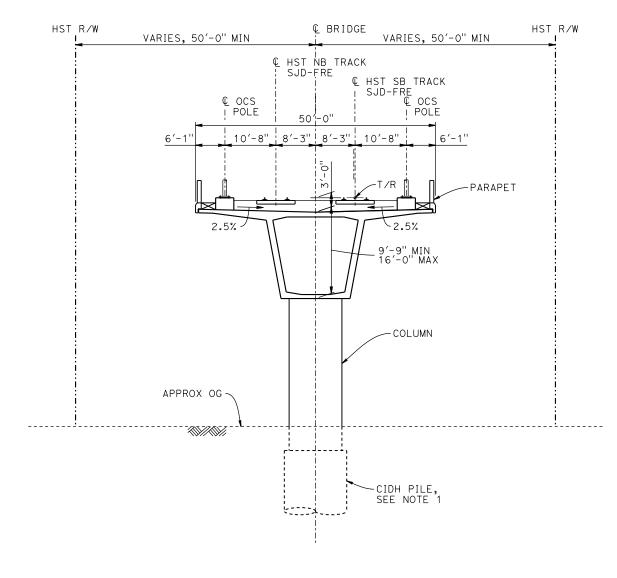

SECTION A-A

BENT COLUMN SCHEDULE					
BENT	COLUMN TYPE	CIDH TYPE			
2 - 5	9'-0" Ø				
6	11'-0" Ø	13'-0" Ø			
7	12'-0" Ø				
8	11'-0" Ø	13'-0" Ø			
9 - 10	10'-0" Ø				
11 - 12	11'-0" Ø	13'-0" Ø			
13 - 18	9'-0" ø				

 $\frac{\text{SECTION }B-B}{1"=10'}$

NOTES:

- PILE AND DRILLED SHAFT LENGTHS TO BE DETERMINED.
- 2. FOR TRACK SUPERELEVATION DETAILS, SEE ALIGNMENT AND TYPICAL SECTION PLANS; DRAWINGS TT-B0051-D AND TT-B0053-D.



-AU								
15							DESIGNED BY M. BRATT	R
							DRAWN BY	
0							CHECKED BY K. CHARAN	
5133a							IN CHARGE C. LEMLEY	CC
00d	REV	DATE	BY	снк	APP	DESCRIPTION	DATE 08/12/2016	

RECORD SET
15% DESIGN
SUBMITTAL
NOT FOR
CONSTRUCTION








CALIFORNIA HIGH-SPEED TRAIN PROJECT MERCED TO FRESNO SECTION


CENTRAL VALLEY WYE
SR 152 (NORTH) TO ROAD 11 WYE ALTERNATIVE
TYPICAL SECTIONS (SJD-FRE)
AERIAL #2 - SR 99 / UPRR - 3 OF 3


CONTRACT NO.
HSR08-05
DRAWING NO.
ST-K3250-D
SCALE
AS SHOWN
SHEET NO.

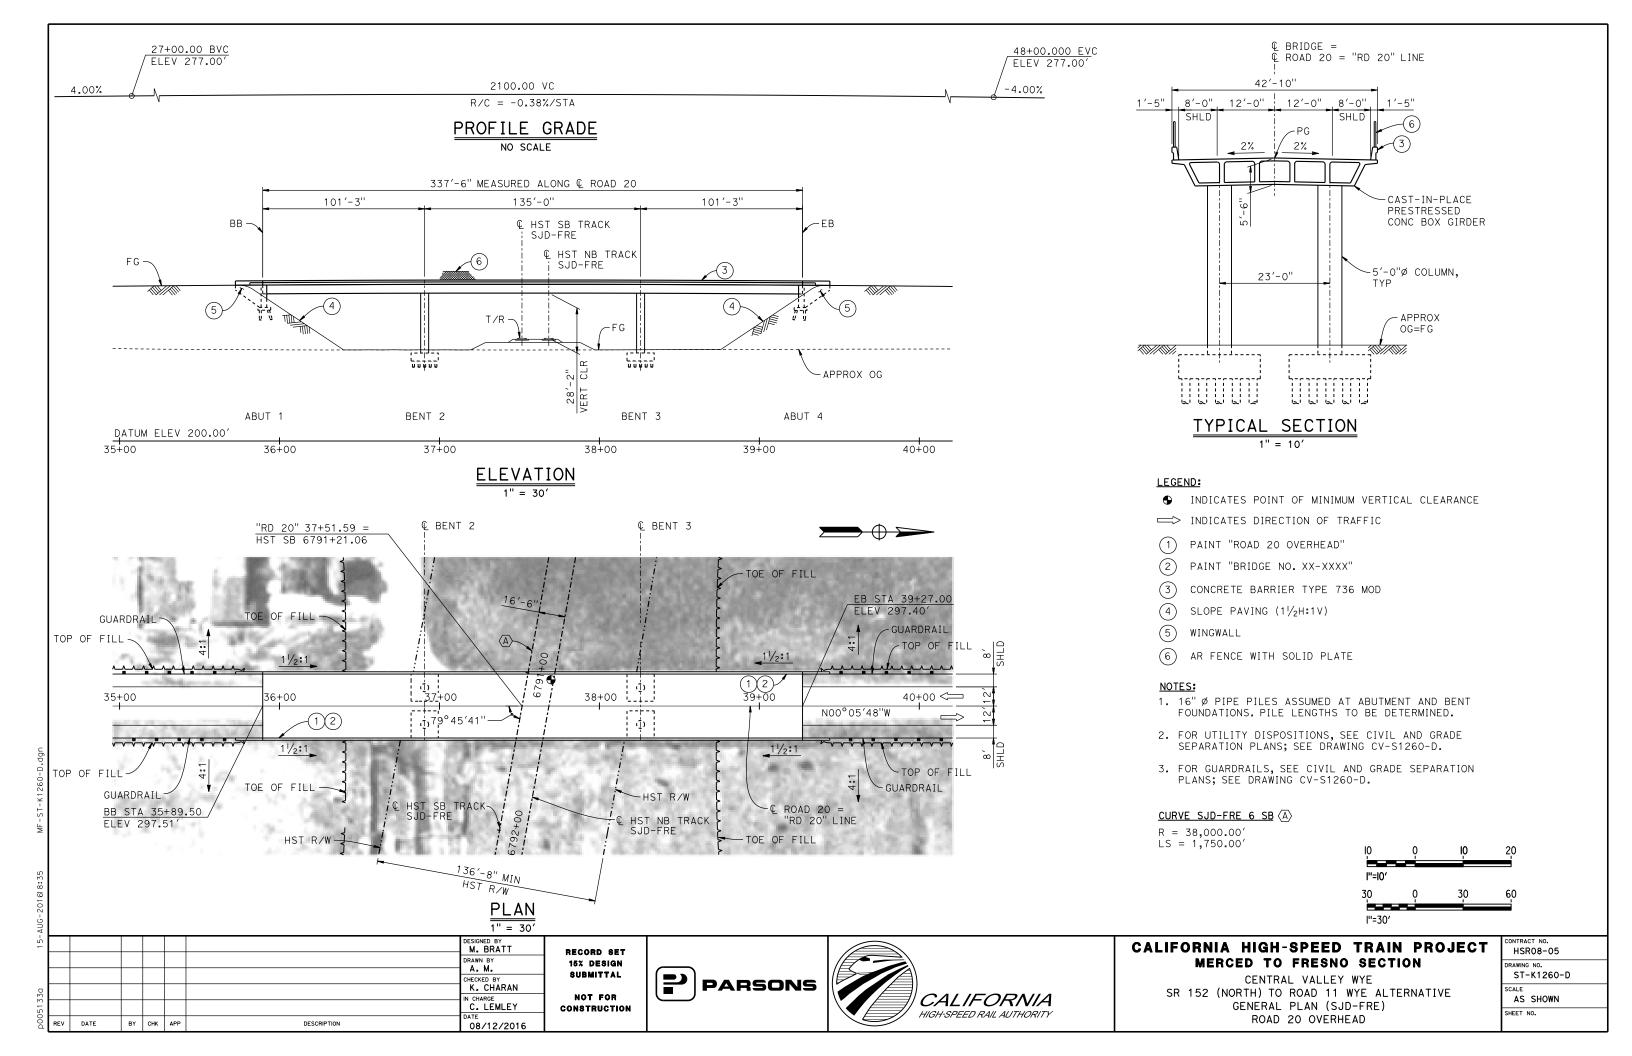


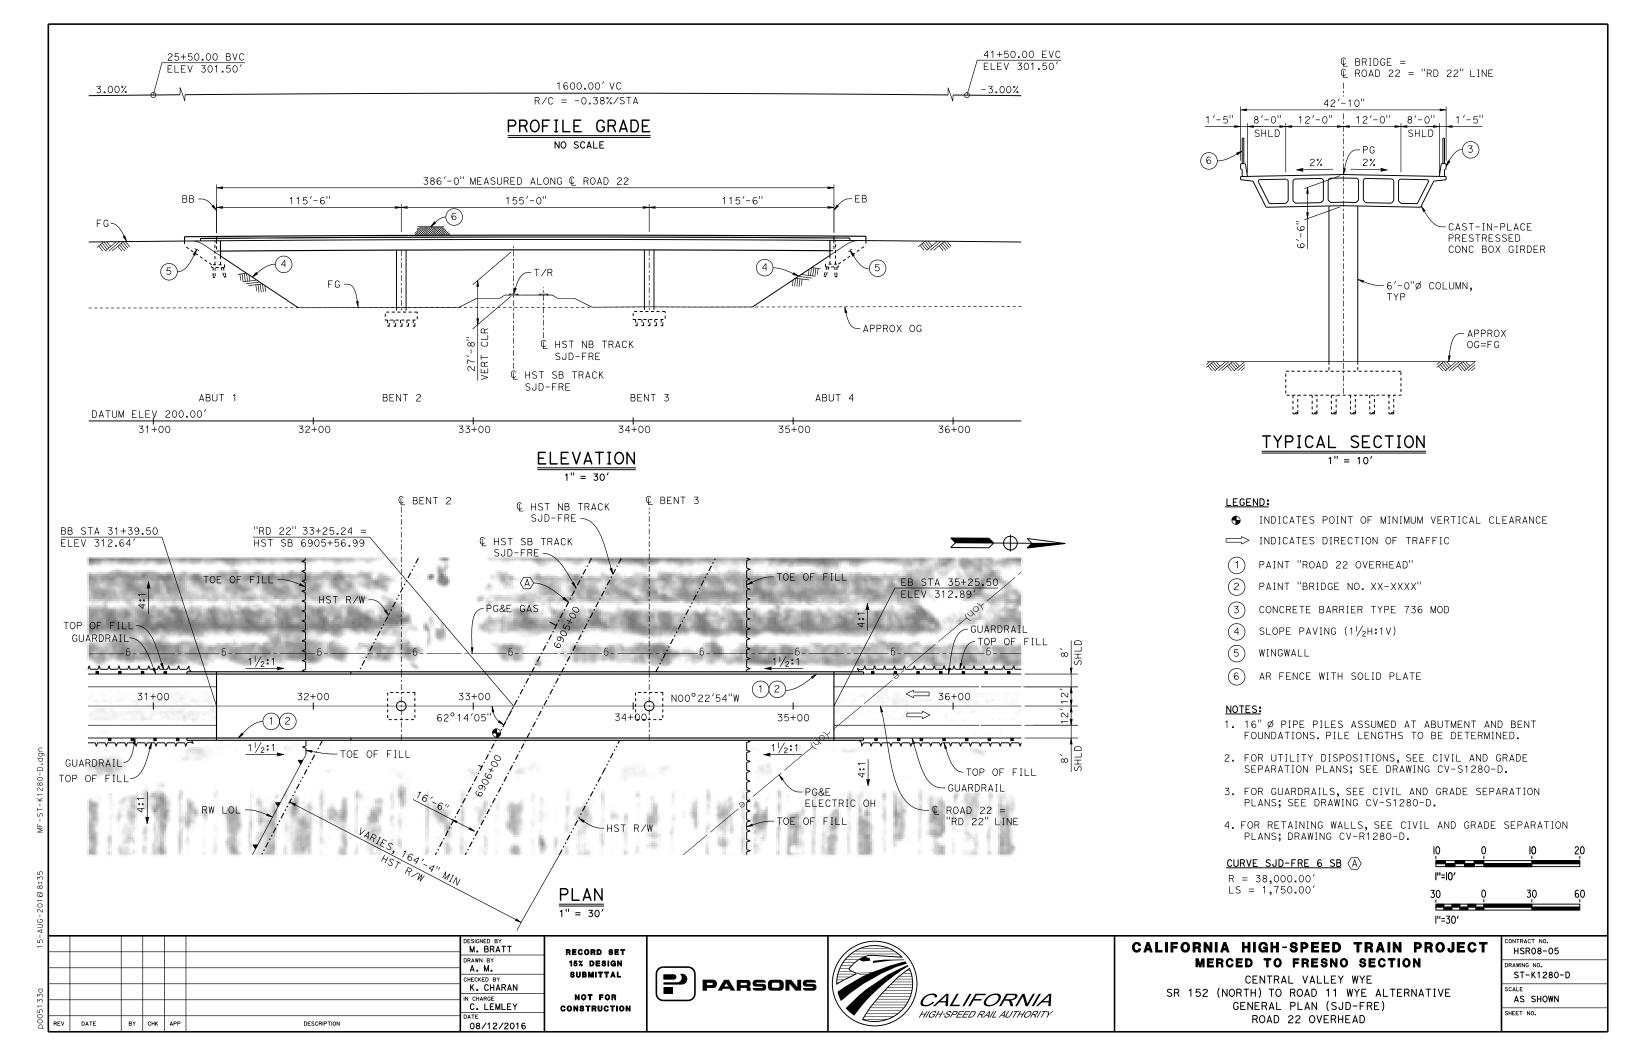

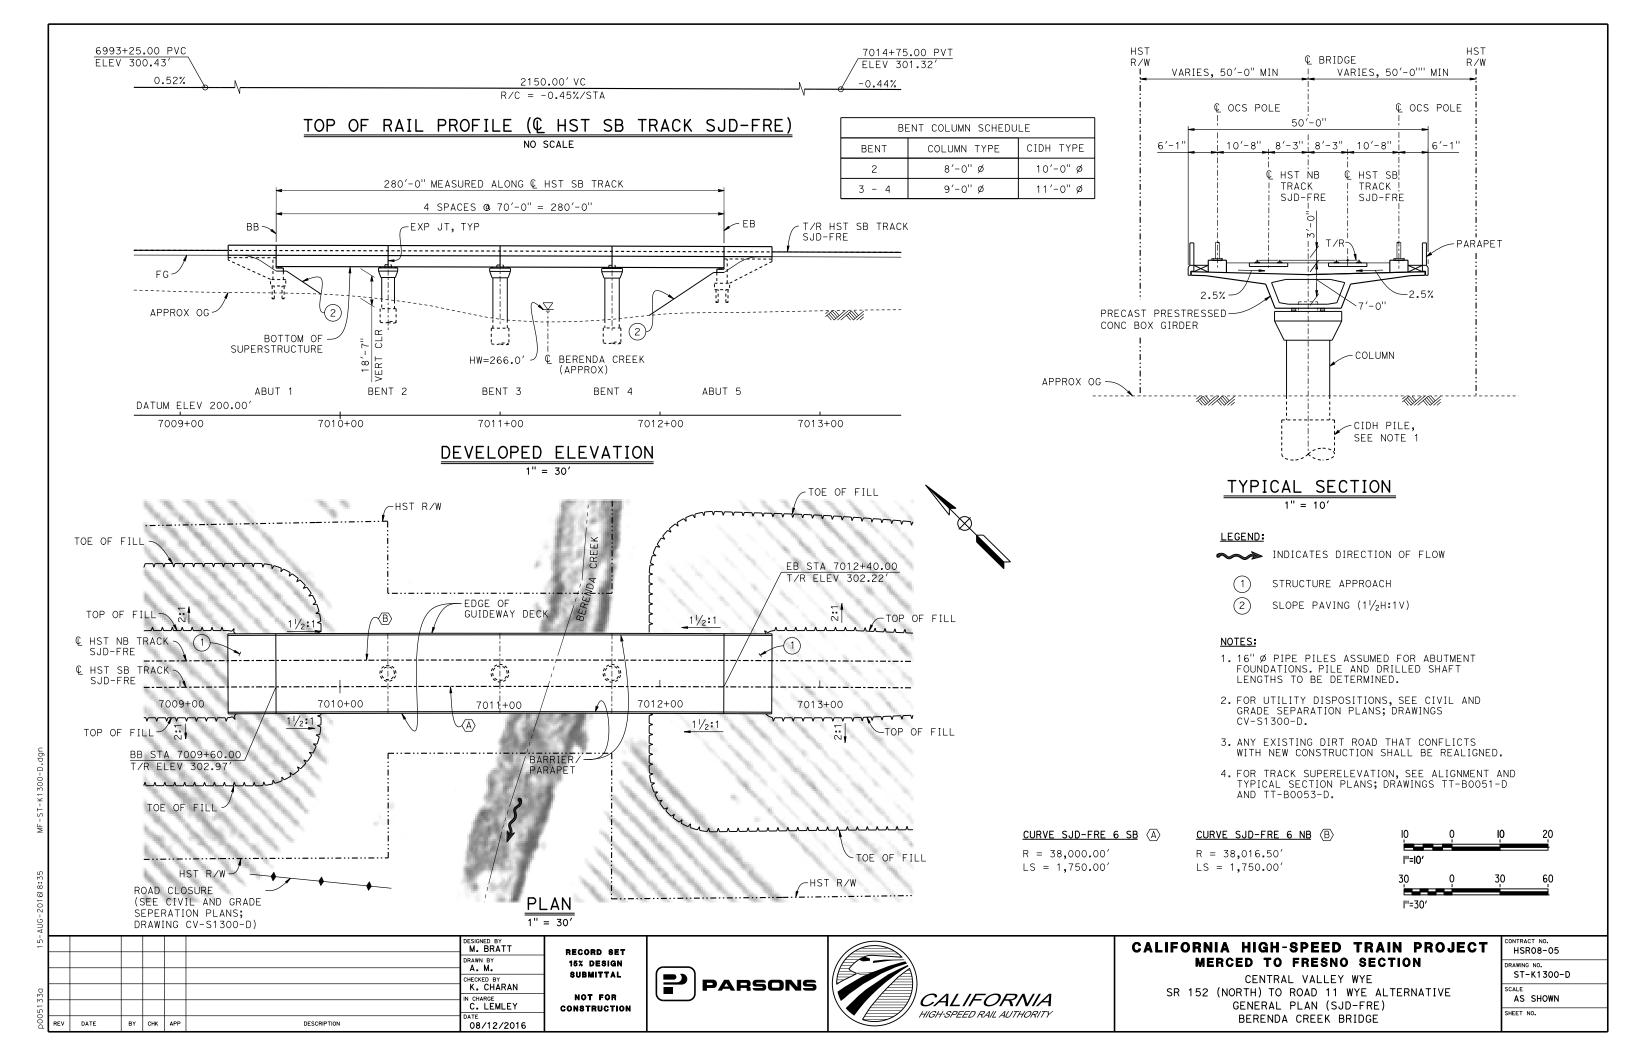

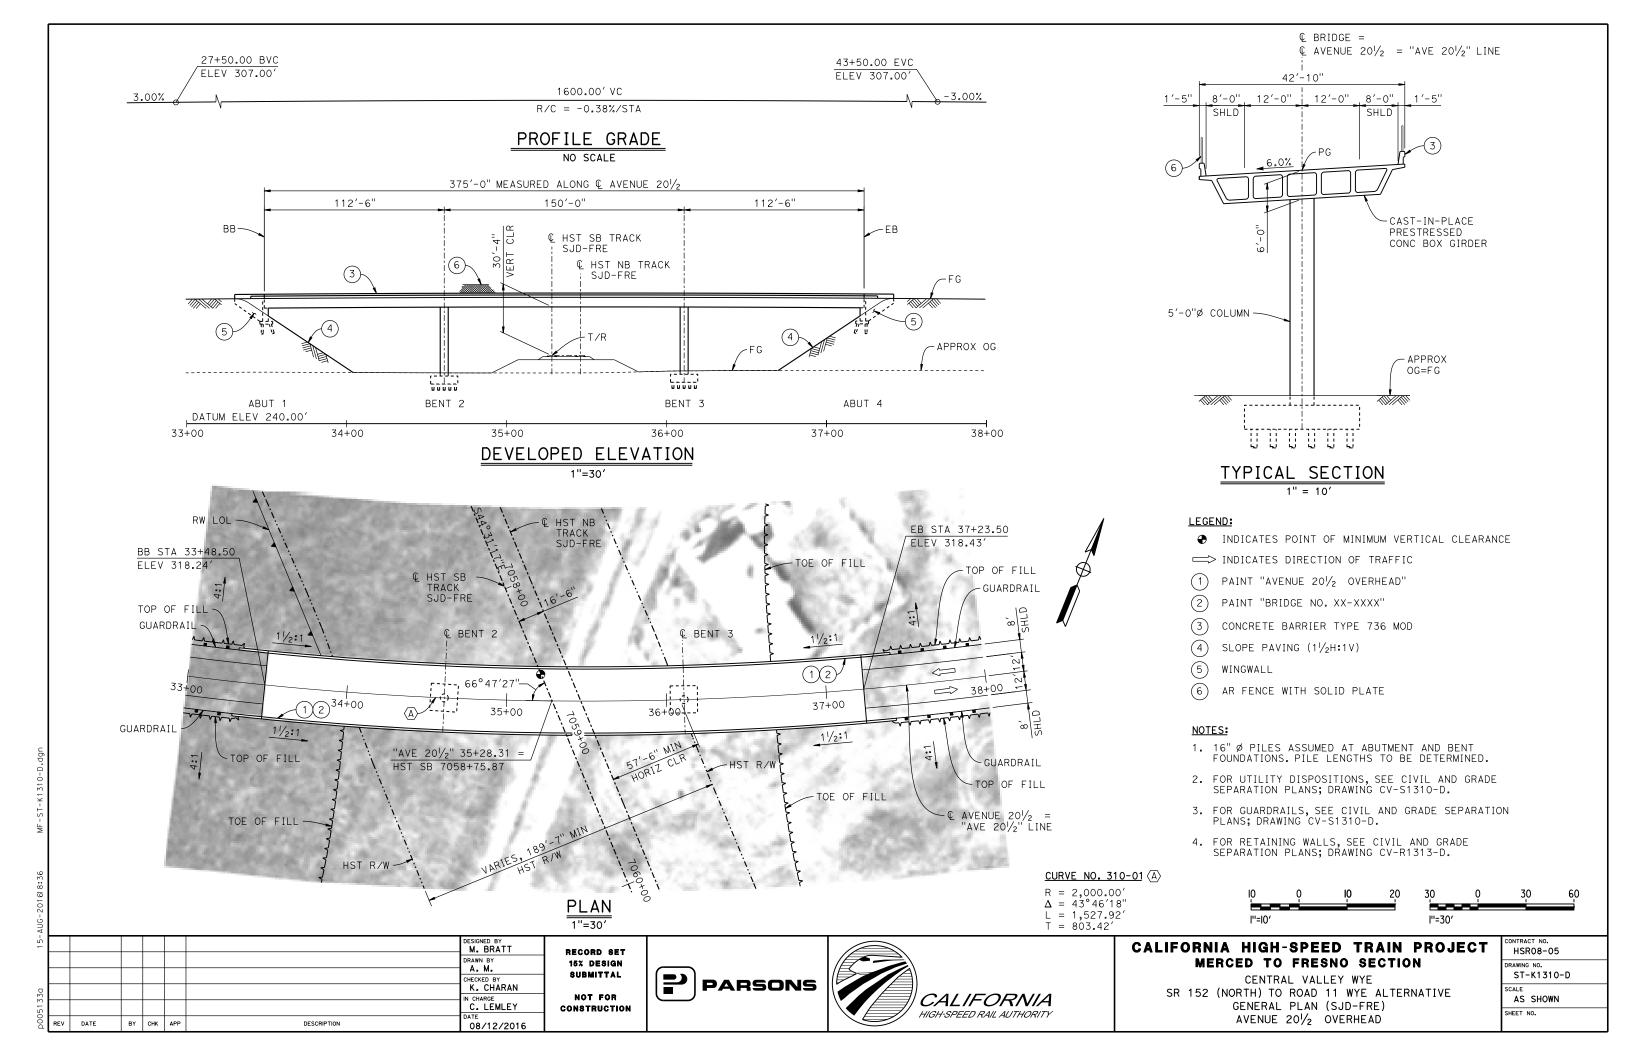

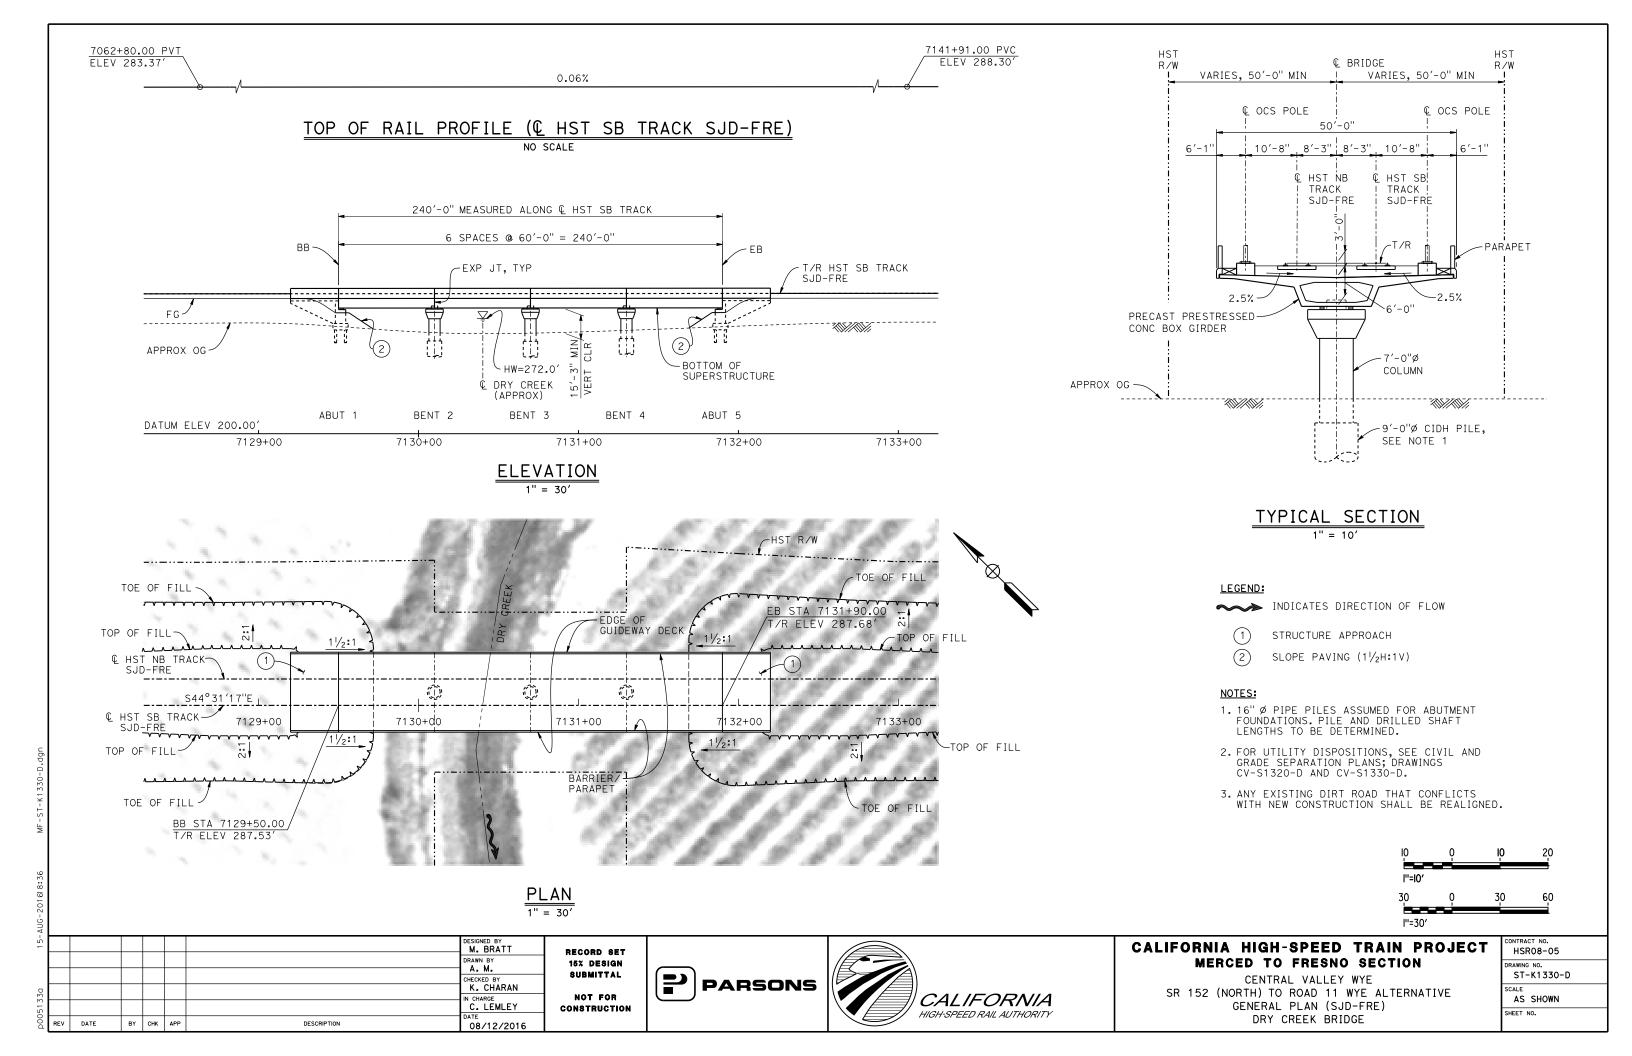

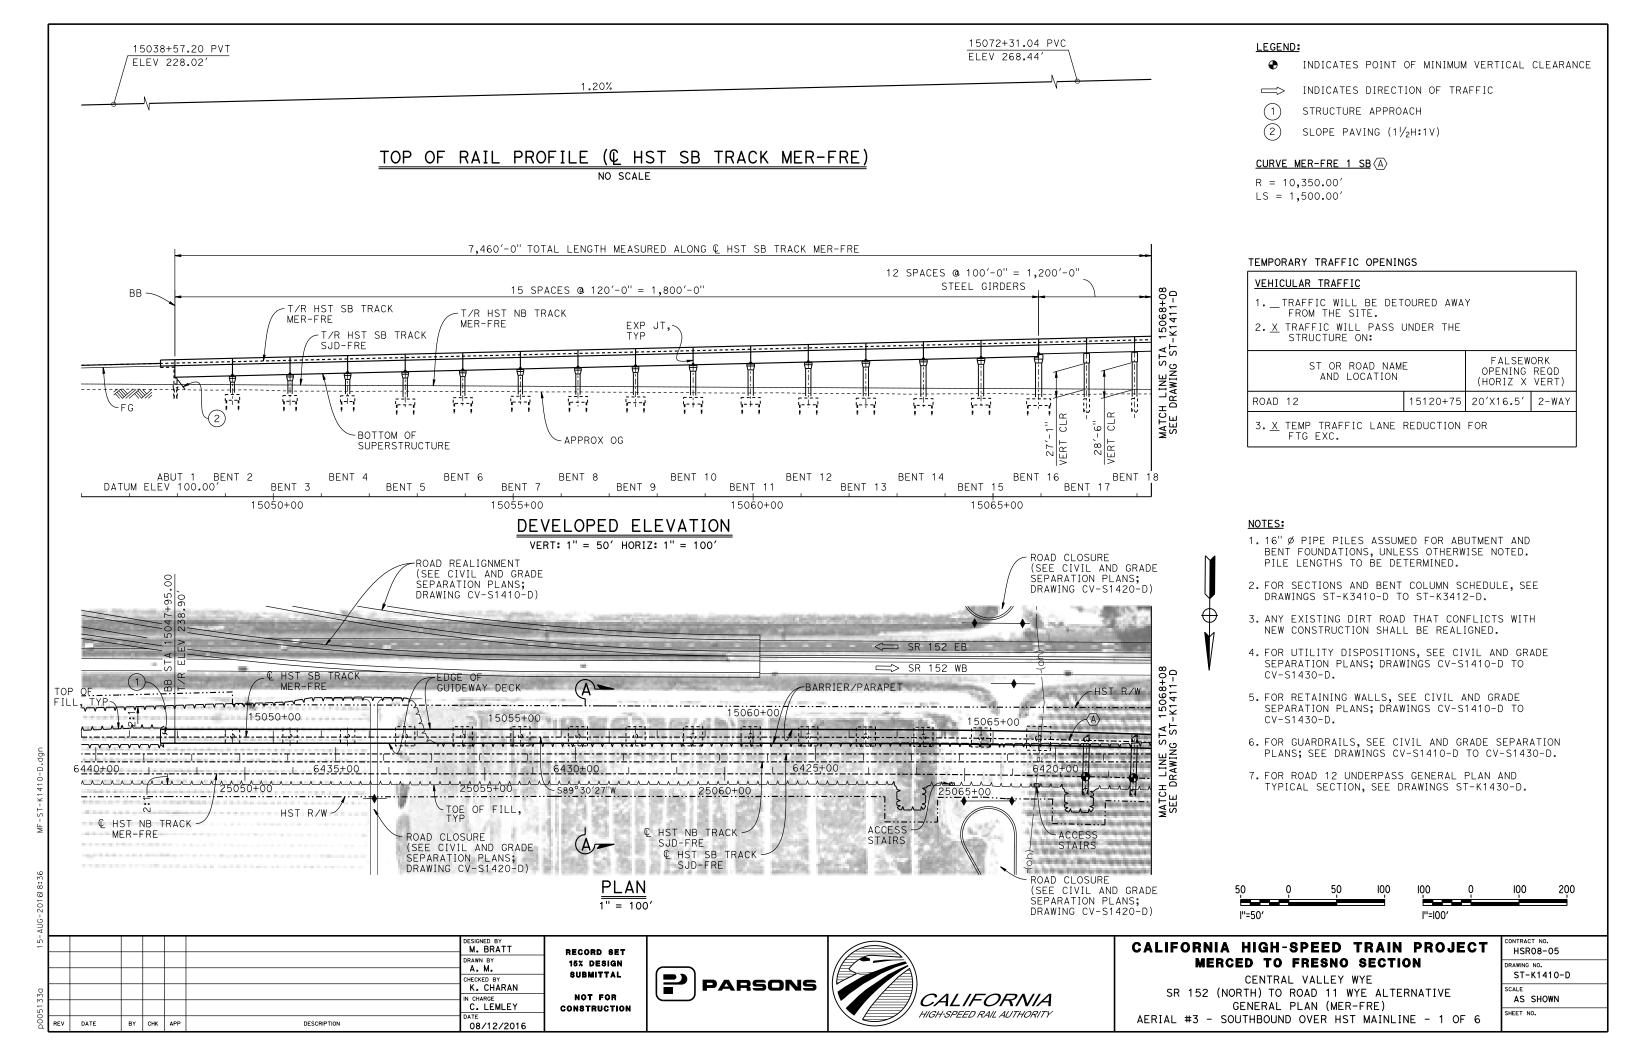

BY CHK APP

DESCRIPTION

RECORD SET

15% DESIGN

SUBMITTAL

NOT FOR

CONSTRUCTION

K. CHARAN

IN CHARGE
C. LEMLEY

08/12/2016

-0.88%

CALIFORNIA HIGH-SPEED TRAIN PROJECT

MERCED TO FRESNO SECTION

CENTRAL VALLEY WYE

SR 152 (NORTH) TO ROAD 11 WYE ALTERNATIVE

GENERAL PLAN (MER-FRE)

AERIAL #3 - SOUTHBOUND OVER HST MAINLINE - 2 OF 6

HSR08-05

AS SHOWN


ST-K1411-D

RAWING NO.

SHEET NO.

TOP OF RAIL PROFILE (HST SB TRACK MER-FRE)

NO SCALE

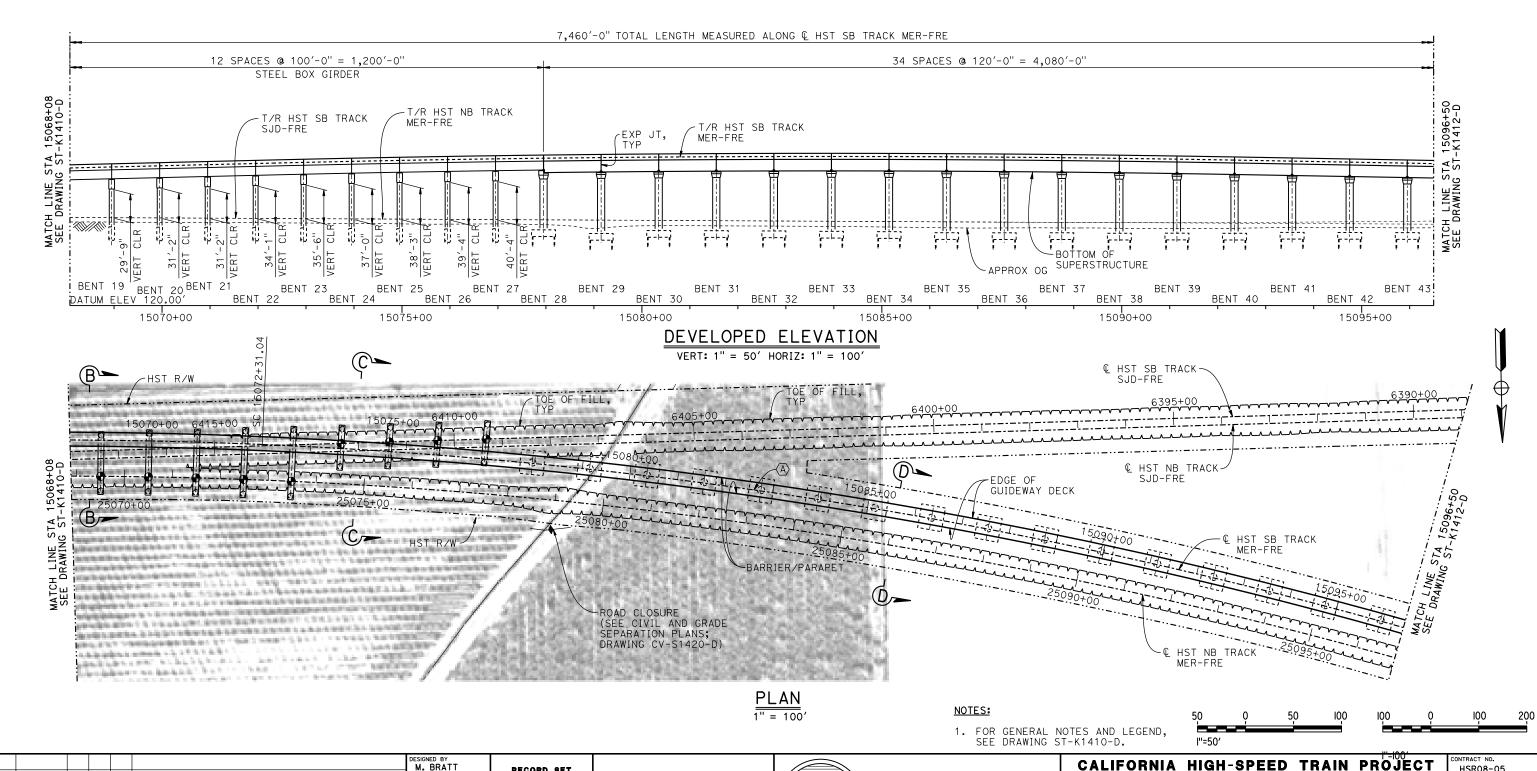

PARSONS

CALIFORNIA

HIGH-SPEED RAIL AUTHORITY

HSR08-05

AS SHOWN

ST-K1412-D

RAWING NO.

SHEET NO.

CALIFORNIA HIGH-SPEED TRAIN PROJECT

MERCED TO FRESNO SECTION

CENTRAL VALLEY WYE


SR 152 (NORTH) TO ROAD 11 WYE ALTERNATIVE


GENERAL PLAN (MER-FRE)

AERIAL #3 - SOUTHBOUND OVER HST MAINLINE - 3 OF 6

TOP OF RAIL PROFILE (& HST SB TRACK MER-FRE)

NO SCALE

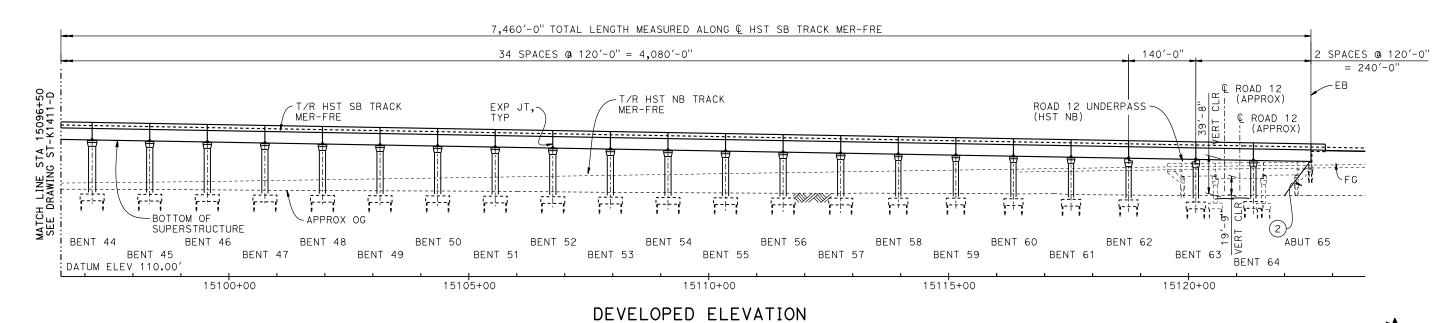

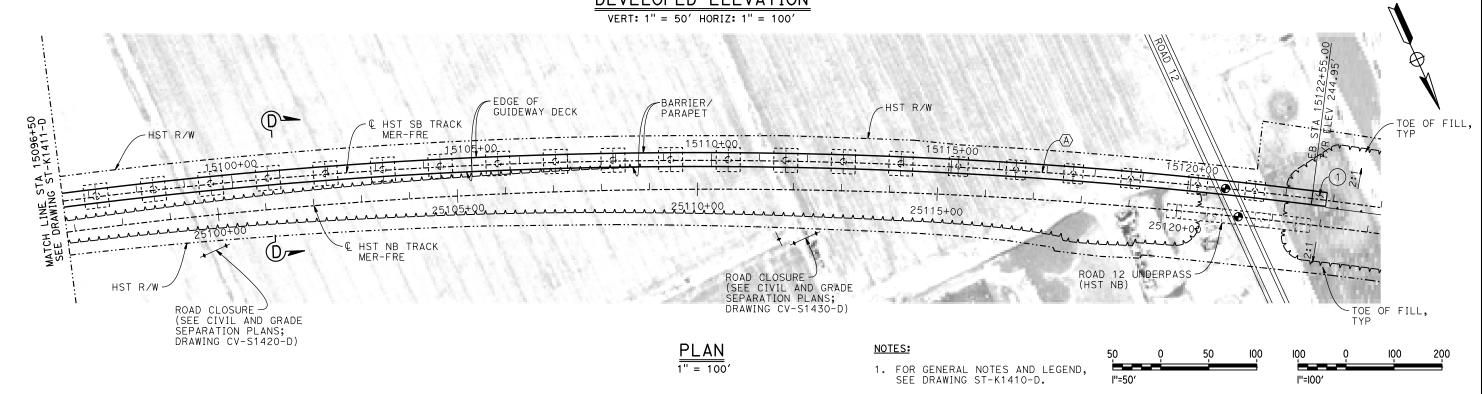

CALIFORNIA

HIGH-SPEED RAIL AUTHORITY

PARSONS

M. BRATT

CHECKED BY

IN CHARGE
C. LEMLEY

08/12/2016

DRAWN BY

DATE

BY CHK APP

DESCRIPTION


RECORD SET

15% DESIGN

SUBMITTAL

NOT FOR

CONSTRUCTION

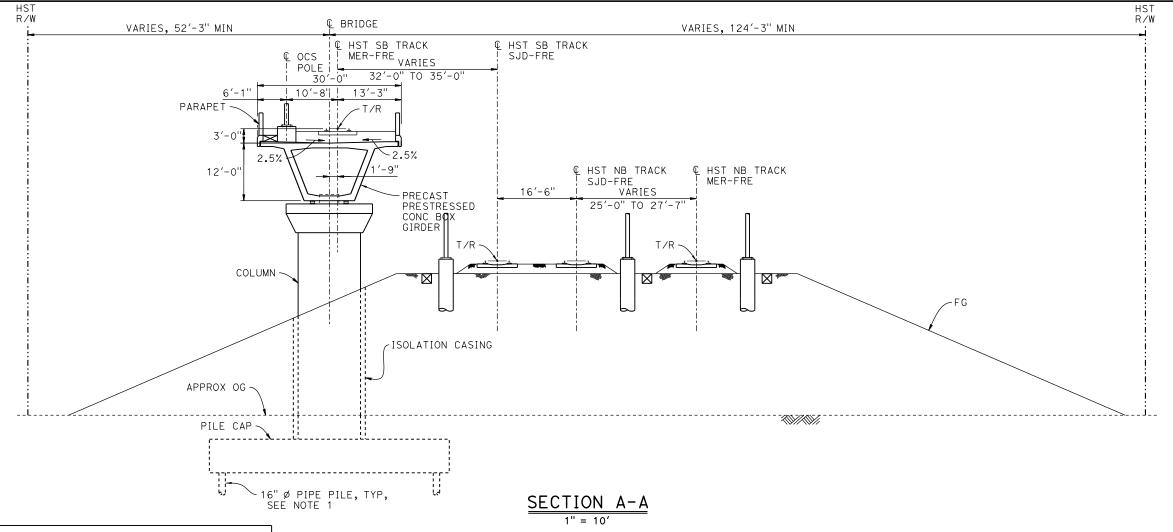

BENT COLUMN SCHEDULE							
BENT	COLUMN TYPE	CIDH TYPE	"A"	TYP SECTION, SHEET			
2 - 4	8'-0" Ø			A-A, ST-K3410-D			
5 - 9	9'-0" Ø			A-A, ST-K3410-D			
10 - 15	11'-0" Ø			A-A, ST-K3410-D			
16	13'-0" Ø			A-A, ST-K3410-D			
17	2 - 10'-0" Ø	12'-0" Ø	108'-0"	B-B, ST-K3411-D			
18	2 - 10'-0" Ø	12'-0" ø	111'-0"	B-B, ST-K3411-D			
19	2 - 10'-0" Ø	12'-0" Ø	115′-0"	B-B, ST-K3411-D			
20	2 - 10'-0" Ø	12'-0" ø	120'-0"	B-B, ST-K3411-D			
21	2 - 10'-0" Ø	12'-0" Ø	124'-0"	B-B, ST-K3411-D			
22	2 - 10'-0" Ø	12'-0" ø	130′-0"	B-B, ST-K3411-D			
23	2 - 10'-0" Ø	12'-0" Ø	137′-0"	B-B, ST-K3411-D			
24 - 27	2 - 10'-0" Ø	12'-0" ø	78′-0"	C-C, ST-K3412-D			
28 - 45	15′-0" ø			D-D, ST-K3412-D			
46 - 58	13'-0" Ø			D-D, ST-K3412-D			
59 - 64	11'-0" Ø			D-D, ST-K3412-D			

NOTES:

- 1. PILE LENGTHS TO BE DETERMINED.
- 2. FOR TRACK SUPERELEVATION DETAILS, SEE ALIGNMENT AND TYPICAL SECTION PLANS; DRAWING TT-B0054-D.

10	ọ	Ιρ	20
l''=10 <i>'</i>			

5							DESIGNED BY M. BRATT	
							DRAWN BY	1
							CHECKED BY	1
20							K. CHARAN IN CHARGE	ł
513							C. LEMLEY] (
000	REV	DATE	BY	снк	APP	DESCRIPTION	08/12/2016	

RECORD SET
15% DESIGN
SUBMITTAL
NOT FOR
CONSTRUCTION








CALIFORNIA HIGH-SPEED TRAIN PROJECT MERCED TO FRESNO SECTION


CENTRAL VALLEY WYE
SR 152 (NORTH) TO ROAD 11 WYE ALTERNATIVE
TYPICAL SECTION (MER-FRE)
AERIAL #3 - SOUTHBOUND OVER HST MAINLINE - 4 OF 6


CONTRACT NO.
HSR08-05
DRAWING NO.
ST-K3410-D
SCALE
AS SHOWN
SHEET NO.

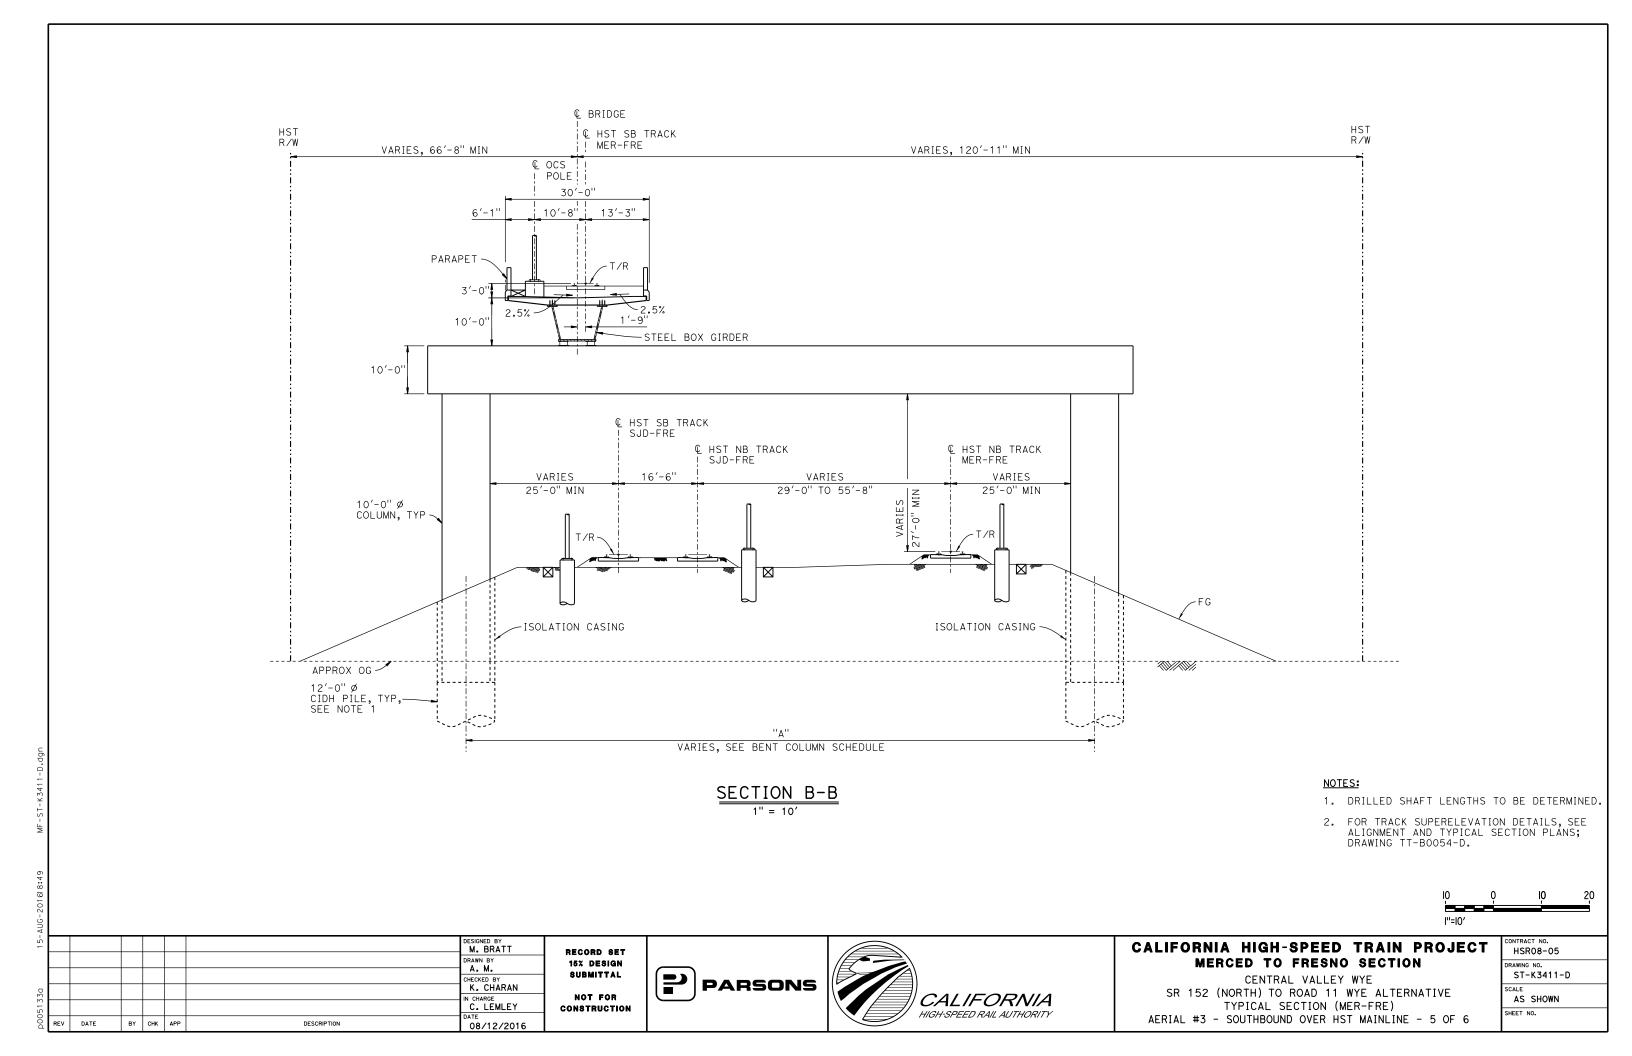


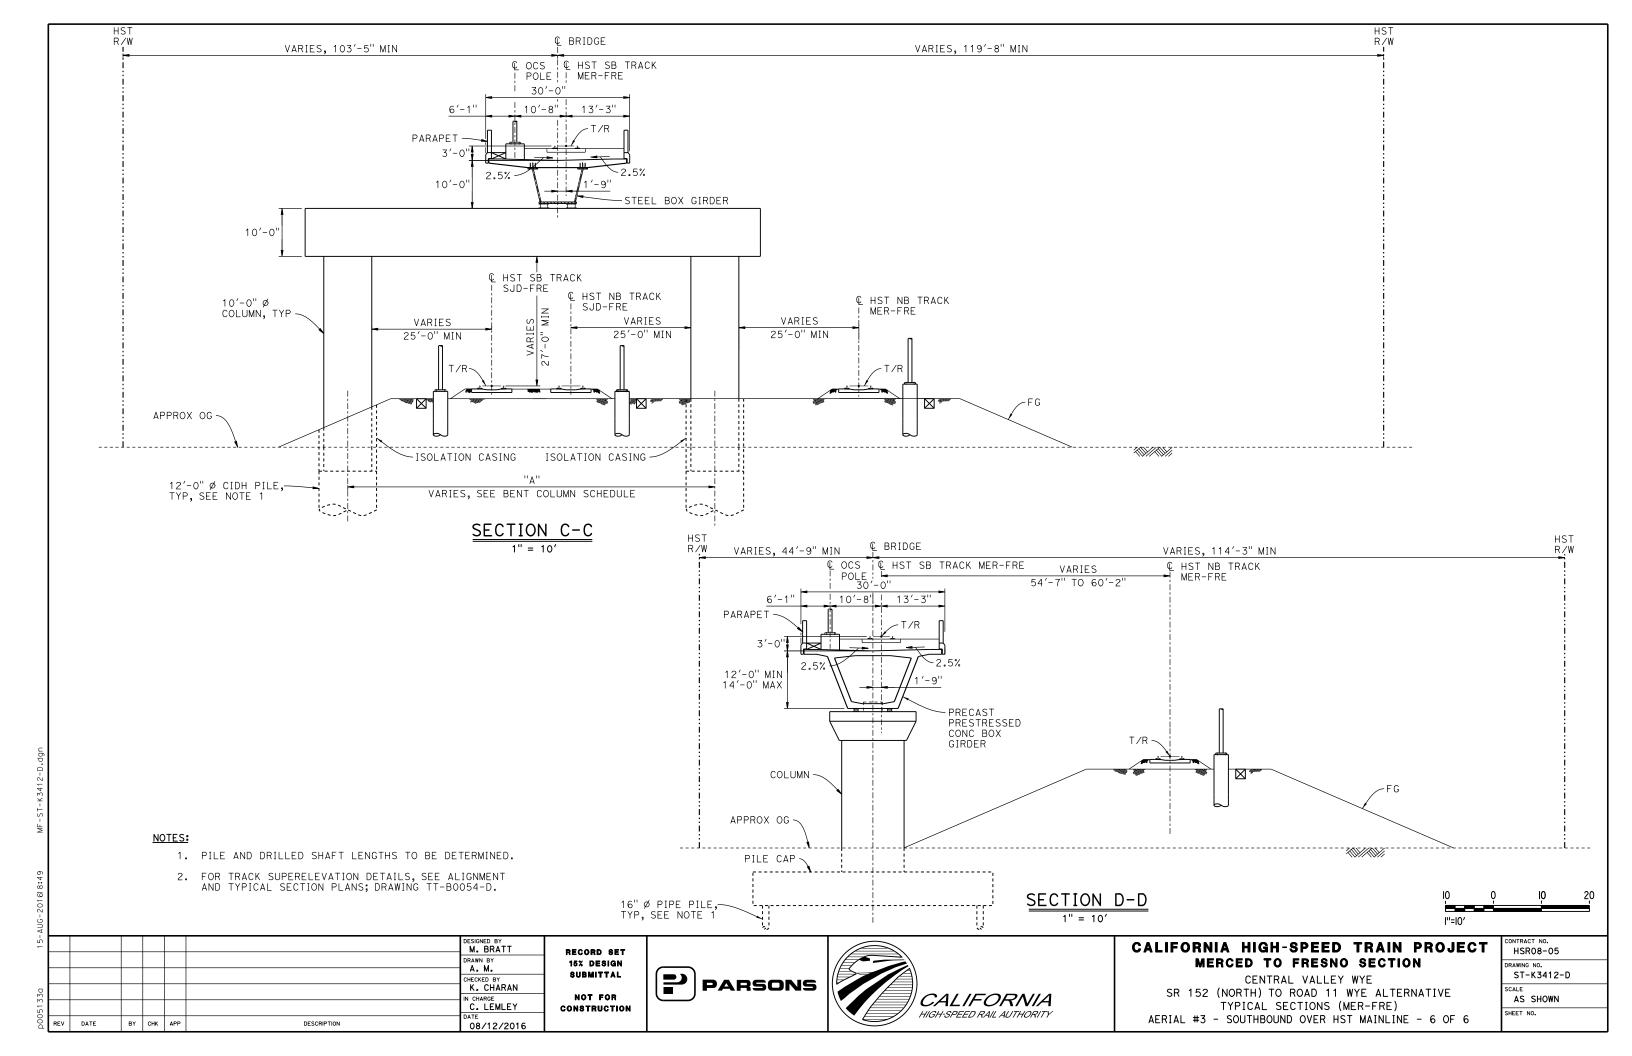

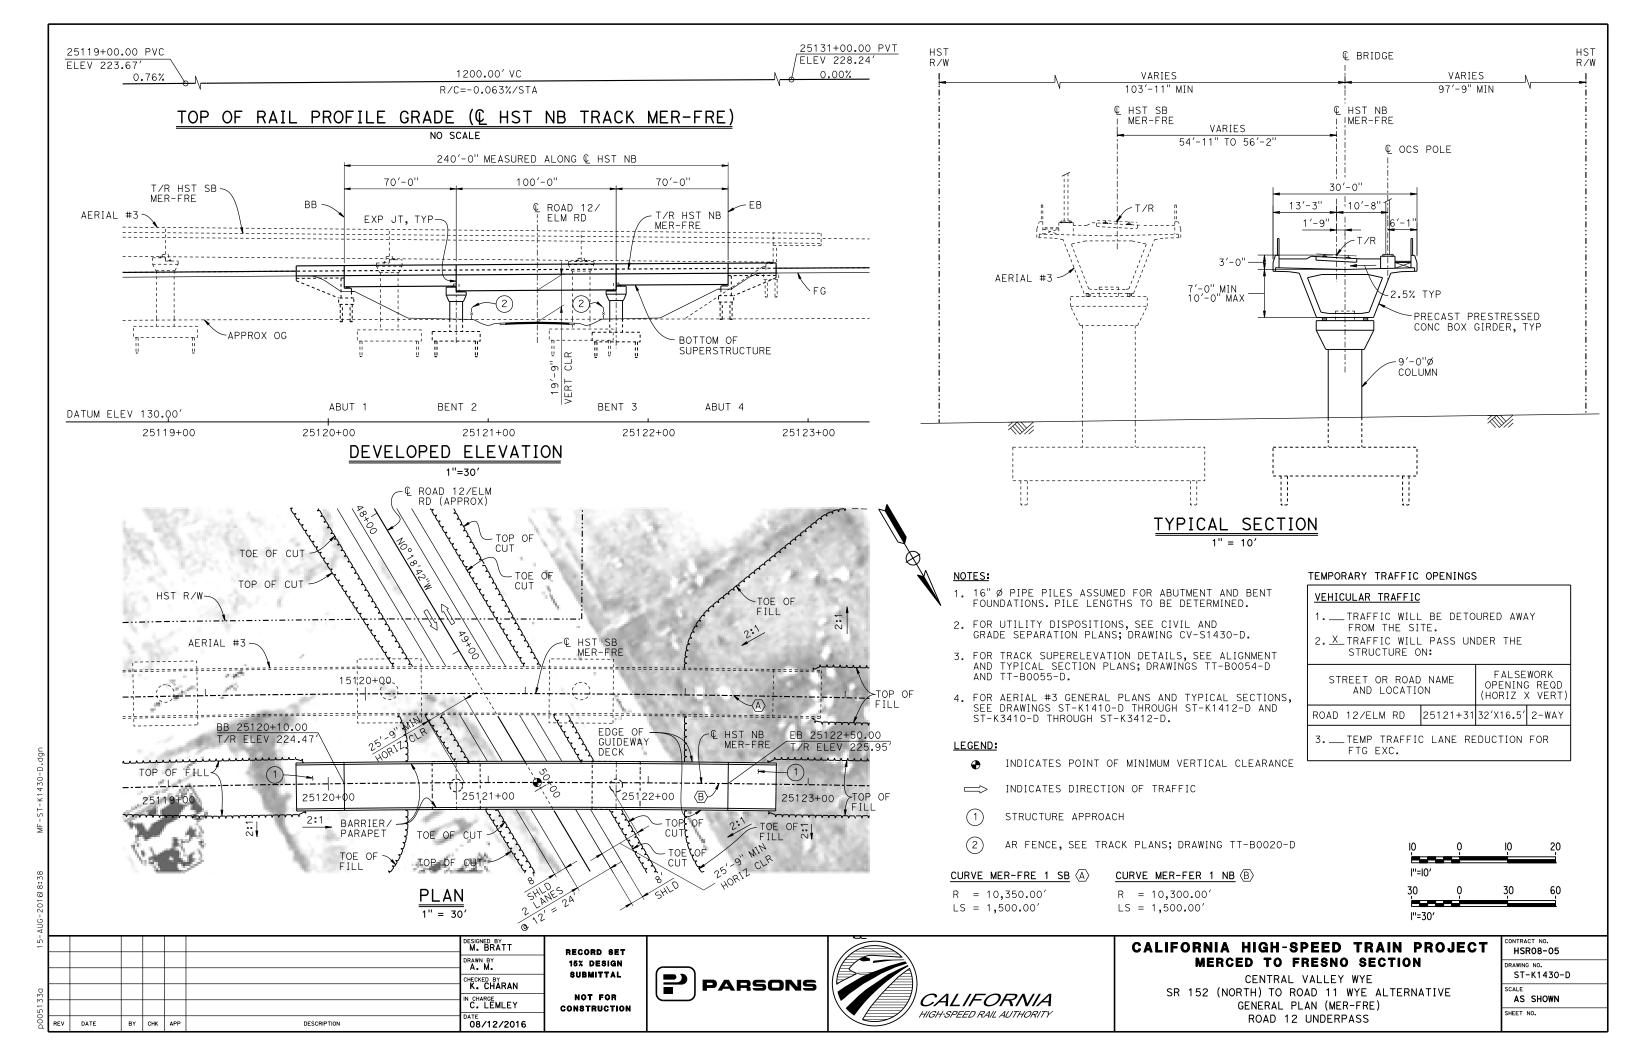

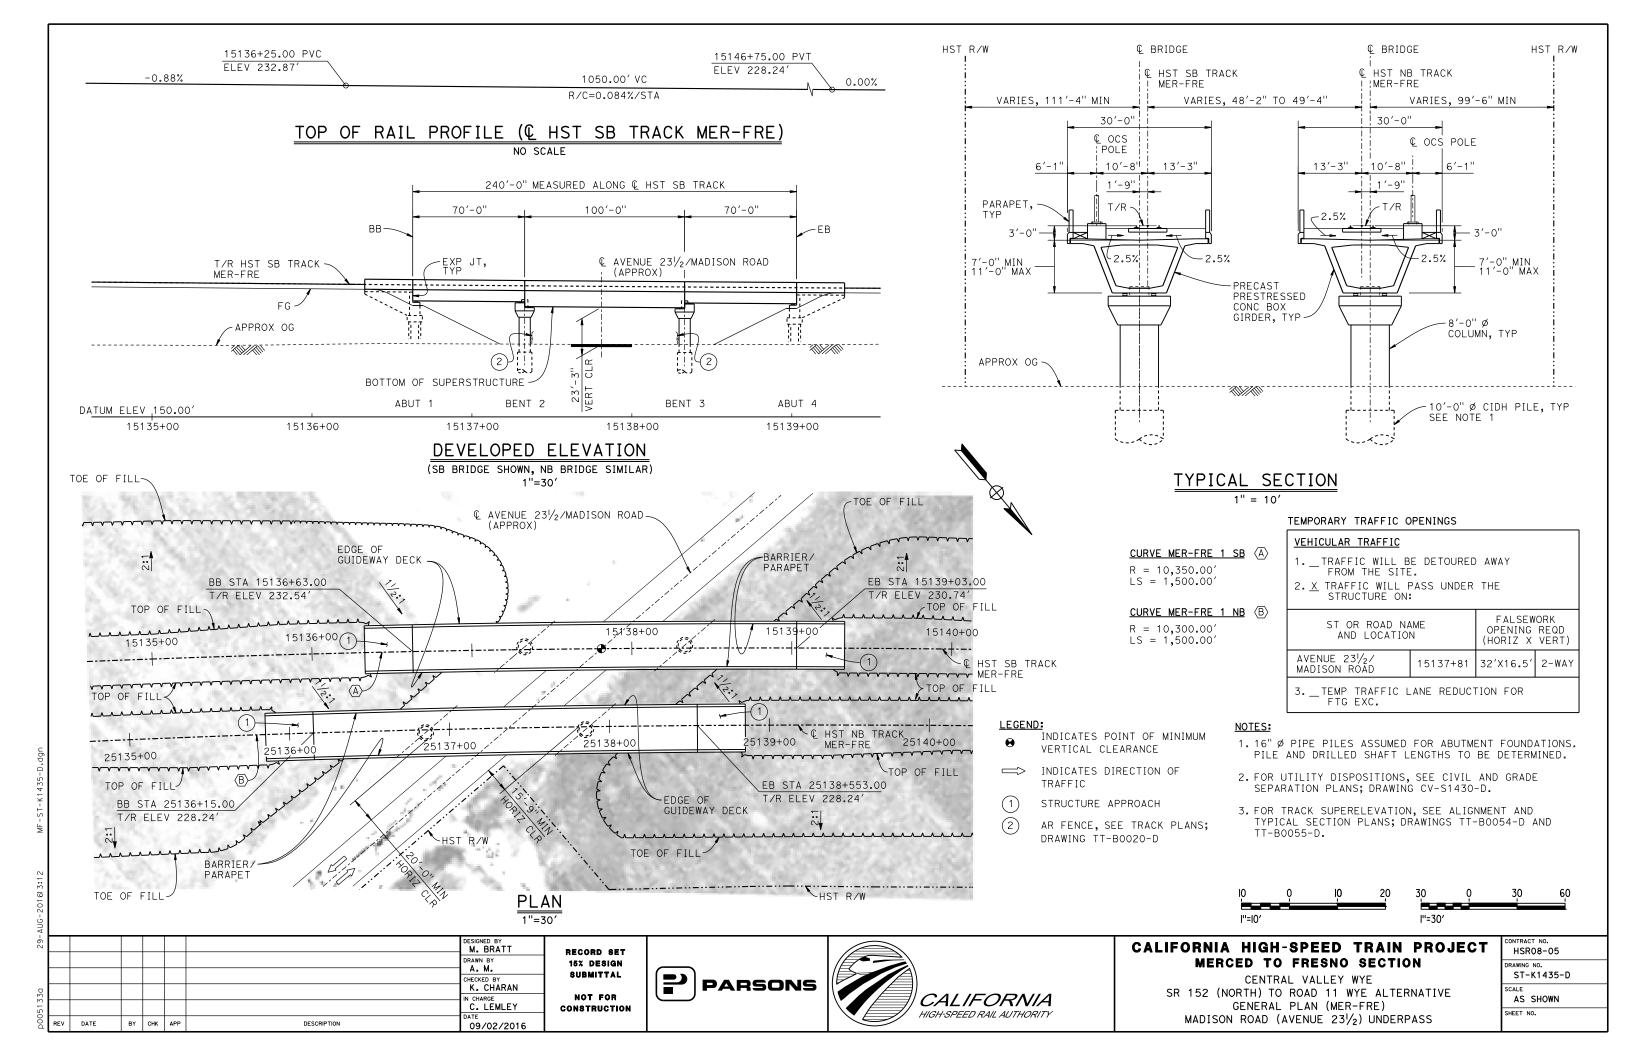

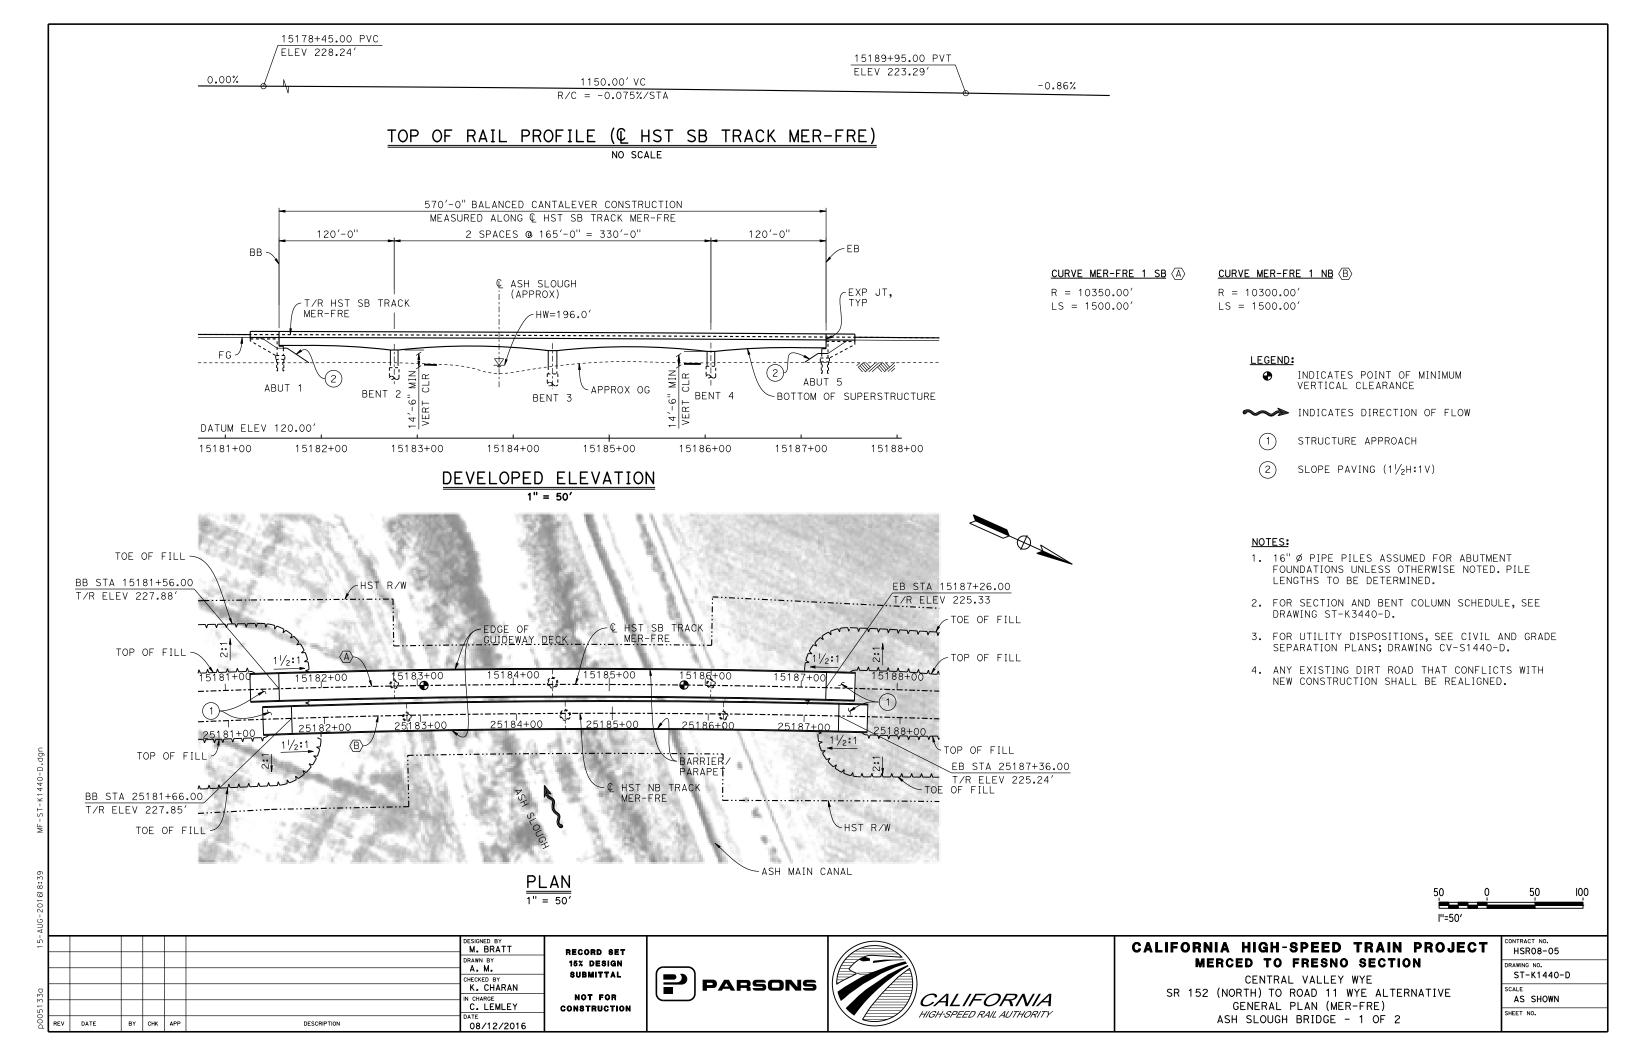

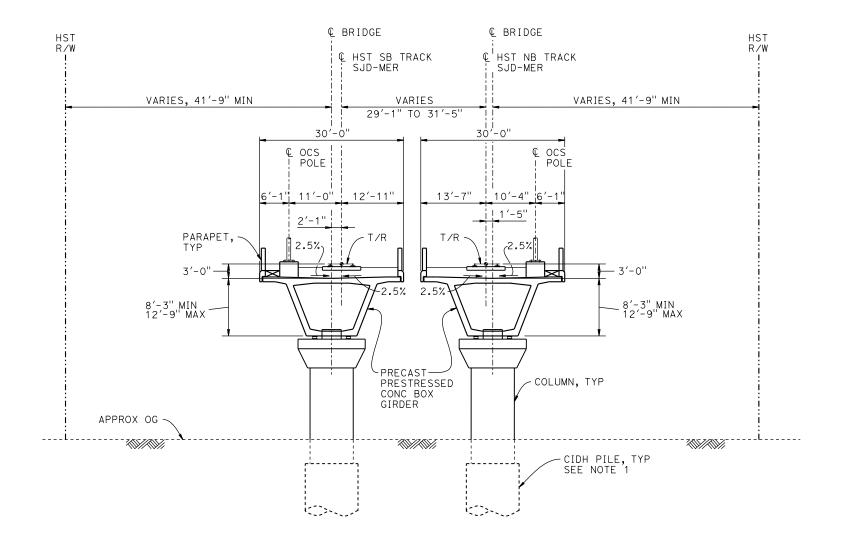

	BENT COLUMN S	SCHEDULE
BENT	COLUMN TYPE	CIDH TYPE
2	7'-0" Ø	9'-0" Ø
3	9'-0" ø	11'-0" Ø
4	7'-0" Ø	9'-0" Ø

TYPICAL SECTION

1" = 10'

NOTE:

- 1. 16" Ø PIPE PILES ASSUMED FOR ABUTMENT FOUNDATIONS. PILE AND DRILLED SHAFT LENGTHS TO BE DETERMINED.
- 2. FOR TRACK SUPERELEVATION DETAILS, SEE ALIGNMENT AND TYPICAL SECTION PLANS; DRAWING TT-B0054-D AND TT-B0055-D.



ΑU								
15-							DESIGNED BY M. BRATT	R
							DRAWN BY A. M.	"
0							CHECKED BY K. CHARAN	'
5133							IN CHARGE C. LEMLEY	 co
00d	REV	DATE	BY	снк	APP	DESCRIPTION	08/12/2016	

RECORD SET
15% DESIGN
SUBMITTAL
NOT FOR
CONSTRUCTION







CALIFORNIA HIGH-SPEED TRAIN PROJECT MERCED TO FRESNO SECTION

CENTRAL VALLEY WYE
SR 152 (NORTH) TO ROAD 11 WYE ALTERNATIVE
TYPICAL SECTION (MER-FRE)
ASH SLOUGH BRIDGE - 2 OF 2

CONTRACT NO. HSR08-05
DRAWING NO.
ST-K3440-D
SCALE
AS SHOWN
SHEET NO.

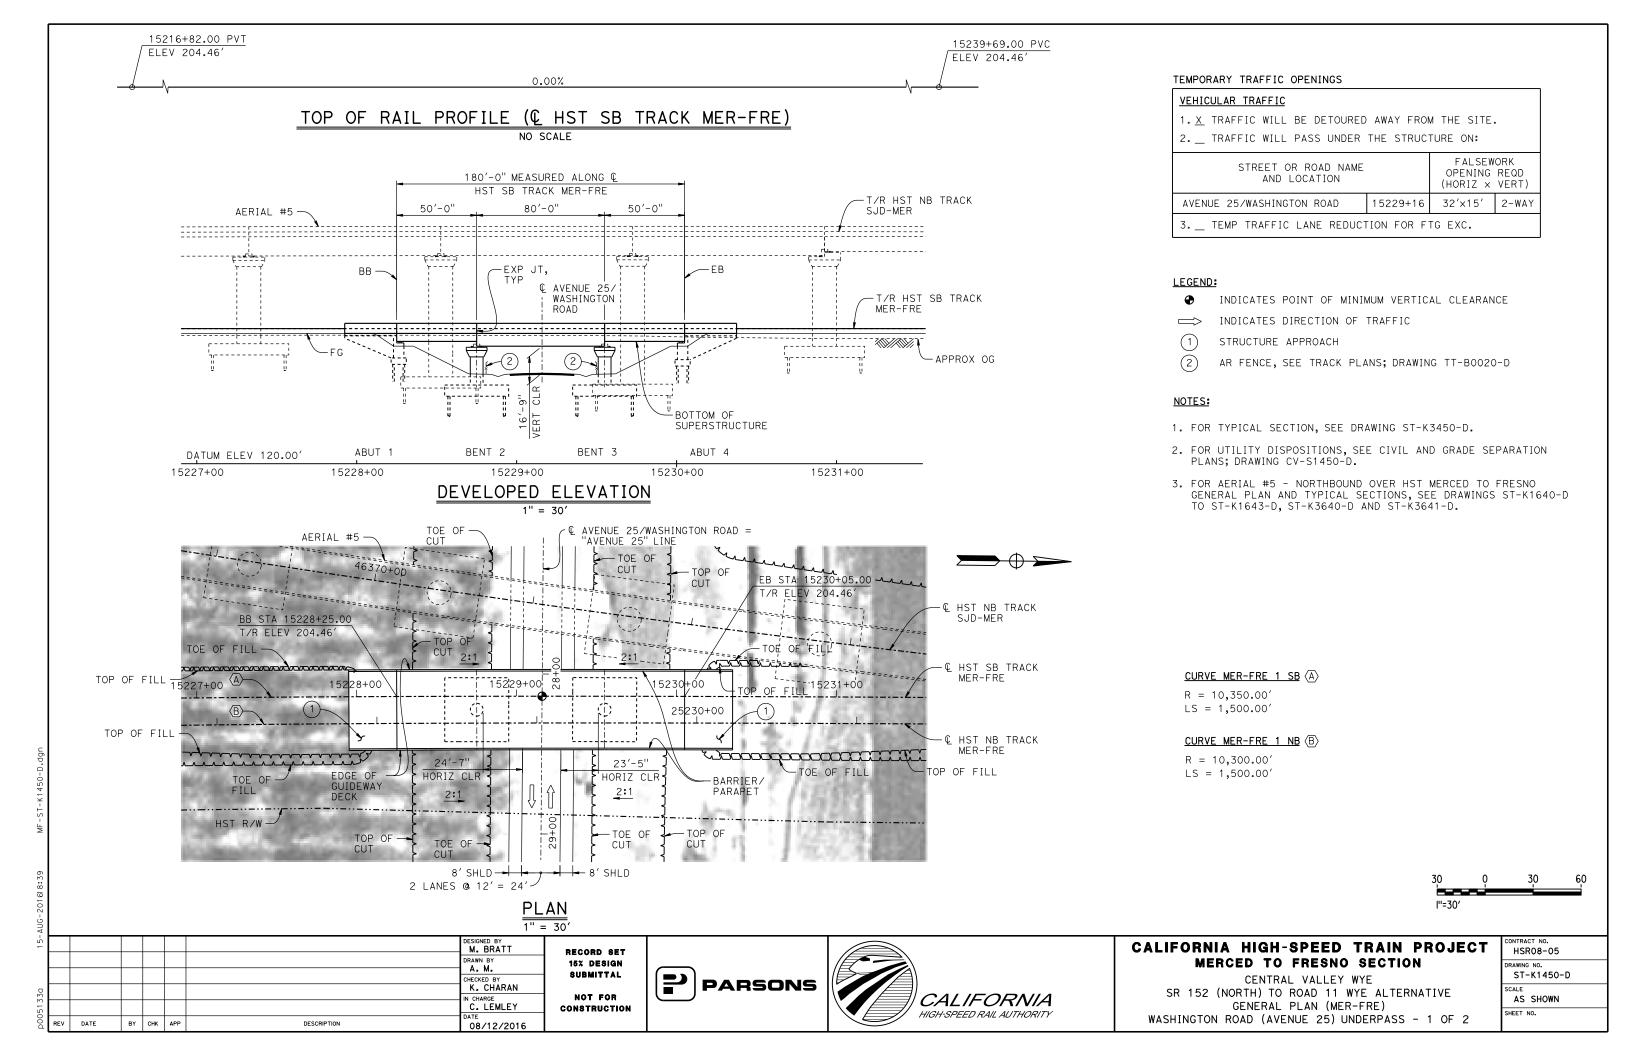

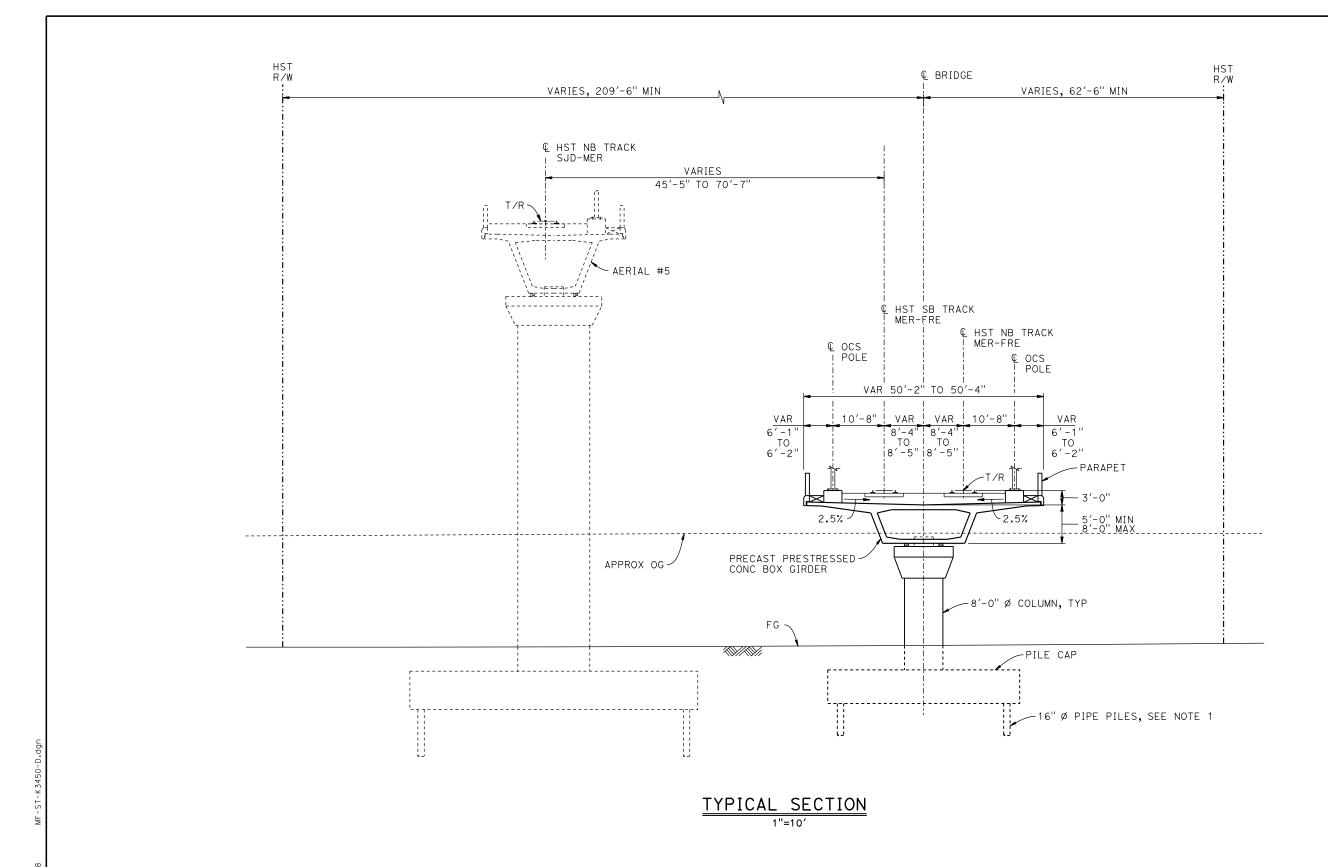

NOTES:

- 1. 16" Ø PIPE PILES ASSUMED FOR ABUTMENT AND BENT FOUNDATIONS. PILE LENGTHS TO BE DETERMINED.
- FOR TRACK SUPERELEVATION DETAILS, SEE ALIGNMENT AND TYPICAL SECTION PLANS; DRAWINGS TT-B0054-D AND TT-B0055-D.



| DESIGNED BY | M. BRATT | DRAWN BY | A. M. | CHECKED BY | K. CHARAN | IN CHARGE | C. LEMLEY | DATE | BY CHK APP | DESCRIPTION | DATE | O8/12/2016 |

RECORD SET
15% DESIGN
SUBMITTAL
NOT FOR
CONSTRUCTION







CALIFORNIA HIGH-SPEED TRAIN PROJECT MERCED TO FRESNO SECTION


CENTRAL VALLEY WYE
SR 152 (NORTH) TO ROAD 11 WYE ALTERNATIVE
TYPICAL SECTION (MER-FRE)
WASHINGTON ROAD (AVENUE 25) UNDERPASS - 2 OF 2

CONTRACT NO.
HSR08-05
DRAWING NO.
ST-K3450-D
SCALE
AS SHOWN
SHEET NO.

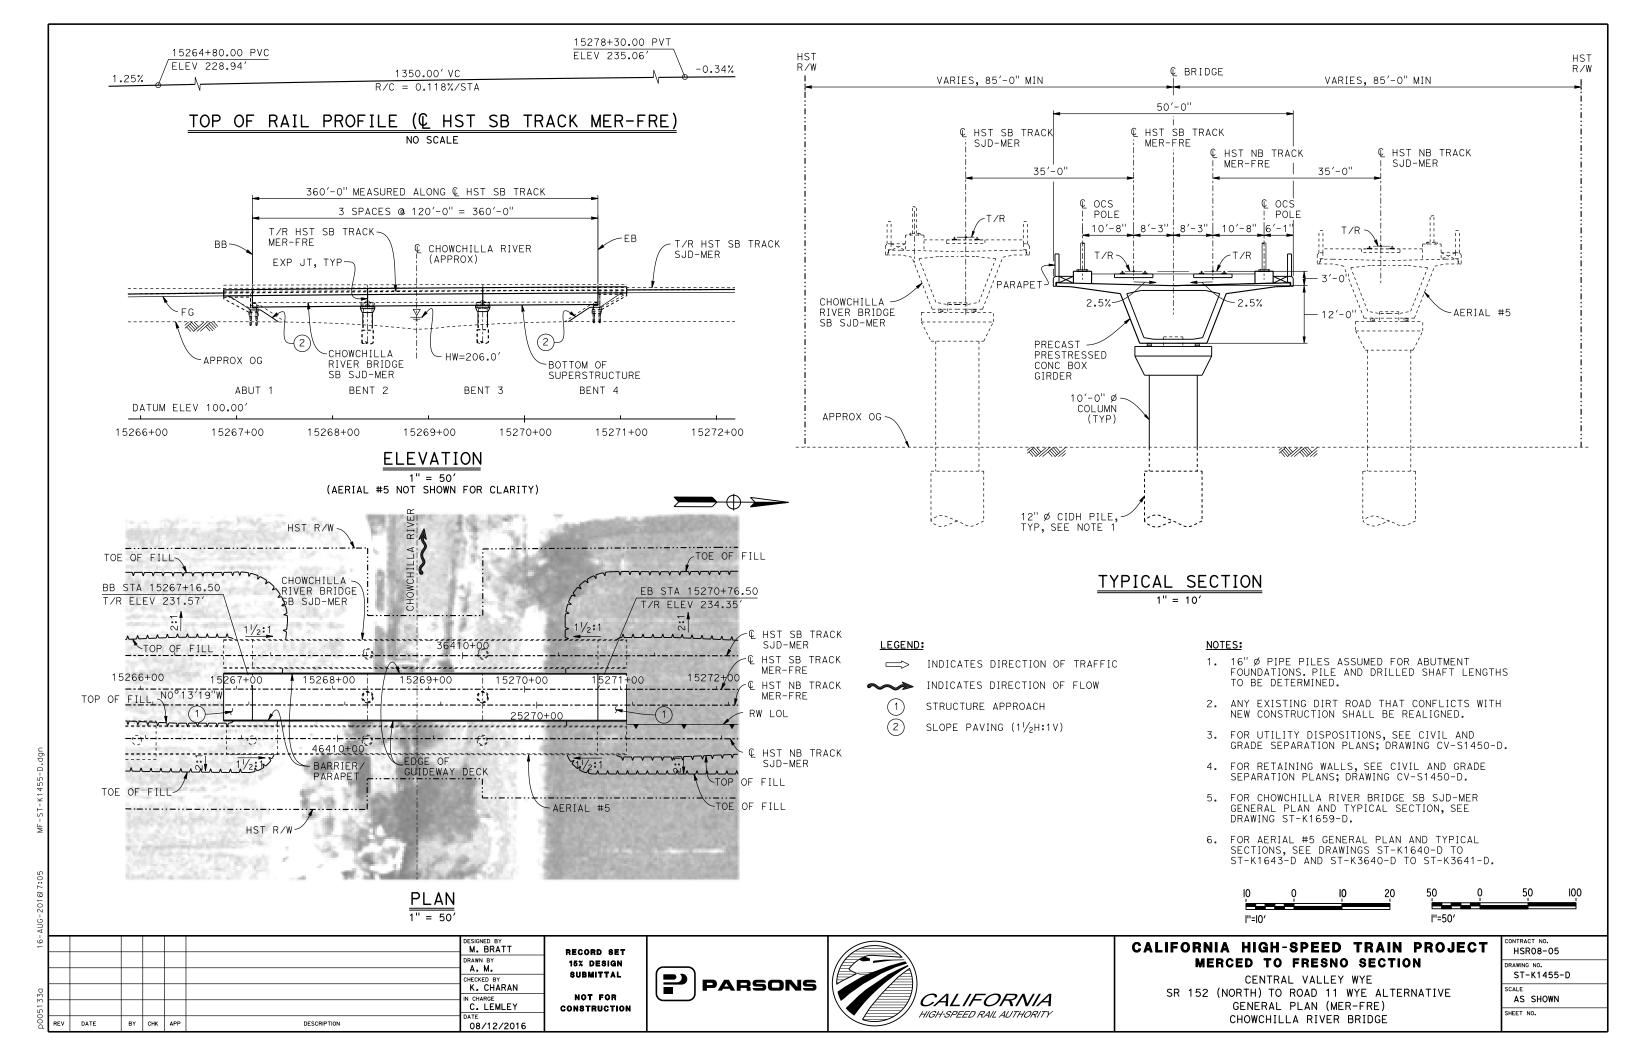

TOP OF RAIL PROFILE (© HST SB TRACK MER-FRE) NO SCALE

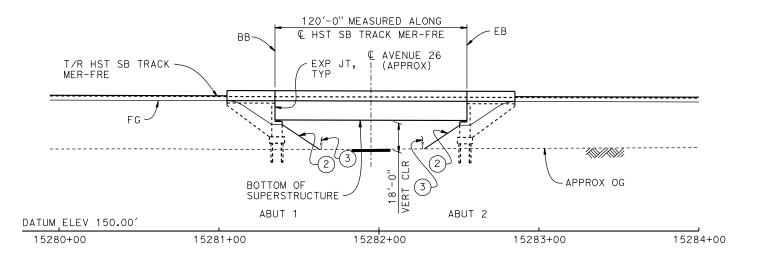

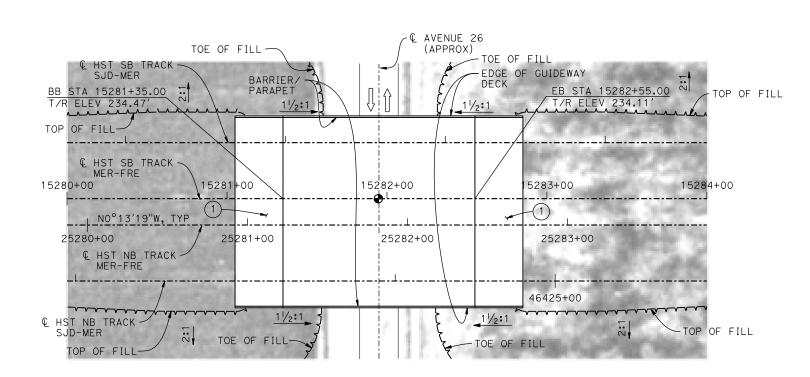

 $\frac{\mathsf{PLAN}}{\mathsf{1''} = 30'}$

08/12/2016

ELEVATION

1" = 30'

HST R/W € BRIDGE HST_R/W VARIES VARIES 150'-8" MIN 130'-0" MIN 120'-0" © HST SB TRACK | MER-FRE € HST SB TRACK SJD-MER HST NB TRACK **Q** HST NB TRACK MER-FRE 35'-0" SJD-MER 35'-0" © OCS ! POLE C OCS © OCS ! POLE POLE POLE -1" 10′-8" 10'-8" 10'-8" 6'-1" PARAPET 2.5%

TYPICAL SECTION

LEGEND:


- INDICATES POINT OF MINIMUM VERTICAL CLEARANCE
- ⇒ INDICATES DIRECTION OF TRAFFIC
- 1) STRUCTURE APPROACH
- 2 SLOPE PAVING $(1\frac{1}{2}H:1V)$
- AR FENCE, SEE TRACK PLANS DRAWING TT-B0020-D

NOTES:

- 16" Ø PIPE PILES ASSUMED FOR ABUTMENT FOUNDATIONS. PILE LENGTHS TO BE DETERMINED.
- 2. FOR UTILITY DISPOSITIONS, SEE CIVIL AND GRADE SEPARATION PLANS; DRAWING CV-S1460-D.
- 3. ANY EXISTING DIRT ROAD THAT CONFLICTS WITH NEW CONSTRUCTION SHALL BE REALIGNED.

TEMPORARY TRAFFIC OPENINGS

VEHICULAR TRAFFIC								
1TRAFFIC WILL BE DETOURED AWAY								
2. X TRAFFIC WILL PASS UNDER THE STRUCTURE ON:								
ST OR ROAD NAME AND LOCATION		FALSEWO OPENING (HORIZ X	REQD					
AVENUE 26	15281+95	32′X16.5′	2-WAY					
3TEMP TRAFFIC LANE REDUCTION FOR FTG EXC.								

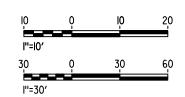

			DESIGNED BY M. BRATT	
			DRAWN BY	
			CHECKED BY	
			K. CHARAN IN CHARGE	
			C. LEMLEY	

DESCRIPTION

DATE

BY CHK APP

RECORD SET
15% DESIGN
SUBMITTAL
NOT FOR
CONSTRUCTION








CALIFORNIA HIGH-SPEED TRAIN PROJECT MERCED TO FRESNO SECTION

CENTRAL VALLEY WYE
SR 152 (NORTH) TO ROAD 11 WYE ALTERNATIVE
GENERAL PLAN (MER-FRE)
AVENUE 26 UNDERPASS

CONTRACT NO.
HSR08-05
DRAWING NO.
ST-K1460-D
SCALE
AS SHOWN
SHEET NO.

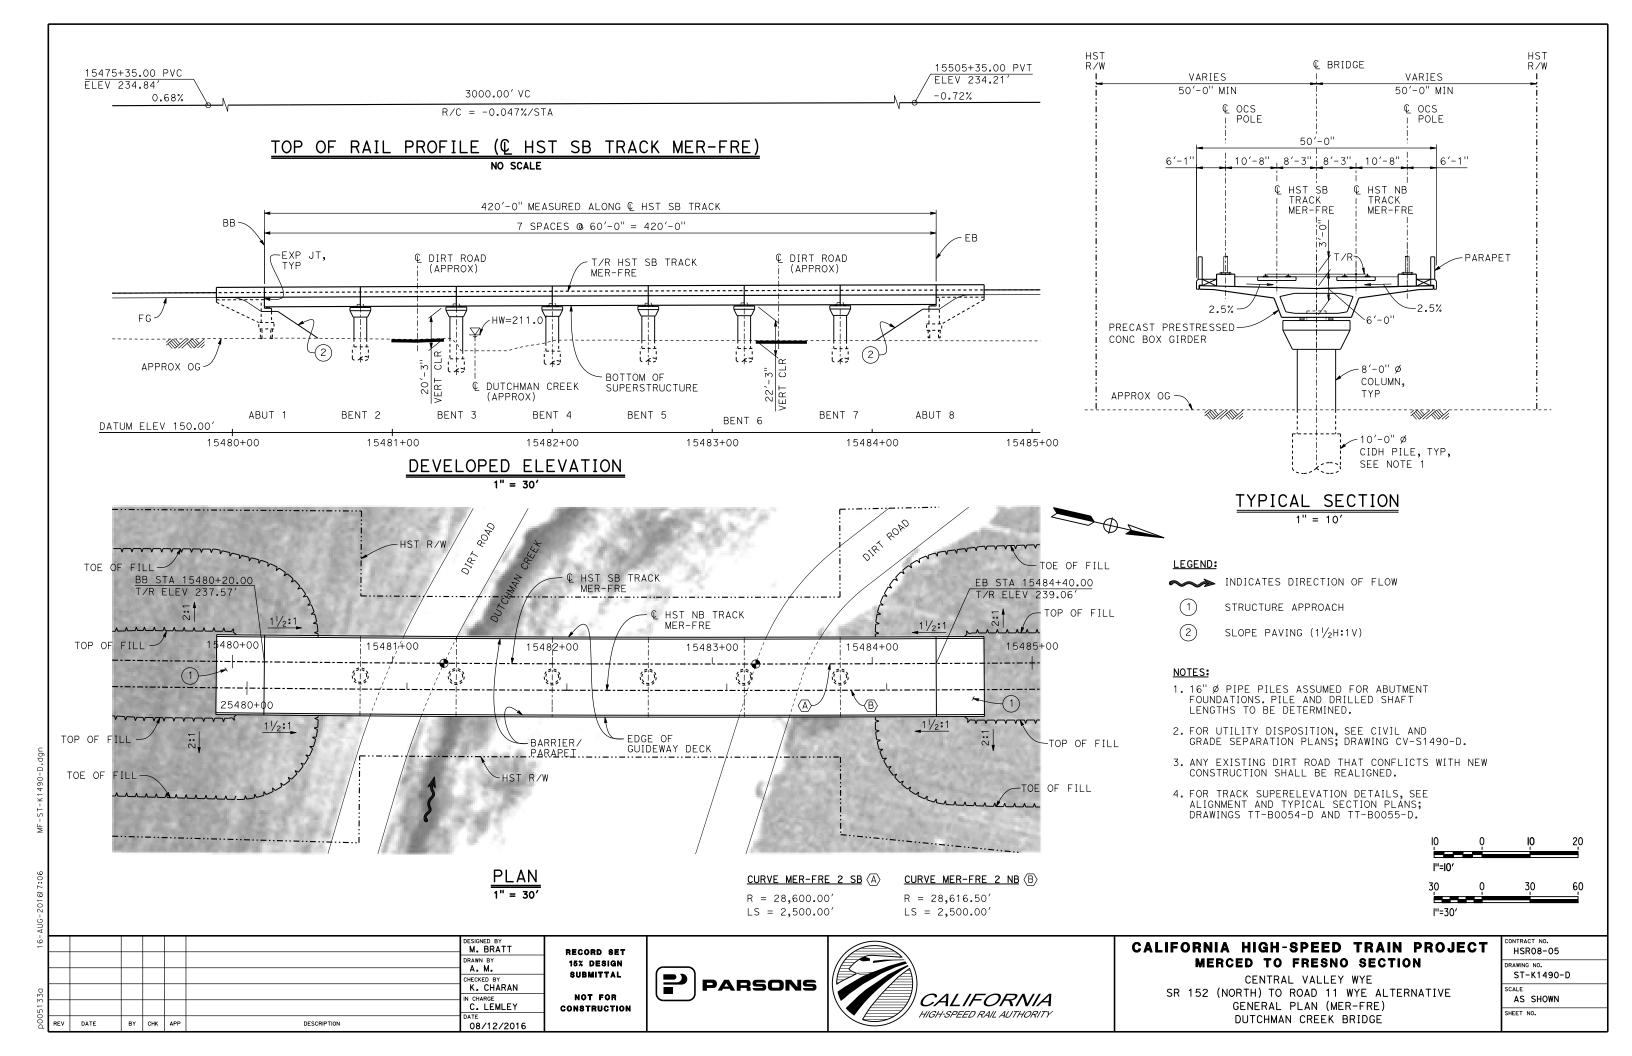

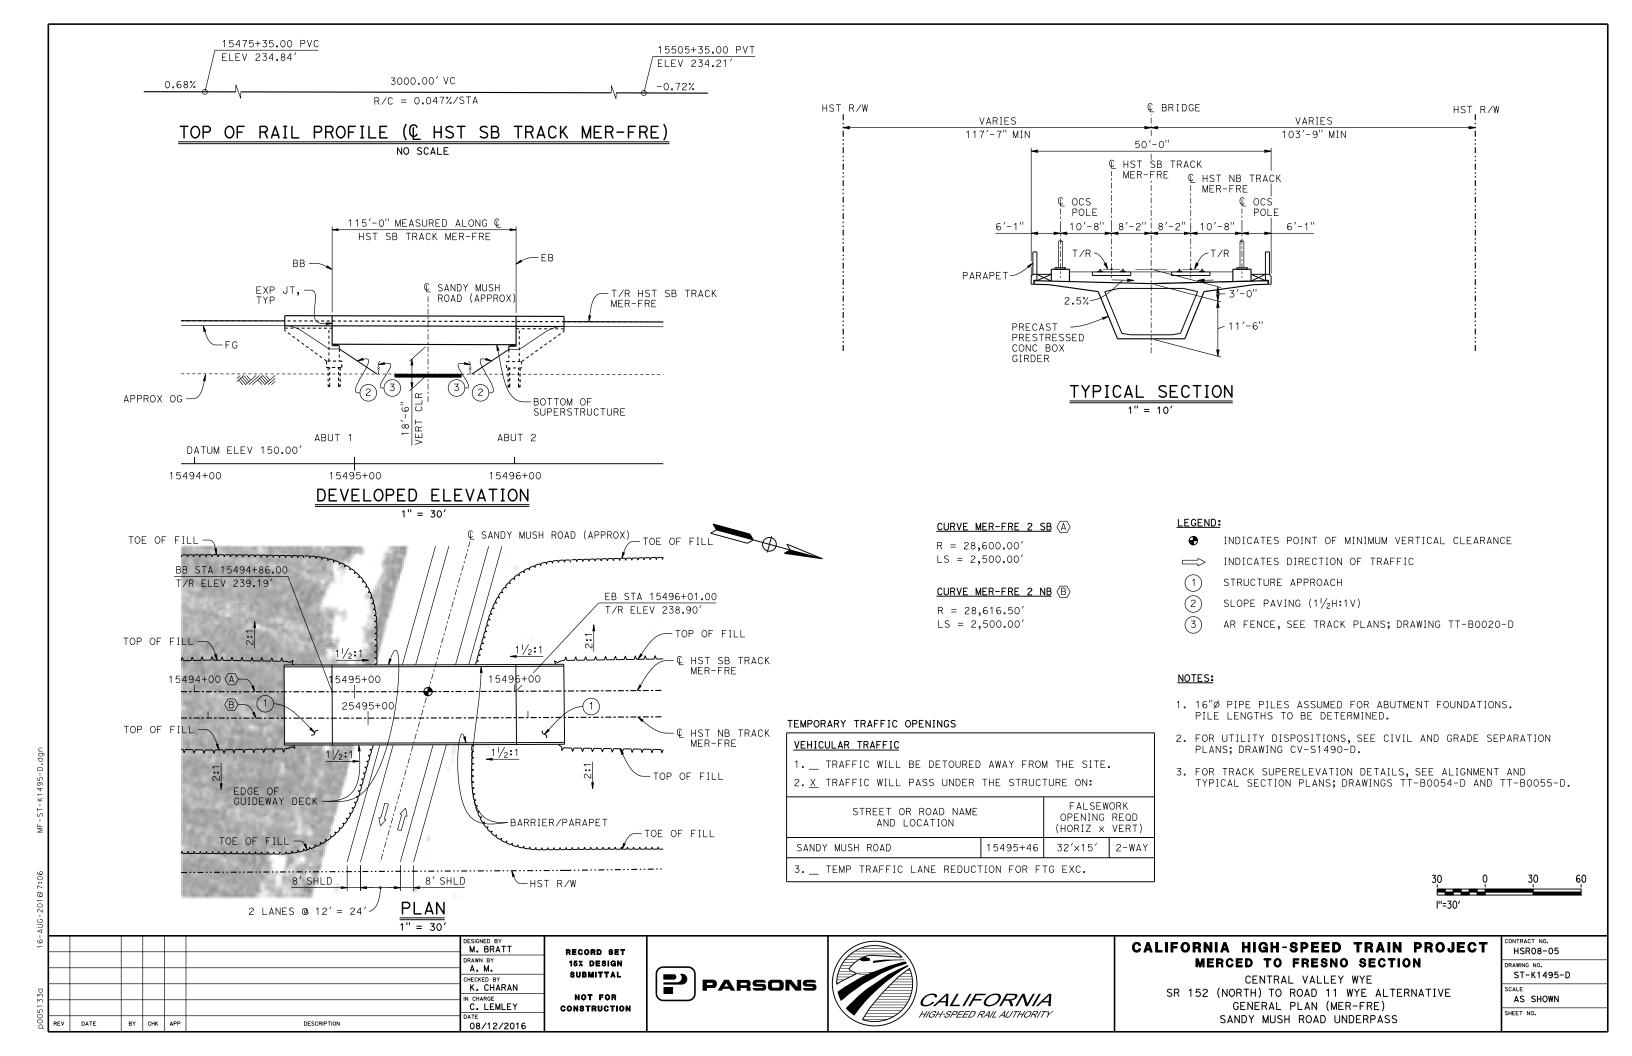

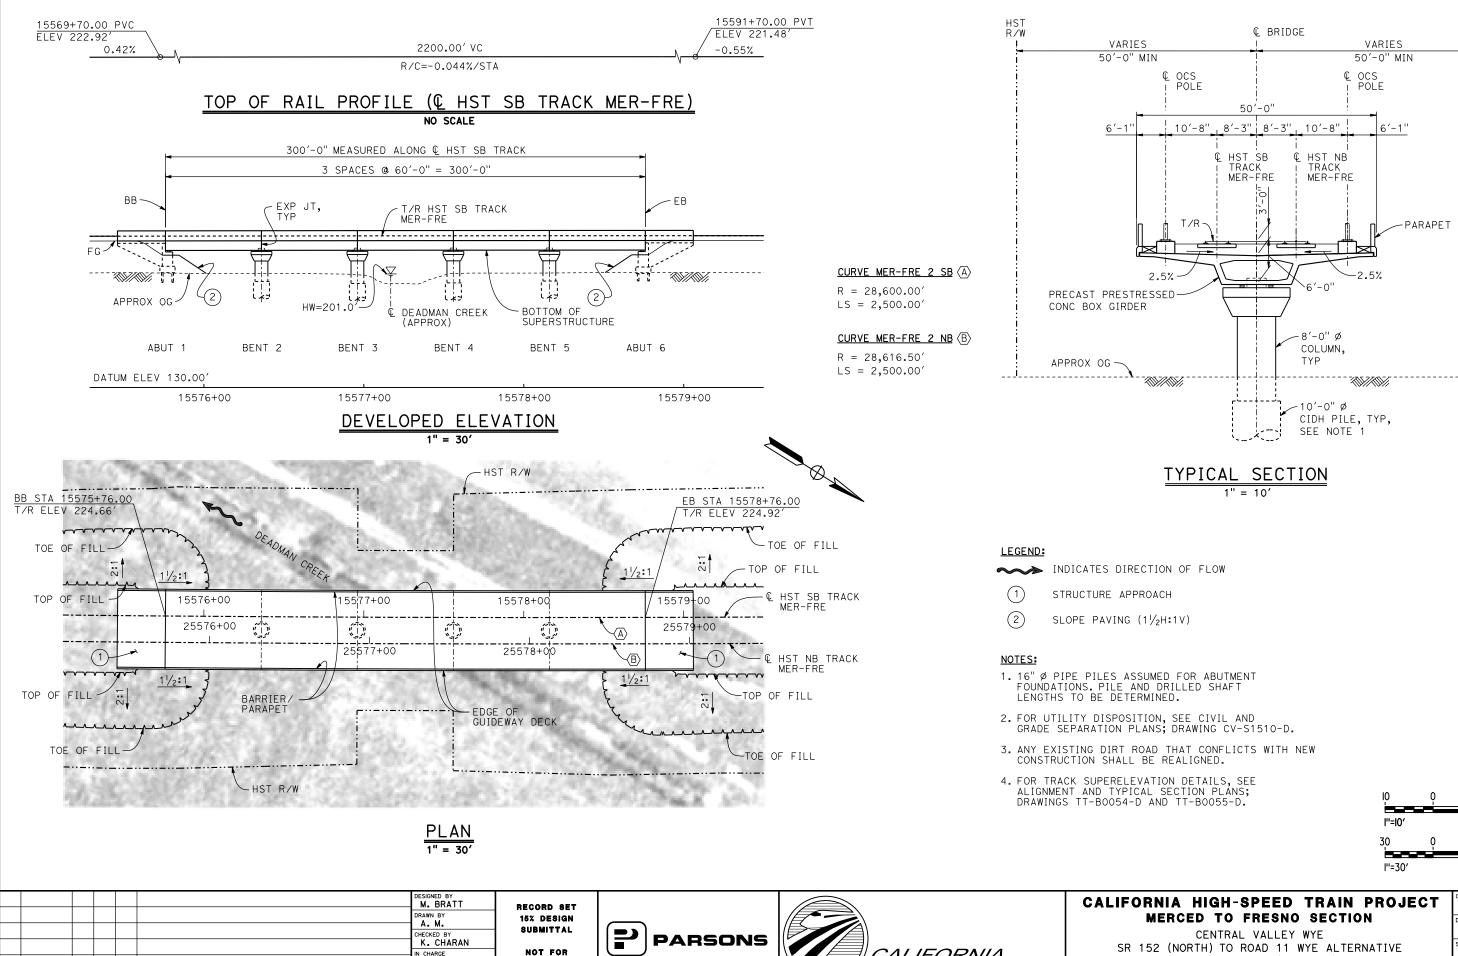

CALIFORNIA

HIGH-SPEED RAIL AUTHORITY

IN CHARGE
C. LEMLEY

08/12/2016

DATE

BY CHK APP

DESCRIPTION

CONSTRUCTION

HSR08-05 RAWING NO. ST-K1510-D AS SHOWN SHEET NO.

30

GENERAL PLAN (MER-FRE)


DEADMAN CREEK BRIDGE No. 1

20

60

HST


R/W

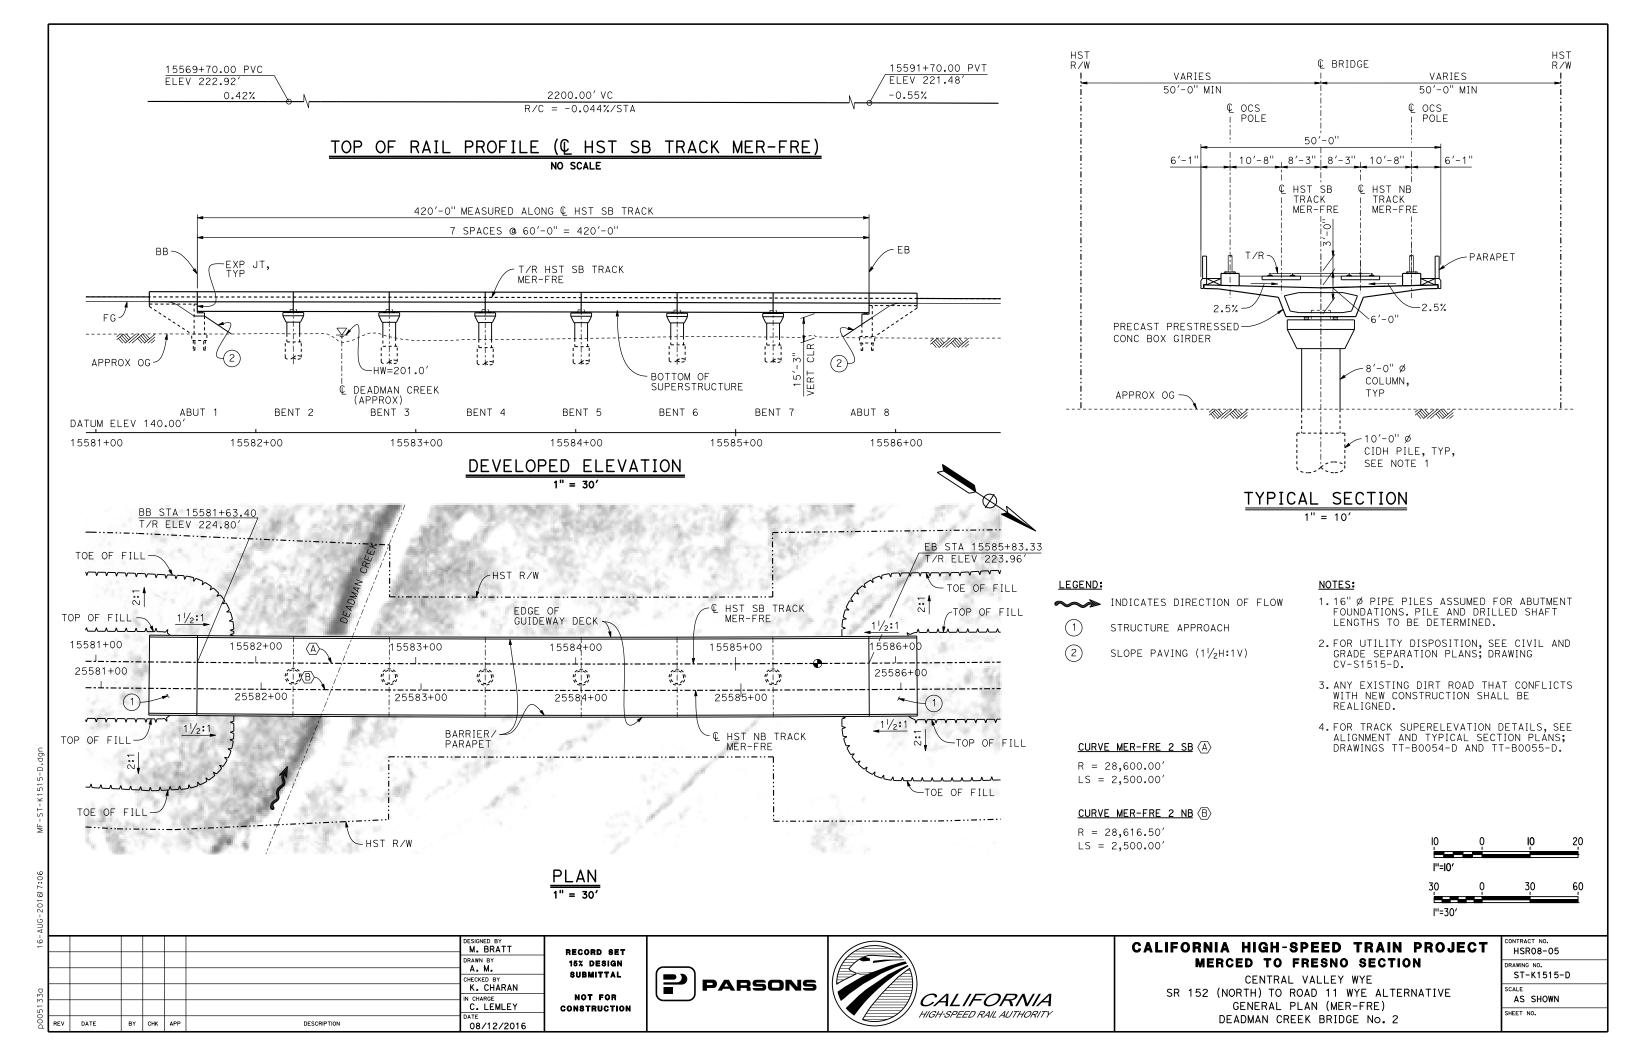

LEGEND: INDICATES POINT OF MINIMUM VERTICAL CLEARANCE 46160+92.99 PVT ELEV 179.90' ➤ INDICATES DIRECTION OF FLOW INDICATES DIRECTION OF TRAFFIC STRUCTURE APPROACH SLOPE PAVING $(1\frac{1}{2}H:1V)$ TOP OF RAIL PROFILE (& HST NB TRACK SJD-MER) TEMPORARY TRAFFIC OPENINGS 7080'-0" TOTAL LENGTH MEASURED ALONG € HST NB TRACK SJD-MER VEHICULAR TRAFFIC 21 SPACES @ 120'-0" = 2520'-0" 1. X TRAFFIC WILL BE DETOURED AWAY FROM THE SITE. BB 2. _ TRAFFIC WILL PASS UNDER THE STRUCTURE ON: T/R HST NB TRACK -EXP JT, TYP SJD-MER FALSEWORK ST OR ROAD NAME OPENING REQD AND LOCATION (HORIZ X VERT HEMLOCK RD | 46211+10 32'X16.5' TEMP TRAFFIC LANE REDUCTION FOR FTG EXC. APPROX OG BOTTOM OF SUPERSTRUCTURE ABUT 1 BENT 3 BENT 5 BENT 7 BENT 9 BENT 11 BENT 13 BENT 15 BENT 17! BENT 2 BENT 4 BENT 6 BENT 8 BENT 10 BENT 12 BENT 14 BENT 16 DATUM ELEV 70.00' NOTES: 16" Ø PIPE PILES ASSUMED FOR ABUTMENT AND BENT FOUNDATIONS, UNLESS OTHERWISE NOTED. PILE LENGTHS TO BE DETERMINED. 46175+00 46180+00 46185+00 46190+00 DEVELOPED ELEVATION 2. FOR SECTIONS AND BENT COLUMN VERT: 1" = 50' HORIZ: 1" = 100' SCHEDULE, SEE DRAWINGS ST-K3610-D AND ST-K3611-D. 3. ANY EXISTING DIRT ROAD THAT CONFLICTS WITH NEW CONSTRUCTION SHALL BE REALIGNED. E HST SB TRACK SJD-MER EDGE OF 4. FOR RETAINING WALLS, SEE CIVIL AND C HST NB TRACK SJD-FRE GUIDEWAY DECK GRADE SEPARATION PLANS; DRAWINGS - L HST SB TRACK SJD-FRE CV-S1610-D AND CV-S1630-D. TOE OF FILL, TYP-C HST NB TRACK SJD-MER 5. FOR UTILITY DISPOSITIONS, SEE CIVIL AND GRADE SEPARATION PLANS; DRAWINGS CV-S1610-D AND CV-S1630-D. 6. FOR HEMLOCK RD (ROAD 9) INTERCHANGE GENERAL PLAN AND TYPICAL SECTION, SEE DRAWING ST-K1160-D. TOP OF FILL. 7. FOR HEMLOCK RD (ROAD 9) OVERHEAD TYP GENERAL PLAN AND TYPICAL SECTION, SEE DRAWING ST-K1620-D. TOE OF FILL, CURVE SJD-MER 1 NB (A) N89°54′47.414"E R = 12,000.00'LS = 1,500.00'I"=50' 200 PLAN l"=100' M. BRATT CALIFORNIA HIGH-SPEED TRAIN PROJECT HSR08-05 RECORD SET MERCED TO FRESNO SECTION 15% DESIGN SUBMITTAL ST-K1610-D CENTRAL VALLEY WYE K. CHARAN **PARSONS** SR 152 (NORTH) TO ROAD 11 WYE ALTERNATIVE NOT FOR N CHARGE C. LEMLEY **CALIFORNIA** AS SHOWN GENERAL PLAN (SJD-MER) CONSTRUCTION HIGH-SPEED RAIL AUTHORITY SHEET NO. AERIAL #4 - NORTHBOUND OVER HST MAINLINE - 1 OF 5 BY CHK APP DESCRIPTION 08/12/2016

TOP OF RAIL PROFILE (& HST NB TRACK SJD-MER)

NO SCALE

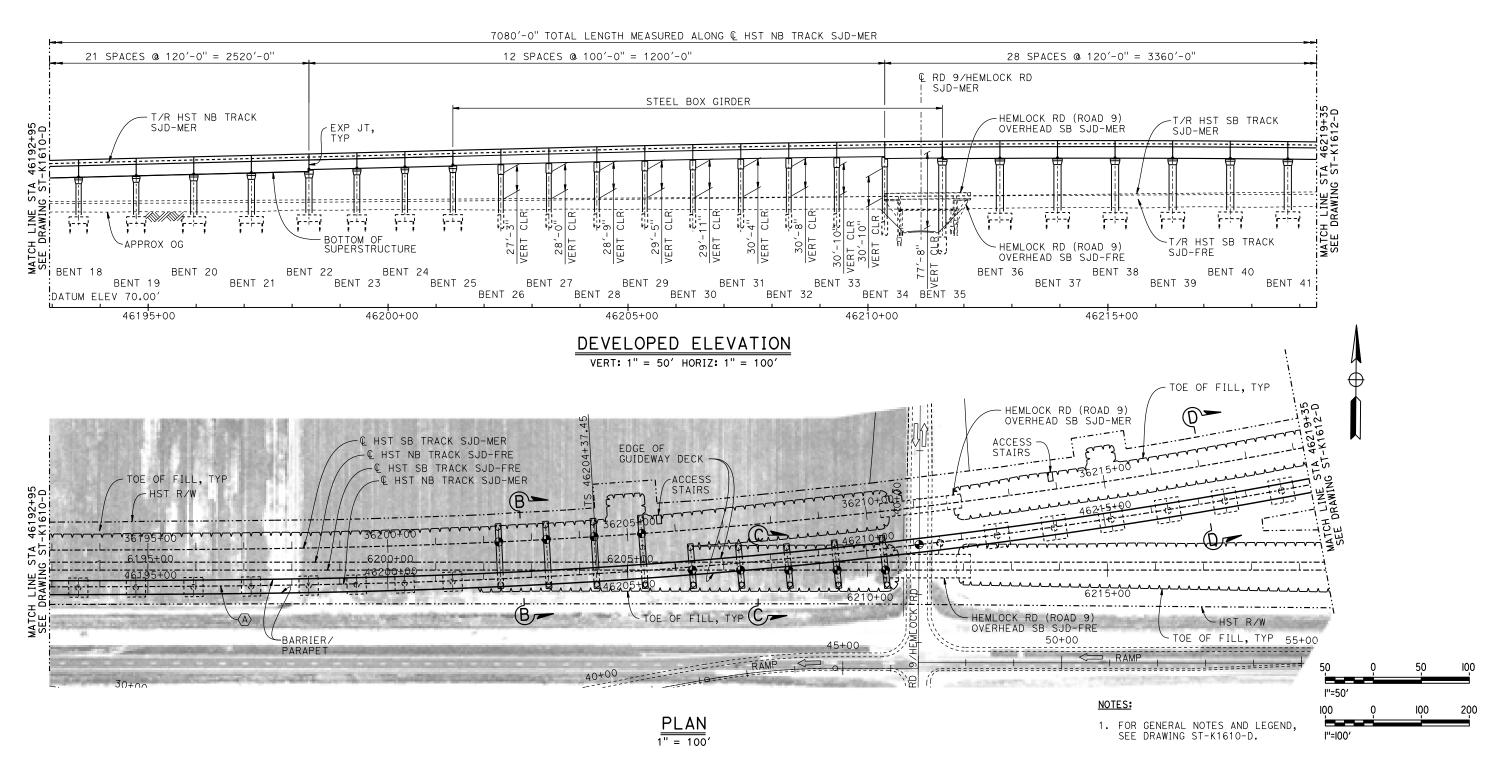

						DESIGNED BY M. BRATT
						DRAWN BY A. M.
						CHECKED BY K. CHARAN
						IN CHARGE C. LEMLEY
REV	DATE	BY	СНК	APP	DESCRIPTION	DATE 08/12/2016

RECORD SET
15% DESIGN
SUBMITTAL
NOT FOR
CONSTRUCTION








CALIFORNIA HIGH-SPEED TRAIN PROJECT MERCED TO FRESNO SECTION


CENTRAL VALLEY WYE
SR 152 (NORTH) TO ROAD 11 WYE ALTERNATIVE
GENERAL PLAN (SJD-MER)
AERIAL #4 - NORTHBOUND OVER HST MAINLINE - 2 OF 5


CONTRACT NO.
HSR08-05
DRAWING NO.
ST-K1611-D
SCALE
AS SHOWN
SHEET NO.

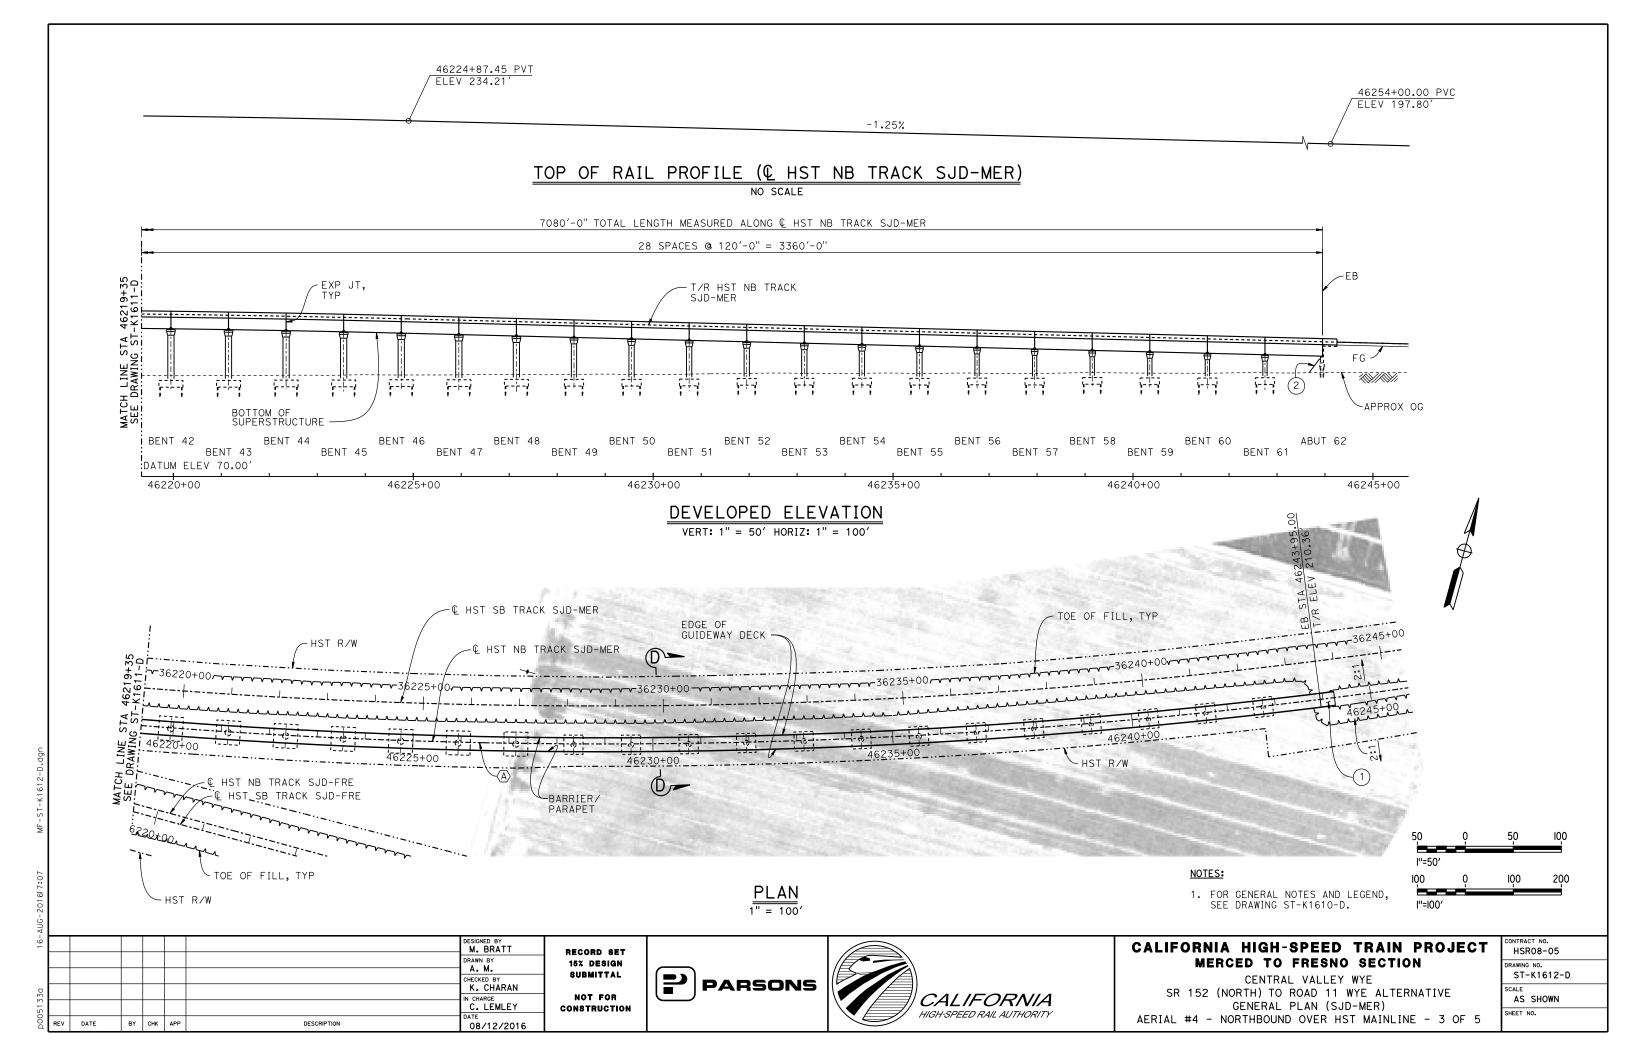

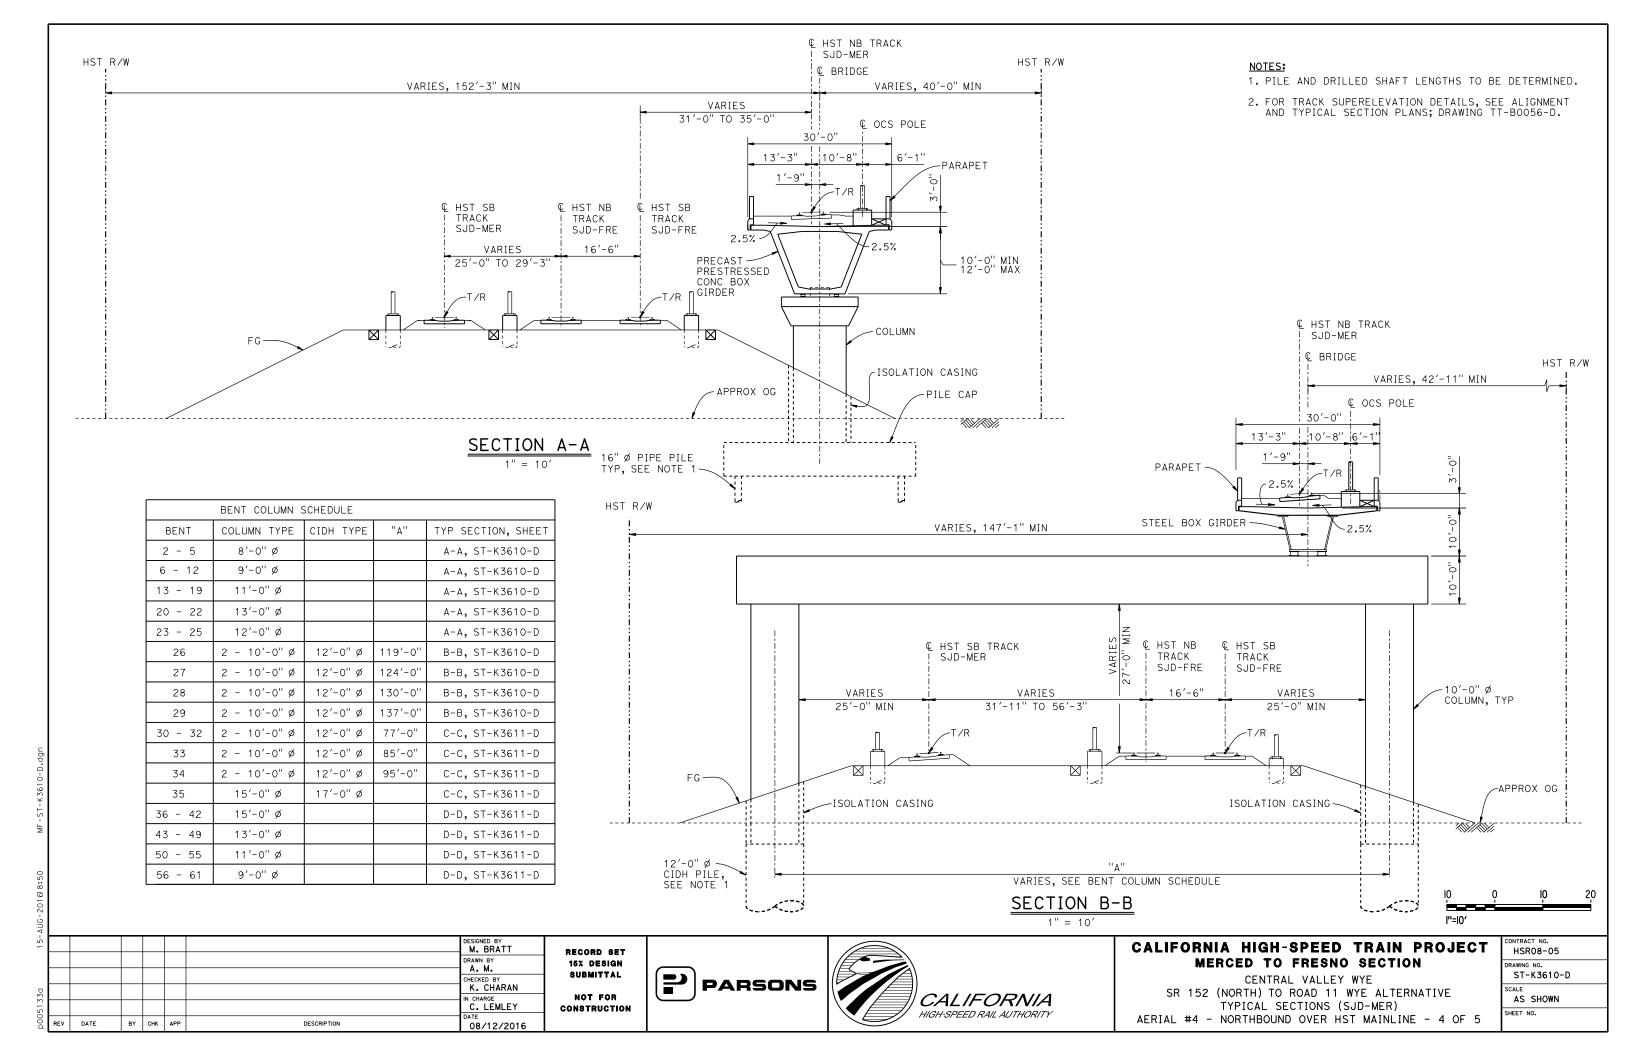

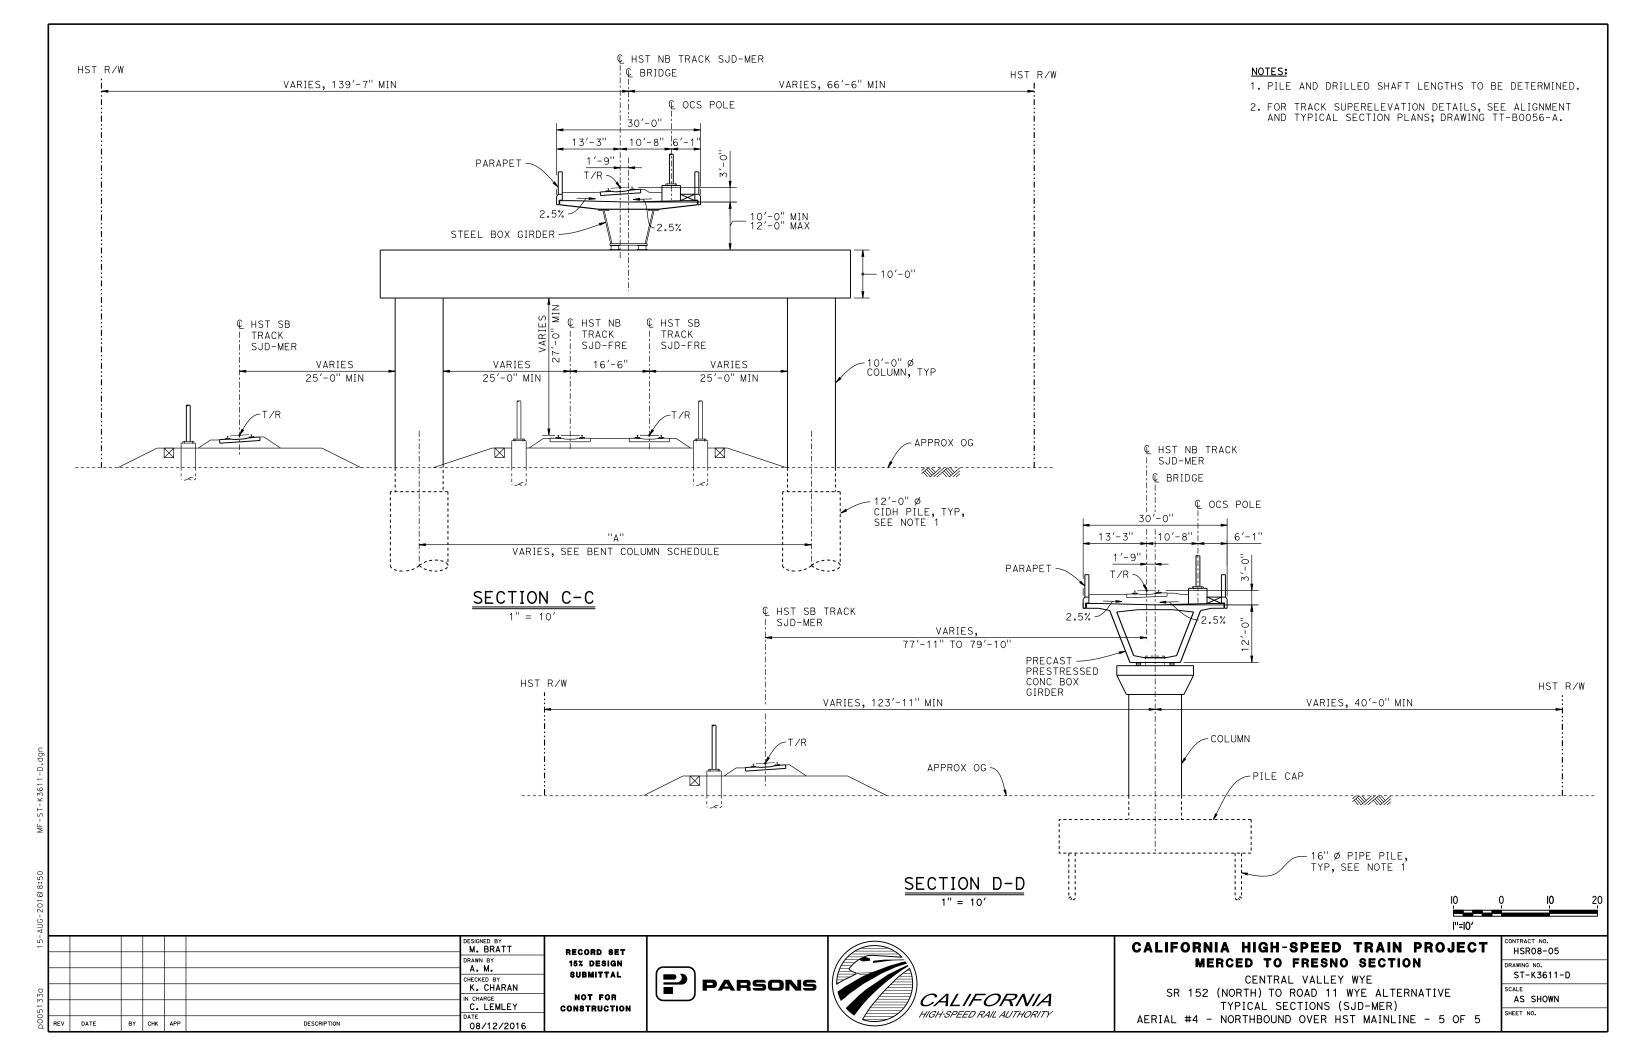


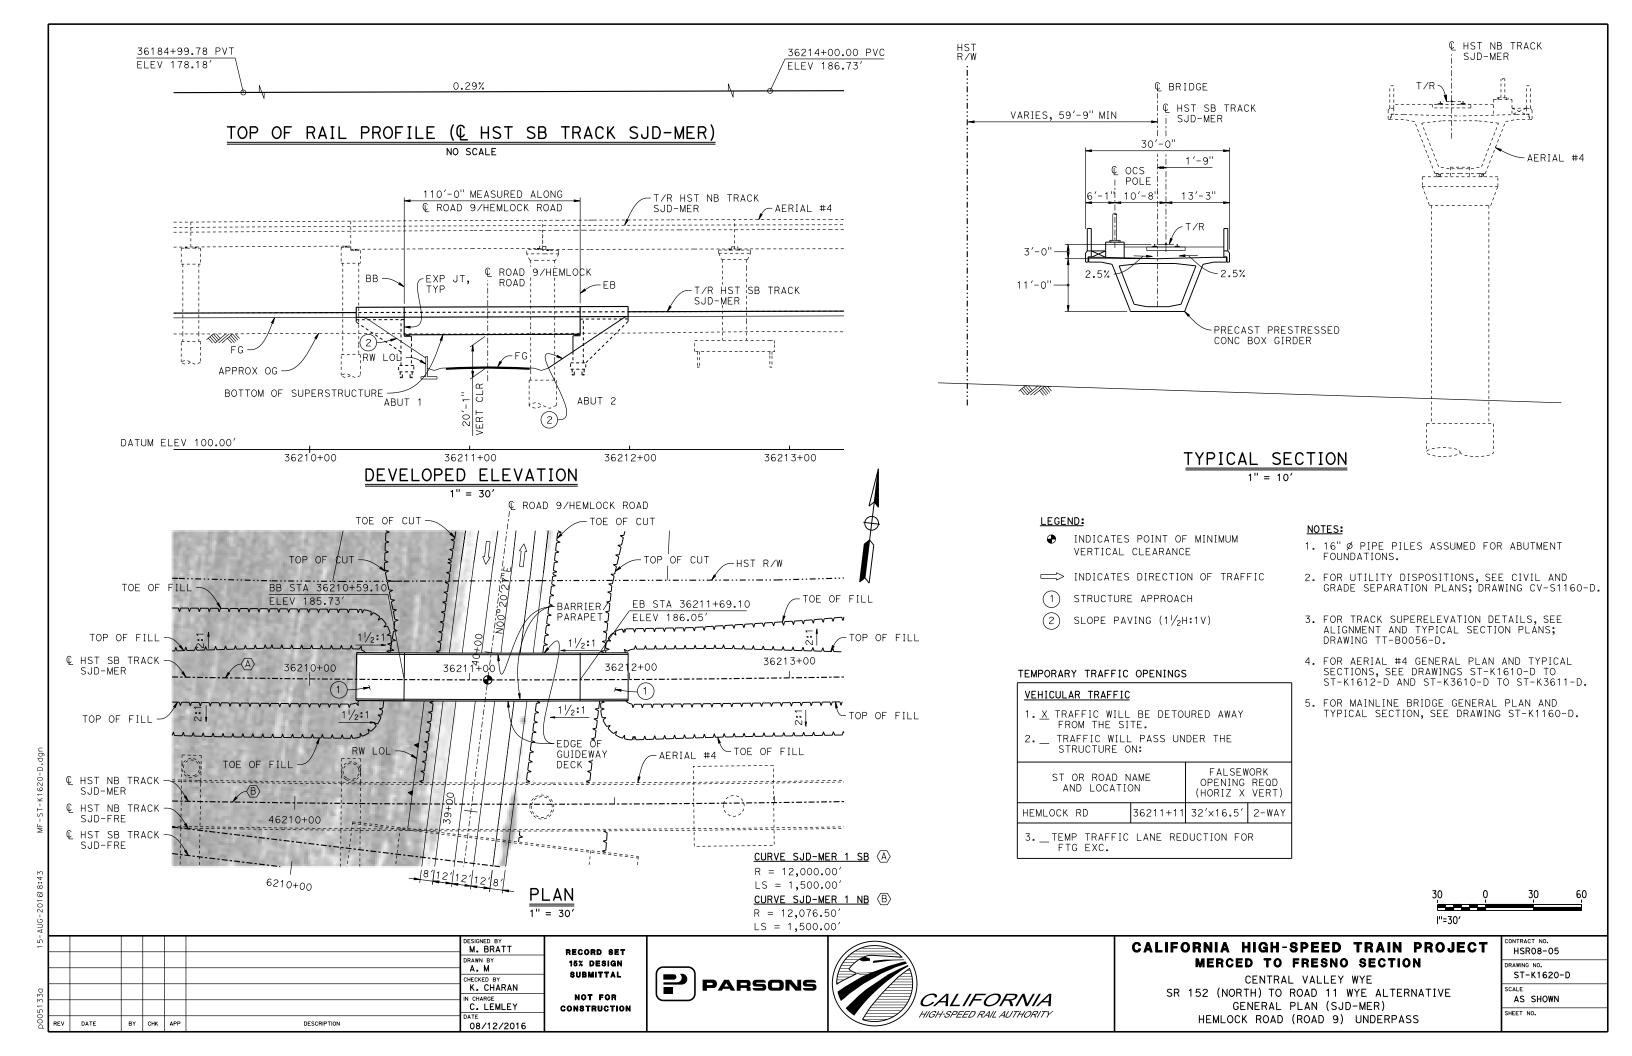

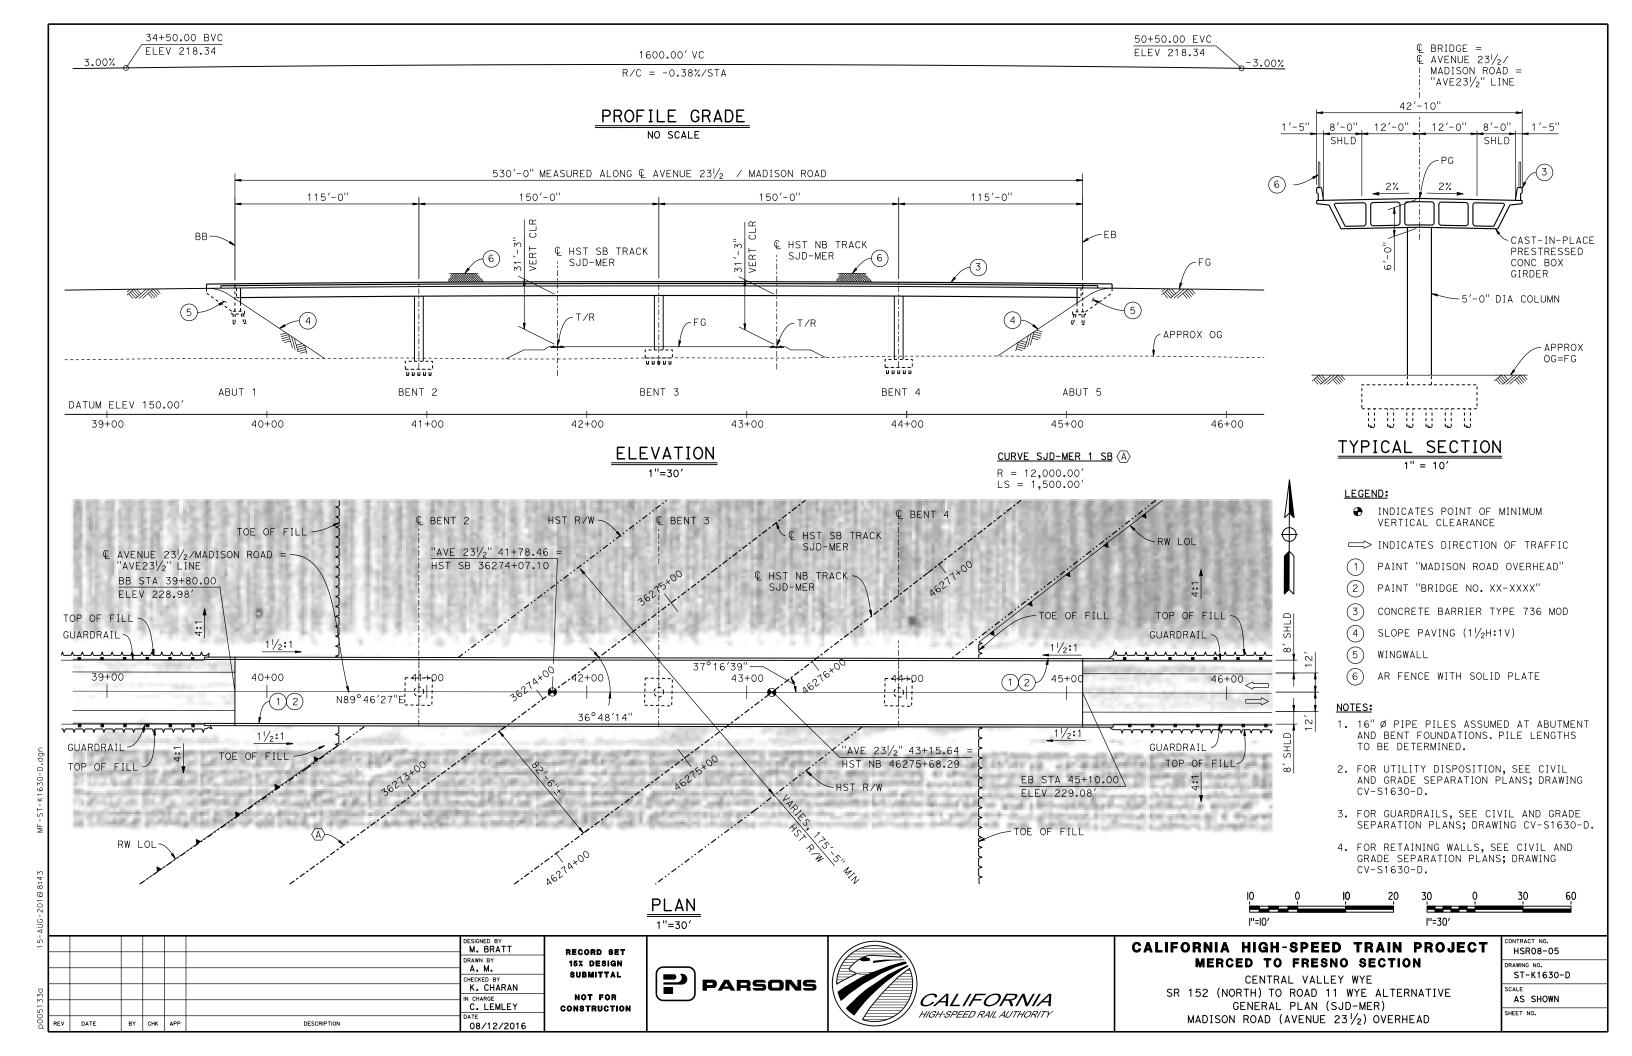

LEGEND: INDICATES POINT OF MINIMUM VERTICAL CLEARANCE 46320+00.00 PVT INDICATES DIRECTION OF TRAFFIC ELEV 208.30' 1.25% >>> INDICATES DIRECTION OF FLOW STRUCTURE APPROACH TOP OF RAIL PROFILE (& HST NB TRACK SJD-MER) SLOPE PAVING (1/2H:1V) NO SCALE CURVE SJD-MER 1 NB (A) R = 12,076.50'TEMPORARY TRAFFIC OPENINGS LS = 1,500.00'VEHICULAR TRAFFIC 8,310'-0" TOTAL LENGTH MEASURED ALONG & HST NB TRACK SJD-MER 1. \underline{X} TRAFFIC WILL BE DETOURED AWAY FROM THE SITE. 36 SPACES @ 120'-0'' = 4,320'-0''2. _ TRAFFIC WILL PASS UNDER THE STRUCTURE ON: FALSEWORK ST OR ROAD NAME OPENING REQD (HORIZ X VERT) AND LOCATION BB~ ROAD 11 REALIGNMENT 46359+08 32'X16.5' 2-WAY T/R HST SB TRACK TA-TS T/R HST NB TRACK EXP JT, SJD-MER MATCH LINE ST, SEE DRAWING S SJD-MER 46371+05 32'X16.5' AVENUE 25/WASHINGTON RD 2-WAY TYP 3. __ TEMP TRAFFIC LANE REDUCTION FOR FTG EXC. FG ~ (2)95 f 5 APPROX OG-BOTTOM OF NOTES: SUPERSTRUCTURE 1. 16" Ø PIPE PILES ASSUMED FOR ABUTMENT AND BENT FOUNDATIONS, UNLESS OTHERWISE NOTED. PILE LENGTHS ABUT 1 BENT 3 BENT 5 BENT 7 BENT 9 BENT 11 BENT 13 BENT 15 TO BE DETERMINED. BENT 2 BENT 4 BENT 6 BENT 8 BENT 10 BENT 12 BENT 14 BENT 16 DATUM ELEV 100.00° 2. FOR SECTIONS AND BENT COLUMN SCHEDULE, SEE DRAWINGS 46335+00 46330+00 46340+00 46345+00 ST-K3640-D AND ST-K3641-D. DEVELOPED ELEVATION 3. ANY EXISTING DIRT ROAD THAT CONFLICTS WITH NEW CONSTRUCTION SHALL BE REALIGNED. VERT: 1" = 50' HORIZ: 1" = 100 4. FOR UTILITY DISPOSITIONS, SEE CIVIL AND GRADE SEPARATION PLANS; DRAWINGS CV-S1640-D TO CV-S1660-D. 5. FOR GUARDRAILS, SEE CIVIL AND GRADE SEPARATION PLANS; DRAWINGS CV-S1640-D TO CV-S1660-D. 6. FOR RETAINING WALLS, SEE CIVIL AND GRADE SEPARATION PLANS; DRAWINGS CV-\$1640-D TO CV-\$1660-D. HST SB TRACK 7. FOR ROAD 11 OVERHEAD GENERAL PLAN AND TYPICAL SECTION, SEE DRAWING ST-K1650-D. 8. FOR WASHINGTON ROAD (AVENUE 25) UNDERPASS MER-FRE GENERAL PLAN AND TYPICAL SECTION, SEE DRAWINGS ST-K1450-D AND TOP 9. FOR WASHINGTON ROAD (AVENUE 25) UNDERPASS SJD-MER GENERAL 46345+00 PLAN AND TYPICAL SECTION, SEE DRAWING ST-K1655-D. 10.FOR CHOWCHILLA RIVER BRIDGE SB MER-FRE GENERAL PLAN AND BARRIER TYPICAL SECTION, SEE DRAWING ST-K1455-D. BARRIER PARAPF1 GUIDEWAY DECK S.ID-MFR 11.FOR CHOWCHILLA RIVER BRIDGE SB SJD-MER GENERAL PLAN AND TYPICAL SECTION, SEE DRAWING ST-K1659-D. PRIVATE FARM ROAD CLOSED 100 100 200 PLAN l"=50' l"=100' 1" = 100' M. BRATT CALIFORNIA HIGH-SPEED TRAIN PROJECT HSR08-05 RECORD SET MERCED TO FRESNO SECTION 15% DESIGN SUBMITTAL ST-K1640-D CENTRAL VALLEY WYE K. CHARAN **PARSONS** SR 152 (NORTH) TO ROAD 11 WYE ALTERNATIVE NOT FOR AS SHOWN N CHARGE C. LEMLEY **CALIFORNIA** GENERAL PLAN (SJD-MER) CONSTRUCTION HIGH-SPEED RAIL AUTHORITY SHEET NO. AERIAL #5 - NORTHBOUND OVER HST MERCED TO FRESNO - 1 OF 6 DATE BY CHK APP DESCRIPTION 08/12/2016

TOP OF RAIL PROFILE (@ HST NB TRACK SJD-MER) NO SCALE

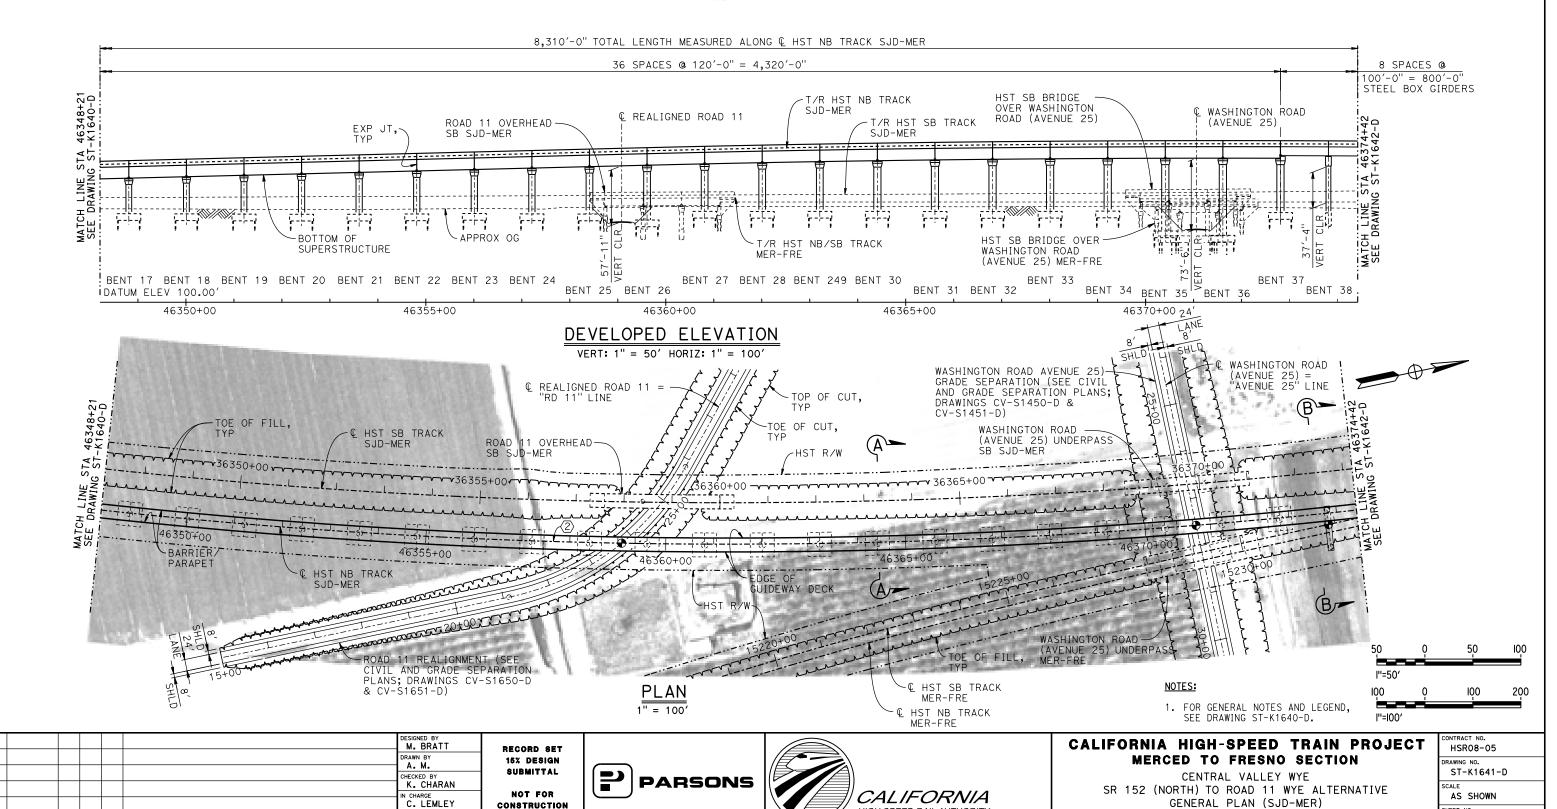

HIGH-SPEED RAIL AUTHORITY

CONSTRUCTION

08/12/2016

BY CHK APP


DESCRIPTION

GENERAL PLAN (SJD-MER)

AERIAL #5 - NORTHBOUND OVER HST MERCED TO FRESNO - 2 OF

SHEET NO.

TOP OF RAIL PROFILE (& HST NB TRACK SJD-MER) NO SCALE

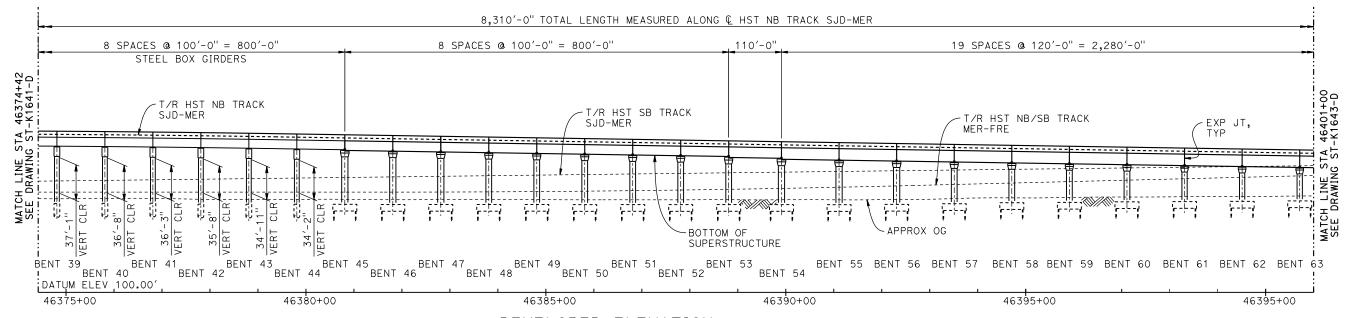

DEVELOPED ELEVATION

VERT: 1" = 50' HORIZ: 1" = 100' ROAD 11 REALIGNMENT (SEE CIVIL AND GRADE SEPARATION PLANS; -PRIVATE FARM REALIGNED ROAD 11 DRAWINGS CV-S1650-D & CV-S1651-D) ROAD CLOSED ROAD 11 BARRIER HST SB TRACK SJD-MER 36395+00 36390+00 36380+00 36385+00 15240+00 46390+00 MATCH SEE DF - EDGE OF BARRIER/ **Q** HST SB TRACK -BARRIER GUIDEWAY DECK PARAPET MER-FRE

> PLAN NOTES: 1" = 100'

HST NB TRACK MER-FRE

1. FOR GENERAL NOTES AND LEGEND, SEE DRAWING ST-K1640-D. CALIFORNIA HIGH-SPEED TRAIN PROJECT

MERCED TO FRESNO SECTION

CENTRAL VALLEY WYE

SR 152 (NORTH) TO ROAD 11 WYE ALTERNATIVE

GENERAL PLAN (SJD-MER)

-- PRIVATE FARM ROAD CLOSED

HSR08-05 ST-K1642-D AS SHOWN SHEET NO. AERIAL #5 - NORTHBOUND OVER HST MERCED TO FRESNO - 3 OF

l"=50'

M. BRATT DRAWN BY K. CHARAN IN CHARGE
C. LEMLEY DATE BY CHK APP DESCRIPTION 08/12/2016

RECORD SET 15% DESIGN SUBMITTAL NOT FOR CONSTRUCTION

HST NB TRACK


SJD-MER

(C)-






TOP OF RAIL PROFILE (HST NB TRACK SJD-MER) NO SCALE

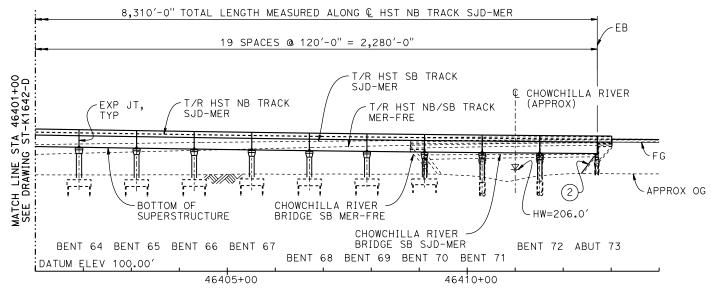

DEVELOPED ELEVATION

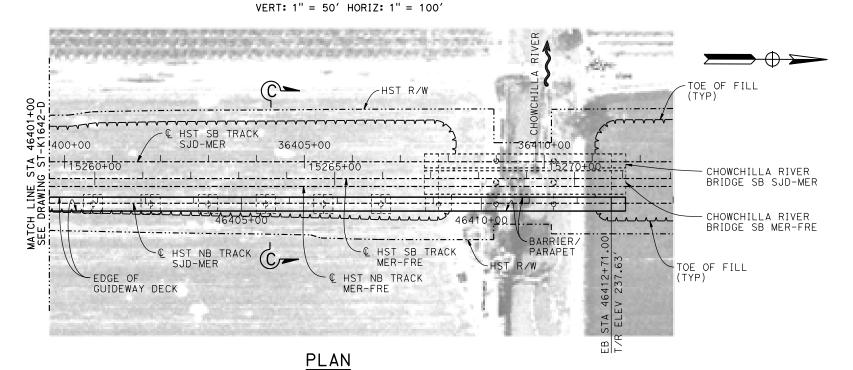

NOTES:

1. FOR GENERAL NOTES AND LEGEND, SEE DRAWING ST-K1640-D.



1								
0		_					DESIGNED BY M. BRATT	
							DRAWN BY A. M.	ĺ
							CHECKED BY	
20							K. CHARAN IN CHARGE	
0.0							C. LEMLEY	c
000	REV	DATE	BY	СНК	APP	DESCRIPTION	08/12/2016	

RECORD SET 15% DESIGN SUBMITTAL NOT FOR CONSTRUCTION






CALIFORNIA HIGH-SPEED TRAIN PROJECT MERCED TO FRESNO SECTION


CENTRAL VALLEY WYE SR 152 (NORTH) TO ROAD 11 WYE ALTERNATIVE GENERAL PLAN (SJD-MER) AERIAL #5 - NORTHBOUND OVER HST MERCED TO FRESNO - 4 OF

	CONTRACT NO. HSRO8-05
	DRAWING NO.
	ST-K1643-D
	SCALE
	AS SHOWN
6	SHEET NO.
Ŭ	

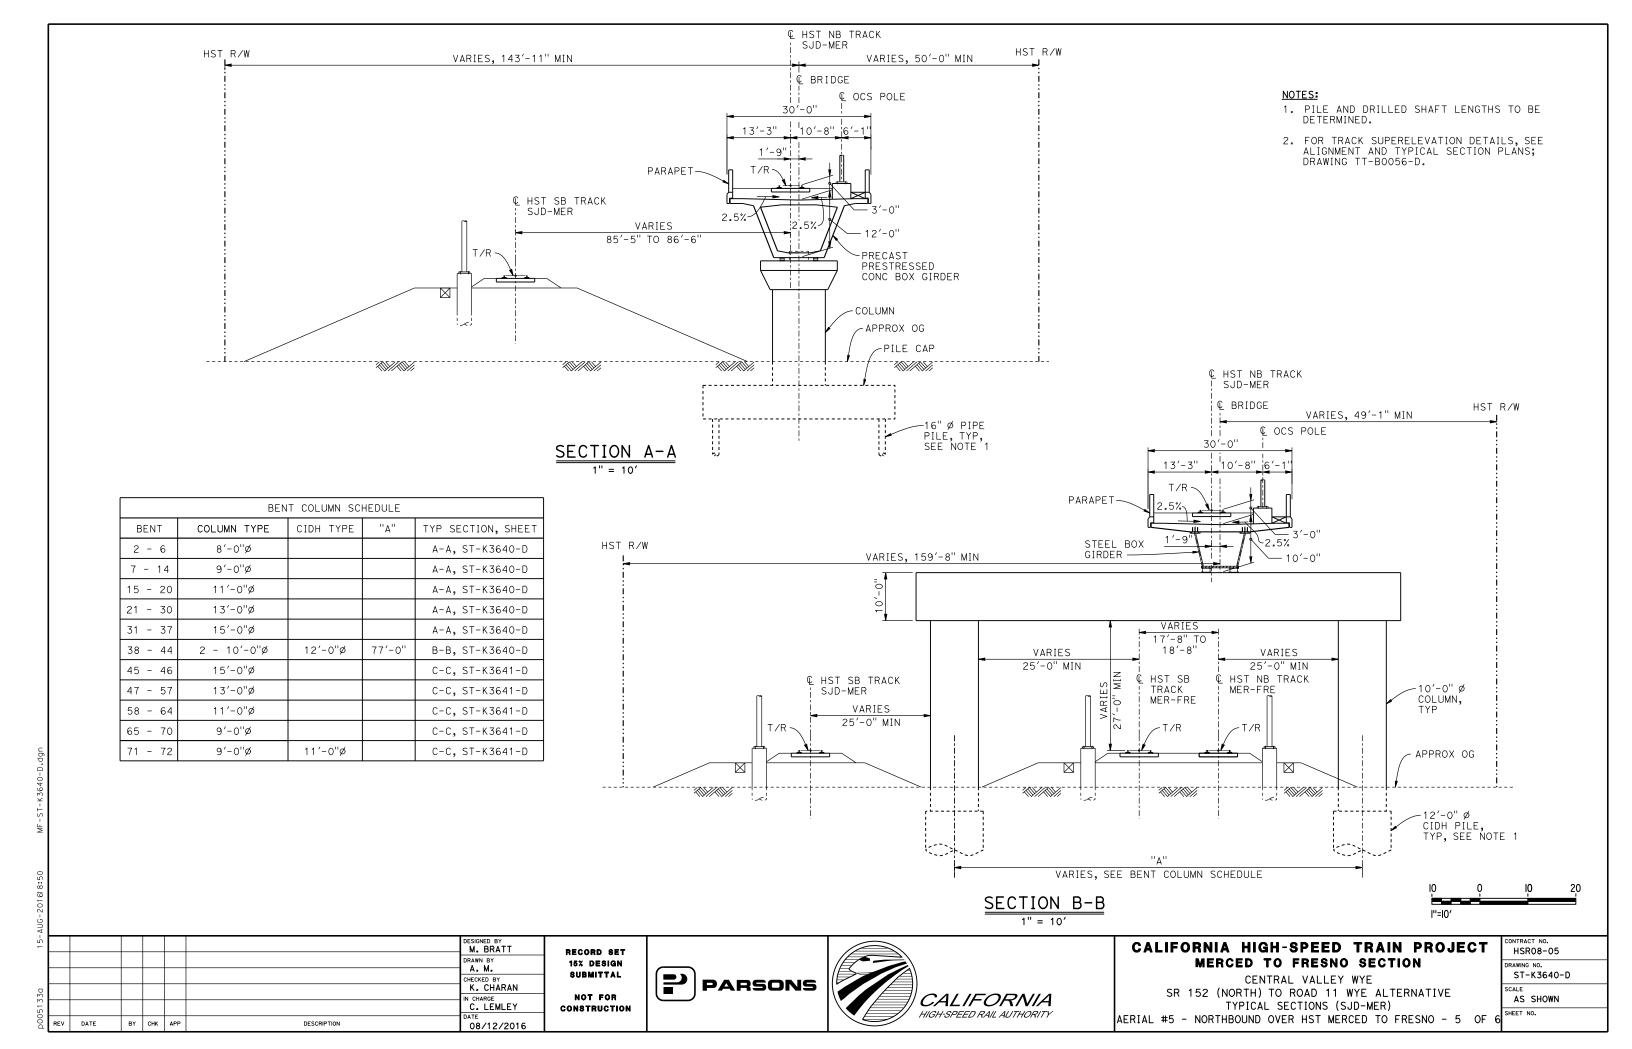

NOTES:

- 1. DRILLED SHAFT LENGTHS TO BE DETERMINED.
- FOR TRACK SUPERELEVATION DETAILS, SEE ALIGNMENT AND TYPICAL SECTION PLANS; DRAWING TT-B0056-D.

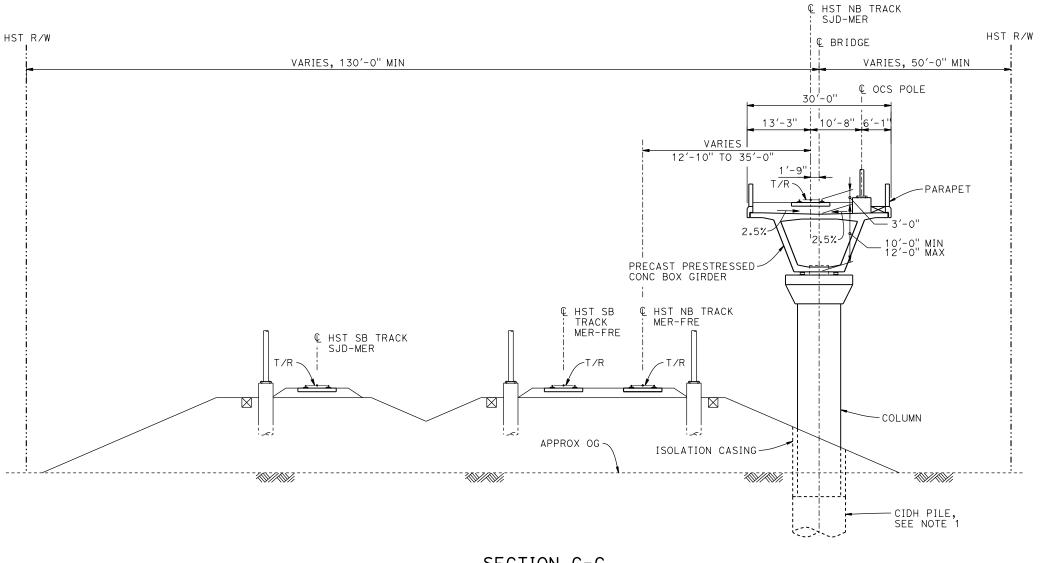

 $\frac{\mathsf{SECTION} \ \mathsf{C-C}}{\mathsf{1"} = \mathsf{10'}}$

5-A							DESIGNED BY	
_							M. BRATT	RE 14
							A. M. CHECKED BY	8
30							K. CHARAN IN CHARGE	
513							C. LEMLEY	COI
00d	REV	DATE	BY	СНК	APP	DESCRIPTION	08/12/2016	

RECORD SET
15% DESIGN
SUBMITTAL
NOT FOR
CONSTRUCTION





CALIFORNIA HIGH-SPEED TRAIN PROJECT MERCED TO FRESNO SECTION


CENTRAL VALLEY WYE

SR 152 (NORTH) TO ROAD 11 WYE ALTERNATIVE
AS S


TYPICAL SECTIONS (SJD-MER)

AERIAL #5 - NORTHBOUND OVER HST MERCED TO FRESNO - 6 OF 6


CONTRACT NO.
HSR08-05
DRAWING NO.
ST-K3641-D
SCALE
AS SHOWN

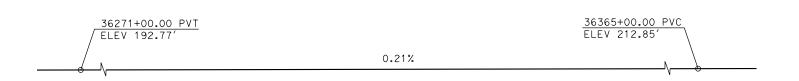

TOP OF RAIL PROFILE (HST SB TRACK SJD-MER) NO SCALE

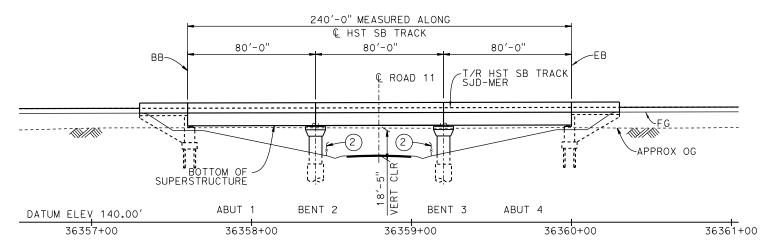

DEVELOPED ELEVATION

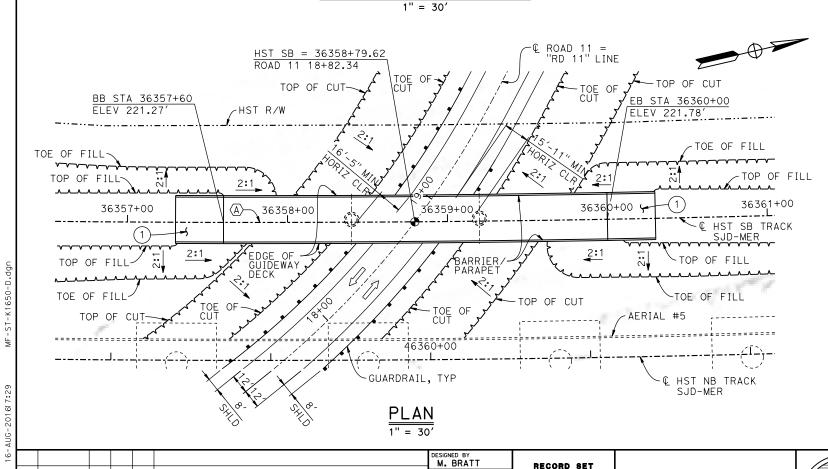

K. CHARAN

IN CHARGE
C. LEMLEY

08/12/2016

DATE

BY CHK APP

DESCRIPTION

15% DESIGN SUBMITTAL

NOT FOR

CONSTRUCTION

PARSONS

CURVE SJD-MER 1 SB (A)

TEMPORARY TRAFFIC OPENINGS

FROM THE SITE.

STRUCTURE ON:

ST OR ROAD NAME

AND LOCATION


1. __ TRAFFIC WILL BE DETOURED AWAY

3. \underline{X} TEMP TRAFFIC LANE REDUCTION FOR

2. X TRAFFIC WILL PASS UNDER THE

VEHICULAR TRAFFIC

R = 12,000.00'LS = 1,500.00'

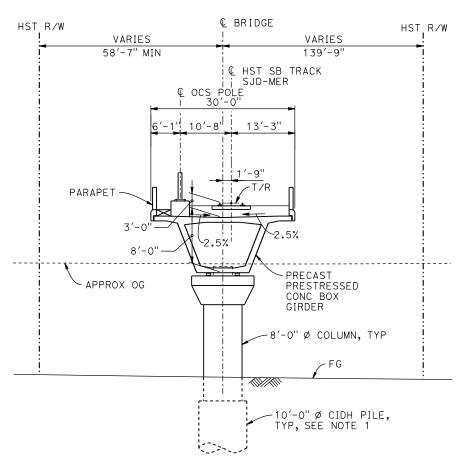

TYPICAL SECTION

NOTES:

- 1. 16" Ø PIPE PILE ASSUMED AT ABUTMENT FOUNDATIONS. PILE AND DRILLED SHAFT LENGTHS TO BE DETERMINED.
- 2. FOR UTILITY DISPOSITIONS, SEE CIVIL AND GRADE SEPARATION PLANS; DRAWING CV-R1650-D.
- 3. FOR GUARDRAILS, SEE CIVIL AND GRADE SEPARATION PLAŃS; DRAWING CV-R1650-D.
- 4. FOR TRACK SUPERELEVATION DETAILS, SEE ALIGNMENT AND TYPICAL SECTION PLANS; DRAWING TT-B0056-D.
- 5. FOR ROAD 11 REALIGNMENT, SEE CIVIL AND GRADE SEPARATION PLANS; DRAWING CV-R1650-D.
- 6. FOR AERIAL # 5 GENERAL PLAN AND TYPICAL SECTIONS, SEE DRAWINGS ST-K1640-D TO ST-K1643-D AND ST-K3640-D TO ST-K3641-D.

ROAD 11

INDICATES POINT OF MINIMUM VERTICAL CLEARANCE

FALSEWORK

OPENING REQD

(HORIZ X VERT)

36358+80 32'X15' 2-WAY

- INDICATES DIRECTION OF TRAFFIC

FTG EXC.

(2)



CALIFORNIA HIGH-SPEED TRAIN PROJECT MERCED TO FRESNO SECTION

CENTRAL VALLEY WYE SR 152 (NORTH) TO ROAD 11 WYE ALTERNATIVE GENERAL PLAN (SJD-MER) ROAD 11 UNDERPASS

CONTRACT NO. HSRO8-05
DRAWING NO. ST-K1650-D
SCALE AS SHOWN
SHEET NO.

LEGEND:







AR FENCE, SEE TRACK PLANS; DRAWING TT-B0050-D


CALIFORNIA

HIGH-SPEED RAIL AUTHORITY

TOP OF RAIL PROFILE (& HST SB TRACK SJD-MER)

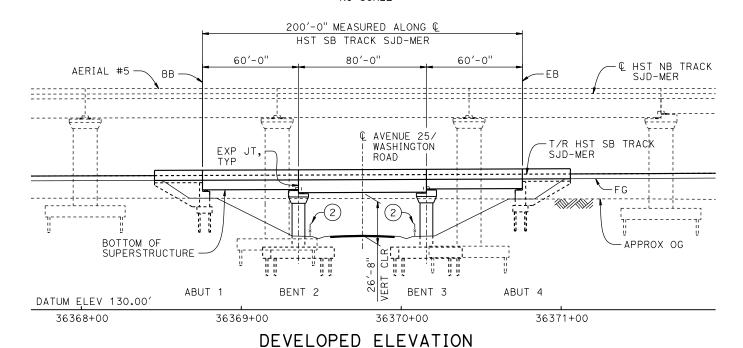

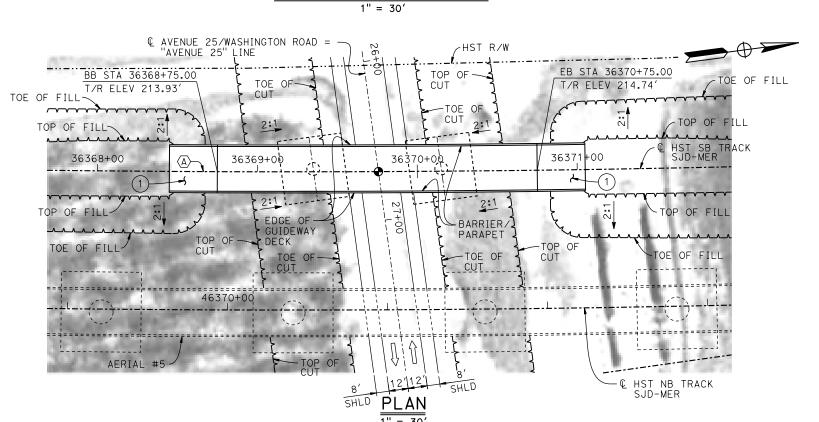

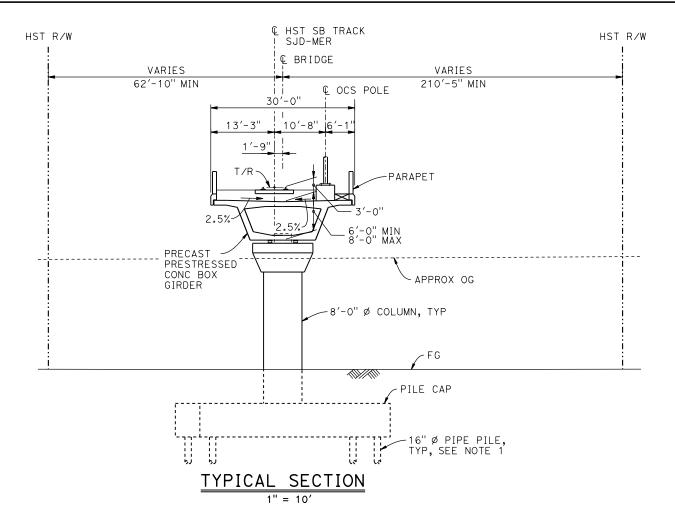

TEMPORARY TRAFFIC OPENINGS

VEHICULAR TRAFFIC

- 1. $\underline{\mathsf{X}}$ TRAFFIC WILL BE DETOURED AWAY FROM THE SITE.
- 2. _ TRAFFIC WILL PASS UNDER THE STRUCTURE ON:

STREET OR ROAD NAME AND LOCATION	FALSEWORK OPENING REQD (HORIZ × VERT)		
VENUE 25/WASHINGTON ROAD	36369+76	32′x15′	2-WAY
TEMP TRAFFIC LANE REDUCT	TION FOR F	TG EXC.	

LEGEND:

- INDICATES POINT OF MINIMUM VERTICAL CLEARANCE
- INDICATES DIRECTION OF TRAFFIC
- STRUCTURE APPROACH
- AR FENCE, SEE TRACK PLANS; DRAWING TT-B0020-D

CURVE SJD-MER 1 SB (A)

R = 12,000.00'LS = 1,500.00'

NOTES:

- 1. 16"Ø PIPE PILES ASSUMED FOR ABUTMENT FOUNDATIONS. PILE LENGTHS TO BE DETERMINED.
- 2. FOR UTILITY DISPOSITIONS, SEE CIVIL AND GRADE SEPARATION PLANS; DRAWING CV-S1650-D.
- 3. FOR AERIAL #5 NORTHBOUND OVER HST MERCED TO FRESNO GENERAL PLAN AND TYPICAL SECTIONS, SEE DRAWINGS ST-K1640-D TO ST-K1643-D, ST-K3640-D AND ST-K3641-D.
- 4. FOR TRACK SUPERELEVATION DETAILS, SEE ALIGNMENT AND TYPICAL SECTION PLANS; DRAWING TT-B0056-D.

1"=10'



						M. BRATT DRAWN BY	
						A. M. CHECKED BY	
						K. CHARAN	
						IN CHARGE	
						C. LEMLEY	
REV	DATE	BY	СНК	APP	DESCRIPTION	DATE 08/12/2016	

RECORD SET 15% DESIGN SUBMITTAL NOT FOR **CONSTRUCTION**





CALIFORNIA HIGH-SPEED TRAIN PROJECT MERCED TO FRESNO SECTION

CENTRAL VALLEY WYE SR 152 (NORTH) TO ROAD 11 WYE ALTERNATIVE GENERAL PLAN (SJD-MER) WASHINGTON ROAD (AVENUE 25) UNDERPASS

CONTRACT NO.
HSR08-05
DRAWING NO.
ST-K1655-D
SCALE
AS SHOWN
SHEET NO.

