


Merced to Fresno Section: Central Valley Wye

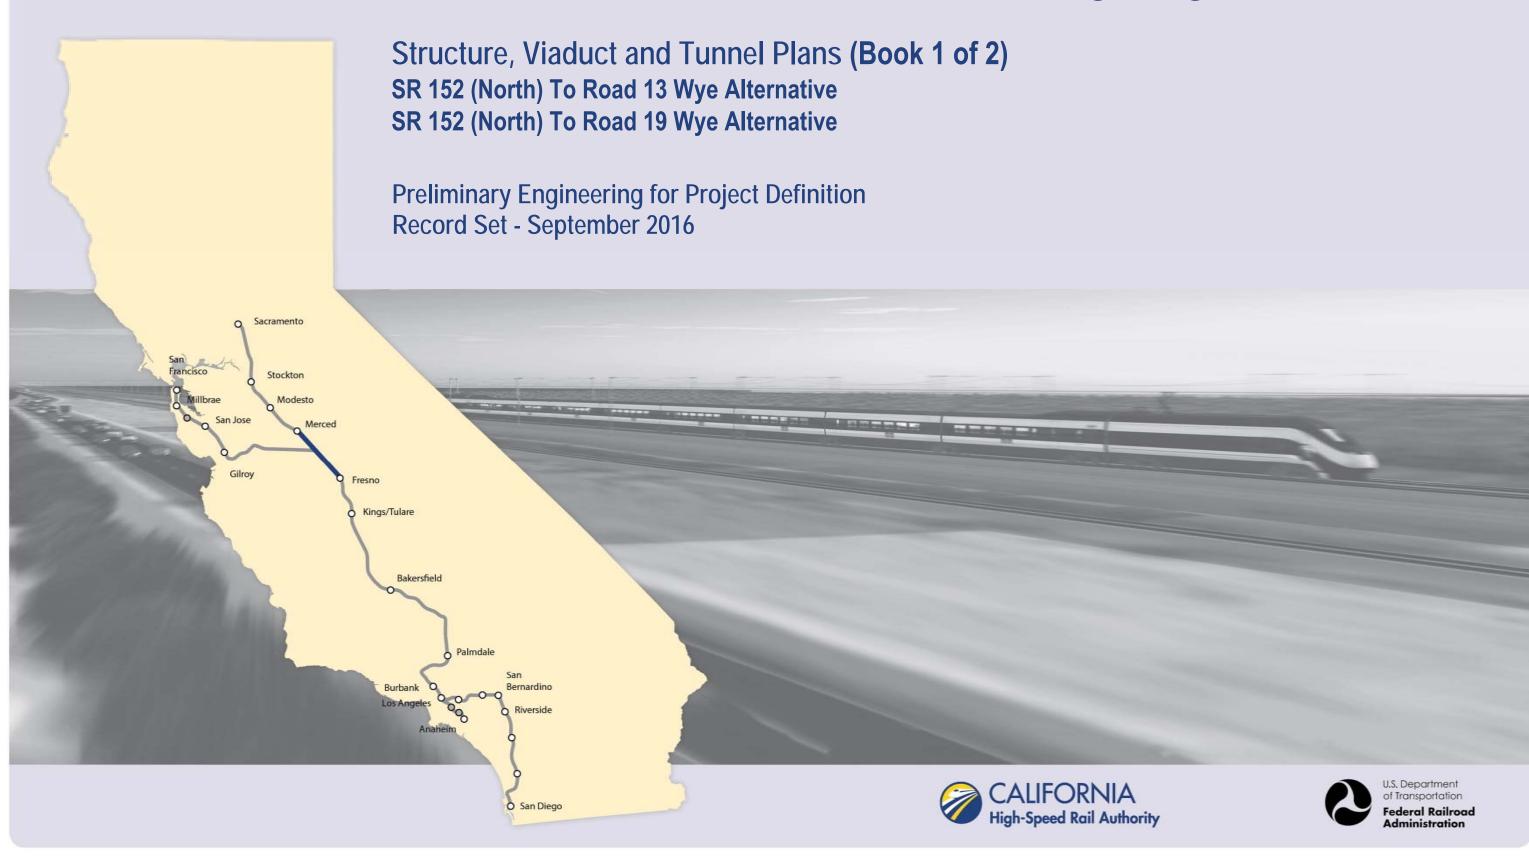

| | | | INDEX OF DRAWINGS | | |
|-------------|--------------------|---|---------------------------------------|---|--|
| DRAWING NO. | SECTION | ALIGNMENT / PLAN SET | TITLE | DESCRIPTION | |
| | | | GENERAL | | |
| ST-B0001 | CENTRAL VALLEY WYE | STRUCTURE, VIADUCT AND TUNNEL PLANS | COVER | | |
| ST-B0002 | CENTRAL VALLEY WYE | STRUCTURE, VIADUCT AND TUNNEL PLANS | INDEX OF DRAWINGS | SHEET 1 OF 8 | |
| ST-B0003 | CENTRAL VALLEY WYE | STRUCTURE, VIADUCT AND TUNNEL PLANS | INDEX OF DRAWINGS | SHEET 2 OF 8 | |
| ST-B0004 | CENTRAL VALLEY WYE | STRUCTURE, VIADUCT AND TUNNEL PLANS | INDEX OF DRAWINGS | SHEET 3 OF 8 | |
| ST-B0005 | CENTRAL VALLEY WYE | STRUCTURE, VIADUCT AND TUNNEL PLANS | INDEX OF DRAWINGS | SHEET 4 OF 8 | |
| ST-B0006 | CENTRAL VALLEY WYE | STRUCTURE, VIADUCT AND TUNNEL PLANS | INDEX OF DRAWINGS | SHEET 5 OF 8 | |
| ST-B0007 | CENTRAL VALLEY WYE | STRUCTURE, VIADUCT AND TUNNEL PLANS | INDEX OF DRAWINGS | SHEET 6 OF 8 | |
| ST-B0008 | CENTRAL VALLEY WYE | STRUCTURE, VIADUCT AND TUNNEL PLANS | INDEX OF DRAWINGS | SHEET 7 OF 8 | |
| ST-B0009 | CENTRAL VALLEY WYE | STRUCTURE, VIADUCT AND TUNNEL PLANS | INDEX OF DRAWINGS | SHEET 8 OF 8 | |
| ST-B0010 | CENTRAL VALLEY WYE | STRUCTURE, VIADUCT AND TUNNEL PLANS | ABBREVIATIONS | SHEET 1 OF 2 | |
| ST-B0011 | CENTRAL VALLEY WYE | STRUCTURE, VIADUCT AND TUNNEL PLANS | ABBREVIATIONS | SHEET 2 OF 2 | |
| ST-B4000 | CENTRAL VALLEY WYE | STRUCTURE, VIADUCT AND TUNNEL PLANS | LOCATION PLAN | | |
| | | SR 1 | 52 (NORTH) TO ROAD 13 WYE ALTERNATIVE | | |
| ST-B4001-A | CENTRAL VALLEY WYE | SR 152 (NORTH) TO ROAD 13 WYE ALTERNATIVE | KEY MAP OF STRUCTURAL PLANS | SHEET 1 OF 2 | |
| ST-B4002-A | CENTRAL VALLEY WYE | SR 152 (NORTH) TO ROAD 13 WYE ALTERNATIVE | KEY MAP OF STRUCTURAL PLANS | SHEET 2 OF 2 | |
| ST-K1050-A | CENTRAL VALLEY WYE | SR 152 (NORTH) TO ROAD 13 WYE ALTERNATIVE | GENERAL PLAN (SJD-FRE) | INDIANA ROAD OVERHEAD | |
| ST-K1060-A | CENTRAL VALLEY WYE | SR 152 (NORTH) TO ROAD 13 WYE ALTERNATIVE | GENERAL PLAN (SJD-FRE) | WILLIS ROAD UNDERPASS | |
| ST-K1065-A | CENTRAL VALLEY WYE | SR 152 (NORTH) TO ROAD 13 WYE ALTERNATIVE | GENERAL PLAN (SJD-FRE) | SAN JOAQUIN RIVER BRIDGE - 1 OF 2 | |
| ST-K3065-A | CENTRAL VALLEY WYE | SR 152 (NORTH) TO ROAD 13 WYE ALTERNATIVE | TYPICAL SECTION (SJD-FRE) | SAN JOAQUIN RIVER BRIDGE - 2 OF 2 | |
| ST-K1070-A | CENTRAL VALLEY WYE | SR 152 (NORTH) TO ROAD 13 WYE ALTERNATIVE | GENERAL PLAN (SJD-FRE) | MARIPOSA SLOUGH BRIDGE | |
| ST-K1075-A | CENTRAL VALLEY WYE | SR 152 (NORTH) TO ROAD 13 WYE ALTERNATIVE | GENERAL PLAN (SJD-FRE) | HARMON ROAD UNDERPASS | |
| ST-K1080-A | CENTRAL VALLEY WYE | SR 152 (NORTH) TO ROAD 13 WYE ALTERNATIVE | GENERAL PLAN (SJD-FRE) | AERIAL #1 - EASTSIDE BYPASS IRRIGATION DITCH - 1 OF 2 | |
| ST-K3080-A | CENTRAL VALLEY WYE | SR 152 (NORTH) TO ROAD 13 WYE ALTERNATIVE | TYPICAL SECTION (SJD-FRE) | AERIAL #1 - EASTSIDE BYPASS IRRIGATION DITCH - 2 OF 2 | |
| ST-K1100-A | CENTRAL VALLEY WYE | SR 152 (NORTH) TO ROAD 13 WYE ALTERNATIVE | GENERAL PLAN (SJD-FRE) | SR 59 / SR 152 INTERCHANGE - 1 OF 4 | |
| ST-K1101-A | CENTRAL VALLEY WYE | SR 152 (NORTH) TO ROAD 13 WYE ALTERNATIVE | GENERAL PLAN (SJD-FRE) | SR 59 / SR 152 INTERCHANGE - 2 OF 4 | |
| ST-K3101-A | CENTRAL VALLEY WYE | SR 152 (NORTH) TO ROAD 13 WYE ALTERNATIVE | TYPICAL SECTIONS (SJD-FRE) | SR 59 / SR 152 INTERCHANGE - 3 OF 4 | |
| ST-K1102-A | CENTRAL VALLEY WYE | SR 152 (NORTH) TO ROAD 13 WYE ALTERNATIVE | GENERAL PLAN (SJD-FRE) | SR 59 / SR 152 INTERCHANGE - 4 OF 4 | |
| ST-K1110-A | CENTRAL VALLEY WYE | SR 152 (NORTH) TO ROAD 13 WYE ALTERNATIVE | GENERAL PLAN (SJD-FRE) | LINCOLN ROAD (ROAD 4) OVERHEAD | |
| ST-K1160-A | CENTRAL VALLEY WYE | SR 152 (NORTH) TO ROAD 13 WYE ALTERNATIVE | GENERAL PLAN (SJD-FRE) | HEMLOCK ROAD (ROAD 9) INTERCHANGE - 1 OF 2 | |
| ST-K3160-A | CENTRAL VALLEY WYE | SR 152 (NORTH) TO ROAD 13 WYE ALTERNATIVE | TYPICAL SECTIONS (SJD-FRE) | HEMLOCK ROAD (ROAD 9) INTERCHANGE - 2 OF 2 | |
| ST-K1170-A | CENTRAL VALLEY WYE | SR 152 (NORTH) TO ROAD 13 WYE ALTERNATIVE | GENERAL PLAN (SJD-FRE) | ASH SLOUGH BRIDGE - 1 OF 2 | |
| ST-K3170-A | CENTRAL VALLEY WYE | SR 152 (NORTH) TO ROAD 13 WYE ALTERNATIVE | TYPICAL SECTION (SJD-FRE) | ASH SLOUGH BRIDGE - 2 OF 2 | |
| ST-K1190-A | CENTRAL VALLEY WYE | SR 152 (NORTH) TO ROAD 13 WYE ALTERNATIVE | GENERAL PLAN (SJD-FRE) | ELM ROAD (ROAD 12) UNDERPASS | |
| ST-K1195-A | CENTRAL VALLEY WYE | SR 152 (NORTH) TO ROAD 13 WYE ALTERNATIVE | GENERAL PLAN (SJD-FRE) | SR 152 (ROAD 12) UNDERCROSSING | |
| ST-K1210-A | CENTRAL VALLEY WYE | SR 152 (NORTH) TO ROAD 13 WYE ALTERNATIVE | GENERAL PLAN (SJD-FRE) | ROBERTSON BOULEVARD (SR 233) INTERCHANGE - 1 OF 2 | |
| ST-K3210-A | CENTRAL VALLEY WYE | SR 152 (NORTH) TO ROAD 13 WYE ALTERNATIVE | TYPICAL SECTIONS (SJD-FRE) | ROBERTSON BOULEVARD (SR 233) INTERCHANGE - 2 OF 2 | |
| ST-K1220-A | CENTRAL VALLEY WYE | SR 152 (NORTH) TO ROAD 13 WYE ALTERNATIVE | GENERAL PLAN (SJD-FRE) | BERENDA SLOUGH BRIDGE - 1 OF 2 | |
| ST-K3220-A | CENTRAL VALLEY WYE | SR 152 (NORTH) TO ROAD 13 WYE ALTERNATIVE | TYPICAL SECTION (SJD-FRE) | BERENDA SLOUGH BRIDGE - 2 OF 2 | |
| ST-K1230-A | CENTRAL VALLEY WYE | SR 152 (NORTH) TO ROAD 13 WYE ALTERNATIVE | GENERAL PLAN (SJD-FRE) | BERENDA WAY (ROAD 16) UNDERPASS | |
| ST-K1235-A | CENTRAL VALLEY WYE | SR 152 (NORTH) TO ROAD 13 WYE ALTERNATIVE | GENERAL PLAN (SJD-FRE) | BERENDA WAY (ROAD 16) INTERCHANGE - 1 OF 2 | |
| ST-K3235-A | CENTRAL VALLEY WYE | SR 152 (NORTH) TO ROAD 13 WYE ALTERNATIVE | TYPICAL SECTION (SJD-FRE) | BERENDA WAY (ROAD 16) INTERCHANGE - 2 OF 2 | |
| ST-K1240-A | CENTRAL VALLEY WYE | SR 152 (NORTH) TO ROAD 13 WYE ALTERNATIVE | | ROAD 17 1/2 OVERHEAD | |
| | | DESIGNED BY M. BRATT RECORD SET DRAWN BY 15% DESIGN | | CALIFORNIA HIGH-SPEED TI Merced to Fresno s | |
| | | CHECKED BY K. CHARAN IN CHARGE NOT FOR | PARSONS | CENTRAL VALLEY WY STRUCTURE, VIADUCT AND TUN TALIFORNIA | |

BY CHK APP

DESCRIPTION

15% DESIGN Submittal NOT FOR CONSTRUCTION

IN CHARGE
C. LEMLEY

DATE 08/12/2016



AIN PROJECT MERCED TO FRESNO SECTION

CENTRAL VALLEY WYE STRUCTURE, VIADUCT AND TUNNEL PLANS INDEX OF DRAWINGS SHEET 1 OF 8

| CONTRACT NO. HSRO8-05 |
|-------------------------|
| DRAWING NO. ST-B0002 |
| NO SCALE |
| SHEET NO. |

| | | | INDEX OF DRAWINGS | | |
|-------------|--------------------|---|----------------------------|---|--|
| DRAWING NO. | SECTION | ALIGNMENT / PLAN SET | TITLE | DESCRIPTION | |
| ST-K1250-A | CENTRAL VALLEY WYE | SR 152 (NORTH) TO ROAD 13 WYE ALTERNATIVE | GENERAL PLAN (SJD-FRE) | AERIAL #2 - SR 99 / UPRR - 1 OF 3 | |
| ST-K1251-A | CENTRAL VALLEY WYE | SR 152 (NORTH) TO ROAD 13 WYE ALTERNATIVE | GENERAL PLAN (SJD-FRE) | AERIAL #2 - SR 99 / UPRR - 2 OF 3 | |
| ST-K3250-A | CENTRAL VALLEY WYE | SR 152 (NORTH) TO ROAD 13 WYE ALTERNATIVE | TYPICAL SECTIONS (SJD-FRE) | AERIAL #2 - SR 99 / UPRR - 3 OF 3 | |
| ST-K1260-A | CENTRAL VALLEY WYE | SR 152 (NORTH) TO ROAD 13 WYE ALTERNATIVE | GENERAL PLAN (SJD-FRE) | ROAD 20 OVERHEAD | |
| ST-K1280-A | CENTRAL VALLEY WYE | SR 152 (NORTH) TO ROAD 13 WYE ALTERNATIVE | GENERAL PLAN (SJD-FRE) | ROAD 22 OVERHEAD | |
| ST-K1310-A | CENTRAL VALLEY WYE | SR 152 (NORTH) TO ROAD 13 WYE ALTERNATIVE | GENERAL PLAN (SJD-FRE) | AVENUE 20 1/2 OVERHEAD | |
| ST-K1330-A | CENTRAL VALLEY WYE | SR 152 (NORTH) TO ROAD 13 WYE ALTERNATIVE | GENERAL PLAN (SJD-FRE) | DRY CREEK BRIDGE | |
| ST-K1420-A | CENTRAL VALLEY WYE | SR 152 (NORTH) TO ROAD 13 WYE ALTERNATIVE | GENERAL PLAN (MER-FRE) | AERIAL #3 - SOUTHBOUND OVER HST MAINLINE - 1 OF 6 | |
| ST-K1421-A | CENTRAL VALLEY WYE | SR 152 (NORTH) TO ROAD 13 WYE ALTERNATIVE | GENERAL PLAN (MER-FRE) | AERIAL #3 - SOUTHBOUND OVER HST MAINLINE - 2 OF 6 | |
| ST-K1422-A | CENTRAL VALLEY WYE | SR 152 (NORTH) TO ROAD 13 WYE ALTERNATIVE | GENERAL PLAN (MER-FRE) | AERIAL #3 - SOUTHBOUND OVER HST MAINLINE - 3 OF 6 | |
| ST-K3420-A | CENTRAL VALLEY WYE | SR 152 (NORTH) TO ROAD 13 WYE ALTERNATIVE | TYPICAL SECTION (MER-FRE) | AERIAL #3 - SOUTHBOUND OVER HST MAINLINE - 4 OF 6 | |
| ST-K3421-A | CENTRAL VALLEY WYE | SR 152 (NORTH) TO ROAD 13 WYE ALTERNATIVE | TYPICAL SECTION (MER-FRE) | AERIAL #3 - SOUTHBOUND OVER HST MAINLINE - 5 OF 6 | |
| ST-K3422-A | CENTRAL VALLEY WYE | SR 152 (NORTH) TO ROAD 13 WYE ALTERNATIVE | TYPICAL SECTIONS (MER-FRE) | AERIAL #3 - SOUTHBOUND OVER HST MAINLINE - 6 OF 6 | |
| ST-K1430-A | CENTRAL VALLEY WYE | SR 152 (NORTH) TO ROAD 13 WYE ALTERNATIVE | GENERAL PLAN (MER-FRE) | RAILROAD DRIVE UNDERPASS (HST NB) | |
| ST-K1433-A | CENTRAL VALLEY WYE | SR 152 (NORTH) TO ROAD 13 WYE ALTERNATIVE | GENERAL PLAN (MER-FRE) | ROBERTSON BOULEVARD (SR 233) UNDERPASS | |
| ST-K1436-A | CENTRAL VALLEY WYE | SR 152 (NORTH) TO ROAD 13 WYE ALTERNATIVE | GENERAL PLAN (MER-FRE) | MADISON ROAD (AVENUE 23 1/2) UNDERPASS | |
| ST-K1450-A | CENTRAL VALLEY WYE | SR 152 (NORTH) TO ROAD 13 WYE ALTERNATIVE | GENERAL PLAN (MER-FRE) | WASHINGTON ROAD (AVENUE 25) UNDERPASS - 1 OF 2 | |
| ST-K3450-A | CENTRAL VALLEY WYE | SR 152 (NORTH) TO ROAD 13 WYE ALTERNATIVE | TYPICAL SECTION (MER-FRE) | WASHINGTON ROAD (AVENUE 25) UNDERPASS - 2 OF 2 | |
| ST-K1455-A | CENTRAL VALLEY WYE | SR 152 (NORTH) TO ROAD 13 WYE ALTERNATIVE | GENERAL PLAN (MER-FRE) | ASH SLOUGH BRIDGE - 1 OF 2 | |
| ST-K3455-A | CENTRAL VALLEY WYE | SR 152 (NORTH) TO ROAD 13 WYE ALTERNATIVE | TYPICAL SECTION (MER-FRE) | ASH SLOUGH BRIDGE - 2 OF 2 | |
| ST-K1460-A | CENTRAL VALLEY WYE | SR 152 (NORTH) TO ROAD 13 WYE ALTERNATIVE | GENERAL PLAN (MER-FRE) | AVENUE 26 1/2 UNDERPASS | |
| ST-K1470-A | CENTRAL VALLEY WYE | SR 152 (NORTH) TO ROAD 13 WYE ALTERNATIVE | GENERAL PLAN (MER-FRE) | CHOWCHILLA RIVER BRIDGE - 1 OF 2 | |
| ST-K3470-A | CENTRAL VALLEY WYE | SR 152 (NORTH) TO ROAD 13 WYE ALTERNATIVE | TYPICAL SECTION (MER-FRE) | CHOWCHILLA RIVER BRIDGE - 2 OF 2 | |
| ST-K1475-A | CENTRAL VALLEY WYE | SR 152 (NORTH) TO ROAD 13 WYE ALTERNATIVE | GENERAL PLAN (MER-FRE) | VISTA AVENUE (ROAD 13) UNDERPASS | |
| ST-K1490-A | CENTRAL VALLEY WYE | SR 152 (NORTH) TO ROAD 13 WYE ALTERNATIVE | GENERAL PLAN (MER-FRE) | DUTCHMAN CREEK BRIDGE | |
| ST-K1495-A | CENTRAL VALLEY WYE | SR 152 (NORTH) TO ROAD 13 WYE ALTERNATIVE | GENERAL PLAN (MER-FRE) | ROAD 11 BRIDGE | |
| ST-T1500-A | CENTRAL VALLEY WYE | SR 152 (NORTH) TO ROAD 13 WYE ALTERNATIVE | GENERAL PLAN (MER-FRE) | RETAINED CUT - SANDY MUSH ROAD - 1 OF 2 | |
| ST-T3500-A | CENTRAL VALLEY WYE | SR 152 (NORTH) TO ROAD 13 WYE ALTERNATIVE | TYPICAL SECTIONS (MER-FRE) | RETAINED CUT - SANDY MUSH ROAD - 2 OF 2 | |
| ST-K1500-A | CENTRAL VALLEY WYE | SR 152 (NORTH) TO ROAD 13 WYE ALTERNATIVE | GENERAL PLAN (MER-FRE) | SANDY MUSH ROAD OVERHEAD | |
| ST-K1620-A | CENTRAL VALLEY WYE | SR 152 (NORTH) TO ROAD 13 WYE ALTERNATIVE | GENERAL PLAN (SJD-MER) | AERIAL #4 - NORTHBOUND OVER HST MAINLINE - 1 OF 6 | |
| ST-K1621-A | CENTRAL VALLEY WYE | SR 152 (NORTH) TO ROAD 13 WYE ALTERNATIVE | GENERAL PLAN (SJD-MER) | AERIAL #4 - NORTHBOUND OVER HST MAINLINE - 2 OF 6 | |
| ST-K1622-A | CENTRAL VALLEY WYE | SR 152 (NORTH) TO ROAD 13 WYE ALTERNATIVE | GENERAL PLAN (SJD-MER) | AERIAL #4 - NORTHBOUND OVER HST MAINLINE - 3 OF 6 | |
| ST-K1623-A | CENTRAL VALLEY WYE | SR 152 (NORTH) TO ROAD 13 WYE ALTERNATIVE | GENERAL PLAN (SJD-MER) | AERIAL #4 - NORTHBOUND OVER HST MAINLINE - 4 OF 6 | |
| ST-K3620-A | CENTRAL VALLEY WYE | SR 152 (NORTH) TO ROAD 13 WYE ALTERNATIVE | TYPICAL SECTIONS (SJD-MER) | AERIAL #4 - NORTHBOUND OVER HST MAINLINE - 5 OF 6 | |
| ST-K3621-A | CENTRAL VALLEY WYE | SR 152 (NORTH) TO ROAD 13 WYE ALTERNATIVE | TYPICAL SECTIONS (SJD-MER) | AERIAL #4 - NORTHBOUND OVER HST MAINLINE - 6 OF 6 | |
| ST-K1630-A | CENTRAL VALLEY WYE | SR 152 (NORTH) TO ROAD 13 WYE ALTERNATIVE | GENERAL PLAN (SJD-MER) | ELM ROAD (ROAD 12) UNDERPASS | |
| ST-K1635-A | CENTRAL VALLEY WYE | SR 152 (NORTH) TO ROAD 13 WYE ALTERNATIVE | GENERAL PLAN (SJD-MER) | MADISON ROAD (AVENUE 23 1/2) OVERHEAD | |
| ST-K1650-A | CENTRAL VALLEY WYE | SR 152 (NORTH) TO ROAD 13 WYE ALTERNATIVE | GENERAL PLAN (SJD-MER) | AERIAL #5 - NORTHBOUND OVER HST MERCED TO FRESNO - 1 OF 5 | |
| ST-K1651-A | CENTRAL VALLEY WYE | SR 152 (NORTH) TO ROAD 13 WYE ALTERNATIVE | GENERAL PLAN (SJD-MER) | AERIAL #5 - NORTHBOUND OVER HST MERCED TO FRESNO - 2 OF 5 | |
| ST-K1652-A | CENTRAL VALLEY WYE | SR 152 (NORTH) TO ROAD 13 WYE ALTERNATIVE | GENERAL PLAN (SJD-MER) | AERIAL #5 - NORTHBOUND OVER HST MERCED TO FRESNO - 3 OF 5 | |
| ST-K3650-A | CENTRAL VALLEY WYE | SR 152 (NORTH) TO ROAD 13 WYE ALTERNATIVE | TYPICAL SECTIONS (SJD-MER) | AERIAL #5 - NORTHBOUND OVER HST MERCED TO FRESNO - 4 OF 5 | |
| ST-K3651-A | CENTRAL VALLEY WYE | SR 152 (NORTH) TO ROAD 13 WYE ALTERNATIVE | TYPICAL SECTIONS (SJD-MER) | AERIAL #5 - NORTHBOUND OVER HST MERCED TO FRESNO - 5 OF 5 | |

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| 16- | | | | | | | DESIGNED BY M. BRATT | |
| | | | | | | | DRAWN BY A. M. | |
| _ | | | | | | | CHECKED BY K. CHARAN | |
| 1330 | | | | | | | IN CHARGE C. LEMLEY | |
| p0051 | REV | DATE | BY | снк | APP | DESCRIPTION | DATE 08/12/2016 | |

RECORD SET 15% DESIGN SUBMITTAL NOT FOR CONSTRUCTION





CALIFORNIA HIGH-SPEED TRAIN PROJECT MERCED TO FRESNO SECTION

CENTRAL VALLEY WYE STRUCTURE, VIADUCT AND TUNNEL PLANS INDEX OF DRAWINGS SHEET 2 OF 8

| CONTRACT NO. |
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| HSR08-05 |
| DRAWING NO. |
| ST-B0003 |
| SCALE |
| NO SCALE |
| SHEET NO. |

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| CH - 2 OF 2 | |
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| 4 | |
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| OF 2 | |
| OF 2 | |
| | |
| ASH SLOUGH BRIDGE ELM ROAD (ROAD 12) OVERHEAD | |
| ROBERTSON BOULEVARD (SR 233) INTERCHANGE - 1 OF 2 | |
| ROBERTSON BOULEVARD (SR 233) INTERCHANGE - 2 OF 2 | |
| BERENDA SLOUGH BRIDGE | |
| | |
| OF 2 | |
| OF 2 | |
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| 3 | |
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| 3 | |
| 3 | |
| | |
| ROAD 22 OVERHEAD | |
| AVENUE 20 1/2 OVERHEAD | |
| DRY CREEK BRIDGE | |
| AERIAL #3 - SOUTHBOUND OVER HST MAINLINE - 1 OF 5 | |
| AERIAL #3 - SOUTHBOUND OVER HST MAINLINE - 2 OF 5 | |
| AERIAL #3 - SOUTHBOUND OVER HST MAINLINE - 3 OF 5 | |
| AERIAL #3 - SOUTHBOUND OVER HST MAINLINE - 4 OF 5 | |
| - 5 OF 5 | |
| H-SPEED T | |
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16-AUG-201607:

| DESIGNED BY | M. BRATT | DRAWN BY | A. M. | CHECKED BY | K. CHARAN | IN CHARGE | C. LEMLEY | DATE | BY CHK | APP | DESCRIPTION | DATE | O8/12/2016

RECORD SET
15% DESIGN
SUBMITTAL
NOT FOR
CONSTRUCTION





CALIFORNIA HIGH-SPEED TRAIN PROJECT MERCED TO FRESNO SECTION

CENTRAL VALLEY WYE STRUCTURE, VIADUCT AND TUNNEL PLANS INDEX OF DRAWINGS SHEET 3 OF 8 CONTRACT NO.
HSR08-05
DRAWING NO.
ST-B0004
SCALE
NO SCALE

NO SCALE

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| 16- | | | | | | | DESIGNED BY M. BRATT | Г |
| | | | | | | | DRAWN BY A. M. | 1 |
| 0 | | | | | | | CHECKED BY K. CHARAN | 1 |
| 5133a | | | | | | | IN CHARGE C. LEMLEY | |
| p0051 | REV | DATE | BY | снк | APP | DESCRIPTION | DATE 08/12/2016 | |

RECORD SET
15% DESIGN
SUBMITTAL
NOT FOR
CONSTRUCTION





CALIFORNIA HIGH-SPEED TRAIN PROJECT MERCED TO FRESNO SECTION

CENTRAL VALLEY WYE
STRUCTURE, VIADUCT AND TUNNEL PLANS
INDEX OF DRAWINGS
SHEET 4 OF 8

| CONTRACT NO. |
|--------------|
| HSR08-05 |
| DRAWING NO. |
| ST-B0005 |
| SCALE |
| NO SCALE |

SHEET NO.

| | | | | INDEX OF DRAWINGS | | | | |
|-------------|--------------------|--|---|----------------------------|-----------------------------------|--|--|--|
| DRAWING NO. | SECTION | ALIGNMENT / PLAN S | ET | TITLE | | DESCRIPTION | | |
| ST-K1070-C | CENTRAL VALLEY WYE | AVENUE 21 TO ROAD 13 WYE | ALTERNATIVE | GENERAL PLAN (SJD-FRE) | SAN JOAQUIN RIVER BRIDGE - 1 OF 2 | | | |
| ST-K3070-C | CENTRAL VALLEY WYE | AVENUE 21 TO ROAD 13 WYE | ALTERNATIVE | TYPICAL SECTION (SJD-FRE) | SAN JOAQU | SAN JOAQUIN RIVER BRIDGE - 2 OF 2 | | |
| ST-K1080-C | CENTRAL VALLEY WYE | AVENUE 21 TO ROAD 13 WYE | ALTERNATIVE | GENERAL PLAN (SJD-FRE) | AERIAL #1 - FRESNO | RIVER AND MARIPOSA SLOUGH - 1 OF 2 | | |
| ST-K3080-C | CENTRAL VALLEY WYE | AVENUE 21 TO ROAD 13 WYE | ALTERNATIVE | TYPICAL SECTION (SJD-FRE) | AERIAL #1 - FRESNO | RIVER AND MARIPOSA SLOUGH - 2 OF 2 | | |
| ST-K1085-C | CENTRAL VALLEY WYE | AVENUE 21 TO ROAD 13 WYE | ALTERNATIVE | GENERAL PLAN (SJD-FRE) | S | R 152 UNDERPASS | | |
| ST-K1090-C | CENTRAL VALLEY WYE | AVENUE 21 TO ROAD 13 WYE | ALTERNATIVE | GENERAL PLAN (SJD-FRE) | FLAN | AGAN ROAD UNDERPASS | | |
| ST-K1100-C | CENTRAL VALLEY WYE | AVENUE 21 TO ROAD 13 WYE | ALTERNATIVE | GENERAL PLAN (SJD-FRE) | AERIAL #2 - EASTSI | DE BYPASS IRRIGATION DITCH - 1 OF 2 | | |
| ST-K3100-C | CENTRAL VALLEY WYE | AVENUE 21 TO ROAD 13 WYE | ALTERNATIVE | TYPICAL SECTION (SJD-FRE) | AERIAL #2 - EASTSI | DE BYPASS IRRIGATION DITCH - 2 OF 2 | | |
| ST-K1120-C | CENTRAL VALLEY WYE | AVENUE 21 TO ROAD 13 WYE | ALTERNATIVE | GENERAL PLAN (SJD-FRE) | LINCOLN | ROAD (ROAD 4) OVERHEAD | | |
| ST-K1150-C | CENTRAL VALLEY WYE | AVENUE 21 TO ROAD 13 WYE | ALTERNATIVE | GENERAL PLAN (SJD-FRE) | JUNIPER | ROAD (ROAD 7) UNDERPASS | | |
| ST-K1155-C | CENTRAL VALLEY WYE | AVENUE 21 TO ROAD 13 WYE | ALTERNATIVE | GENERAL PLAN (SJD-FRE) | ASH S | LOUGH BRIDGE - 1 OF 2 | | |
| ST-K3155-C | CENTRAL VALLEY WYE | AVENUE 21 TO ROAD 13 WYE | ALTERNATIVE | TYPICAL SECTION (SJD-FRE) | ASH S | LOUGH BRIDGE - 2 OF 2 | | |
| ST-K1160-C | CENTRAL VALLEY WYE | AVENUE 21 TO ROAD 13 WYE | ALTERNATIVE | GENERAL PLAN (SJD-FRE) | HEMLOCK | ROAD (ROAD 9) OVERHEAD | | |
| ST-K1200-C | CENTRAL VALLEY WYE | AVENUE 21 TO ROAD 13 WYE | ALTERNATIVE | GENERAL PLAN (SJD-FRE) | ROBERTS | ON BOULEVARD OVERHEAD | | |
| ST-K1210-C | CENTRAL VALLEY WYE | AVENUE 21 TO ROAD 13 WYE | ALTERNATIVE | GENERAL PLAN (SJD-FRE) | R | DAD 14 UNDERPASS | | |
| ST-K1220-C | CENTRAL VALLEY WYE | AVENUE 21 TO ROAD 13 WYE | ALTERNATIVE | GENERAL PLAN (SJD-FRE) | BER | ENDA SLOUGH BRIDGE | | |
| ST-K1230-C | CENTRAL VALLEY WYE | AVENUE 21 TO ROAD 13 WYE | ALTERNATIVE | GENERAL PLAN (SJD-FRE) | BERENDA | WAY (ROAD 16) OVERHEAD | | |
| ST-K1260-C | CENTRAL VALLEY WYE | AVENUE 21 TO ROAD 13 WYE | ALTERNATIVE | GENERAL PLAN (SJD-FRE) | R | OAD 19 OVERHEAD | | |
| ST-K1270-C | CENTRAL VALLEY WYE | AVENUE 21 TO ROAD 13 WYE | ALTERNATIVE | GENERAL PLAN (SJD-FRE) | RO | DAD 20 UNDERPASS | | |
| ST-K1275-C | CENTRAL VALLEY WYE | AVENUE 21 TO ROAD 13 WYE | ALTERNATIVE | GENERAL PLAN (SJD-FRE) | AERIAL #3 | 3 - SR 99 / UPRR - 1 OF 2 | | |
| ST-K3275-C | CENTRAL VALLEY WYE | AVENUE 21 TO ROAD 13 WYE | ALTERNATIVE | TYPICAL SECTIONS (SJD-FRE) | AERIAL #3 | 3 - SR 99 / UPRR - 2 OF 2 | | |
| ST-K1290-C | CENTRAL VALLEY WYE | AVENUE 21 TO ROAD 13 WYE | ALTERNATIVE | GENERAL PLAN (SJD-FRE) | R | ROAD 22 OVERHEAD | | |
| ST-K1300-C | CENTRAL VALLEY WYE | AVENUE 21 TO ROAD 13 WYE | ALTERNATIVE | GENERAL PLAN (SJD-FRE) | AVEN | AVENUE 20 1/2 OVERHEAD | | |
| ST-K1320-C | CENTRAL VALLEY WYE | AVENUE 21 TO ROAD 13 WYE | ALTERNATIVE | GENERAL PLAN (SJD-FRE) | С | DRY CREEK BRIDGE | | |
| ST-K1420-C | CENTRAL VALLEY WYE | AVENUE 21 TO ROAD 13 WYE | ALTERNATIVE | GENERAL PLAN (MER-FRE) | AERIAL #4 - SOUTI | AERIAL #4 - SOUTHBOUND OVER HST MAINLINE - 1 OF 6 | | |
| ST-K1421-C | CENTRAL VALLEY WYE | AVENUE 21 TO ROAD 13 WYE | ALTERNATIVE | GENERAL PLAN (MER-FRE) | AERIAL #4 - SOUTH | AERIAL #4 - SOUTHBOUND OVER HST MAINLINE - 2 OF 6 | | |
| ST-K1422-C | CENTRAL VALLEY WYE | AVENUE 21 TO ROAD 13 WYE | ALTERNATIVE | GENERAL PLAN (MER-FRE) | AERIAL #4 - SOUTH | HBOUND OVER HST MAINLINE - 3 OF 6 | | |
| ST-K1423-C | CENTRAL VALLEY WYE | AVENUE 21 TO ROAD 13 WYE | ALTERNATIVE | GENERAL PLAN (MER-FRE) | AERIAL #4 - SOUTH | HBOUND OVER HST MAINLINE - 4 OF 6 | | |
| ST-K3420-C | CENTRAL VALLEY WYE | AVENUE 21 TO ROAD 13 WYE | ALTERNATIVE | TYPICAL SECTIONS (MER-FRE) | AERIAL #4 - SOUTH | HBOUND OVER HST MAINLINE - 5 OF 6 | | |
| ST-K3421-C | CENTRAL VALLEY WYE | AVENUE 21 TO ROAD 13 WYE | ALTERNATIVE | TYPICAL SECTIONS (MER-FRE) | AERIAL #4 - SOUTH | HBOUND OVER HST MAINLINE - 6 OF 6 | | |
| ST-K1426-C | CENTRAL VALLEY WYE | AVENUE 21 TO ROAD 13 WYE | ALTERNATIVE | GENERAL PLAN (MER-FRE) | HST NB BR | IDGE OVER BERENDA SLOUGH | | |
| ST-K1430-C | CENTRAL VALLEY WYE | AVENUE 21 TO ROAD 13 WYE | ALTERNATIVE | GENERAL PLAN (MER-FRE) | ROAD | 14 UNDERPASS (HST NB) | | |
| ST-K1435-C | CENTRAL VALLEY WYE | AVENUE 21 TO ROAD 13 WYE | ALTERNATIVE | GENERAL PLAN (MER-FRE) | AVEN | NUE 21 1/2 OVERHEAD | | |
| ST-K1440-C | CENTRAL VALLEY WYE | AVENUE 21 TO ROAD 13 WYE | ALTERNATIVE | GENERAL PLAN (MER-FRE) | ROBERTSO | ROBERTSON BOULEVARD UNDERPASS | | |
| ST-K1445-C | CENTRAL VALLEY WYE | AVENUE 21 TO ROAD 13 WYE | ALTERNATIVE | GENERAL PLAN (MER-FRE) | AVEN | AVENUE 22 1/2 UNDERPASS | | |
| ST-K1450-C | CENTRAL VALLEY WYE | AVENUE 21 TO ROAD 13 WYE | ALTERNATIVE | GENERAL PLAN (MER-FRE) | SR 15 | SR 152 UNDERPASS - 1 OF 2 | | |
| ST-K3450-C | CENTRAL VALLEY WYE | AVENUE 21 TO ROAD 13 WYE | ALTERNATIVE | TYPICAL SECTION (MER-FRE) | SR 15 | SR 152 UNDERPASS - 2 OF 2 | | |
| ST-K1470-C | CENTRAL VALLEY WYE | AVENUE 21 TO ROAD 13 WYE | ALTERNATIVE | GENERAL PLAN (MER-FRE) | WASHINGTON | WASHINGTON ROAD (AVENUE 25) UNDERPASS | | |
| ST-K1475-C | CENTRAL VALLEY WYE | AVENUE 21 TO ROAD 13 WYE | ALTERNATIVE | GENERAL PLAN (MER-FRE) | ASH S | ASH SLOUGH BRIDGE - 1 OF 2 | | |
| ST-K3475-C | CENTRAL VALLEY WYE | AVENUE 21 TO ROAD 13 WYE | ALTERNATIVE | TYPICAL SECTION (MER-FRE) | ASH S | ASH SLOUGH BRIDGE - 2 OF 2 | | |
| ST-K1480-C | CENTRAL VALLEY WYE | AVENUE 21 TO ROAD 13 WYE | ALTERNATIVE | GENERAL PLAN (MER-FRE) | AVEN | AVENUE 26 1/2 UNDERPASS | | |
| ST-K1490-C | CENTRAL VALLEY WYE | AVENUE 21 TO ROAD 13 WYE | ALTERNATIVE | GENERAL PLAN (MER-FRE) | CHOWCHIL | CHOWCHILLA RIVER BRIDGE - 1 OF 2 | | |
| ST-K3490-C | CENTRAL VALLEY WYE | AVENUE 21 TO ROAD 13 WYE . | ALTERNATIVE | TYPICAL SECTION (MER-FRE) | CHOWCHIL | LA RIVER BRIDGE - 2 OF 2 | | |
| | | DESIGNED BY M. BRATT DRAWN BY A. M. CHECKED BY K. CHARAN IN CHARGE | RECORD SET 15% DESIGN SUBMITTAL NOT FOR | PARSONS | CALIFORNIA | CALIFORNIA HIGH-SPEED T MERCED TO FRESNO S CENTRAL VALLEY WY STRUCTURE, VIADUCT AND TUI | | |

BY CHK APP

DESCRIPTION

15% DESIGN Submittal NOT FOR CONSTRUCTION

IN CHARGE
C. LEMLEY

DATE 08/12/2016



AIN PROJECT MERCED TO FRESNO SECTION

CENTRAL VALLEY WYE
STRUCTURE, VIADUCT AND TUNNEL PLANS
INDEX OF DRAWINGS
SHEET 5 OF 8

| HSRO8-05 |
|-------------------------|
| DRAWING NO. ST-B0006 |
| NO SCALE |
| |

SHEET NO.

| <u> </u> | | | | INDEX OF DRAWINGS | | | |
|-------------|--------------------|-------------------------------|---------------|--|---|--|--|
| DRAWING NO. | SECTION | ALIGNMENT / PLAN SI | ΞΤ | TITLE | DESCRIPTION | | |
| ST-K1495-C | CENTRAL VALLEY WYE | AVENUE 21 TO ROAD 13 WYE A | LTERNATIVE | GENERAL PLAN (MER-FRE) | GENERAL PLAN (MER-FRE) VISTA AVENUE (ROAD 13) UNDERPASS | | |
| ST-K1510-C | CENTRAL VALLEY WYE | AVENUE 21 TO ROAD 13 WYE A | LTERNATIVE | GENERAL PLAN (MER-FRE) | DUTCHMAN CREEK BRIDGE | | |
| ST-K1515-C | CENTRAL VALLEY WYE | AVENUE 21 TO ROAD 13 WYE A | LTERNATIVE | GENERAL PLAN (MER-FRE) | ROAD 11 BRIDGE | | |
| ST-T1520-C | CENTRAL VALLEY WYE | AVENUE 21 TO ROAD 13 WYE A | LTERNATIVE | GENERAL PLAN (MER-FRE) | RETAINED CUT - SANDY MUSH ROAD - 1 | OF 2 | |
| ST-T3520-C | CENTRAL VALLEY WYE | AVENUE 21 TO ROAD 13 WYE A | LTERNATIVE | TYPICAL SECTIONS (MER-FRE) | RETAINED CUT - SANDY MUSH ROAD - 2 | OF 2 | |
| ST-K1520-C | CENTRAL VALLEY WYE | AVENUE 21 TO ROAD 13 WYE A | LTERNATIVE | GENERAL PLAN (MER-FRE) | SANDY MUSH ROAD OVERHEAD | | |
| ST-K1620-C | CENTRAL VALLEY WYE | AVENUE 21 TO ROAD 13 WYE A | LTERNATIVE | GENERAL PLAN (SJD-MER) | AERIAL #5 - NORTHBOUND OVER HST MAINLINE | - 1 OF 5 | |
| ST-K1621-C | CENTRAL VALLEY WYE | AVENUE 21 TO ROAD 13 WYE A | LTERNATIVE | GENERAL PLAN (SJD-MER) | AERIAL #5 - NORTHBOUND OVER HST MAINLINE | - 2 OF 5 | |
| ST-K1622-C | CENTRAL VALLEY WYE | AVENUE 21 TO ROAD 13 WYE A | LTERNATIVE | GENERAL PLAN (SJD-MER) | AERIAL #5 - NORTHBOUND OVER HST MAINLINE | - 3 OF 5 | |
| ST-K3620-C | CENTRAL VALLEY WYE | AVENUE 21 TO ROAD 13 WYE A | LTERNATIVE | TYPICAL SECTIONS (SJD-MER) | AERIAL #5 - NORTHBOUND OVER HST MAINLINE | - 4 OF 5 | |
| T-K3621-C | CENTRAL VALLEY WYE | AVENUE 21 TO ROAD 13 WYE A | LTERNATIVE | TYPICAL SECTIONS (SJD-MER) | AERIAL #5 - NORTHBOUND OVER HST MAINLINE | - 5 OF 5 | |
| T-K1630-C | CENTRAL VALLEY WYE | AVENUE 21 TO ROAD 13 WYE A | LTERNATIVE | GENERAL PLAN (SJD-MER) | AVENUE 21 1/2 OVERHEAD | | |
| ST-K1640-C | CENTRAL VALLEY WYE | AVENUE 21 TO ROAD 13 WYE A | LTERNATIVE | GENERAL PLAN (SJD-MER) | AERIAL #6 - NORTHBOUND OVER HST MERCED TO FR | ESNO - 1 OF | |
| T-K1641-C | CENTRAL VALLEY WYE | AVENUE 21 TO ROAD 13 WYE # | LTERNATIVE | GENERAL PLAN (SJD-MER) | AERIAL #6 - NORTHBOUND OVER HST MERCED TO FR | ESNO - 2 OF | |
| T-K1642-C | CENTRAL VALLEY WYE | AVENUE 21 TO ROAD 13 WYE A | LTERNATIVE | GENERAL PLAN (SJD-MER) | AERIAL #6 - NORTHBOUND OVER HST MERCED TO FR | ESNO - 3 OF | |
| T-K1643-C | CENTRAL VALLEY WYE | AVENUE 21 TO ROAD 13 WYE A | LTERNATIVE | GENERAL PLAN (SJD-MER) | AERIAL #6 - NORTHBOUND OVER HST MERCED TO FR | ESNO - 4 OF | |
| T-K3640-C | CENTRAL VALLEY WYE | AVENUE 21 TO ROAD 13 WYE A | LTERNATIVE | TYPICAL SECTIONS (SJD-MER) | AERIAL #6 - NORTHBOUND OVER HST MERCED TO FR | ESNO - 5 OF | |
| T-K3641-C | CENTRAL VALLEY WYE | AVENUE 21 TO ROAD 13 WYE A | LTERNATIVE | TYPICAL SECTIONS (SJD-MER) | AERIAL #6 - NORTHBOUND OVER HST MERCED TO FR | ESNO - 6 OF | |
| T-K1646-C | CENTRAL VALLEY WYE | AVENUE 21 TO ROAD 13 WYE A | LTERNATIVE | GENERAL PLAN (SJD-MER) | AVENUE 22 1/2 UNDERPASS (HST SB) | | |
| | | | SR 152 | (NORTH) TO ROAD 11 WYE ALTERNATIVE | <u>'</u> | | |
| T-B4001-D | CENTRAL VALLEY WYE | SR 152 (NORTH) TO ROAD 11 WYE | ALTERNATIVE | KEY MAP OF STRUCTURAL PLANS | SHEET 1 OF 2 | | |
| T-B4002-D | CENTRAL VALLEY WYE | SR 152 (NORTH) TO ROAD 11 WYE | ALTERNATIVE | KEY MAP OF STRUCTURAL PLANS | SHEET 2 OF 2 | | |
| T-K1050-D | CENTRAL VALLEY WYE | SR 152 (NORTH) TO ROAD 11 WYE | ALTERNATIVE | GENERAL PLAN (SJD-FRE) | INDIANA ROAD OVERHEAD | INDIANA ROAD OVERHEAD | |
| T-K1055-D | CENTRAL VALLEY WYE | SR 152 (NORTH) TO ROAD 11 WYE | ALTERNATIVE | GENERAL PLAN (SJD-FRE) | WOOD SLOUGH BRIDGE | WOOD SLOUGH BRIDGE | |
| Γ-K1060-D | CENTRAL VALLEY WYE | SR 152 (NORTH) TO ROAD 11 WYE | ALTERNATIVE | GENERAL PLAN (SJD-FRE) | WILLIS ROAD UNDERPASS | | |
| T-K1065-D | CENTRAL VALLEY WYE | SR 152 (NORTH) TO ROAD 11 WYE | ALTERNATIVE | GENERAL PLAN (SJD-FRE) | SAN JOAQUIN RIVER BRIDGE - 1 OF 2 | 2 | |
| Γ-K3065-D | CENTRAL VALLEY WYE | SR 152 (NORTH) TO ROAD 11 WYE | ALTERNATIVE | TYPICAL SECTION (SJD-FRE) | SAN JOAQUIN RIVER BRIDGE - 2 OF 2 | <u> </u> | |
| Γ-K1070-D | CENTRAL VALLEY WYE | SR 152 (NORTH) TO ROAD 11 WYE | ALTERNATIVE | GENERAL PLAN (SJD-FRE) | MARIPOSA SLOUGH BRIDGE | | |
| T-K1075-D | CENTRAL VALLEY WYE | SR 152 (NORTH) TO ROAD 11 WYE | ALTERNATIVE | GENERAL PLAN (SJD-FRE) | HARMON ROAD UNDERPASS | | |
| T-K1080-D | CENTRAL VALLEY WYE | SR 152 (NORTH) TO ROAD 11 WYE | ALTERNATIVE | GENERAL PLAN (SJD-FRE) | AERIAL #1 - EASTSIDE BYPASS IRRIGATION DITC | CH - 1 OF 2 | |
| Γ-K3080-D | CENTRAL VALLEY WYE | SR 152 (NORTH) TO ROAD 11 WYE | ALTERNATIVE | TYPICAL SECTION (SJD-FRE) | AERIAL #1 - EASTSIDE BYPASS IRRIGATION DITC | CH - 2 OF 2 | |
| T-K1100-D | CENTRAL VALLEY WYE | SR 152 (NORTH) TO ROAD 11 WYE | - ALTERNATIVE | GENERAL PLAN (SJD-FRE) | SR 59 / SR 152 INTERCHANGE - 1 OF | 4 | |
| T-K1101-D | CENTRAL VALLEY WYE | SR 152 (NORTH) TO ROAD 11 WYE | ALTERNATIVE | GENERAL PLAN (SJD-FRE) | SR 59 / SR 152 INTERCHANGE - 2 OF | 4 | |
| T-K3101-D | CENTRAL VALLEY WYE | SR 152 (NORTH) TO ROAD 11 WYE | ALTERNATIVE | TYPICAL SECTIONS (SJD-FRE) | SR 59 / SR 152 INTERCHANGE - 3 OF | 4 | |
| T-K1102-D | CENTRAL VALLEY WYE | SR 152 (NORTH) TO ROAD 11 WYE | ALTERNATIVE | GENERAL PLAN (SJD-FRE) | SR 59 / SR 152 INTERCHANGE - 4 OF | 4 | |
| T-K1110-D | CENTRAL VALLEY WYE | SR 152 (NORTH) TO ROAD 11 WYE | ALTERNATIVE | GENERAL PLAN (SJD-FRE) LINCOLN ROAD (ROAD 4) OVERHEAD | | | |
| Γ-K1160-D | CENTRAL VALLEY WYE | SR 152 (NORTH) TO ROAD 11 WYE | ALTERNATIVE | GENERAL PLAN (SJD-FRE) | | | |
| T-K1161-D | CENTRAL VALLEY WYE | SR 152 (NORTH) TO ROAD 11 WYE | ALTERNATIVE | GENERAL PLAN (SJD-FRE) | HEMLOCK ROAD (ROAD 9) INTERCHANGE - 1 OF 2 | | |
| T-K3161-D | CENTRAL VALLEY WYE | SR 152 (NORTH) TO ROAD 11 WYE | | TYPICAL SECTIONS (SJD-FRE) | | HEMLOCK ROAD (ROAD 9) INTERCHANGE - 2 OF 2 | |
| T-K1170-D | CENTRAL VALLEY WYE | SR 152 (NORTH) TO ROAD 11 WYE | | GENERAL PLAN (SJD-FRE) | ASH SLOUGH BRIDGE - 1 OF 2 | | |
| T-K3170-D | CENTRAL VALLEY WYE | SR 152 (NORTH) TO ROAD 11 WYE | | TYPICAL SECTION (SJD-FRE) | ASH SLOUGH BRIDGE - 2 OF 2 | | |
| T-K1190-D | CENTRAL VALLEY WYE | SR 152 (NORTH) TO ROAD 11 WYE | | GENERAL PLAN (SJD-FRE) | ELM ROAD (ROAD 12) UNDERPASS | | |
| ST-K1195-D | CENTRAL VALLEY WYE | SR 152 (NORTH) TO ROAD 11 WYE | | GENERAL PLAN (SJD-FRE) | SR 152 (ROAD 12) UNDERCROSSING | | |
| | | DESIGNED BY M. BRATT | RECORD SET | | CALIFORNIA HIG | H-SPEED | |
| | | DRAWN BY A. M. | 15% DESIGN | | | O FRESNO | |

BY CHK APP

DESCRIPTION

A. M.
CHECKED BY
K. CHARAN 15% DESIGN Submittal NOT FOR CONSTRUCTION IN CHARGE
C. LEMLEY DATE 08/12/2016

PARSONS



AIN PROJECT MERCED TO FRESNO SECTION

CENTRAL VALLEY WYE STRUCTURE, VIADUCT AND TUNNEL PLANS INDEX OF DRAWINGS SHEET 6 OF 8

| HSR08-05 |
|-------------------------|
| DRAWING NO. ST-B0007 |
| NO SCALE |
| SHEET NO. |

| | | | INDEX OF DRAWINGS | |
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| DRAWING NO. | SECTION | ALIGNMENT / PLAN SET | TITLE | DESCRIPTION |
| ST-K1210-D | CENTRAL VALLEY WYE | SR 152 (NORTH) TO ROAD 11 WYE ALTERNATIVE | GENERAL PLAN (SJD-FRE) | ROBERTSON BOULEVARD (SR 233) INTERCHANGE - 1 OF 2 |
| ST-K3210-D | CENTRAL VALLEY WYE | SR 152 (NORTH) TO ROAD 11 WYE ALTERNATIVE | TYPICAL SECTIONS (SJD-FRE) | ROBERTSON BOULEVARD (SR 233) INTERCHANGE - 2 OF 2 |
| ST-K1220-D | CENTRAL VALLEY WYE | SR 152 (NORTH) TO ROAD 11 WYE ALTERNATIVE | GENERAL PLAN (SJD-FRE) | BERENDA SLOUGH BRIDGE - 1 OF 2 |
| ST-K3220-D | CENTRAL VALLEY WYE | SR 152 (NORTH) TO ROAD 11 WYE ALTERNATIVE | TYPICAL SECTION (SJD-FRE) | BERENDA SLOUGH BRIDGE - 2 OF 2 |
| ST-K1230-D | CENTRAL VALLEY WYE | SR 152 (NORTH) TO ROAD 11 WYE ALTERNATIVE | GENERAL PLAN (SJD-FRE) | BERENDA WAY (ROAD 16) UNDERPASS |
| ST-K1235-D | CENTRAL VALLEY WYE | SR 152 (NORTH) TO ROAD 11 WYE ALTERNATIVE | GENERAL PLAN (SJD-FRE) | BERENDA WAY (ROAD 16) INTERCHANGE - 1 OF 2 |
| ST-K3235-D | CENTRAL VALLEY WYE | SR 152 (NORTH) TO ROAD 11 WYE ALTERNATIVE | TYPICAL SECTION (SJD-FRE) | BERENDA WAY (ROAD 16) INTERCHANGE - 2 OF 2 |
| ST-K1240-D | CENTRAL VALLEY WYE | SR 152 (NORTH) TO ROAD 11 WYE ALTERNATIVE | GENERAL PLAN (SJD-FRE) | ROAD 17 1/2 OVERHEAD |
| ST-K1250-D | CENTRAL VALLEY WYE | SR 152 (NORTH) TO ROAD 11 WYE ALTERNATIVE | GENERAL PLAN (SJD-FRE) | AERIAL #2 - SR 99 / UPRR - 1 OF 3 |
| ST-K1251-D | CENTRAL VALLEY WYE | SR 152 (NORTH) TO ROAD 11 WYE ALTERNATIVE | GENERAL PLAN (SJD-FRE) | AERIAL #2 - SR 99 / UPRR - 2 OF 3 |
| ST-K3250-D | CENTRAL VALLEY WYE | SR 152 (NORTH) TO ROAD 11 WYE ALTERNATIVE | TYPICAL SECTIONS (SJD-FRE) | AERIAL #2 - SR 99 / UPRR - 3 OF 3 |
| ST-K1260-D | CENTRAL VALLEY WYE | SR 152 (NORTH) TO ROAD 11 WYE ALTERNATIVE | GENERAL PLAN (SJD-FRE) | ROAD 20 OVERHEAD |
| ST-K1280-D | CENTRAL VALLEY WYE | SR 152 (NORTH) TO ROAD 11 WYE ALTERNATIVE | GENERAL PLAN (SJD-FRE) | ROAD 22 OVERHEAD |
| ST-K1300-D | CENTRAL VALLEY WYE | SR 152 (NORTH) TO ROAD 11 WYE ALTERNATIVE | GENERAL PLAN (SJD-FRE) | BERENDA CREEK BRIDGE |
| ST-K1310-D | CENTRAL VALLEY WYE | SR 152 (NORTH) TO ROAD 11 WYE ALTERNATIVE | GENERAL PLAN (SJD-FRE) | AVENUE 20 1/2 OVERHEAD |
| ST-K1330-D | CENTRAL VALLEY WYE | SR 152 (NORTH) TO ROAD 11 WYE ALTERNATIVE | GENERAL PLAN (SJD-FRE) | DRY CREEK BRIDGE |
| ST-K1410-D | CENTRAL VALLEY WYE | SR 152 (NORTH) TO ROAD 11 WYE ALTERNATIVE | GENERAL PLAN (MER-FRE) | AERIAL #3 - SOUTHBOUND OVER HST MAINLINE - 1 OF 6 |
| ST-K1411-D | CENTRAL VALLEY WYE | SR 152 (NORTH) TO ROAD 11 WYE ALTERNATIVE | GENERAL PLAN (MER-FRE) | AERIAL #3 - SOUTHBOUND OVER HST MAINLINE - 2 OF 6 |
| ST-K1412-D | CENTRAL VALLEY WYE | SR 152 (NORTH) TO ROAD 11 WYE ALTERNATIVE | GENERAL PLAN (MER-FRE) | AERIAL #3 - SOUTHBOUND OVER HST MAINLINE - 3 OF 6 |
| ST-K3410-D | CENTRAL VALLEY WYE | SR 152 (NORTH) TO ROAD 11 WYE ALTERNATIVE | TYPICAL SECTION (MER-FRE) | AERIAL #3 - SOUTHBOUND OVER HST MAINLINE - 4 OF 6 |
| ST-K3411-D | CENTRAL VALLEY WYE | SR 152 (NORTH) TO ROAD 11 WYE ALTERNATIVE | TYPICAL SECTION (MER-FRE) | AERIAL #3 - SOUTHBOUND OVER HST MAINLINE - 5 OF 6 |
| ST-K3412-D | CENTRAL VALLEY WYE | SR 152 (NORTH) TO ROAD 11 WYE ALTERNATIVE | TYPICAL SECTIONS (MER-FRE) | AERIAL #3 - SOUTHBOUND OVER HST MAINLINE - 6 OF 6 |
| ST-K1430-D | CENTRAL VALLEY WYE | SR 152 (NORTH) TO ROAD 11 WYE ALTERNATIVE | GENERAL PLAN (MER-FRE) | ROAD 12 UNDERPASS |
| ST-K1435-D | CENTRAL VALLEY WYE | SR 152 (NORTH) TO ROAD 11 WYE ALTERNATIVE | GENERAL PLAN (MER-FRE) | MADISON ROAD (AVENUE 23 1/2) UNDERPASS |
| ST-K1440-D | CENTRAL VALLEY WYE | SR 152 (NORTH) TO ROAD 11 WYE ALTERNATIVE | GENERAL PLAN (MER-FRE) | ASH SLOUGH BRIDGE - 1 OF 2 |
| ST-K3440-D | CENTRAL VALLEY WYE | SR 152 (NORTH) TO ROAD 11 WYE ALTERNATIVE | TYPICAL SECTION (MER-FRE) | ASH SLOUGH BRIDGE - 2 OF 2 |
| ST-K1450-D | CENTRAL VALLEY WYE | SR 152 (NORTH) TO ROAD 11 WYE ALTERNATIVE | GENERAL PLAN (MER-FRE) | WASHINGTON ROAD (AVENUE 25) UNDERPASS - 1 OF 2 |
| ST-K3450-D | CENTRAL VALLEY WYE | SR 152 (NORTH) TO ROAD 11 WYE ALTERNATIVE | TYPICAL SECTION (MER-FRE) | WASHINGTON ROAD (AVENUE 25) UNDERPASS - 2 OF 2 |
| ST-K1455-D | CENTRAL VALLEY WYE | SR 152 (NORTH) TO ROAD 11 WYE ALTERNATIVE | GENERAL PLAN (MER-FRE) | CHOWCHILLA RIVER BRIDGE |
| ST-K1460-D | CENTRAL VALLEY WYE | SR 152 (NORTH) TO ROAD 11 WYE ALTERNATIVE | GENERAL PLAN (MER-FRE) | AVENUE 26 UNDERPASS |
| ST-K1490-D | CENTRAL VALLEY WYE | SR 152 (NORTH) TO ROAD 11 WYE ALTERNATIVE | GENERAL PLAN (MER-FRE) | DUTCHMAN CREEK BRIDGE |
| ST-K1495-D | CENTRAL VALLEY WYE | SR 152 (NORTH) TO ROAD 11 WYE ALTERNATIVE | GENERAL PLAN (MER-FRE) | SANDY MUSH ROAD UNDERPASS |
| ST-K1510-D | CENTRAL VALLEY WYE | SR 152 (NORTH) TO ROAD 11 WYE ALTERNATIVE | GENERAL PLAN (MER-FRE) | DEADMAN CREEK BRIDGE No. 1 |
| ST-K1515-D | CENTRAL VALLEY WYE | SR 152 (NORTH) TO ROAD 11 WYE ALTERNATIVE | GENERAL PLAN (MER-FRE) | DEADMAN CREEK BRIDGE No. 2 |
| ST-K1610-D | CENTRAL VALLEY WYE | SR 152 (NORTH) TO ROAD 11 WYE ALTERNATIVE | GENERAL PLAN (SJD-MER) | AERIAL #4 - NORTHBOUND OVER HST MAINLINE - 1 OF 5 |
| ST-K1611-D | CENTRAL VALLEY WYE | SR 152 (NORTH) TO ROAD 11 WYE ALTERNATIVE | GENERAL PLAN (SJD-MER) | AERIAL #4 - NORTHBOUND OVER HST MAINLINE - 2 OF 5 |
| ST-K1612-D | CENTRAL VALLEY WYE | SR 152 (NORTH) TO ROAD 11 WYE ALTERNATIVE | GENERAL PLAN (SJD-MER) | AERIAL #4 - NORTHBOUND OVER HST MAINLINE - 3 OF 5 |
| ST-K3610-D | CENTRAL VALLEY WYE | SR 152 (NORTH) TO ROAD 11 WYE ALTERNATIVE | TYPICAL SECTIONS (SJD-MER) | AERIAL #4 - NORTHBOUND OVER HST MAINLINE - 4 OF 5 |
| ST-K3611-D | CENTRAL VALLEY WYE | SR 152 (NORTH) TO ROAD 11 WYE ALTERNATIVE | TYPICAL SECTIONS (SJD-MER) | AERIAL #4 - NORTHBOUND OVER HST MAINLINE - 5 OF 5 |
| ST-K1620-D | CENTRAL VALLEY WYE | SR 152 (NORTH) TO ROAD 11 WYE ALTERNATIVE | GENERAL PLAN (SJD-FRE) | HEMLOCK ROAD (ROAD 9) UNDERPASS |
| ST-K1630-D | CENTRAL VALLEY WYE | SR 152 (NORTH) TO ROAD 11 WYE ALTERNATIVE | GENERAL PLAN (SJD-MER) | MADISON ROAD (AVENUE 23 1/2) OVERHEAD |
| | | | | |

M. BRATT DRAWN BY
A. M. CHECKED BY
K. CHARAN IN CHARGE
C. LEMLEY DATE 08/12/2016 BY CHK APP DESCRIPTION

RECORD SET 15% DESIGN SUBMITTAL NOT FOR

CONSTRUCTION





CALIFORNIA HIGH-SPEED TRAIN PROJECT MERCED TO FRESNO SECTION

CENTRAL VALLEY WYE STRUCTURE, VIADUCT AND TUNNEL PLANS INDEX OF DRAWINGS SHEET 7 OF 8

| HSRO8-05 |
|-------------------------|
| DRAWING NO. ST-B0008 |
| SCALE NO SCALE |

NO SCALE SHEET NO.

| | | | INDEX OF DRAWINGS | |
|-------------|--------------------|---|----------------------------|---|
| DRAWING NO. | SECTION | ALIGNMENT / PLAN SET | TITLE | DESCRIPTION |
| ST-K1641-D | CENTRAL VALLEY WYE | SR 152 (NORTH) TO ROAD 11 WYE ALTERNATIVE | GENERAL PLAN (SJD-MER) | AERIAL #5 - NORTHBOUND OVER HST MERCED TO FRESNO - 2 OF 6 |
| ST-K1642-D | CENTRAL VALLEY WYE | SR 152 (NORTH) TO ROAD 11 WYE ALTERNATIVE | GENERAL PLAN (SJD-MER) | AERIAL #5 - NORTHBOUND OVER HST MERCED TO FRESNO - 3 OF 6 |
| ST-K1643-D | CENTRAL VALLEY WYE | SR 152 (NORTH) TO ROAD 11 WYE ALTERNATIVE | GENERAL PLAN (SJD-MER) | AERIAL #5 - NORTHBOUND OVER HST MERCED TO FRESNO - 4 OF 6 |
| ST-K3640-D | CENTRAL VALLEY WYE | SR 152 (NORTH) TO ROAD 11 WYE ALTERNATIVE | TYPICAL SECTIONS (SJD-MER) | AERIAL #5 - NORTHBOUND OVER HST MERCED TO FRESNO - 5 OF 6 |
| ST-K3641-D | CENTRAL VALLEY WYE | SR 152 (NORTH) TO ROAD 11 WYE ALTERNATIVE | TYPICAL SECTIONS (SJD-MER) | AERIAL #5 - NORTHBOUND OVER HST MERCED TO FRESNO - 6 OF 6 |
| ST-K1650-D | CENTRAL VALLEY WYE | SR 152 (NORTH) TO ROAD 11 WYE ALTERNATIVE | GENERAL PLAN (SJD-MER) | ROAD 11 UNDERPASS |
| ST-K1653-D | CENTRAL VALLEY WYE | SR 152 (NORTH) TO ROAD 11 WYE ALTERNATIVE | GENERAL PLAN (SJD-MER) | WASHINGTON ROAD (AVENUE 25) UNDERPASS |
| ST-K1656-D | CENTRAL VALLEY WYE | SR 152 (NORTH) TO ROAD 11 WYE ALTERNATIVE | GENERAL PLAN (SJD-MER) | CHOWCHILLA RIVER BRIDGE |

MF-ST-BOOO9

16-AUG-201610:

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| 0 | | | | | | | DESIGNED BY M. BRATT | |
| | | | | | | | DRAWN BY A. M. | |
| _ | | | | | | | CHECKED BY K. CHARAN | |
| 1 236 | | | | | | | IN CHARGE C. LEMLEY | |
| دالالا | REV | DATE | BY | СНК | APP | DESCRIPTION | DATE 08 /12 /2016 | |

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CONSTRUCTION





CALIFORNIA HIGH-SPEED TRAIN PROJECT MERCED TO FRESNO SECTION

CENTRAL VALLEY WYE
STRUCTURE, VIADUCT AND TUNNEL PLANS
INDEX OF DRAWINGS
SHEET 8 OF 8

| HSR08-05 |
|-------------------------|
| DRAWING NO. ST-B0009 |
| NO SCALE |
| SHEET NO. |

| | (A) | | | | (D CONTINUED) | | (F CONTINUED) | | (J CONTINUED) |
|----------------|--------------------------------------|----------|--|------------|----------------------------------|-------------|---|------------|-------------------------------------|
| | | | | 25.7 | | 5.1.75 | | | |
| AB | AGGREGATE BASE | CAA | CABLE ANCHOR ASSEMBLY | DET | DETAIL, DETOUR | FNTB | FACING NORTHBOUND TRAFFIC | JS | JUNCTION STRUCTURE |
| ABBC | ASBESTOS BONDED BITUMINOUS COATED | CAP | CORRUGATED ALUMINUM PIPE | DF | DOUGLAS FIR, DIRECT FIXATION | FOB | FREE ON BOARD | JT | JOINT |
| ABM | AIR-BLOWN MORTAR | CAPA | CORRUGATED ALUMINUM PIPE ARCH | DI | DRAINAGE INLET, DROP INLET | FOC | FACE OF CONCRETE | | |
| ABN | ABANDON | CAS | CONSTRUCTION AREA SIGN | DIA | DIAMETER | FR RD | FRONTAGE ROAD | | L |
| ABUT | ABUTMENT | CB | CONCRETE BARRIER | DIAPH | DIAPHRAGM | FRE | FRESNO | L | LENGTH |
| AC | ASPHALT CONCRETE | CBW | CONCRETE BLOCK WALL | DIST | DISTANCE, DISTRICT | FS | FAR SIDE, FINISHED SURFACE | LAT | LATITUDE |
| ACB | ASPHALT CONCRETE BASE | C-C | CENTER TO CENTER | DMBB | DOUBLE METAL BEAM BARRIER | FSBT | FACING SOUTHBOUND TRAFFIC | LCB | LEAN CONCRETE BASE LAST LONG TIE |
| ACP | ASBESTOS CEMENT PIPE ADDED DEAD LOAD | CHSRA | CALIFORNIA HIGH-SPEED RAIL | DR DTBB | DRIVE DOUBLE THRIE BEAM BARRIER | FTG FWBT | FOOTING FACING WESTBOUND TRAFFIC | LLT | LAST LONG TIE LANE |
| ADL ADJ | ADJUST | CHSR | AUTHORITY (SEE AUTHORITY) CALIFORNIA HIGH-SPEED RAIL | DWY | DRIVEWAY | FWY | FREEWAY | LN LOC | LOCATION |
| AFES | ALTERNATIVE FLARED END SECTION | CHST | CALIFORNIA HIGH-SPEED TRAIN | DWI | DRIVEWAT | L AA I | | LOL | LAYOUT LINE |
| AHD | AHEAD | CG | CENTER OF GRAVITY | | (E) | | G | LONG | LONGITUDE |
| ALT | ALTERNATE | CHNL | CHANNEL | F | EAST | G | GRADE, ACCELERATION DUE TO | LONGIT | LONGITUDINAL |
| AM | TIME FROM MIDNIGHT TO NOON | CI | CAST IRON | EA | ACTUAL SUPERELEVATION | O | GRAVITY | LS | LUMP SUM, LENGTH OF SPIRAL |
| AP | ALTERNATIVE PIPE | CIDH | CAST-IN-DRILLED-HOLE | EASE | EASEMENT | GA | GAGE | LT | LEFT |
| APC | ALTERNATIVE PIPE CULVERT | CIP | CAST-IN-PLACE, CAST IRON PIPE | EB | END OF BRIDGE, EASTBOUND | GALV | GALVANIZED | LVC | LENGTH OF VERTICAL CURVE |
| APPROX | APPROXIMATE | CIPCP | CAST-IN-PLACE CONCRETE PIPE | EC | END HORIZONTAL CURVE | GP | GRADING PLANE | 2.0 | |
| APU | ALTERNATIVE PIPE UNDERDRAIN | CISS | CAST-IN-STEEL SHELL | ECR | END CURB RETURN | GR | GUARD RAILING | | (M $)$ |
| AR | ACCESS RESTRICTION | CJP | COMPLETE JOINT PENETRATION | ED | EDGE DRAIN | GRDR | GIRDER | MAINT | MAINTENANCE |
| ARS | ACCELERATION RESPONSE SPECTRUM | CL | CHAIN LINK, CLASS | EDC | EDGE DRAIN CLEANOUT | GSP | GALVANIZED STEEL PIPE | MAX | MAXIMUM |
| AS | AGGREGATE SUBBASE | CL-6 | CHAIN LINK FENCE (6 FT) | EDO | EDGE DRAIN OUTLET | GTR | GUTTER | MB | METAL BEAM |
| ASRP | ALUMINUM SPIRAL RIB PIPE | CLR | CLEAR, CLEARANCE | EDV | EDGE DRAIN VENT | | | MBB | METAL BEAM BARRIER |
| ASSY | ASSEMBLY | СМ | CORRUGATED METAL | ELEC | ELECTROLIER | | (H) | MBGR | METAL BEAM GUARD RAILING |
| ATC | AUTOMATIC TRAIN CONTROL | CMP | CORRUGATED METAL PIPE | ELECT | ELECTRIC | Н | HEIGHT | MED | MEDIAN |
| ATPB | ASPHALT TREATED PERMEABLE BASE | СО | COUNTY | ELEV | ELEVATION | H, HR | HOUR | MER | MERCED |
| ATPM | ASPHALT TREATED PERMEABLE MATERIAL | COL | COLUMN | EMB | EMBANKMENT | HD | HORIZONTAL DRAIN | MF | MERCED TO FRESNO |
| AUTHORITY | CALIFORNIA HIGH-SPEED RAIL AUTHORITY | CONC | CONCRETE | ENGR | ENGINEER | HDWL | HEADWALL | МН | MANHOLE |
| AVE | AVENUE | COND | CONDUIT | EOD | EDGE OF DECK | HEX HD | HEXAGONAL HEAD | MIN | MINIMUM |
| AVG | AVERAGE | CONN | CONNECTOR | EP | EDGE OF PAVEMENT | НМА | HOT MIXED ASPHALT | MISC | MISCELLANEOUS |
| @ | AT | CONST | CONSTRUCT, CONSTRUCTION | EQ | EQUATION | HORIZ | HORIZONTAL | MISC I & S | S MISCELLANEOUS IRON AND STEEL |
| | В | CONT | CONTINUOUS | ES | EDGE OF SHOULDER | HP | HINGE POINT, HORSEPOWER | MKR | MARKER |
| | | COORD | COORDINATE | ET | END TUNNEL | HPS | HIGH PERFORMANCE STEEL | MOD | MODIFIED, MODIFY |
| BAGR | BRIDGE APPROACH GUARD RAILING | CP | CANDLEPOWER | ETW | EDGE OF TRAVELED WAY | HS | HIGH STRENGTH | MON | MONUMENT |
| ВВ | BEGINNING OF BRIDGE | CP1 | CONSTRUCTION PACKAGE 1 | EU | UNBALANCED SUPERELEVATION | HSR | HIGH-SPEED RAIL | MOW | MAINTENANCE-OF-WAY FACILITY |
| В-В | BACK-TO-BACK | CR | CREEK | EVC | END VERTICAL CURVE | HST | HIGH-SPEED TRAIN | MP | METAL PLATE |
| BC | BEGIN HORIZONTAL CURVE | CRCP | CONTINUOUS REINFORCED CONCRETE PAVEMENT | EW | ENDWALL | HW | HEADWALL, | MPGR | METAL PLATE GUARD RAILING |
| BCR | BEGIN CURB RETURN | CRSP | CONCRETED ROCK SLOPE PROTECTION | EXC | EXCAVATION | | 100-YR HIGH WATER (UNLESS NOTED | MPH | MILES PER HOUR |
| BEG | BEGIN | CRZ | CLEAR RECOVERY ZONE | EXIST, (E) | EXISTING | | OTHERWISE) | MR | MOVEMENT RATING |
| BIT CTD | BITUMINOUS COATED | CS | CURVE SPIRAL POINT | EXP | EXPANSION, EXPRESSWAY | HWM | HIGH WATER MARK | MSE | MECHANICALLY STABILIZED EARTH |
| BK | BACK | CSP | CORRUGATED STEEL PIPE | EXP JT | EXPANSION JOINT | HWY | HIGHWAY | MTL | MATERIAL |
| BKF | BACKFILL | CSPA | CORRUGATED STEEL PIPE ARCH | EXT | EXTERIOR | | | | N |
| BLDG | BUILDING | CTB | CEMENT TREATED BASE | | (F) | 10 | I I I I I I I I I I I I I I I I I I I | N | |
| BLM | BRIDGE-LOG MILE | СТРВ | CEMENT TREATED PERMEABLE BASE | F 2 2 | | IB | IMPORTED BORROW | N | NORTH |
| BLVD | BOULEVARD | СТРМ | CEMENT TREATED PERMEABLE MATERIAL | F & C | FRAME AND COVER | ID | INSIDE DIAMETER | NB | NORTHBOUND |
| BM BOT | BENCH MARK | CTRS | CENTERS | F & G | FRAME AND GRATE | IF | INSIDE FACE | NC | NORMAL CROWN |
| BOT | BOTTOM | CULV | CULVERT | FB | FLOOR BEAM | INT | INTERIOR | NIC | NOT IN CONTRACT |
| BNSF | BNSF RAILWAY | <u>C</u> | CENTERLINE | FDN | FOUNDATION | INV | INVERT | NO. | NUMBER (MUST HAVE PERIOD) |
| BR BRG | BRIDGE | | | FEBT | FACING EASTBOUND TRAFFIC | IRR | IRRIGATION | NOS. | NUMBERS (MUST HAVE PERIOD) |
| BRG BT | BEARING BEGIN TUNNEL | D | DEPTH | FES FF | FLARED END SECTION FILTER FABRIC | IS | INTERLOCKING SITE | NPS NS | NOMINAL PIPE SIZE NEAR SIDE |
| Θ BTU | BRITISH THERMAL UNIT | DD | DOWNDRAIN | F G | FINISHED GRADE | | J | NTS | NOT TO SCALE |
| BVC | BEGIN VERTICAL CURVE | DBL | DOUBLE | FH | FIRE HYDRANT | JCT | JUNCTION | INIJ | |
| BM BAC | BARBED WIRE | DEG | DEGREE | FIG | FIGURE | JP | JOINT POLE | | |
| 10-2 | SANDED WINE | DEL | DELINEATOR | FL | FLOW LINE | JPCP | JOINT FOLE JOINTED PLAIN CONCRETE PAVEMENT | OBI R | OBLITERATE |
| DP - 2 | | ULL | DESIGNED BY | , L | Ton Live | 01 01 | | | CONTRACT NO |
| 1 | + + - | | C. LEMLEY RECORD SET | | | | CALIFORNIA HIGH-SPI | | IN PROJECT HSR08-05 |
| | + + + | | DRAWN BY J. KIDWELL SUBMITTAL | | | | MERCED TO FRI | | DRAWING NO. ST-B0010 |
| | + + + | | HA. M. HAI | RSONS | | | CENTRAL VA STRUCTURE, VIADUCT | | |
| 133 | + + + | | IN CHARGE C. LEMLEY CONSTRUCTION | | CALIFOR | | ABBREVI | | NO SCALE |
| CO REV DATE BY | Y CHK APP DESCRIPTION | | DATE 08/12/2016 | | HIGH-SPEED RAIL AU | THORITY | SHEET 1 | | SHEET NO. |
| <u> </u> | | | 00/12/2010 | | | | | | |

| 1330 | | | J. KIDWELL SURMITTAL | PARSO | CALIFORN | VA | CENTRAL VALLEY WYE STRUCTURE, VIADUCT AND TUNNEL PLANS ABBREVIATIONS |
|----------|---|-------------|--|-------------|---------------------------------------|-------|--|
| Q Q | | | DESIGNED BY C. LEMLEY DRAWN BY 15% DESIGN | | | | CALIFORNIA HIGH-SPEED TRAIN PROJECTION |
| 76-2011 | POINT OF VERTICAL CURVE | | | | | | |
| PVC | POLYVINYL CHLORIDE, | SJD | SAN JOSE DIRIDON STATION | | | | |
| <u> </u> | POINT OF TANGENCY | SIM | SIMILAR | TRK | TRACK | | |
| PSP | PARALLELING STATION PERFORATED STEEL PIPE | SHLD SHT | SHEET | TRANS | TRANSITION | | |
| PS, P/S | POINT OF SWITCH, PRESTRESSED, | SG | SUBGRADE SHOULDER | TPSS T/R | TRACTION POWER SUBSTATION TOP OF RAIL | | |
| PS&E | PLANS, SPECIFICATIONS AND ESTIMATES | SEP | SEPARATION | TPM | TREATED PERMEABLE MATERIAL | | |
| PRVC | POINT OF REVERSE VERTICAL CURVE | SEC | SECOND, SECTION | TPF | TRACTION POWER FACILITY | | |
| PRF | PAVEMENT REINFORCING FABRIC | SD | STORM DRAIN | TPB | TREATED PERMEABLE BASE | | |
| 5 PRC | POINT OF REVERSE CURVE | SCSP | SLOTTED CORRUGATED STEEL PIPE | TP | TELEPHONE POLE | | |
| PPP | PERFORATED PLASTIC PIPE | SC | SAND CUSHION, SPIRAL CURVE POINT | TOT | TOTAL | | |
| PPL | PREFORMED PERMEABLE LINER | SB | SOUTHBOUND | ТО | TURNOUT | YRS | YEARS |
| | POWER POLE | SAPP | STRUCTURAL ALUMINUM PLATE PIPE | ТМ | TECHNICAL MEMORANDUM | YR | YEAR |
| PP | PIPE PILE, PLASTIC PIPE, | SALV | SALVAGE | TG | TOP OF GRADE | | |
| POVC | POINT OF VERTICAL CURVE | SAE | STRUCTURE APPROACH EMBANKMENT | TEMP | TEMPORARY | | Y |
| POT | POINT OF TANGENT | S | SOUTH, SUPPLEMENT | TEL | TELEPHONE | XO | CROSSOVER |
| POE | POINT OF END | | (<u> </u> | TCE | TEMPORARY CONSTRUCTION EASEMENT | XING | CROSSING |
| POC | POINT OF HORIZONTAL CURVE | | C | TCB | TRAFFIC CONTROL BOX | X SEC | CROSS SECTION |
| РОВ | POINT OF BEGINNING | RWY | RAILWAY | TC | TOP OF CURB, TRAIN CONTROL | | (X) |
| PN | PAVING NOTCH | R/W | RIGHT-OF-WAY | TBR | TIMBER | | |
| | TIME FROM NOON TO MIDNIGHT | • • • | RETAINING WALL | TBD | TO BE DETERMINED | WWLOL | WINGWALL LAYOUT LINE |
| PM | POST MILE, | RW | REDWOOD, | ТВВ | THRIE BEAM BARRIER | ww | WINGWALL |
| P/L | PROPERTY LINE | RTE | ROUTE | TAN | TANGENT | WV | WATER VALVE |
| P, PL | PLATE | RT | RIGHT | TAB | TABLET | WT | WEIGHT |
| PJP | PARTIAL JOINT PENETRATION | RSP | ROCK SLOPE PROTECTION | Т | SEMI-TANGENT | WSP | WELDED STEEL PIPE |
| PITO | POINT OF INTERSECTION TURNOUT | RR | RAILROAD | | (T) | WS | WATER SURFACE |
| PI | POINT OF INTERSECTION | | REFERENCE POINT | 5 15 | | WM | WIRE MESH |
| PG&E | PACIFIC GAS AND ELECTRIC | RP | RADIUS POINT, | S4S | SURFACE 4 SIDES | WH | WEEP HOLE |
| PG | PROFILE GRADE | RM | ROAD-MIXED | SYM | SYMMETRICAL | WCB | WORLD COORDINATE BEARING |
| PERM MTL | PERMEABLE MATERIAL | RDWY | ROADWAY | SWS | SWITCHING STATION | WB | WESTBOUND |
| PED UC | PEDESTRIAN UNDERCROSSING | REV | REVISED | SWR | SEWER | W | WEST, WIDTH |
| PED OC | PEDESTRIAN OVERCROSSING | RET | RETAINING | SW | SIDEWALK, SOUND WALL | | (|
| PED | PEDESTRIAN | REPL | REPLACEMENT | SURF | SURFACING | | |
| PCVC | POINT OF COMPOUND VERTICAL CURVE | REL | RELOCATE | STR | STRUCTURE | VOL | VOLUME |
| | PRESTRESSED CONCRETE PIPE | | REINFORCING | STD | STANDARD | VIA | VIADUCT |
| PCP | PERFORATED CONCRETE PIPE, | REINF | REINFORCED, REINFORCEMENT, | STBB | SINGLE THRIE BEAM BARRIER | VERT | VERTICAL |
| | PORTLAND CEMENT CONCRETE | RD | ROAD | STA | STATION | VCP | VITRIFIED CLAY PIPE |
| PCC | POINT OF COMPOUND CURVE, | RCPA | REINFORCED CONCRETE PIPE ARCH | ST | STREET, SPIRAL TANGENT POINT | VC | VERTICAL CURVE |
| PC | POINT OF CURVATURE, PRECAST | RCP | REINFORCED CONCRETE PIPE | SSRP | STEEL SPIRAL RIB PIPE | VAR | VARIABLE |
| РВ | PULL BOX, PHASE BREAK | RCB | REINFORCED CONCRETE BOX | SSPPA | STRUCTURAL STEEL PLATE PIPE ARCH | V | DESIGN SPEED, VALVE |
| PAP | PERFORATED ALUMINUM PIPE | RCA | REINFORCED CONCRETE ARCH | SSPP | STRUCTURAL STEEL PLATE PIPE | | (V |
| Р | PAGE | R/C | RATE OF CHANGE | SSPA | STRUCTURAL STEEL PLATE ARCH | | V |
| | (P) | R & S | REMOVE AND SALVAGE | SSD | STRUCTURAL SECTION DRAIN | UXO | UNIVERSAL CROSSOVER |
| | | R & D | REMOVE AND DISPOSE | SSBM | STRAP AND SADDLE BRACKET METHOD | UPRR | UNION PACIFIC RAILROAD |
| OPP | OPPOSITE | R | RADIUS | SS | SLOPE STAKE, SUBSTATION | UP | UNDERPASS |
| 0-0 | OUT TO OUT | | R | SRS | STANDALONE RADIO SITE | UON | UNLESS OTHERWISE NOTED |
| ОН | OVERHEAD | | | SR | STATE ROUTE | UD | UNDERDRAIN |
| OGAC | OPEN GRADED ASPHALT CONCRETE | QTY | QUANTITY | SPP | SLOTTED PLASTIC PIPE | UC | UNDERCROSSING |
| OG | ORIGINAL GROUND | | (Q | SPEC | SPECIAL, SPECIFICATIONS | | |
| OF | OUTSIDE FACE | | | SM | SELECTED MATERIAL | | |
| OD | OUTSIDE DIAMETER | PVT | POINT OF VERTICAL TANGENT | S | STATION LINE | TYP | TYPICAL |
| ocs | OVERHEAD CONTACT SYSTEM | PVMT | PAVEMENT | SJV | SAN JOAQUIN VALLEY | 13 | TUBULAR STEEL, TANGENT SPIRAL POINT |
| ос | OVERCROSSING | PVI | POINT OF VERTICAL INTERSECTION | SJM | SAN JOSE TO MERCED | TS | TRANSVERSE, TRAFFIC SIGNAL, |
| I | (O CONTINUED) | | (P CONTINUED) | | (S CONTINUED) | | (T CONTINUED) |

CONSTRUCTION

IN CHARGE
C. LEMLEY

DATE 08/12/2016

DESCRIPTION


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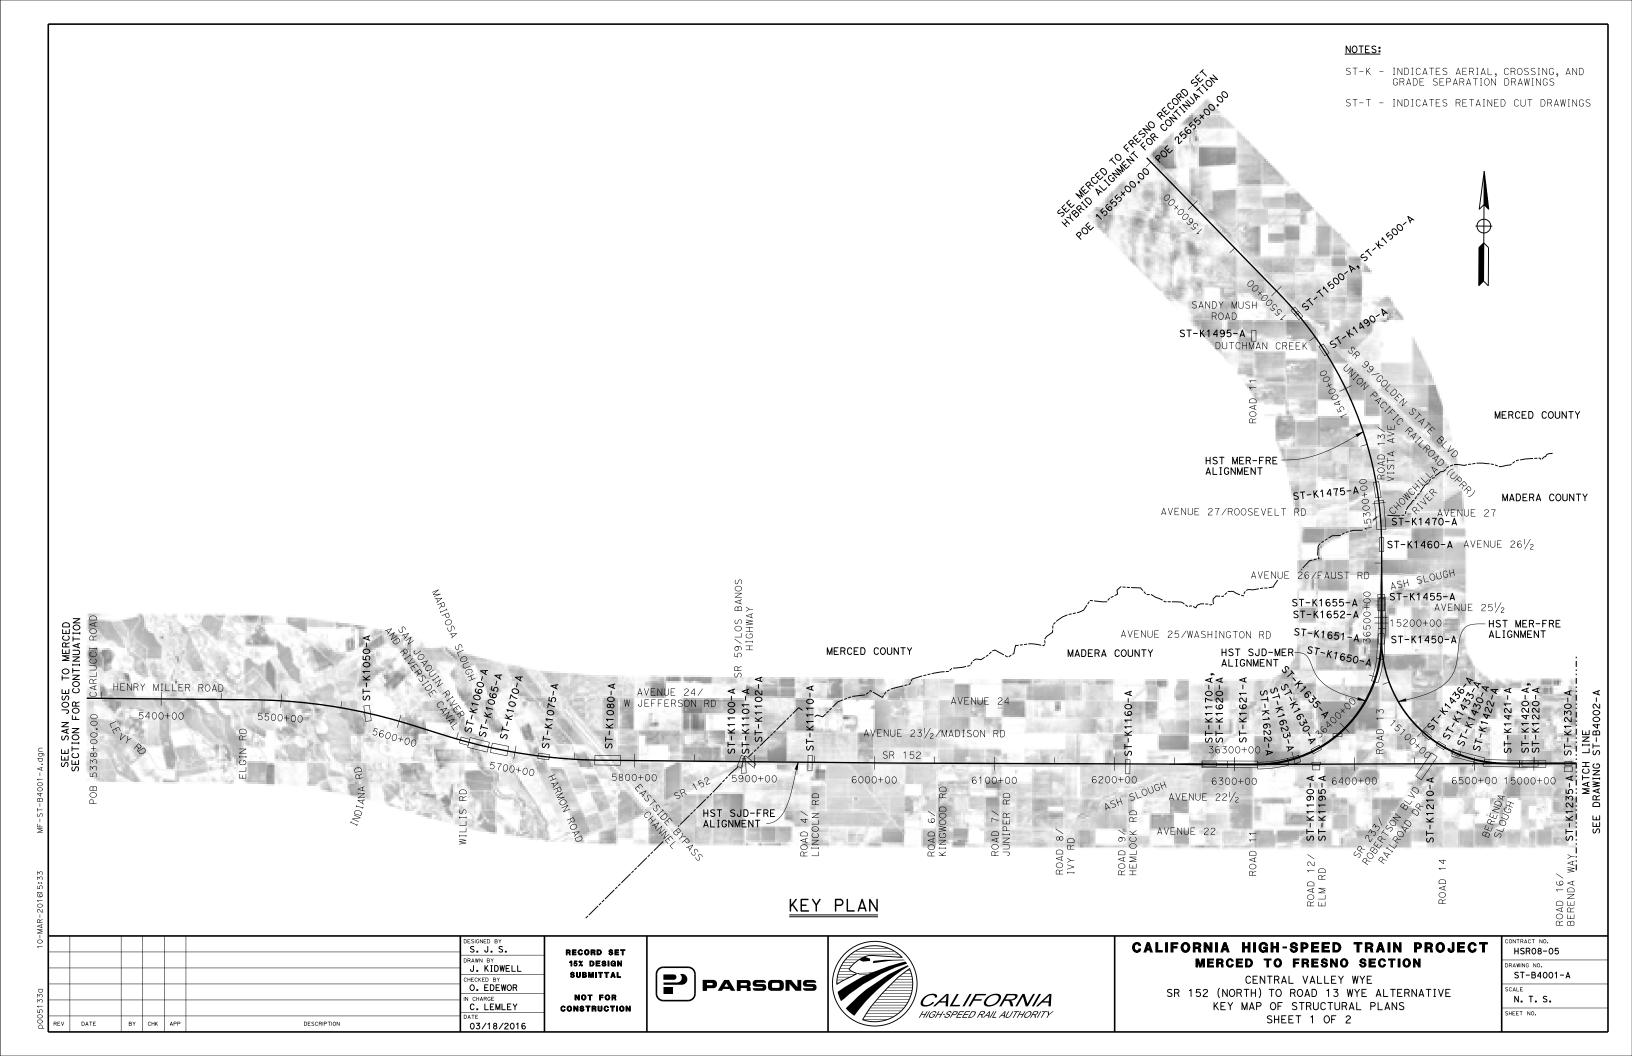
BY CHK APP

CENTRAL VALLEY WYE
STRUCTURE, VIADUCT AND TUNNEL PLANS
ABBREVIATIONS SHEET 2 OF 2

CONTRACT NO. HSRO8-05 DRAWING NO. ST-B0011 SCALE NO SCALE

SHEET NO.



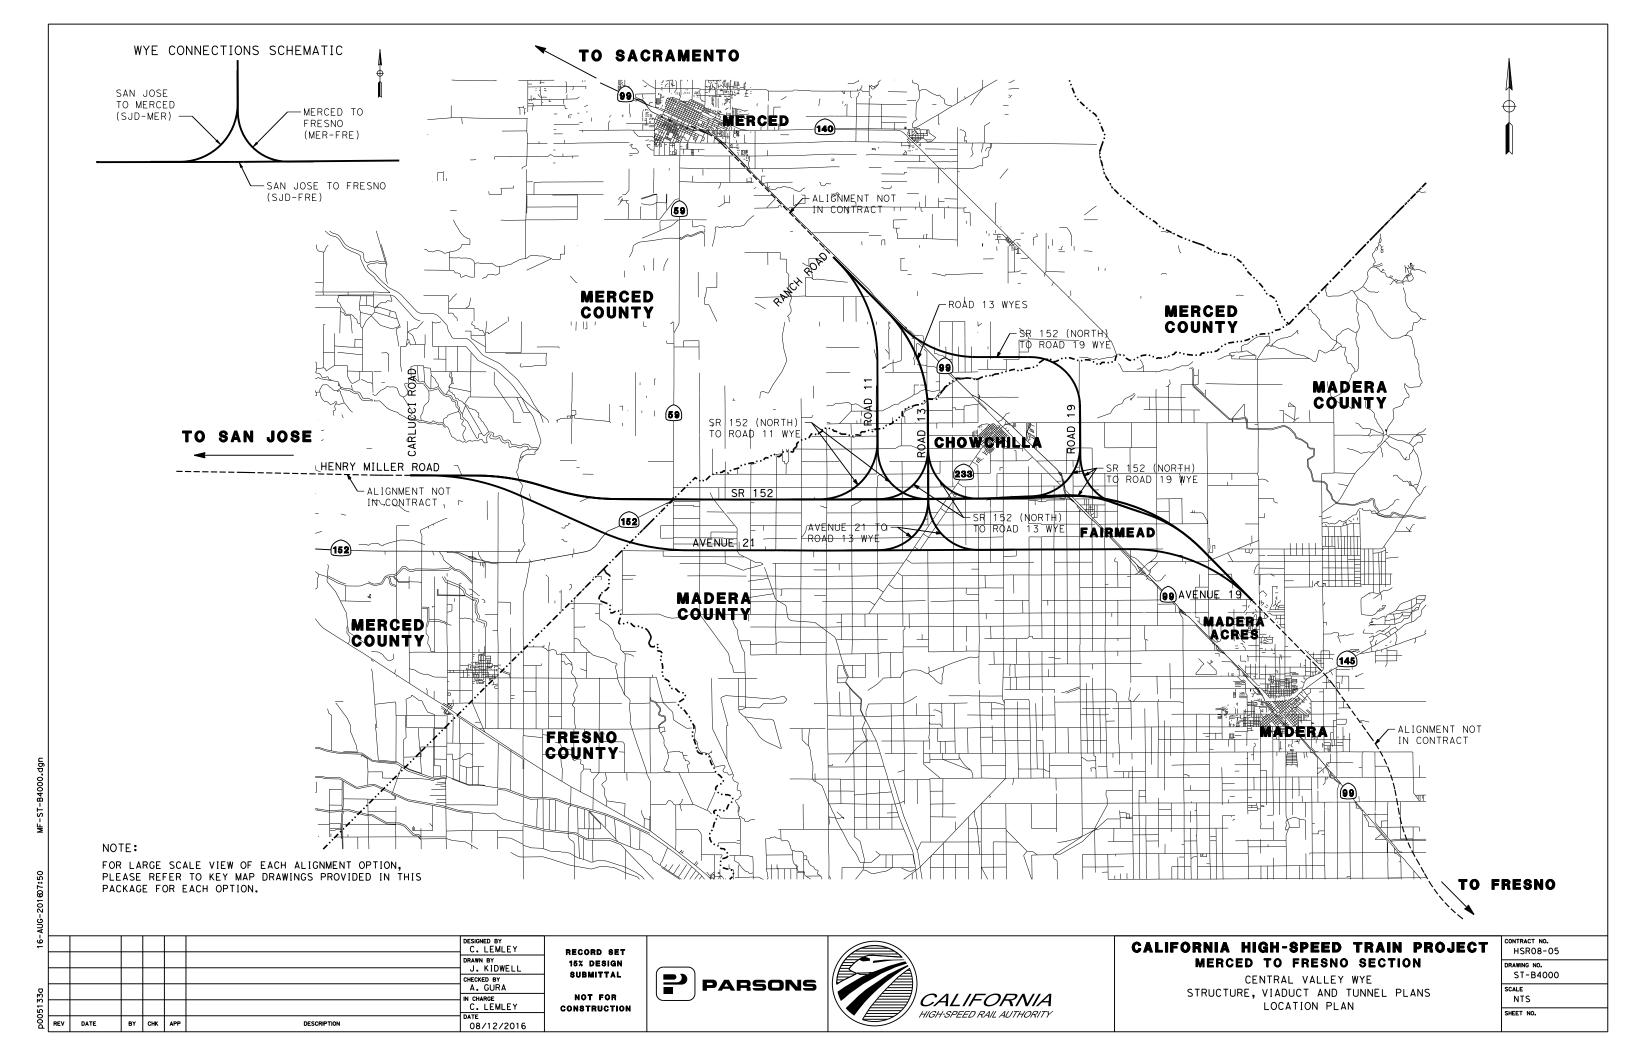

NOTES:

ST-K - INDICATES AERIAL, CROSSING, AND GRADE SEPARATION DRAWINGS





| | | | | | | DESIGNED BY |
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| | | | | | | DRAWN BY J. KIDWELL |
| | | | | | | CHECKED BY |
| | | | | | | A. GURA IN CHARGE |
| | | | | | | C. LEMLEY |
| REV | DATE | BY | CHK | APP | DESCRIPTION | 03/18/2016 |

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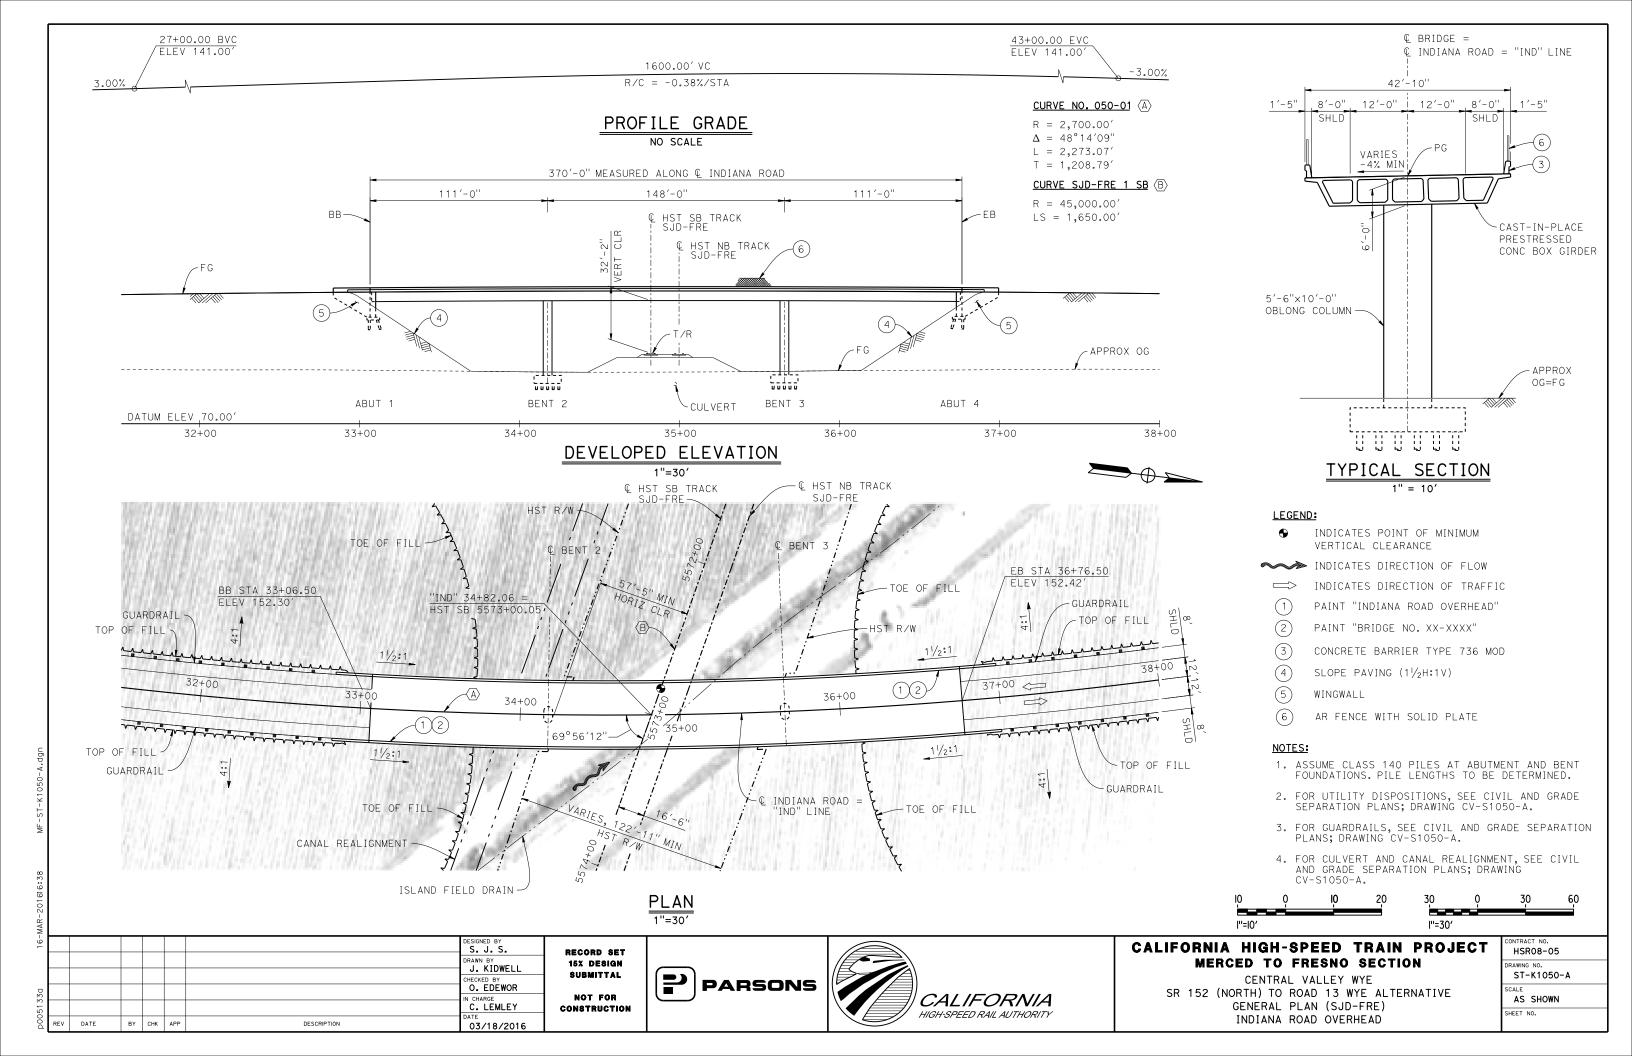



CALIFORNIA HIGH-SPEED TRAIN PROJECT MERCED TO FRESNO SECTION

CENTRAL VALLEY WYE SR 152 (NORTH) TO ROAD 13 WYE ALTERNATIVE KEY MAP OF STRUCTURAL PLANS SHEET 2 OF 2

| , | CONTRACT NO. HSR08-05 |
|---|---------------------------|
| | DRAWING NO. ST-B4002-A |
| | SCALE N. T. S. |

SHEET NO.



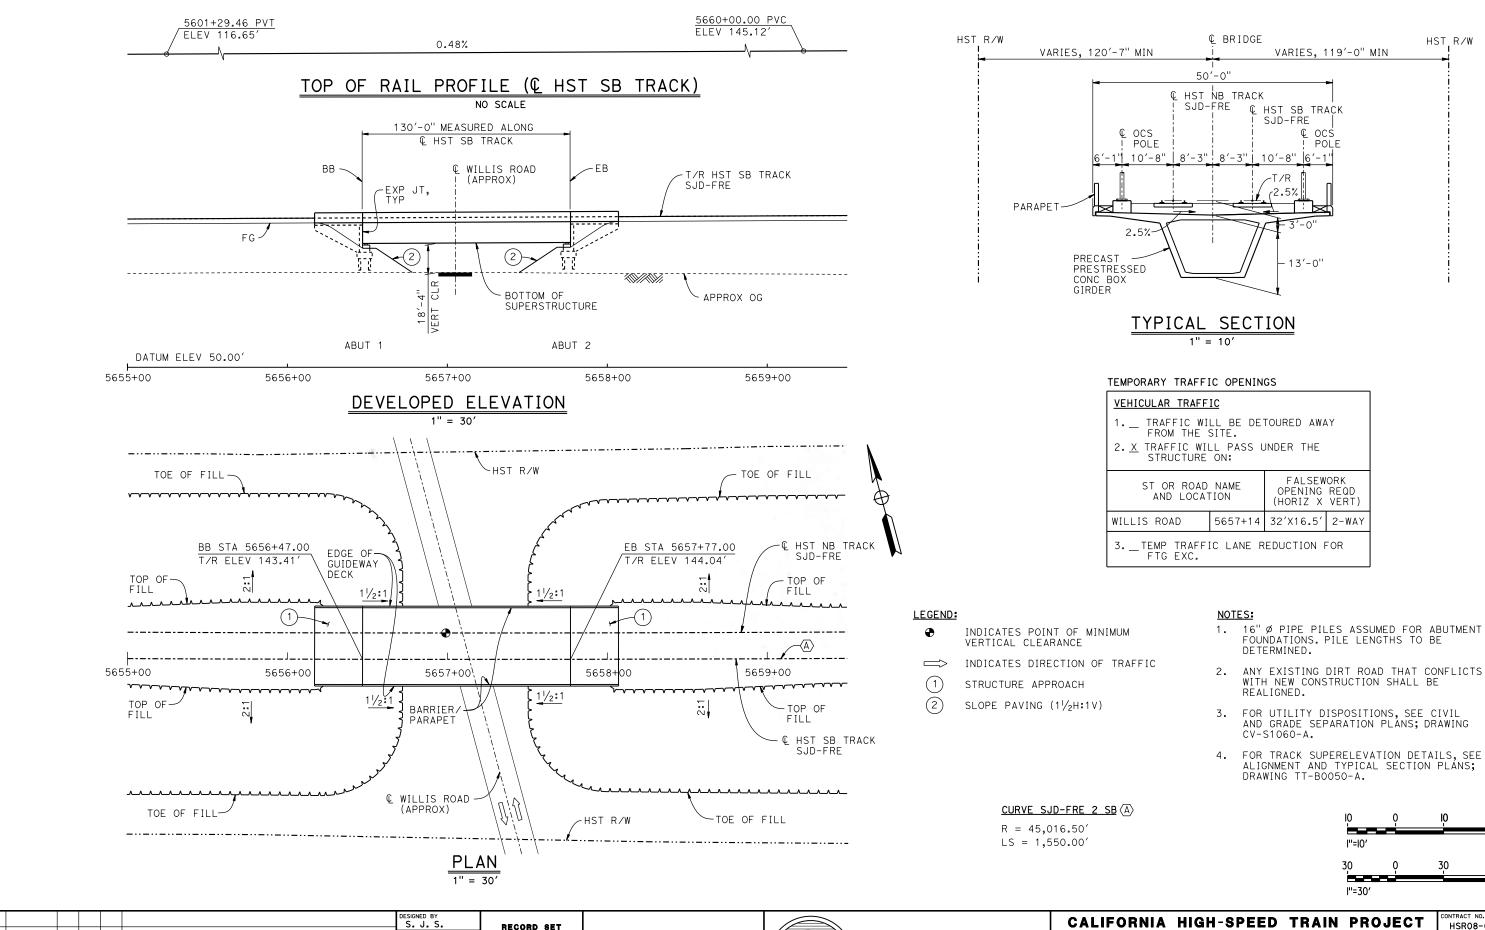

PARSONS

CALIFORNIA

HIGH-SPEED RAIL AUTHORITY

DRAWN BY

DATE

BY CHK APP

DESCRIPTION

O. EDEWOR

IN CHARGE

C. LEMLEY

02/13/2015

15% DESIGN

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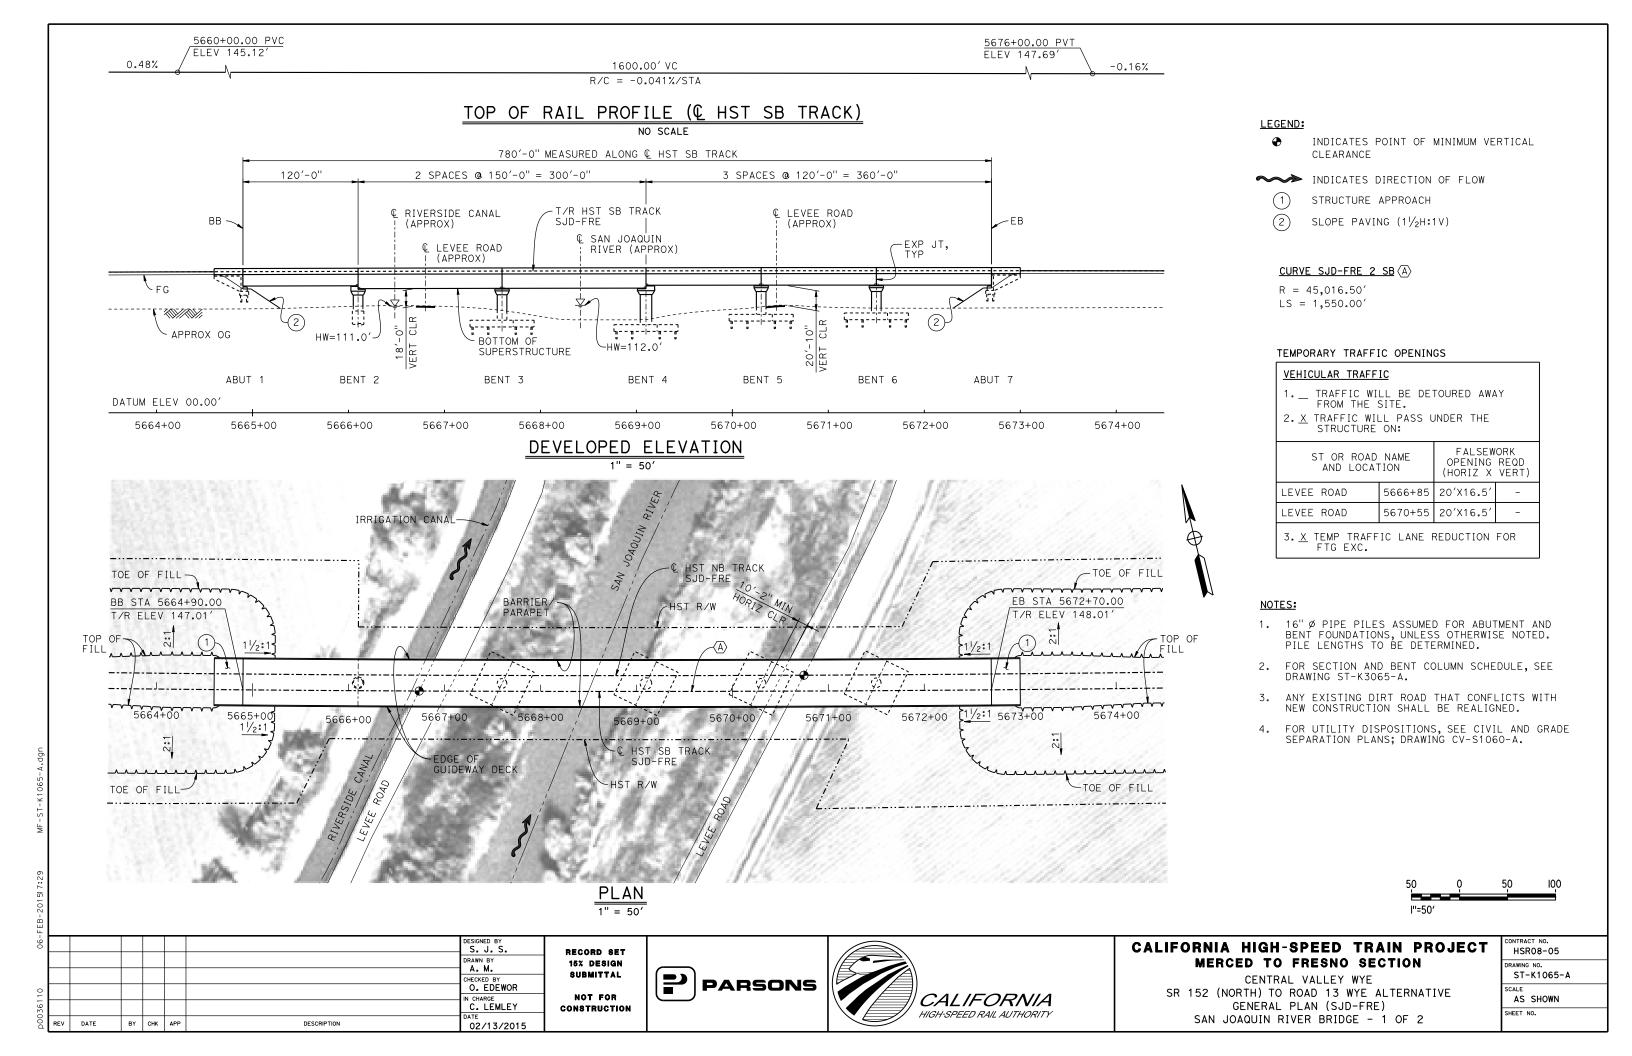
CALIFORNIA HIGH-SPEED TRAIN PROJECT MERCED TO FRESNO SECTION

CENTRAL VALLEY WYE SR 152 (NORTH) TO ROAD 13 WYE ALTERNATIVE GENERAL PLAN (SJD-FRE) WILLIS ROAD UNDERPASS

HSR08-05 RAWING NO. ST-K1060-A AS SHOWN SHEET NO.

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HST_R/W



€ BRIDGE

| | BENT COLUMN SCHED | ULE |
|-------|-------------------|----------|
| BENT | COLUMN TYPE | CIDH |
| 2 | 10'-0'' Ø | 12'-0" Ø |
| 3 | 10'-0'' Ø | |
| 4 | 12'-0" Ø | |
| 5 - 6 | 10'-0" Ø | |

NOTES:

- 1. PILE AND DRILLED SHAFT LENGTHS TO BE DETERMINED.
- 2. FOR TRACK SUPERELEVATION DETAILS, SEE ALIGNMENT AND TYPICAL SECTION PLANS; DRAWING TT-BOO50-A.



| | | | | | | | DESIGNED BY S. J. S. | |
|----------|------|----|----|-----|-----|-------------|-------------------------|----|
| | | | | | | | DRAWN BY A. M. | 1 |
| L | | | | | | | CHECKED BY O. EDEWOR | İ |
| \vdash | + | | | | | | IN CHARGE C. LEMLEY | ١, |
| RE | V DA | TE | BY | СНК | APP | DESCRIPTION | DATE 02/13/2015 | ` |

HST R/W

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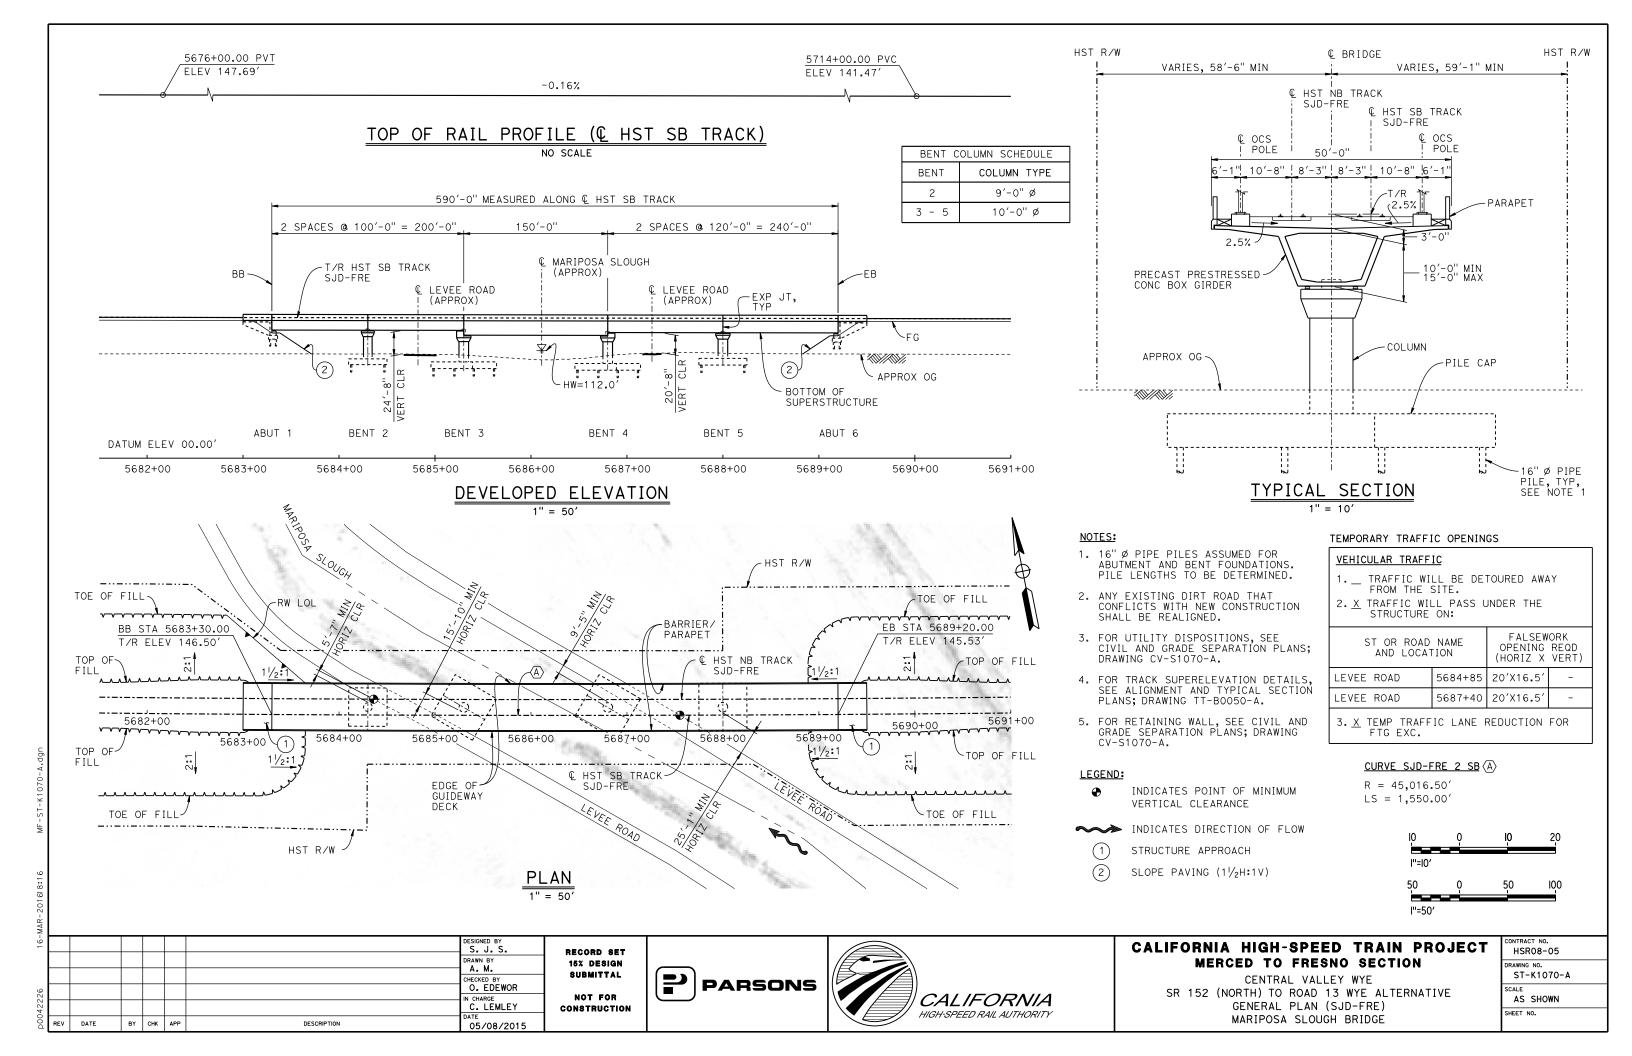



HST R/W


CALIFORNIA HIGH-SPEED TRAIN PROJECT MERCED TO FRESNO SECTION


CENTRAL VALLEY WYE
SR 152 (NORTH) TO ROAD 13 WYE ALTERNATIVE
TYPICAL SECTION (SJD-FRE)
SAN JOAQUIN RIVER BRIDGE - 2 OF 2

| CONTRACT NO. |
|--------------|
| HSR08-05 |
| DRAWING NO. |
| ST-K3065-A |
| SCALE |
| AS SHOWN |
| SHEET NO. |
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| BENT C | OLUMN SCHEDULE |
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| BENT | COLUMN TYPE |
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| 3 | 10'-0" Ø |
| 4 | 12'-0" Ø |
| 5 | 13'-0'' ø |
| 6 - 7 | 15'-0" Ø |
| 8 - 12 | 12'-0" Ø |

NOTES:

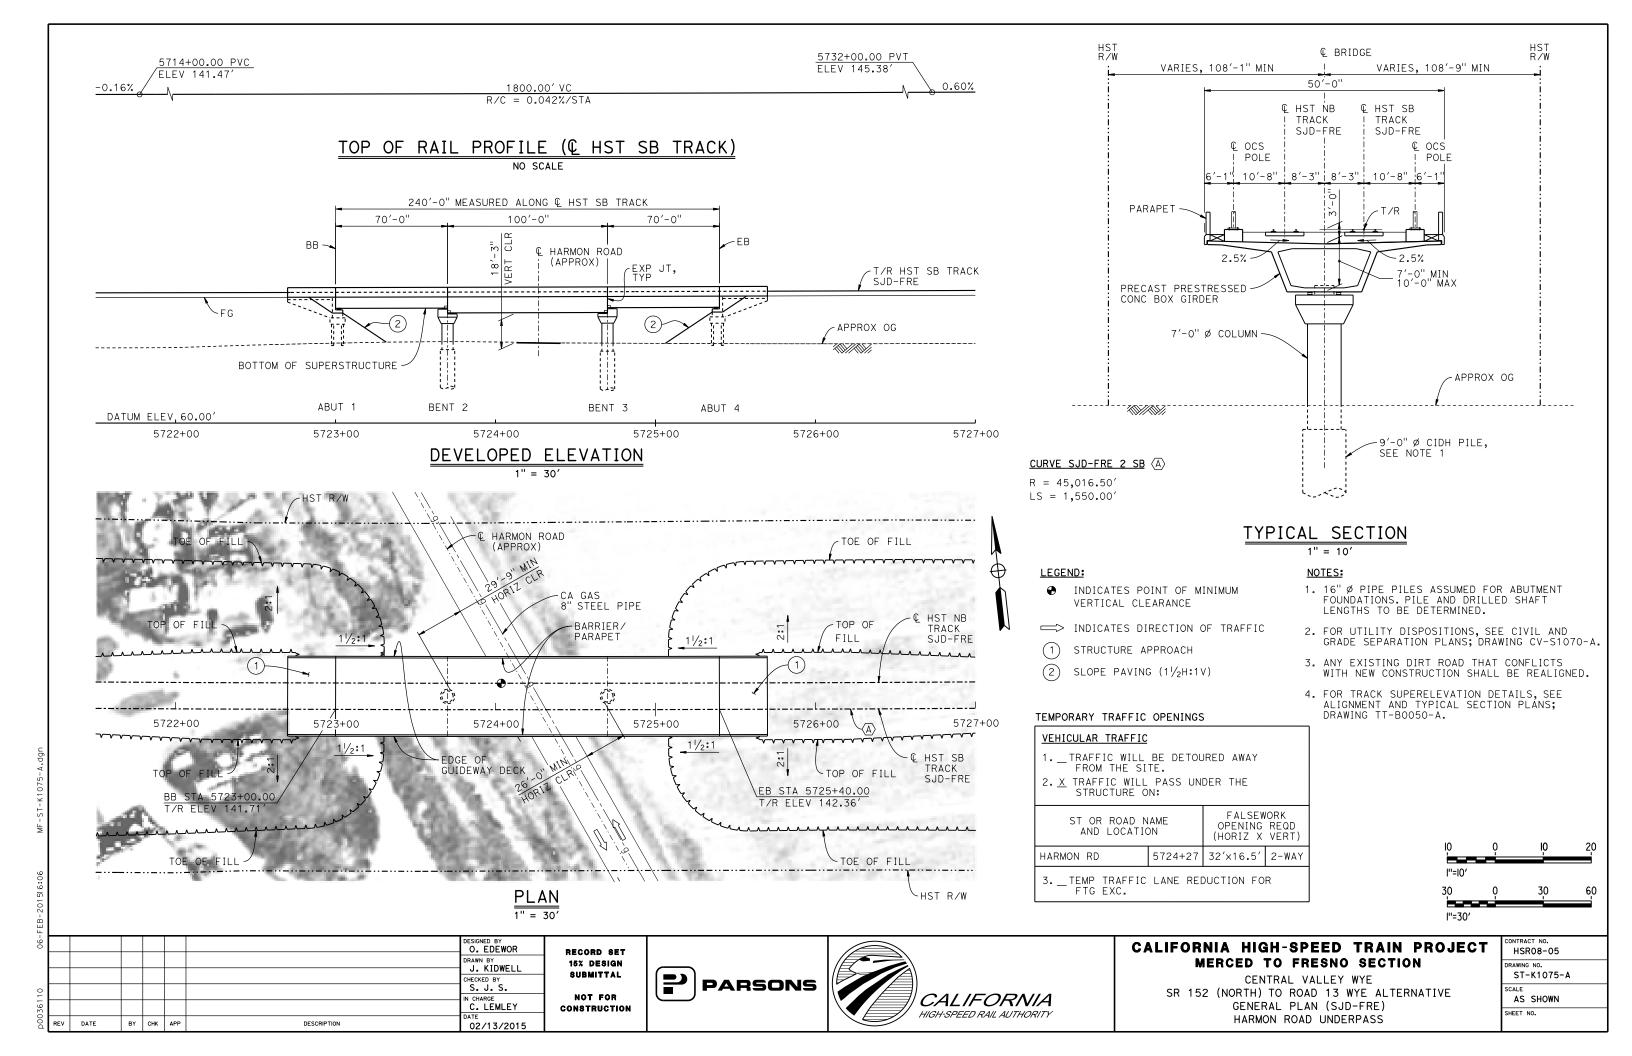- 1. PILE LENGTHS TO BE DETERMINED.
- 2. FOR TRACK SUPERELEVATION DETAILS, SEE ALIGNMENT AND TYPICAL SECTION PLANS; DRAWING TT-B0050-A.

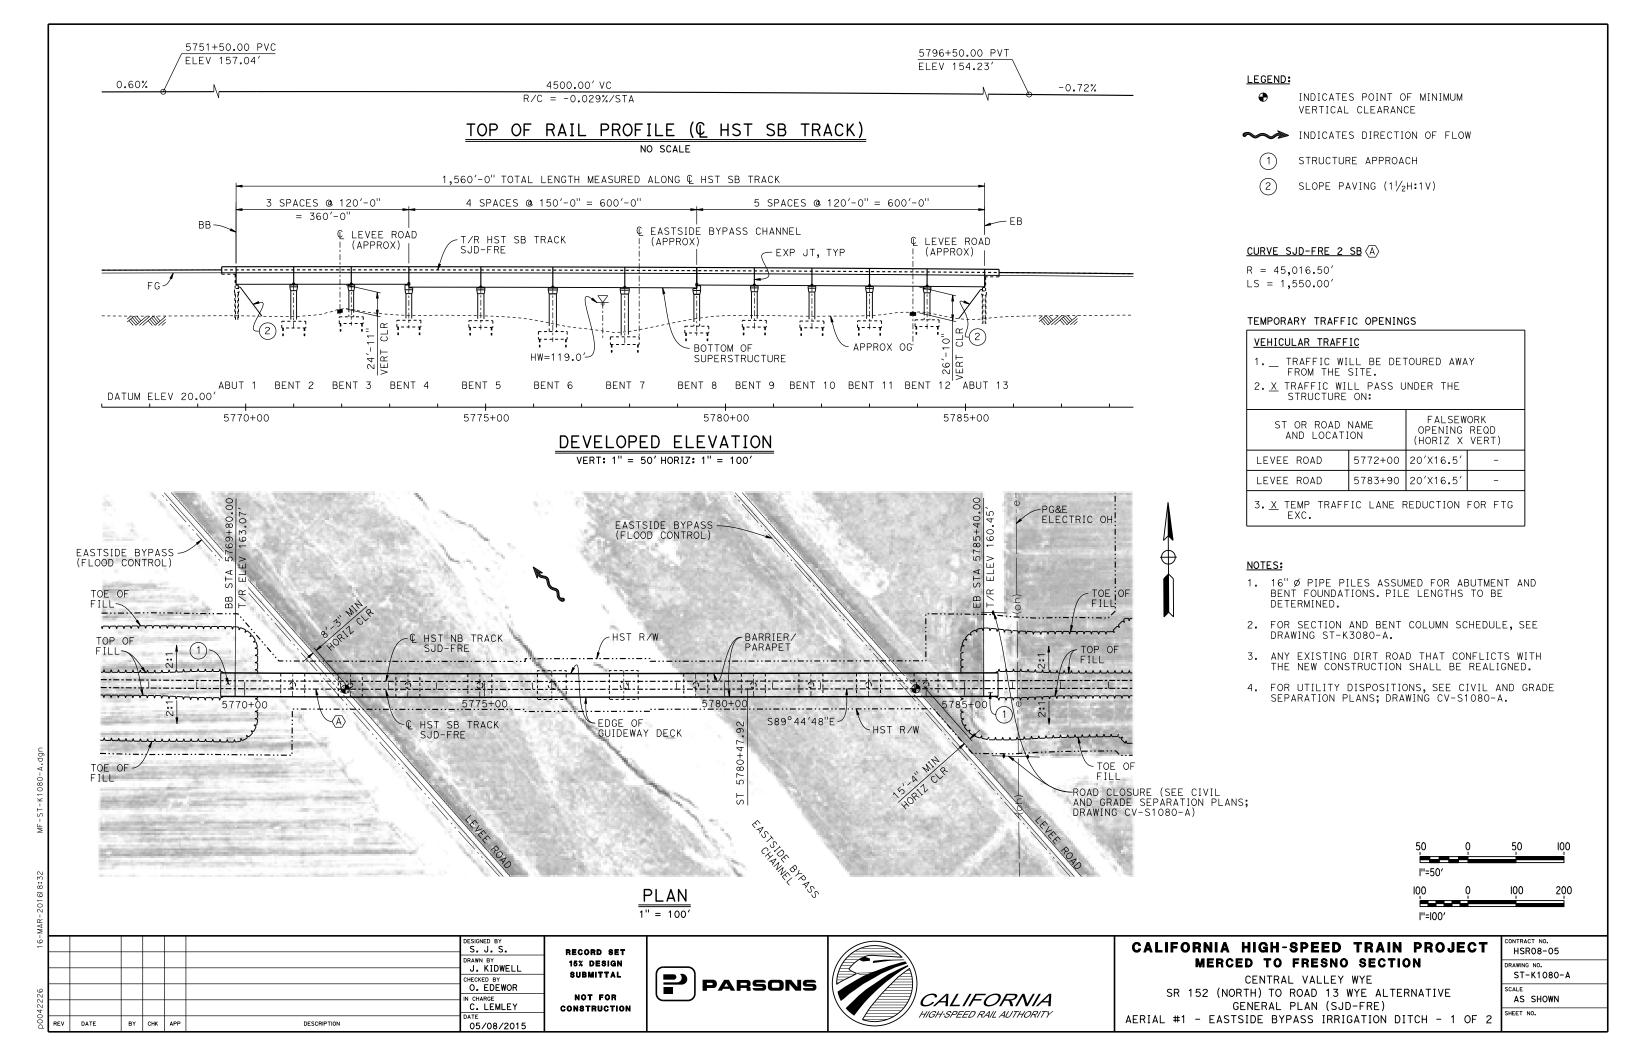
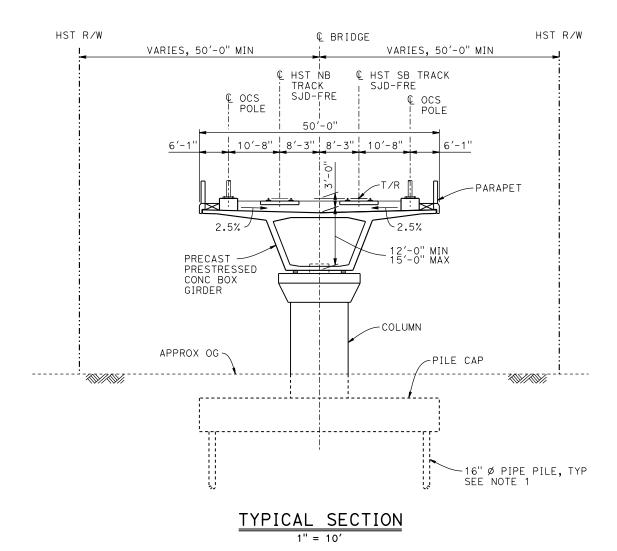
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| -90 | | | | | | | DESIGNED BY | _ |
| | | | | | | | DRAWN BY J. KIDWELL | R |
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| 3611 | | | | | | | IN CHARGE C. LEMLEY | co |
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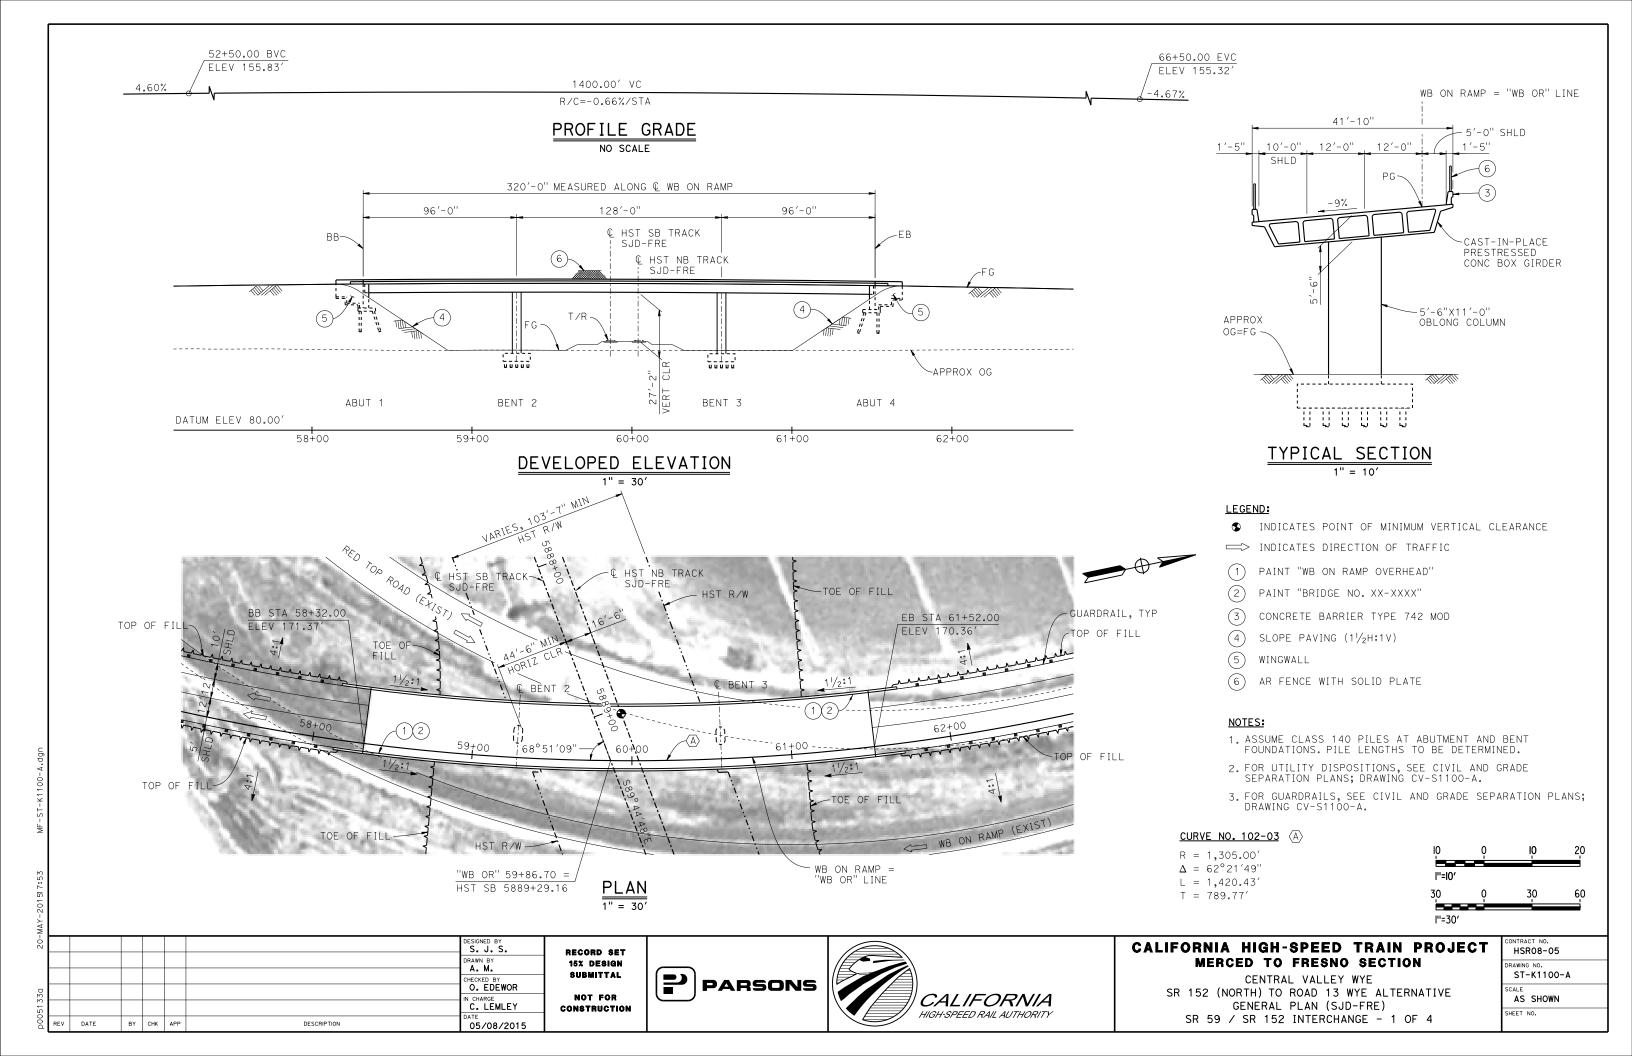






CALIFORNIA HIGH-SPEED TRAIN PROJECT MERCED TO FRESNO SECTION

CENTRAL VALLEY WYE
SR 152 (NORTH) TO ROAD 13 WYE ALTERNATIVE
TYPICAL SECTION (SJD-FRE)
AERIAL #1 - EASTSIDE BYPASS IRRIGATION DITCH - 2 OF 2

| Г | CONTRACT NO. HSRO8-05 |
|---|---------------------------|
| | DRAWING NO. ST-K3080-A |
| | SCALE AS SHOWN |
| 2 | SHEET NO. |



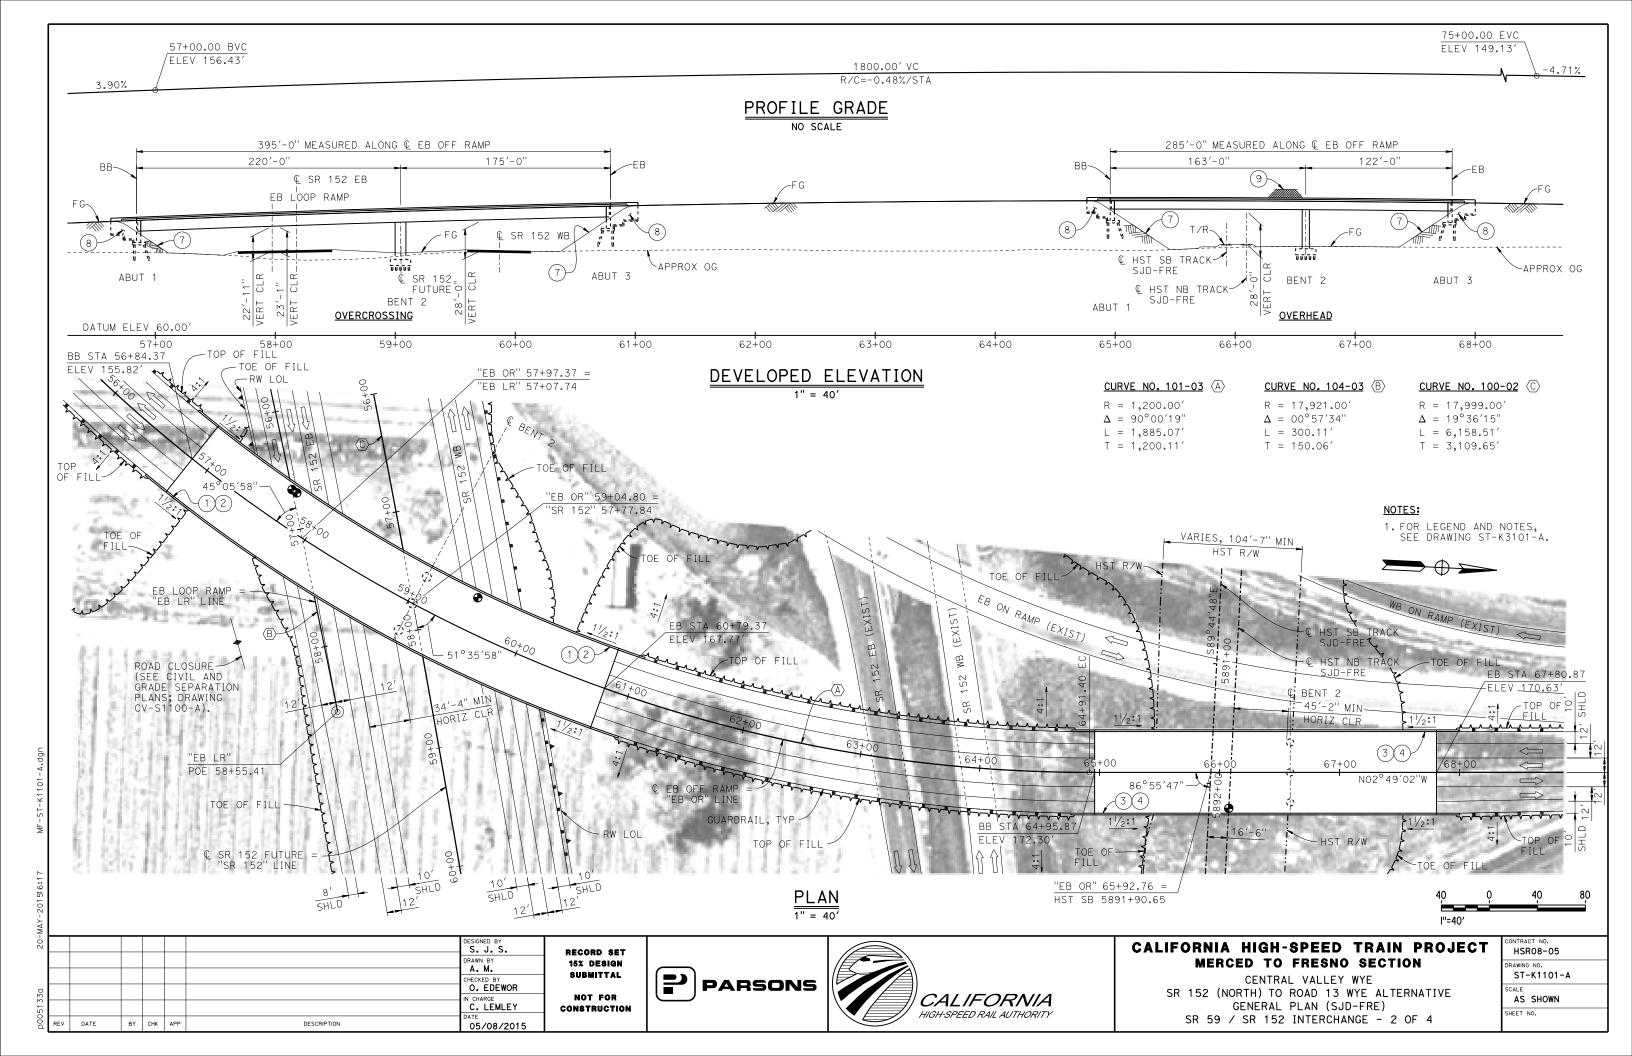


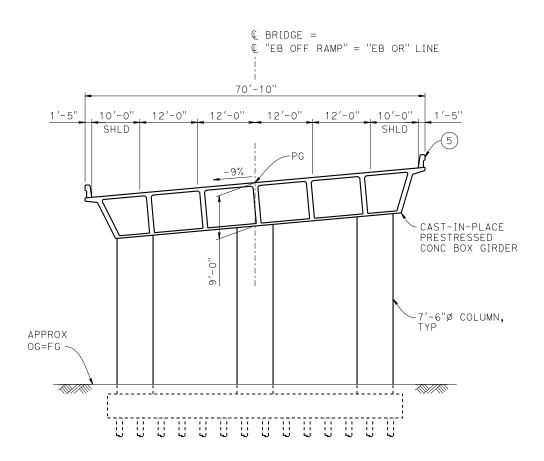

TYPICAL SECTION AT OVERCROSSING

LEGEND:

- ♠ INDICATES POINT OF MINIMUM VERTICAL CLEARANCE
- (1) PAINT "EB OFF RAMP OVERCROSSING"
- (2) PAINT "BRIDGE NO. XX-XXXX"
- (3) PAINT "EB OFF RAMP OVERHEAD"
- 4 PAINT "BRIDGE NO. XX-XXXX"
- (5) CONCRETE BARRIER TYPE 742
- (6) CONCRETE BARRIER TYPE 736 MOD
- (7) SLOPE PAVING $(1\frac{1}{2}H:1V)$
- (8) WINGWALL
- 9) AR FENCE WITH SOLID PLATE

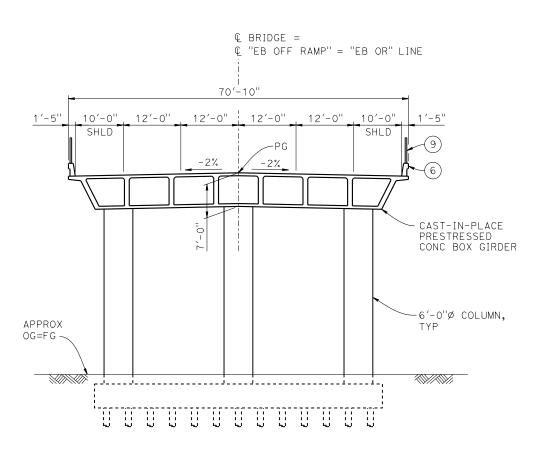

TYPICAL SECTION AT OVERHEAD

NOTES:

- 1. ASSUME CLASS 140 PILES AT ABUTMENT AND BENT FOUNDATIONS. PILE LENGTHS TO BE DETERMINED.
- 2. FOR UTILITY DISPOSITIONS, SEE CIVIL AND GRADE SEPARATION PLANS; DRAWING CV-S1100-A.
- 3. FOR RETAINING WALLS, SEE CIVIL AND GRADE SEPARATION PLANS; DRAWING CV-S1100-A.
- 4. FOR GUARDRAILS, SEE CIVIL AND GRADE SEPARATION PLANS; DRAWING CV-S1100-A.



RECORD SET
15% DESIGN
SUBMITTAL
NOT FOR
CONSTRUCTION







CALIFORNIA HIGH-SPEED TRAIN PROJECT MERCED TO FRESNO SECTION

CENTRAL VALLEY WYE
SR 152 (NORTH) TO ROAD 13 WYE ALTERNATIVE
TYPICAL SECTIONS (SJD-FRE)
SR 59 / SR 152 INTERCHANGE - 3 OF 4

| CONTRACT NO. |
|--------------|
| HSR08-05 |
| DRAWING NO. |
| ST-K3101-A |
| SCALE |
| AS SHOWN |
| SHEET NO. |
| |

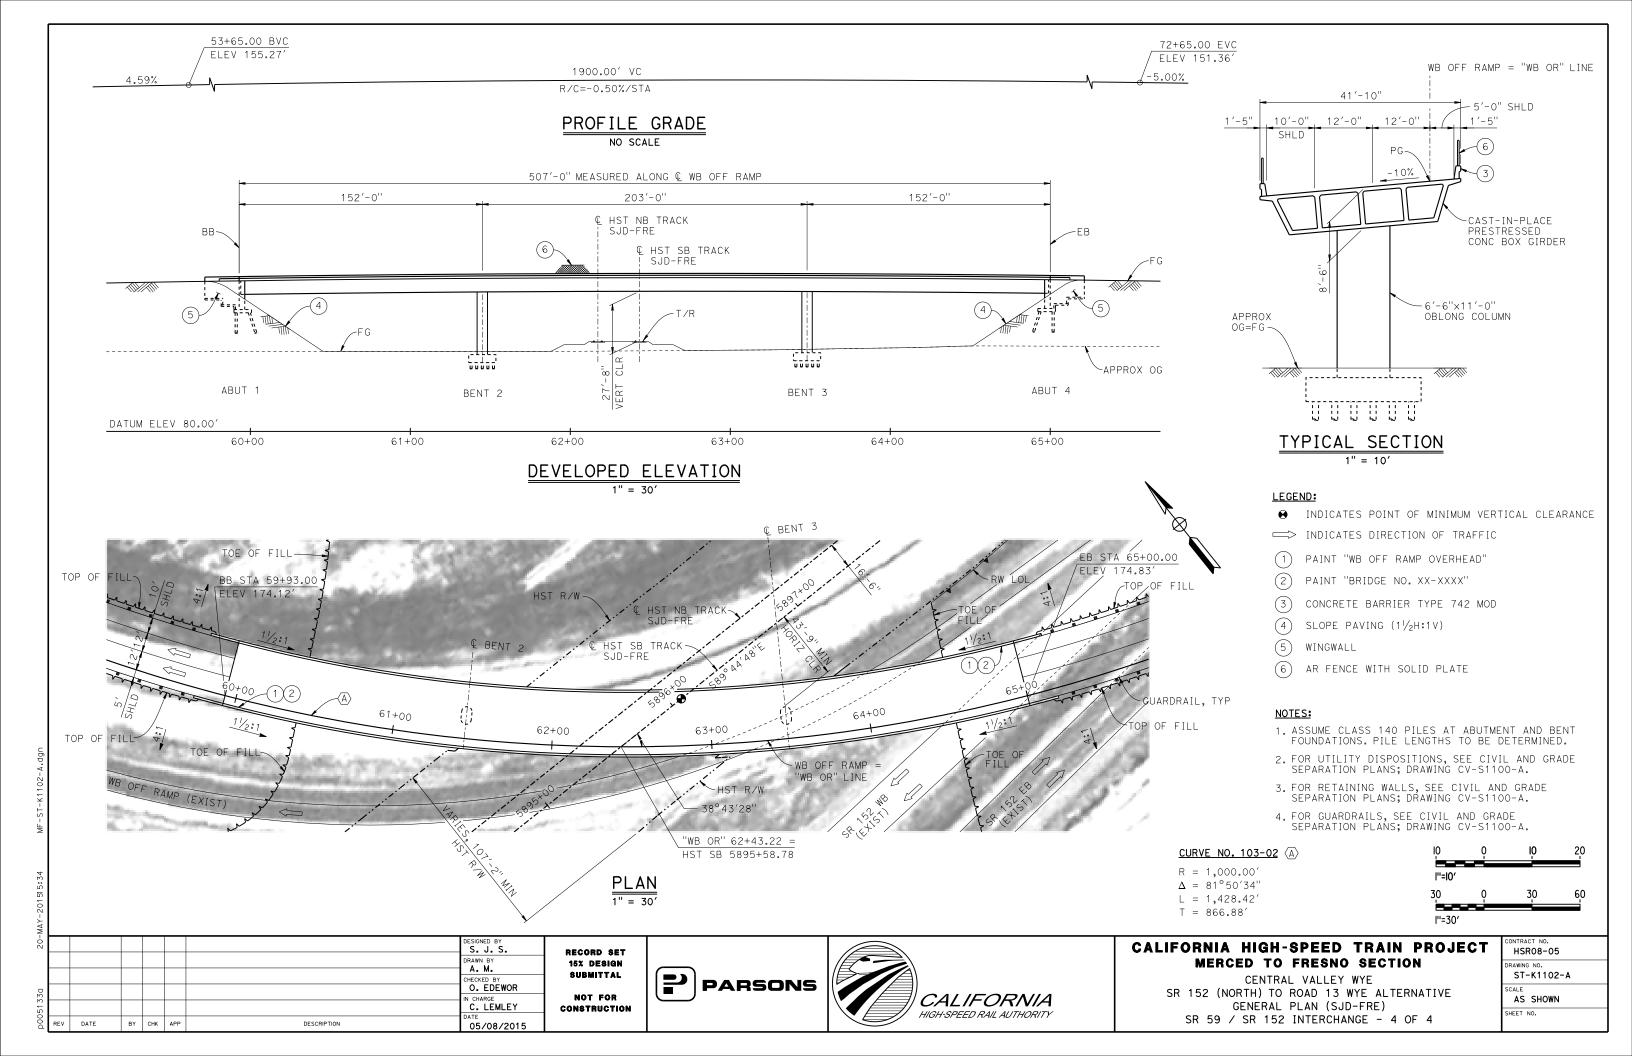

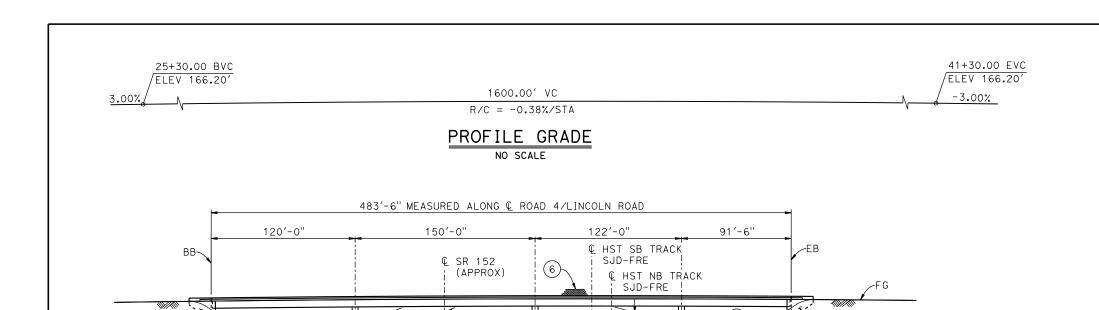

ELEVATION
1" = 40'

32+00

้ายต่อย

BENT 3


33+00

RETAINING WALL


<u>ַ</u> טַעַיעַעַ

BENT 4

34+00

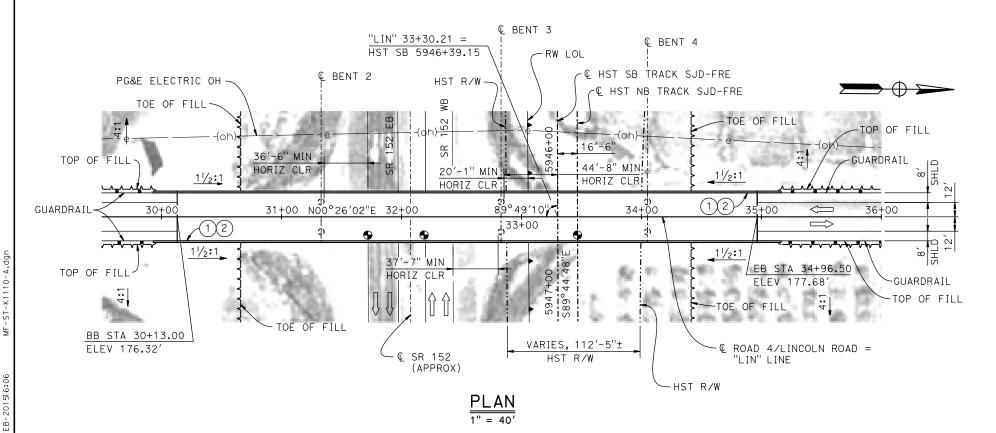

02/13/2015

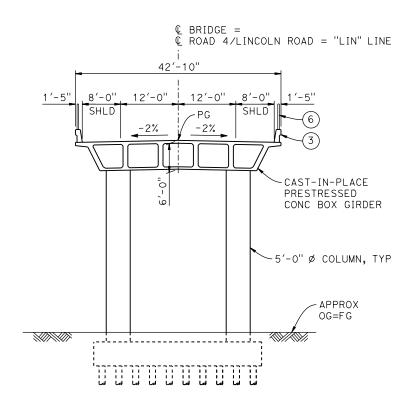

TYPICAL SECTION 1" = 10'

TEMPORARY TRAFFIC OPENINGS

VEHICULAR TRAFFIC

- 1. $_$ TRAFFIC WILL BE DETOURED AWAY FROM THE SITE.
- 2. \underline{X} TRAFFIC WILL PASS UNDER THE STRUCTURE ON:


| ST OR ROAD AND LOCA | FALSEW OPENING (HORIZ × | REQD | |
|-----------------------------|-------------------------------|--------------------|-------|
| SR 152 | 31+83 | 40′x16.5′ | E BND |
| SR 152 | 32+30 | 40′x16 . 5′ | W BND |
| 3. — TEMP TRAFF FTG EXC. | IC LANE R | EDUCTION F | FOR |

LEGEND:

- INDICATES POINT OF MINIMUM VERTICAL CLEARANCE
- □ INDICATES DIRECTION OF TRAFFIC
- (1) PAINT "LINCOLN ROAD OVERHEAD"
- (2) PAINT "BRIDGE NO. XX-XXXX"
- 3) CONCRETE BARRIER TYPE 736 MOD
- (4) SLOPE PAVING (11/2H:1V)
- (5) WINGWALL
- 6) AR FENCE WITH SOLID PLATE

NOTES:

- 1. ASSUME CLASS 140 PILES AT ABUTMENT AND BENT FOUNDATIONS. PILE LENGTHS TO BE DETERMINED.
- 2. FOR UTILITY DISPOSITIONS, SEE CIVIL AND GRADE SEPARATION PLANS; DRAWING CV-S1110-A.
- 3. FOR GUARDRAILS, SEE CIVIL AND GRADE SEPARATION PLANS, DRAWING CV-S1110-A.
- 4. FOR RETAINING WALL, SEE CIVIL AND GRADE SEPARATION PLANS, DRAWING CV-S1110-A.

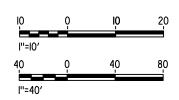

| | | | O. EDEWOR | ۱, |
|--|--|--|-----------------------|----|
| | | | D. TAFOYA | 1 |
| | | | CHECKED BY | ł |
| | | | S. J. S. IN CHARGE | |
| | | | C. LEMLEY | c |
| | | | | |

DESCRIPTION

บับบับบั

BENT 2

31+00

ABUT 1

30+00

DATUM ELEV 70.00

REV DATE

BY CHK APP

RECORD SET
15% DESIGN
SUBMITTAL
NOT FOR
CONSTRUCTION





-APPROX OG

36+00


ABUT 5

35+00


CALIFORNIA HIGH-SPEED TRAIN PROJECT MERCED TO FRESNO SECTION

CENTRAL VALLEY WYE
SR 152 (NORTH) TO ROAD 13 WYE ALTERNATIVE
GENERAL PLAN (SJD-FRE)
LINCOLN ROAD (ROAD 4) OVERHEAD

| CONTRACT NO. HSR08-05 |
|---------------------------|
| DRAWING NO. ST-K1110-A |
| SCALE AS SHOWN |
| SHEET NO. |

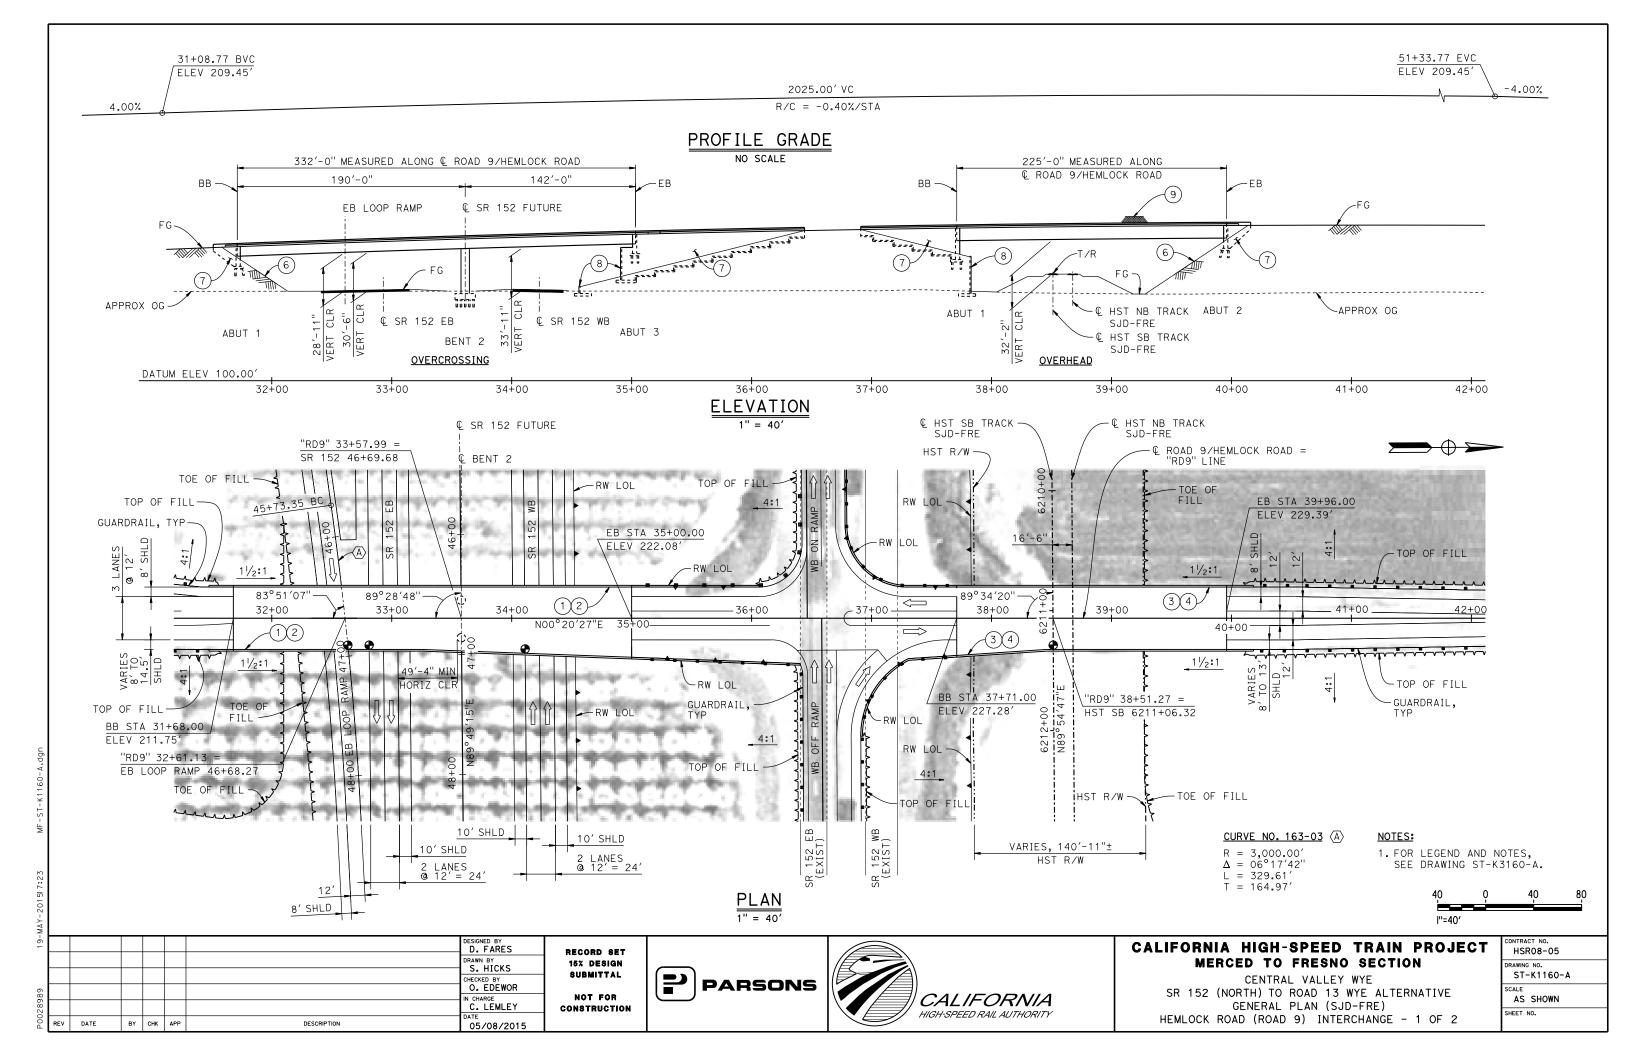

TYPICAL SECTION AT OVERCROSSING

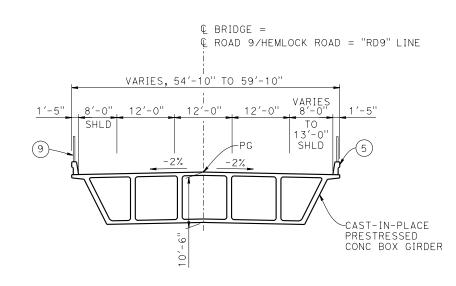

TYPICAL SECTION AT OVERHEAD

LEGEND:

- INDICATES POINT OF MINIMUM VERTICAL CLEARANCE
- PAINT "HEMLOCK ROAD OVERCROSSING"
- PAINT "BRIDGE NO. XX-XXXX"
- (3) PAINT "HEMLOCK ROAD OVERHEAD"
- (4) PAINT "BRIDGE NO. XX-XXXX"
- CONCRETE BARRIER TYPE 736 MOD
- SLOPE PAVING $(1\frac{1}{2}H:1V)$
- WINGWALL
- RETAINING WALL
- AR FENCE WITH SOLID PLATE

- 1. ASSUME CLASS 140 PILES AT ABUTMENT AND BENT FOUNDATIONS. PILE LENGTHS TO BE DETERMINED.
- 2. FOR UTILITY DISPOSITIONS, SEE CIVIL AND GRADE SEPARATION PLANS; DRAWING CV-S1160-A.
- 3. FOR RETAINING WALLS, SEE CIVIL AND GRADE SEPARATION PLANS; DRAWING CV-S1160-A.
- 4. FOR GUARDRAILS, SEE CIVIL AND GRADE SEPARATION PLAŃS; DRAWING CV-S1160-A.



D. FARES S. HICKS O. EDEWOR C. LEMLEY BY CHK APP DESCRIPTION 05/<u>08/2015</u>

RECORD SET 15% DESIGN SUBMITTAL NOT FOR CONSTRUCTION







CALIFORNIA HIGH-SPEED TRAIN PROJECT MERCED TO FRESNO SECTION

CENTRAL VALLEY WYE SR 152 (NORTH) TO ROAD 13 WYE ALTERNATIVE TYPICAL SECTIONS (SJD-FRE) HEMLOCK ROAD (ROAD 9) INTERCHANGE - 2 OF 2

HSR08-05 ST-K3160-A AS SHOWN

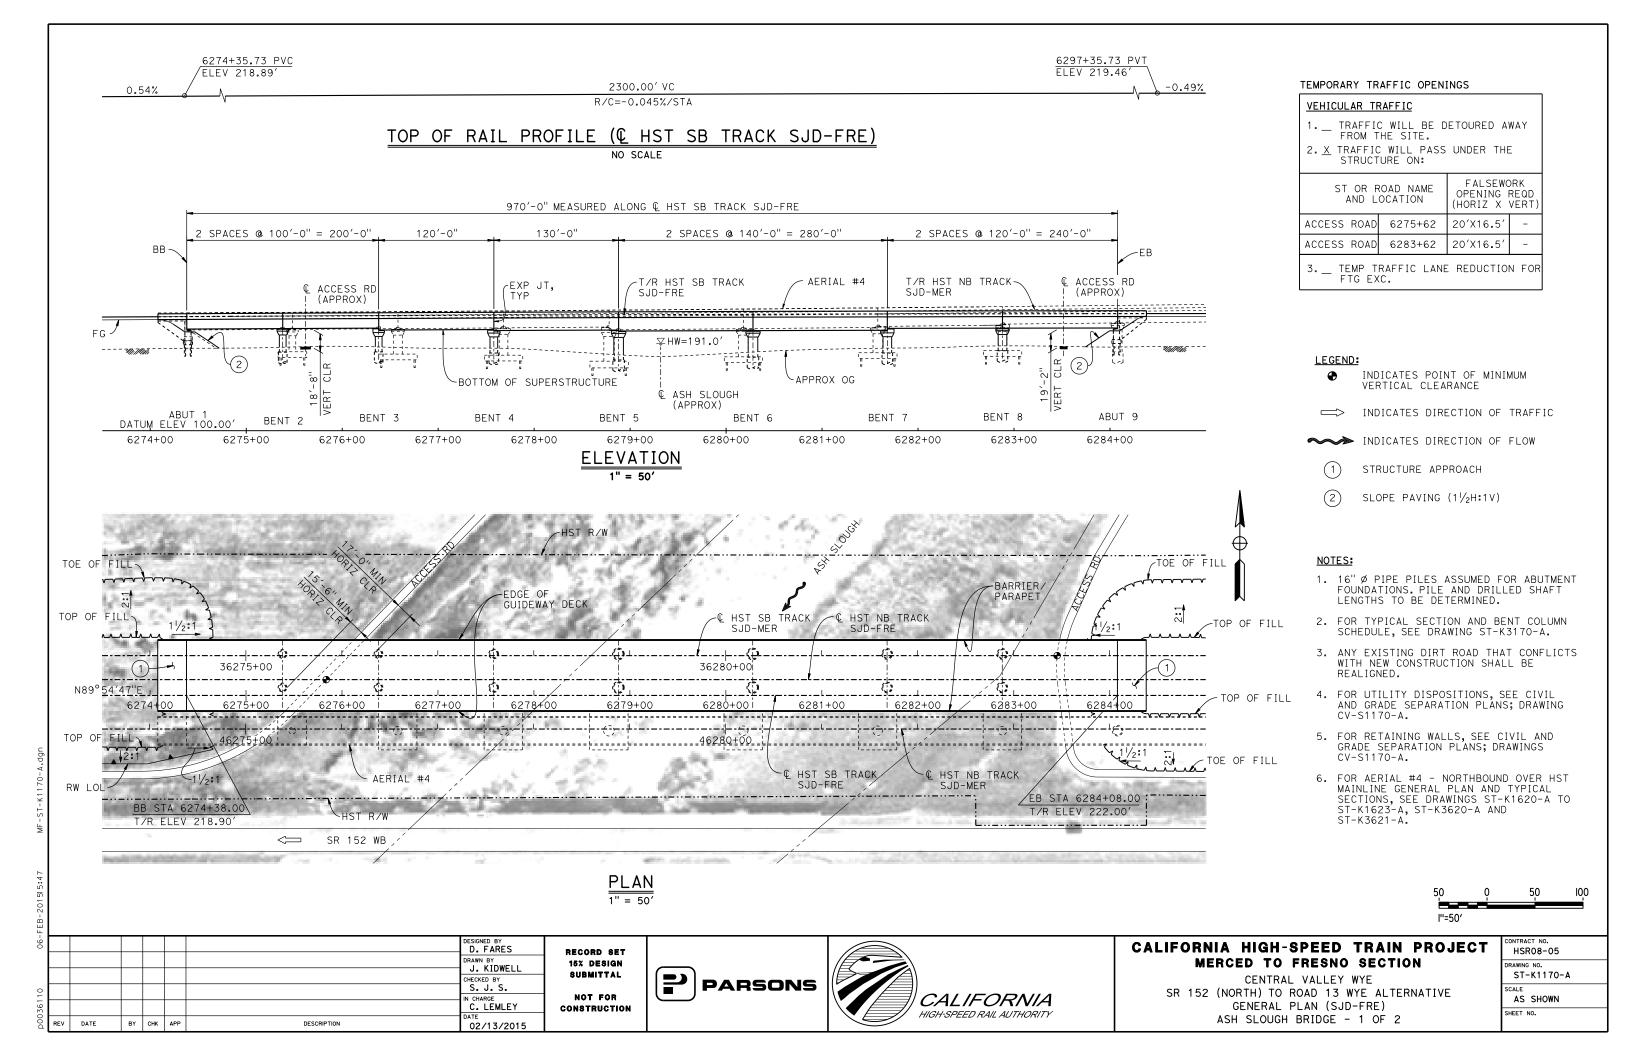

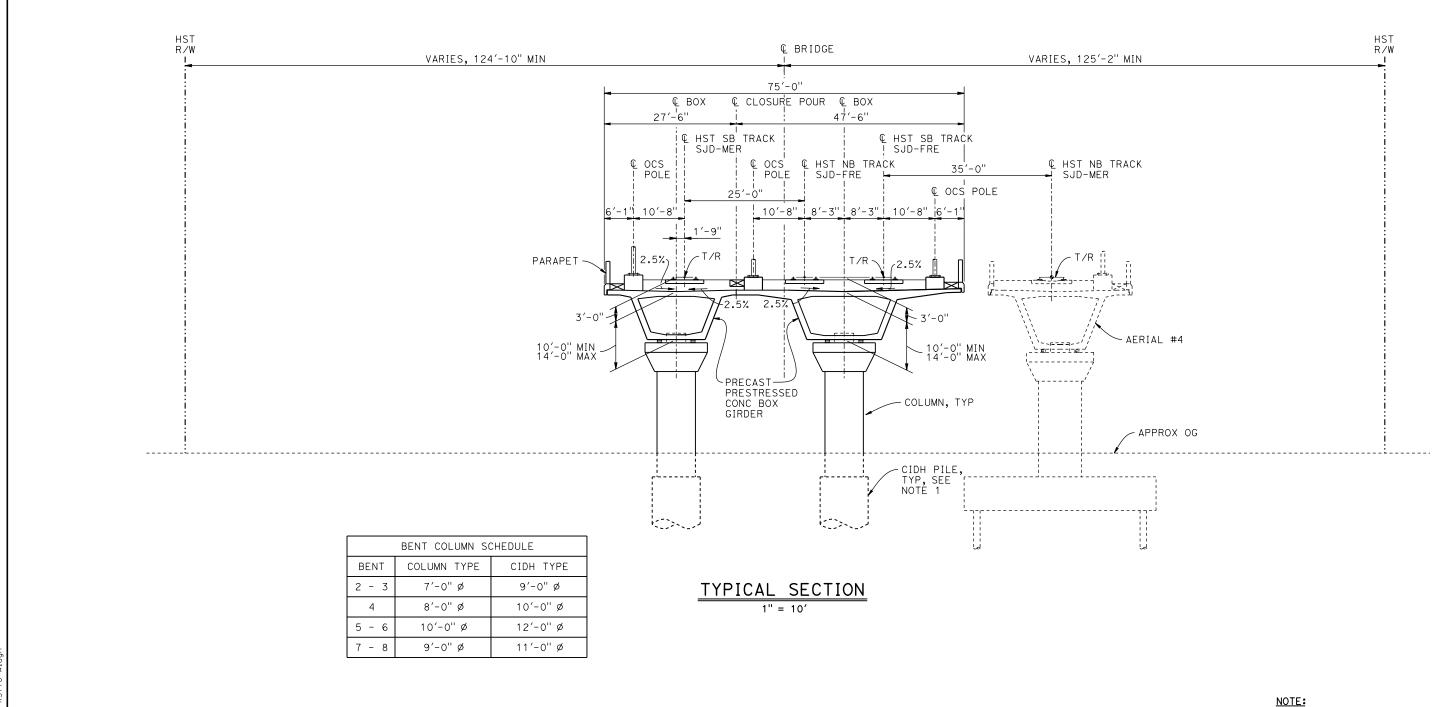

1. DRILLED SHAFT LENGTHS TO BE DETERMINED.



| -90 | | | | | | | D. FARES | F |
|------|-----|------|----|-----|-----|-------------|---------------------|-----|
| | | | | | | | DRAWN BY J. KIDWELL | 1 " |
| 0 | | | | | | | CHECKED BY | |
| 3611 | | | | | | | IN CHARGE C. LEMLEY | C |
| 00d | REV | DATE | BY | СНК | APP | DESCRIPTION | 02/13/2015 | |

RECORD SET 15% DESIGN SUBMITTAL NOT FOR CONSTRUCTION






CALIFORNIA HIGH-SPEED TRAIN PROJECT MERCED TO FRESNO SECTION


CENTRAL VALLEY WYE SR 152 (NORTH) TO ROAD 13 WYE ALTERNATIVE TYPICAL SECTION (SJD-FRE) ASH SLOUGH BRIDGE - 2 OF 2

| CONTRACT NO. HSR08-05 |
|-----------------------|
| DRAWING NO. |
| ST-K3170-A |
| SCALE |
| AS SHOWN |
| SHEET NO. |

TOP OF RAIL PROFILE (@ HST SB TRACK)

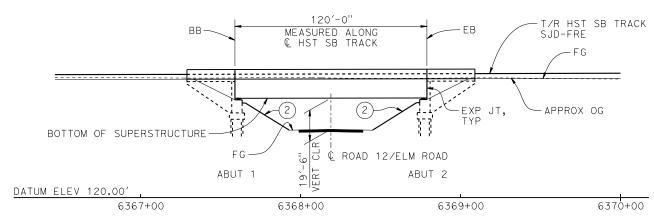

ELEVATION

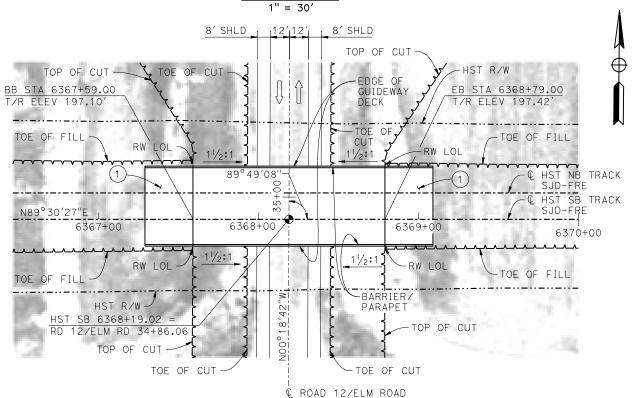

PLAN

LEGEND:

- ♣ INDICATES POINT OF MINIMUM VERTICAL CLEARANCE
- (1) STRUCTURE APPROACH
- (2) SLOPE PAVING $(1\frac{1}{2}H:1V)$

HST € BRIDGE R/W R/W VARIES, 51'-4" MIN VARIES, 51'-9" MIN € HST NB TRACK SJD-FRE & HST SB_TRACK € ocs POLE SJD-FRE © ocs POLE 10'-8" | 8'-3" | 8'-3" | 10'-8" PARAPET: PRECAST PRESTRESSED 12'-0" CONC BOX GIRDER TYPICAL SECTION

TEMPORARY TRAFFIC OPENINGS

VEHICULAR TRAFFIC

- 1. __ TRAFFIC WILL BE DETOURED AWAY FROM THE SITE.
- 2. $\underline{\mathbf{X}}$ TRAFFIC WILL PASS UNDER THE STRUCTURE ON:


STREET OR ROAD NAME OPENING REQUIRED (HORIZ X VERT)

ROAD 12/ELM ROAD 6368+19 32'x16.5' 2-WAY

3. _ TEMP TRAFFIC LANE REDUCTION FOR FTG EXC.

NOTES:

- 16"Ø PIPE PILES ASSUMED FOR ABUTMENT FOUNDATIONS. PILE LENGTHS TO BE DETERMINED.
- 2. FOR UTILITY DISPOSITIONS, SEE CIVIL AND GRADE SEPARATION PLANS; DRAWING CV-S1190-A.
- 3. FOR RETAINING WALLS, SEE CIVIL AND GRADE SEPARATION PLANS; DRAWING CV-S1190-A.

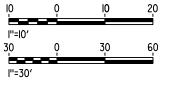

RECORD SET
15% DESIGN
SUBMITTAL
NOT FOR
CONSTRUCTION








CALIFORNIA HIGH-SPEED TRAIN PROJECT MERCED TO FRESNO SECTION

CENTRAL VALLEY WYE
SR 152 (NORTH) TO ROAD 13 WYE ALTERNATIVE
GENERAL PLAN (SJD-FRE)
ELM ROAD (ROAD 12) UNDERPASS

CONTRACT NO.
HSRO8-05
DRAWING NO.
ST-K1190-A
SCALE
AS SHOWN
SHEET NO.

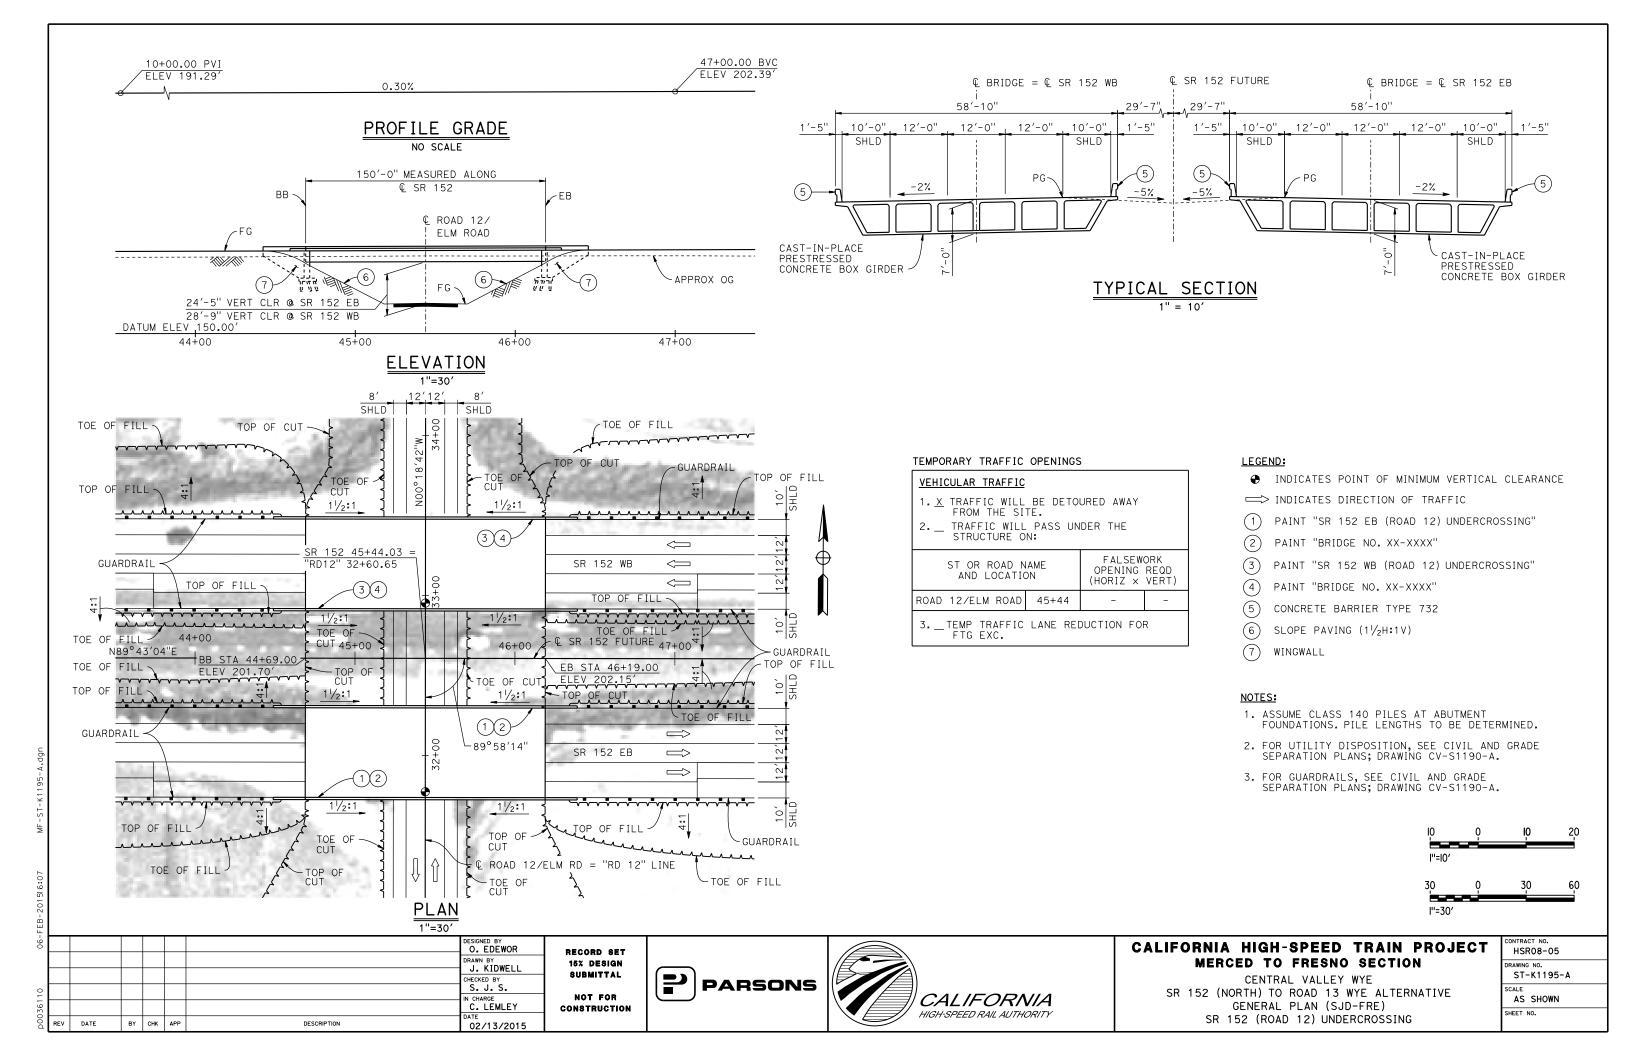

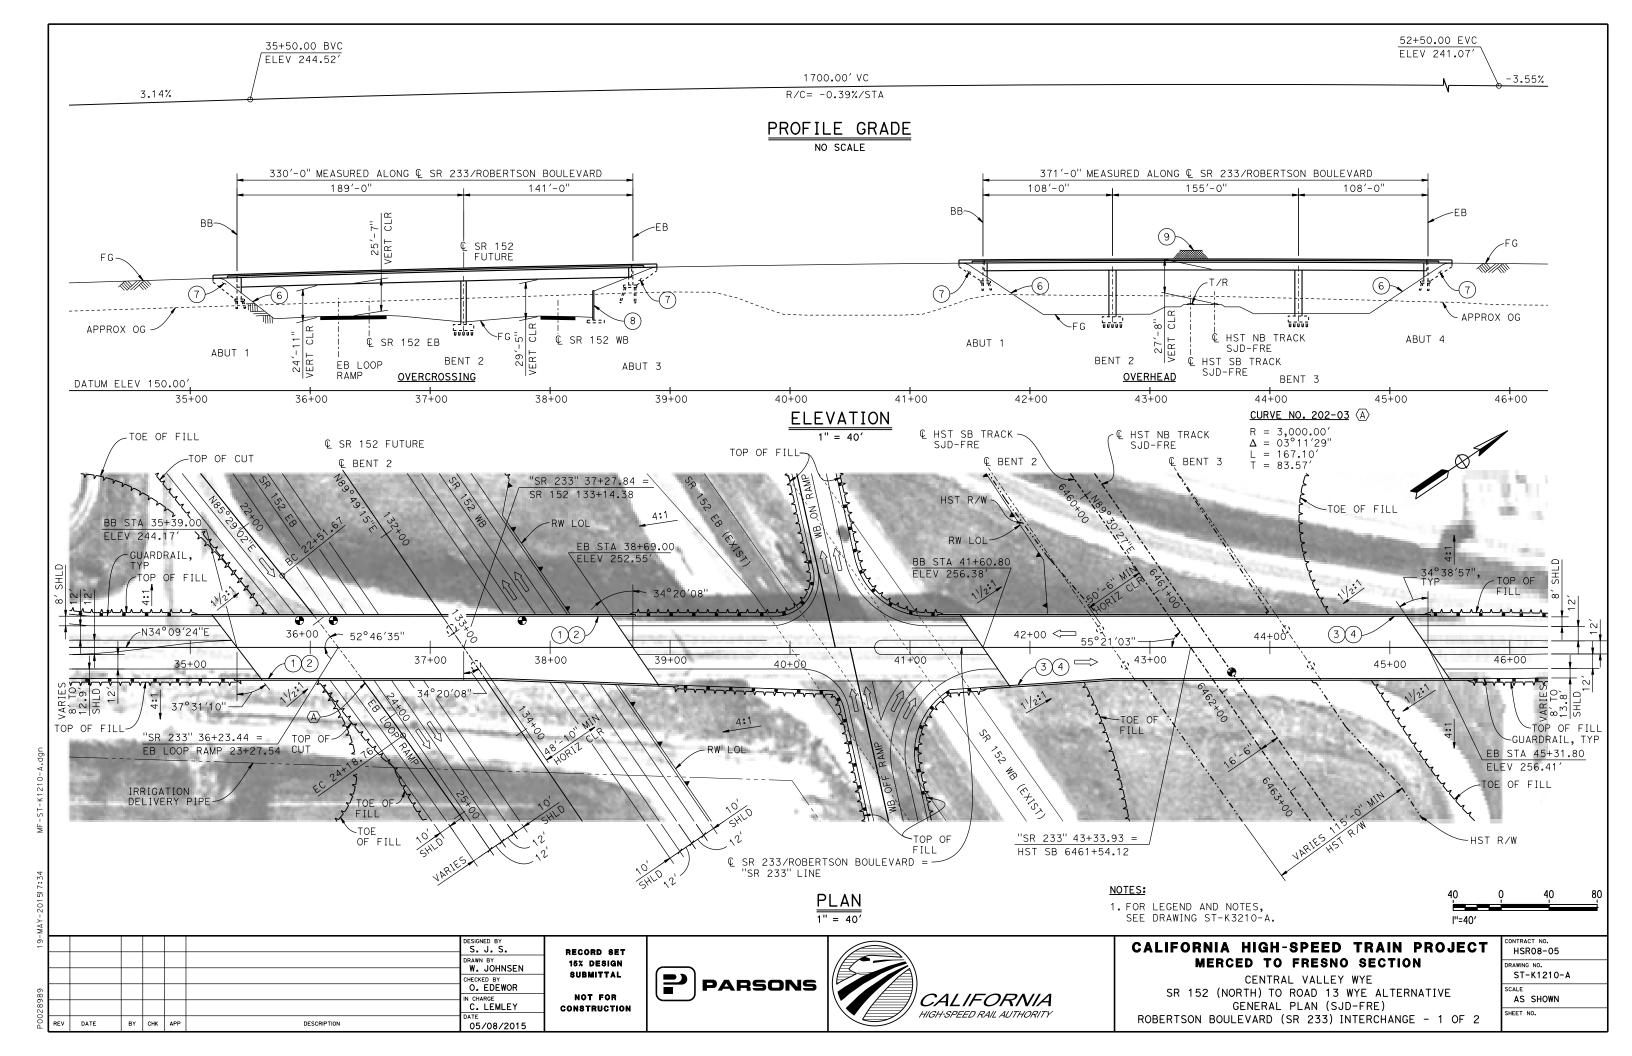

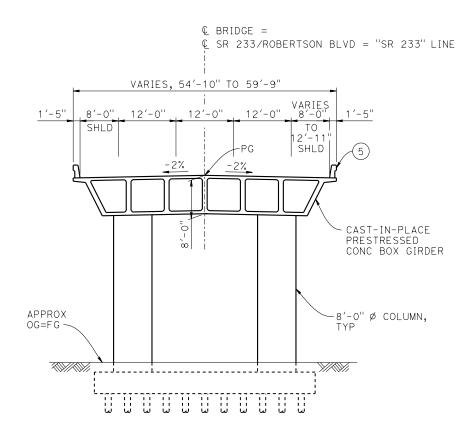

TYPICAL SECTION AT OVERCROSSING

TYPICAL SECTION AT OVERHEAD

© BRIDGE =

VARIES, 54'-10" TO 60'-8"

12'-0"

SHLD

APPROX

OG=FG

© SR 233/ROBERTSON BLVD = "SR 233" LINE

ТО

LEGEND:

- ◆ INDICATES POINT OF MINIMUM VERTICAL CLEARANCE
- PAINT "ROBERTSON BLVD OVERCROSSING"
- 2 PAINT "BRIDGE NO. XX-XXXX"
- PAINT "ROBERTSON BLVD OVERHEAD"
- 4 PAINT "BRIDGE NO. XX-XXXX"
- CONCRETE BARRIER TYPE 736 MOD
- (6) SLOPE PAVING $(1\frac{1}{2}H:1V)$
- WINGWALL
- (8) RETAINING WALL
- AR FENCE WITH SOLID PLATE

1. ASSUME CLASS 140 PILES AT ABUTMENT AND BENT FOUNDATIONS. PILE LENGTHS TO BE DETERMINED.

CAST-IN-PLACE

CONC BOX GIRDER

PRESTRESSED

-6'-0" Ø COLUMN,

- 2. FOR UTILITY DISPOSITIONS, SEE CIVIL AND GRADE SEPARATION PLANS; DRAWING CV-S1210-A.
- 3. FOR RETAINING WALLS, SEE CIVIL AND GRADE SEPARATION PLANS; DRAWING CV-S1210-A.
- 4. FOR GUARDRAILS, SEE CIVIL AND GRADE SEPARATION PLANS; DRAWING CV-S1210-A.

| IO | Ō | ΙO | 20 |
|---------|---|----|----|
| l''=l0′ | | | |

DESIGNED BY W. JOHNSEN O. EDEWOR C. LEMLEY BY CHK APP DESCRIPTION 05/<u>08/2015</u>

RECORD SET 15% DESIGN SUBMITTAL NOT FOR CONSTRUCTION







CALIFORNIA HIGH-SPEED TRAIN PROJECT MERCED TO FRESNO SECTION

CENTRAL VALLEY WYE SR 152 (NORTH) TO ROAD 13 WYE ALTERNATIVE TYPICAL SECTIONS (SJD-FRE) ROBERTSON BOULEVARD (SR 233) INTERCHANGE - 2 OF 2

| CONTRACT NO. HSR08-05 |
|---------------------------|
| DRAWING NO. ST-K3210-A |
| AS SHOWN |


PARSONS

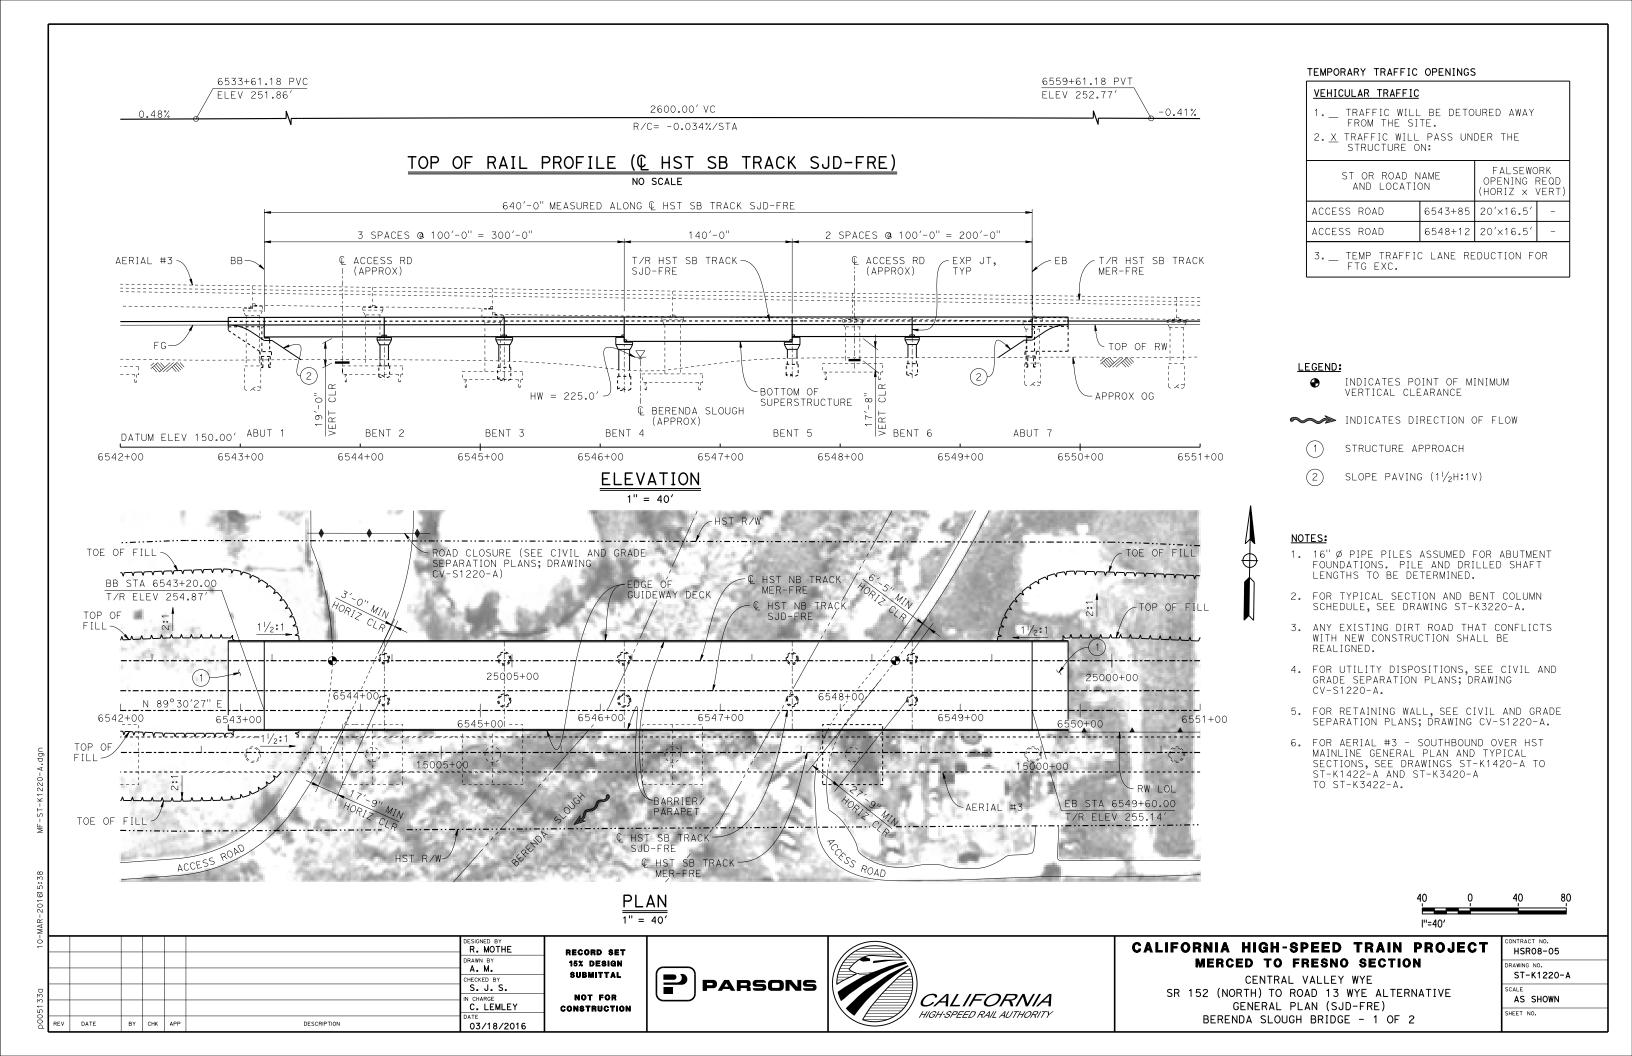

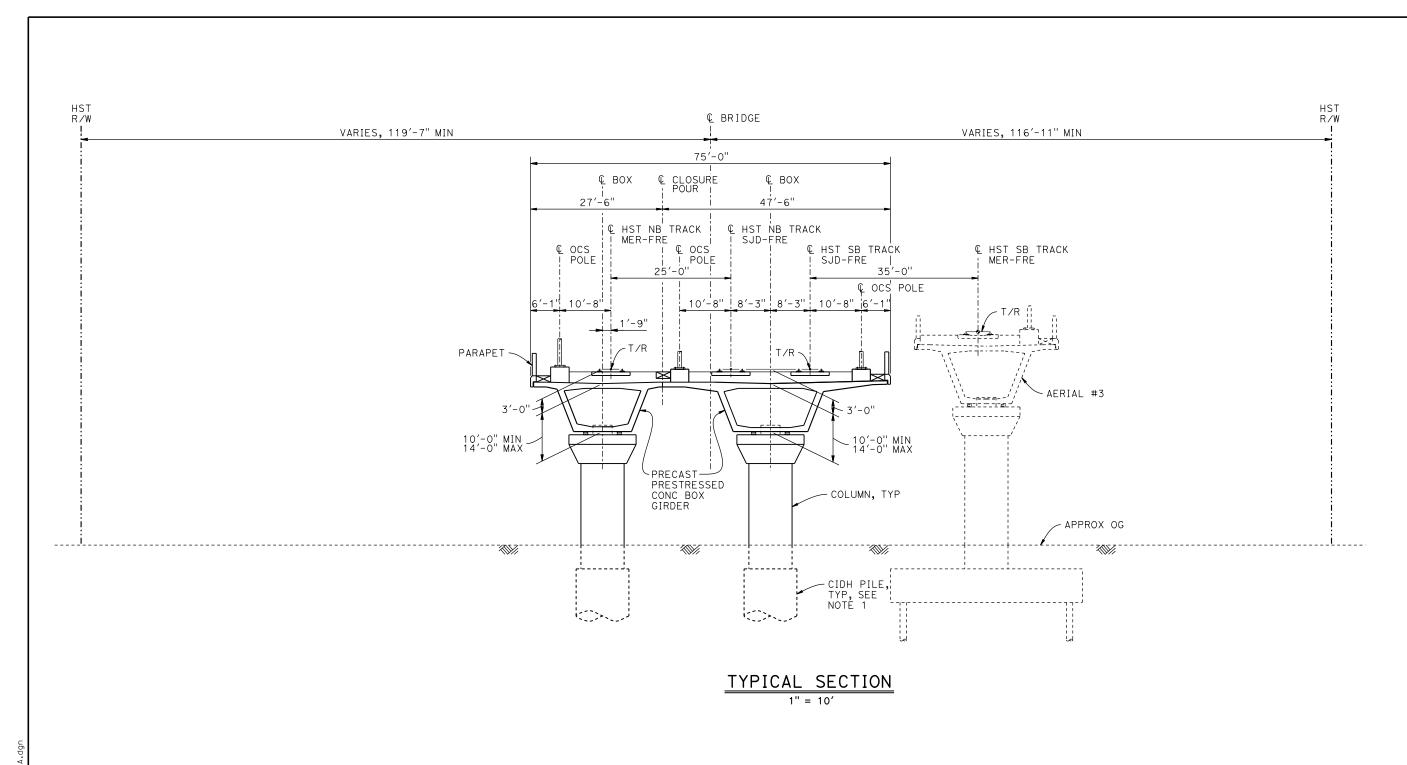

| | BENT COLUMN SCHEDULE | | | | | | |
|-------|----------------------|-----------|--|--|--|--|--|
| BENT | COLUMN TYPE | CIDH TYPE | | | | | |
| 2 | 7'-0" ø | 9'-0" ø | | | | | |
| 3 - 4 | 9'-0" Ø | 11'-0" ø | | | | | |
| 5 | 8'-0" ø | 10'-0" ø | | | | | |
| 6 | 7′-0" Ø | 9′-0'' ø | | | | | |

1. DRILLED SHAFT LENGTHS TO BE DETERMINED.

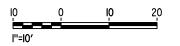

| 06-F | | | | | | | DESIGNED BY R. MOTHE | |
|-------|-----|------|----|-----|-----|-------------|----------------------|------------------|
| | | | | | | | DRAWN BY A. M. | 1 ' |
| 0 | | | | | | | CHECKED BY S. J. S. | İ |
| 11 | | | | | | | IN CHARGE C. LEMLEY |] _c , |
| p0036 | REV | DATE | BY | снк | APP | DESCRIPTION | DATE 02/13/2015 | |

RECORD SET
15% DESIGN
SUBMITTAL
NOT FOR
CONSTRUCTION








CALIFORNIA HIGH-SPEED TRAIN PROJECT MERCED TO FRESNO SECTION

CENTRAL VALLEY WYE SR 152 (NORTH) TO ROAD 13 WYE ALTERNATIVE TYPICAL SECTION (SJD-FRE) BERENDA SLOUGH BRIDGE - 2 OF 2

| CONTRACT NO. | | | | | | | | |
|--------------|--|--|--|--|--|--|--|--|
| HSR08-05 | | | | | | | | |
| DRAWING NO. | | | | | | | | |
| ST-K3220-A | | | | | | | | |
| SCALE | | | | | | | | |
| AS SHOWN | | | | | | | | |
| SHEET NO. | | | | | | | | |
| | | | | | | | | |

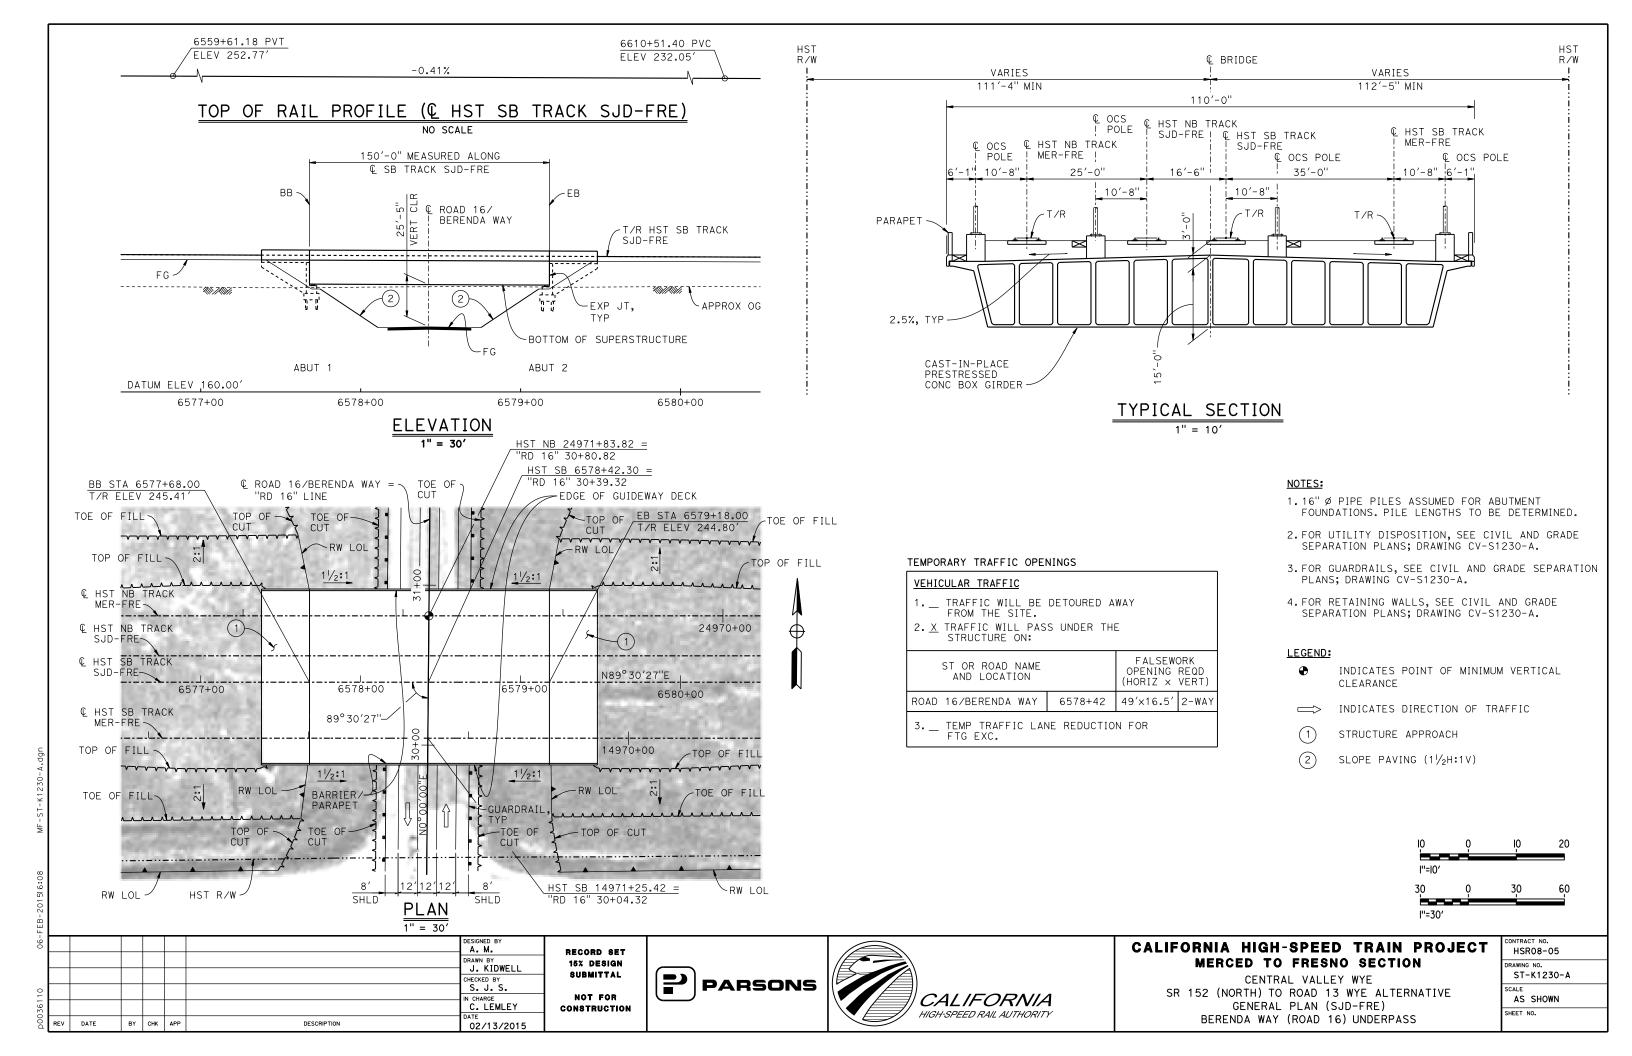

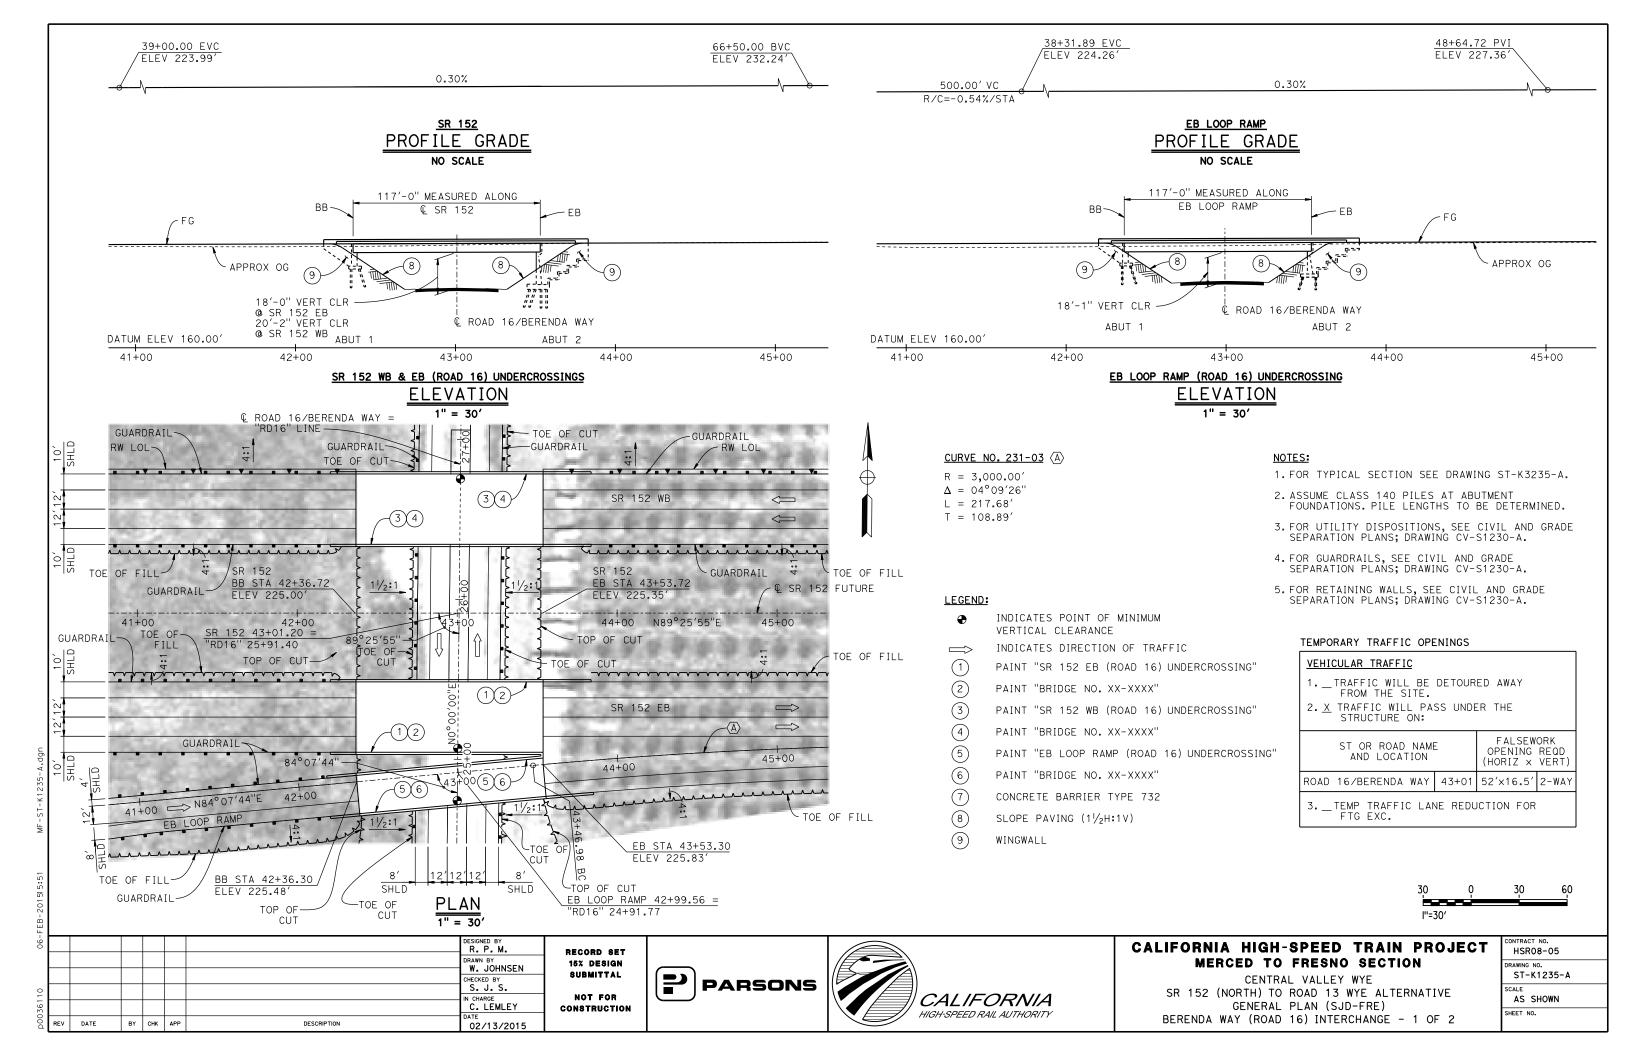

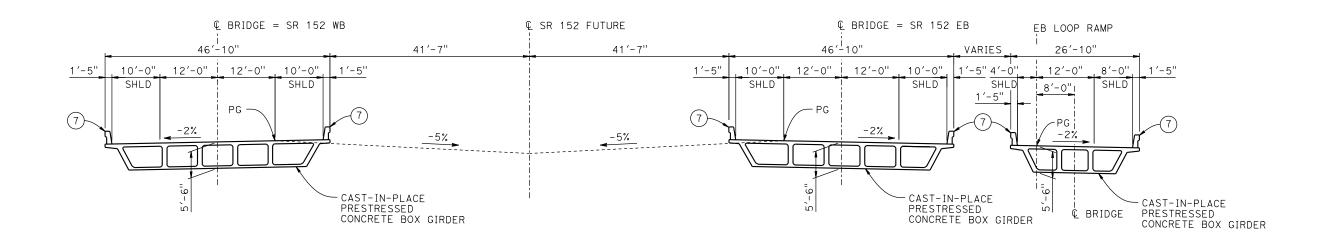

TYPICAL SECTION
1" = 10'



| Ē | | | | | | | | |
|------|-----|------|----|-----|-----|-------------|---------------------|----------|
| -90 | | | | | | | DESIGNED BY | |
| | | | | | | | DRAWN BY W. JOHNSEN | RE 15 |
| | | | | | | | CHECKED BY S. J. S. | 81 |
| 5110 | | | | | | | IN CHARGE | 1 |
| 036 | | | | | | | C. LEMLEY | CON |
| D00 | REV | DATE | BY | CHK | APP | DESCRIPTION | 02/13/2015 | |

RECORD SET
15% DESIGN
SUBMITTAL
NOT FOR
CONSTRUCTION







CALIFORNIA HIGH-SPEED TRAIN PROJECT MERCED TO FRESNO SECTION


CENTRAL VALLEY WYE
SR 152 (NORTH) TO ROAD 13 WYE ALTERNATIVE
TYPICAL SECTION (SJD-FRE)
BERENDA WAY (ROAD 16) INTERCHANGE - 2 OF 2

| - | CONTRACT NO. HSR08-05 |
|---|-----------------------|
| | 1131100 03 |
| | DRAWING NO. |
| | ST-K3235-A |
| | SCALE |
| | AS SHOWN |
| | SHEET NO. |
| | |

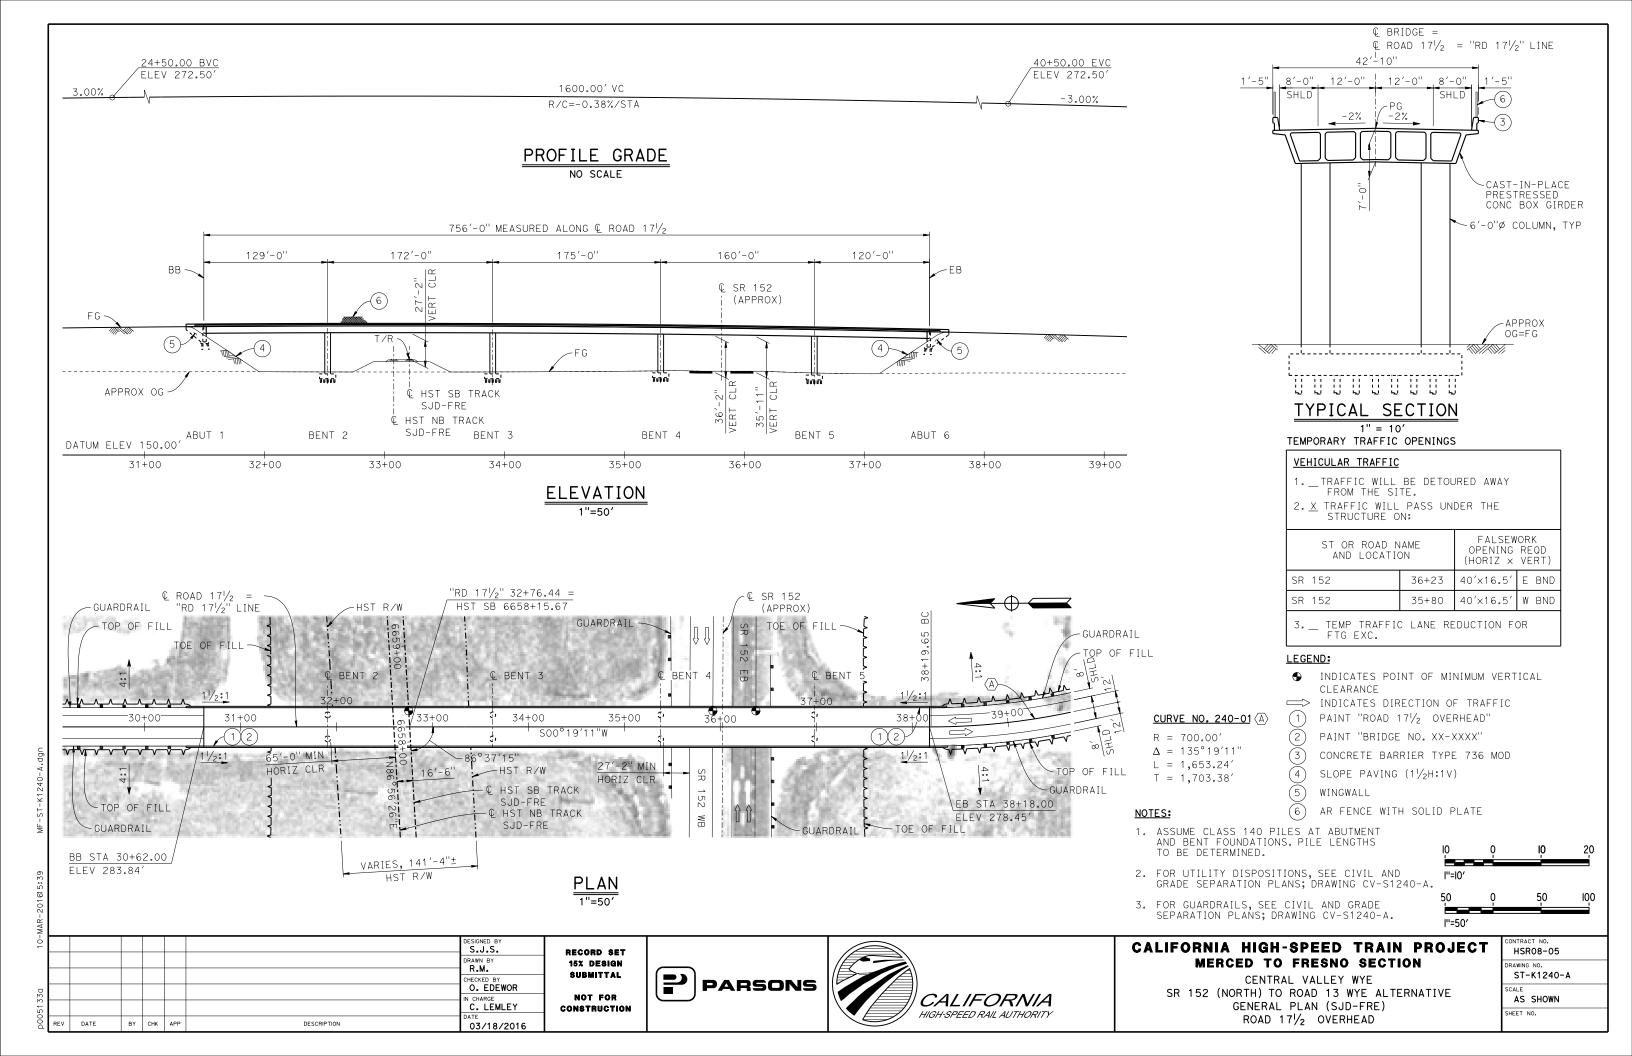


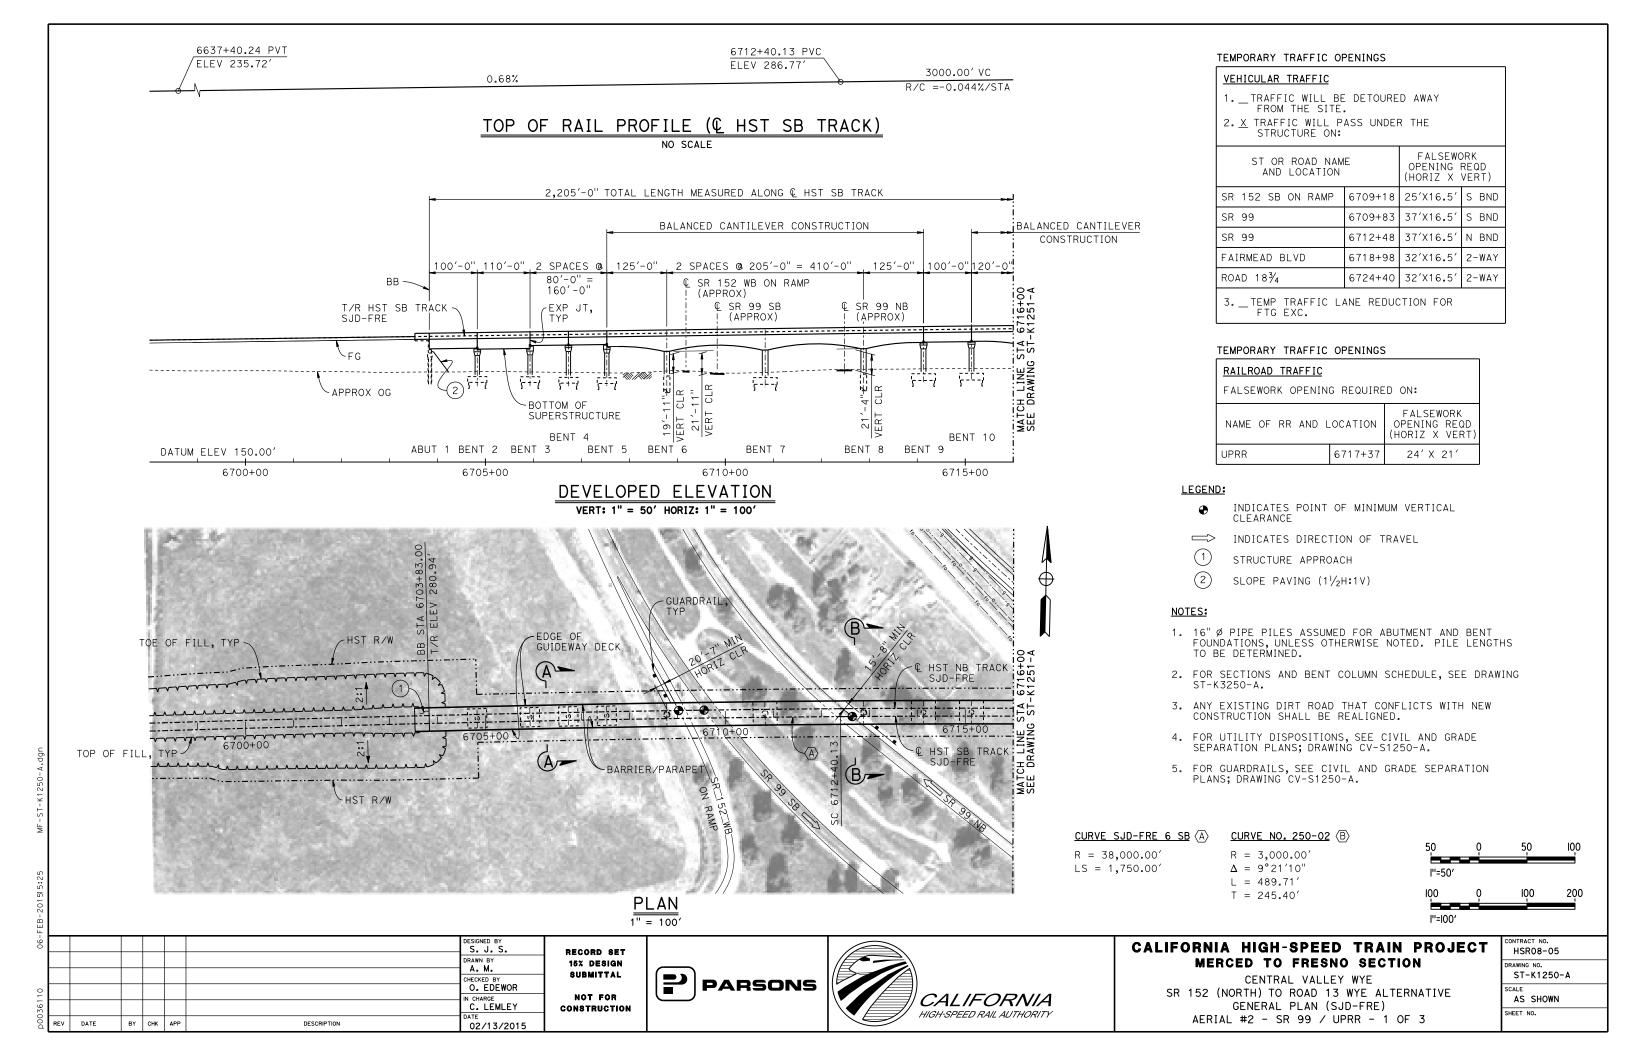


TOP OF RAIL PROFILE (& HST SB TRACK) NO SCALE

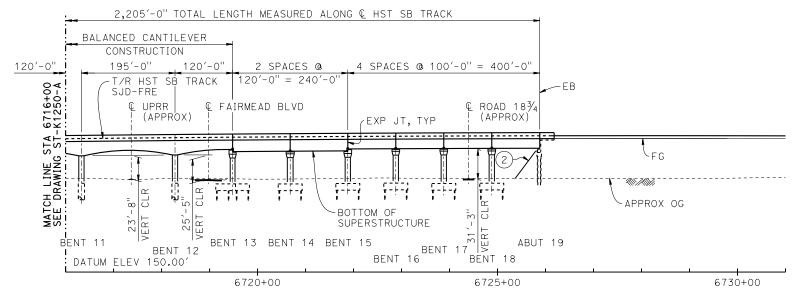

DEVELOPED ELEVATION

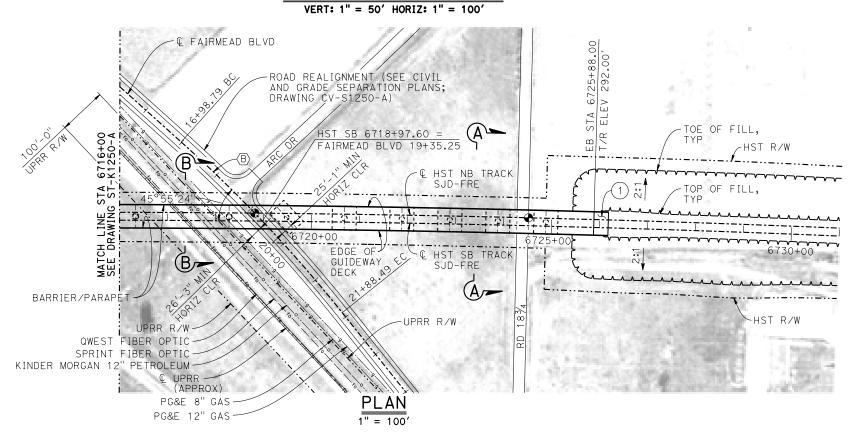

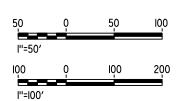

DESIGNED BY
S. J. S.

DRAWN BY
A. M.
CHECKED BY
O. EDEWOR
IN CHARGE
C. LEMLEY
DATE
BY
CHK APP
DESCRIPTION
DESCRIPTION
DESCRIPTION
DATE
03/18/2016

RECORD SET
15% DESIGN
SUBMITTAL
NOT FOR
CONSTRUCTION







CALIFORNIA HIGH-SPEED TRAIN PROJECT MERCED TO FRESNO SECTION

CENTRAL VALLEY WYE
SR 152 (NORTH) TO ROAD 13 WYE ALTERNATIVE
GENERAL PLAN (SJD-FRE)
AERIAL #2 - SR 99 / UPRR - 2 OF 3

| CONTRACT NO. |
|--------------|
| HSR08-05 |
| DRAWING NO. |
| ST-K1251-A |
| SCALE |
| AS SHOWN |
| SHEET NO. |
| |

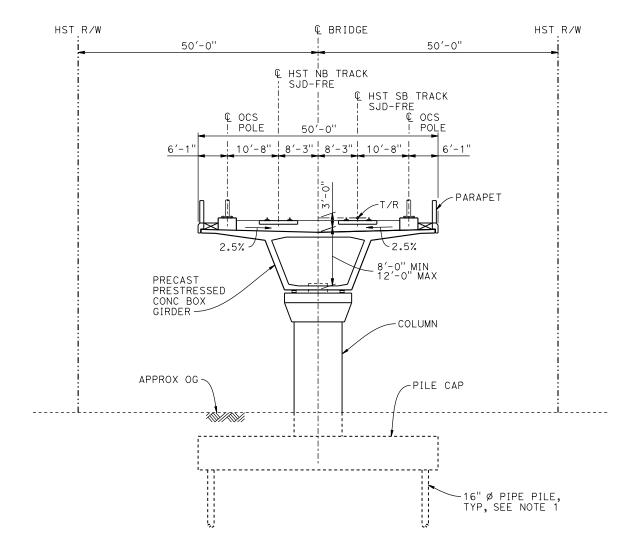

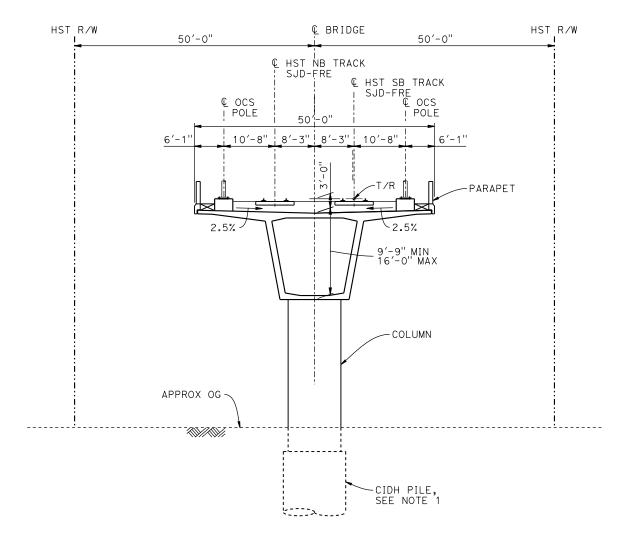


SECTION A-A

| В | ENT COLUMN SCHED | JLE |
|---------|------------------|-----------|
| BENT | COLUMN TYPE | CIDH TYPE |
| 2 - 5 | 9'-0" ø | |
| 6 | 11'-0" Ø | 13'-0" Ø |
| 7 | 12'-0" Ø | |
| 8 | 11'-0" Ø | 13'-0" Ø |
| 9 - 10 | 10'-0" Ø | |
| 11 - 12 | 11'-0" Ø | 13'-0" Ø |
| 13 | 10'-0" Ø | |
| 14 | 12′-0" ø | |
| 15 - 18 | 11'-0" Ø | |

$\frac{\text{SECTION }B-B}{1''=10'}$

NOTES:

- PILE AND DRILLED SHAFT LENGTHS TO BE DETERMINED.
- 2. FOR TRACK SUPERELEVATION DETAILS, SEE ALIGNMENT AND TYPICAL SECTION PLANS; DRAWING TT-BOO51-A.

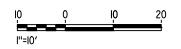

| ij | | | | | | | | |
|-------|-----|------|----|-----|-----|-------------|----------------------|----|
| -90 | | | | | | | DESIGNED BY | R |
| | | | | | | | DRAWN BY | 1 |
| 0 | | | | | | | CHECKED BY O. EDEWOR | |
| _ | | | | | | | IN CHARGE C. LEMLEY | CO |
| p0036 | REV | DATE | BY | снк | APP | DESCRIPTION | 02/13/2015 | |

RECORD SET
15% DESIGN
SUBMITTAL
NOT FOR
CONSTRUCTION








CALIFORNIA HIGH-SPEED TRAIN PROJECT MERCED TO FRESNO SECTION


CENTRAL VALLEY WYE
SR 152 (NORTH) TO ROAD 13 WYE ALTERNATIVE
TYPICAL SECTIONS (SJD-FRE)
AERIAL #2 - SR 99 / UPRR - 3 OF 3

| CONTRACT NO. HSR08-05 | | | | | | |
|--------------------------|--|--|--|--|--|--|
| DRAWING NO. | | | | | | |
| ST-K3250-A | | | | | | |
| SCALE | | | | | | |
| AS SHOWN | | | | | | |
| SHEET NO. | | | | | | |
| | | | | | | |

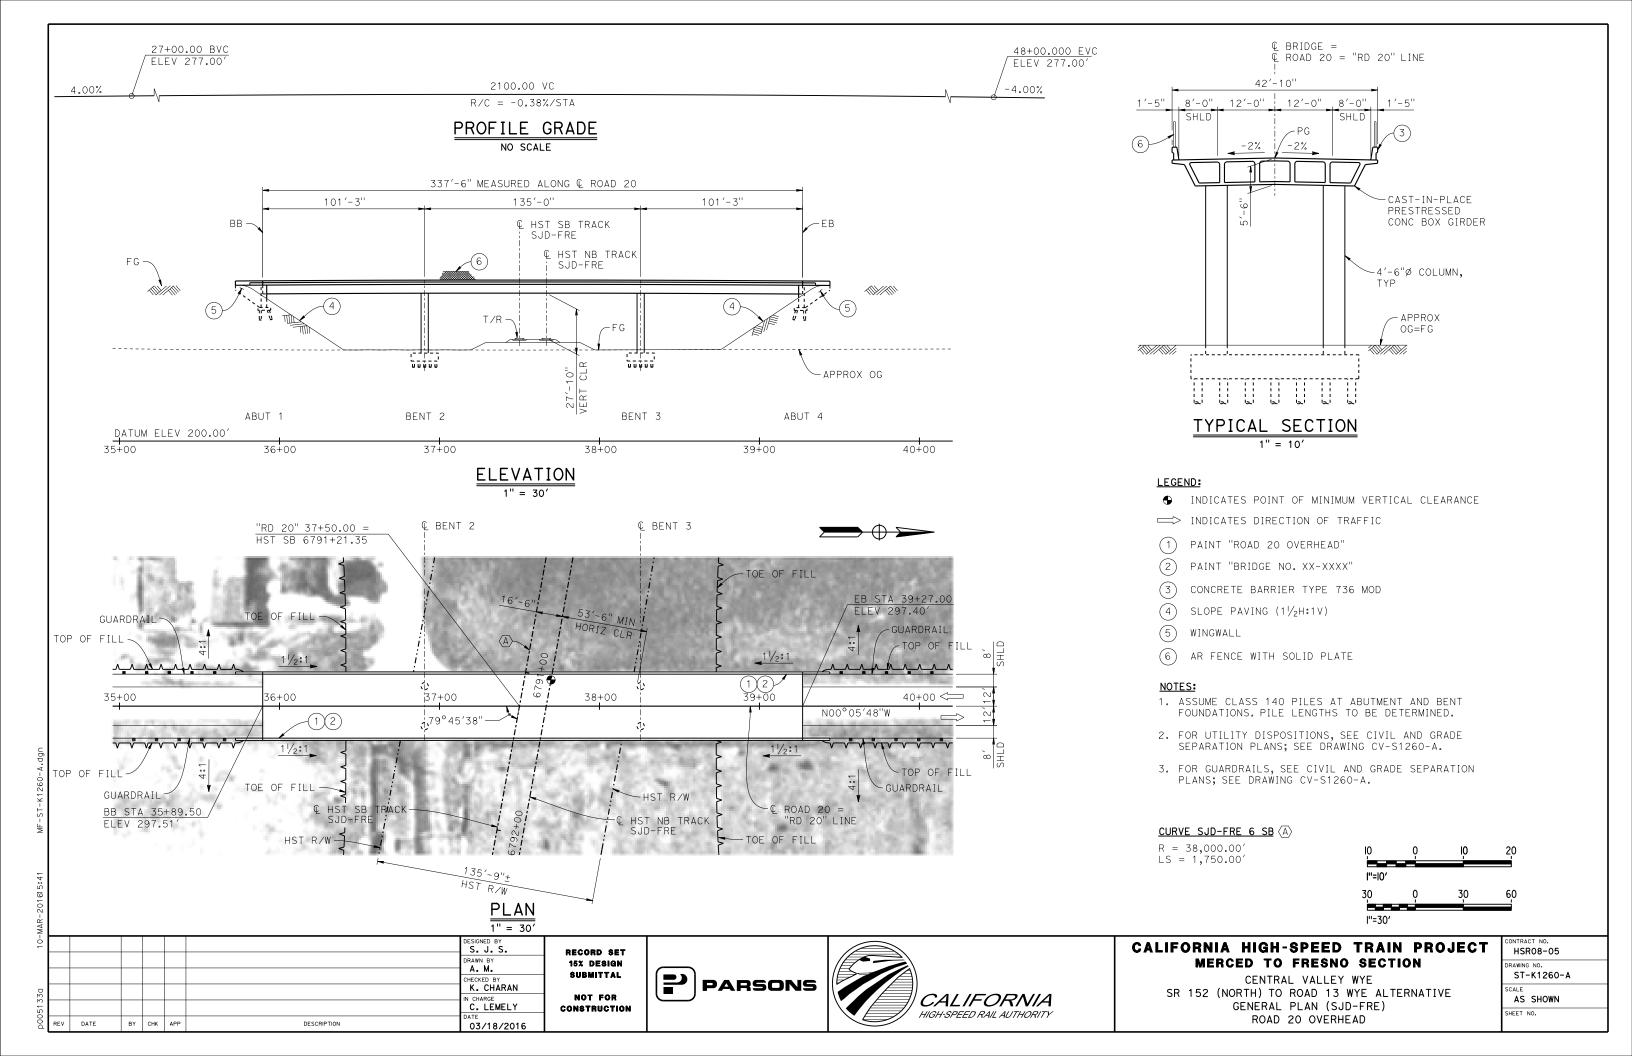

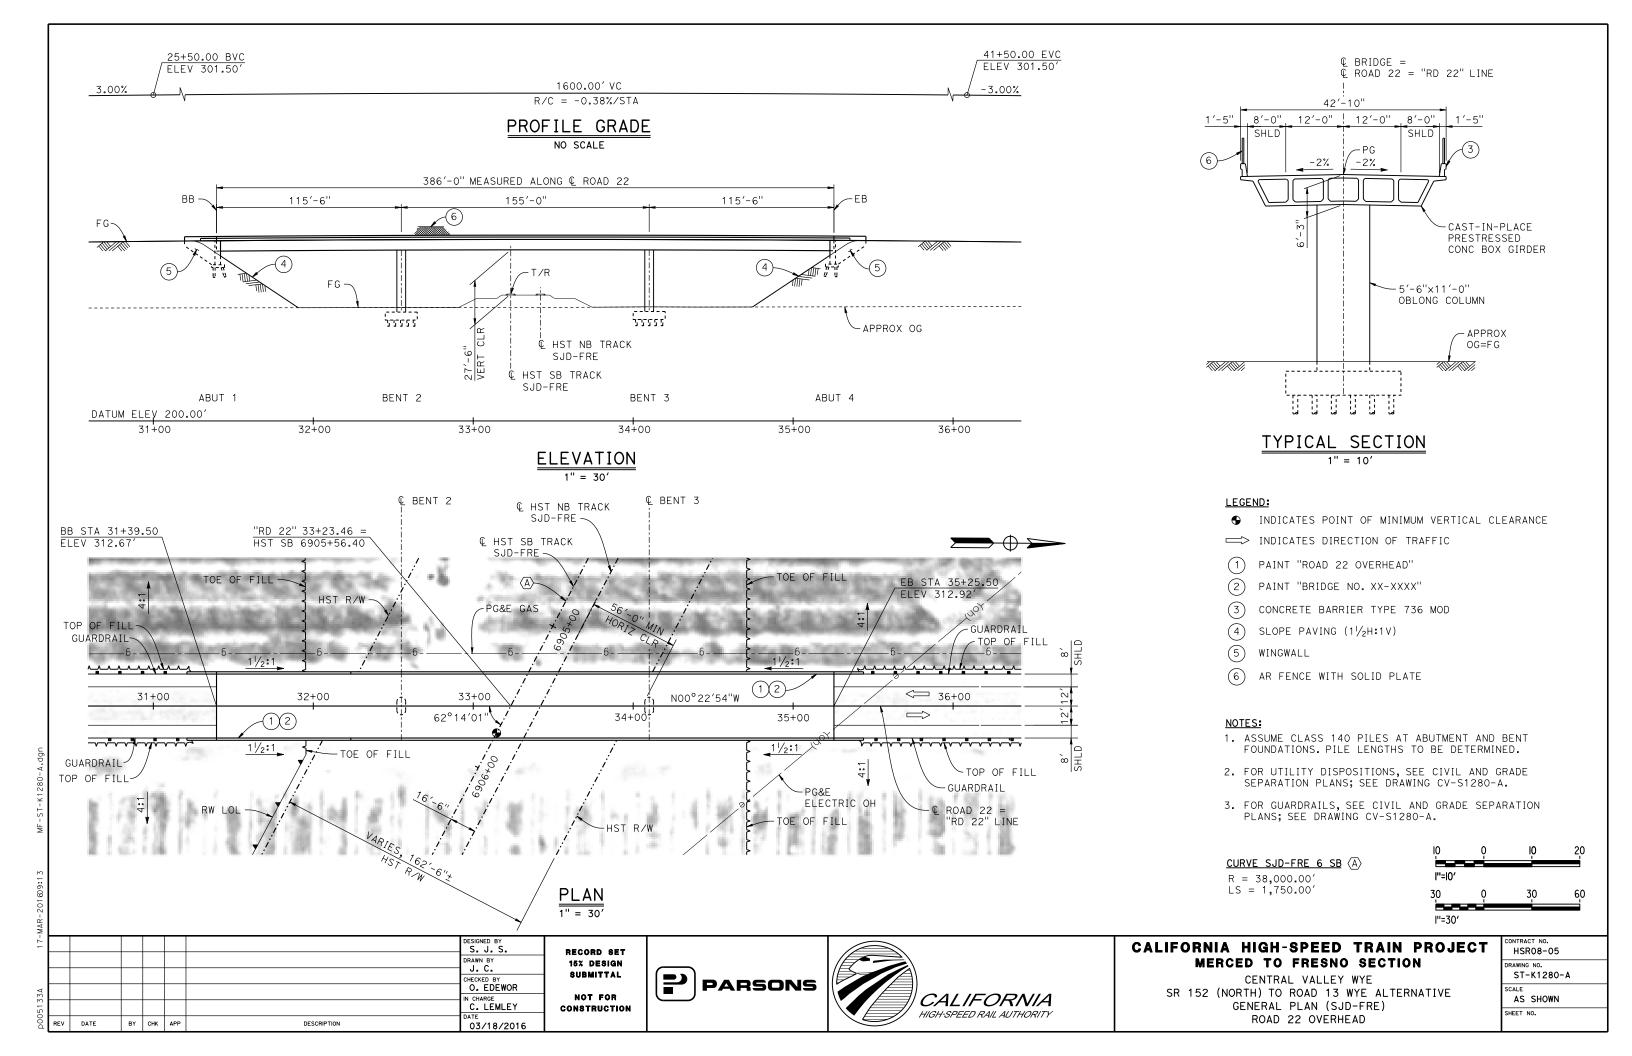

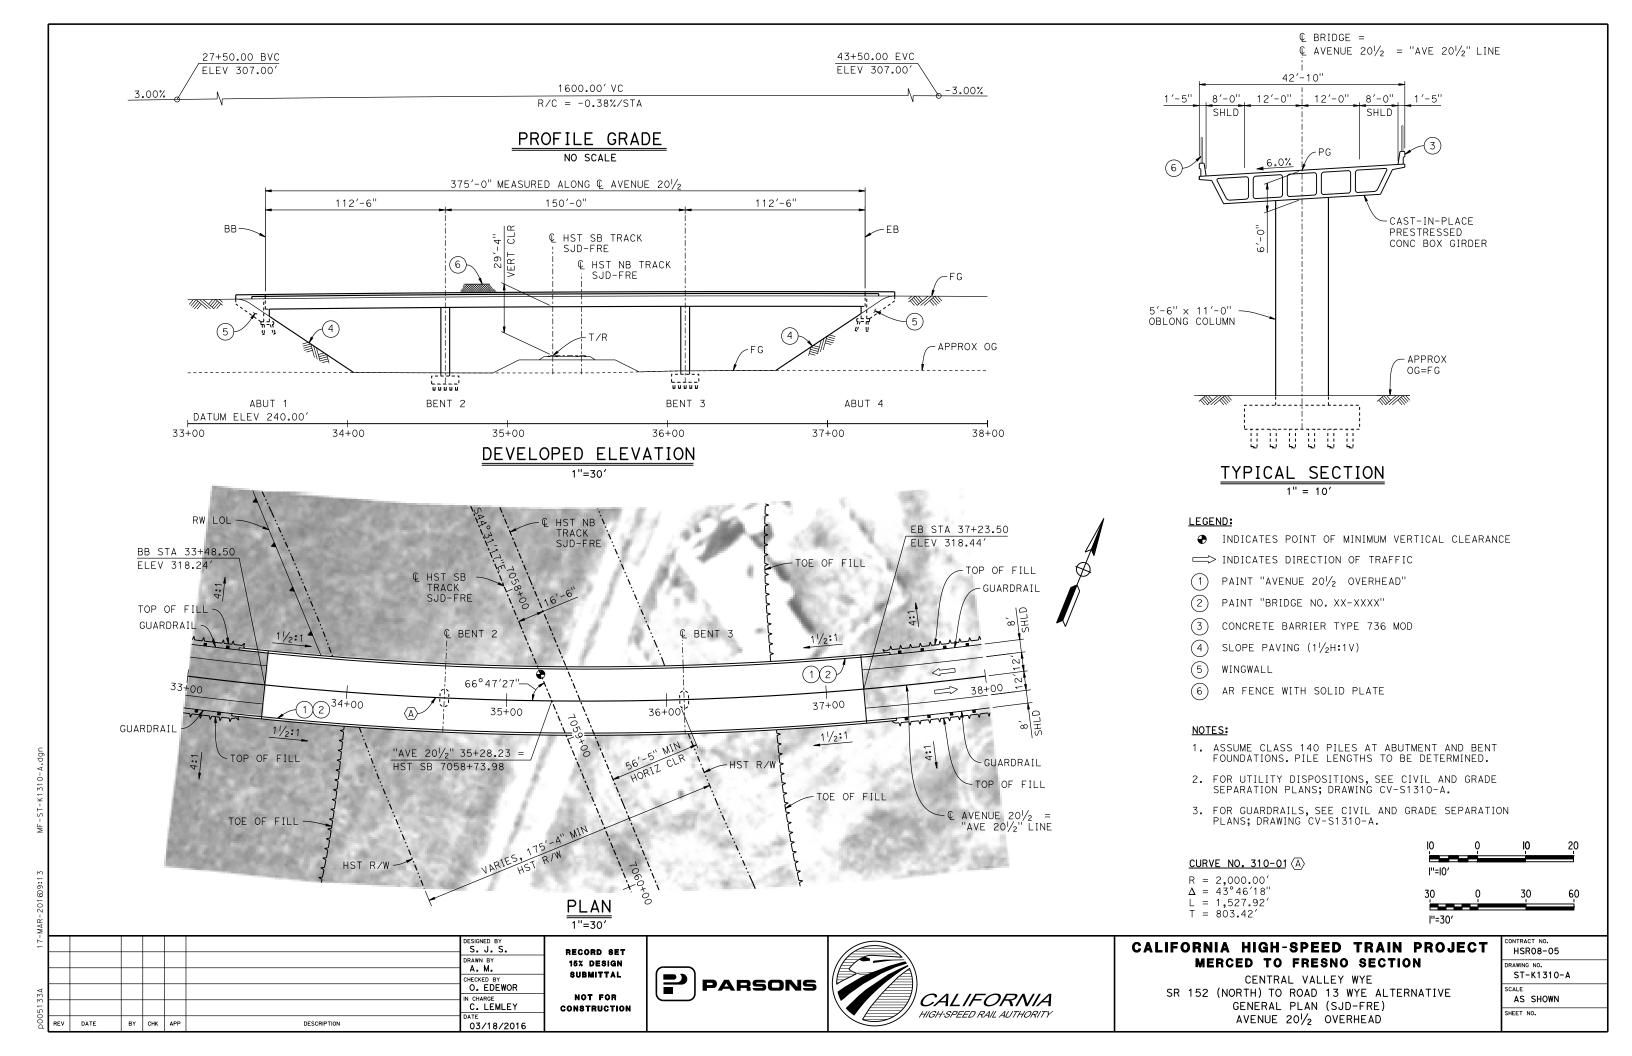

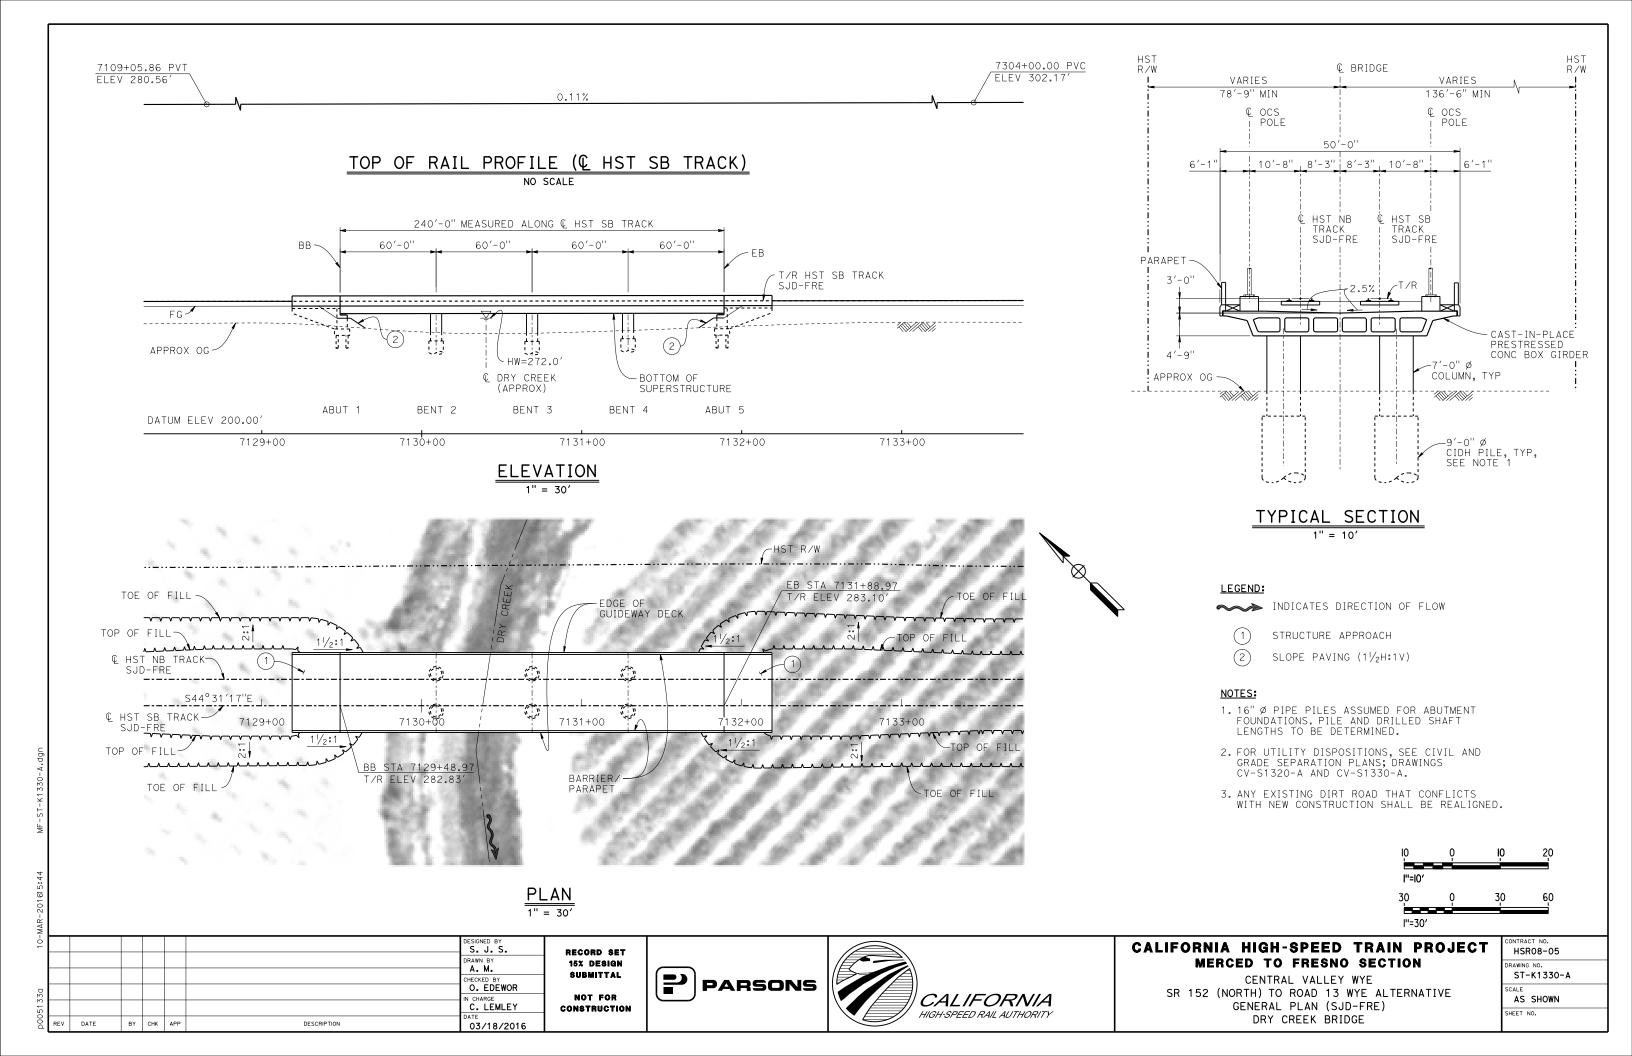


LEGEND: 14984+36.73 PVT INDICATES POINT OF MINIMUM VERTICAL CLEARANCE ELEV 253.44' 1.25% STRUCTURE APPROACH (2) SLOPE PAVING (1/2H:1V) TOP OF RAIL PROFILE (& HST SB TRACK MER-FRE) CURVE MER-FRE 1 SB (A) NO SCALE R = 10,350.00'LS = 1,500.00'7,625'-0" TOTAL LENGTH MEASURED ALONG & HST SB TRACK MER-FRE TEMPORARY TRAFFIC OPENINGS VEHICULAR TRAFFIC 2 SPACES @ 100'-0" 7 SPACES @ 120'-0" = 840'-0" 3 SPACES @ 150'-0'' = 450'-0''13 SPACES @ 120'-0" = 1,560'-0" BB 1. _ TRAFFIC WILL BE DETOURED AWAY = 200'-0' T/R HST SB TRACK FROM THE SITE. C ACCESS ROAD T/R HST NB TRACK MER-FRE ♠ ACCESS ROAD (APPROX) MER-FRE 2. X TRAFFIC WILL PASS UNDER THE BERENDA SLOUGH! (APPROX) STRUCTURE ON: T/R HST SB TRACK EXP JT. (APPROX) SJD-FRE TYP FALSEWORK OPENING REQD (HORIZ X VERT) ST OR ROAD NAME AND LOCATION ۲FG ACCESS ROAD 15001+80 20'X16.5' ? \\\ ----ACCESS ROAD 15006+01 20'X16.5' RAILROAD DR 15066+35 20'X16.5' 2-WAY ACCESS ROAD - BOTTOM OF 15066+75 20'X16.5' BERENDA SLOUGH SUPERSTRUCTURE BRIDGE 3. X TEMP TRAFFIC LANE REDUCTION FOR ABUT 1 BENT 2 BENT 4 BENT 8 BENT 10 BENT 12 BENT 6 BENT 14 BENT 16 FTG EXC. BENT 3 BENT 5 BENT 7 BENT 9 BENT 11 BENT 13 BENT 15 BENT 17 DATUM ELEV 120.00' 14990+00 14995+00 15000+00 15005+00 15010+00 DEVELOPED ELEVATION NOTES: VERT: 1" = 50' HORIZ: 1" = 100' 1.16" Ø PIPE PILES ASSUMED FOR ABUTMENT AND BENT FOUNDATIONS, UNLESS OTHERWISE NOTED. PILE LENGTHS TO BE DETERMINED. ROAD REALIGNMENT (SEE CIVIL AND GRADE 2. FOR SECTIONS AND BENT COLUMN SCHEDULE, SEE SEPARATION PLANS; DRAWINGS ST-K3420-A TO ST-K3422-A. DRAWING CV-S1420-A) 3. ANY EXISTING DIRT ROAD THAT CONFLICTS WITH NEW CONSTRUCTION SHALL BE REALIGNED. SR 152 EE 4. FOR UTILITY DISPOSITIONS, SEE CIVIL AND GRADE SR 152 WB SEPARATION PLANS; DRAWINGS CV-S1420-A AND 15012+00 -K1421-A CV-S1430-A. -HST_R/W BARRIER/PARAPET 5. FOR RETAINING WALLS, SEE CIVIL AND GRADE TOP OF MER-FRE GUIDEWAY DECK SEPARATION PLANS; DRAWINGS CV-S1420-A AND FILL, TYP CV-S1430-A. TCH LINE ST E DRAWING 6. FOR GUARDRAILS, SEE CIVIL AND GRADE SEPARATION PLANS; SEE DRAWINGS CV-S1420-A AND CV-S1430-A. 7. FOR BERENDA SLOUGH BRIDGE GENERAL PLAN AND TYPICAL SECTION, SEE DRAWINGS ST-K1220-A AND 24995+00 -S89°30′27"W 25000+00 25010+00 ST-K3220-A. 8. FOR RAILROAD DRIVE UNDERPASS (HST NB) GENERAL PLAN AND TYPICAL SECTION, SEE DRAWING TOE OF FILL, ST-K1430-A. C HST NB TRACK -C HST NB TRACK -Carly Transport Street and Authorities and BERENDA SLOUGH SJD-FRE BRIDGE **©** HST SB TRACK CLOSURE PLAN 200 (SEE CIVIL AND GRADE SEPARATION PLANS; 1'' = 100DRAWING CV-S1420-A) l"=100' R. MOTHE CALIFORNIA HIGH-SPEED TRAIN PROJECT HSR08-05 RECORD SET MERCED TO FRESNO SECTION 15% DESIGN RAWING NO. Ĵ. KIDWELL SUBMITTAL ST-K1420-A CENTRAL VALLEY WYE O. EDEWOR **PARSONS** SR 152 (NORTH) TO ROAD 13 WYE ALTERNATIVE NOT FOR CALIFORNIA AS SHOWN C. LEMLEY GENERAL PLAN (MER-FRE) CONSTRUCTION HIGH-SPEED RAIL AUTHORITY SHEET NO. AERIAL #3 - SOUTHBOUND OVER HST MAINLINE - 1 OF 6 DATE BY CHK APP DESCRIPTION 02/13/2015


15037+64.00 PVT

TOP OF RAIL PROFILE (HST SB TRACK MER-FRE)

NO SCALE

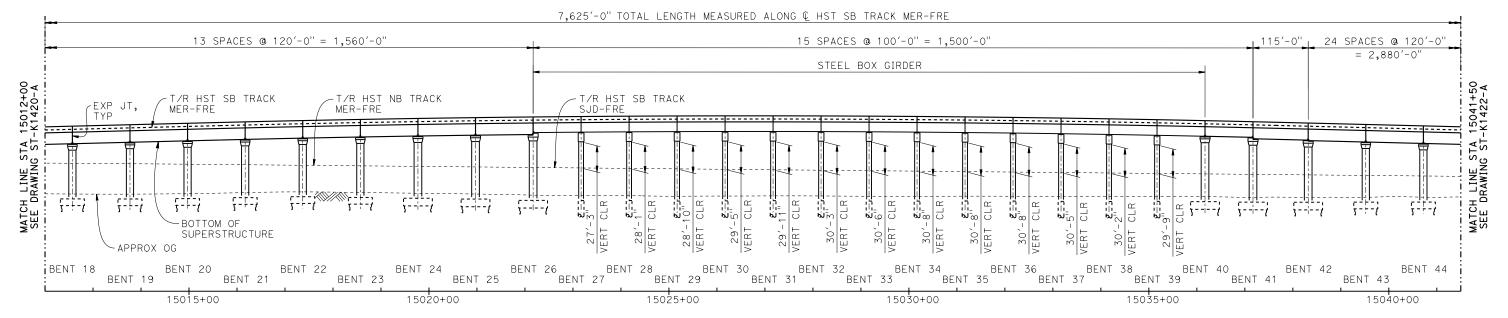

DEVELOPED ELEVATION VERT: 1" = 50' HORIZ: 1" = 100'

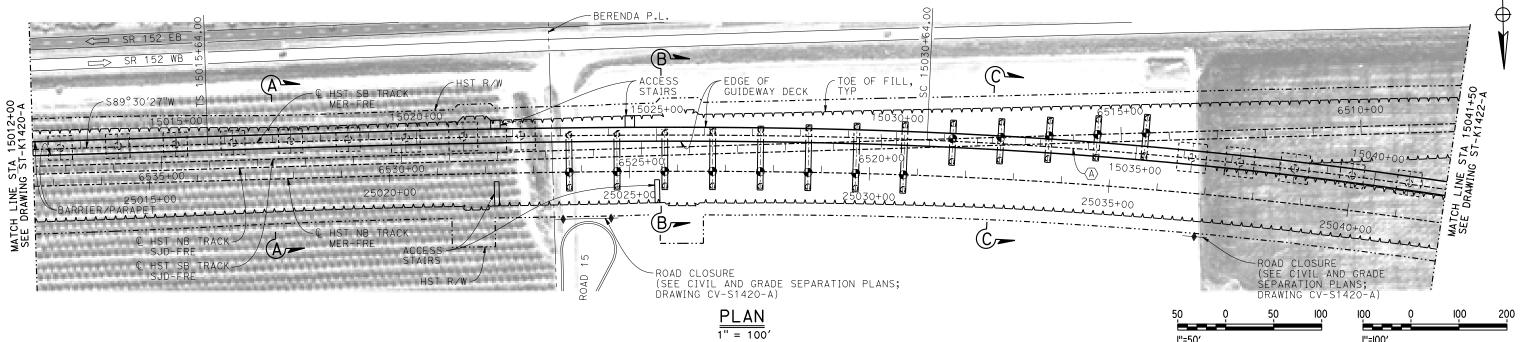

| Σ | | | | | | | | |
|-------|-----|------|----|-----|-----|-------------|----------------------|---|
| 9 | | | | | | | DESIGNED BY R. MOTHE | |
| | | | | | | | DRAWN BY J. KIDWELL | İ |
| | | | | | | | CHECKED BY O. EDEWOR | İ |
| 33d | | | | | | | IN CHARGE | İ |
| poopl | | | | | | | C. LEMLEY DATE | İ |
| 2 | REV | DATE | BY | CHK | APP | DESCRIPTION | 05/08/2015 | ı |

RECORD SET
15% DESIGN
SUBMITTAL
NOT FOR
CONSTRUCTION






CALIFORNIA HIGH-SPEED TRAIN PROJECT MERCED TO FRESNO SECTION


CENTRAL VALLEY WYE
SR 152 (NORTH) TO ROAD 13 WYE ALTERNATIVE
GENERAL PLAN (MER-FRE)
AERIAL #3 - SOUTHBOUND OVER HST MAINLINE - 2 OF 6

| CONTRACT NO. |
|--------------|
| HSR08-05 |
| DRAWING NO. |
| ST-K1421-A |
| SCALE |
| AS SHOWN |
| SHEET NO. |

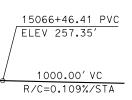


TOP OF RAIL PROFILE (@ HST SB TRACK MER-FRE)

NO SCALE

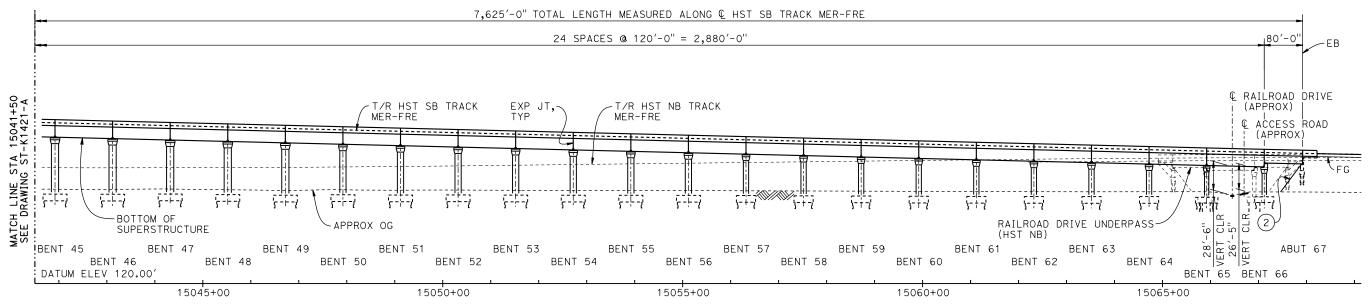

DEVELOPED ELEVATION

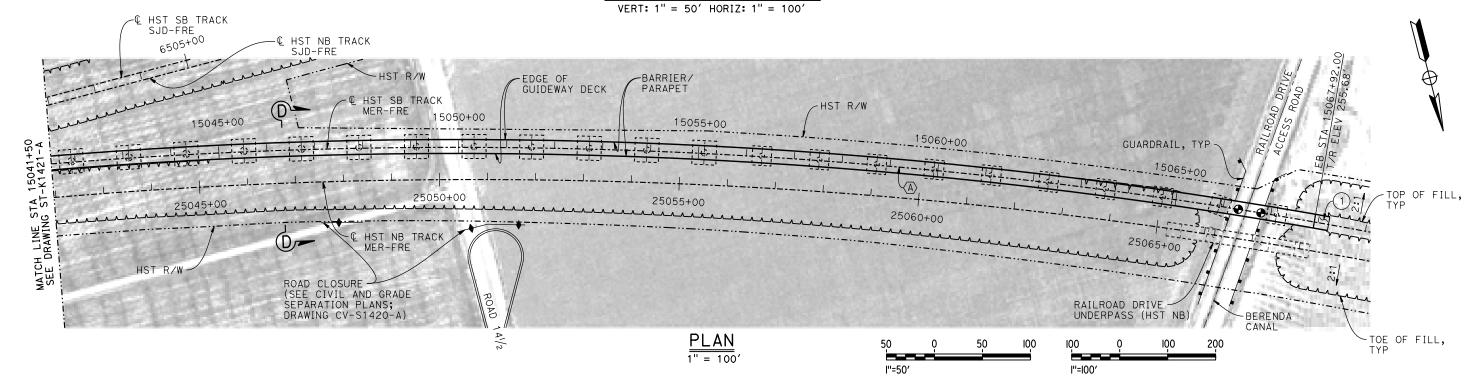

| Į. | | | | | | | | |
|-------|-----|------|----|-----|-----|-------------|----------------------|-------------------------|
| -90 | | | | | | | DESIGNED BY R. MOTHE | RECORD SET |
| | | | | | | | DRAWN BY J. KIDWELL | 15% DESIGN |
| _ | | | | | | | CHECKED BY O. EDEWOR | SUBMITTAL |
| 36110 | | | | | | | IN CHARGE C. LEMLEY | NOT FOR CONSTRUCTION |
| p003 | REV | DATE | BY | СНК | APP | DESCRIPTION | DATE 02/13/2015 | - CONSTRUCTION |


PARSONS



CALIFORNIA HIGH-SPEED TRAIN PROJECT MERCED TO FRESNO SECTION

CENTRAL VALLEY WYE SR 152 (NORTH) TO ROAD 13 WYE ALTERNATIVE GENERAL PLAN (MER-FRE) AERIAL #3 - SOUTHBOUND OVER HST MAINLINE - 3 OF 6

| | HSR08-05 |
|---|---------------------------|
| | DRAWING NO. ST-K1422-A |
| | AS SHOWN |
| ı | SHEET NO. |

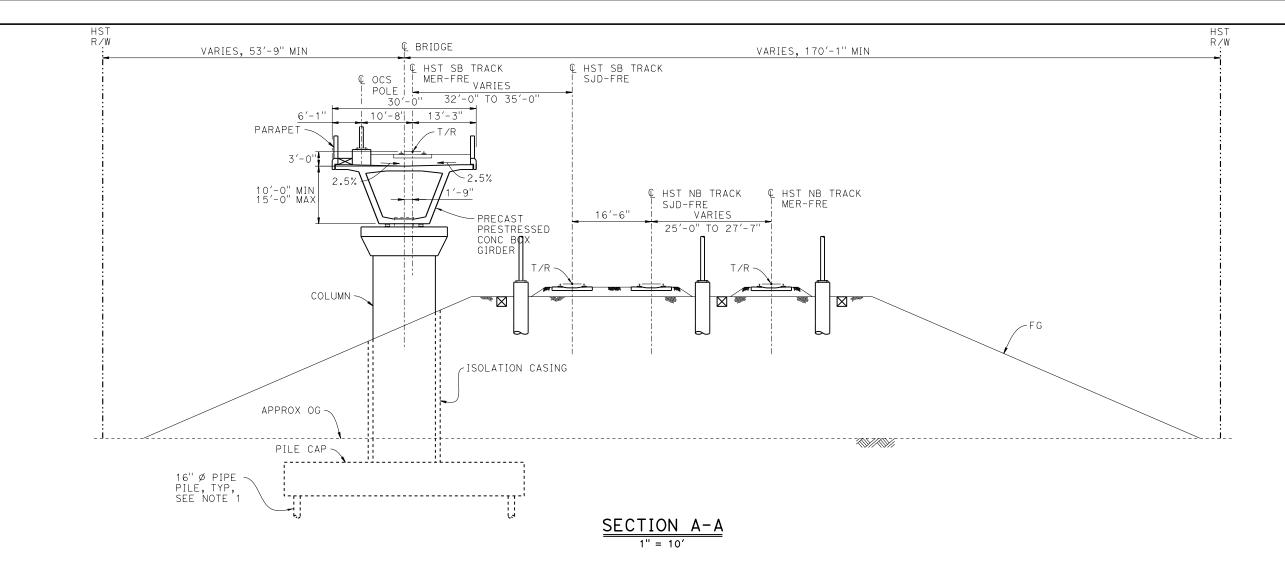

| BE | | | |
|---------|--------------|-----------|---------|
| BENT | COLUMN TYPE | CIDH TYPE | "A" |
| 2 - 4 | 9'-0" Ø | 11'-0" Ø | |
| 5 - 8 | 11'-0" Ø | 13'-0" Ø | |
| 9 | 12'-0" Ø | | |
| 10 - 11 | 13'-0" Ø | | |
| 12 | 12'-0" Ø | | |
| 13 | 11'-0" Ø | 13'-0" Ø | |
| 14 - 16 | 13'-0" Ø | | |
| 17 - 23 | 15'-0" Ø | | |
| 24 - 26 | 16'-0" ø | | |
| 27 - 28 | 2 - 10'-0" Ø | | 108'-0" |
| 29 | 2 - 10'-0" Ø | | 110'-0" |
| 30 | 2 - 10'-0" Ø | | 113′-0" |

| | BENT COLUMN SCHEDULE | | | | |
|---------|----------------------|-----------|---------|--|--|
| BENT | COLUMN TYPE | CIDH TYPE | "A" | | |
| 31 | 2 - 10'-0" Ø | | 117′-0" | | |
| 32 | 2 - 10'-0" Ø | | 121'-0" | | |
| 33 | 2 - 10'-0" Ø | | 127′-0" | | |
| 34 | 2 - 10'-0" Ø | | 133′-0" | | |
| 35 - 39 | 2 - 10'-0" Ø | | 78'-0" | | |
| 40 - 42 | 16'-0" Ø | | | | |
| 43 - 49 | 15'-0" Ø | | | | |
| 50 - 56 | 13'-0" Ø | | | | |
| 57 - 64 | 11'-0" Ø | | | | |
| 65 - 66 | 9'-0" Ø | | | | |

- 1. PILE LENGTHS TO BE DETERMINED.
- 2. FOR TRACK SUPERELEVATION DETAILS, SEE ALIGNMENT AND TYPICAL SECTION PLANS; DRAWING TT-B0054-A.



| - | | | | | | | DESIGNED BY R. MOTHE | |
|---|-----|------|----|-----|-----|-------------|----------------------|-----|
| | | | | | | | DRAWN BY J. KIDWELL | 1 |
| | | | | | | | CHECKED BY | 1 |
| 3 | | | | | | | O. EDEWOR IN CHARGE | |
| 5 | | | | | | | C. LEMLEY | _ c |
| , | REV | DATE | BY | СНК | APP | DESCRIPTION | 05/08/2015 | |

RECORD SET
15% DESIGN
SUBMITTAL
NOT FOR
CONSTRUCTION








CALIFORNIA HIGH-SPEED TRAIN PROJECT MERCED TO FRESNO SECTION


CENTRAL VALLEY WYE
SR 152 (NORTH) TO ROAD 13 WYE ALTERNATIVE
TYPICAL SECTION (MER-FRE)
AERIAL #3 - SOUTHBOUND OVER HST MAINLINE - 4 OF 6


| CONTRACT NO. |
|--------------|
| HSR08-05 |
| DRAWING NO. |
| ST-K3420-A |
| SCALE |
| AS SHOWN |
| SHEET NO. |
| |

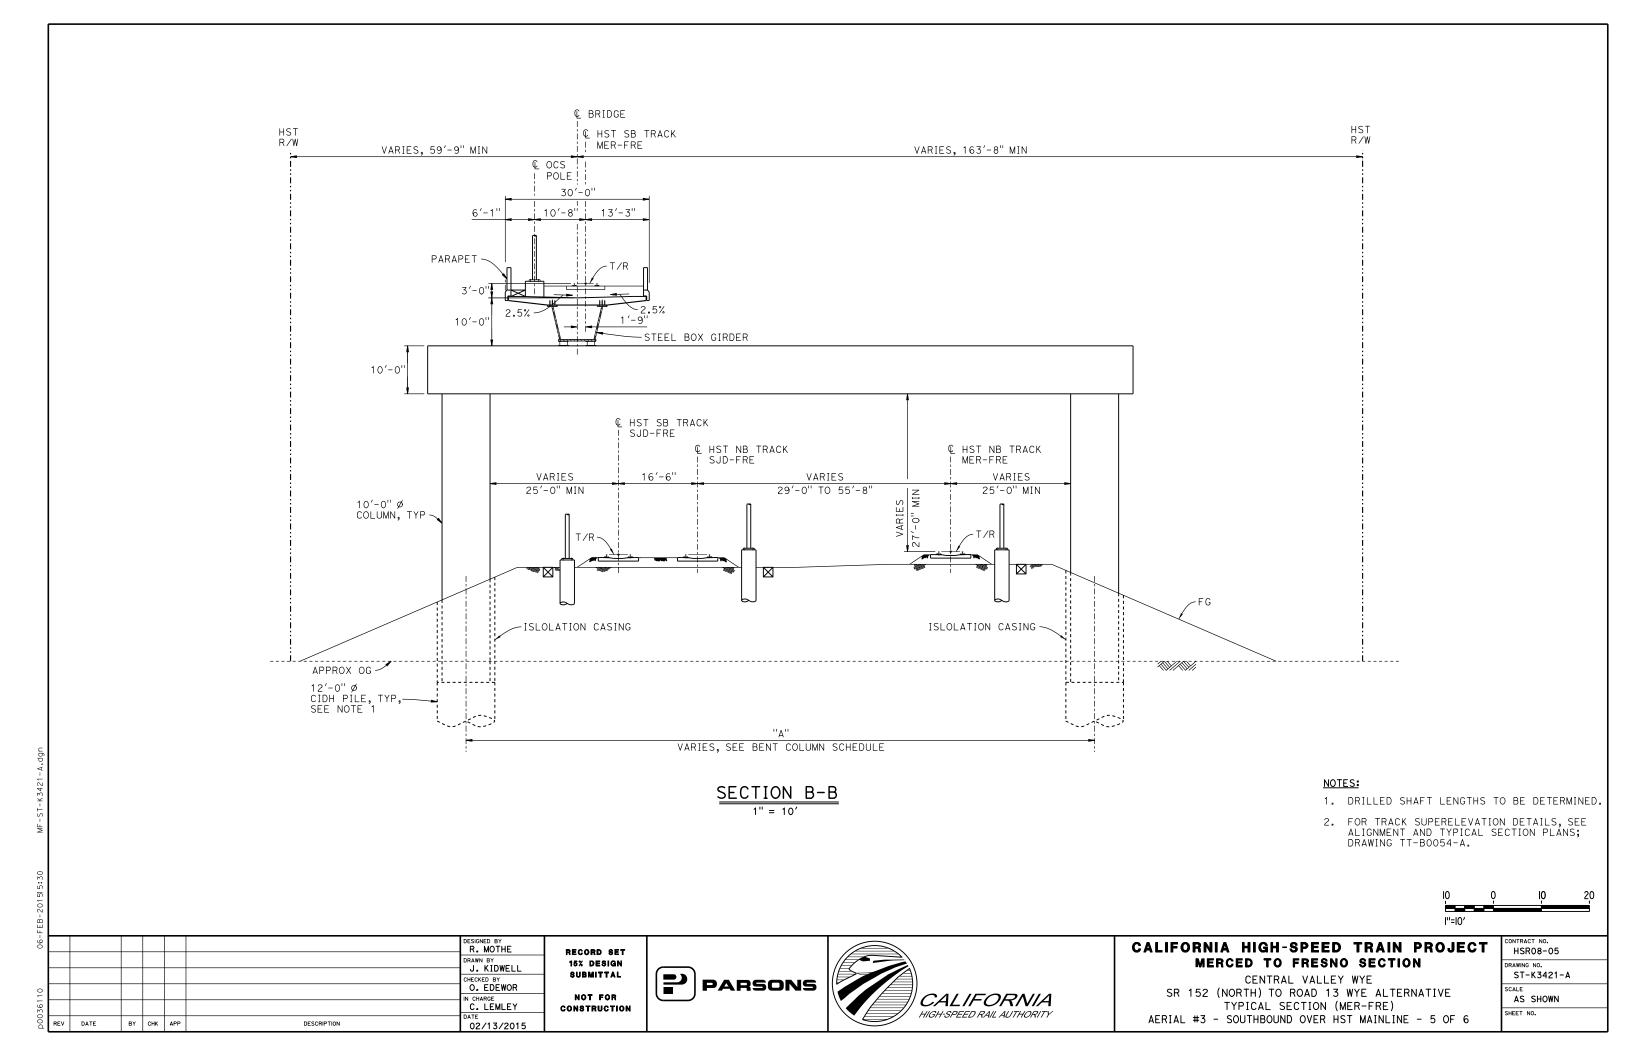


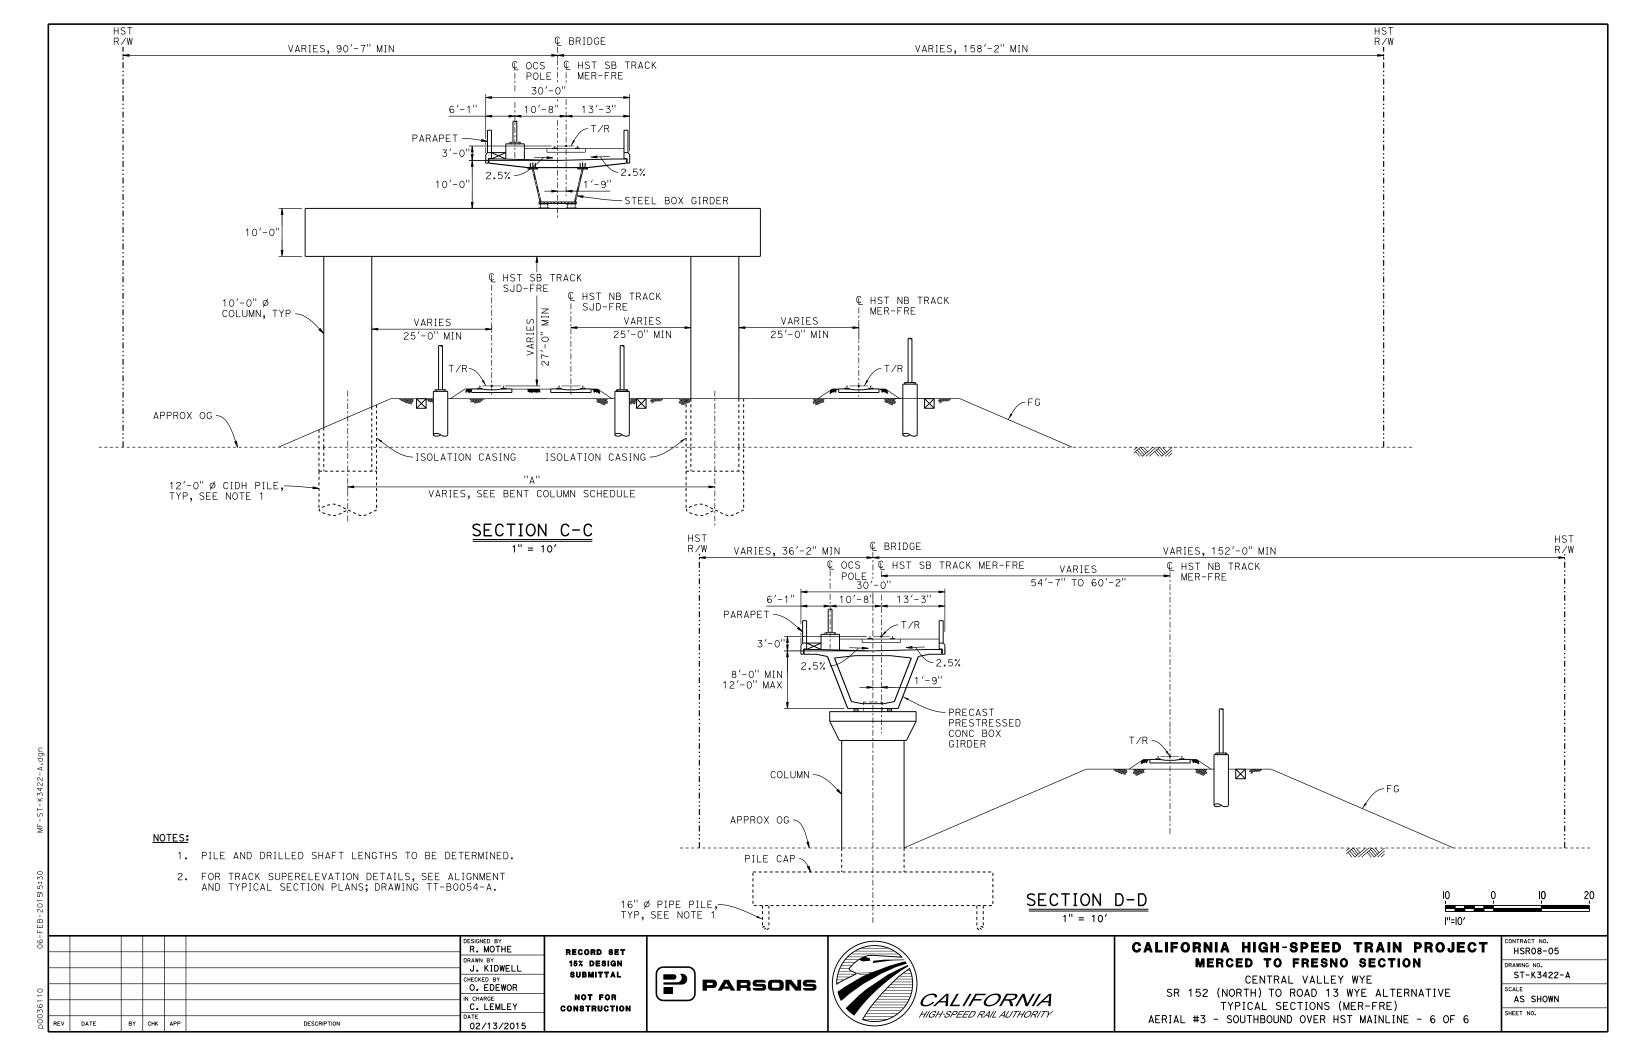


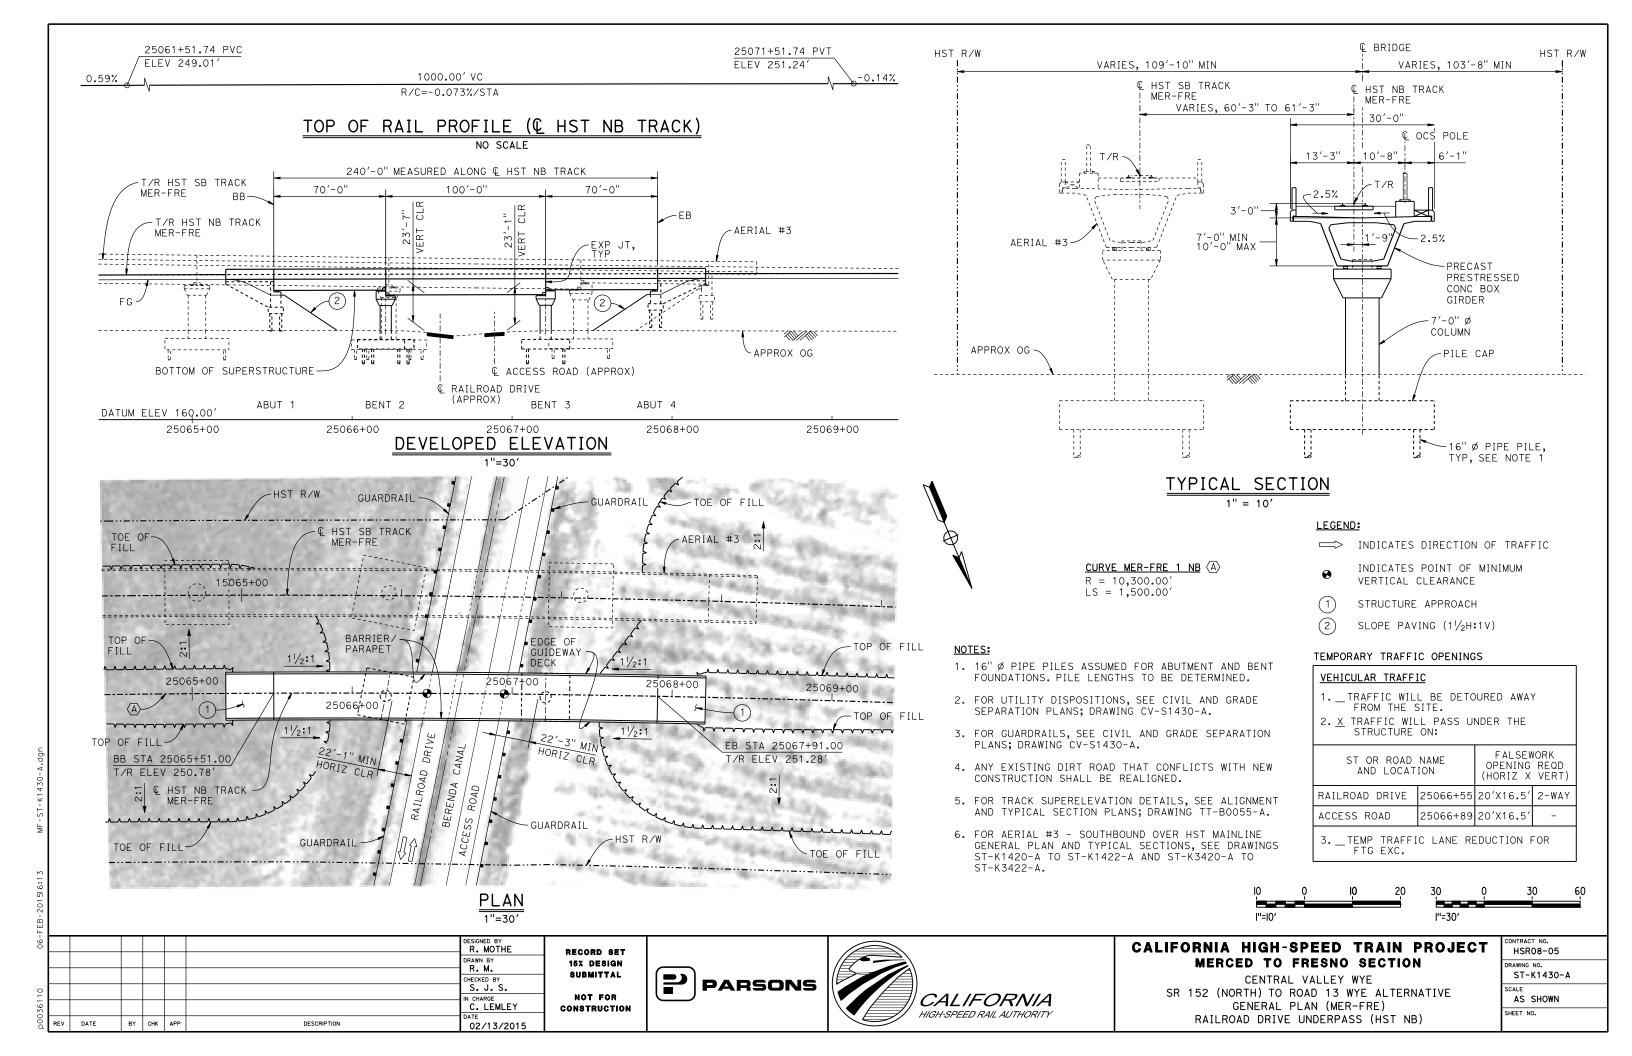

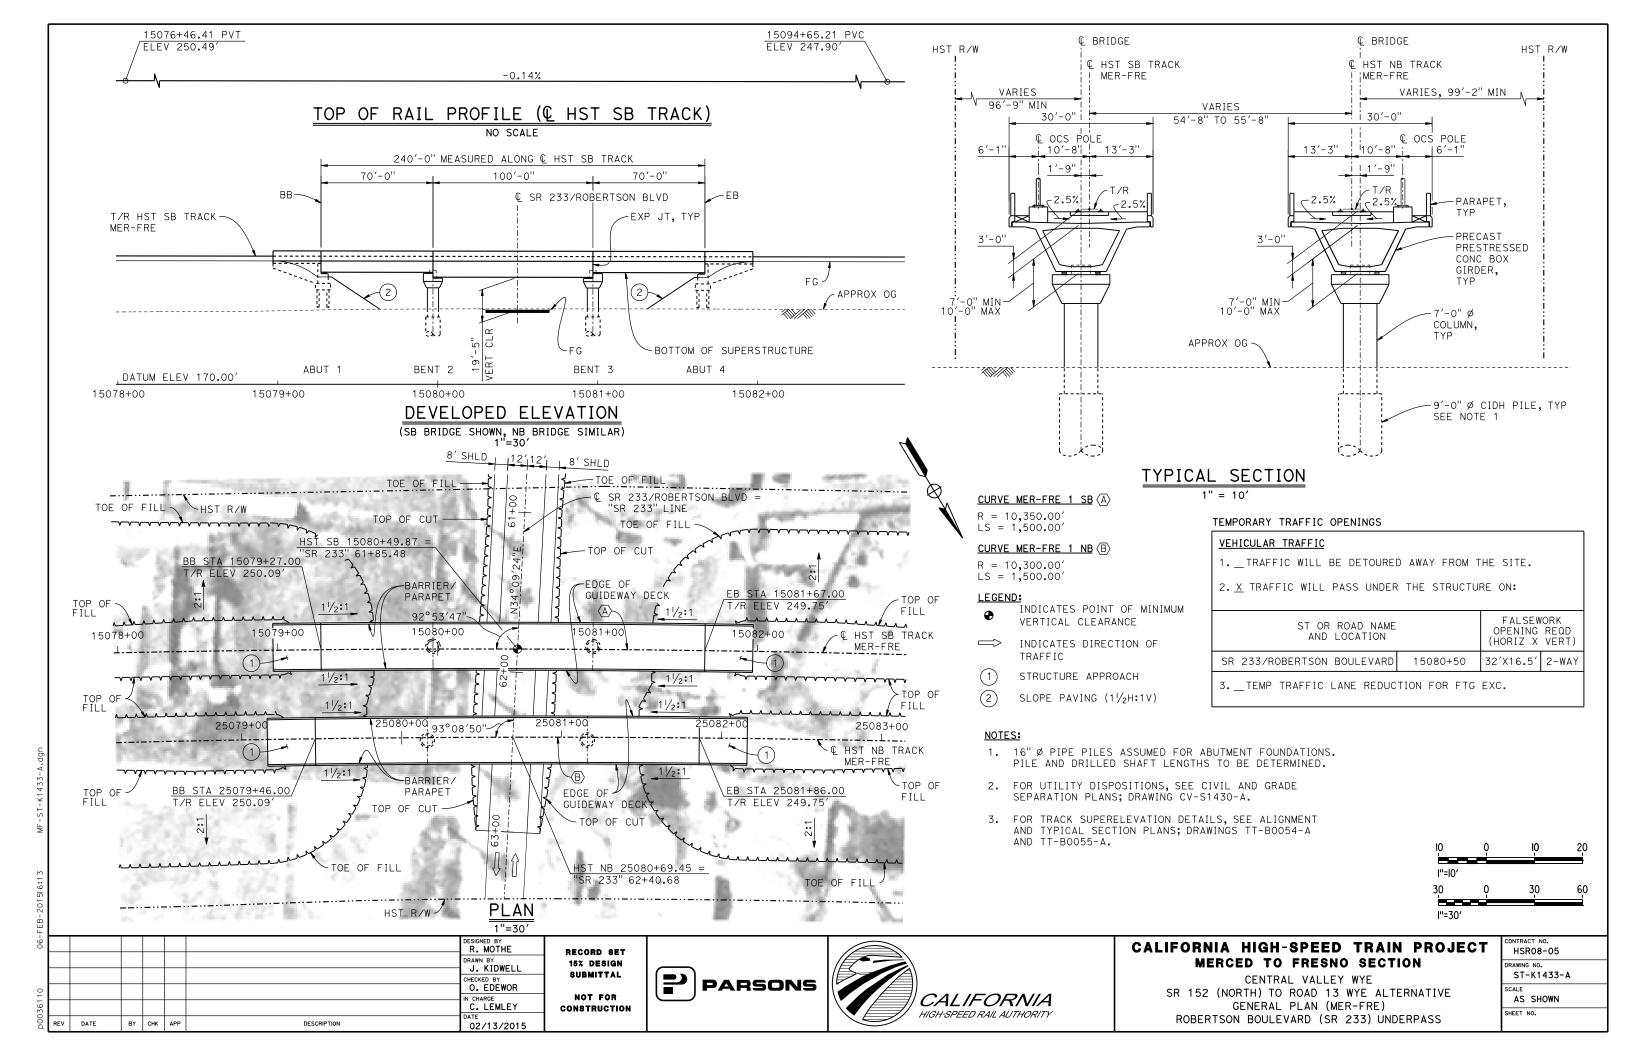

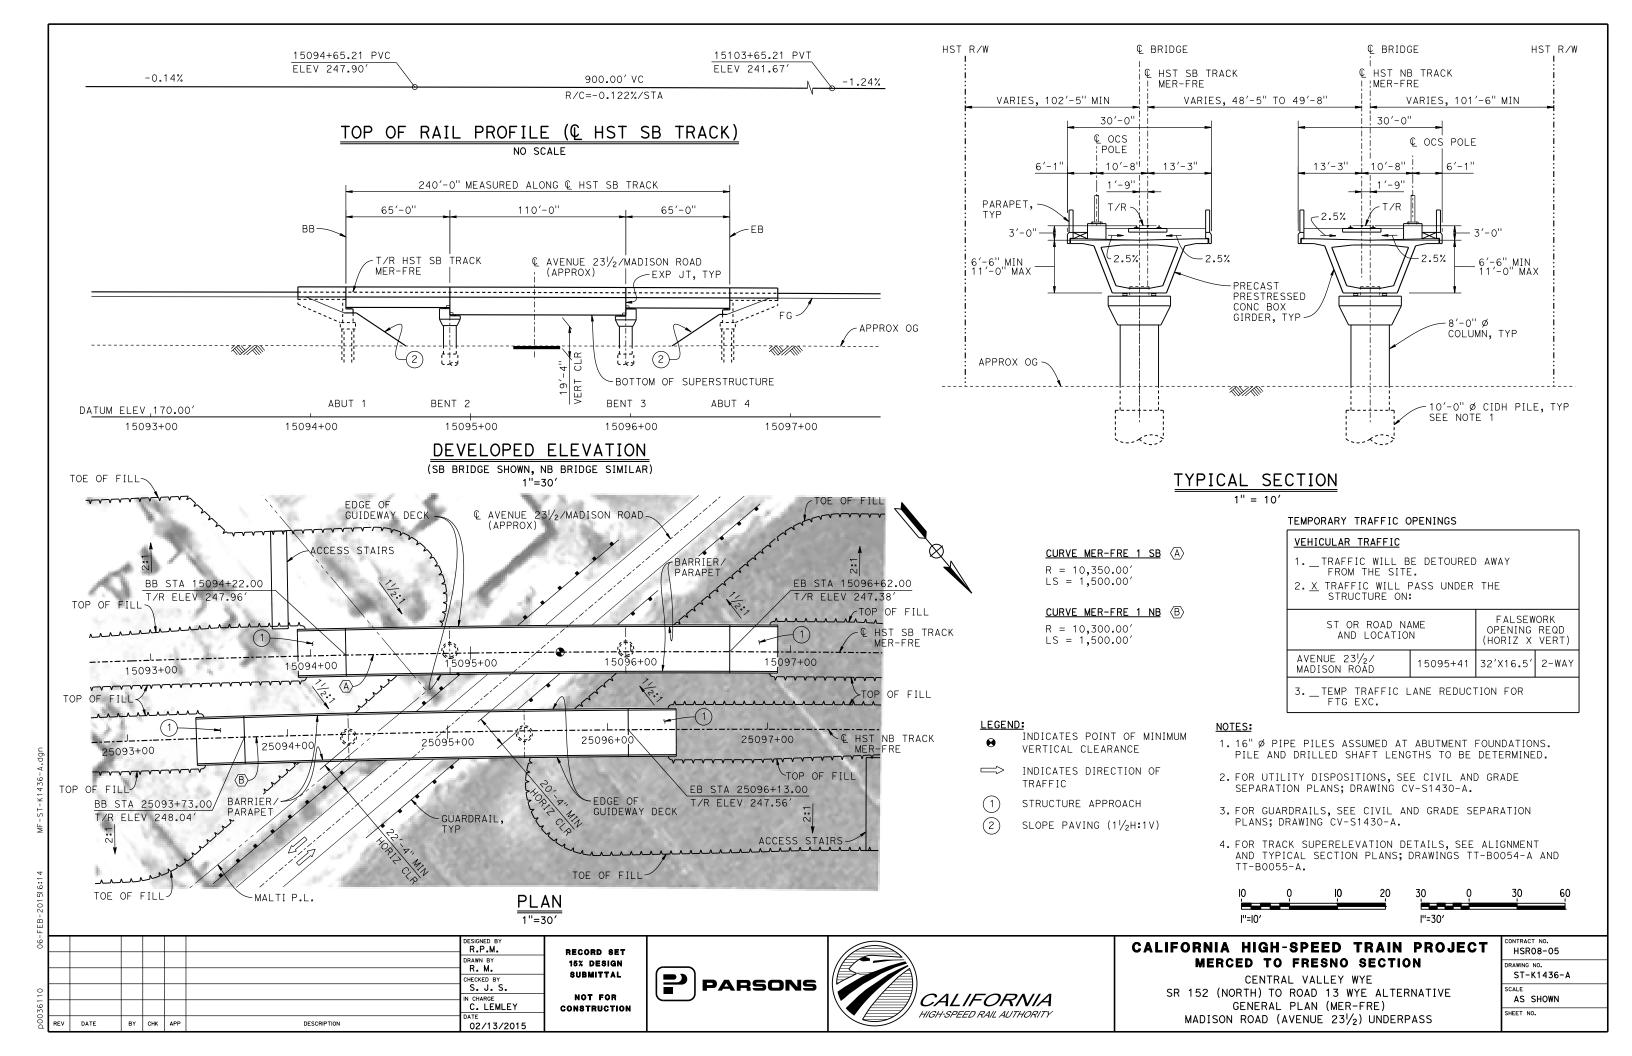

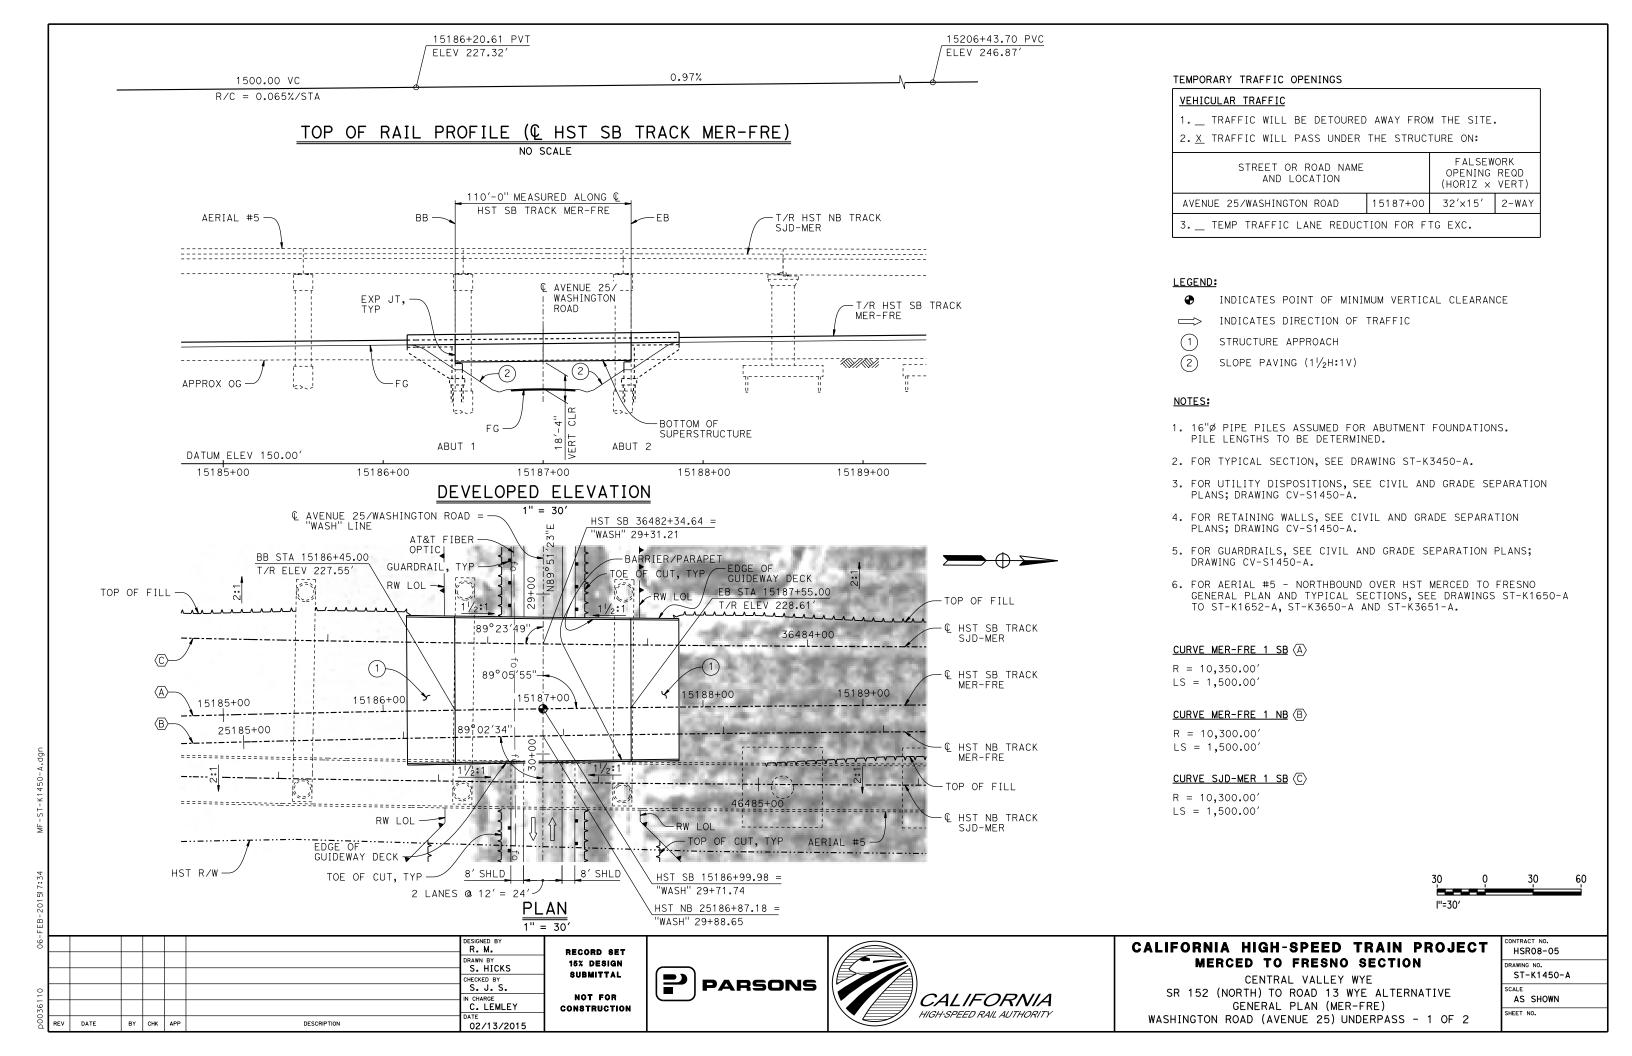

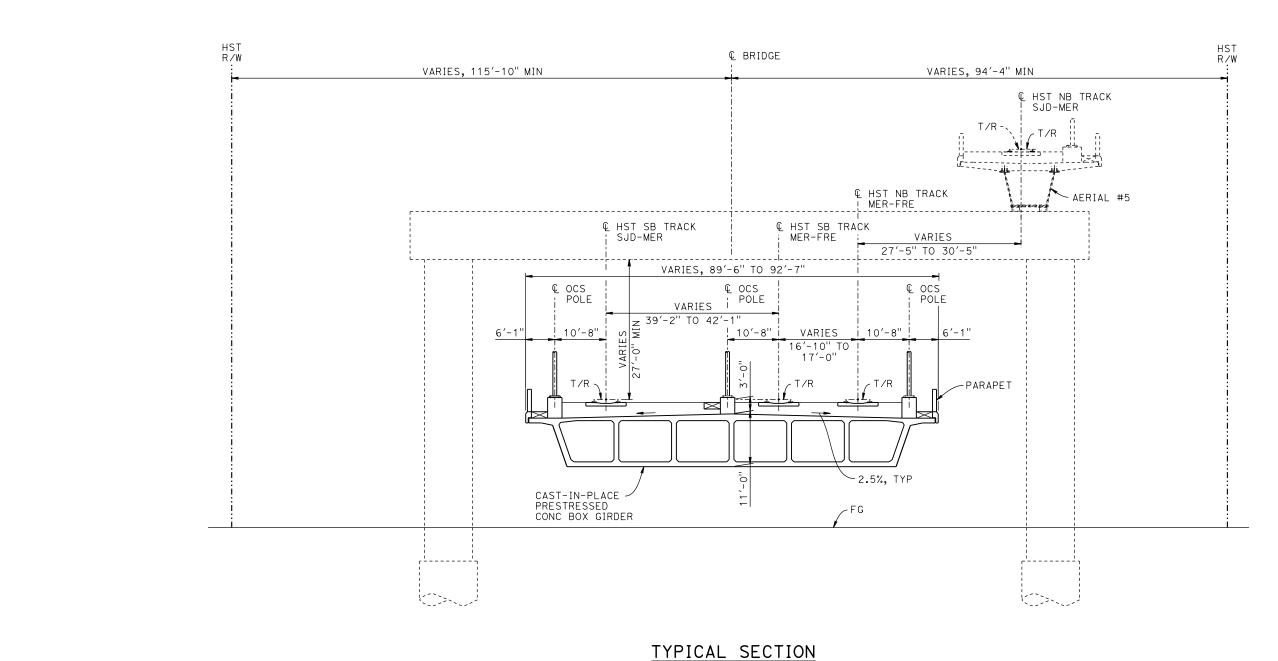

1. FOR TRACK SUPERELEVATION DETAILS, SEE ALIGNMENT AND TYPICAL SECTION PLANS; DRAWINGS TT-B0054-A TO TT-B0056-A.



| F | Щ, | | | | | | | |
|-----|-----|------|----|-----|-----|-------------|-------------------|-----|
| 90 | | | | | | | DESIGNED BY R. M. | RE |
| | | | | | | | DRAWN BY S. HICKS | 15 |
| | | | | | | | CHECKED BY | 8 |
| 110 | | | | | | | IN CHARGE | |
| 036 | | | | | | | C. LEMLEY DATE | CON |
| о́d | REV | DATE | BY | CHK | APP | DESCRIPTION | 02/13/2015 | |

RECORD SET
15% DESIGN
SUBMITTAL
NOT FOR
CONSTRUCTION







CALIFORNIA HIGH-SPEED TRAIN PROJECT MERCED TO FRESNO SECTION

CENTRAL VALLEY WYE
SR 152 (NORTH) TO ROAD 13 WYE ALTERNATIVE
TYPICAL SECTION (MER-FRE)
WASHINGTON ROAD (AVENUE 25) UNDERPASS - 2 OF 2

| CONTRACT NO. |
|--------------|
| HSR08-05 |
| DRAWING NO. |
| ST-K3450-A |
| SCALE |
| AS SHOWN |
| SHEET NO. |
| |

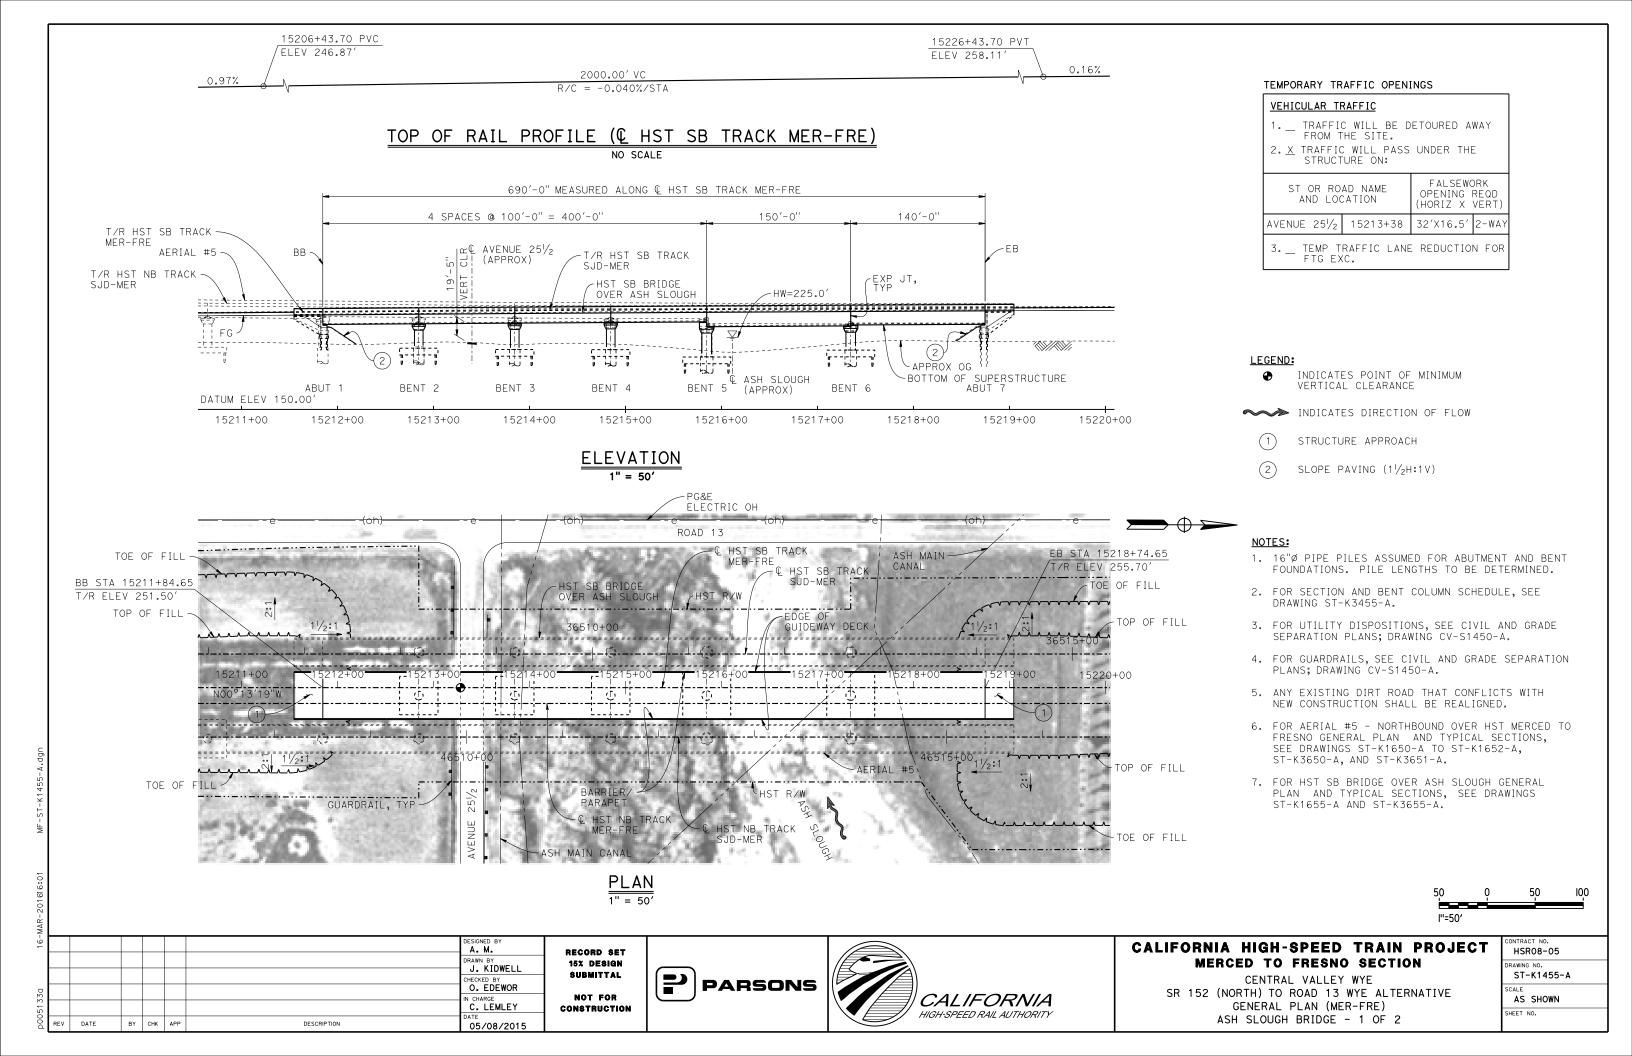

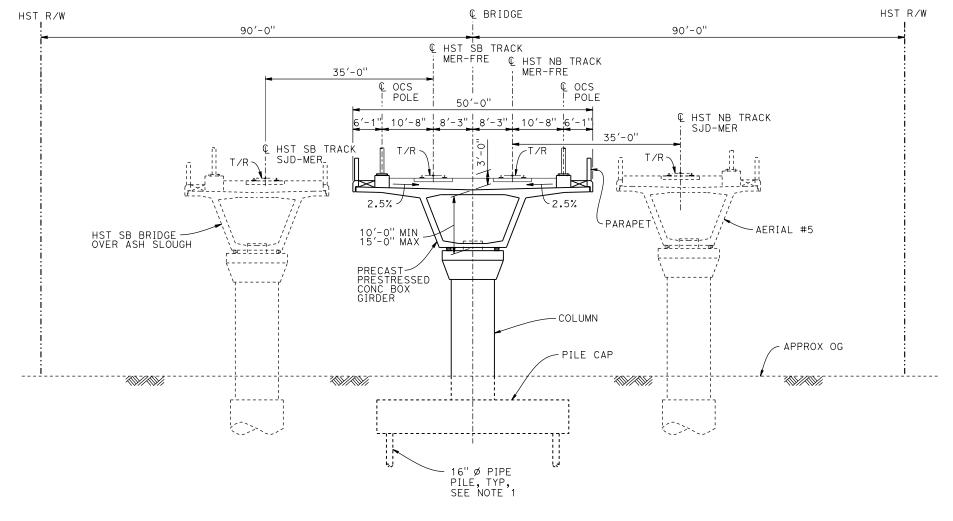

| BENT COL | UMN SCHEDULE |
|----------|--------------|
| BENT | COLUMN TYPE |
| 2 - 4 | 9'-0" Ø |
| 5 - 6 | 10′-0''ø |

1. PILE LENGTHS TO BE DETERMINED.

TYPICAL SECTION

| o | o | ΙO | 20 |
|-------------|----------|----|----|
| ''= 0' | | | |

| - | | | | | | | | |
|-----|-----|------|----|-----|-----|-------------|--------------------|-----|
| -90 | | | | | | | DESIGNED BY A. M. | RE |
| | | | | | | | DRAWN BY | 15 |
| | | | | | | | CHECKED BY | 81 |
| 0 | | | | | | | O. EDEWOR | |
| 361 | | | | | | | C. LEMLEY | CON |
| D00 | REV | DATE | BY | СНК | APP | DESCRIPTION | DATE 02/13/2015 | |

RECORD SET
15% DESIGN
SUBMITTAL
NOT FOR
CONSTRUCTION








CALIFORNIA HIGH-SPEED TRAIN PROJECT MERCED TO FRESNO SECTION


CENTRAL VALLEY WYE
SR 152 (NORTH) TO ROAD 13 WYE ALTERNATIVE
TYPICAL SECTION (MER-FRE)
ASH SLOUGH BRIDGE - 2 OF 2

| I | CONTRACT NO. HSR08-05 |
|---|---------------------------|
| I | DRAWING NO. ST-K3455-A |
| I | AS SHOWN |
| I | SHEET NO. |

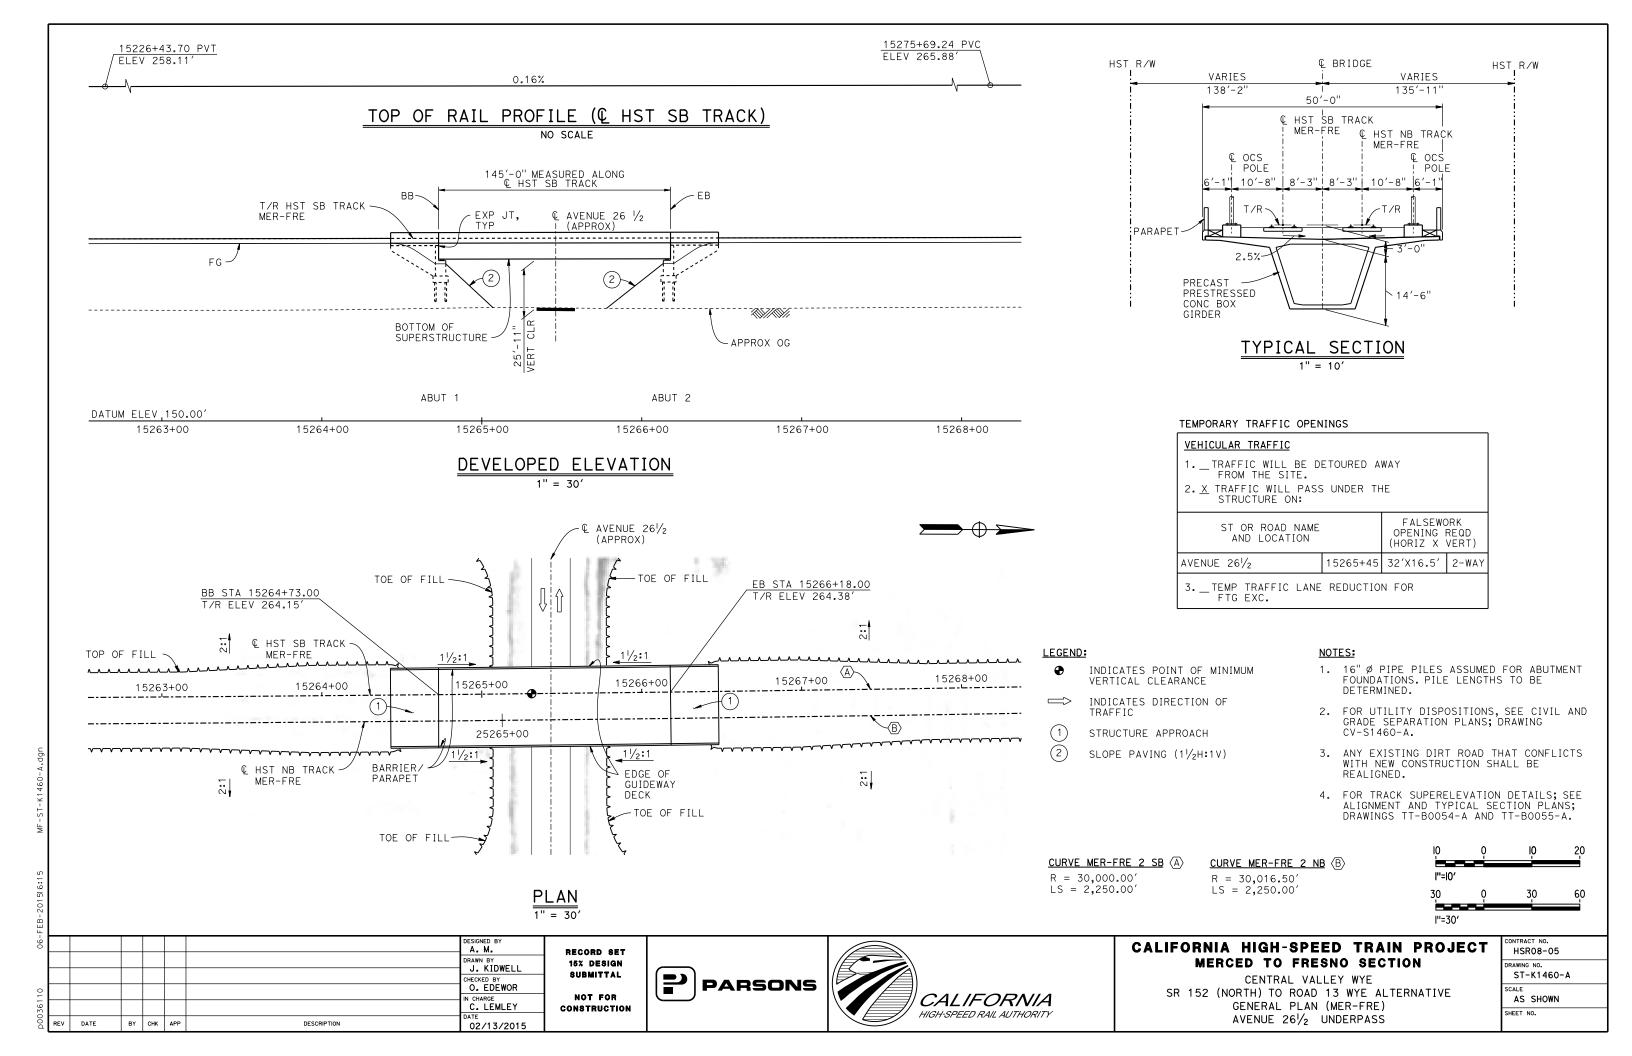

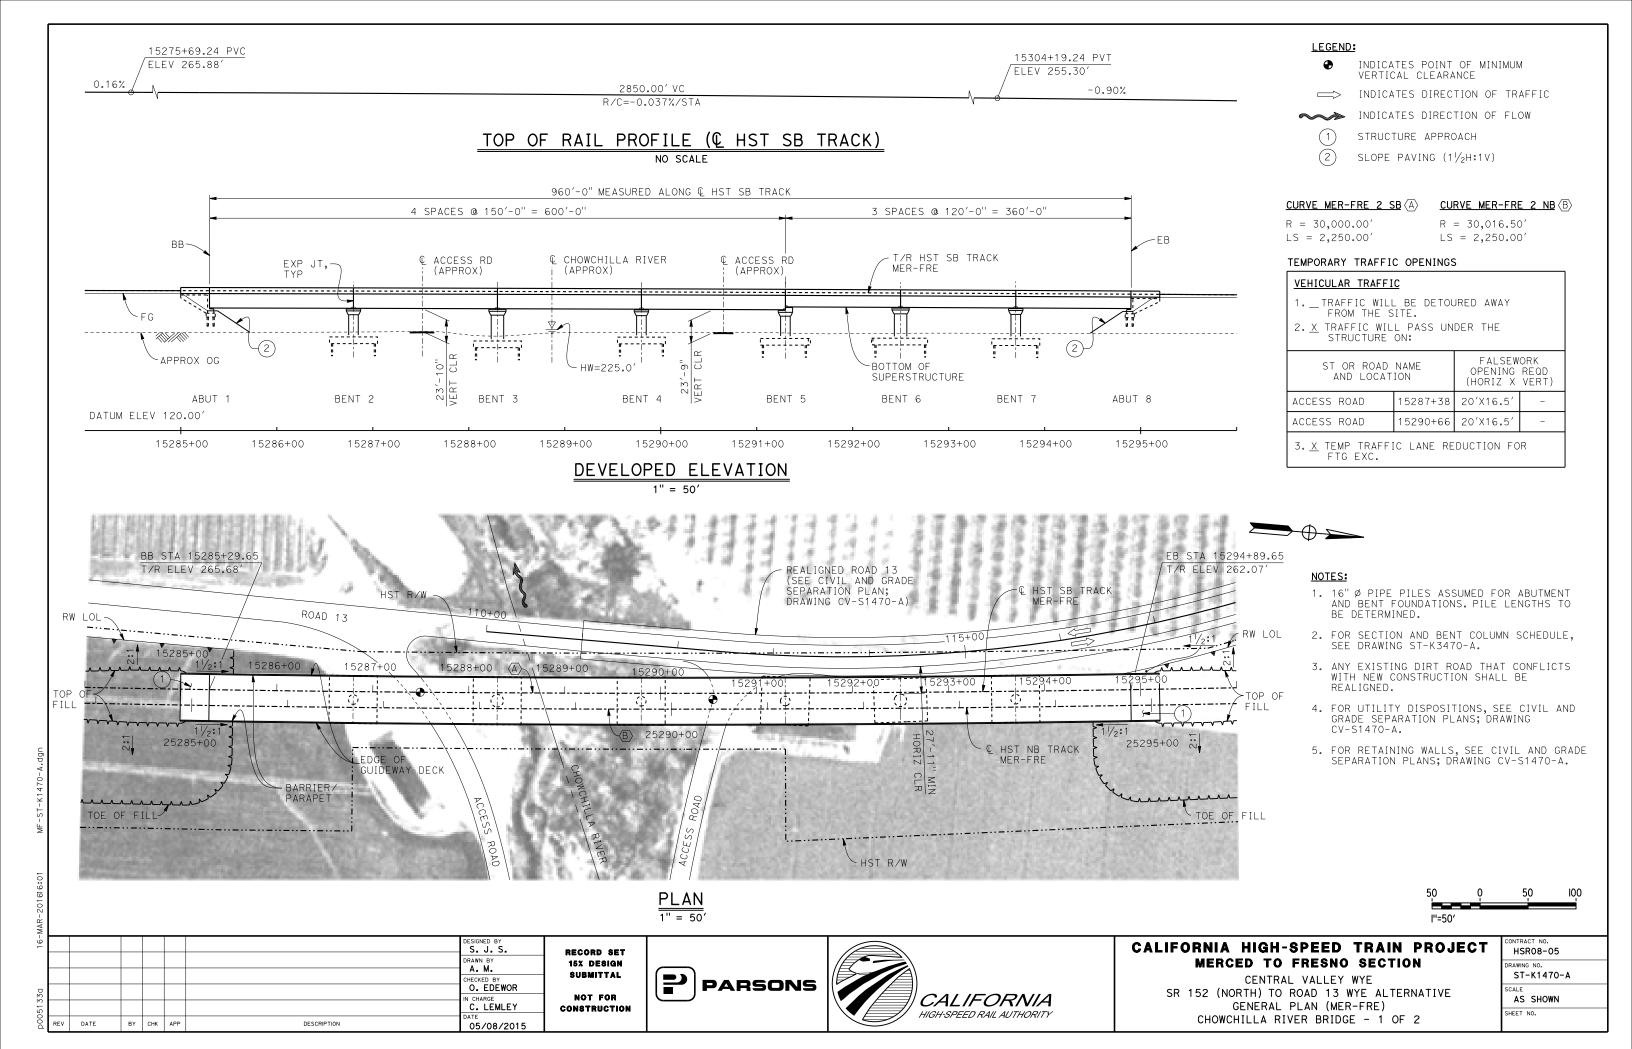

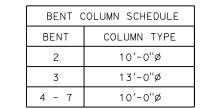

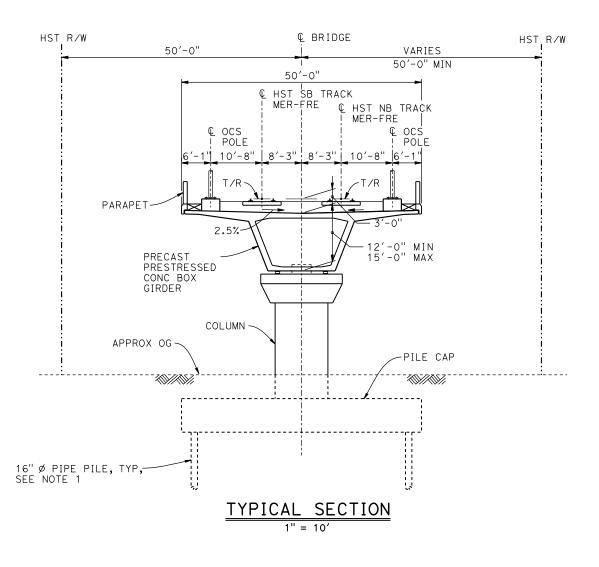

- 1. PILE LENGTHS TO BE DETERMINED.
- 2. FOR TRACK SUPERELEVATION DETAILS, SEE ALIGNMENT AND TYPICAL SECTION PLANS; DRAWINGS TT-B0054-A AND TT-B0055-A.



| FE | | | | | | | | |
|------|-----|------|----|-----|-----|-------------|------------------------|----|
| -90 | | | | | | | DESIGNED BY | |
| | | | | | | | DRAWN BY A. M. | R |
| 0 | | | | | | | CHECKED BY O. EDEWOR | · |
| 3611 | | | | | | | IN CHARGE C. LEMLEY | co |
| D00 | REV | DATE | BY | снк | APP | DESCRIPTION | 02/13/2015 | |

RECORD SET
15% DESIGN
SUBMITTAL
NOT FOR
CONSTRUCTION








CALIFORNIA HIGH-SPEED TRAIN PROJECT MERCED TO FRESNO SECTION

CENTRAL VALLEY WYE
SR 152 (NORTH) TO ROAD 13 WYE ALTERNATIVE
TYPICAL SECTION (MER-FRE)
CHOWCHILLA RIVER BRIDGE - 2 OF 2


| CONTRACT NO. HSR08-05 |
|---------------------------|
| DRAWING NO. ST-K3470-A |
| SCALE AS SHOWN |
| SHEET NO. |

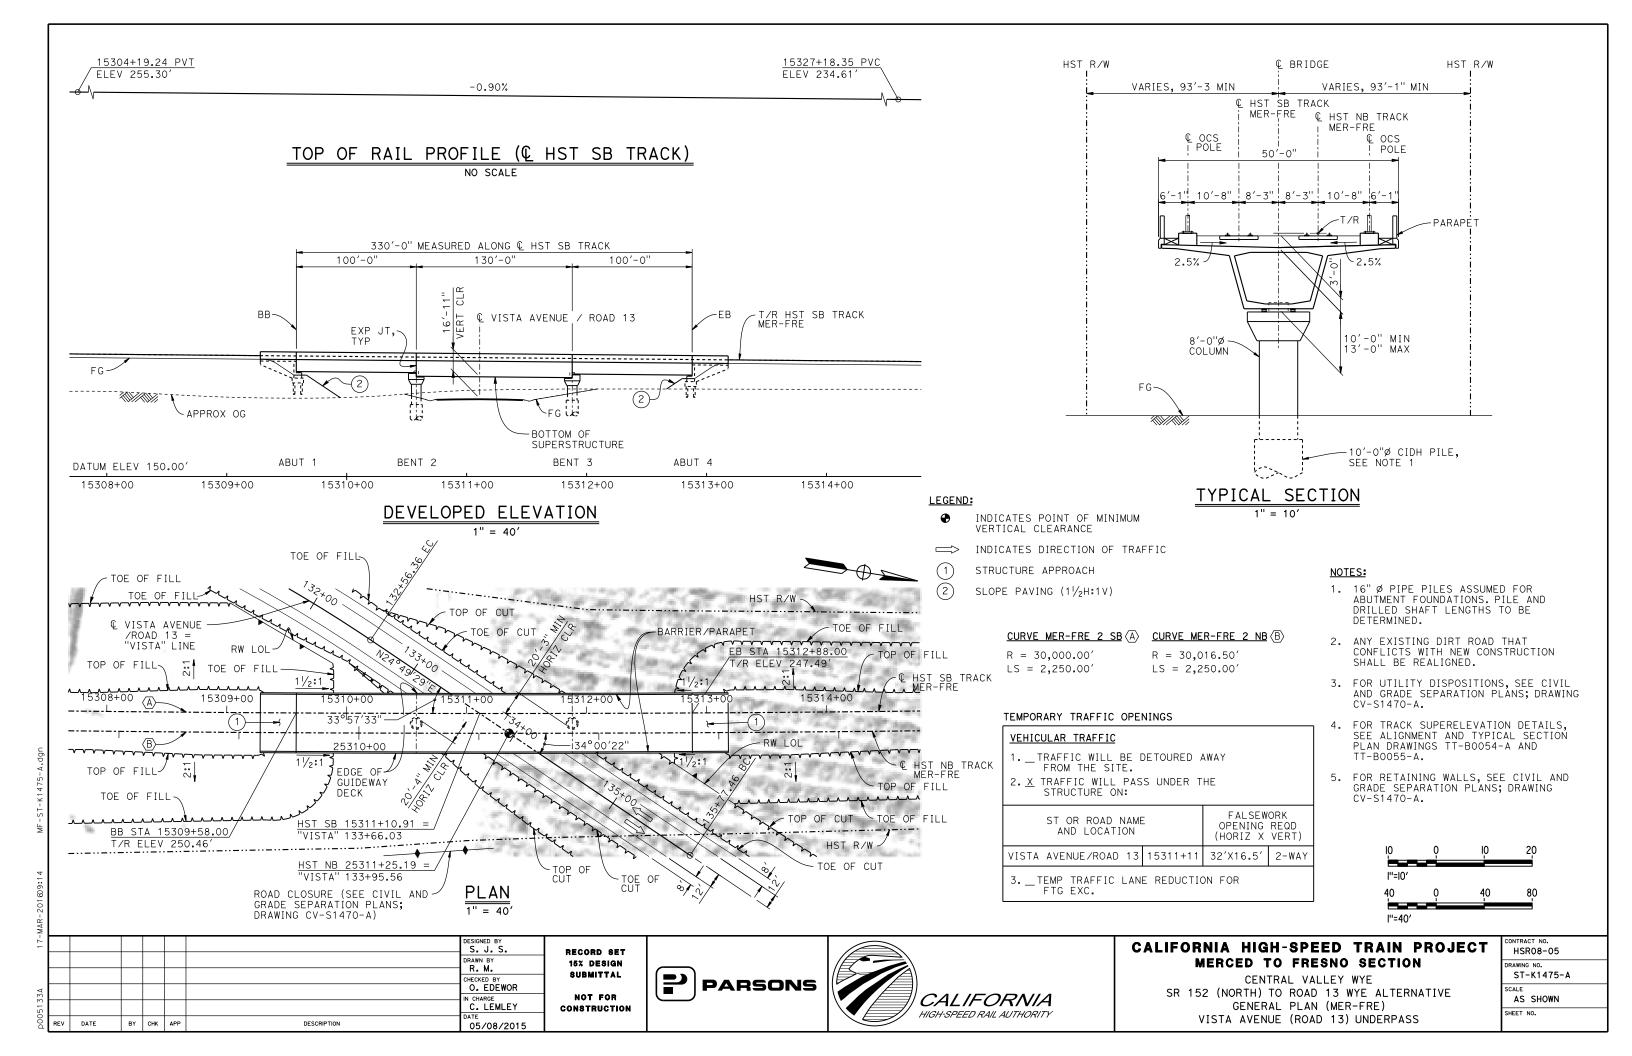


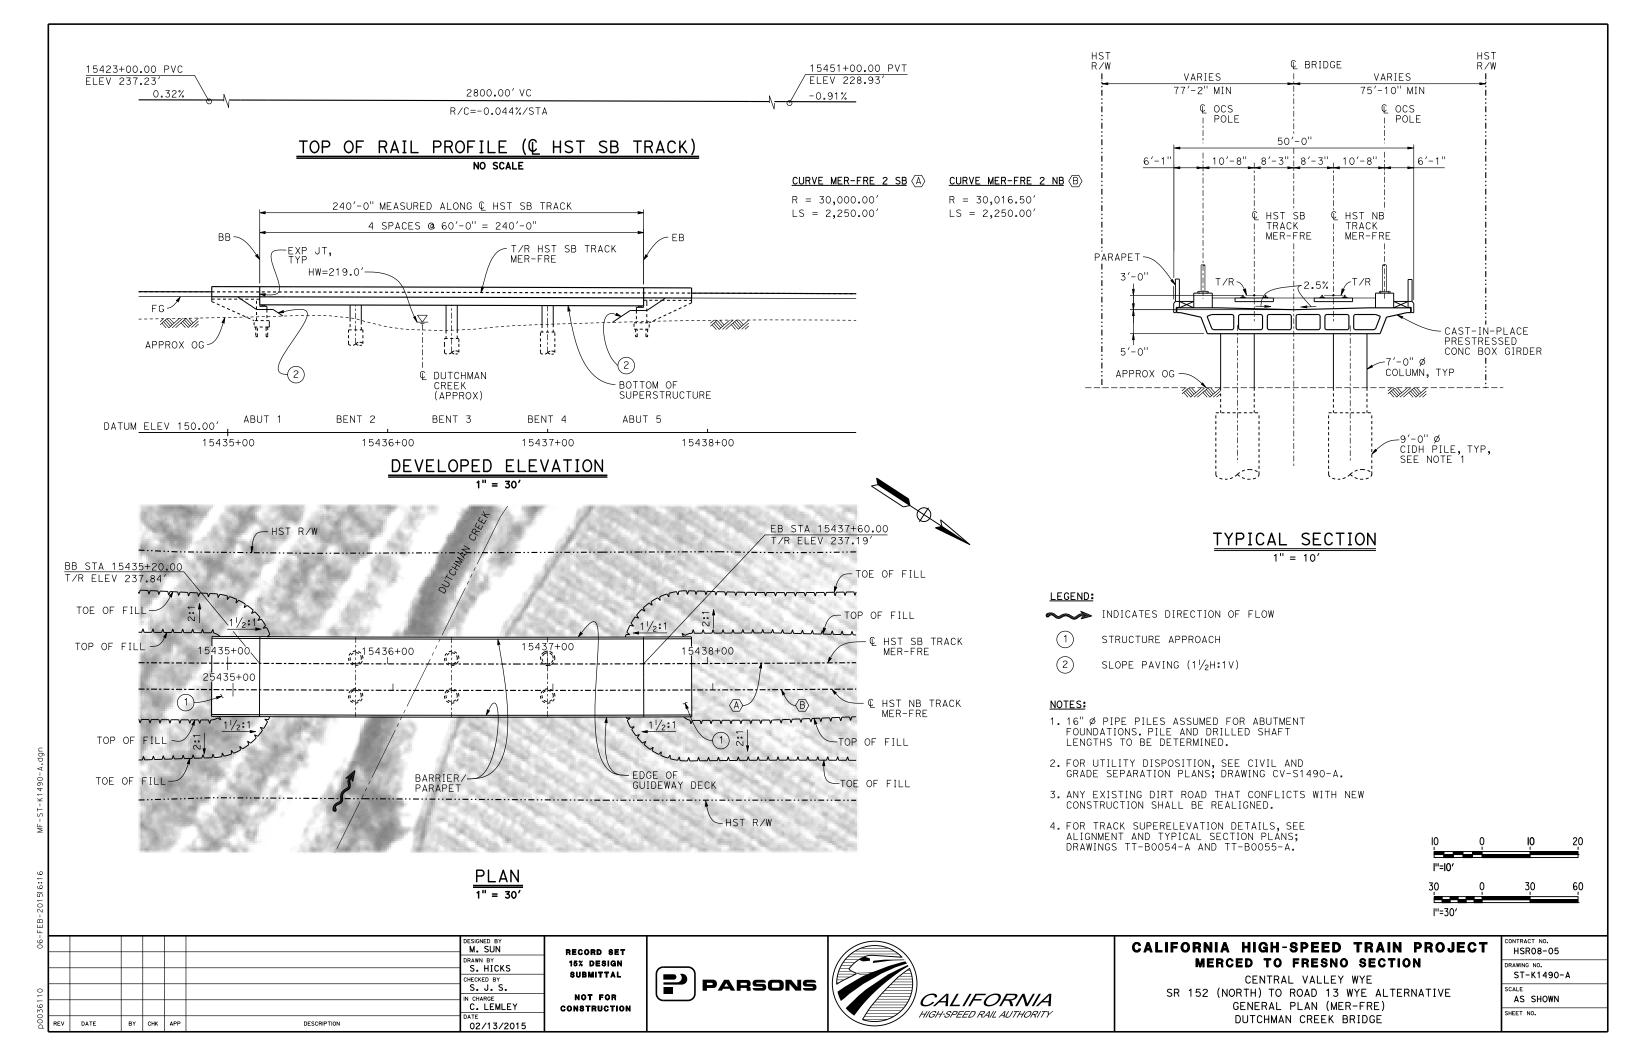

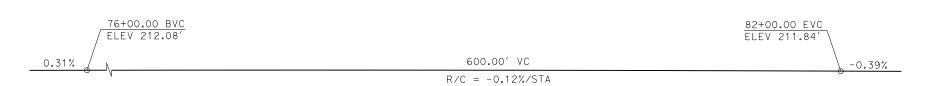

PROFILE GRADE NO SCALE

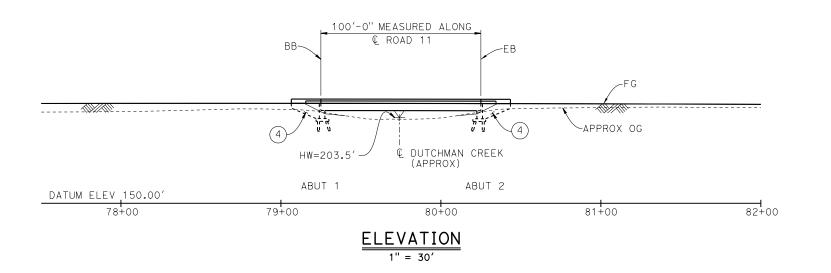

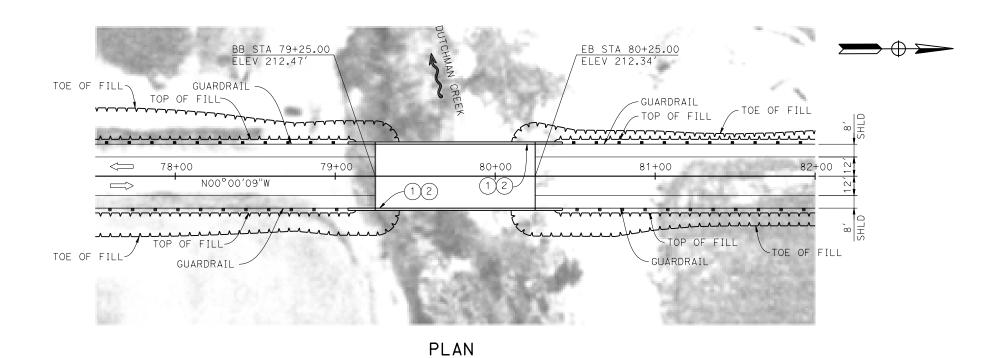

© BRIDGE 42'-10" 1'-5" 8'-0" 12'-0" 12'-0" 8'-0" 1'-5" SHLD PG -2% -2% -2% CAST-IN-PLACE PRESTRESSED CONC BOX GIRDER

TYPICAL SECTION

LEGEND:

INDICATES DIRECTION OF FLOW

⇒ INDICATES DIRECTION OF TRAFFIC

(1) PAINT "ROAD 11 BRIDGE"


2 PAINT "BRIDGE NO. XX-XXXX"

(3) CONCRETE BARRIER TYPE 732

(4) WINGWALL

NOTES:

- 1. ASSUME CLASS 140 PILES AT ABUTMENT AND BENT FOUNDATIONS. PILE LENGTHS TO BE DETERMINED.
- 2. FOR UTILITY DISPOSITIONS, SEE CIVIL AND GRADE SEPARATION PLANS; DRAWING CV-R1492-A.
- 3. FOR GUARDRAILS, SEE CIVIL AND GRADE SEPARATION PLANS; DRAWING CV-R1492-A.

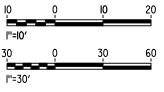

| MAF | | | | | | | | |
|-----|-----|------|----|-----|-----|-------------|----------------------|---|
| 10- | | | | | | | DESIGNED BY | |
| | | | | | | | DRAWN BY | ' |
| 3a | | | | | | | CHECKED BY K. CHARAN | |
| 513 | | | | | | | IN CHARGE C. LEMLEY | C |
| D00 | REV | DATE | BY | СНК | APP | DESCRIPTION | 03/18/2016 | |

RECORD SET
15% DESIGN
SUBMITTAL
NOT FOR
CONSTRUCTION








CALIFORNIA HIGH-SPEED TRAIN PROJECT MERCED TO FRESNO SECTION

CENTRAL VALLEY WYE
SR 152 (NORTH) TO ROAD 13 WYE ALTERNATIVE
GENERAL PLAN (MER-FRE)
ROAD 11 BRIDGE

| CONTRACT NO. |
|--------------|
| HSR08-05 |
| DRAWING NO. |
| ST-K1495-A |
| SCALE |
| AS SHOWN |
| SHEET NO. |
| |

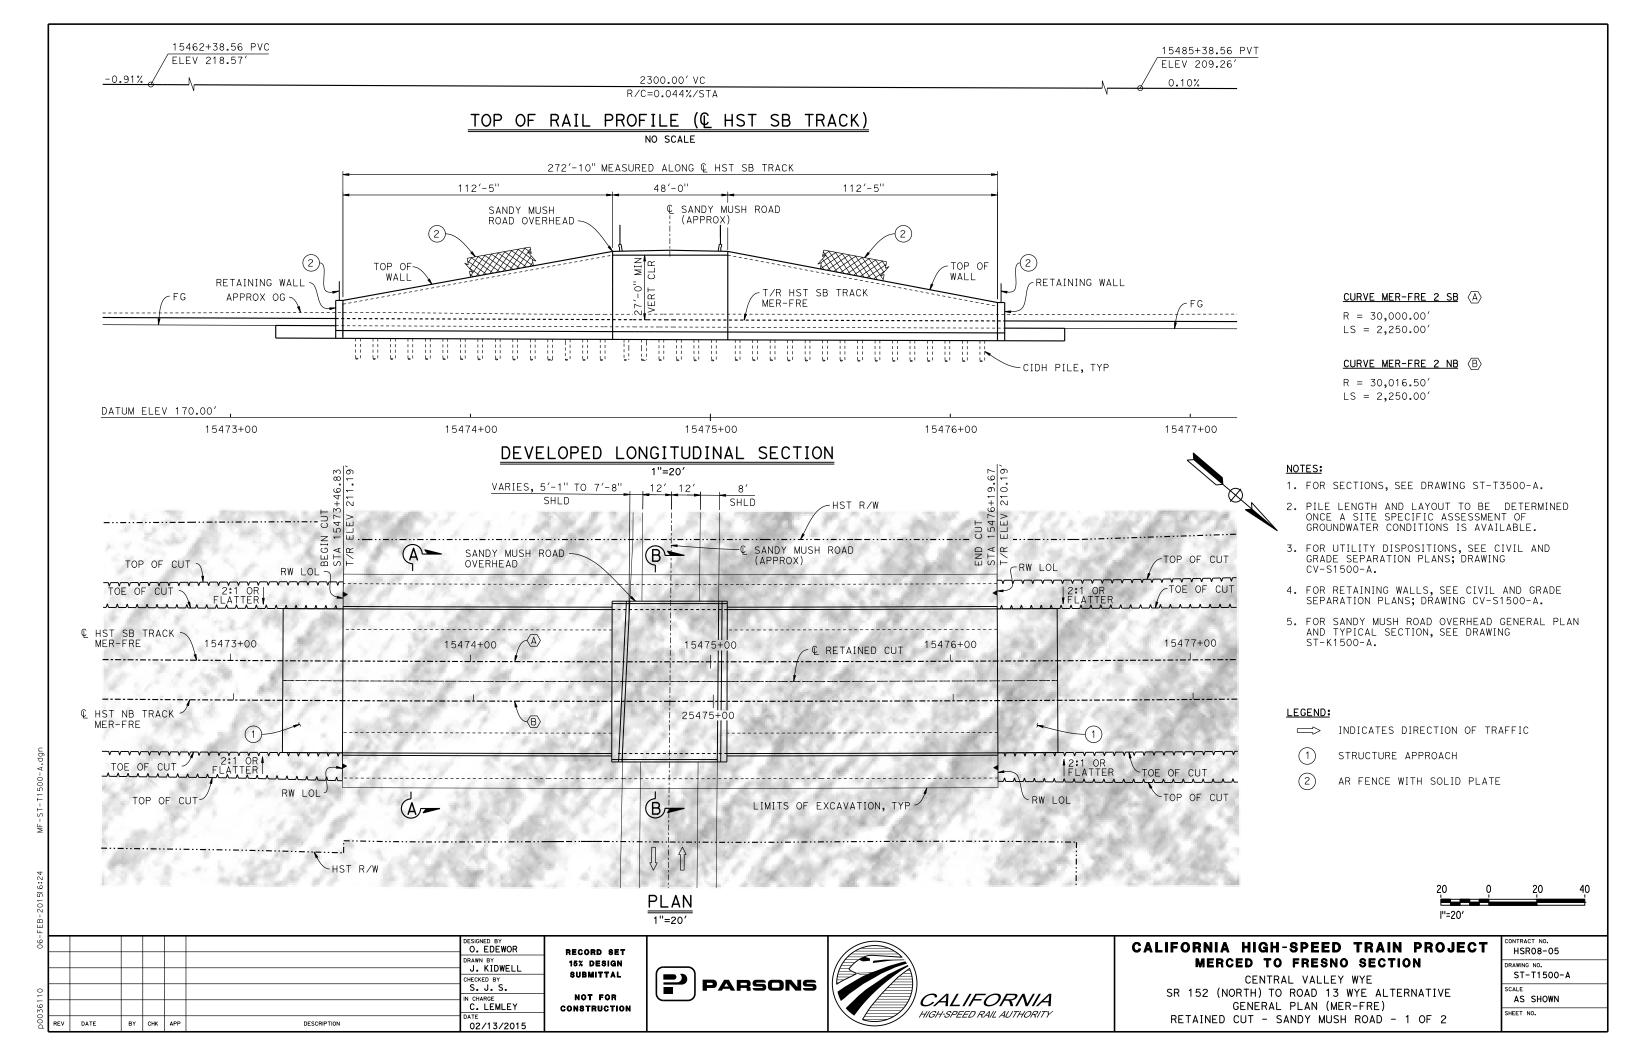

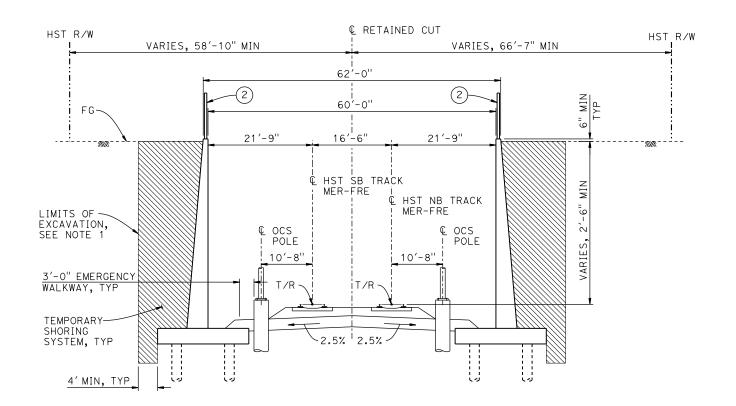


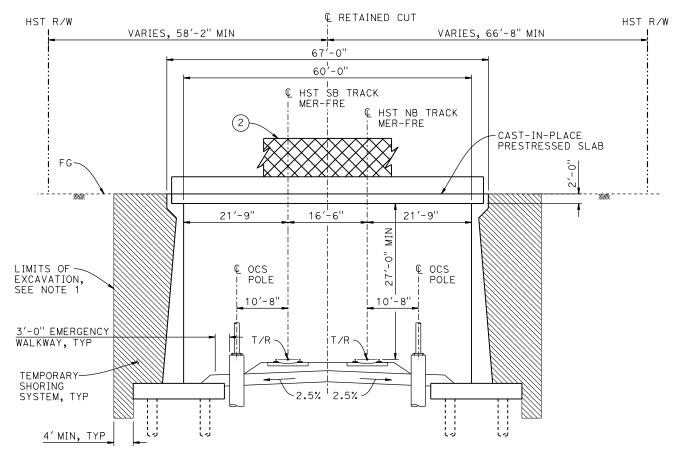

SECTION A-A

 $\frac{\mathsf{SECTION} \ \mathsf{B-B}}{\mathsf{1''} = \mathsf{10'}}$

- 1. LIMITS OF EXCAVATION SHALL NOT EXTEND BEYOND
- 2. PILE LENGTH AND LAYOUT TO BE DETERMINED ONCE A SITE SPECIFIC ASSESSMENT OF GROUNDWATER CONDITIONS IS AVAILABLE.
- 3. FOR TRACK SUPERELEVATION DETAILS, SEE ALIGNMENT AND TYPICAL SECTION PLANS; DRAWINGS TT-B0054-A AND TT-B0055-A.

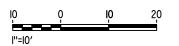

| با | | | | | | | | |
|-----|-----|------|----|-----|-----|-------------|-----------------------|--------------|
| -90 | | | | | | | DESIGNED BY O. EDEWOR | RECORD SET |
| | | | | | | | DRAWN BY | 15% DESIGN |
| | | | | | | | CHECKED BY | SUBMITTAL |
| 0 | | | | | | | S. J. S. IN CHARGE | NOT FOR |
| 361 | | | | | | | C. LEMLEY | CONSTRUCTION |
| 00d | REV | DATE | BY | СНК | APP | DESCRIPTION | 02/13/2015 | |






CALIFORNIA HIGH-SPEED TRAIN PROJECT MERCED TO FRESNO SECTION

CENTRAL VALLEY WYE SR 152 (NORTH) TO ROAD 13 WYE ALTERNATIVE TYPICAL SECTIONS (MER-FRE) RETAINED CUT - SANDY MUSH ROAD - 2 OF 2

| CONTRACT NO. |
|--------------|
| HSR08-05 |
| DRAWING NO. |
| ST-T3500-A |
| SCALE |
| AS SHOWN |
| SHEET NO. |
| |

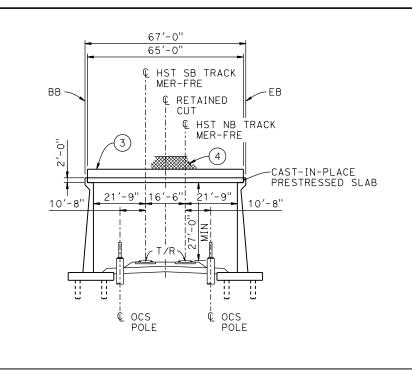

48'-0"

42'-10"

© SANDY MUSH ROAD
(APPROX)

1'-5" 8'-0" 12'-0" 8'-0" 1'-5"

SHLD LANE SHLD

PG

-2%


-2%

CAST-IN-PLACE
PRESTRESSED SLAB

 $\frac{\text{TYPICAL SECTION}}{\frac{3}{6}"=1.7-0"}$

DATUM ELEV 160.00'

ELEVATION 1"=20'

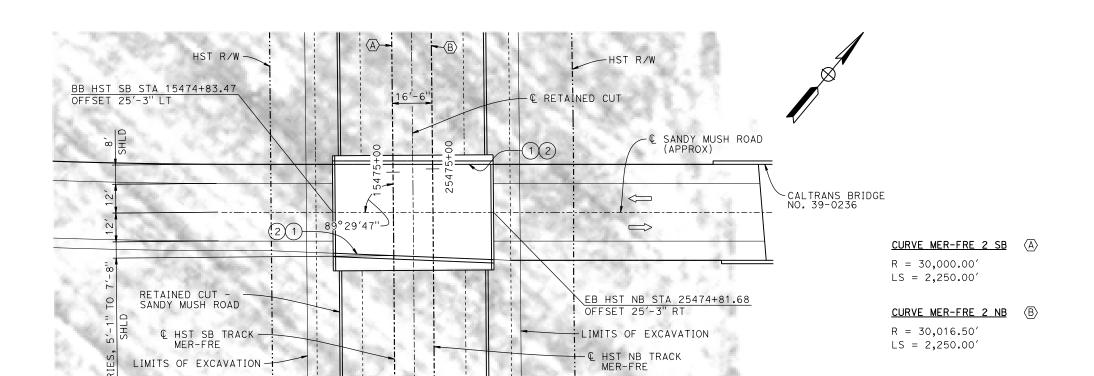


LEGEND:

- (1) PAINT "SANDY MUSH ROAD OVERHEAD"
- 2) PAINT "BRIDGE NO. XX-XXXX"
- (3) CONCRETE BARRIER TYPE 736 MOD
- (4) AR FENCE WITH SOLID PLATE

NOTES:

- 1. FOR UTILITY DISPOSITIONS, SEE CIVIL AND GRADE SEPARATION PLANS; DRAWING CV-S1500-A.
- 2. PILE LENGTH AND LAYOUT TO BE DETERMINED ONCE A SITE SPECIFIC ASSESSMENT OF GROUNDWATER CONDITIONS IS AVAILABLE.
- 3. FOR RETAINED CUT SANDY MUSH ROAD GENERAL PLAN AND TYPICAL SECTIONS, SEE DRAWINGS ST-T1500-A AND ST-T3500-A.

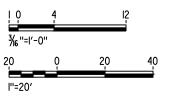

DESIGNED BY
O. EDEWOR

DRAWN BY
J. KIDWELL
CHECKED BY
S. J. S.
IN CHARGE
C. LEMLEY

DESCRIPTION

DATE

BY CHK APP

RECORD SET
15% DESIGN
SUBMITTAL
NOT FOR
CONSTRUCTION

60′-0"

PLAN 1"=20'

02/13/2015

VARIES, 126'-0" ±
HST R/W







CALIFORNIA HIGH-SPEED TRAIN PROJECT MERCED TO FRESNO SECTION

CENTRAL VALLEY WYE
SR 152 (NORTH) TO ROAD 13 WYE ALTERNATIVE
GENERAL PLAN (MER-FRE)
SANDY MUSH ROAD OVERHEAD

| CONTRACT NO. |
|--------------|
| HSR08-05 |
| DRAWING NO. |
| ST-K1500-A |
| SCALE |
| AS SHOWN |
| SHEET NO. |

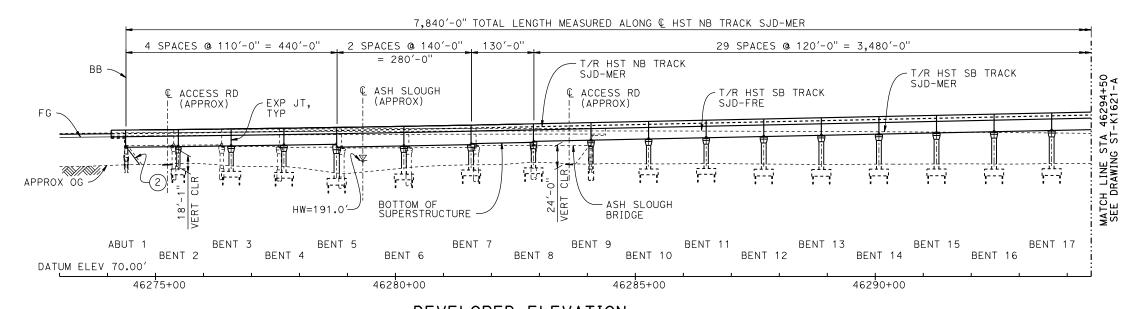

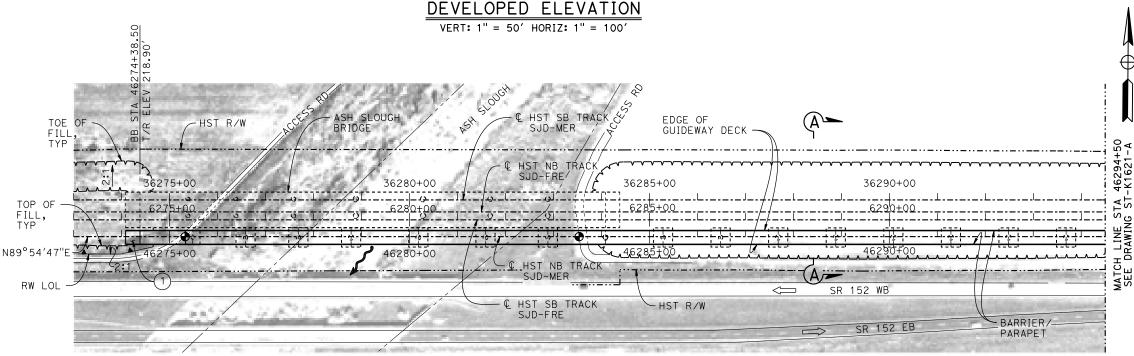

LEGEND:

INDICATES POINT OF MINIMUM VERTICAL CLEARANCE

➤ INDICATES DIRECTION OF FLOW

⇒ INDICATES DIRECTION OF TRAFFIC

(1) STRUCTURE APPROACH

2) SLOPE PAVING $(1\frac{1}{2}H:1V)$

TEMPORARY TRAFFIC OPENINGS


| VEHICULAR TRAFFIC | | | | | | |
|--|----------|-----------|---|--|--|--|
| 1 TRAFFIC WILL BE DETOURED AWAY FROM THE SITE. 2. X TRAFFIC WILL PASS UNDER THE STRUCTURE ON: | | | | | | |
| ST OR ROAD NAME OPENING REQU (HORIZ X VERT) | | | | | | |
| ACCESS ROAD | 46275+25 | 20′X16.5′ | - | | | |
| ACCESS ROAD 46283+62 20'X16.5' - | | | | | | |
| 3. X TEMP TRAFFIC LANE REDUCTION FOR FTG FXC. | | | | | | |

NOTES:

- 16" Ø PIPE PILES ASSUMED FOR ABUTMENT AND BENT FOUNDATIONS, UNLESS OTHERWISE NOTED. PILE LENGTHS TO BE DETERMINED.
- 2. FOR SECTIONS AND BENT COLUMN SCHEDULE, SEE DRAWINGS ST-K3620-A AND ST-K3621-A.
- 3. ANY EXISTING DIRT ROAD THAT CONFLICTS WITH NEW CONSTRUCTION SHALL BE REALIGNED.
- 4. FOR RETAINING WALLS, SEE CIVIL AND GRADE SEPARATION PLANS; DRAWINGS CV-S1610-A AND CV-S1620-A.
- 5. FOR UTILITY DISPOSITIONS, SEE CIVIL AND GRADE SEPARATION PLANS; DRAWINGS CV-S1610-A AND CV-S1620-A.
- 6. FOR ASH SLOUGH BRIDGE GENERAL PLAN AND TYPICAL SECTION, SEE DRAWINGS ST-K1170-A AND ST-K3170-A.

CURVE SJD-MER 1 NB (A)

R = 10,376.50' LS = 1,500.00'

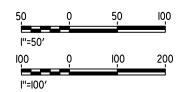

| 핖 | | | | | | | | |
|-------|------|------|----|------|-----|-------------|------------------------|-----|
| -90 | | | | | | | DESIGNED BY A. M. | |
| | | | | | | | DRAWN BY W. JOHNSEN | l |
| | | | | | | | CHECKED BY S. J. S. | l |
| 5110 | | | | | | | IN CHARGE C. LEMLEY | ا ا |
| p0036 | REV | DATE | BY | снк | APP | DESCRIPTION | DATE | ' |
| σ. | ILL* | DAIL | 01 | CIIK | AII | DESCRIPTION | 02/13/2015 | |

RECORD SET
15% DESIGN
SUBMITTAL

NOT FOR
CONSTRUCTION

PLAN

1" = 100'





CALIFORNIA HIGH-SPEED TRAIN PROJECT MERCED TO FRESNO SECTION

CENTRAL VALLEY WYE
SR 152 (NORTH) TO ROAD 13 WYE ALTERNATIVE
GENERAL PLAN (SJD-MER)
AERIAL #4 - NORTHBOUND OVER HST MAINLINE - 1 OF 6


CONTRACT NO.
HSRO8-05
DRAWING NO.
ST-K1620-A
SCALE
AS SHOWN
SHEET NO.

2100.00' VC R/C=-0.110%/STA

1.05%

TOP OF RAIL PROFILE (& HST NB TRACK SJD-MER)



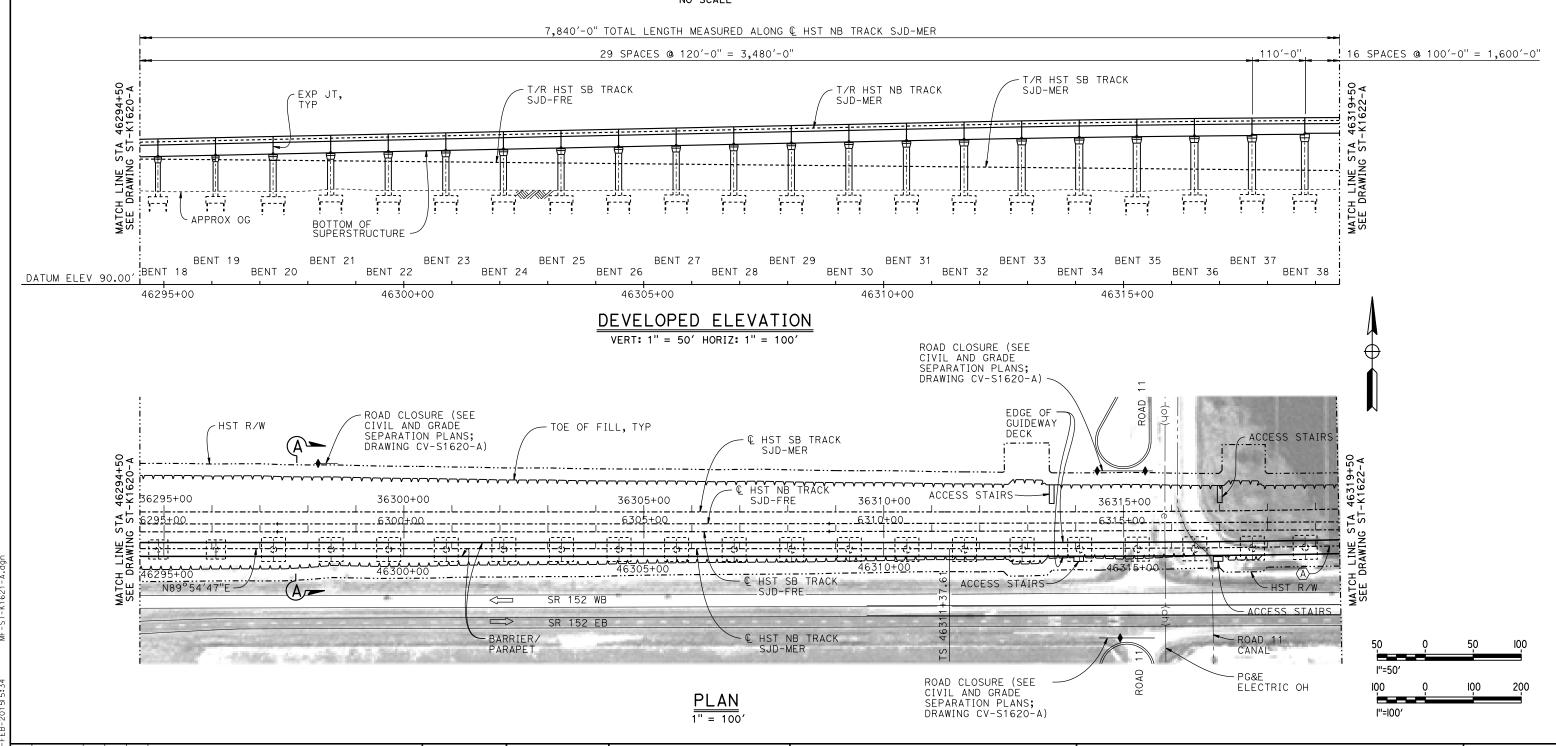

DESIGNED BY RECORD SET DRAWN BY
W. JOHNSEN 15% DESIGN SUBMITTAL CHECKED BY IN CHARGE
C. LEMLEY CONSTRUCTION DATE BY CHK APP DESCRIPTION 02/13/2015



NOT FOR




CALIFORNIA HIGH-SPEED TRAIN PROJECT MERCED TO FRESNO SECTION

CENTRAL VALLEY WYE SR 152 (NORTH) TO ROAD 13 WYE ALTERNATIVE GENERAL PLAN (SJD-MER) AERIAL #4 - NORTHBOUND OVER HST MAINLINE - 2 OF 6

| CONTRACT NO. |
|--------------|
| HSR08-05 |
| DRAWING NO. |
| ST-K1621-A |
| SCALE |
| AS SHOWN |
| SHEET NO. |
| |

TOP OF RAIL PROFILE (& HST NB TRACK SJD-MER)

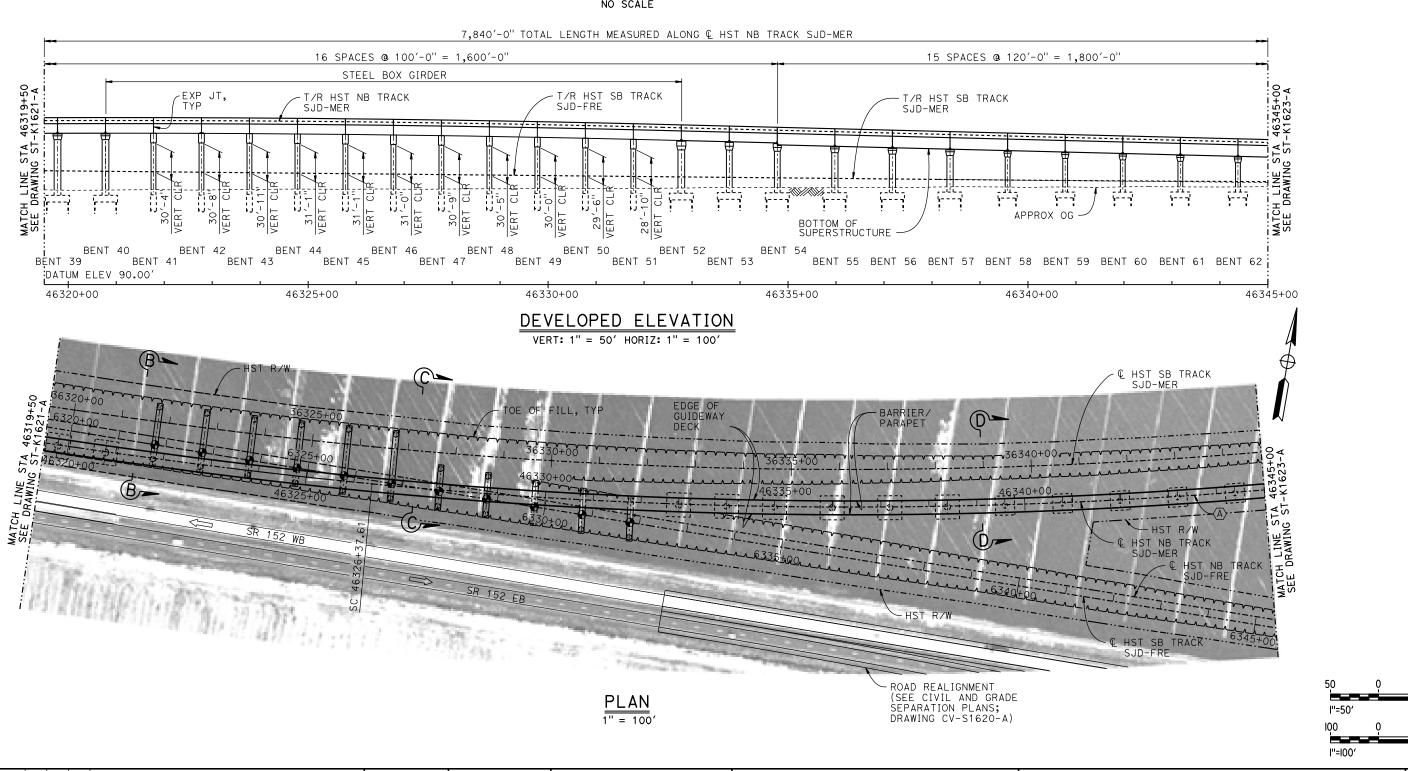

| ŀE | | | | | | | | |
|-------|-----|------|----|-----|-----|-------------|-----------------------|---|
| -90 | | | | | | | DESIGNED BY A. M. | |
| | | | | | | | DRAWN BY W. JOHNSEN | |
| | | | | | | | CHECKED BY | |
| 110 | | | | | | | S. J. S. IN CHARGE | |
| p0036 | | | | | | | C. LEMLEY | С |
|)Od | REV | DATE | BY | снк | APP | DESCRIPTION | 02/13/2015 | |

RECORD SET 15% DESIGN SUBMITTAL NOT FOR CONSTRUCTION





CALIFORNIA HIGH-SPEED TRAIN PROJECT MERCED TO FRESNO SECTION


CENTRAL VALLEY WYE SR 152 (NORTH) TO ROAD 13 WYE ALTERNATIVE GENERAL PLAN (SJD-MER) AERIAL #4 - NORTHBOUND OVER HST MAINLINE - 3 OF 6

| CONTRACT NO. |
|--------------|
| HSR08-05 |
| DRAWING NO. |
| ST-K1622-A |
| SCALE |
| AS SHOWN |
| SHEET NO. |
| |
| |


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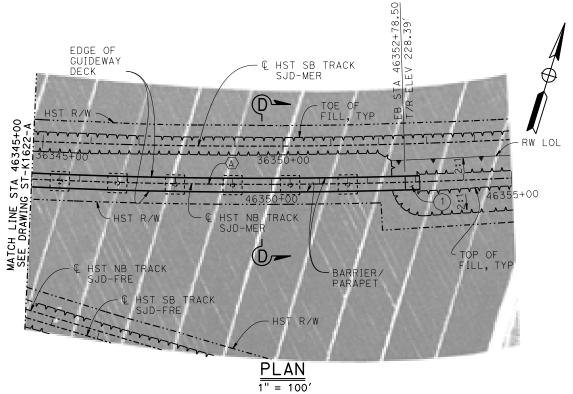
TOP OF RAIL PROFILE (HST NB TRACK SJD-MER)

NO SCALE

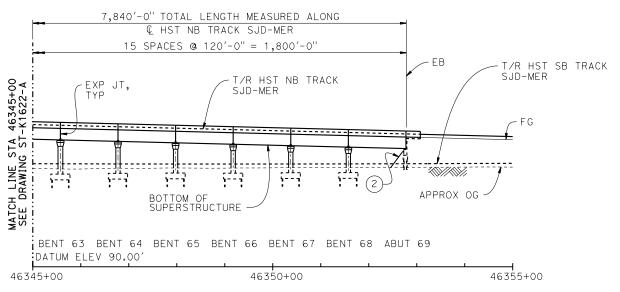

DEVELOPED ELEVATION



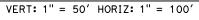

| 50 | Q | 50 | 100 |
|----------|---|-----|-----|
| l''=50' | _ | | |
| 100 | Q | IQ0 | 200 |
| l''=l00′ | | | |

| | | | | | | DESIGNED BY A. M. | |
|-----|------|----|-----|-----|-------------|---------------------|-----|
| | | | | | | DRAWN BY W. JOHNSEN | |
| | | | | | | CHECKED BY | |
| | | | | | | IN CHARGE C. LEMLEY |] 。 |
| REV | DATE | BY | СНК | APP | DESCRIPTION | 05/08/2015 | |

RECORD SET
15% DESIGN
SUBMITTAL
NOT FOR
CONSTRUCTION








CALIFORNIA HIGH-SPEED TRAIN PROJECT MERCED TO FRESNO SECTION


CENTRAL VALLEY WYE
SR 152 (NORTH) TO ROAD 13 WYE ALTERNATIVE
GENERAL PLAN (SJD-MER)
AERIAL #4 - NORTHBOUND OVER HST MAINLINE - 4 OF 6

| CONTRACT NO. |
|--------------|
| HSR08-05 |
| DRAWING NO. |
| ST-K1623-A |
| SCALE |
| AS SHOWN |
| SHEET NO. |
| |

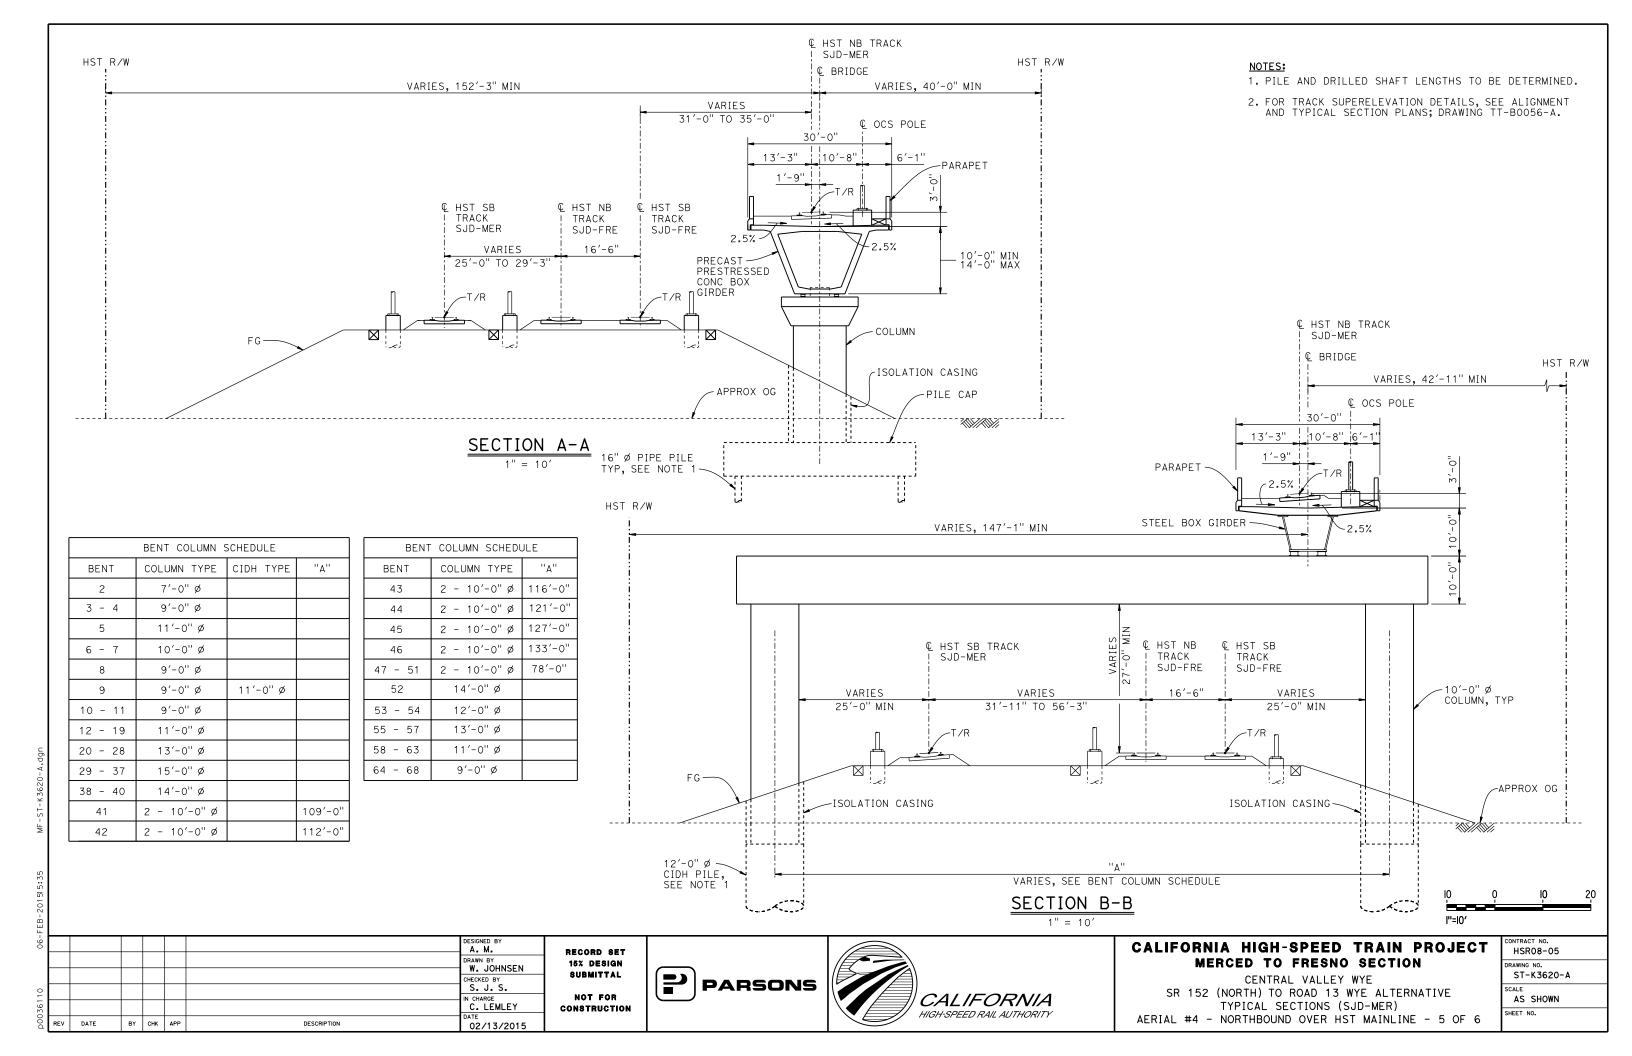

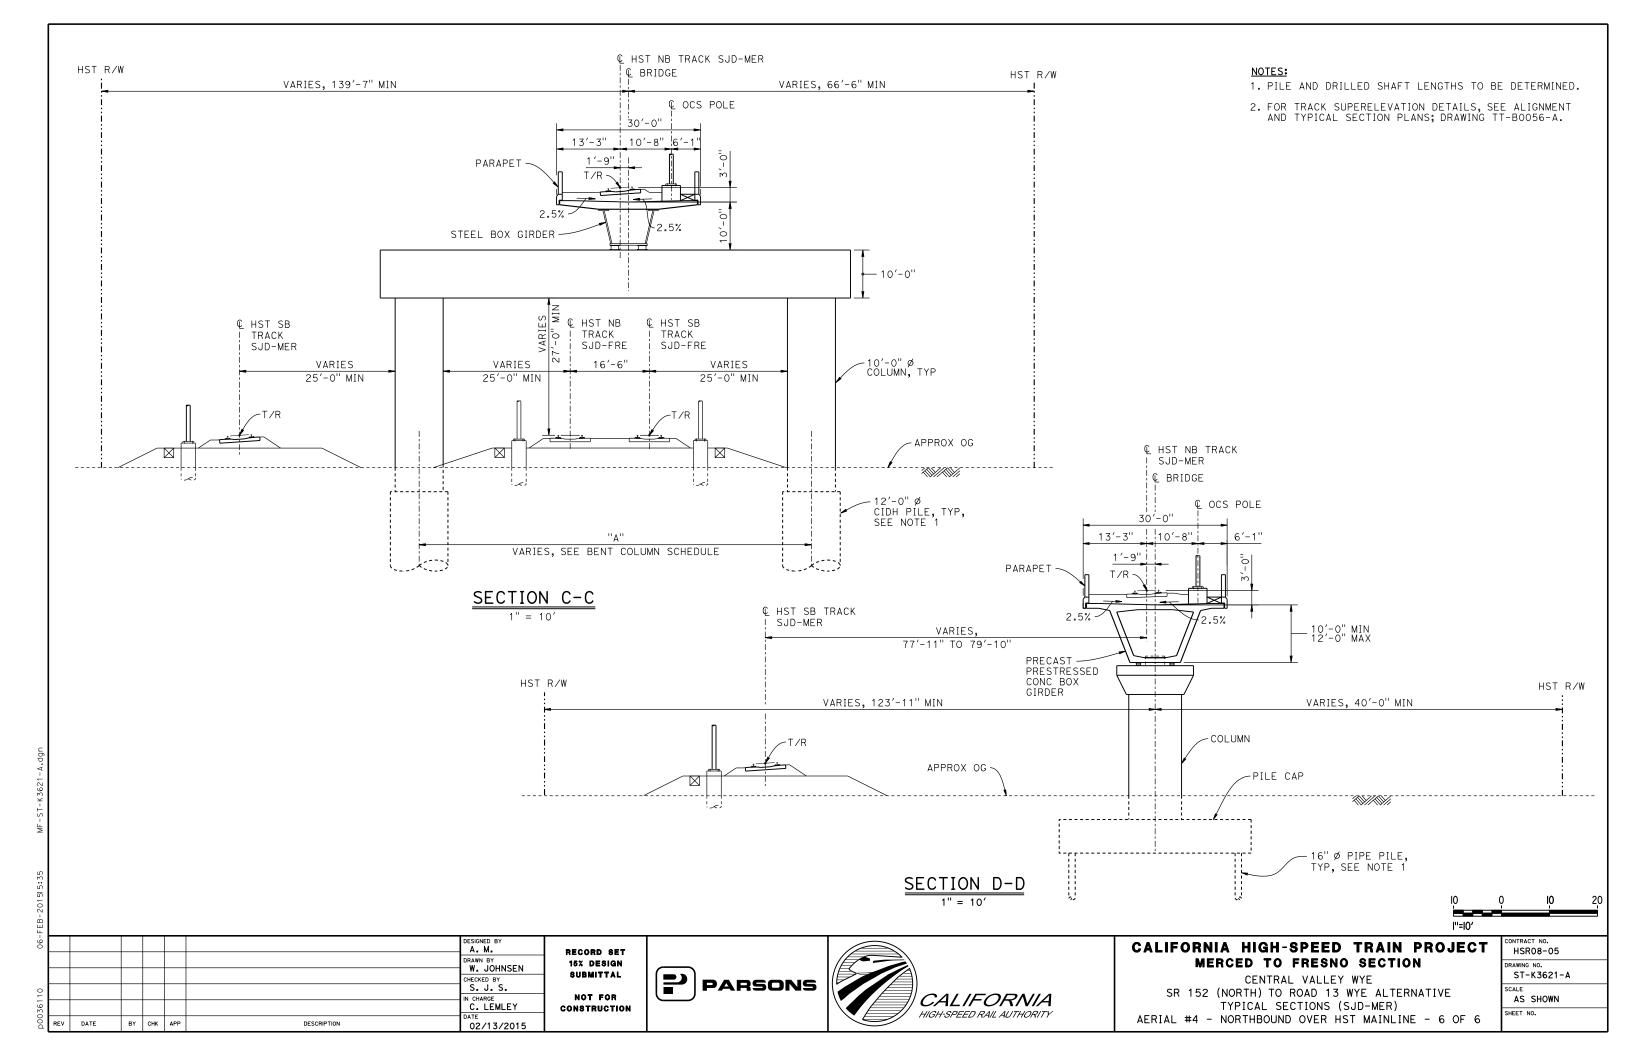


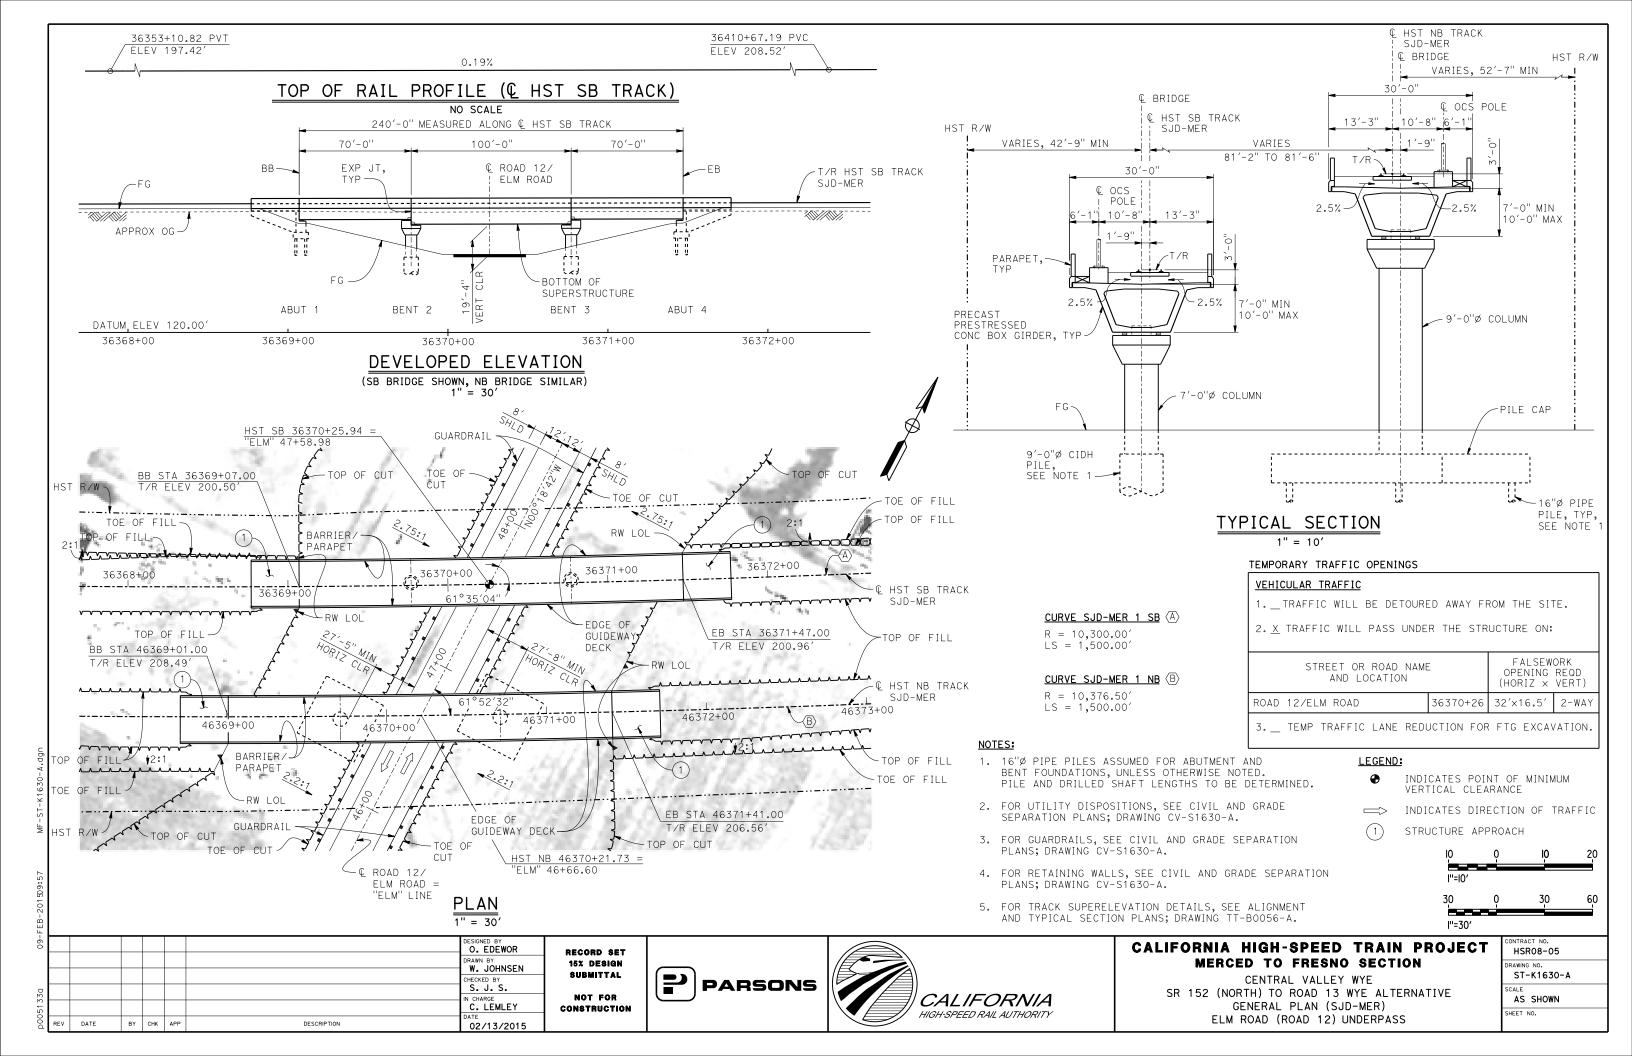

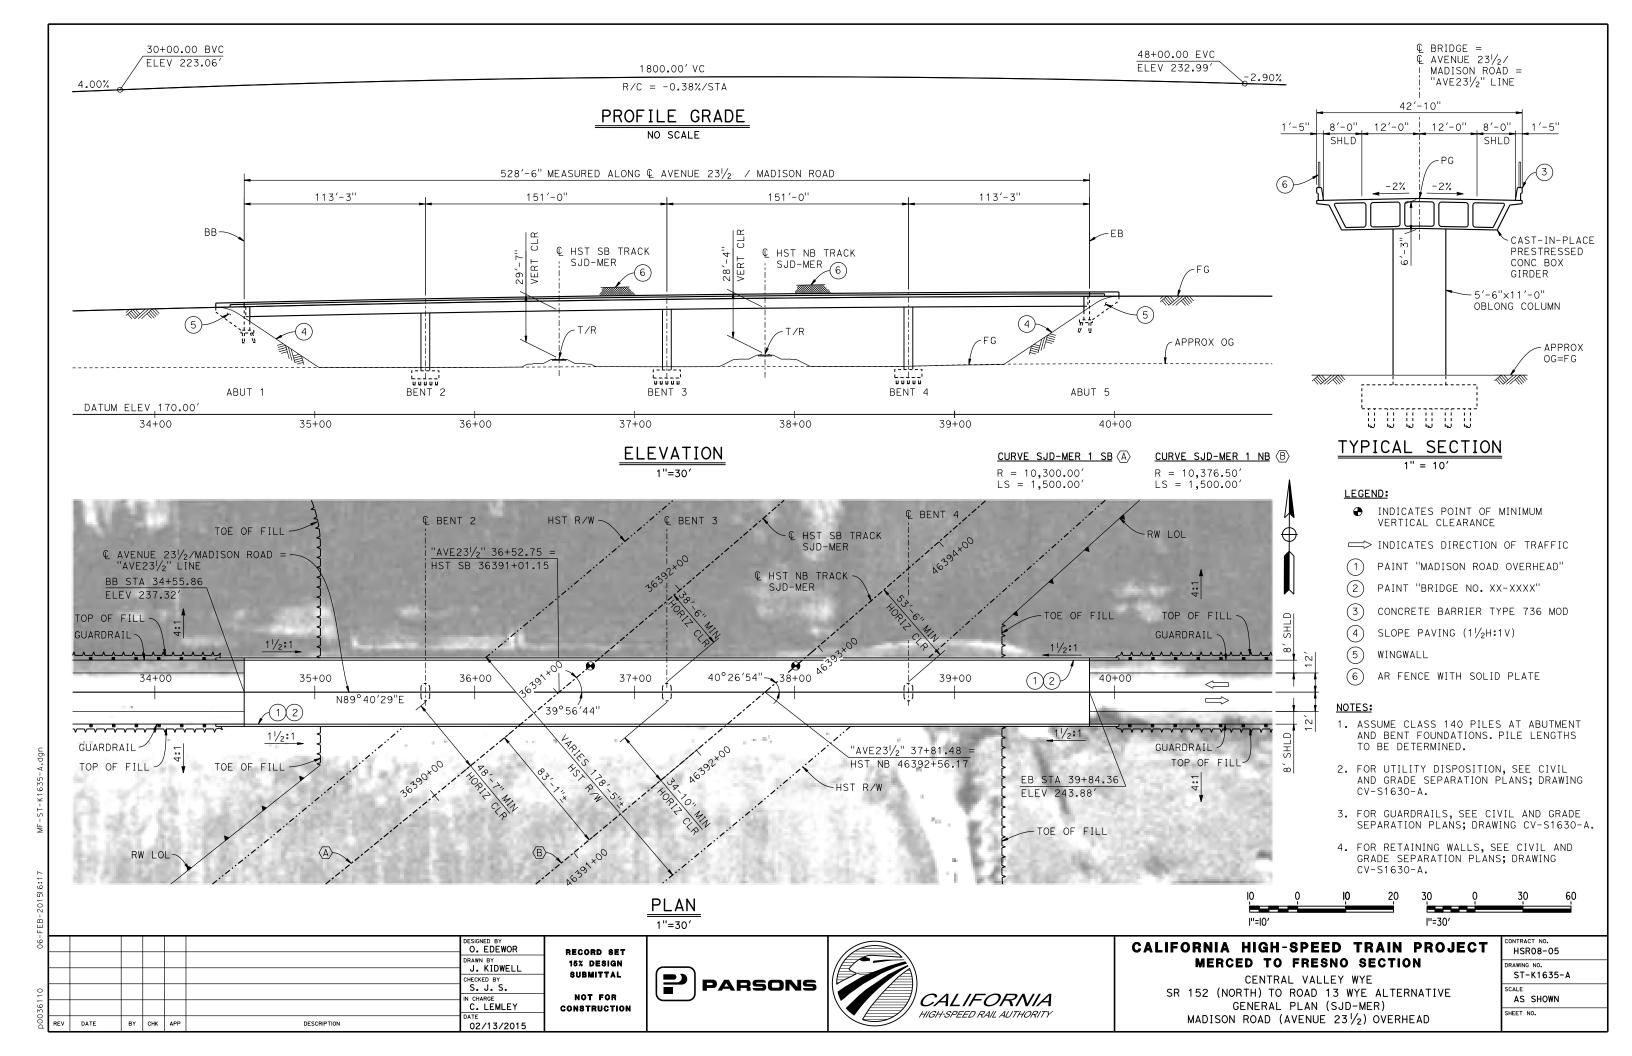


46430+27.13 PVT ELEV 219.46' 1.25%

TOP OF RAIL PROFILE (HST NB TRACK SJD-MER)

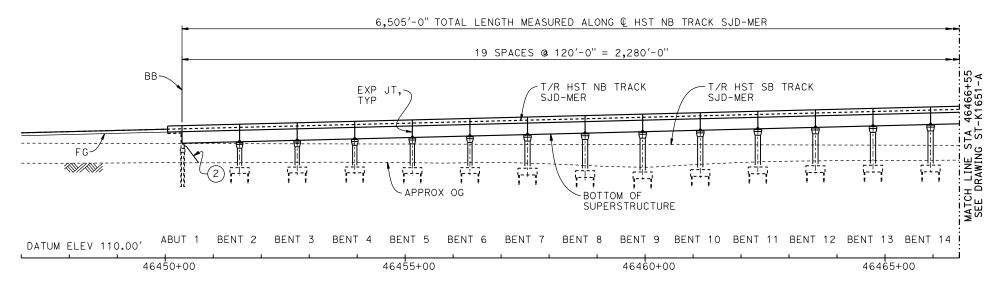

DEVELOPED ELEVATION

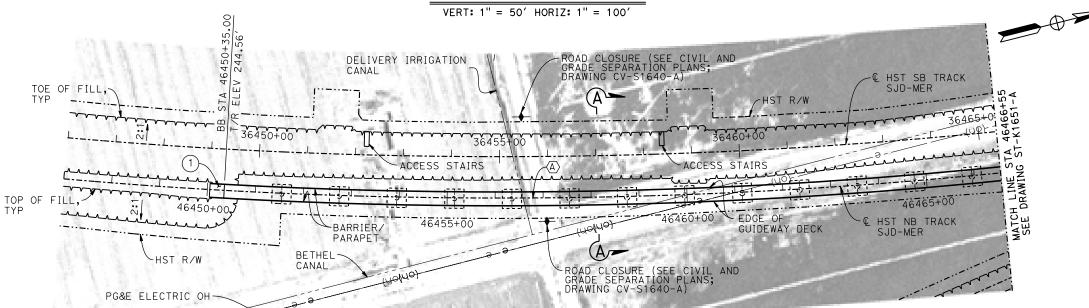

$\frac{PLAN}{1" = 100'}$

DESIGNED BY S. J. S. DRAWN BY R. M. CHECKED BY O. EDEWOR IN CHARGE C. LEMLEY DATE BY CHK APP DESCRIPTION DATE 02/13/2015

RECORD SET
15% DESIGN
SUBMITTAL
NOT FOR
CONSTRUCTION





LEGEND:

INDICATES POINT OF MINIMUM VERTICAL CLEARANCE

INDICATES DIRECTION OF FLOW

(1) STRUCTURE APPROACH

(2) SLOPE PAVING $(1\frac{1}{2}H:1V)$

CURVE SJD-MER 1 NB (A)

R = 10,376.50'LS = 1,500.00'

TEMPORARY TRAFFIC OPENINGS

VEHICULAR TRAFFIC


- 1. _ TRAFFIC WILL BE DETOURED AWAY FROM THE SITE.
- 2. \underline{X} TRAFFIC WILL PASS UNDER THE STRUCTURE ON:

| ST OR ROAD NAME AND LOCATION | FALSEWORK OPENING REQD (HORIZ X VERT) | | | | | | | |
|-----------------------------------|---|-----------|-------|--|--|--|--|--|
| AVENUE 25/WASHINGTON RD | 46483+65 | 32′X16.5′ | 2-WAY | | | | | |
| AVENUE 251/2 | 46510+03 | 32′X16.5′ | 2-WAY | | | | | |
| 7 TEND TRAFFIC LANE DEPUGLION FOR | | | | | | | | |

3. _ TEMP TRAFFIC LANE REDUCTION FOR FTG EXC.

NOTES:

- 1. 16" Ø PIPE PILES ASSUMED FOR ABUTMENT AND BENT FOUNDATIONS, UNLESS OTHERWISE NOTED. PILE LENGTHS TO BE DETERMINED.
- 2. FOR SECTIONS AND BENT COLUMN SCHEDULE, SEE DRAWINGS ST-K3650-A AND ST-K3651-A.
- 3. ANY EXISTING DIRT ROAD THAT CONFLICTS WITH NEW CONSTRUCTION SHALL BE REALIGNED.
- 4. FOR UTILITY DISPOSITIONS, SEE CIVIL AND GRADE SEPARATION PLANS; DRAWINGS CV-S1640-A AND CV-S1650-A.
- 5. FOR GUARDRAILS, SEE CIVIL AND GRADE SEPARATION PLANS; DRAWINGS CV-S1640-A AND CV-S1650-A.
- 6. FOR RETAINING WALLS, SEE CIVIL AND GRADE SEPARATION PLANS; DRAWINGS CV-S1640-A AND CV-S1650-A.
- 7. FOR WASHINGTON ROAD (AVENUE 25) UNDERPASS GENERAL PLAN AND TYPICAL SECTION, SEE DRAWINGS ST-K1450-A AND ST-K3450-A.
- 8. FOR ASH SLOUGH BRIDGE GENERAL PLAN AND TYPICAL SECTIONS, SEE DRAWINGS ST-K1455-A AND ST-K3455-A.
- 9. FOR HST SB BRIDGE OVER ASH SLOUGH GENERAL PLAN AND TYPICAL SECTIONS, SEE DRAWINGS ST-K1655-A AND ST-K3655-A.

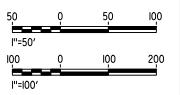


CALIFORNIA HIGH-SPEED TRAIN PROJECT MERCED TO FRESNO SECTION

CENTRAL VALLEY WYE
SR 152 (NORTH) TO ROAD 13 WYE ALTERNATIVE
GENERAL PLAN (SJD-MER)
AERIAL #5 - NORTHBOUND OVER HST MERCED TO FRESNO - 1 OF 5

CONTRACT NO.
HSR08-05
DRAWING NO.
ST-K1650-A
SCALE
AS SHOWN
SHEET NO.

TOP OF RAIL PROFILE (HST NB TRACK SJD-MER)

NO SCALE

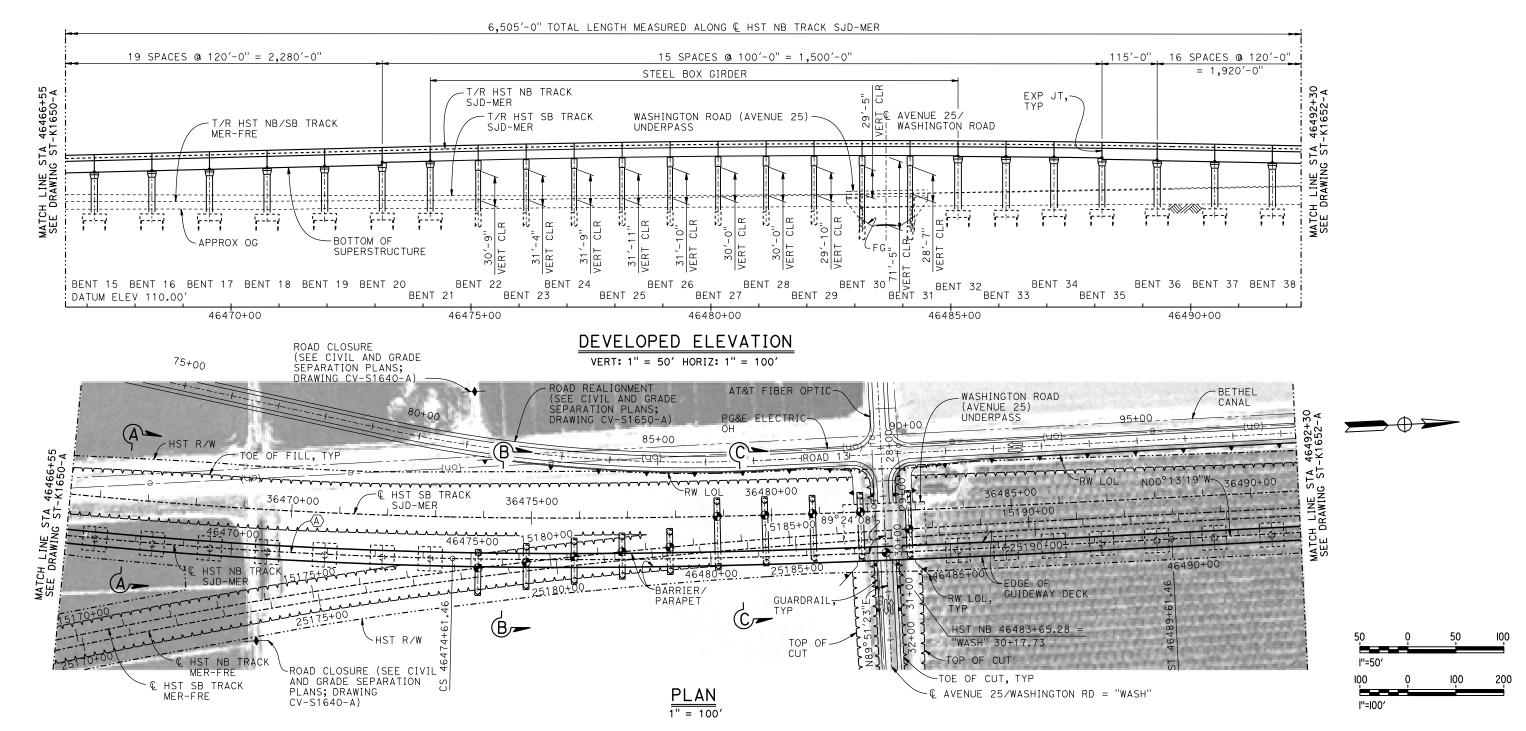

DESIGNED BY S. J. S. DRAWN BY R. M. CHECKED BY O. EDEWOR IN CHARGE C. LEMLEY CONSTRUCTION

DESCRIPTION

02/13/2015

BY CHK APP


PARSONS




CALIFORNIA HIGH-SPEED TRAIN PROJECT MERCED TO FRESNO SECTION


CENTRAL VALLEY WYE
SR 152 (NORTH) TO ROAD 13 WYE ALTERNATIVE
GENERAL PLAN (SJD-MER)
AERIAL #5 - NORTHBOUND OVER HST MERCED TO FRESNO - 2 OF

| | CONTRACT NO. |
|---|--------------|
| | HSR08-05 |
| | DRAWING NO. |
| | ST-K1651-A |
| | SCALE |
| | AS SHOWN |
| 5 | SHEET NO. |
| | |

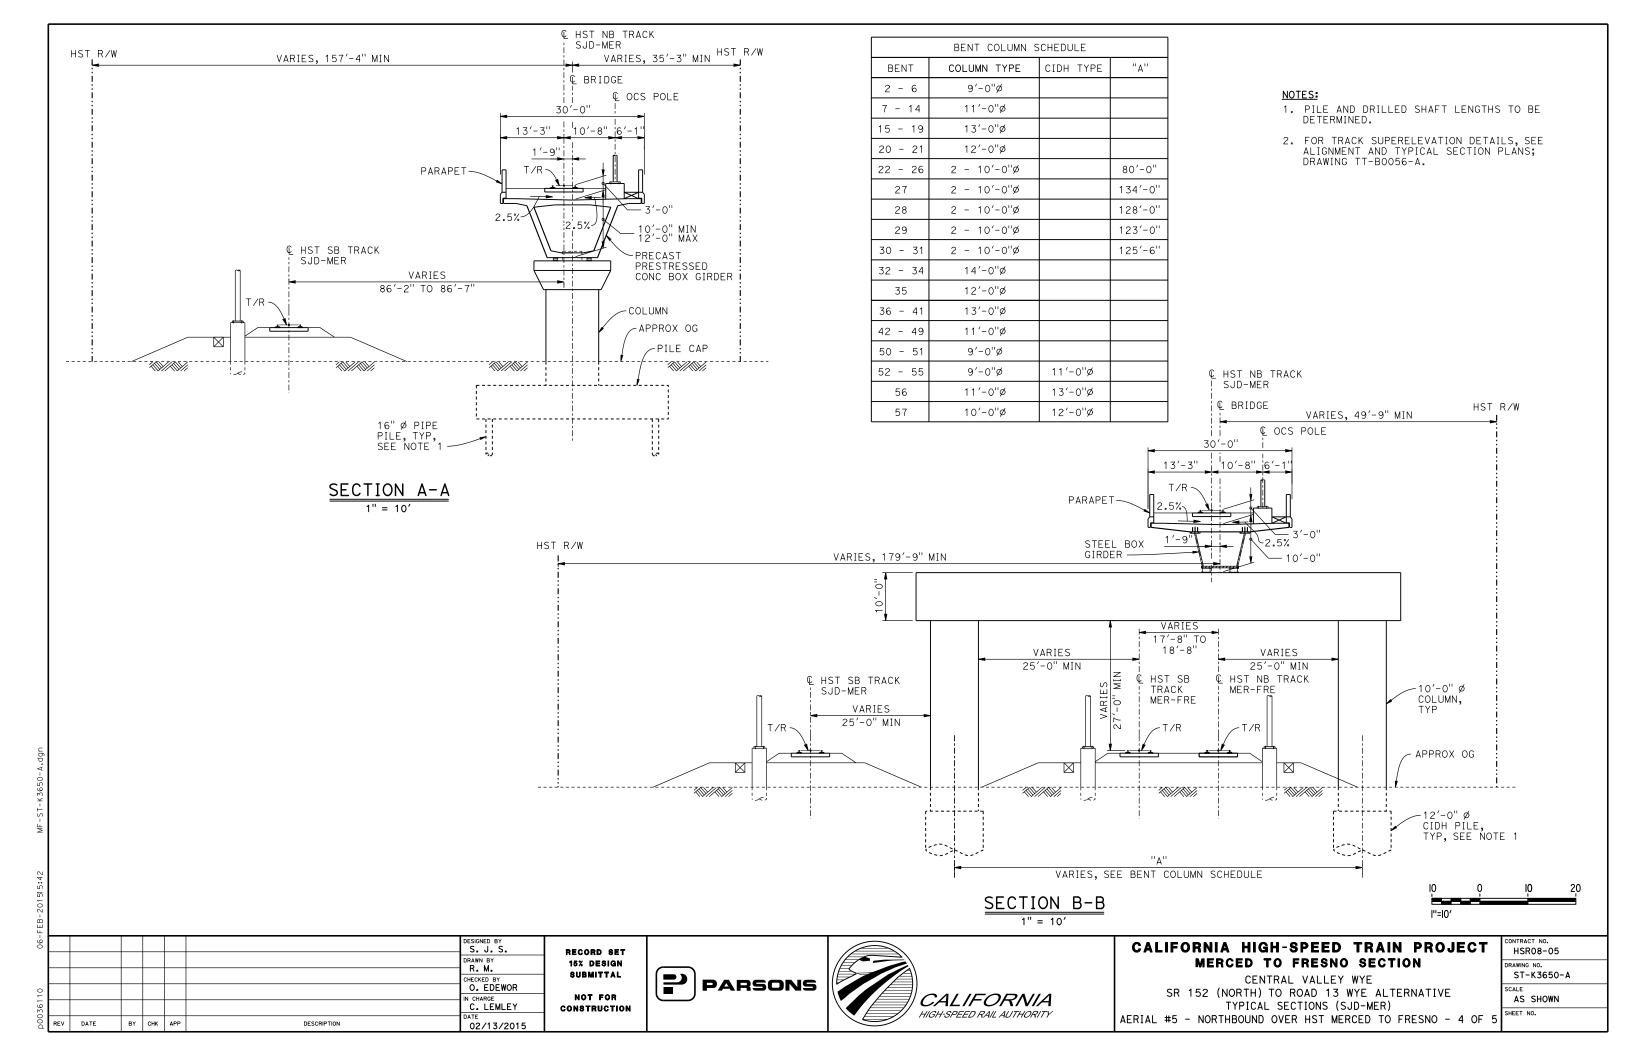

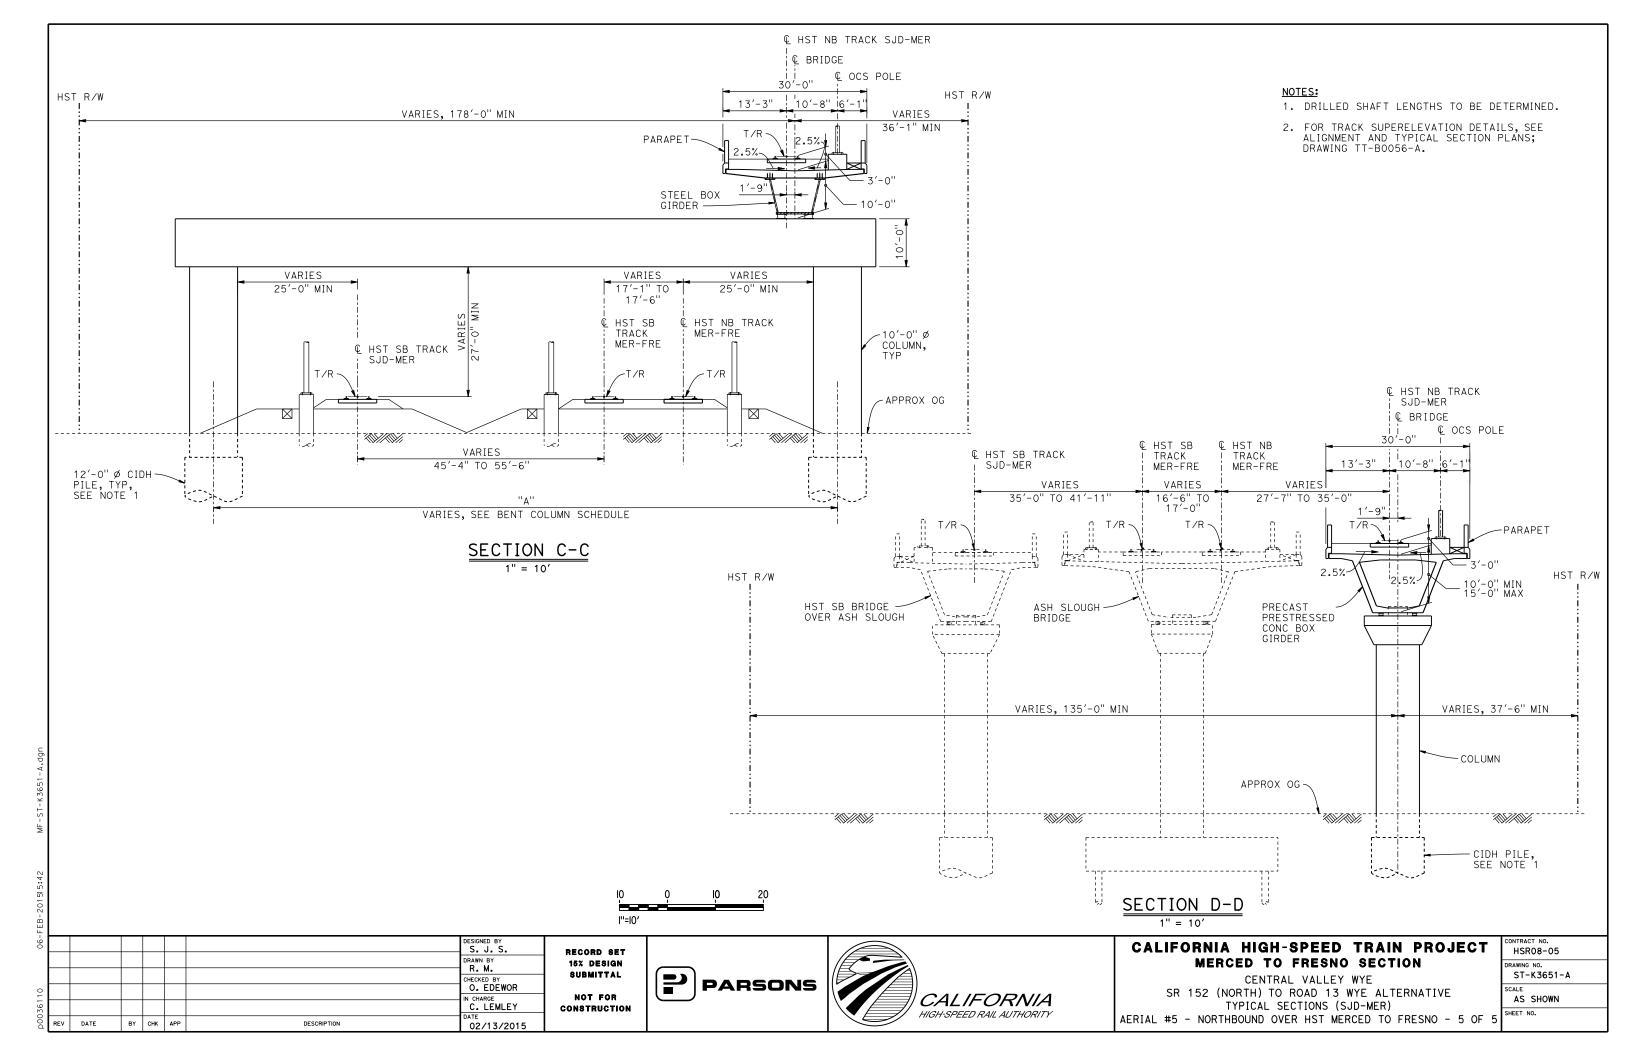

36516+54.59 PVT 36505+54.59 PVC ELEV 257.28' ELEV 250.72' 1100.00' VC 0.16% TEMPORARY TRAFFIC OPENINGS 1.04% R/C=-0.080%/STA VEHICULAR TRAFFIC TOP OF RAIL PROFILE (HST SB TRACK SJD-MER) 1. __TRAFFIC WILL BE DETOURED AWAY FROM THE SITE. NO SCALE 2. \underline{X} TRAFFIC WILL PASS UNDER THE STRUCTURE ON: 690'-0" MEASURED ALONG € HST SB TRACK SJD-MER FALSEWORK ST OR ROAD NAME OPENING REQD (HORIZ X VERT) 4 SPACES @ 100'-0" = 400'-0" 140'-0" AND LOCATION BB –EB AVENUE $25\frac{1}{2}$ 36508+73 32'x16.5' 2-WAY AVENUE $25\frac{1}{2}$ (APPROX) 3. _ TEMP TRAFFIC LANE REDUCTION FOR T/R HST NB TRACK T/R HST SB/NB TRACK T/R HST SB TRACK ∠EXP JT, FTG EXC. AERIAL #5~ MER-FRE SJD-MER SJD-MER TYP £=3 FG-יר לבי יו [] -HW=225.0' LEGEND: APPROX OG ASH SLOUGH BOTTOM OF INDICATES POINT OF MINIMUM **Q** ASH SLOUGH BRIDGE SUPERSTRUCTURE VERTICAL CLEARANCE (APPROX) BENT 2 BENT 3 BENT 4 BENT 5 BENT 6 ABUT 1 ABUT 7 DATUM ELEV 130.00 INDICATES DIRECTION OF FLOW 36506+00 36507+00 36508+00 36509+00 36510+00 36511+00 36512+00 36513+00 36514+00 36515+00 36516+00 STRUCTURE APPROACH ELEVATION SLOPE PAVING (11/2H:1V) 1'' = 50'ELECTRIC OH ROAD 13 TOE OF FILL -€ HST SB TRACK MER-FRE : NOTES: TOE OF FILL BB STA 36507+19.24 1. 16" Ø PIPE PILES ASSUMED FOR ABUTMENT AND BENT T/R ELEV 252.32' FOUNDATIONS. PILE LENGTHS TO BE DETERMINED. EDGE OF GUIDEWAY TOP OF FILL DECK T/R ELEV 256.66' 2. FOR SECTION AND BENT COLUMN SCHEDULE, SEE 36506+00 DRAWING ST-K3655-A. 36515+00 3. ANY EXISTING DIRT ROAD THAT CONFLICTS WITH NEW CONSTRUCTION SHALL BE REALIGNED. 5220+00 4. FOR UTILITY DISPOSITIONS, SEE CIVIL AND GRADE SEPARATION PLANS; DRAWING CV-S1650-A. 25210+00 5. FOR GUARDRAIL, SEE CIVIL AND GRADE SEPARATION 25220+00 PLANS; DRAWING CV-S1650-A. TOP OF FILE 6. FOR ASH SLOUGH BRIDGE GENERAL PLAN AND TYPICAL SECTIONS, SEE DRAWINGS ST-K1455-A AND ST-K3455-A ℃ HST NB TRACK C HST NB TRACK TOP OF FILL TOE OF FILL -7. FOR AERIAL #5 - NORTHBOUND OVER HST MERCED TO FRESNO GENERAL PLAN AND TYPICAL SECTIONS, SEE DRAWINGS ST-K1650-A TO ST-K1652-A, ST-K3650-A GUARDRAIL TYP AND ST-K3651-A. TOE OF FILL HST R/W PLAN I"=50' 1" = 50' DESIGNED BY CALIFORNIA HIGH-SPEED TRAIN PROJECT HSR08-05 RECORD SET DRAWN BY
W. JOHNSEN MERCED TO FRESNO SECTION 15% DESIGN RAWING NO. SUBMITTAL ST-K1655-A CENTRAL VALLEY WYE O. EDEWOR **PARSONS** SR 152 (NORTH) TO ROAD 13 WYE ALTERNATIVE NOT FOR **CALIFORNIA** AS SHOWN N CHARGE C. LEMLEY GENERAL PLAN (SJD-MER) CONSTRUCTION HIGH-SPEED RAIL AUTHORITY SHEET NO. HST SB BRIDGE OVER ASH SLOUGH - 1 OF 2 DATE BY CHK APP DESCRIPTION 02/13/2015

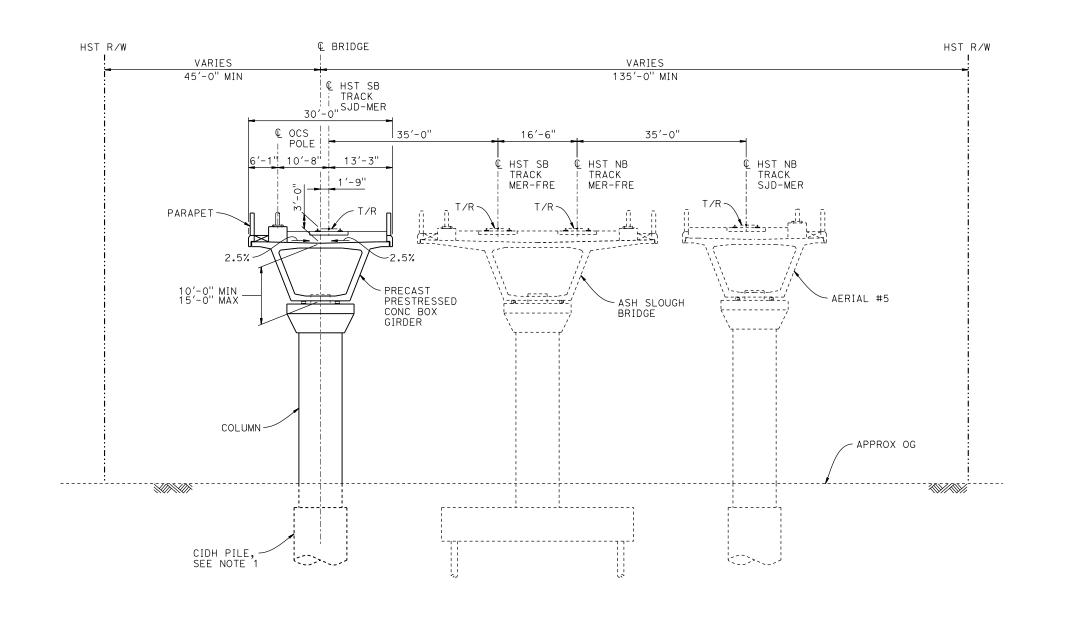

TYPICAL SECTION

| | | BENT COLUMN SCHED | ULE |
|--|-------|-------------------|-----------|
| | BENT | COLUMN TYPE | CIDH TYPE |
| | 2 - 4 | 9'-0" Ø | 11'-0" Ø |
| | 5 | 11'-0" Ø | 13'-0" Ø |
| | 6 | 10'-0" Ø | 12'-0" Ø |

NOTES:

1. DRILLED SHAFT LENGTHS TO BE DETERMINED.

| H. | | | | | | | | |
|------|-----|------|----|-----|-----|-------------|----------------------|-------------|
| -90 | | | | | | | DESIGNED BY | REC |
| | | | | | | | DRAWN BY | 15% |
| 0 | | | | | | | CHECKED BY O. EDEWOR | \$ U |
| 3611 | | | | | | | IN CHARGE C. LEMLEY | N CON |
| D00 | REV | DATE | BY | снк | APP | DESCRIPTION | 02/13/2015 | |

RECORD SET
15% DESIGN
SUBMITTAL
NOT FOR
CONSTRUCTION






CALIFORNIA HIGH-SPEED TRAIN PROJECT MERCED TO FRESNO SECTION

CENTRAL VALLEY WYE
SR 152 (NORTH) TO ROAD 13 WYE ALTERNATIVE
TYPICAL SECTION (SJD-MER)
HST SB BRIDGE OVER ASH SLOUGH - 2 OF 2

| CONTRACT NO. HSR08-05 |
|---------------------------|
| DRAWING NO. ST-K3655-A |
| 31-K3655-A |
| SCALE |
| AS SHOWN |
| SHEET NO. |
| |

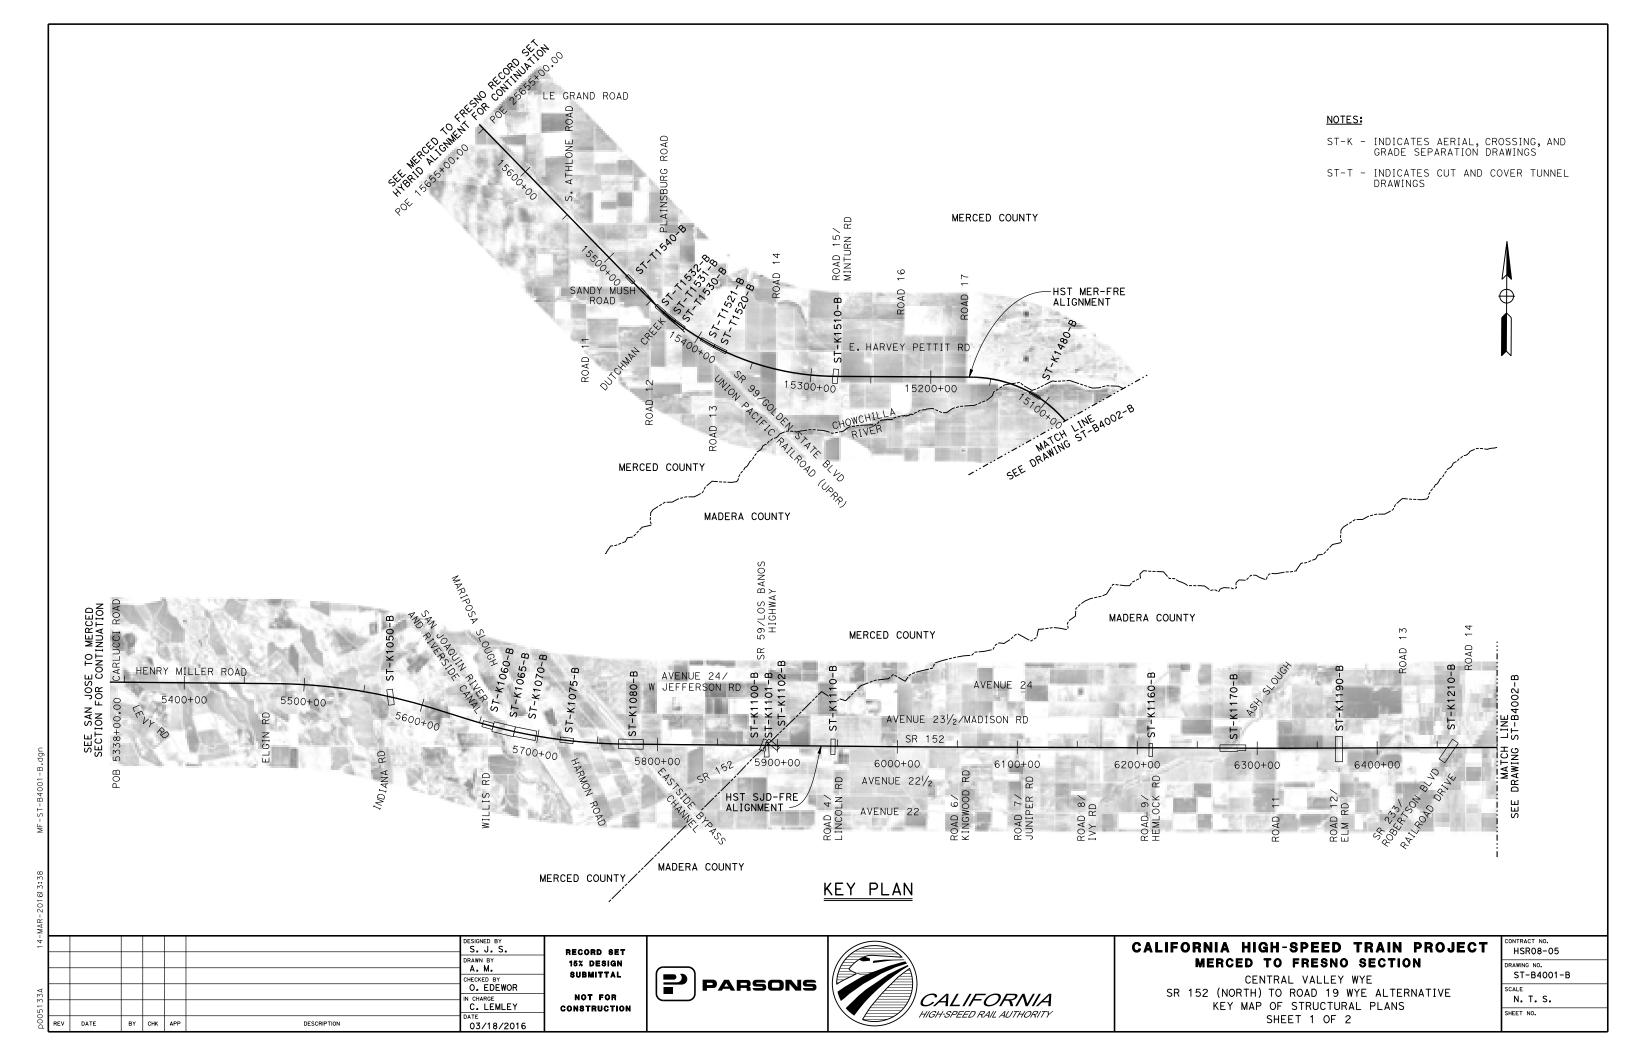



RECORD SET

15% DESIGN SUBMITTAL

NOT FOR

CONSTRUCTION

PARSONS

CALIFORNIA

HIGH-SPEED RAIL AUTHORITY

DRAWN BY

BY CHK APP

DESCRIPTION

A. GURA

C. LEMLEY

03/18/2016

NOTES:


ST-K - INDICATES AERIAL, CROSSING, AND GRADE SEPARATION DRAWINGS




CALIFORNIA HIGH-SPEED TRAIN PROJECT MERCED TO FRESNO SECTION

CENTRAL VALLEY WYE SR 152 (NORTH) TO ROAD 19 WYE ALTERNATIVE KEY MAP OF STRUCTURAL PLANS SHEET 2 OF 2

| CONTRACT NO. HSR08-05 |
|---------------------------|
| DRAWING NO. ST-B4002-B |
| N. T. S. |
| SHEET NO. |

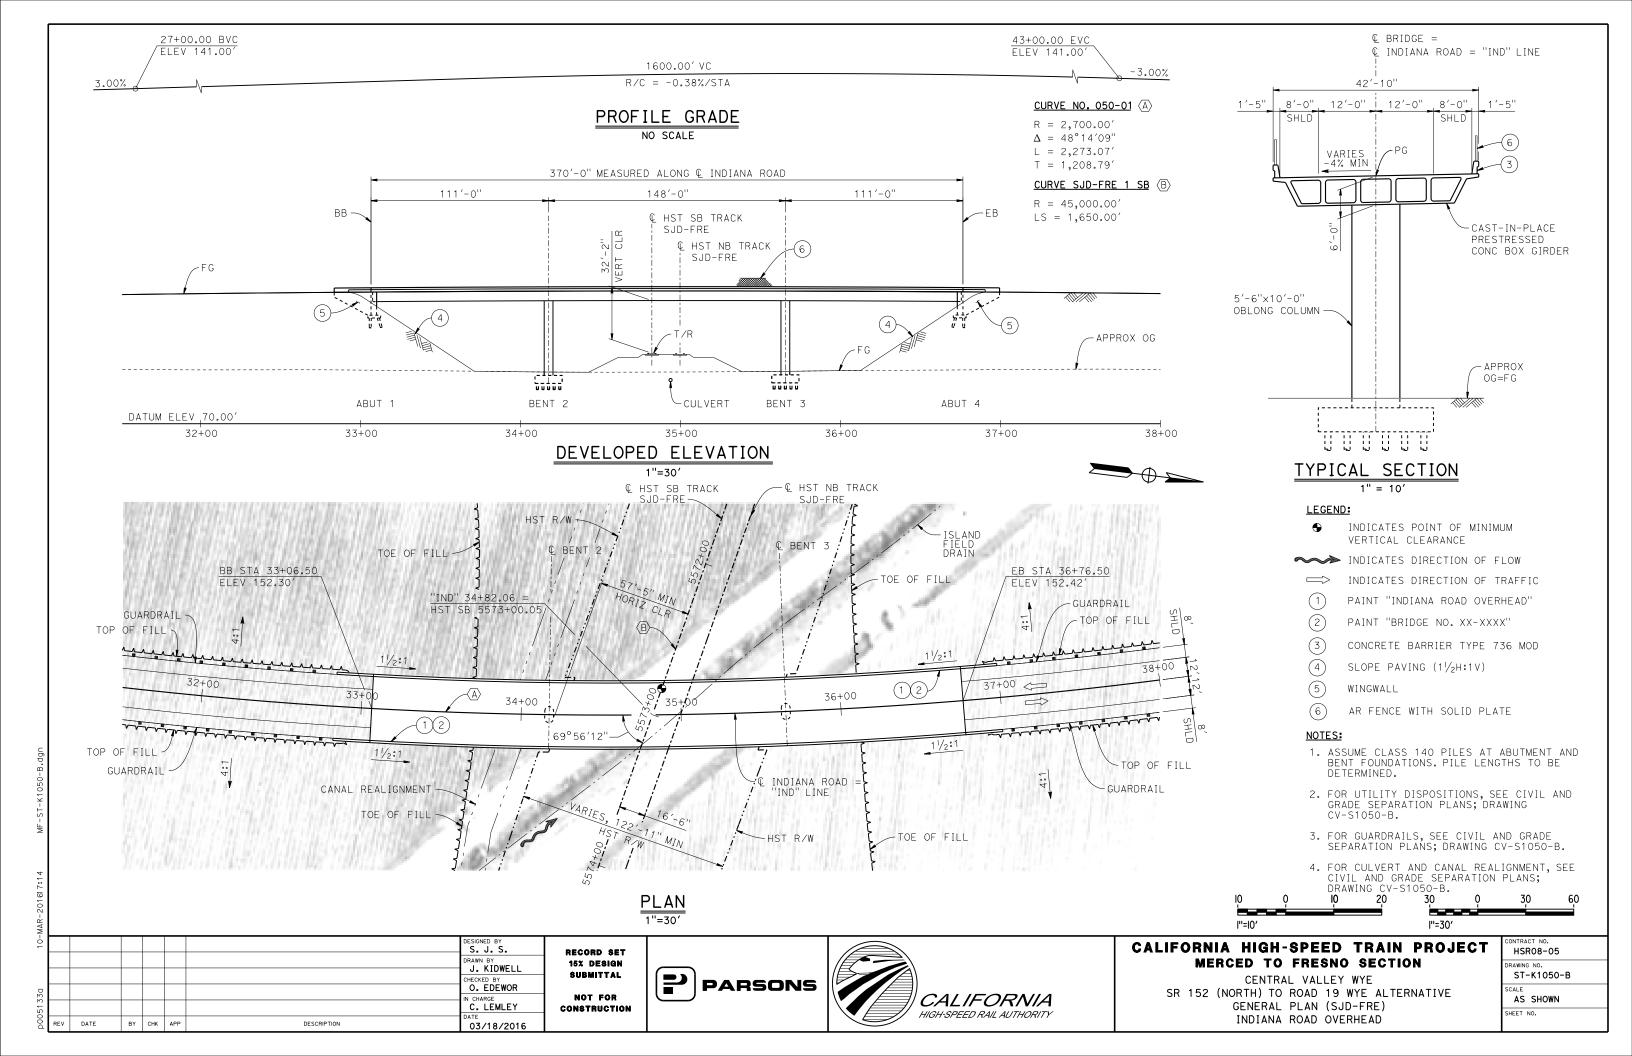

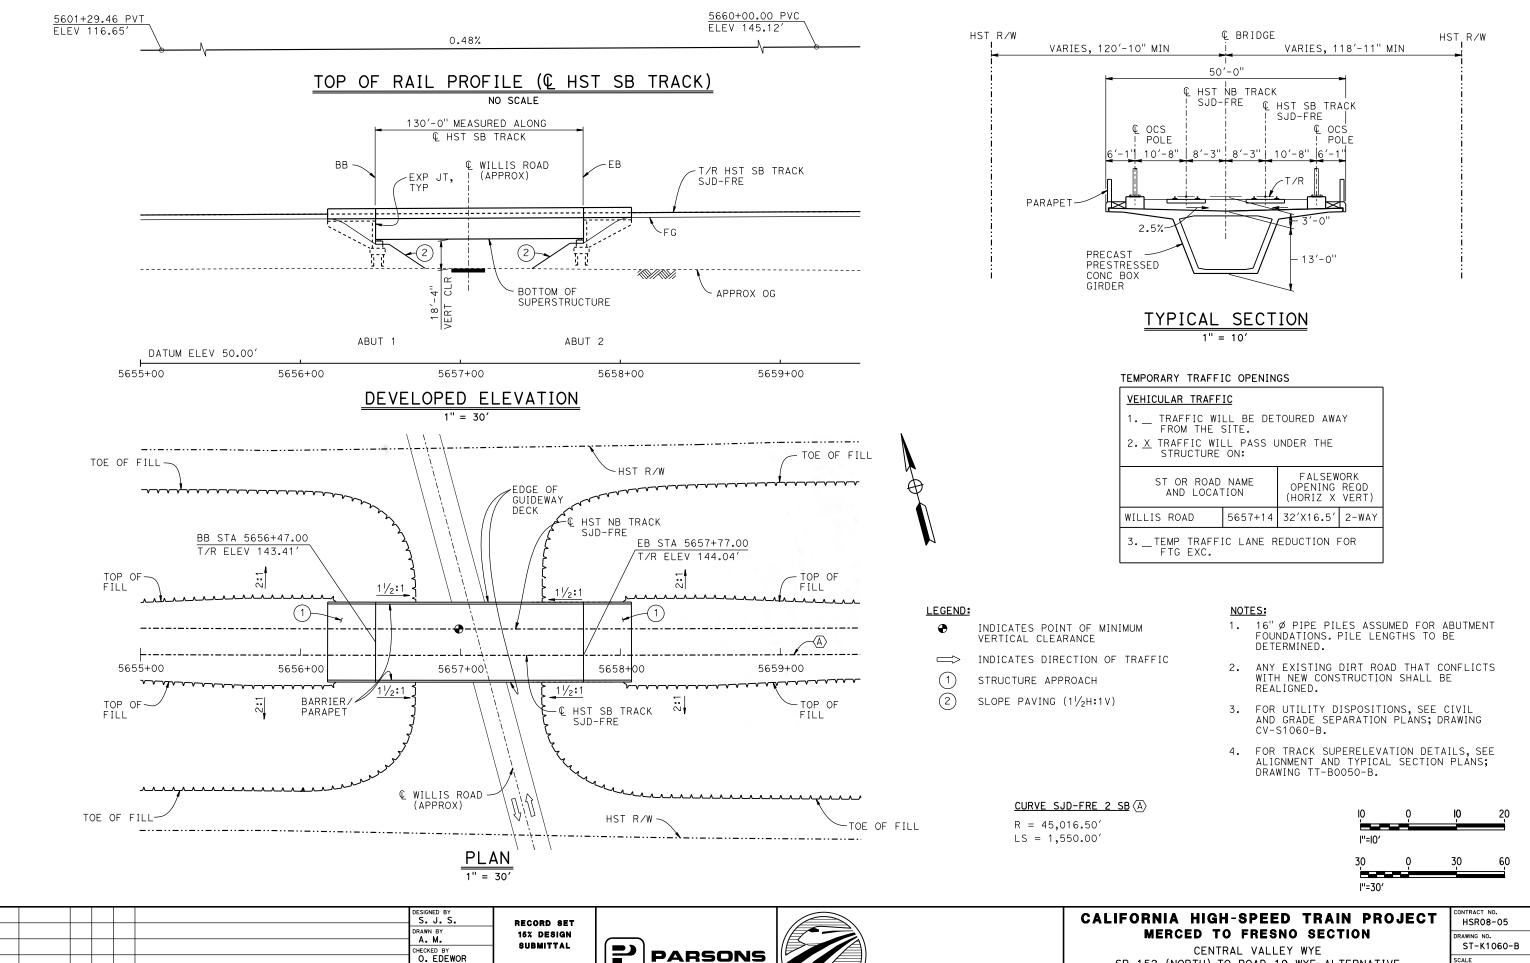

CALIFORNIA

HIGH-SPEED RAIL AUTHORITY

NOT FOR

CONSTRUCTION

IN CHARGE

C. LEMLEY

02/13/2015

DATE

BY CHK APP


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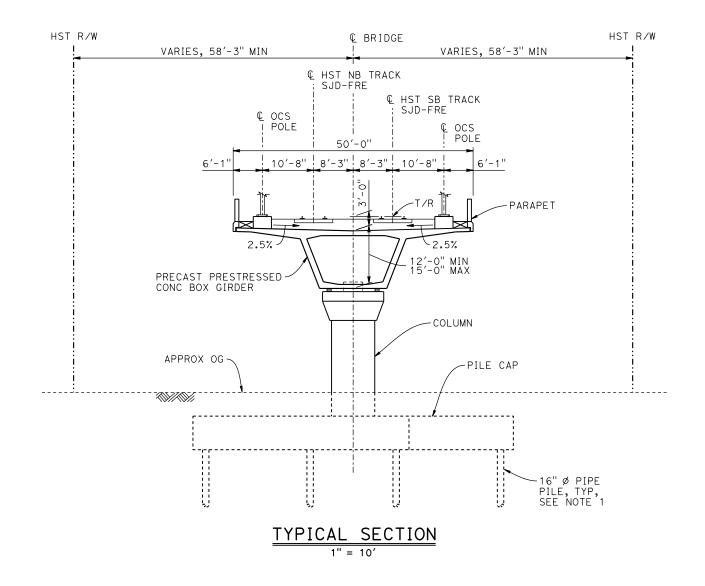
AS SHOWN SHEET NO.

SR 152 (NORTH) TO ROAD 19 WYE ALTERNATIVE

GENERAL PLAN (SJD-FRE)

WILLIS ROAD UNDERPASS



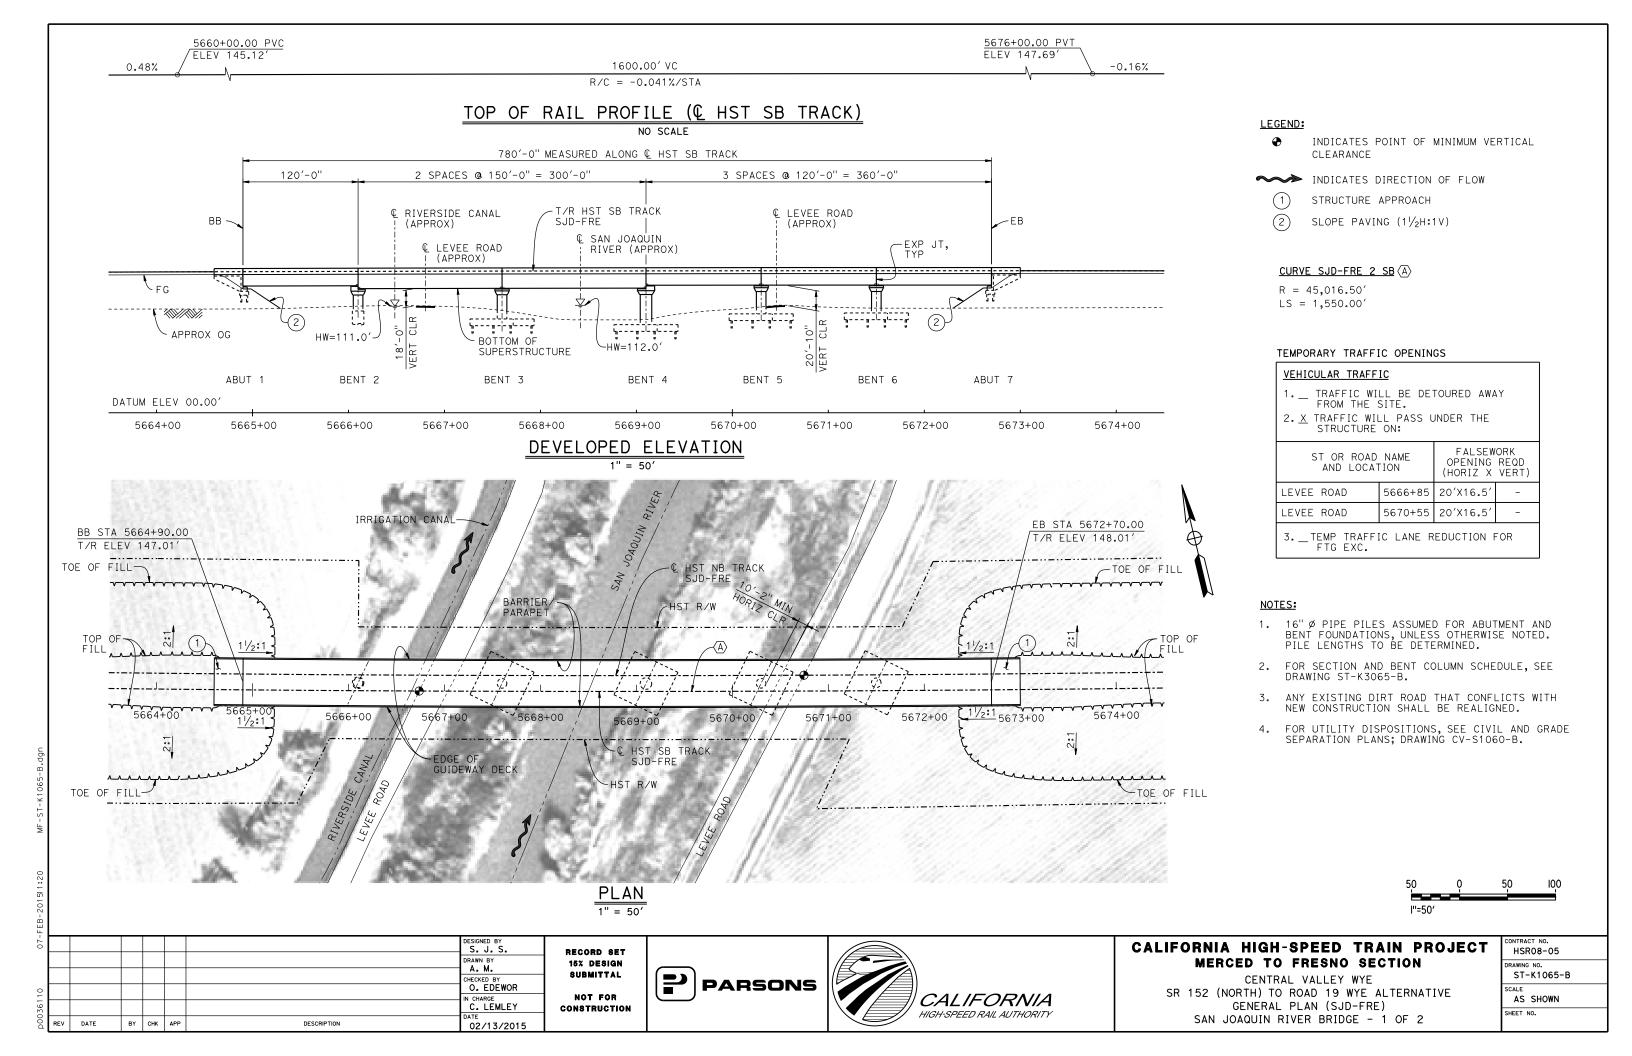

| BENT COLUMN SCHEDULE | | | | | | | |
|----------------------|-------------|----------|--|--|--|--|--|
| BENT | COLUMN TYPE | CIDH | | | | | |
| 2 | 10'-0'' Ø | 12'-0" Ø | | | | | |
| 3 | 10'-0" Ø | | | | | | |
| 4 | 12′-0" ø | | | | | | |
| 5 - 6 | 10'-0" Ø | | | | | | |

NOTES:

- 1. PILE AND DRILLED SHAFT LENGTHS TO BE DETERMINED.
- 2. FOR TRACK SUPERELEVATION DETAILS, SEE ALIGNMENT AND TYPICAL SECTION PLANS; DRAWING TT-BOO50-B.



| 님 | Щ, | | | | | | | |
|------|-----|------|----|-----|-----|-------------|----------------------|---------|
| 07 | | | | | | | DESIGNED BY S. J. S. | |
| | | | | | | | DRAWN BY A. M. | RI 1 |
| 0 | | | | | | | CHECKED BY O. EDEWOR | 8 |
| 3611 | | | | | | | IN CHARGE C. LEMLEY | co |
| 00d | REV | DATE | BY | снк | APP | DESCRIPTION | 02/13/2015 | |

RECORD SET
15% DESIGN
SUBMITTAL
NOT FOR
CONSTRUCTION








CALIFORNIA HIGH-SPEED TRAIN PROJECT MERCED TO FRESNO SECTION


CENTRAL VALLEY WYE
SR 152 (NORTH) TO ROAD 19 WYE ALTERNATIVE
TYPICAL SECTION (SJD-FRE)
SAN JOAQUIN RIVER BRIDGE - 2 OF 2

| CONTRACT NO. | | | | | | | |
|--------------|--|--|--|--|--|--|--|
| HSR08-05 | | | | | | | |
| DRAWING NO. | | | | | | | |
| ST-K3065-B | | | | | | | |
| SCALE | | | | | | | |
| AS SHOWN | | | | | | | |
| SHEET NO. | | | | | | | |
| | | | | | | | |

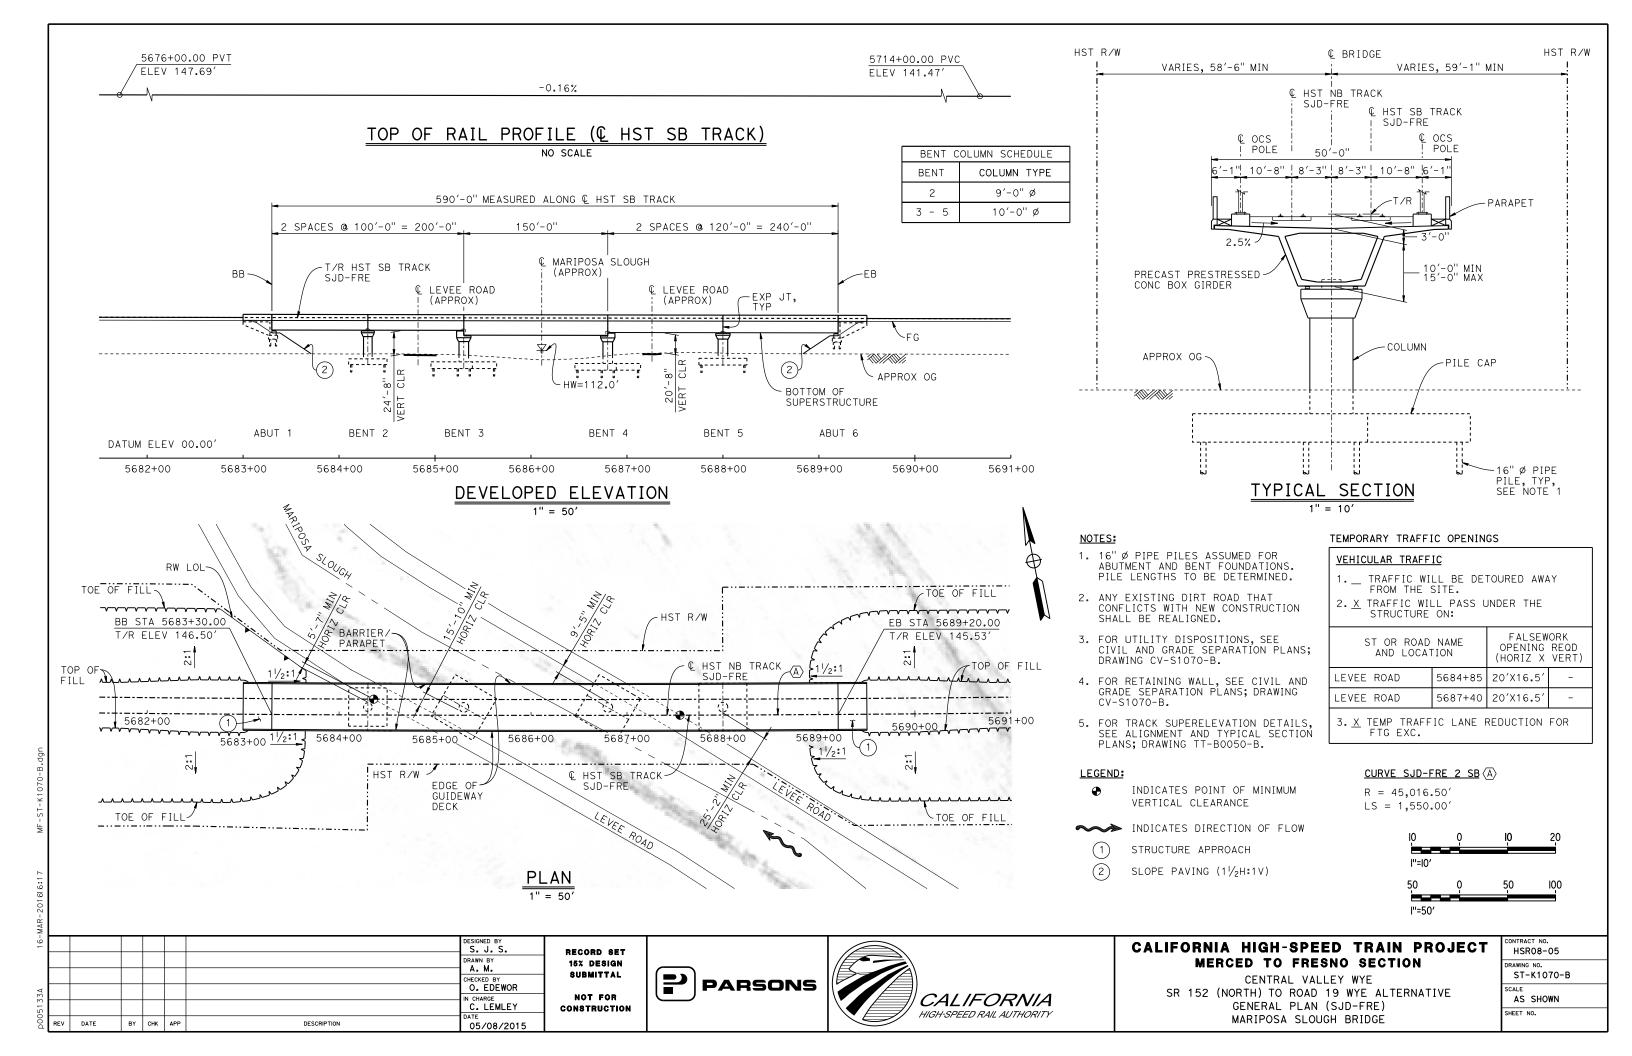

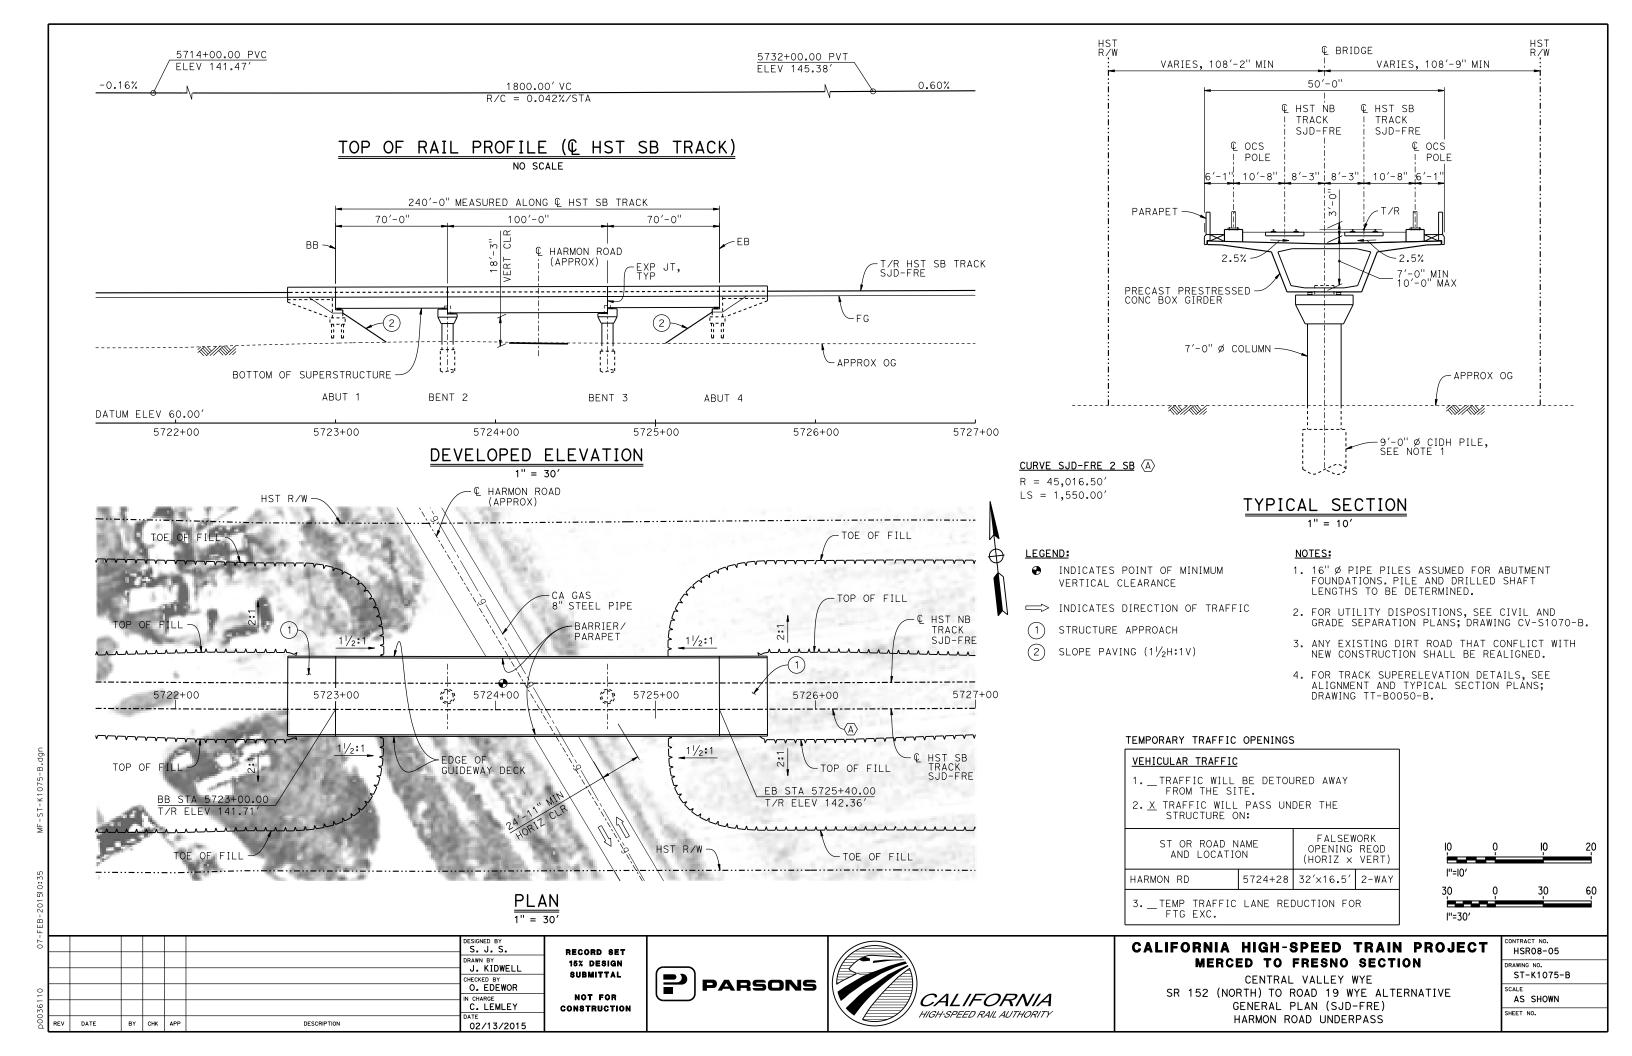

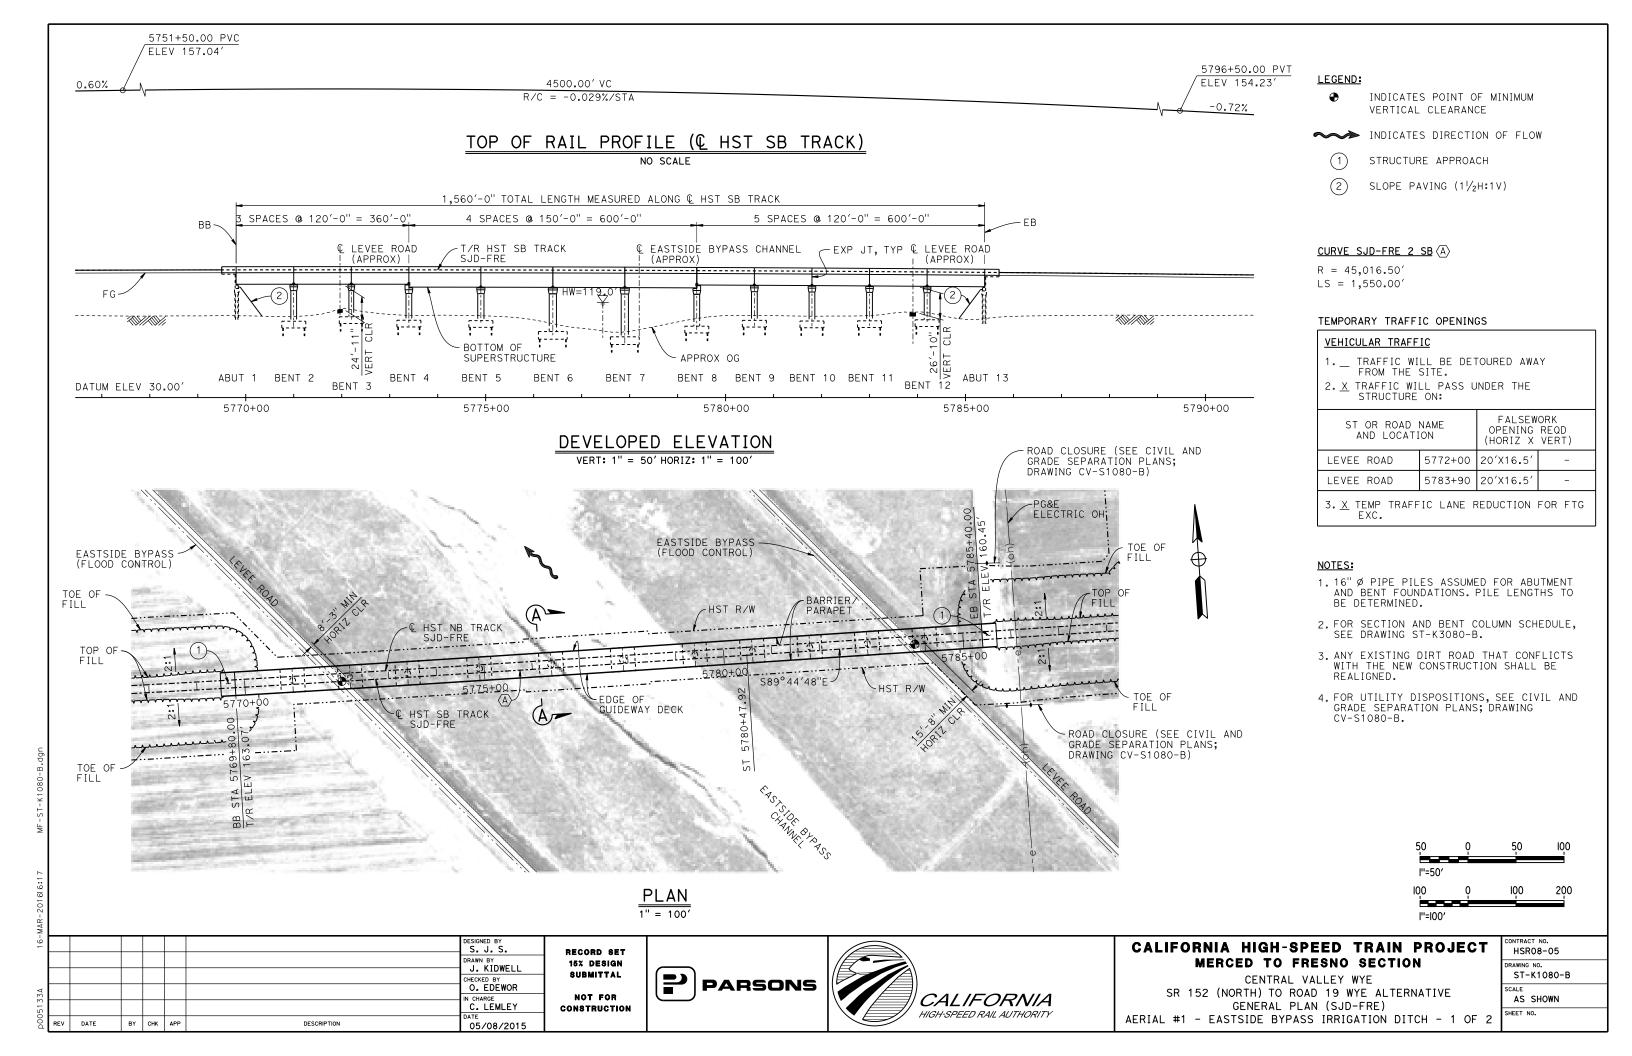

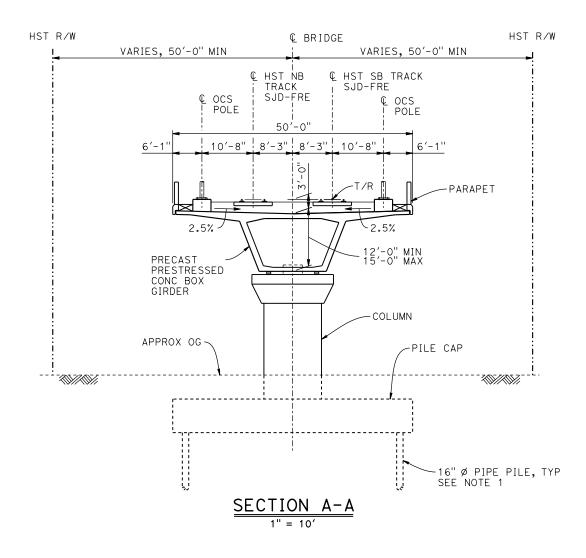

| BENT C | OLUMN SCHEDULE |
|--------|----------------|
| BENT | COLUMN TYPE |
| 2 | 12′-0" ø |
| 3 | 10'-0" Ø |
| 4 | 12'-0" Ø |
| 5 | 13'-0" Ø |
| 6 - 7 | 15′-0'' ø |
| 8 - 12 | 12'-0" Ø |

NOTES:

- 1. PILE LENGTHS TO BE DETERMINED.
- 2. FOR TRACK SUPERELEVATION DETAILS, SEE ALIGNMENT AND TYPICAL SECTION PLANS; DRAWING TT-B0050-B.



| ij | | | | | | | | |
|------|-----|------|----|-----|-----|-------------|----------------------|----------|
| -20 | | | | | | | DESIGNED BY | |
| | | | | | | | DRAWN BY | R 1 |
| 0 | | | | | | | CHECKED BY O. EDEWOR | |
| 3611 | | | | | | | IN CHARGE C. LEMLEY | co |
| 00d | REV | DATE | ВҮ | СНК | APP | DESCRIPTION | DATE 02/13/2015 | |

RECORD SET
15% DESIGN
SUBMITTAL
NOT FOR
CONSTRUCTION






CALIFORNIA HIGH-SPEED TRAIN PROJECT MERCED TO FRESNO SECTION


CENTRAL VALLEY WYE


SR 152 (NORTH) TO ROAD 19 WYE ALTERNATIVE
TYPICAL SECTION (SJD-FRE)

AERIAL #1 - EASTSIDE BYPASS IRRIGATION DITCH - 2 OF 2

| Т | CONTRACT NO. HSRO8-05 |
|---|---------------------------|
| | DRAWING NO. ST-K3080-B |
| | AS SHOWN |

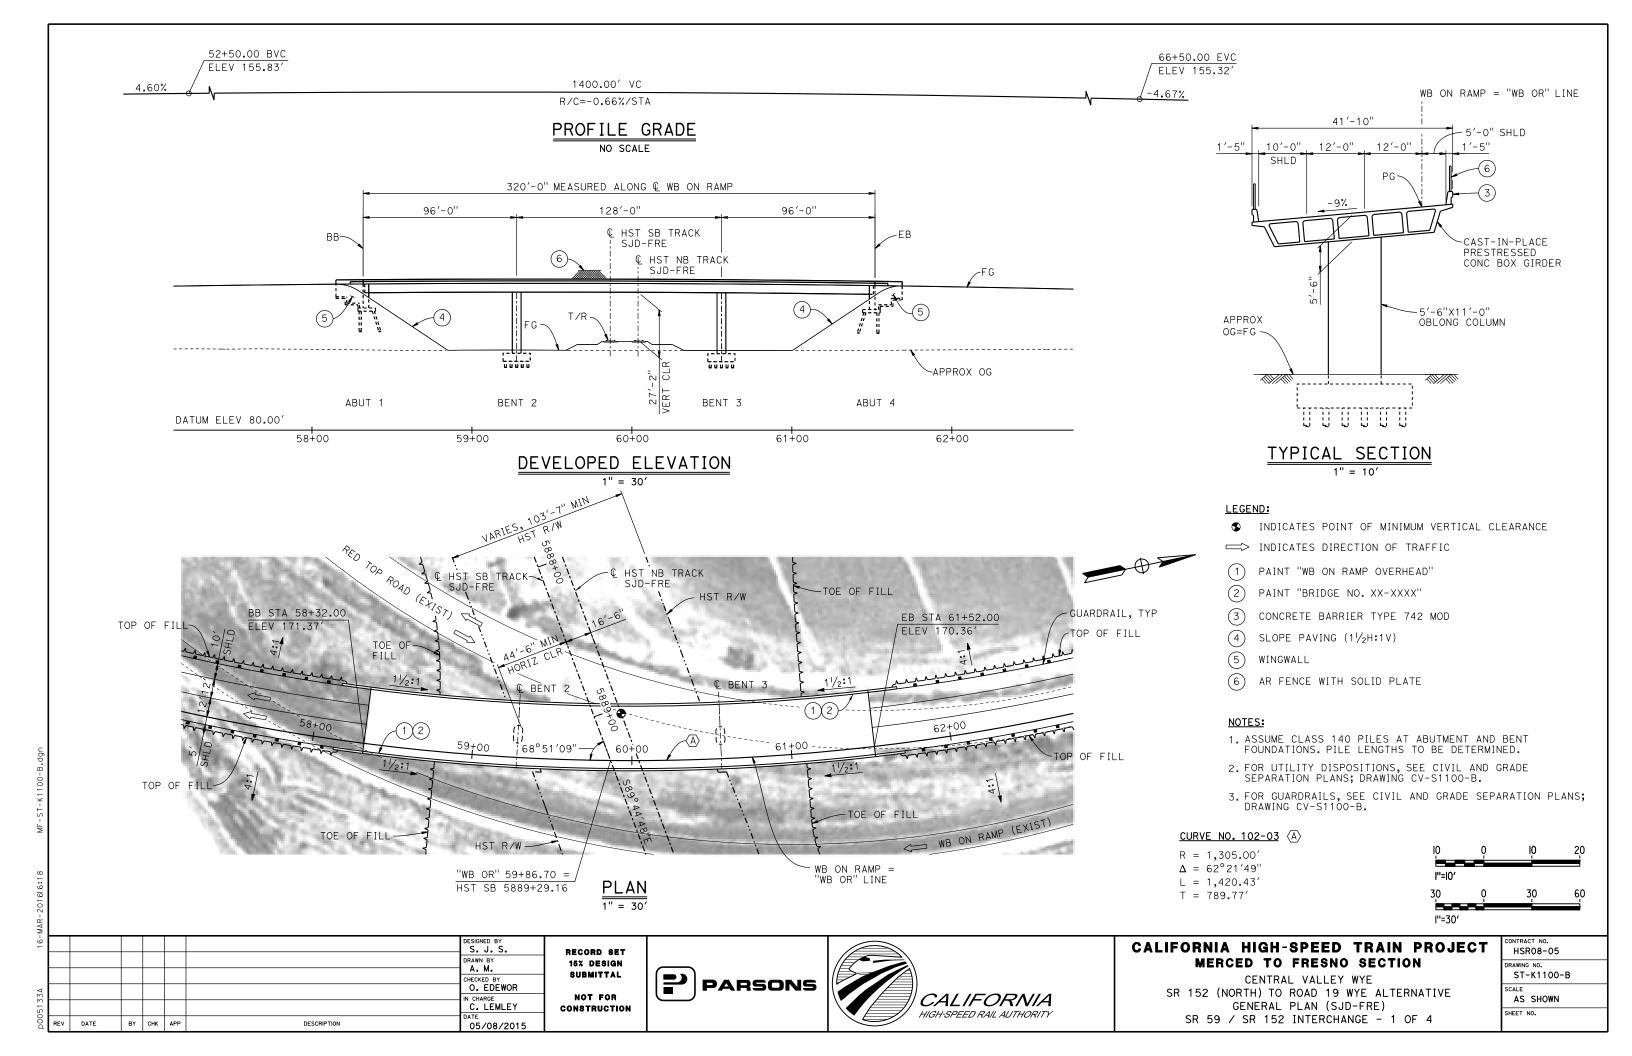

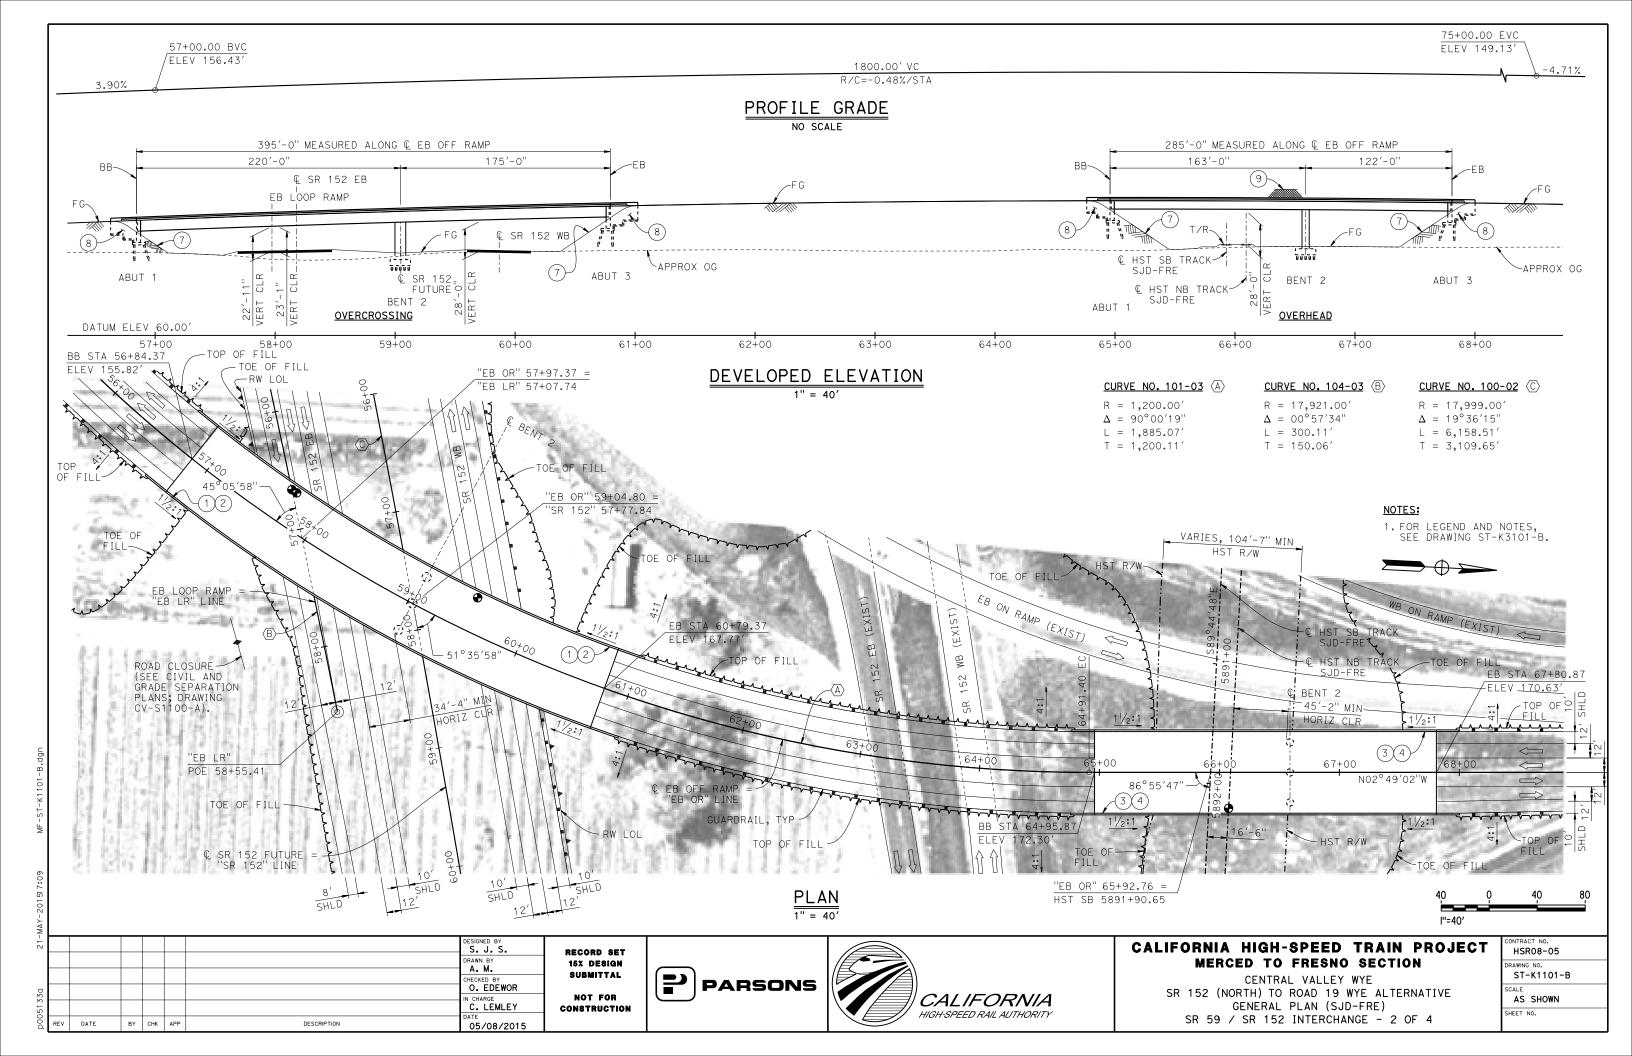


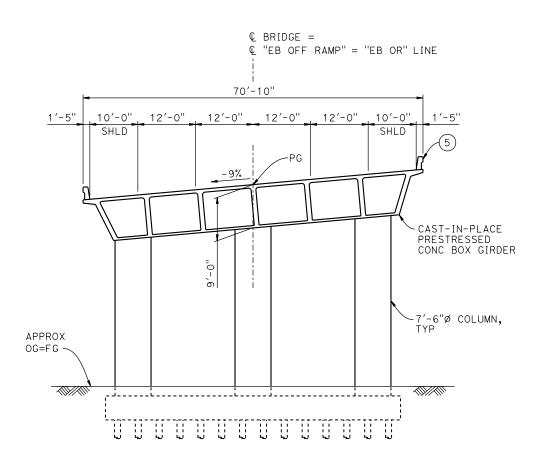

TYPICAL SECTION AT OVERCROSSING

LEGEND:


- INDICATES POINT OF MINIMUM VERTICAL CLEARANCE
- (1) PAINT "EB OFF RAMP OVERCROSSING"
- (2) PAINT "BRIDGE NO. XX-XXXX"
- (3) PAINT "EB OFF RAMP OVERHEAD"
- (4) PAINT "BRIDGE NO. XX-XXXX"
- (5) CONCRETE BARRIER TYPE 742
- (6) CONCRETE BARRIER TYPE 736 MOD
- (7) SLOPE PAVING $(1\frac{1}{2}H:1V)$
- (8) WINGWALL
- 9) AR FENCE WITH SOLID PLATE

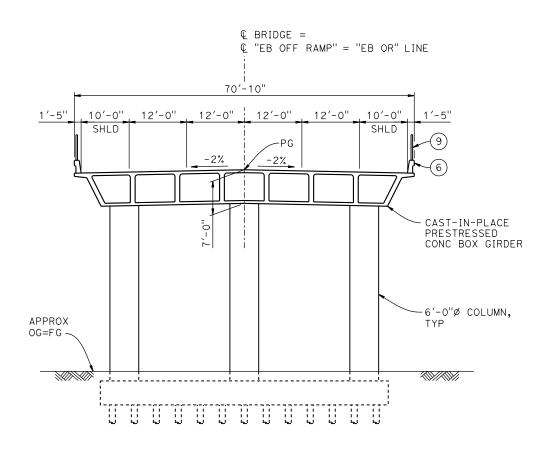

TYPICAL SECTION AT OVERHEAD

NOTES:

- 1. ASSUME CLASS 140 PILES AT ABUTMENT AND BENT FOUNDATIONS. PILE LENGTHS TO BE DETERMINED.
- 2. FOR UTILITY DISPOSITIONS, SEE CIVIL AND GRADE SEPARATION PLANS; DRAWING CV-S1100-B.
- 3. FOR RETAINING WALLS, SEE CIVIL AND GRADE SEPARATION PLANS; DRAWING CV-S1100-B.
- 4. FOR GUARDRAILS, SEE CIVIL AND GRADE SEPARATION PLANS; DRAWING CV-S1100-B.

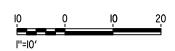

| DESIGNED BY S. J. S. | DRAWN BY A. M. | CHECKED BY O. EDEWOR | IN CHARGE C. LEMLEY | DATE | BY CHK APP | DESCRIPTION | DATE | DATE |

RECORD SET
15% DESIGN
SUBMITTAL
NOT FOR
CONSTRUCTION







CALIFORNIA HIGH-SPEED TRAIN PROJECT MERCED TO FRESNO SECTION


CENTRAL VALLEY WYE
SR 152 (NORTH) TO ROAD 19 WYE ALTERNATIVE
TYPICAL SECTIONS (SJD-FRE)
SR 59 / SR 152 INTERCHANGE - 3 OF 4

| | HSR08-05 | | | | | | | | |
|--|---------------------------|--|--|--|--|--|--|--|--|
| | DRAWING NO. ST-K3101-B | | | | | | | | |
| | AS SHOWN | | | | | | | | |
| | SHEET NO. | | | | | | | | |

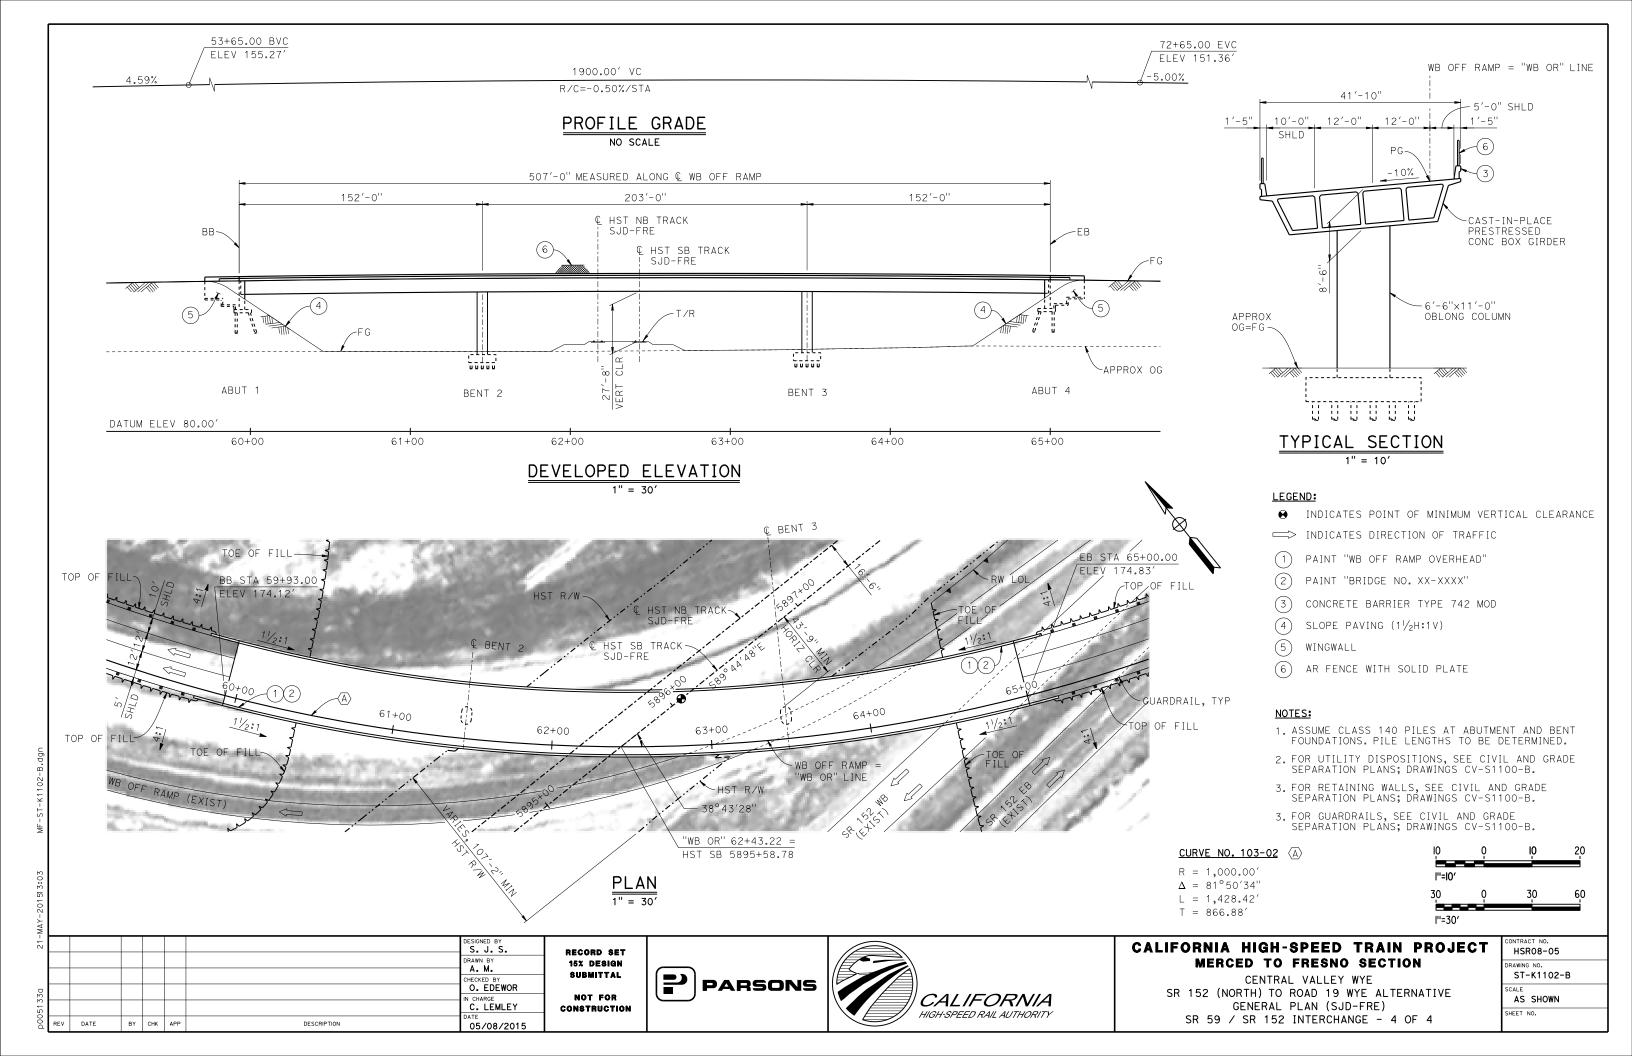


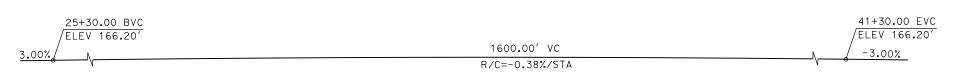


PROFILE GRADE NO SCALE

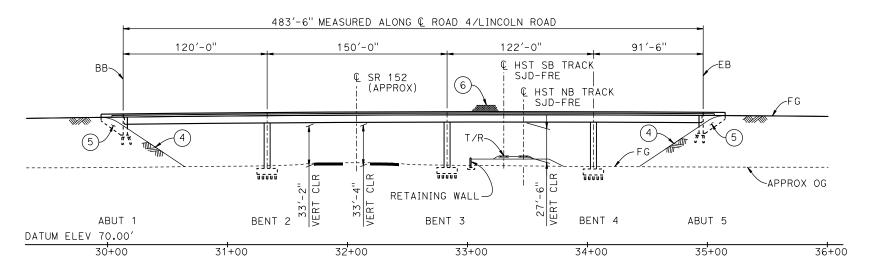

ELEVATION 1" = 40'

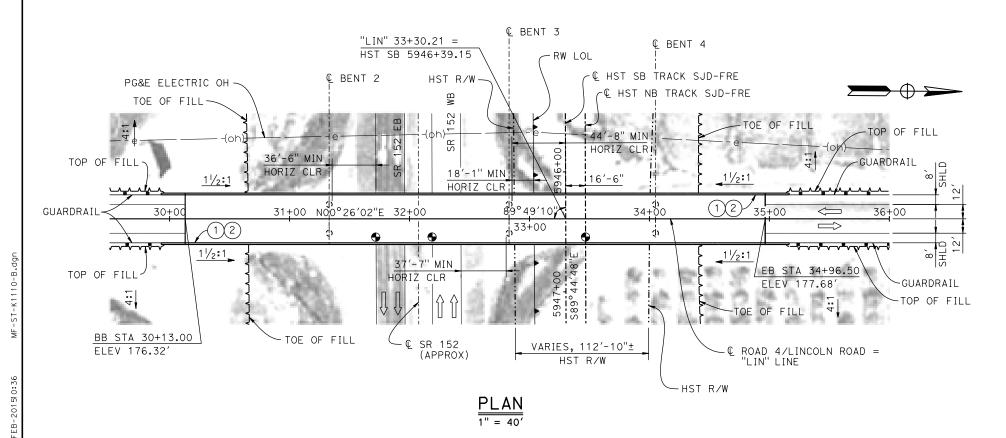

02/13/2015

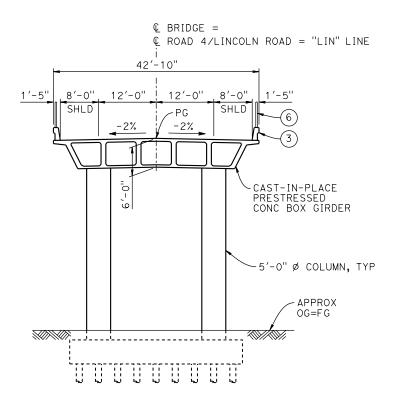

TYPICAL SECTION 1" = 10'

TEMPORARY TRAFFIC OPENINGS

VEHICULAR TRAFFIC

- 1. _ TRAFFIC WILL BE DETOURED AWAY FROM THE SITE.
- 2. \underline{X} TRAFFIC WILL PASS UNDER THE STRUCTURE ON:

| ST OR ROAD AND LOCA | FALSEWORK OPENING REQD (HORIZ X VERT) | | |
|------------------------|---|-----------|-------|
| SR 152 | 31+83 | 40′X16.5′ | E BND |
| SR 152 | 32+30 | 40′X16.5′ | W BND |
| | | | |


3. __TEMP TRAFFIC LANE REDUCTION FOR FTG EXC.

LEGEND:

- INDICATES POINT OF MINIMUM VERTICAL CLEARANCE
- 1 PAINT "LINCOLN ROAD OVERHEAD"
- (2) PAINT "BRIDGE NO. XX-XXXX"
- (3) CONCRETE BARRIER TYPE 736 MOD
- (4) SLOPE PAVING $(1\frac{1}{2}H:1V)$
- (5) WINGWALL
- (6) AR FENCE WITH SOLID PLATE

NOTES:

- ASSUME CLASS 140 PILES AT ABUTMENT AND BENT FOUNDATIONS. PILE LENGTHS TO BE DETERMINED.
- 2. FOR UTILITY DISPOSITIONS, SEE CIVIL AND GRADE SEPARATION PLANS; DRAWING CV-S1110-B.
- 3. FOR RETAINING WALL, SEE CIVIL AND GRADE SEPARATION PLANS; DRAWING CV-S1110-B.
- 4. FOR GUARDRAIL, SEE CIVIL AND GRADE SEPARATION PLANS; DRAWING CV-S1110-B.

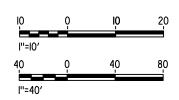

| | | | S. J. S. | l R |
|--|--|--|---------------------|------|
| | | | DRAWN BY J. KIDWELL | 1 |
| | | | CHECKED BY | |
| | | | O. EDEWOR | |
| | | | C. LEMLEY | l co |

DESCRIPTION

DATE

BY CHK APP

RECORD SET
15% DESIGN
SUBMITTAL
NOT FOR
CONSTRUCTION






CALIFORNIA HIGH-SPEED TRAIN PROJECT MERCED TO FRESNO SECTION

CENTRAL VALLEY WYE
SR 152 (NORTH) TO ROAD 19 WYE ALTERNATIVE
GENERAL PLAN (SJD-FRE)
LINCOLN ROAD (ROAD 4) OVERHEAD


| CONTRACT NO. HSR08-05 |
|---------------------------|
| DRAWING NO. ST-K1110-B |
| SCALE AS SHOWN |
| SHEET NO. |

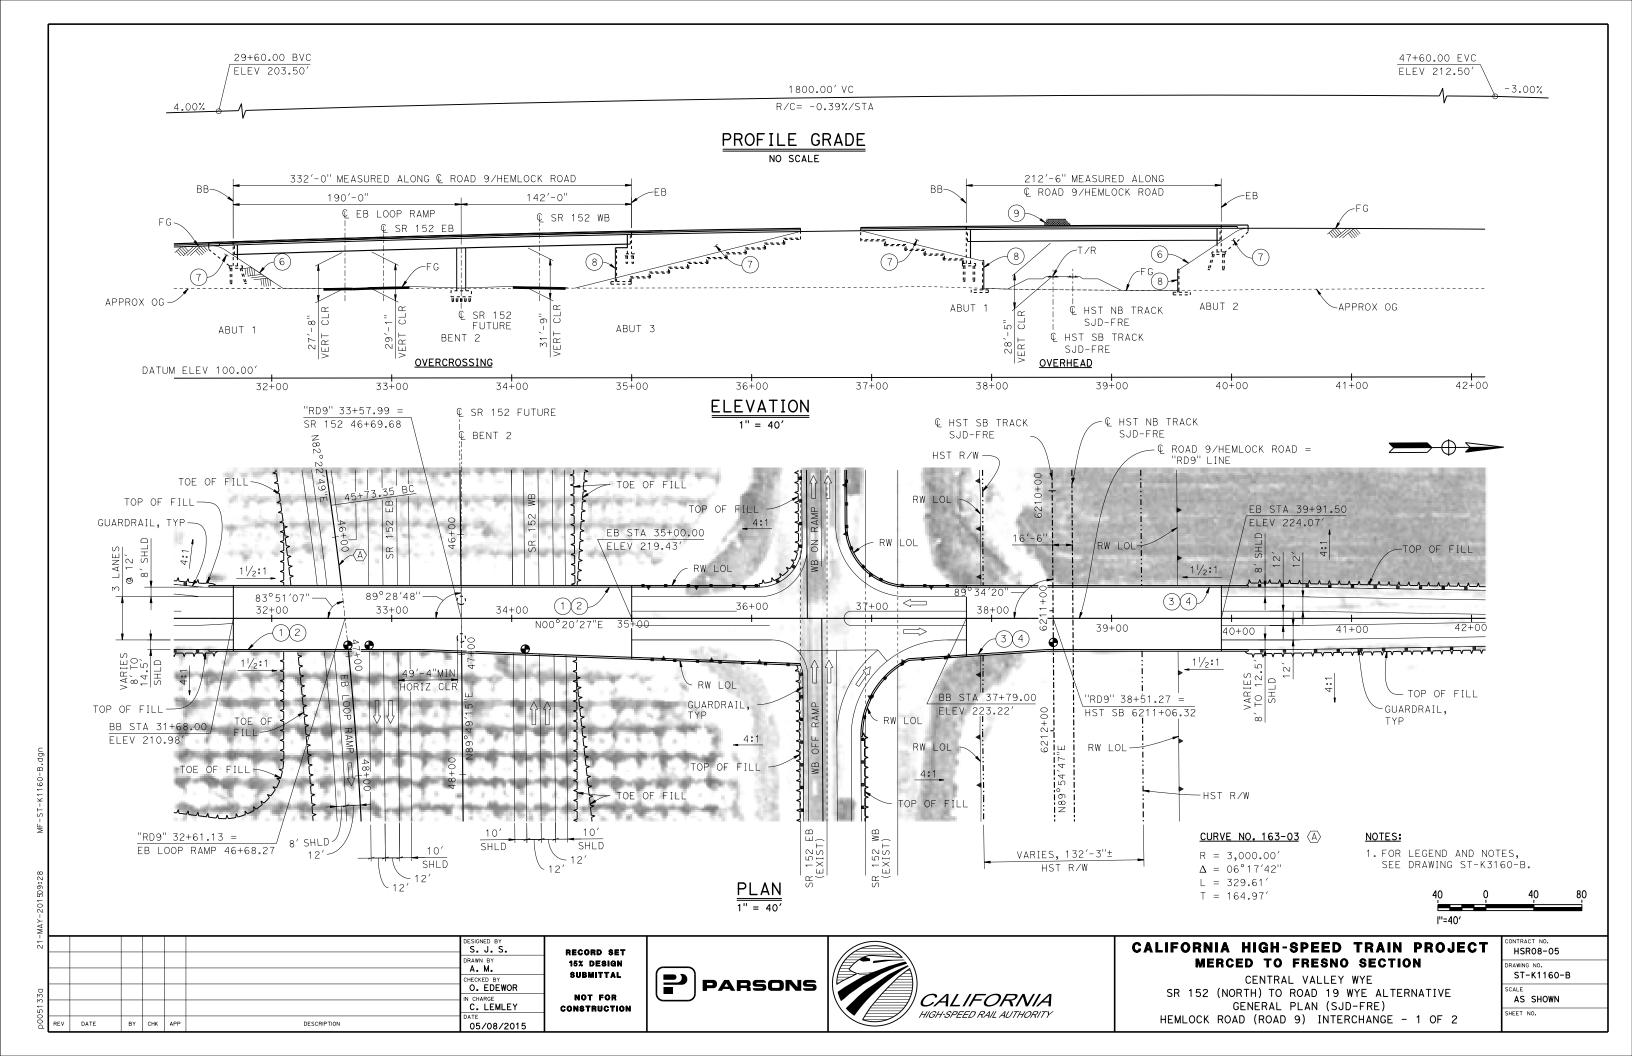

TYPICAL SECTION AT OVERCROSSING

LEGEND:

- ◆ INDICATES POINT OF MINIMUM VERTICAL CLEARANCE
- PAINT "HEMLOCK ROAD OVERCROSSING"
- (2) PAINT "BRIDGE NO. XX-XXXX"
- PAINT "HEMLOCK ROAD OVERHEAD"
- (4) PAINT "BRIDGE NO. XX-XXXX"
- CONCRETE BARRIER TYPE 736 MOD
- 6 SLOPE PAVING $(1\frac{1}{2}H:1V)$
- (7)WINGWALL
- (8) RETAINING WALL
- AR FENCE WITH SOLID PLATE

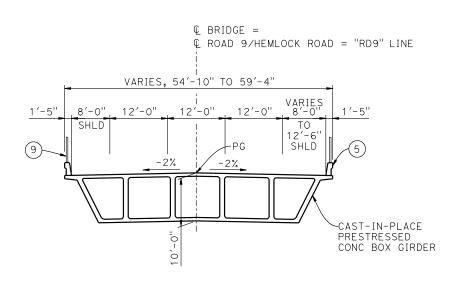

TYPICAL SECTION AT OVERHEAD

- 1. ASSUME CLASS 140 PILES AT ABUTMENT AND BENT FOUNDATIONS. PILE LENGTHS TO BE DETERMINED.
- 2. FOR UTILITY DISPOSITIONS, SEE CIVIL AND GRADE SEPARATION PLANS; DRAWING CV-S1160-B.
- 3. FOR RETAINING WALLS, SEE CIVIL AND GRADE SEPARATION PLANS; DRAWING CV-S1160-B.
- 4. FOR GUARDRAILS, SEE CIVIL AND GRADE SEPARATION PLANS; DRAWING CV-S1160-B.

| 10 | 0 | IO | 20 |
|--------|---|----|----|
| | | | |
| l"=I0' | | | |

DESIGNED BY DRAWN BY
J. KIDWELL O. EDEWOR IN CHARGE

C. LEMLEY CONSTRUCTION REV DATE BY CHK APP DESCRIPTION 05/08/2015

RECORD SET 15% DESIGN SUBMITTAL NOT FOR








CALIFORNIA HIGH-SPEED TRAIN PROJECT MERCED TO FRESNO SECTION


CENTRAL VALLEY WYE SR 152 (NORTH) TO ROAD 19 WYE ALTERNATIVE TYPICAL SECTIONS (SJD-FRE) HEMLOCK ROAD (ROAD 9) INTERCHANGE - 2 OF 2

| CONTRACT NO. |
|--------------|
| HSR08-05 |
| DRAWING NO. |
| ST-K3160-B |
| SCALE |
| AS SHOWN |
| SHEET NO. |

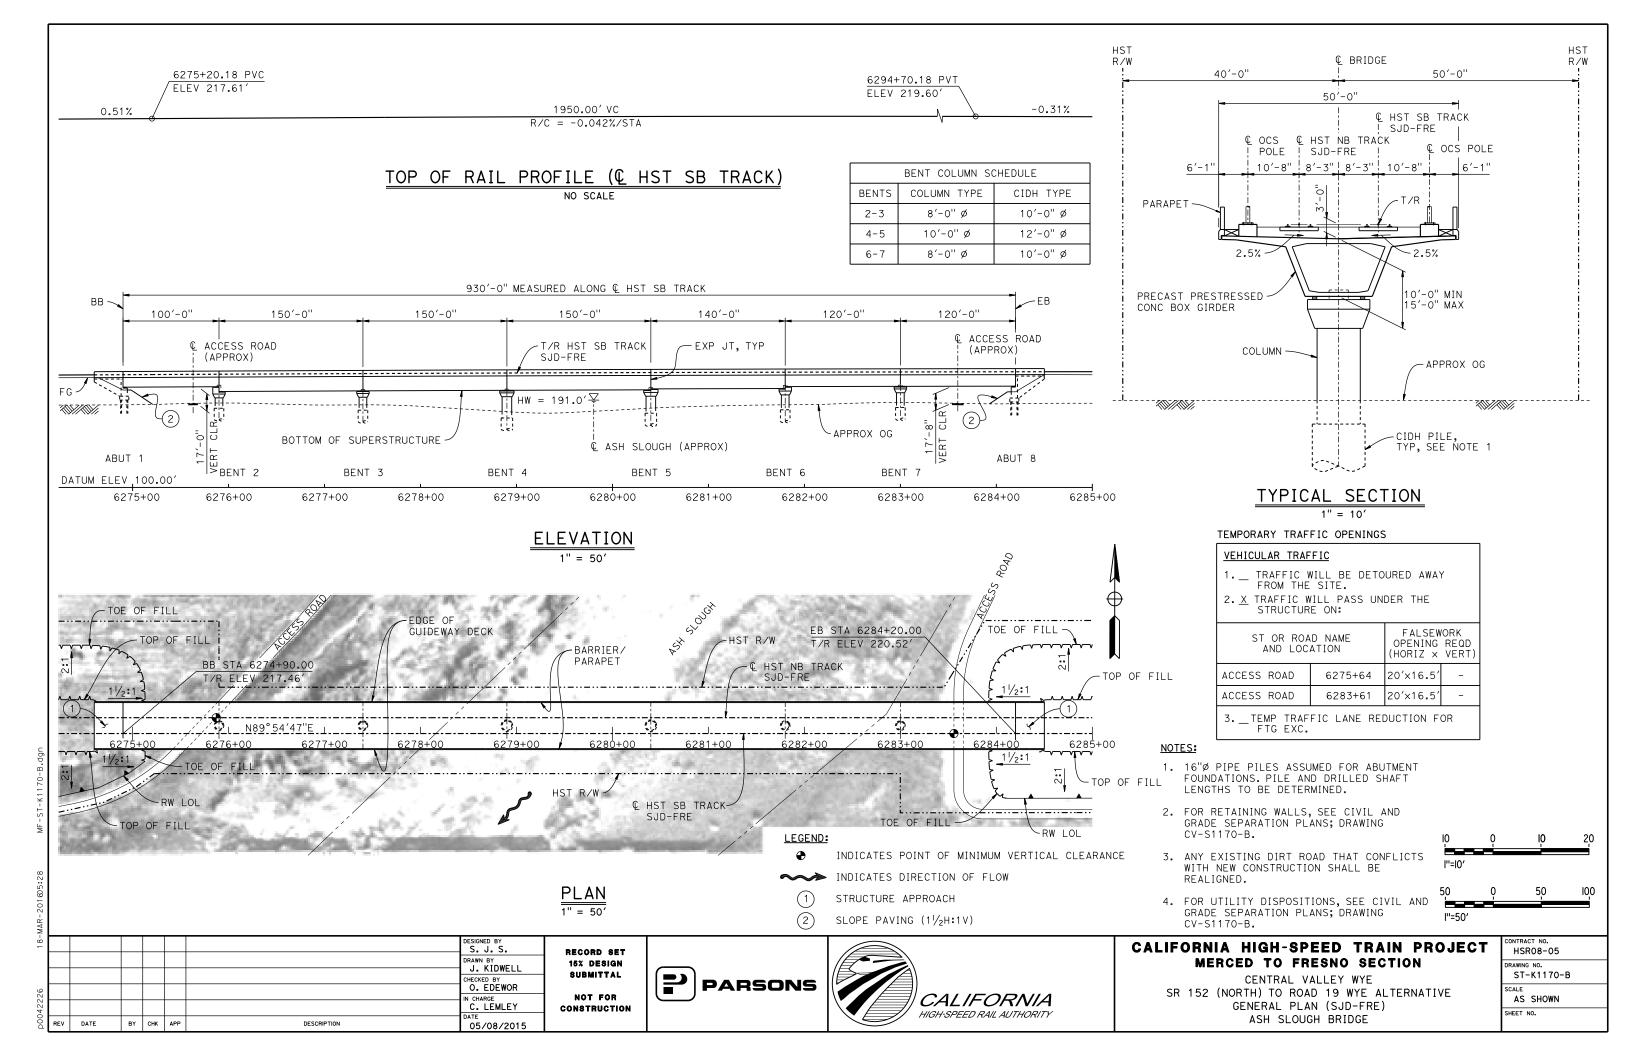

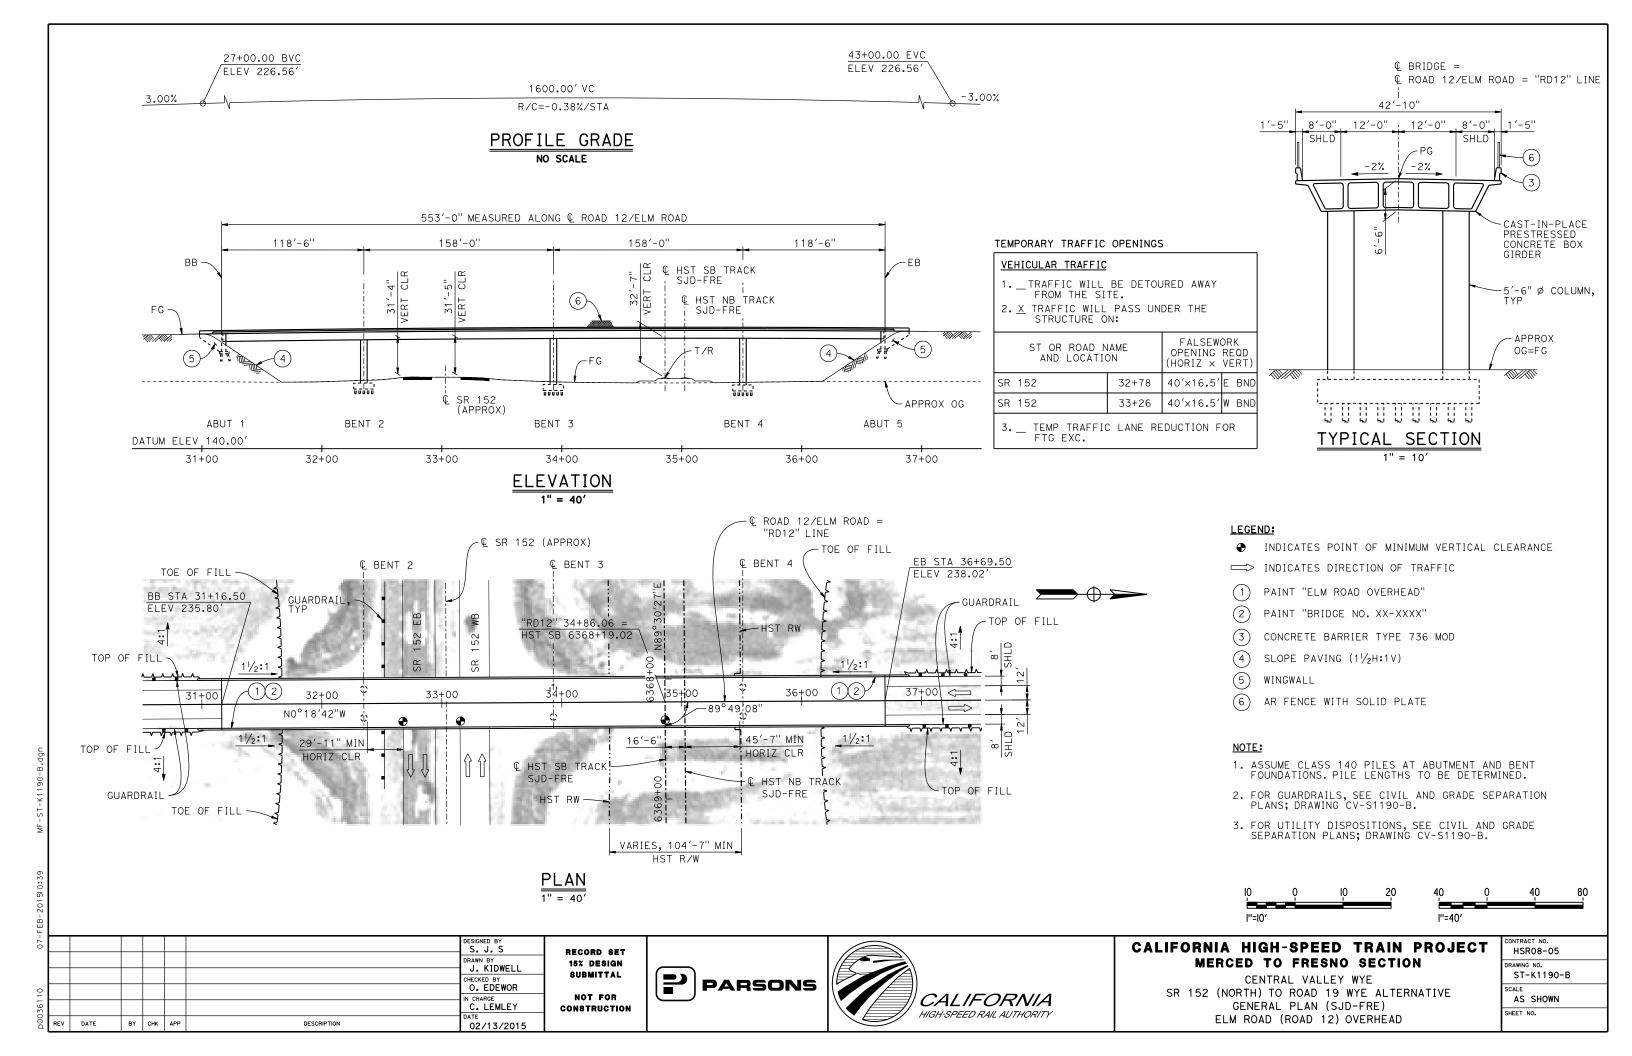

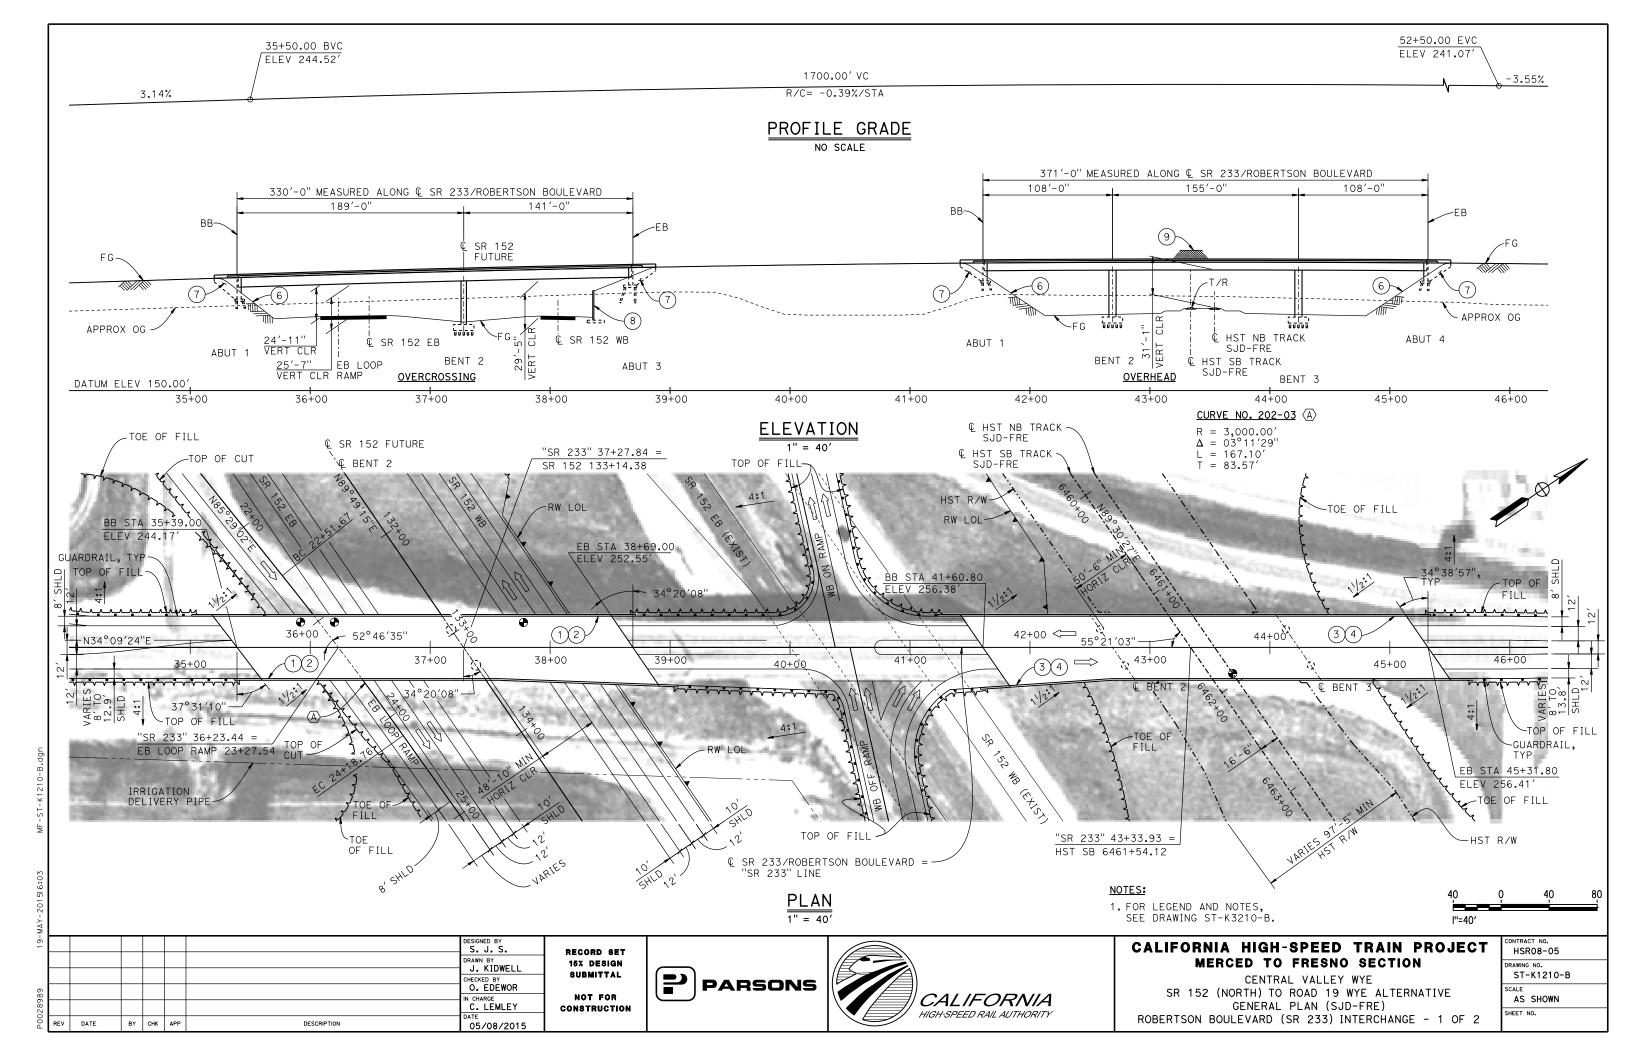


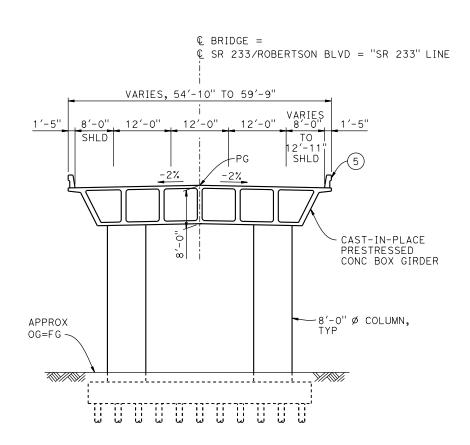

TYPICAL SECTION AT OVERCROSSING

LEGEND:

- ◆ INDICATES POINT OF MINIMUM VERTICAL CLEARANCE
- PAINT "ROBERTSON BLVD OVERCROSSING"
- 2 PAINT "BRIDGE NO. XX-XXXX"
- (3) PAINT "ROBERTSON BLVD OVERHEAD"
- 4 PAINT "BRIDGE NO. XX-XXXX"
- CONCRETE BARRIER TYPE 736 MOD
- 6 SLOPE PAVING $(1\frac{1}{2}H:1V)$
- WINGWALL
- (8) RETAINING WALL
- AR FENCE WITH SOLID PLATE

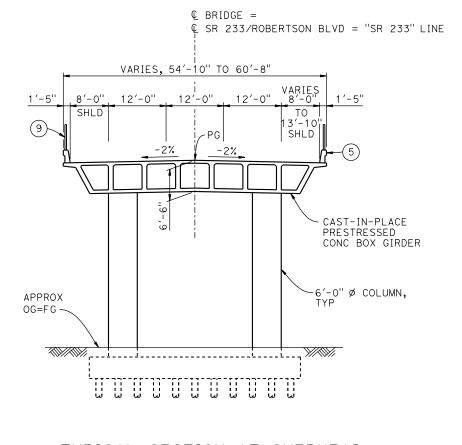

TYPICAL SECTION AT OVERHEAD

- 1. ASSUME CLASS 140 PILES AT ABUTMENT AND BENT FOUNDATIONS. PILE LENGTHS TO BE DETERMINED.
- 2. FOR UTILITY DISPOSITIONS, SEE CIVIL AND GRADE SEPARATION PLANS; DRAWINGS CV-S1210-B.
- 3. FOR RETAINING WALLS, SEE CIVIL AND GRADE SEPARATION PLANS; DRAWINGS CV-S1210-B.
- 4. FOR GUARDRAILS, SEE CIVIL AND GRADE SEPARATION PLANS; DRAWINGS CV-S1210-B.



DESIGNED BY S. J. S. DRAWN BY
J. KIDWELL O. EDEWOR IN CHARGE

C. LEMLEY DATE BY CHK APP DESCRIPTION 05/08/2015


RECORD SET 15% DESIGN SUBMITTAL NOT FOR CONSTRUCTION






CALIFORNIA HIGH-SPEED TRAIN PROJECT MERCED TO FRESNO SECTION

CENTRAL VALLEY WYE SR 152 (NORTH) TO ROAD 19 WYE ALTERNATIVE TYPICAL SECTIONS (SJD-FRE) ROBERTSON BOULEVARD (SR 233) INTERCHANGE - 2 OF 2 HSR08-05 ST-K3210-B AS SHOWN

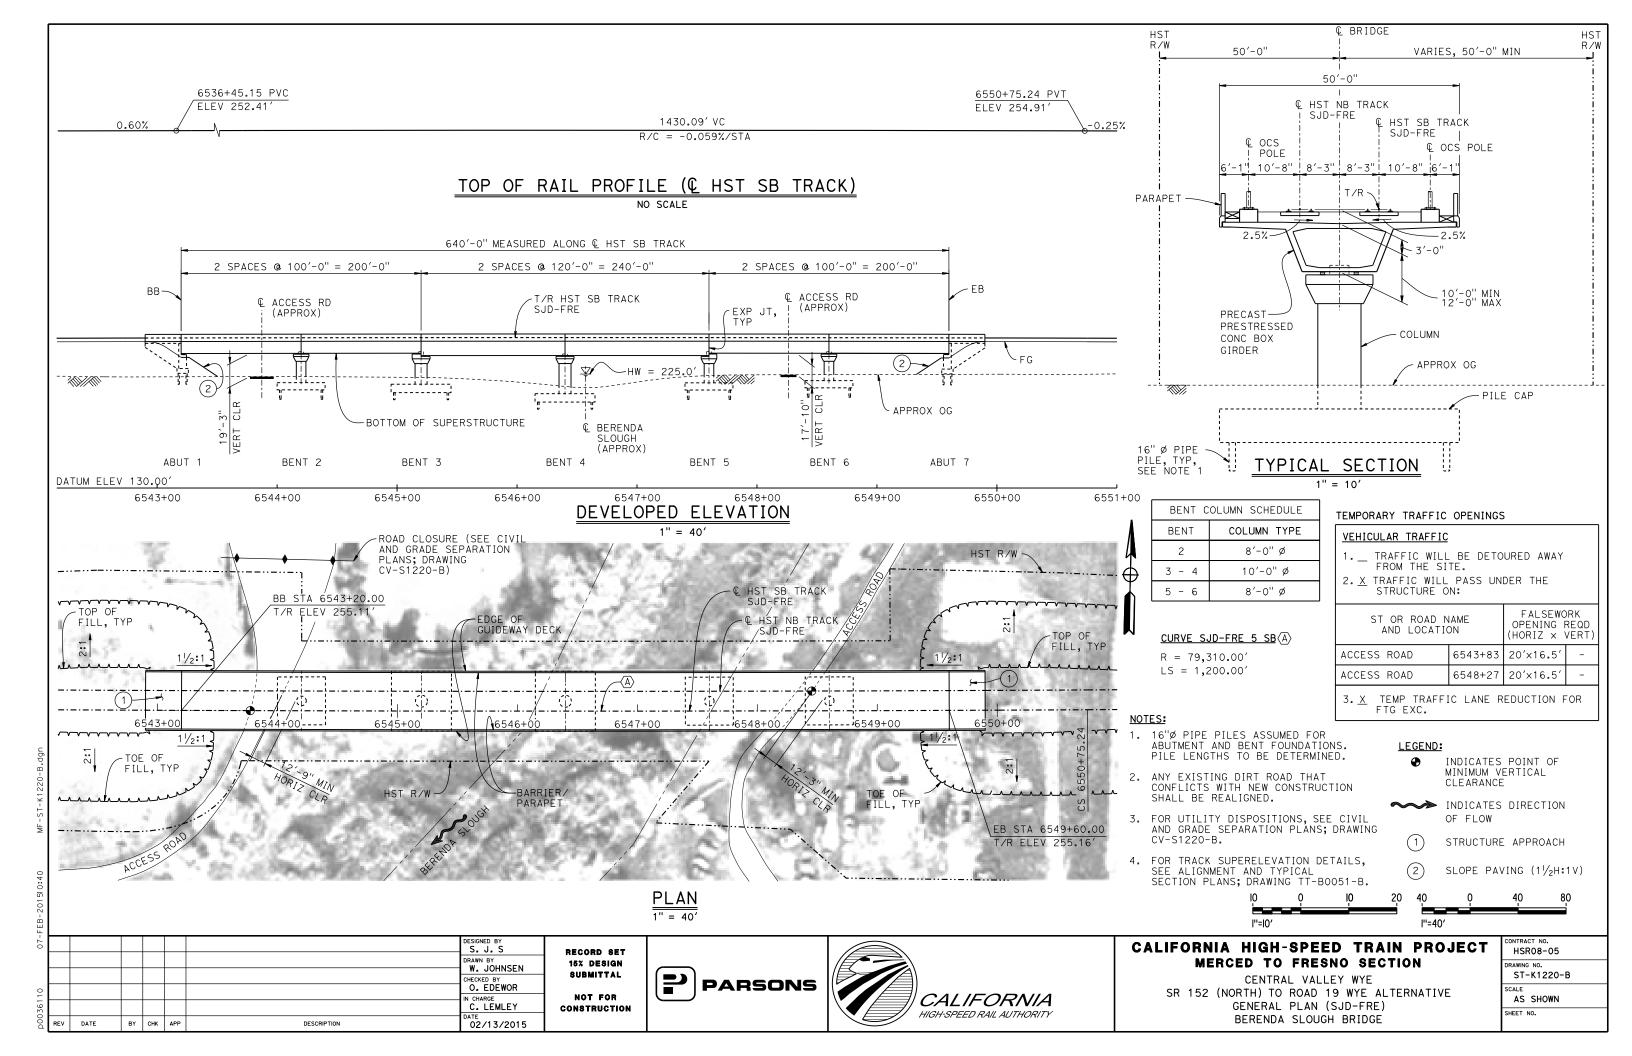

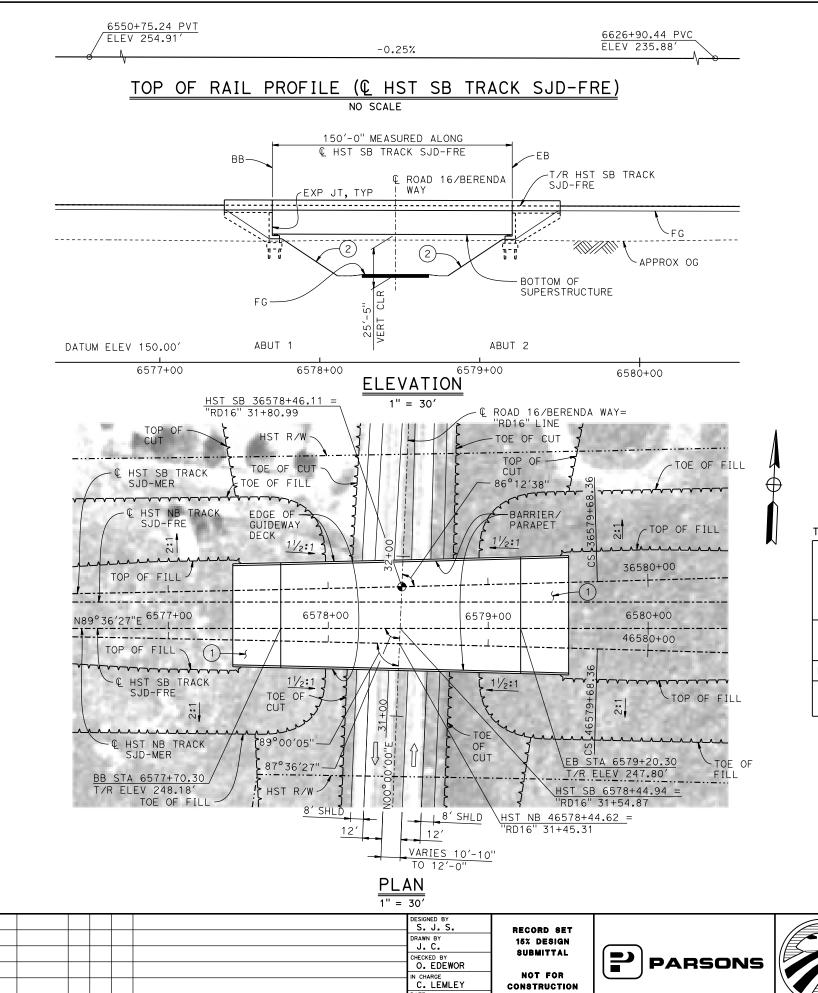


05/08/2015

DATE

BY CHK APP

DESCRIPTION

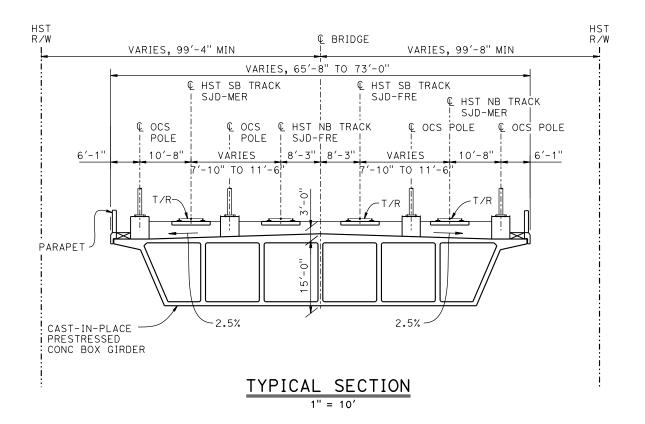

TEMPORARY TRAFFIC OPENINGS

VEHICULAR TRAFFIC

- 1. __ TRAFFIC WILL BE DETOURED AWAY FROM THE SITE.
- 2. \underline{X} TRAFFIC WILL PASS UNDER THE STRUCTURE ON:

| ST OR ROAD N AND LOCATIO | FALSEW OPENING (HORIZ X | | |
|-----------------------------|-------------------------------|-----------|-------|
| ROAD 16/BERENDA WAY | 6578+45 | 52′×16.5′ | 2-WAY |

3. _ TEMP TRAFFIC LANE REDUCTION FOR FTG EXC.

CALIFORNIA


HIGH-SPEED RAIL AUTHORITY

NOTES:

- 1. 16" Ø PIPE PILES ASSUMED FOR ABUTMENT FOUNDATIONS. PILE LENGTHS TO BE DETERMINED.
- 2. FOR UTILITY DISPOSITIONS, SEE CIVIL AND GRADE SEPARATION PLANS; DRAWING CV-S1230-B.


LEGEND:


- INDICATES POINT OF MINIMUM VERTICAL CLEARANCE
- (1) STRUCTURE APPROACH
- 2) SLOPE PAVING $(1\frac{1}{2}H:1V)$

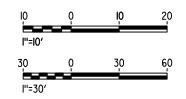


| CALIFORNIA HIGH-SPEED TRAIN PROJECT |
|-------------------------------------|
| MERCED TO FRESNO SECTION |
| CENTRAL VALLEY WYE |


CENTRAL VALLEY WYE
SR 152 (NORTH) TO ROAD 19 WYE ALTERNATIVE
GENERAL PLAN (SJD-FRE)
BERENDA WAY (ROAD 16) UNDERPASS

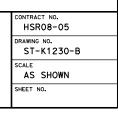

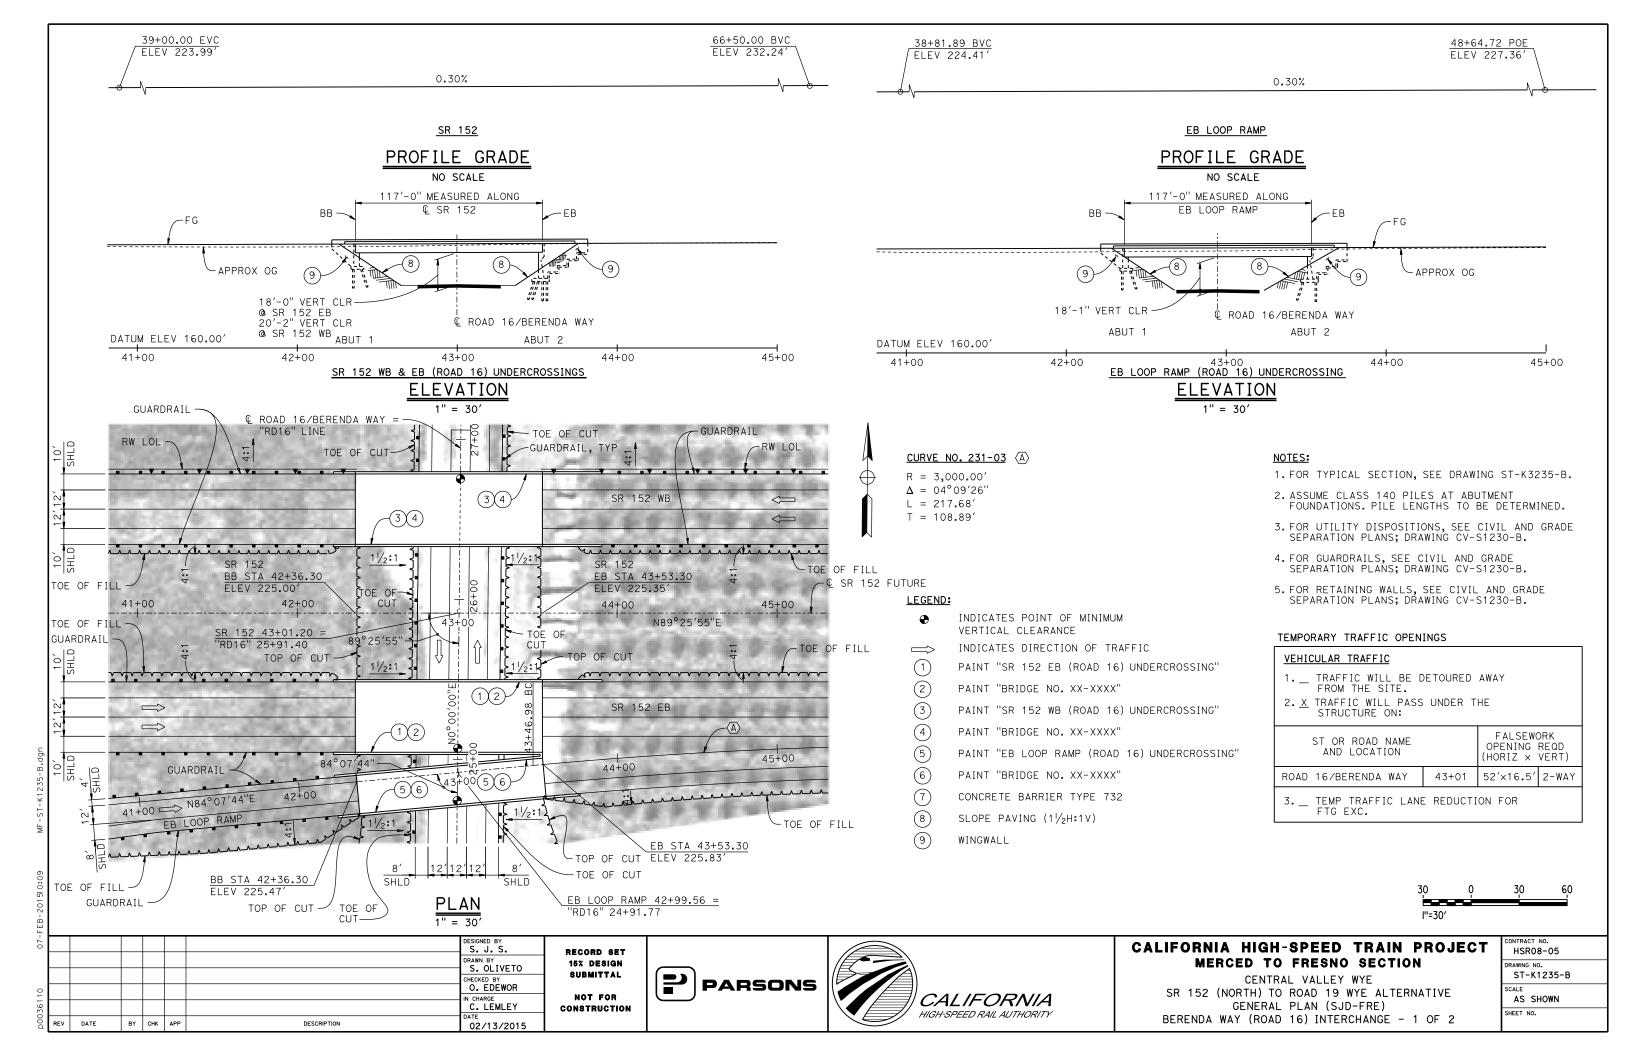

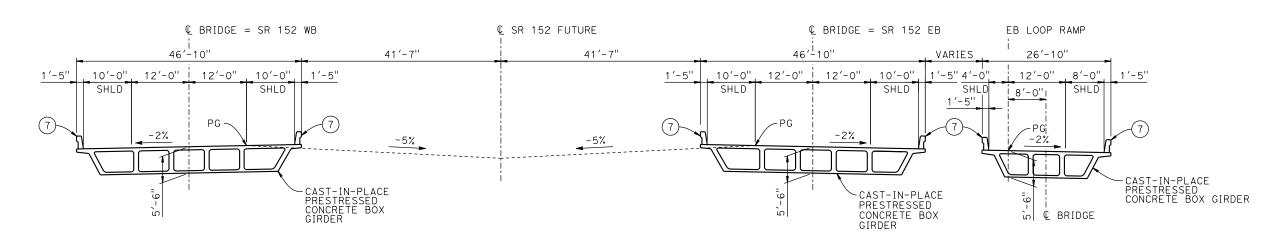

TYPICAL SECTION

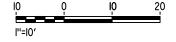

| Ē | | | | | | | | |
|-------|-----|------|----|-----|-----|-------------|----------------------|-----|
| - 20 | | | | | | | DESIGNED BY | RE: |
| | | | | | | | DRAWN BY S. OLIVETO | 15 |
| _ | | | | | | | CHECKED BY O. EDEWOR | કા |
| 36110 | | | | | | | IN CHARGE C. LEMLEY | CON |
| D00 | REV | DATE | BY | снк | APP | DESCRIPTION | DATE 02/13/2015 | |

RECORD SET
15% DESIGN
SUBMITTAL
NOT FOR
CONSTRUCTION






CALIFORNIA HIGH-SPEED TRAIN PROJECT MERCED TO FRESNO SECTION

CENTRAL VALLEY WYE
SR 152 (NORTH) TO ROAD 19 WYE ALTERNATIVE
TYPICAL SECTION (SJD-FRE)
BERENDA WAY (ROAD 16) INTERCHANGE - 2 OF 2

| CONTRACT NO. HSR08-05 | | | | | |
|---------------------------|--|--|--|--|--|
| DRAWING NO. ST-K3235-B | | | | | |
| AS SHOWN | | | | | |
| SHEET NO. | | | | | |

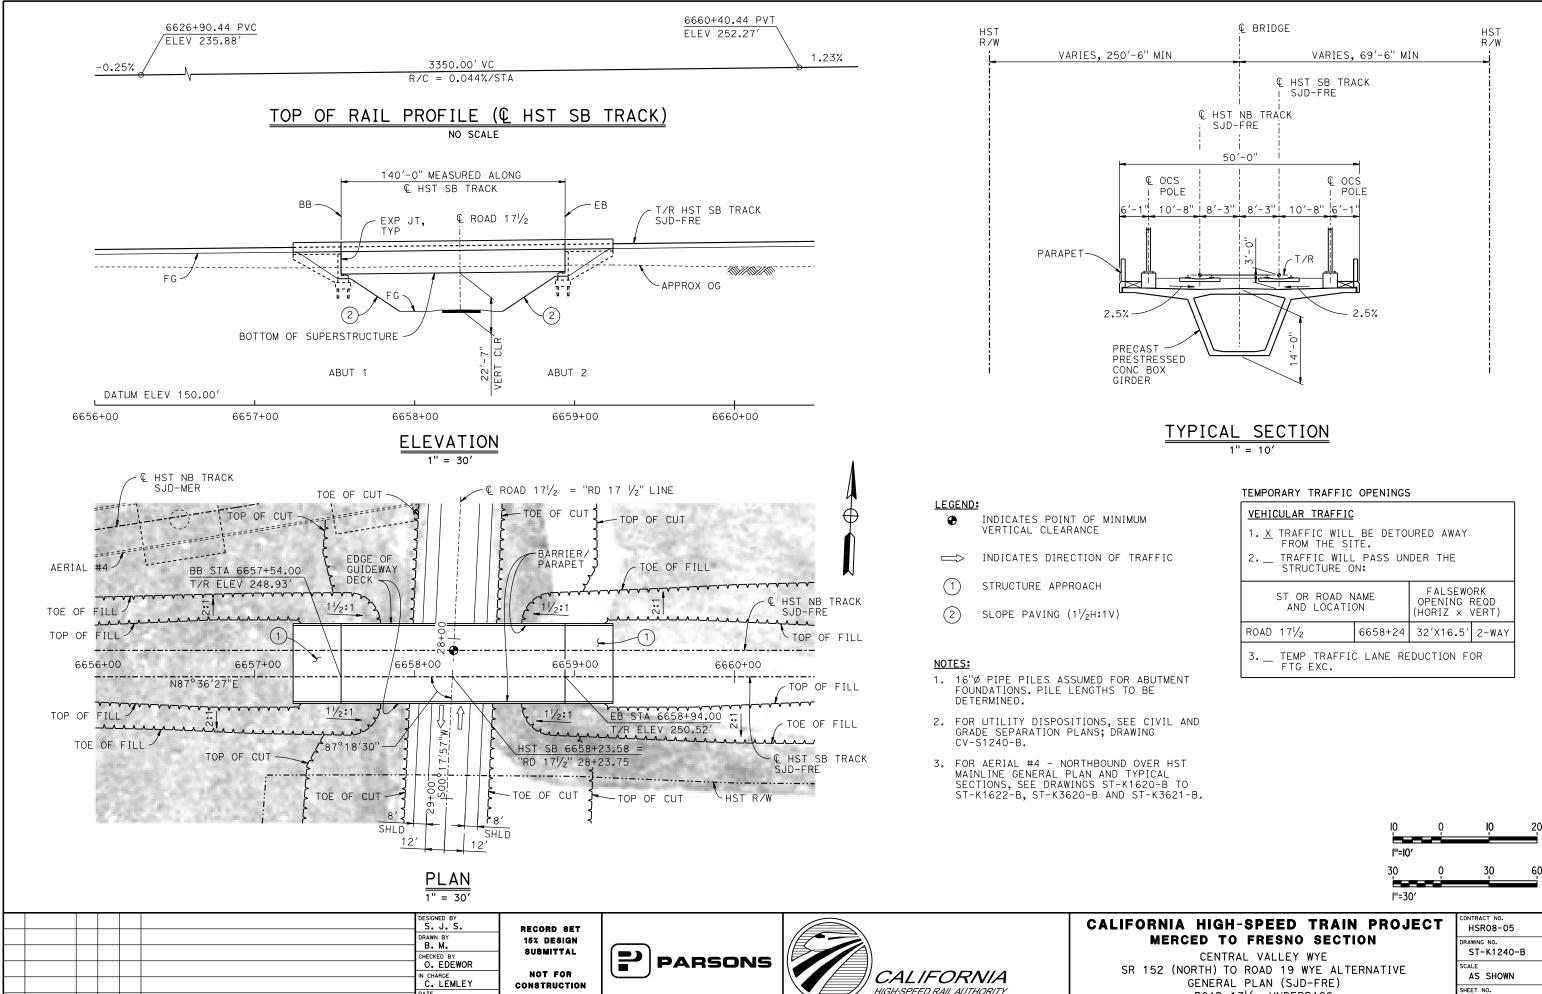

DATE

BY CHK APP


DESCRIPTION


05/08/2015



ROAD 171/2 UNDERPASS

| | CONTRACT NO. | | | | |
|------------|--------------|--|--|--|--|
| ı | HSR08-05 | | | | |
| ı | DRAWING NO. | | | | |
| ST-K1240-B | | | | | |
| ı | SCALE | | | | |
| ı | AS SHOWN | | | | |
| | SHEET NO. | | | | |

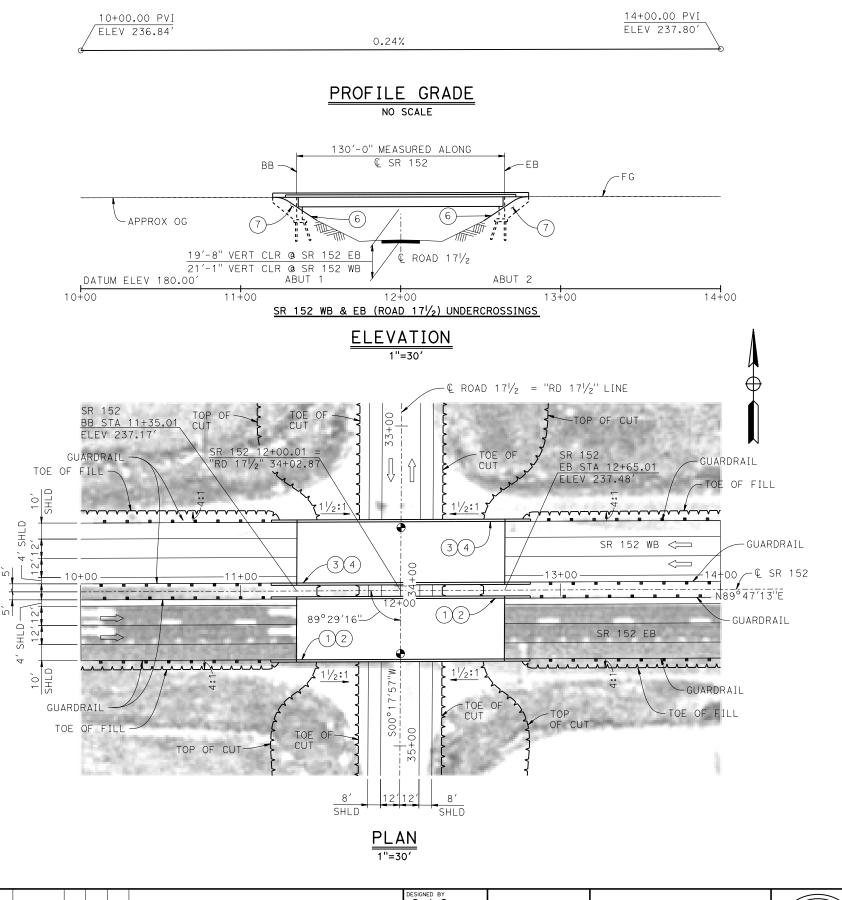

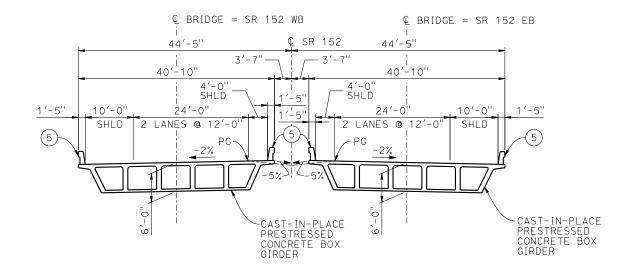

TYPICAL SECTION

1"=10


LEGEND:


- INDICATES POINT OF MINIMUM VERTICAL CLEARANCE
- (1) PAINT "SR 152 EB (ROAD 171/2) UNDERCROSSING"
- 2) PAINT "BRIDGE NO. XX-XXXX"
- $\widehat{ ext{(3)}}$ PAINT "SR 152 WB (ROAD 17 $\frac{1}{2}$) UNDERCROSSING"
- 4) PAINT "BRIDGE NO. XX-XXXX"
- 5) CONCRETE BARRIER TYPE 732
- (6) SLOPE PAVING (11/2H:1V)
- 7) WINGWALL

NOTES:

- ASSUME CLASS 140 PILES AT ABUTMENT FOUNDATIONS. PILE LENGTHS TO BE DETERMINED.
- 2. FOR UTILITY DISPOSITIONS, SEE CIVIL AND GRADE SEPARATION PLANS; DRAWING CV-S1240-B.
- 3. FOR GUARDRAILS, SEE CIVIL AND GRADE SEPARATION PLANS; DRAWING CV-S1240-B.

TEMPORARY TRAFFIC OPENINGS

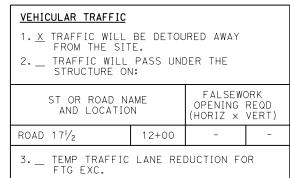

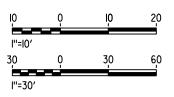

| DESIGNED BY | S. J. S. | DRAWN BY | W. JOHNSEN | CHECKED BY | O. EDEWOR | IN CHARGE | C. LEMLEY | DATE | BY | CHK | APP | DESCRIPTION | DATE | DATE 
RECORD SET
15% DESIGN
SUBMITTAL
NOT FOR
CONSTRUCTION





CALIFORNIA HIGH-SPEED TRAIN PROJECT MERCED TO FRESNO SECTION

CENTRAL VALLEY WYE

SR 152 (NORTH) TO ROAD 19 WYE ALTERNATIVE
GENERAL PLAN (SJD-FRE)
SR 152 (ROAD 17½) UNDERCROSSING

| CONTRACT NO. |
|--------------|
| HSR08-05 |
| DRAWING NO. |
| ST-K1245-B |
| SCALE |
| AS SHOWN |
| SHEET NO. |
| |


6692+54.93 PVT ELEV 282.99'


0.35%

6712+54.93 PVC ELEV 289.99'

2500.00' VC
R/C=-0.044%/STA

TOP OF RAIL PROFILE (& HST SB TRACK)

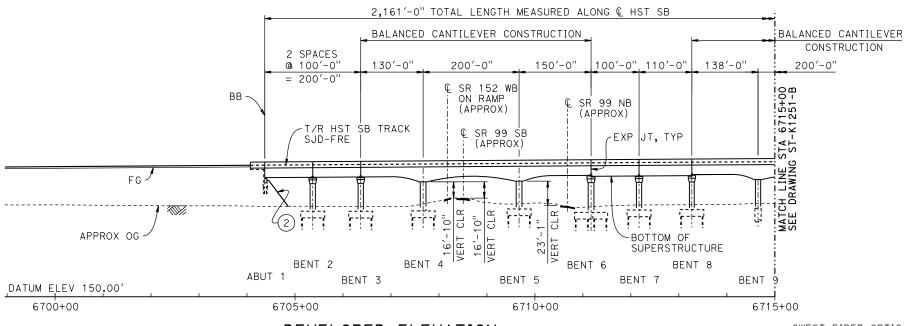

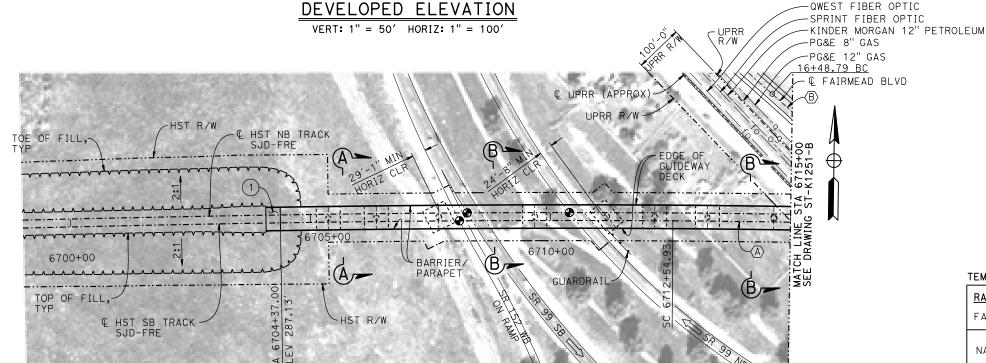

LEGEND:

- INDICATES POINT OF MINIMUM VERTICAL CLEARANCE
- 1) STRUCTURE APPROACH
- (2) SLOPE PAVING $(1\frac{1}{2}H:1V)$

CURVE SJD-FRE 6 SB (A)

CURVE NO. 250-02 (B)

R = 28,600.00'LS = 2,000.00' R = 3,000.00' $\Delta = 9^{\circ}21'10''$

L = 489.71'

T = 245.40'

TEMPORARY TRAFFIC OPENINGS

VEHICULAR TRAFFIC

- 1. _ TRAFFIC WILL BE DETOURED AWAY
 - FROM THE SITE.
- 2. X TRAFFIC WILL PASS UNDER THE STRUCTURE ON:

| ST OR ROAD NAME AND LOCATION | FALSEWORK OPENING REQD (HORIZ X VERT) | | |
|---------------------------------|---|-----------|-------|
| SR 152 WB ON RAMP | 6708+18 | 25′X16.5′ | S BND |
| SR 99 | 6708+51 | 37′X16.5′ | S BND |
| SR 99 | 6710+68 | 37′X16.5′ | N BND |
| FAIRMEAD BLVD | 6717+33 | 32′X16.5′ | 2-WAY |
| ARC DR | 6719+51 | 32′X16.5′ | 2-WAY |
| ROAD 18¾ | 6724+43 | 32′X16.5′ | 2-WAY |


3. \underline{X} TEMP TRAFFIC LANE REDUCTION FOR FTG EXC.

NOTES:

- 16" Ø PIPE PILES ASSUMED FOR ABUTMENT AND BENT FOUNDATIONS, UNLESS OTHERWISE NOTED. PILE LENGTHS TO BE DETERMINED.
- 2. FOR SECTIONS AND BENT COLUMN SCHEDULE, SEE DRAWING ST-K3250-B.
- 3. ANY EXISTING DIRT ROAD THAT CONFLICTS WITH NEW CONSTRUCTION SHALL BE REALIGNED.
- 4. FOR UTILITY DISPOSITIONS, SEE CIVIL AND GRADE SEPARATION PLANS; DRAWING CV-S1250-B.
- 5. FOR GUARDRAILS, SEE CIVIL AND GRADE SEPARATION PLANS; DRAWING CV-S1250-B.

TEMPORARY TRAFFIC OPENINGS

| RAILROAD TRAFFIC | | | | | | |
|---|---------|-----------|--|--|--|--|
| FALSEWORK OPENING REQUIRED ON: | | | | | | |
| NAME OF RR AND LOCATION OPENING REQUESTION (HORIZ X VER | | | | | | |
| UPRR | 6715+73 | 24′ X 21′ | | | | |

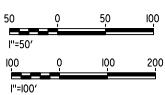

| | | | DESIGNED BY | |
|--|--|--|-------------|---|
| | | | DRAWN BY | l |
| | | | CHECKED BY | l |
| | | | O. EDEWOR | l |
| | | | C. LEMLEY | ا |

DESCRIPTION

DATE

BY CHK APP

RECORD SET
15% DESIGN
SUBMITTAL
NOT FOR
CONSTRUCTION

PLAN

1" = 100'

05/08/2015






CALIFORNIA HIGH-SPEED TRAIN PROJECT MERCED TO FRESNO SECTION

CENTRAL VALLEY WYE
SR 152 (NORTH) TO ROAD 19 WYE ALTERNATIVE
GENERAL PLAN (SJD-FRE)
AERIAL #2 - SR 99 / UPRR - 1 OF 3

| CONTRACT NO. HSR08-05 |
|---------------------------|
| DRAWING NO. ST-K1250-B |
| AS SHOWN |
| SHEET NO. |


TOP OF RAIL PROFILE (& HST SB TRACK)

NO SCALE

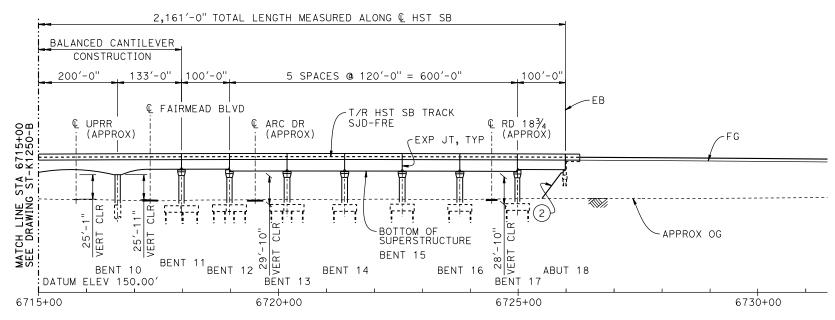

DEVELOPED ELEVATION

VERT: 1" = 50' HORIZ: 1" = 100'

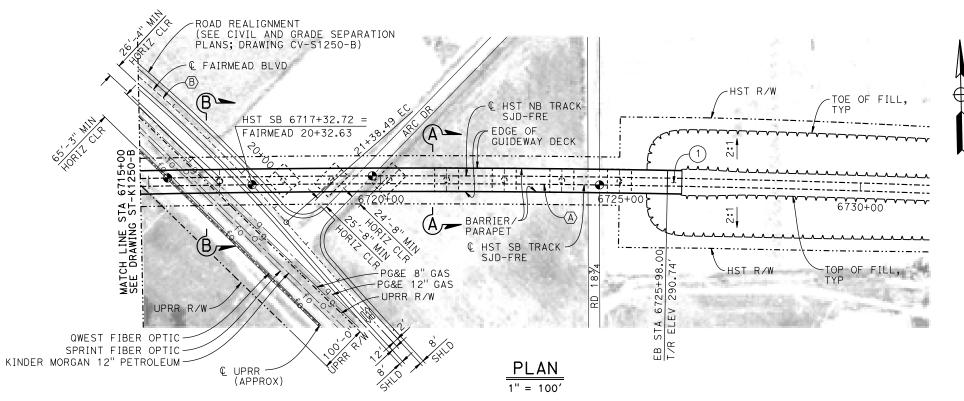

| 50 | Q | 50 | 100 |
|----------|---|-----|-----|
| l''=50′ | | | |
| 100 | Q | 100 | 200 |
| l''=l00′ | | | |

| - | | | | | | | | |
|-----|-----|------|----|-----|-----|-------------|---------------------|---|
| 5 | | | | | | | DESIGNED BY | |
| | | | | | | | DRAWN BY R. M. | |
| | | | | | | | CHECKED BY | |
| 2 | | | | | | | O. EDEWOR IN CHARGE | |
| 361 | | | | | | | C. LEMLEY | c |
| D00 | REV | DATE | BY | СНК | APP | DESCRIPTION | 02/13/2015 | |

RECORD SET
15% DESIGN
SUBMITTAL
NOT FOR
CONSTRUCTION







CALIFORNIA HIGH-SPEED TRAIN PROJECT MERCED TO FRESNO SECTION

CENTRAL VALLEY WYE
SR 152 (NORTH) TO ROAD 19 WYE ALTERNATIVE
GENERAL PLAN (SJD-FRE)
AERIAL #2 - SR 99 / UPRR - 2 OF 3

| CONTRACT NO. |
|--------------|
| HSR08-05 |
| DRAWING NO. |
| ST-K1251-B |
| SCALE |
| AS SHOWN |
| SHEET NO. |
| |

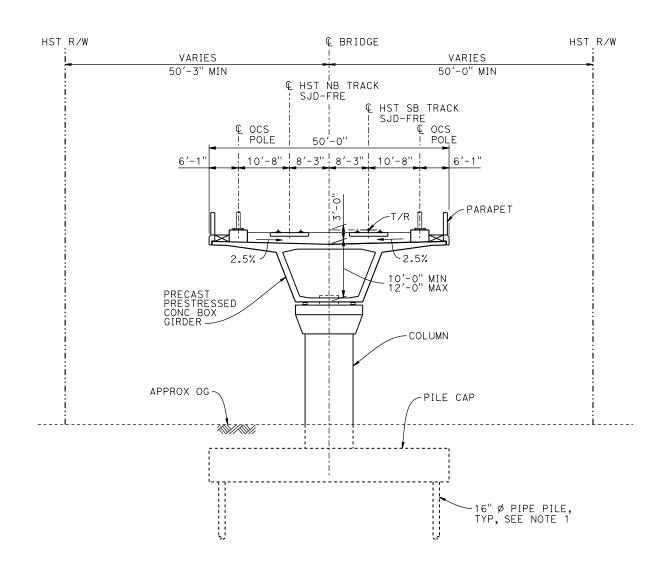

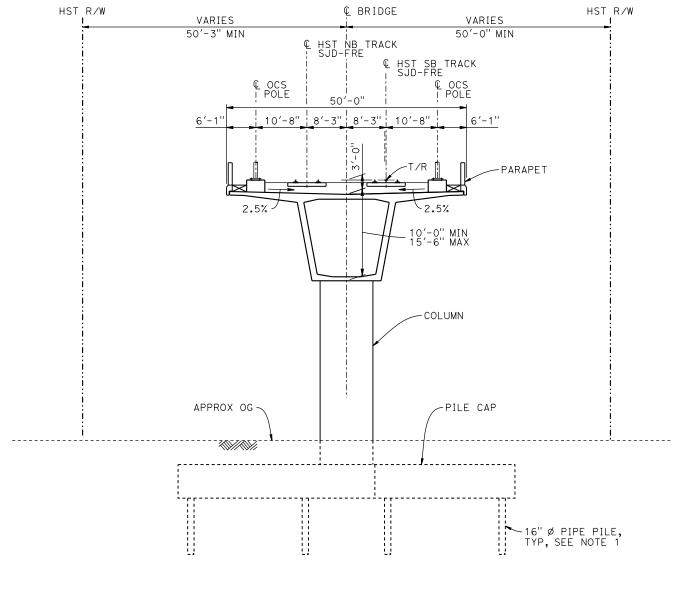

SECTION A-A

| BENT COLUMN SCHEDULE | | | | | | | |
|----------------------|-------------|-----------|--|--|--|--|--|
| BENT | COLUMN TYPE | CIDH TYPE | | | | | |
| 2 - 3 | 11'-0''Ø | | | | | | |
| 4 - 5 | 12'-0''ø | | | | | | |
| 6 | 12'-0''ø | | | | | | |
| 7 | 11'-0''ø | | | | | | |
| 8 | 10'-0"ø | | | | | | |
| 9 - 10 | 11'-0''ø | 13′-0''ø | | | | | |
| 11 - 12 | 11'-0''Ø | | | | | | |
| 13 - 16 | 12'-0"ø | | | | | | |
| 17 | 10'-0"ø | | | | | | |

$\frac{\text{SECTION }B-B}{1"=10'}$

NOTES:

- PILE AND DRILLED SHAFT LENGTHS TO BE DETERMINED.
- 2. FOR TRACK SUPERELEVATION DETAILS, SEE ALIGNMENT AND TYPICAL SECTION PLANS; DRAWING TT-B0051-B.

| ΙO | Ō | Ι <mark></mark> Ο | 20 |
|---------|---|-------------------|----|
| l''=I0' | | | |

| MA | | | | | | | | |
|------|-----|------|----|-----|-----|-------------|----------------------|---------|
| 16- | | | | | | | DESIGNED BY | R |
| | | | | | | | DRAWN BY | ָר י |
| Α | | | | | | | CHECKED BY O. EDEWOR | : |
| 5133 | | | | | | | IN CHARGE C. LEMLEY | CO |
| D00 | REV | DATE | BY | снк | APP | DESCRIPTION | DATE 05/08/2015 | |

RECORD SET
15% DESIGN
SUBMITTAL
NOT FOR
CONSTRUCTION






CALIFORNIA HIGH-SPEED TRAIN PROJECT MERCED TO FRESNO SECTION

CENTRAL VALLEY WYE
SR 152 (NORTH) TO ROAD 19 WYE ALTERNATIVE
TYPICAL SECTIONS (SJD-FRE)
AERIAL #2 - SR 99 / UPRR - 3 OF 3

| CONTRACT NO. HSRO8-05 |
|---------------------------|
| DRAWING NO. ST-K3250-B |
| SCALE |
| AS SHOWN |
| |

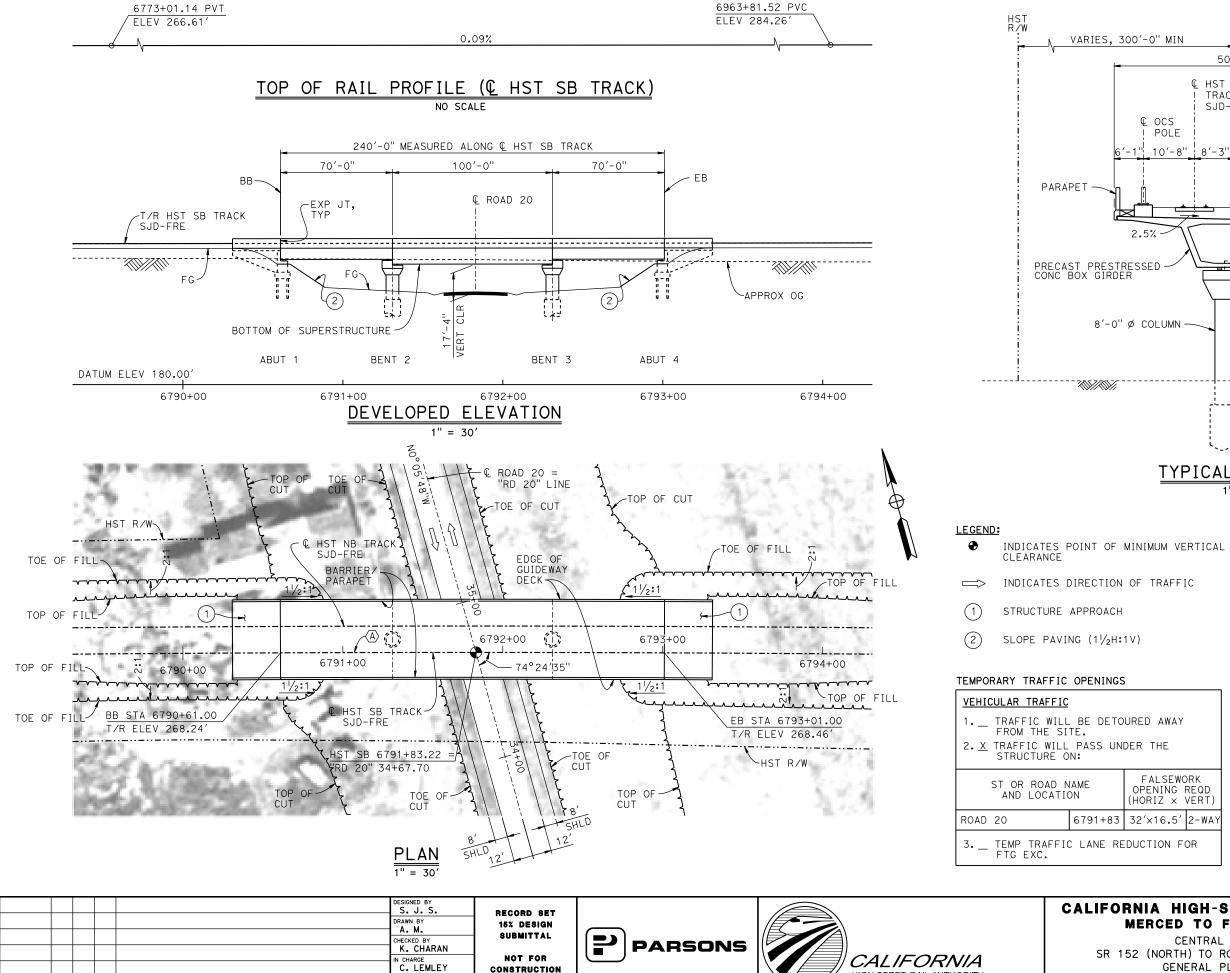


DATE

BY CHK APP

DESCRIPTION

05/08/2015

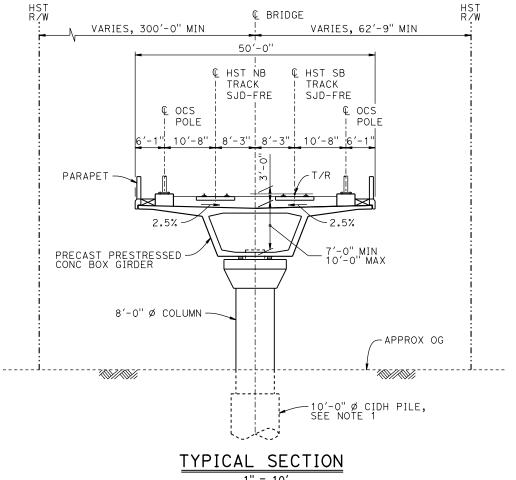


NOTES:

- 16"Ø PIPE PILES ASSUMED FOR ABUTMENT FOUNDATIONS. PILE AND DRILLED SHAFT LENGTHS TO BE DETERMINED.
- 2. FOR UTILITY DISPOSITIONS, SEE CIVIL AND GRADE SEPARATION PLANS; DRAWING CV-S1260-B.
- 3. FOR TRACK SUPERELEVATION DETAILS, SEE ALIGNMENT AND TYPICAL SECTION PLANS; DRAWING TT-B0051-B.

CURVE SJD-FRE 6 SB (A)

R = 28,600.00'LS = 2,000.00'

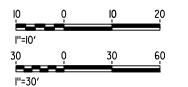



CALIFORNIA HIGH-SPEED TRAIN PROJECT MERCED TO FRESNO SECTION


HIGH-SPEED RAIL AUTHORITY

CENTRAL VALLEY WYE
SR 152 (NORTH) TO ROAD 19 WYE ALTERNATIVE
GENERAL PLAN (SJD-FRE)
ROAD 20 UNDERPASS

| HSR08-05 |
|---------------------------|
| DRAWING NO. ST-K1260-B |
| SCALE AS SHOWN |
| SHEET NO. |

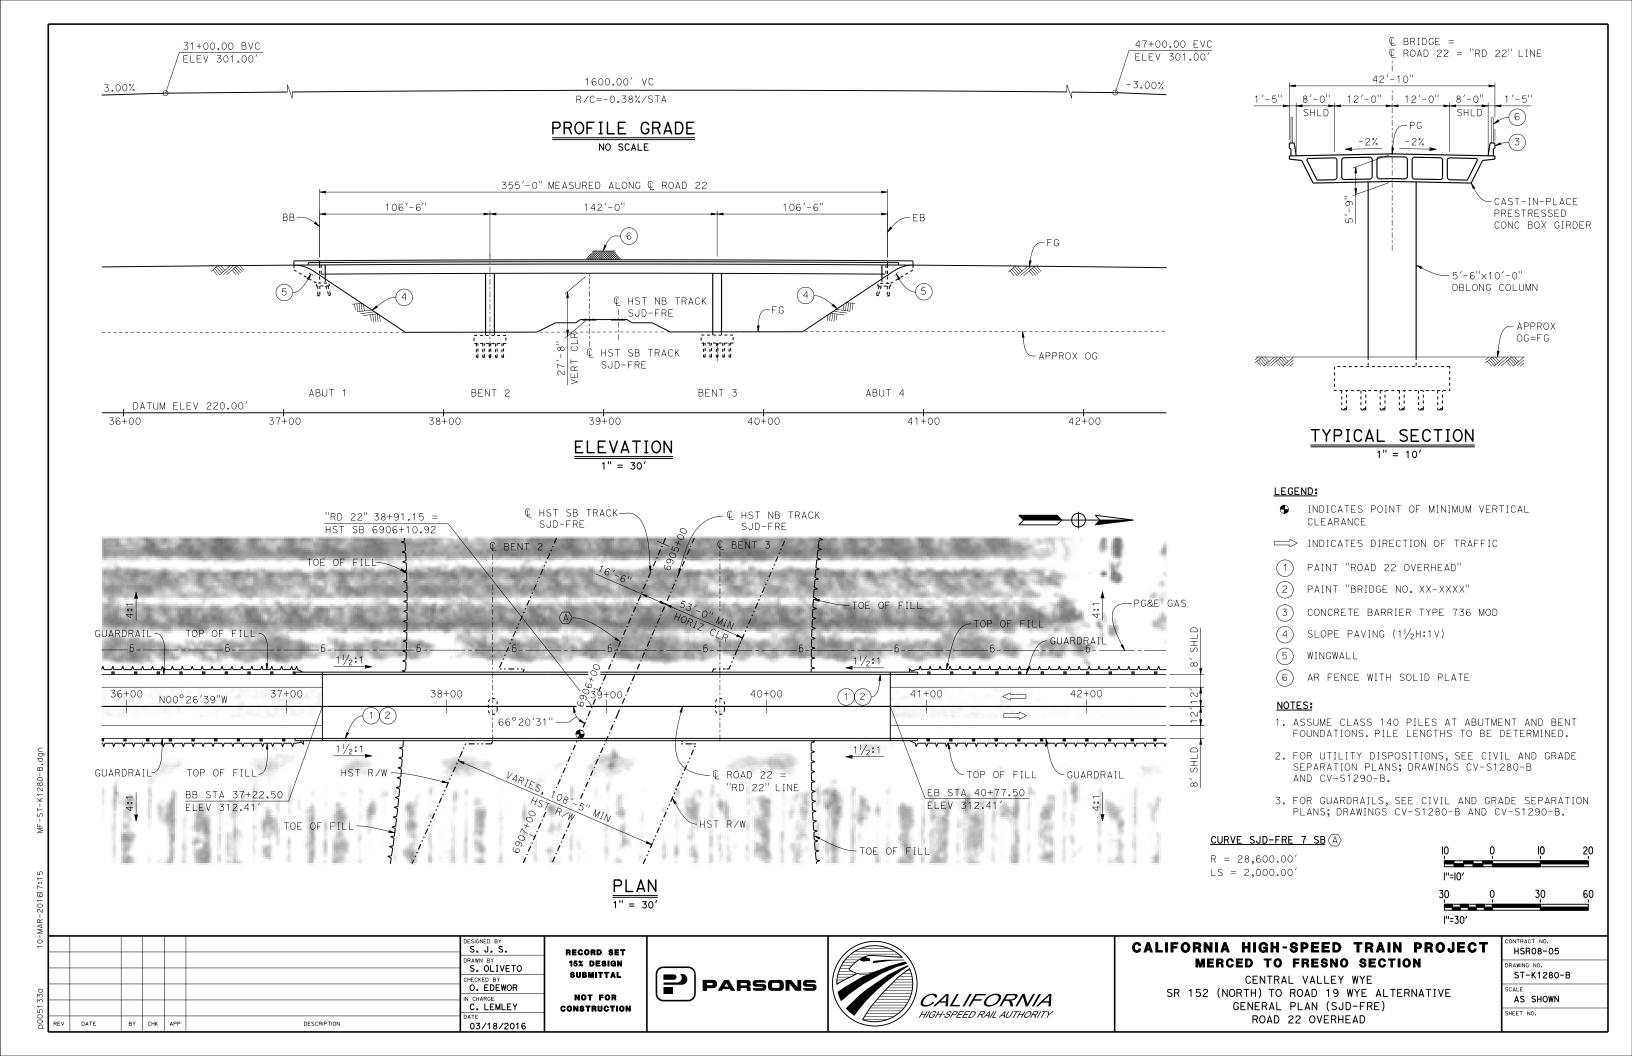

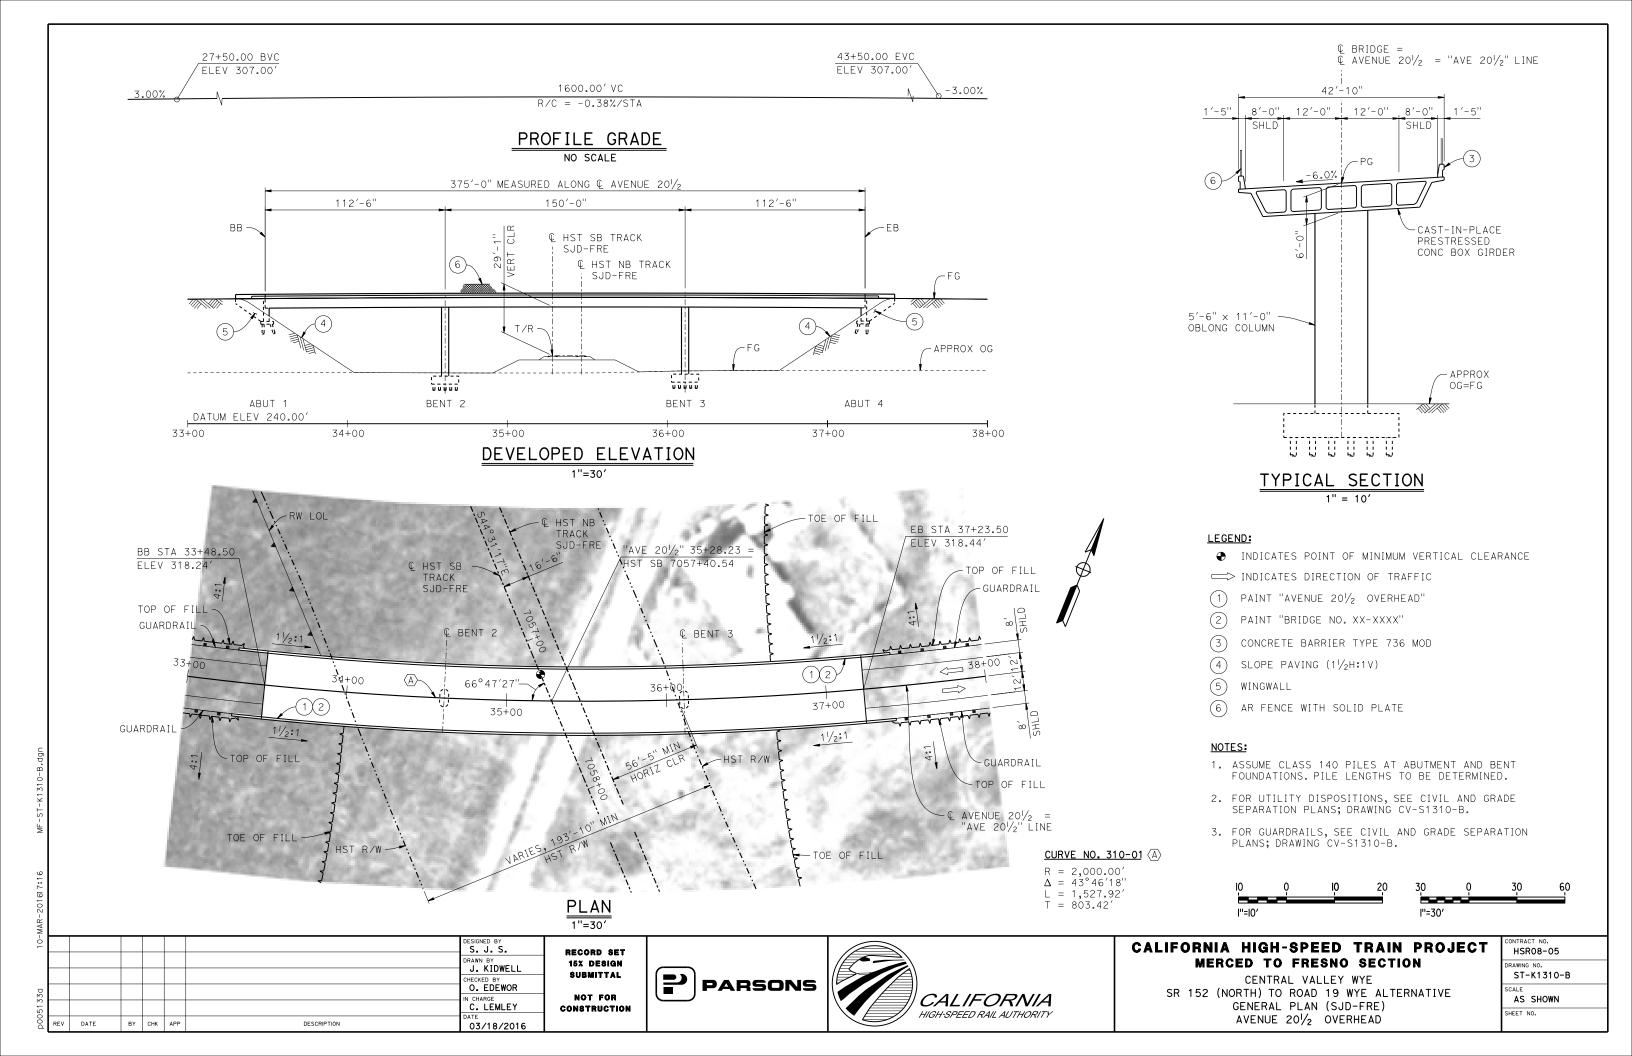

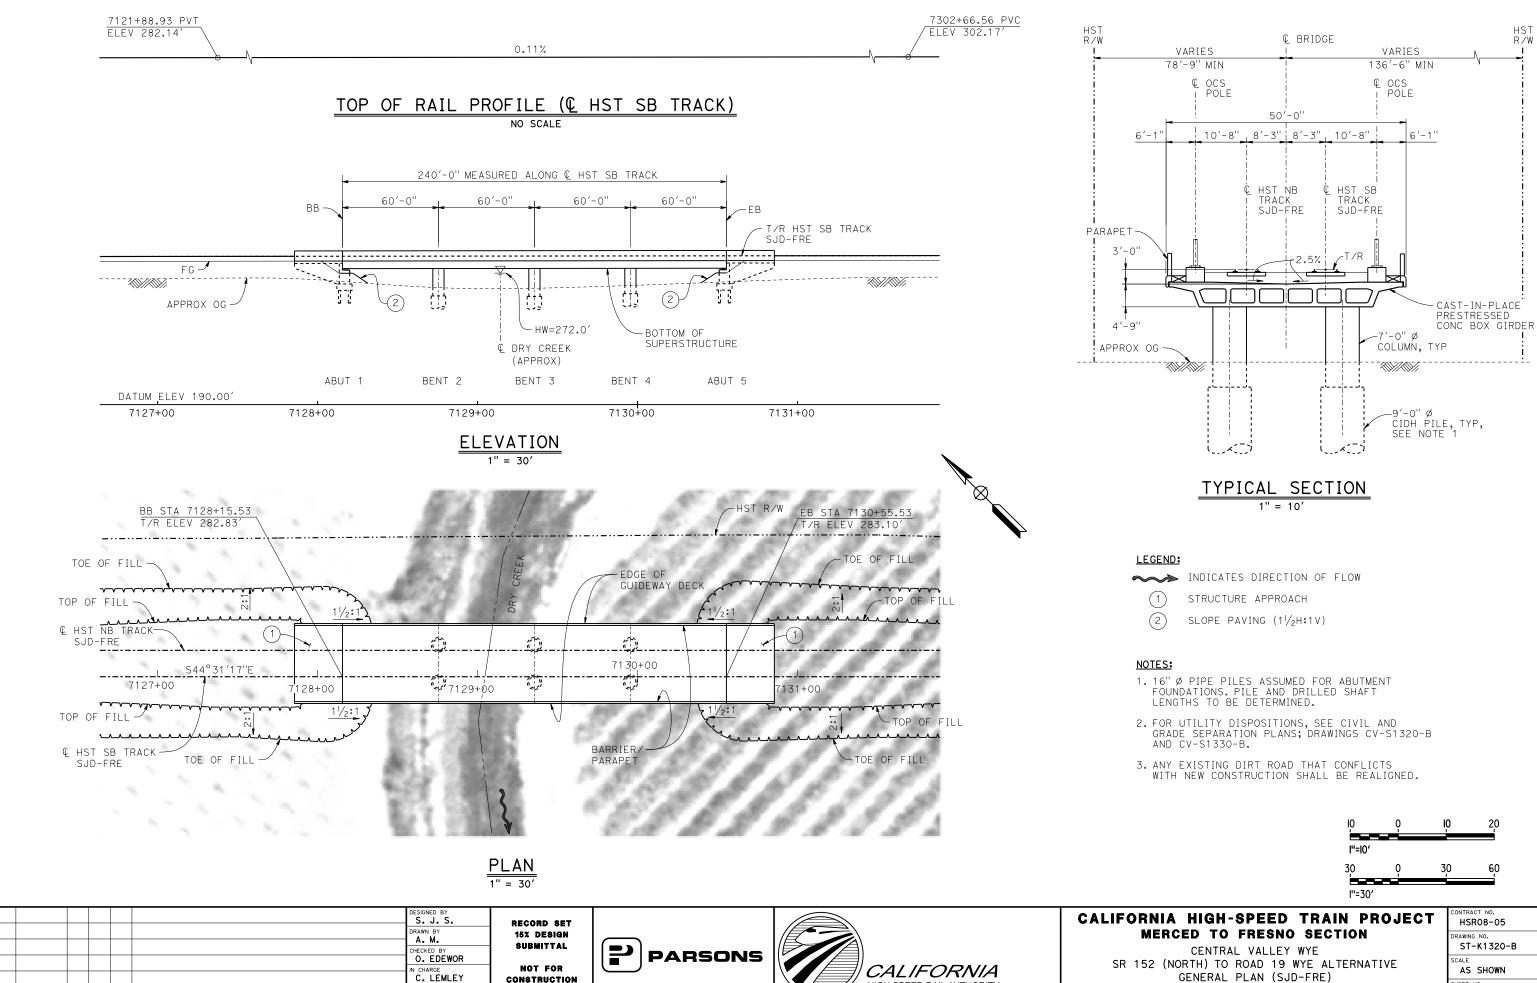



DATE

BY CHK APP

DESCRIPTION

03/18/2016




GENERAL PLAN (SJD-FRE) DRY CREEK BRIDGE


| CONTRACT NO. HSR08-05 |
|---------------------------|
| DRAWING NO. ST-K1320-B |
| AS SHOWN |
| SHEET NO. |

R/W

TOP OF RAIL PROFILE (HST SB TRACK MER-FRE) NO SCALE

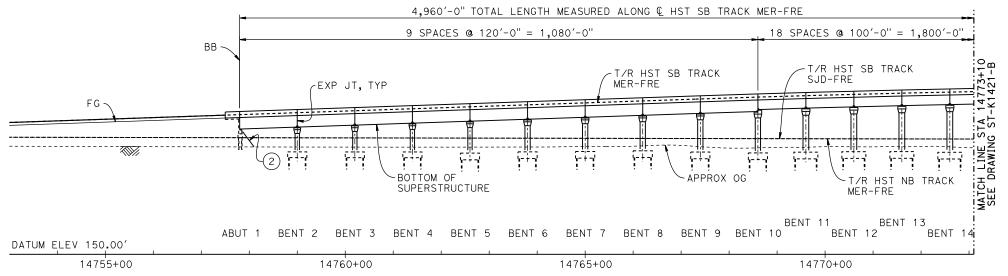

DEVELOPED ELEVATION

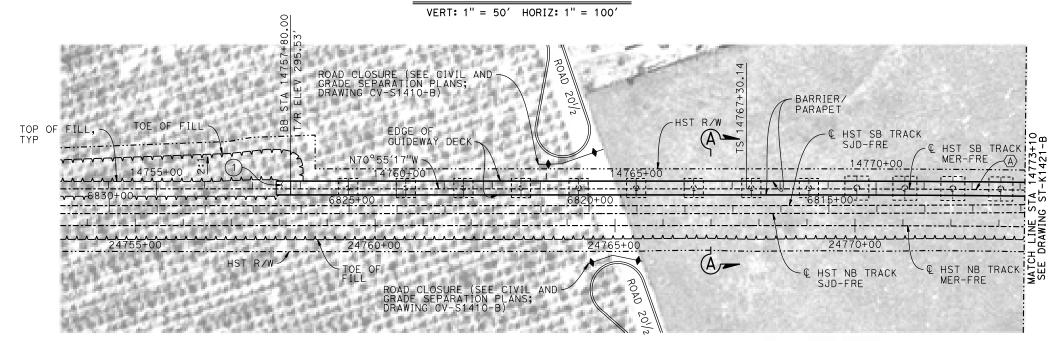

PLAN 1" = 100

LEGEND:

- (1) STRUCTURE APPROACH
- (2) SLOPE PAVING $(1\frac{1}{2}H:1V)$

CURVE MER-FRE 1 SB (A)

R = 10,300.00'LS = 1,200.00'

TEMPORARY TRAFFIC OPENINGS

| VEHICULAR TRAFFIC | | | | | | | |
|--|----------|-----------|-------|--|--|--|--|
| 1TRAFFIC WILL BE DETOURED AWAY FROM THE SITE. | | | | | | | |
| 2. X TRAFFIC WILL PASS UNDER THE STRUCTURE ON: | | | | | | | |
| ST OR ROAD NAME OPENING REQD (HORIZ X VERT | | | | | | | |
| ROAD 20 | 14793+07 | 32′X16.5′ | 2-WAY | | | | |
| 3TEMP TRAFFIC LANE REDUCTION FOR FTG EXC. | | | | | | | |

NOTES:

- 1. 16" Ø PIPE PILES ASSUMED FOR ABUTMENT AND BENT FOUNDATIONS, UNLESS OTHERWISE NOTED. PILE LENGTHS TO BE DETERMINED.
- 2. FOR SECTIONS AND BENT COLUMN SCHEDULE, SEE DRAWINGS ST-K3420-B AND ST-K3421-B.
- 3. ANY EXISTING DIRT ROAD THAT CONFLICTS WITH NEW CONSTRUCTION SHALL BE REALIGNED.
- 4. FOR UTILITY DISPOSITIONS, SEE CIVIL AND GRADE SEPARATION PLANS; DRAWINGS CV-S1410-B AND CV-S1420-B.
- 5. FOR ROAD 20 UNDERPASS GENERAL PLAN AND TYPICAL SECTION, SEE DRAWING ST-K1260-B.
- 6. FOR ROAD 20 UNDERPASS (HST NB) GENERAL PLAN AND TYPICAL SECTION, SEE DRAWING ST-K1425-B.



| Z Z | | | | | | | | |
|--------|-----|------|----|-----|-----|-------------|----------------------|---|
| 9 | | | | | | | DESIGNED BY | |
| | | | | | | | DRAWN BY A. M. | l |
| n | | | | | | | CHECKED BY K. CHARAN | |
| 000 | | | | | | | IN CHARGE C. LEMLEY | c |
| | REV | DATE | BY | снк | APP | DESCRIPTION | 05/08/2015 | |

RECORD SET
15% DESIGN
SUBMITTAL
NOT FOR
CONSTRUCTION





CALIFORNIA HIGH-SPEED TRAIN PROJECT MERCED TO FRESNO SECTION

CENTRAL VALLEY WYE

SR 152 (NORTH) TO ROAD 19 WYE ALTERNATIVE

GENERAL PLAN (MER-FRE)

AERIAL #3 - SOUTHBOUND OVER HST MAINLINE - 1 OF 5

| CONTRACT NO. |
|--------------|
| HSR08-05 |
| DRAWING NO. |
| ST-K1420-B |
| SCALE |
| AS SHOWN |
| SHEET NO. |
| |

TOP OF RAIL PROFILE (HST SB TRACK MER-FRE) NO SCALE

K. CHARAN

IN CHARGE
C. LEMLEY

05/08/2015


DATE

BY CHK APP

DESCRIPTION

NOT FOR

CONSTRUCTION

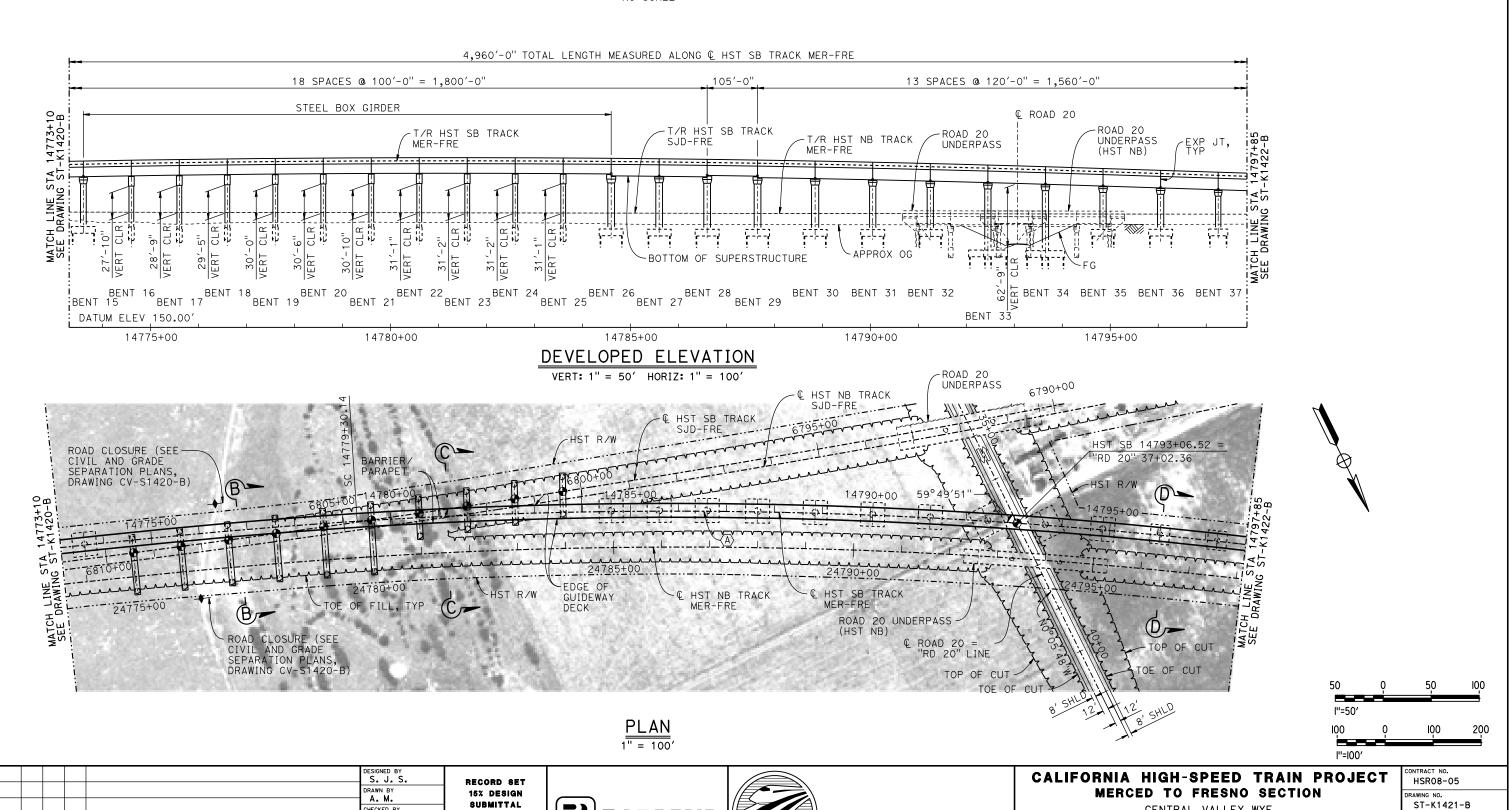

CALIFORNIA

HIGH-SPEED RAIL AUTHORITY

PARSONS

CENTRAL VALLEY WYE


SR 152 (NORTH) TO ROAD 19 WYE ALTERNATIVE


GENERAL PLAN (MER-FRE)

AERIAL #3 - SOUTHBOUND OVER HST MAINLINE - 2 OF 5

AS SHOWN

SHEET NO.

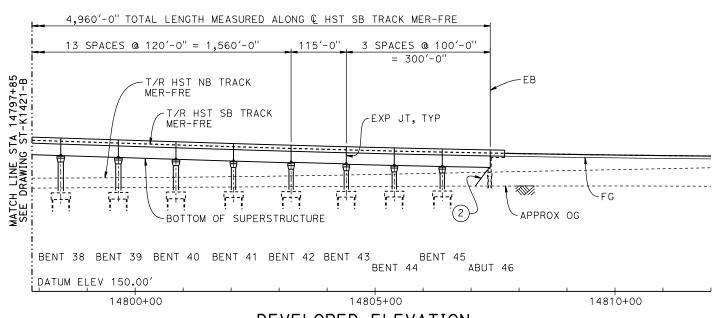

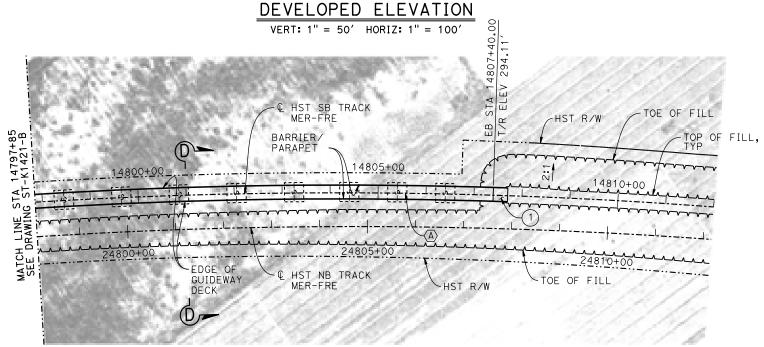

PLAN 1" = 100'

l''=50'

| ` — | | | | _ | | 1 | |
|-----|------|----|-----|-----|-------------|------------------------|--------------|
| | | | | | | DESIGNED BY | RECORD SET |
| | | | | | | DRAWN BY | 15% DESIGN |
| | | | | | | CHECKED BY | SUBMITTAL |
| | | | | | | K. CHARAN IN CHARGE | NOT FOR |
| | | | | | | C. LEMLEY | CONSTRUCTION |
| REV | DATE | BY | СНК | APP | DESCRIPTION | 05/08/2015 | |

15% DESIGN SUBMITTAL NOT FOR CONSTRUCTION





CALIFORNIA HIGH-SPEED TRAIN PROJECT MERCED TO FRESNO SECTION


CENTRAL VALLEY WYE SR 152 (NORTH) TO ROAD 19 WYE ALTERNATIVE GENERAL PLAN (MER-FRE) AERIAL #3 - SOUTHBOUND OVER HST MAINLINE - 3 OF 5


| CONTRACT NO. |
|--------------|
| HSR08-05 |
| DRAWING NO. |
| ST-K1422-B |
| SCALE |
| AS SHOWN |
| SHEET NO. |
| |


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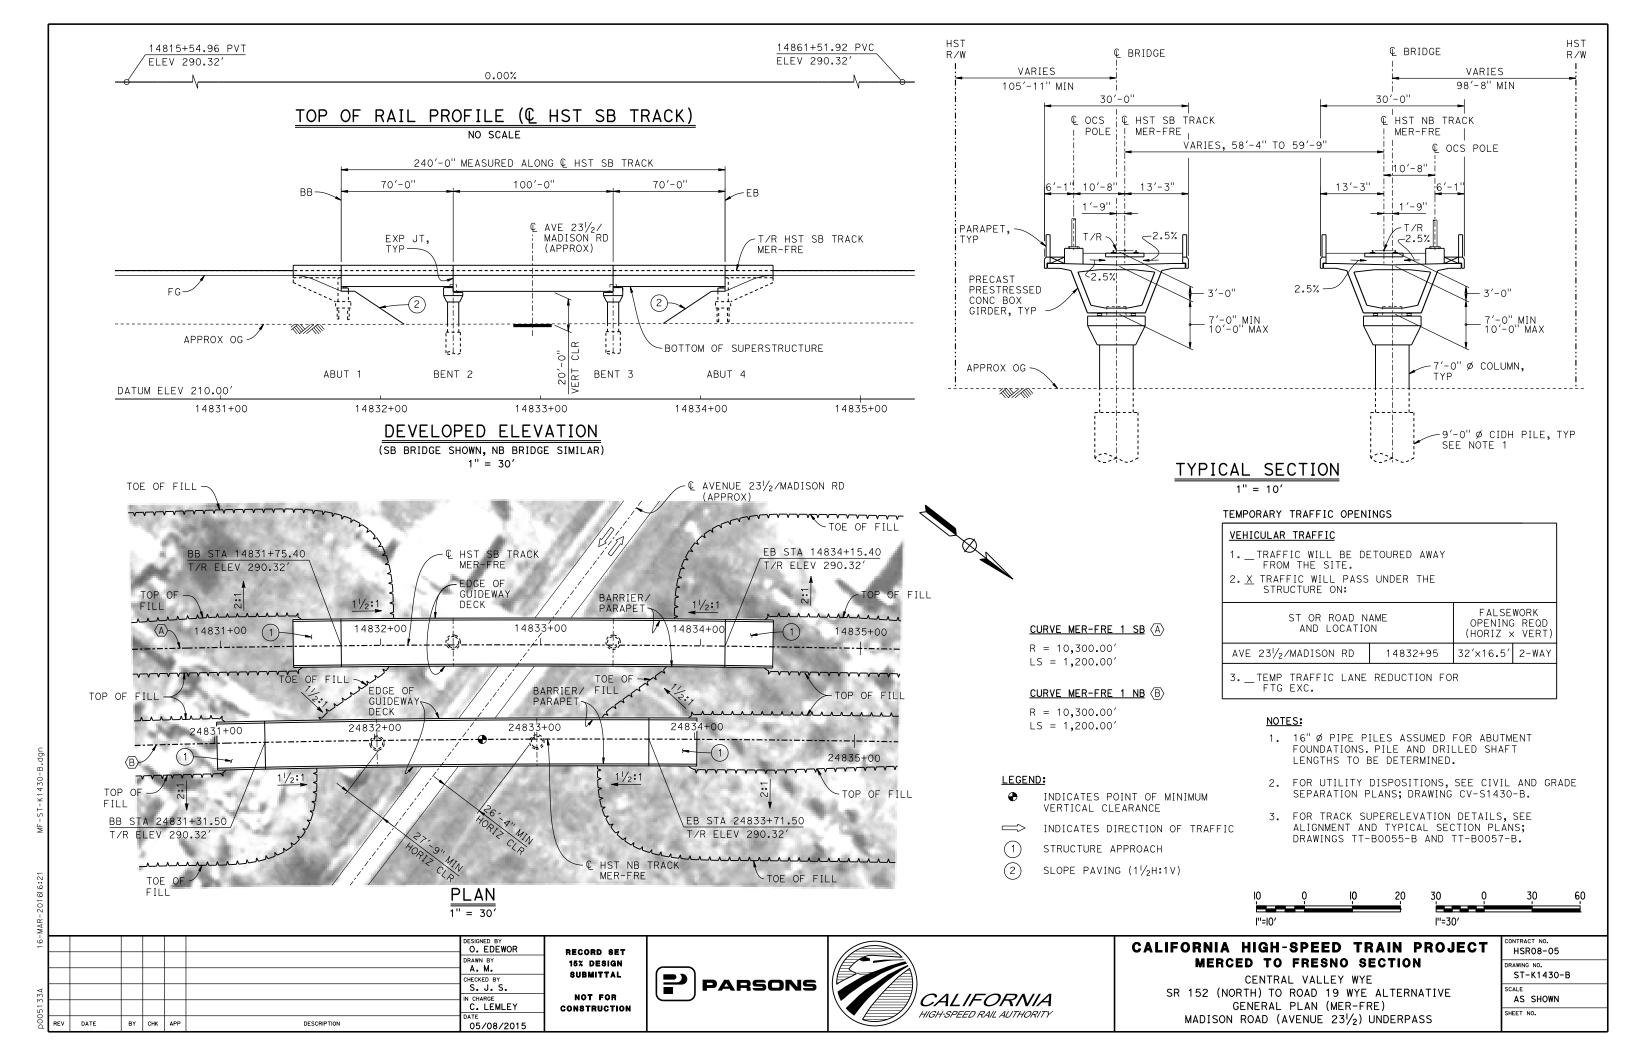
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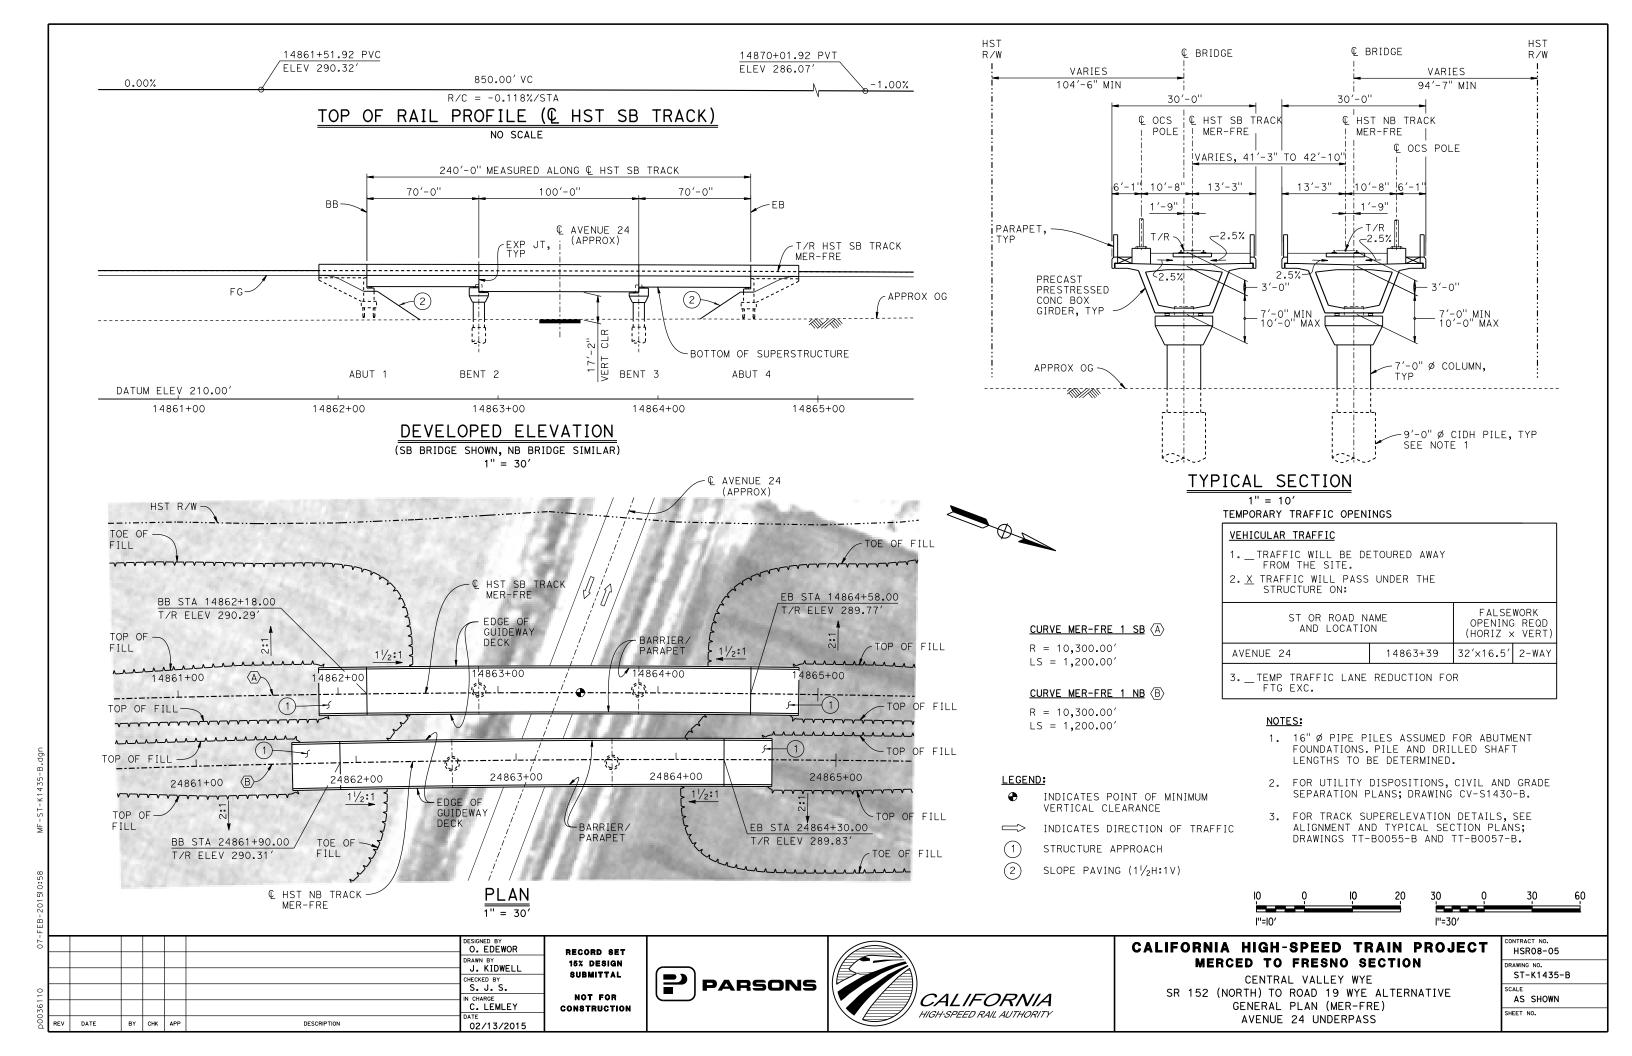
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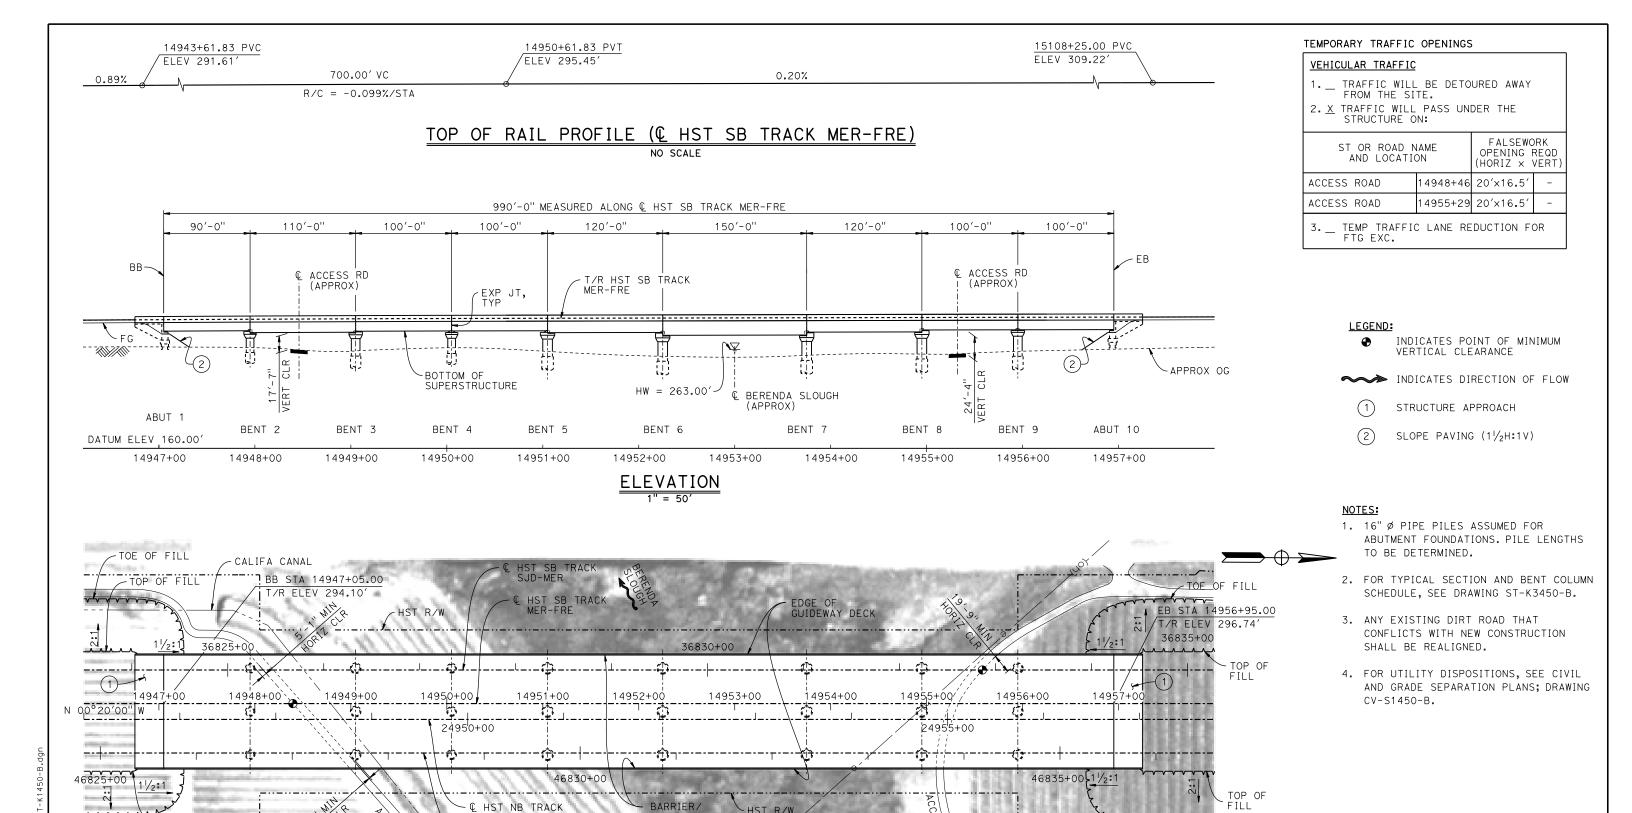






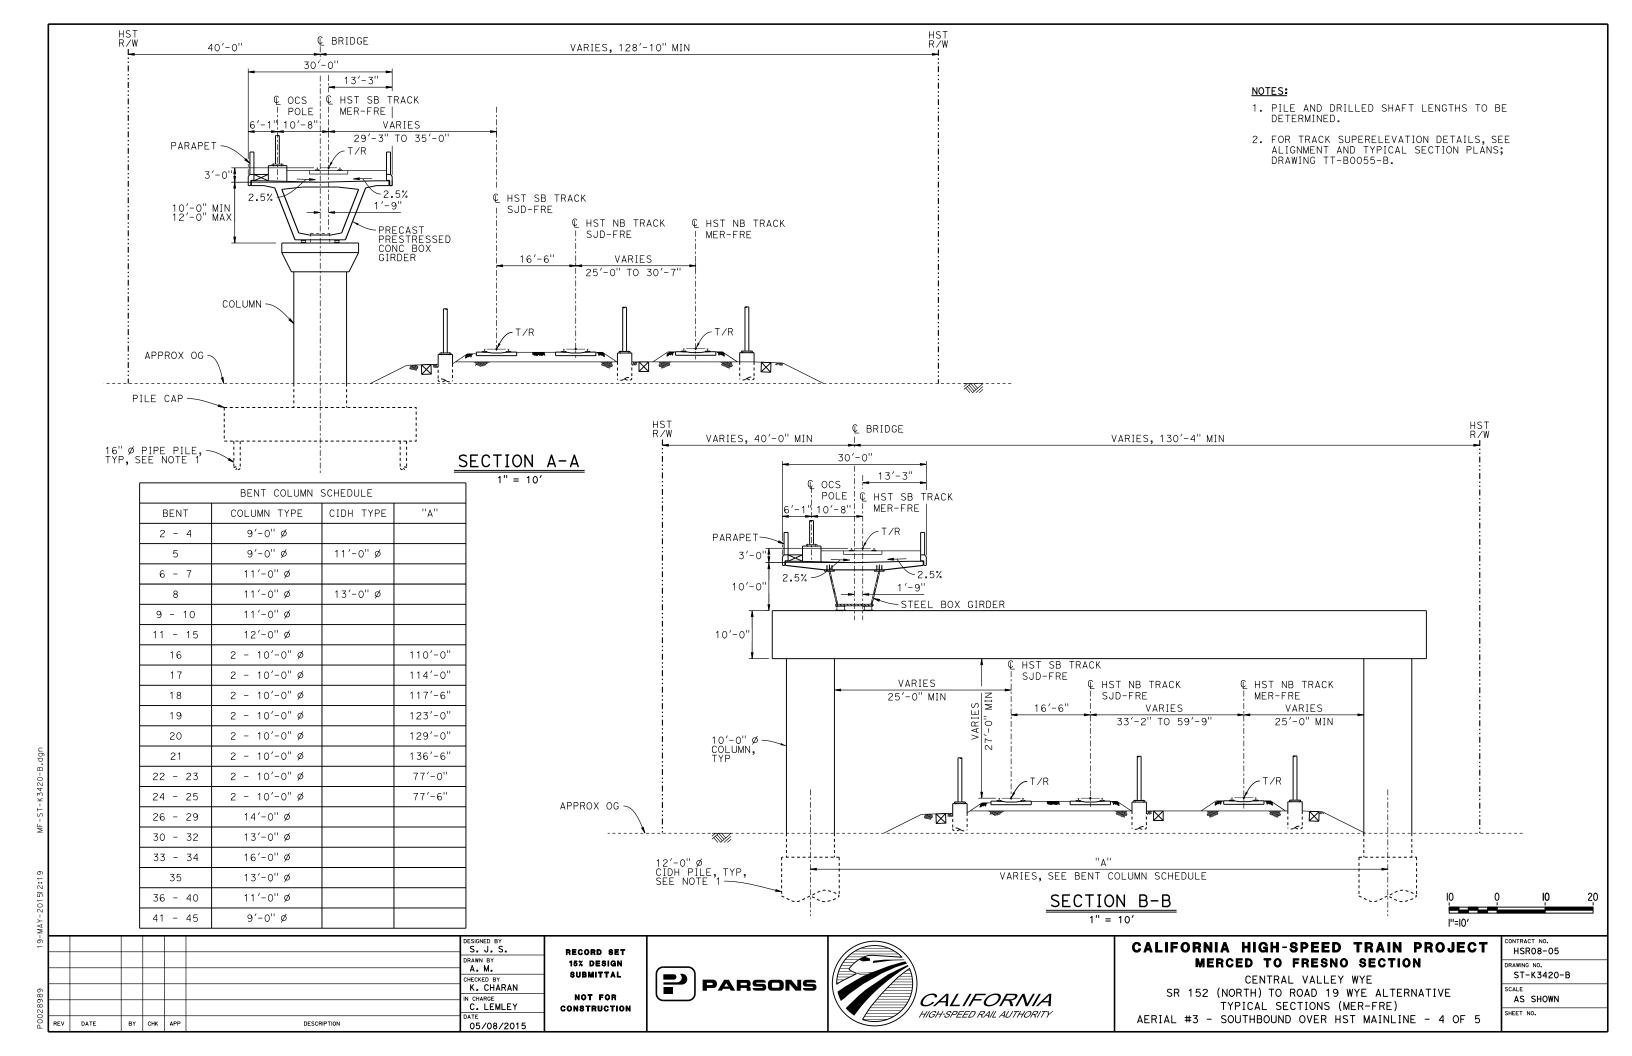

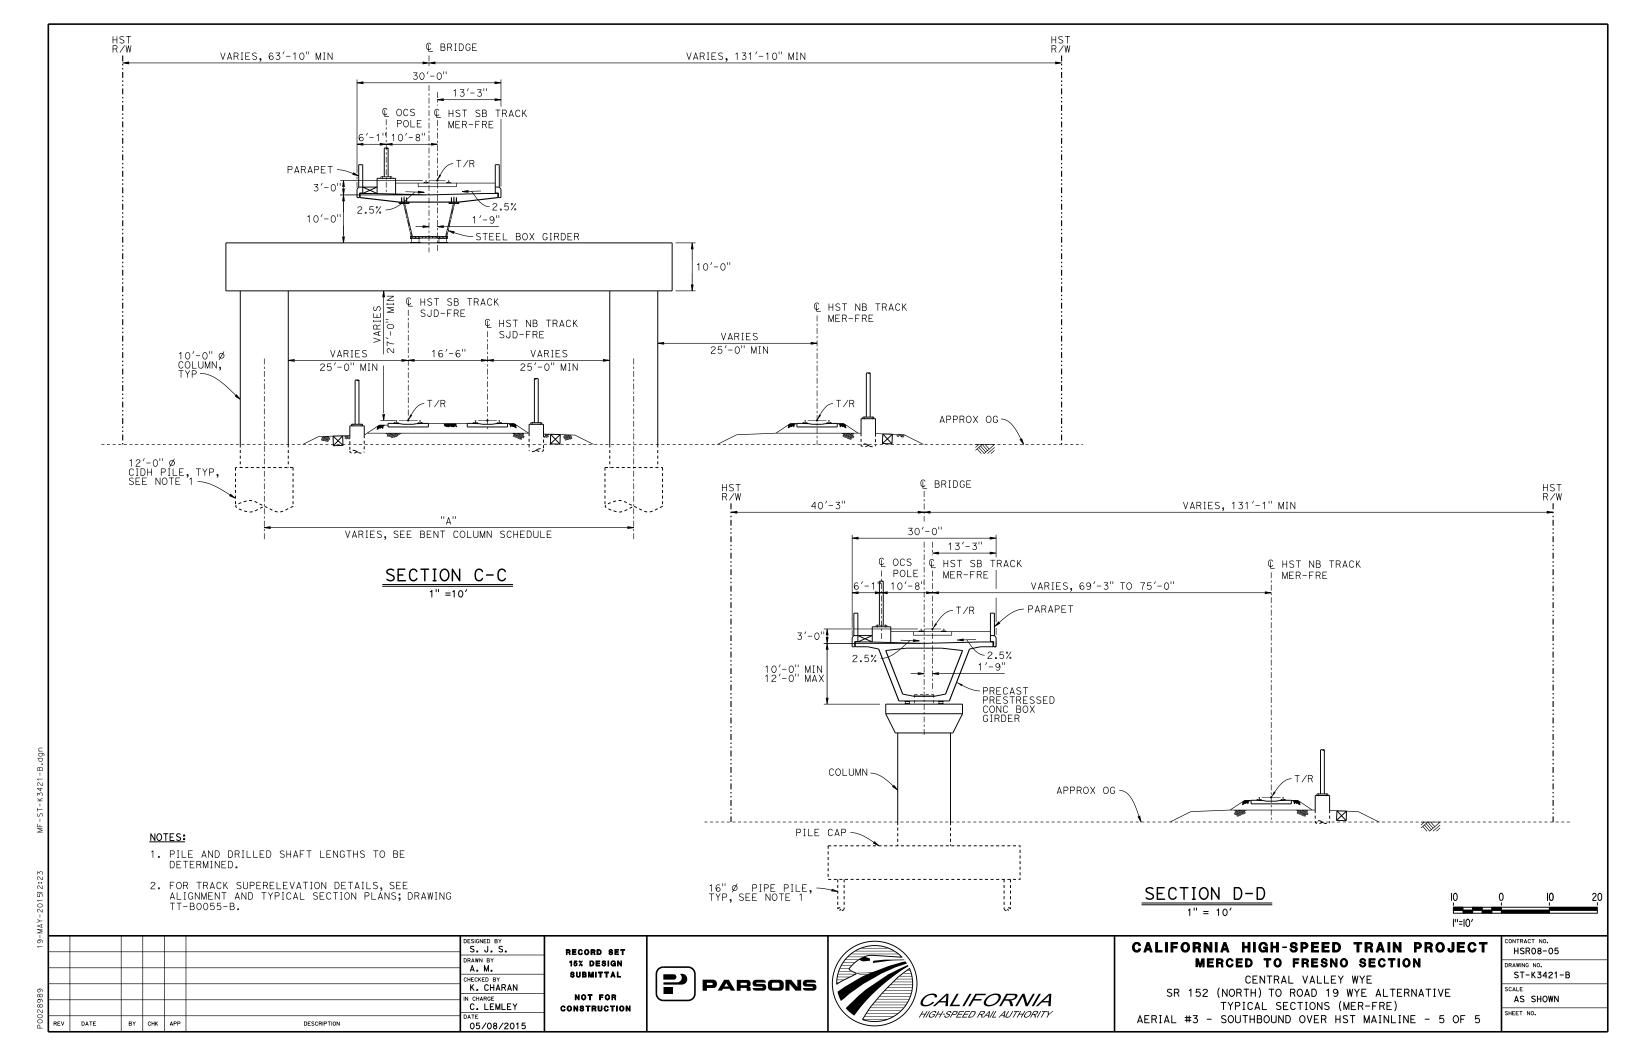

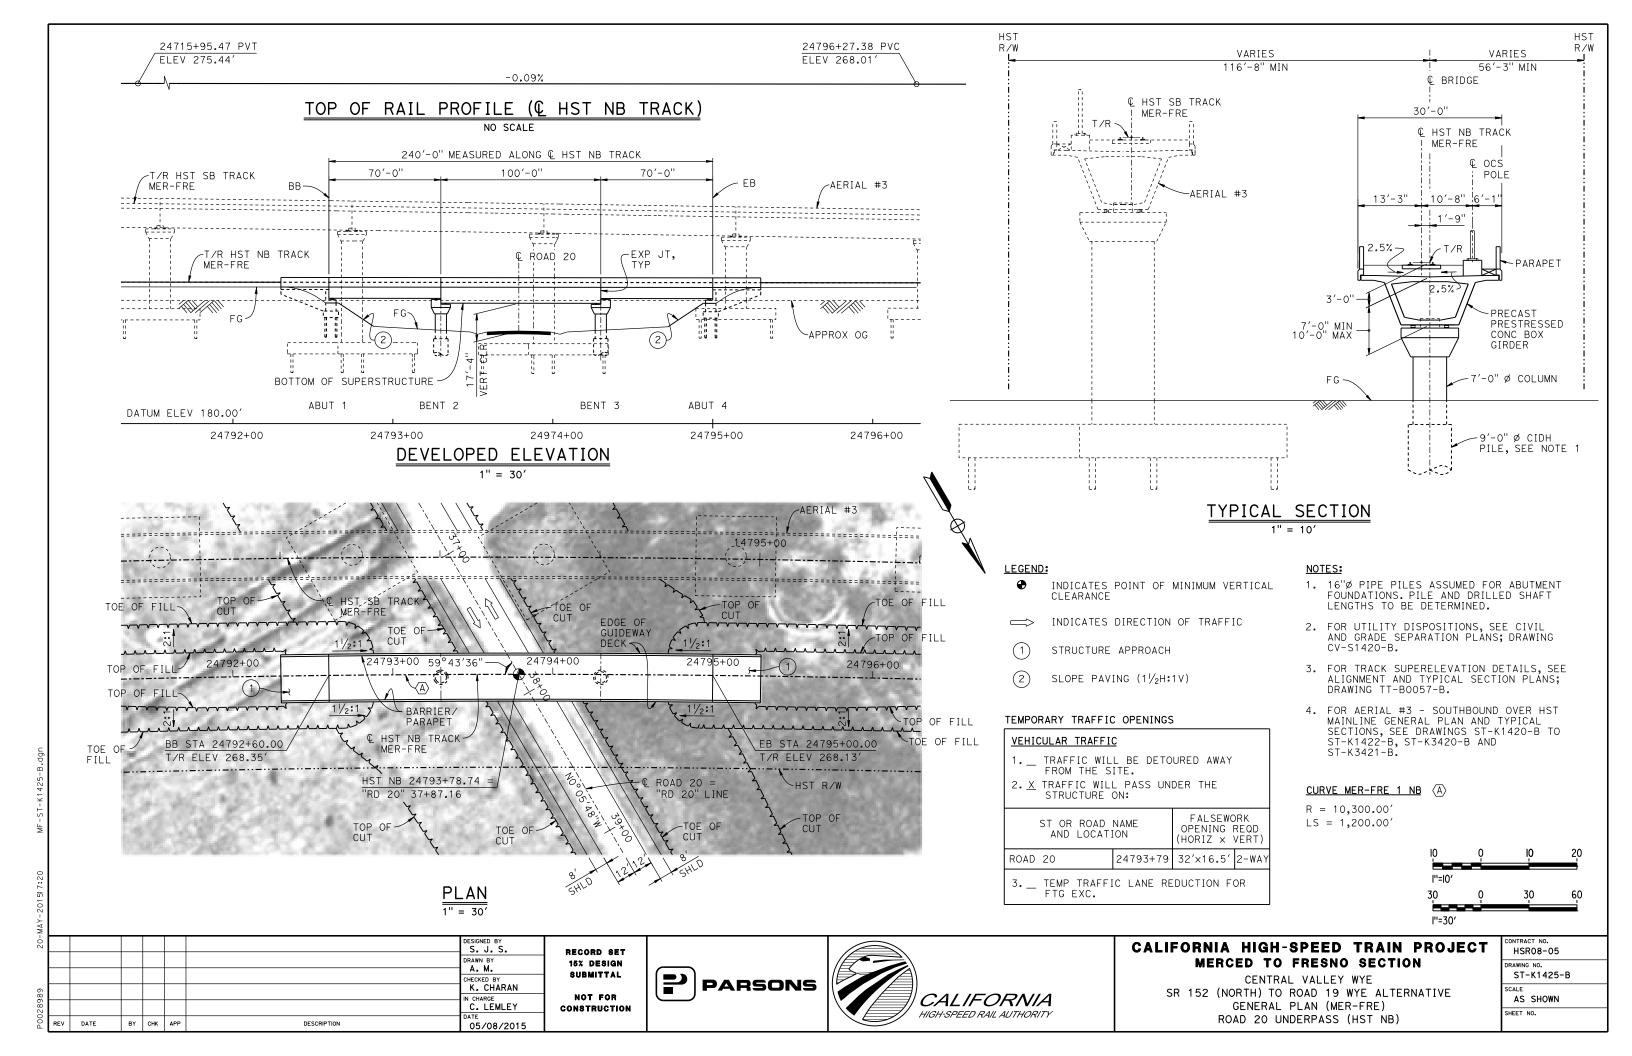

50 0 50 100

TOP OF

TOE OF FILL

RECORD SET
15% DESIGN
SUBMITTAL
NOT FOR
CONSTRUCTION

MER-FRE

- © HST NB TRACK SJD-MER



PLAN

1" = 50'




CALIFORNIA HIGH-SPEED TRAIN PROJECT MERCED TO FRESNO SECTION

TOE OF FILL

CENTRAL VALLEY WYE
SR 152 (NORTH) TO ROAD 19 WYE ALTERNATIVE
GENERAL PLAN (MER-FRE)
BERENDA SLOUGH BRIDGE - 1 OF 2

| CONTRACT NO. |
|--------------|
| HSR08-05 |
| DRAWING NO. |
| ST-K1450-B |
| SCALE |
| AS SHOWN |
| SHEET NO. |
| |

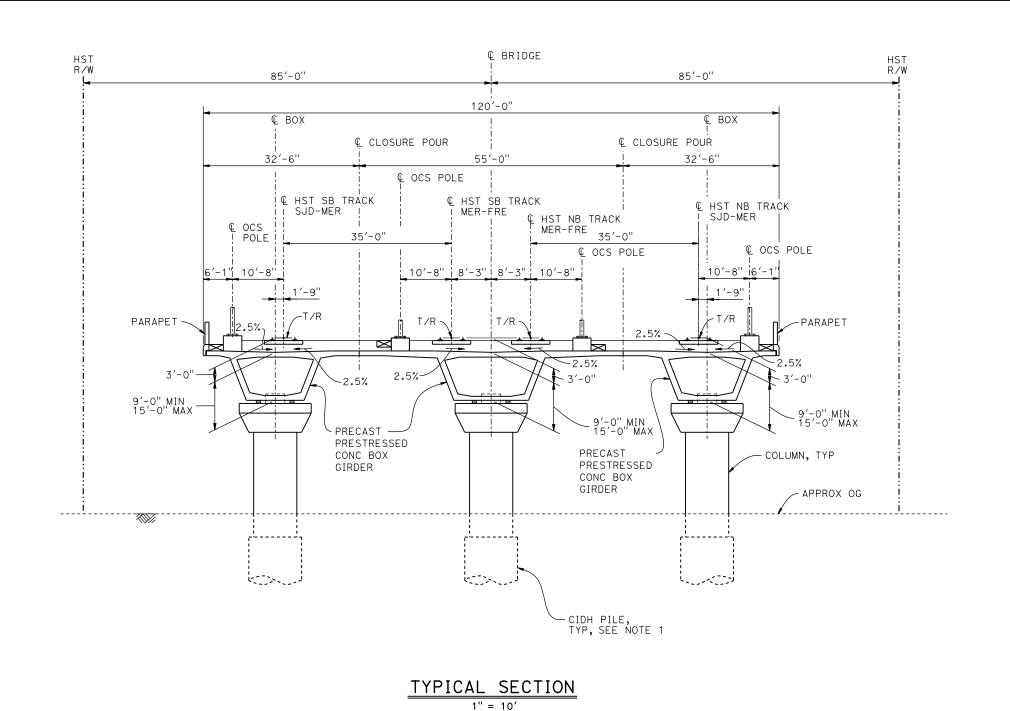

| | BENT COLUMN SCH | HEDULE |
|-------|---------------------|----------------------|
| BENT | COLUMN TYPE | CIDH TYPE |
| 2 | 8'-0" Ø | 10'-0" Ø |
| 3 | 9'-0" Ø | 11'-0" Ø |
| 4 | 8'-0" Ø | 10'-0" Ø |
| 5 - 8 | 10'-0" Ø | 12′-0" Ø |
| 9 | 9'-0" Ø | 11'-0" Ø |
| 4 | 8'-0" Ø 10'-0" Ø | 10'-0" Ø 12'-0" Ø |

NOTE:

1. DRILLED SHAFT LENGTHS TO BE DETERMINED.



| 07-F | | | | | | | DESIGNED BY O. EDEWOR | RE |
|--------|-----|------|----|-----|-----|-------------|-----------------------|-----|
| | | | | | | | DRAWN BY | 15 |
| 0 | | | | | | | CHECKED BY | 81 |
| _ | | | | | | | IN CHARGE C. LEMLEY | CON |
| .9E00d | REV | DATE | BY | снк | APP | DESCRIPTION | 02/13/2015 | |

RECORD SET
15% DESIGN
SUBMITTAL
NOT FOR
CONSTRUCTION








CALIFORNIA HIGH-SPEED TRAIN PROJECT MERCED TO FRESNO SECTION

CENTRAL VALLEY WYE
SR 152 (NORTH) TO ROAD 19 WYE ALTERNATIVE
TYPICAL SECTION (MER-FRE)
BERENDA SLOUGH BRIDGE - 2 OF 2

| CONTRACT NO. HSR08-05 |
|---------------------------|
| DRAWING NO. ST-K3450-B |
| SCALE |
| |
| AS SHOWN |
| SHEET NO. |
| |

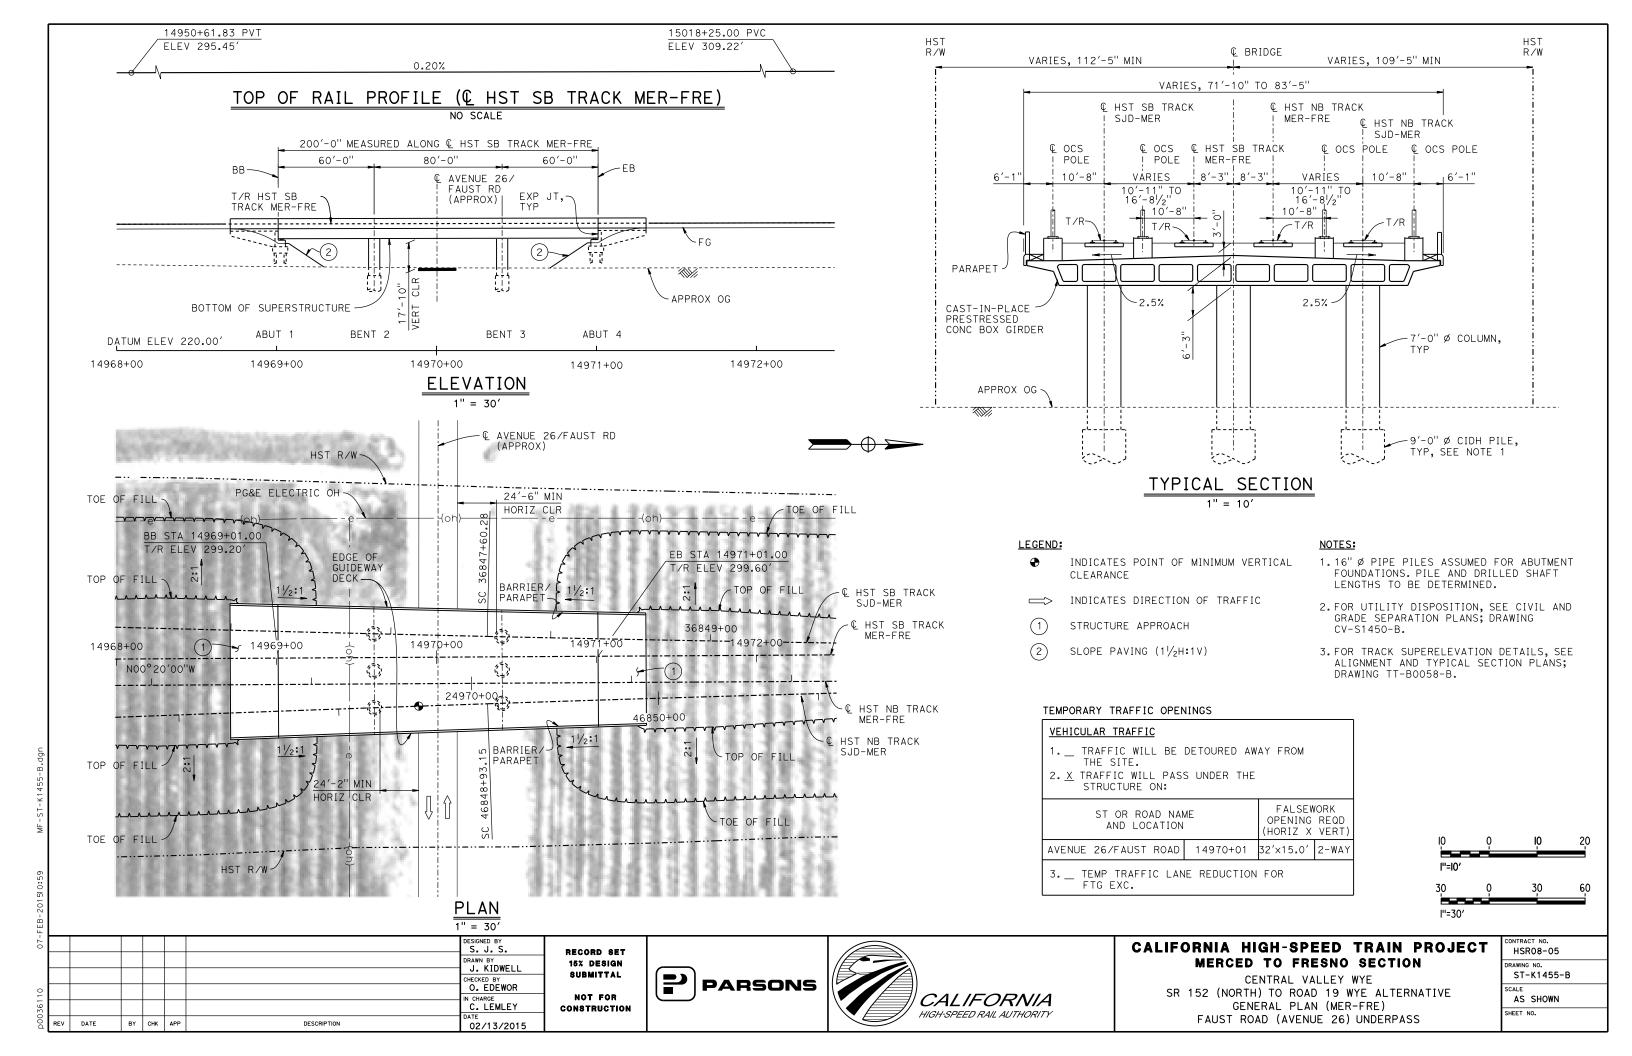

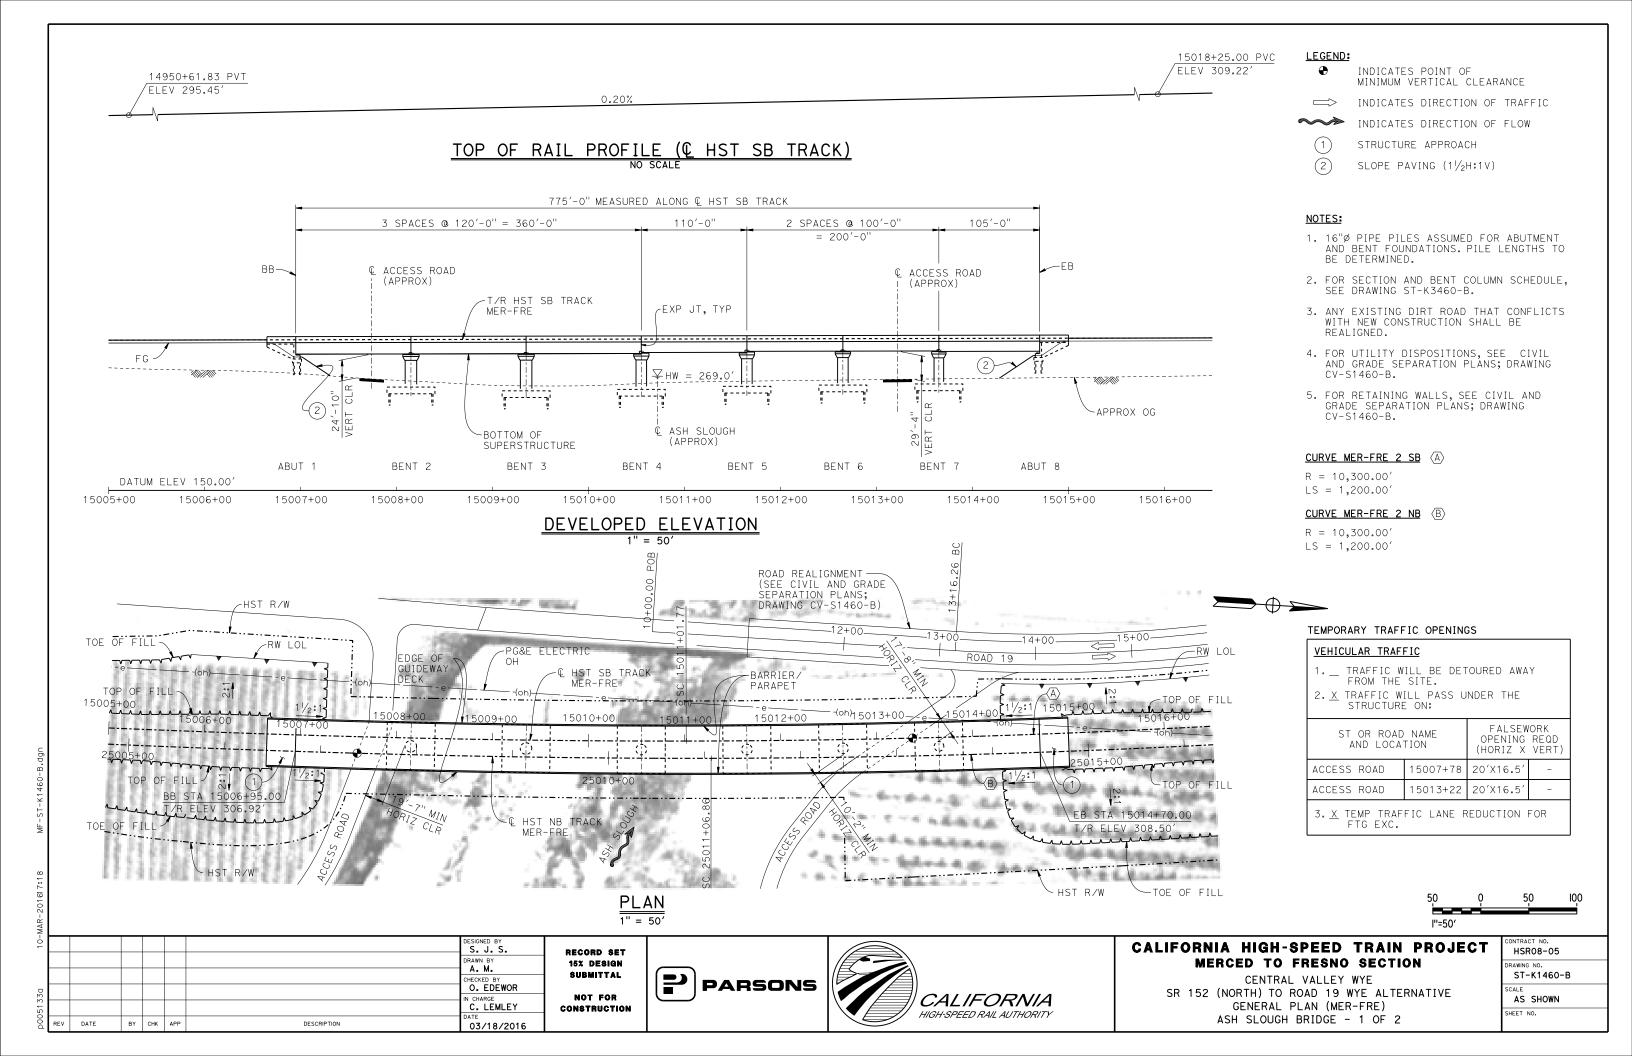

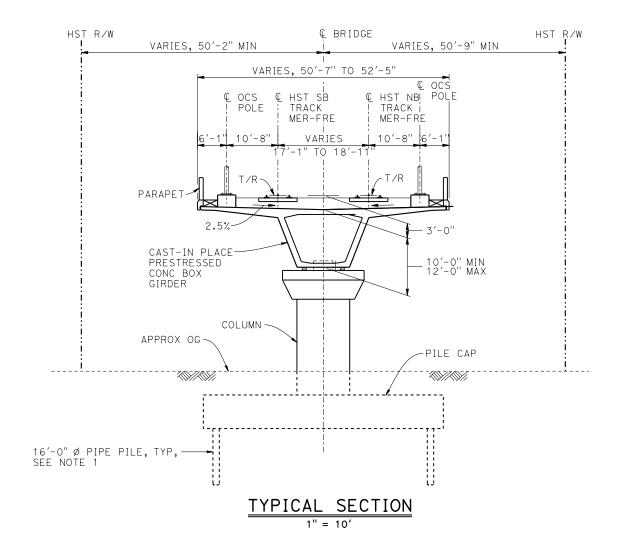

| BENT C | OLUMN SCHEDULE |
|--------|----------------|
| BENT | COLUMN TYPE |
| 2 - 3 | 12'-0" Ø |
| 4 - 6 | 11'-0'' ø |
| 7 | 10'-0" Ø |

NOTES:

- 1. PILE LENGTHS TO BE DETERMINED.
- 2. FOR TRACK SUPERELEVATION DETAILS, SEE ALIGNMENT AND TYPICAL SECTION PLANS; DRAWINGS TT-B0055-B AND TT-B0057-B.



| MΑΥ | | | | | | | | |
|-------|-----|------|----|-----|-----|-------------|----------------------|---|
| 22- | | | | | | | DESIGNED BY S. J. S. | |
| | | | | | | | DRAWN BY A. M. | • |
| 30 | | | | | | | CHECKED BY O. EDEWOR | |
| M | | | | | | | IN CHARGE C. LEMLEY | c |
| p0051 | REV | DATE | BY | снк | APP | DESCRIPTION | DATE 05/08/2015 | |

RECORD SET
15% DESIGN
SUBMITTAL
NOT FOR
CONSTRUCTION








CALIFORNIA HIGH-SPEED TRAIN PROJECT MERCED TO FRESNO SECTION

CENTRAL VALLEY WYE
SR 152 (NORTH) TO ROAD 19 WYE ALTERNATIVE
TYPICAL SECTION (MER-FRE)
ASH SLOUGH BRIDGE - 2 OF 2


| CONTRACT NO. |
|--------------|
| HSR08-05 |
| DRAWING NO. |
| ST-K3460-B |
| SCALE |
| AS SHOWN |
| SHEET NO. |
| |

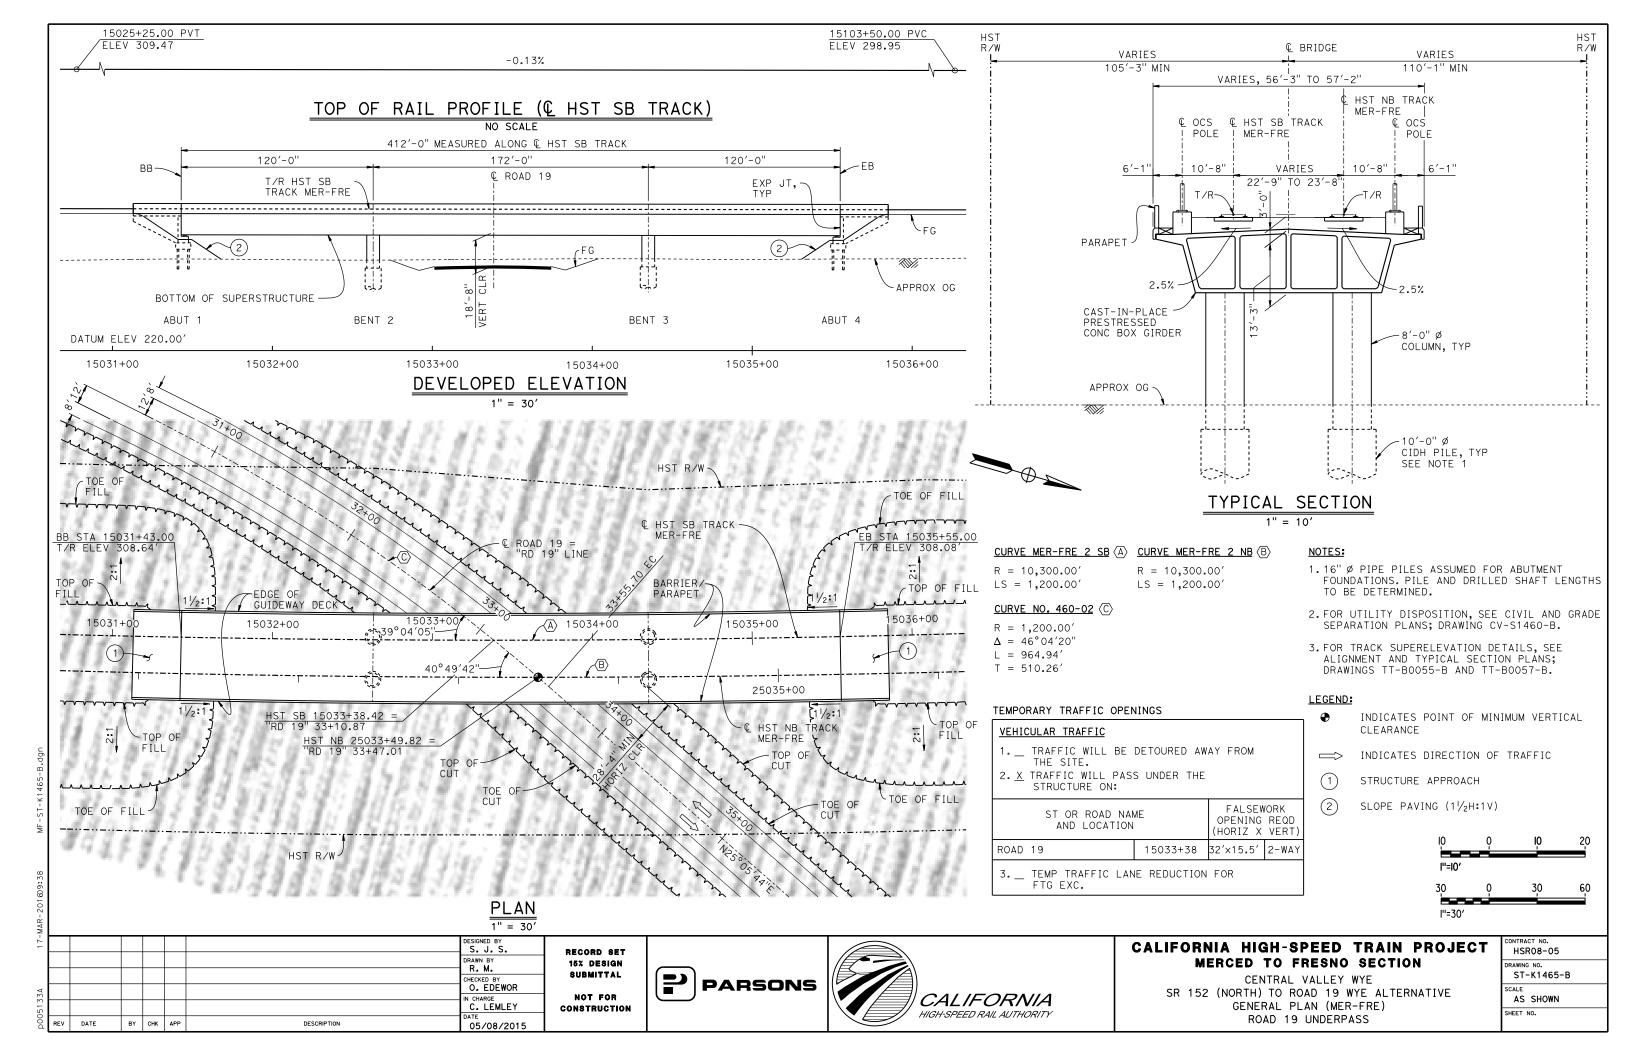

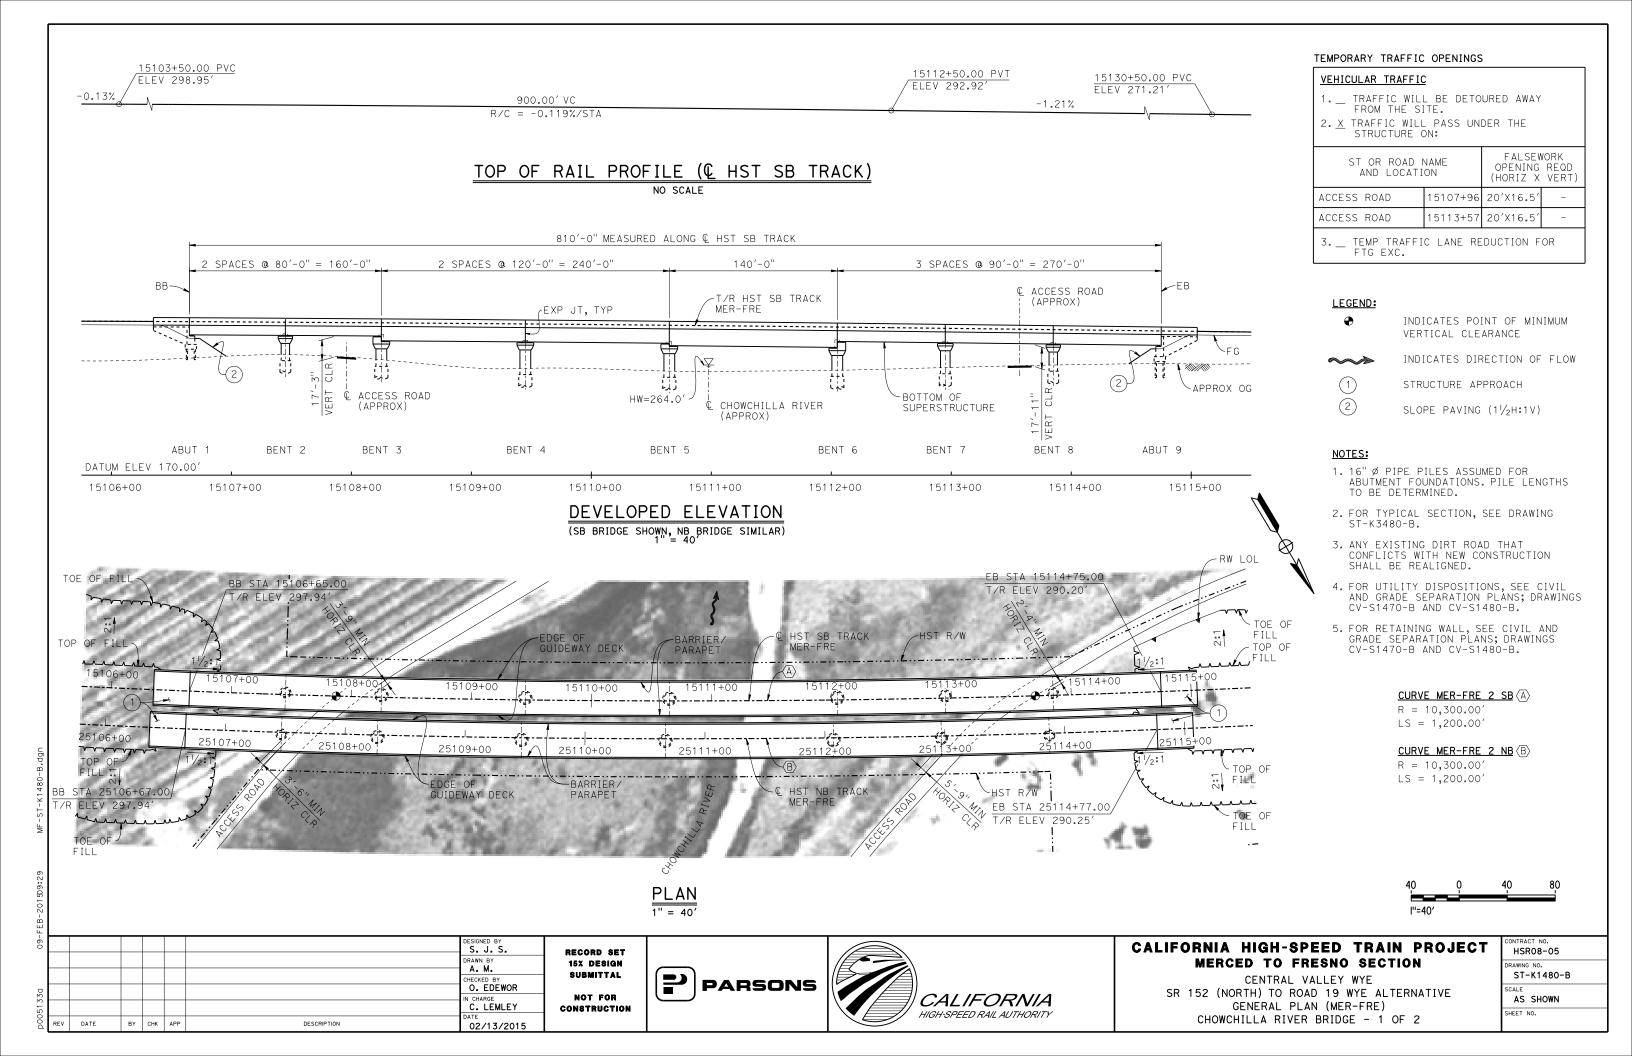

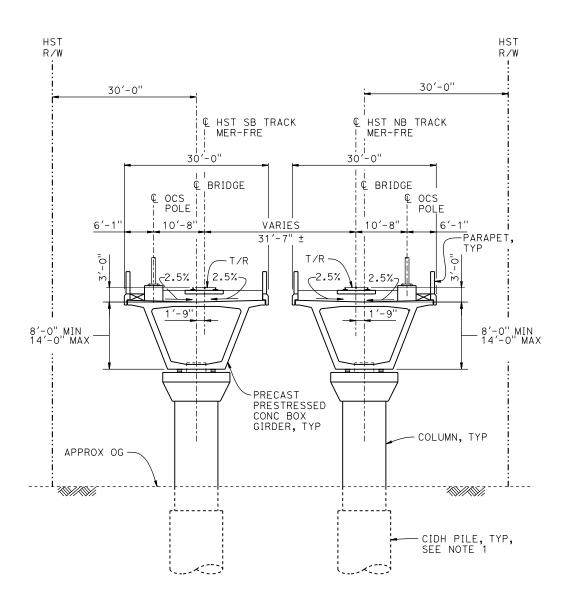

TYPICAL SECTION

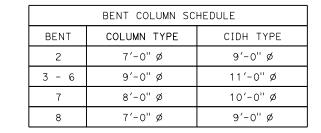

NOTES:

- 1. DRILLED SHAFT LENGTHS TO BE DETERMINED.
- 2. FOR TRACK SUPERELEVATION DETAILS, SEE ALIGNMENT AND TYPICAL SECTION PLANS; DRAWINGS TT-B0055-B AND TT-B0057-B.



| FEB | | | | | | | | |
|-------|-----|------|----|-----|-----|-------------|-----------------------|----|
| -70 | | | | | | | DESIGNED BY S. J. S. | R |
| | | | | | | | DRAWN BY A. M. | 1 |
| 0 | | | | | | | CHECKED BY O. EDEWOR | |
| 3611(| | | | | | | IN CHARGE C. LEMLEY | co |
| D00d | REV | DATE | BY | СНК | APP | DESCRIPTION | DATE 02/13/2015 | |

RECORD SET
15% DESIGN
SUBMITTAL
NOT FOR
CONSTRUCTION







CALIFORNIA HIGH-SPEED TRAIN PROJECT MERCED TO FRESNO SECTION

CENTRAL VALLEY WYE
SR 152 (NORTH) TO ROAD 19 WYE ALTERNATIVE
TYPICAL SECTION (MER-FRE)
CHOWCHILLA RIVER BRIDGE - 2 OF 2


| CONTRACT NO. |
|--------------|
| HSR08-05 |
| DRAWING NO. |
| ST-K3480-B |
| SCALE |
| AS SHOWN |
| SHEET NO. |
| |

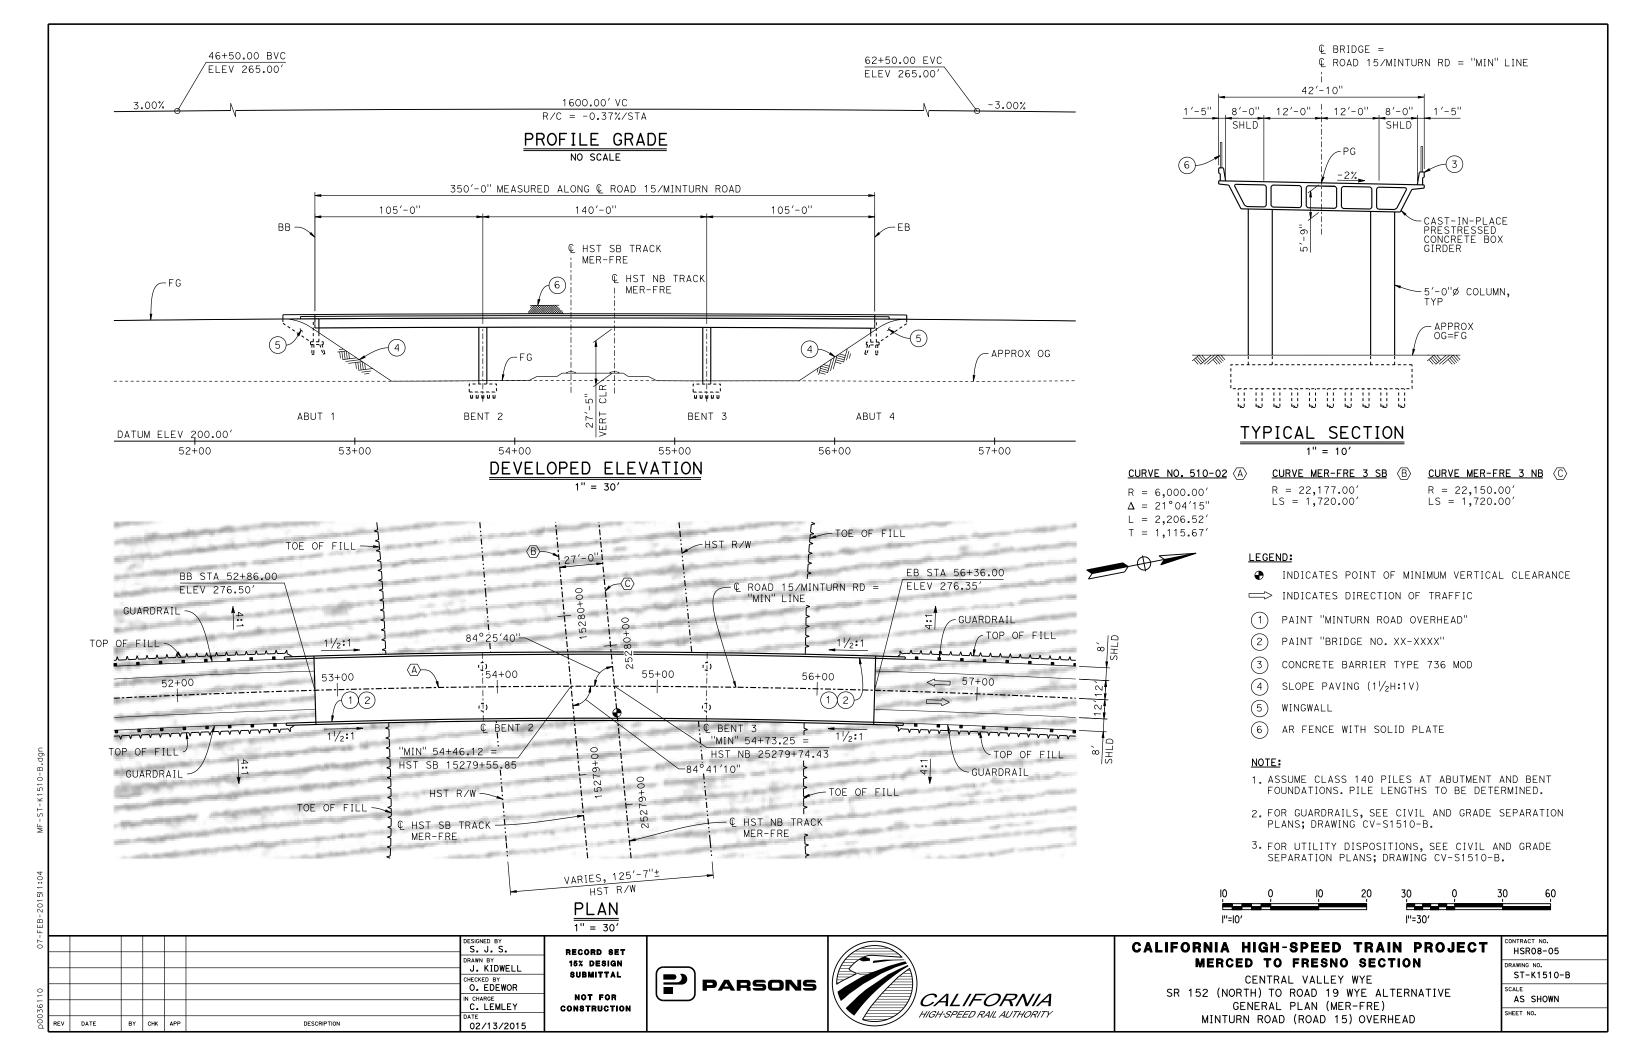

TOP OF RAIL PROFILE (HST SB TRACK) NO SCALE

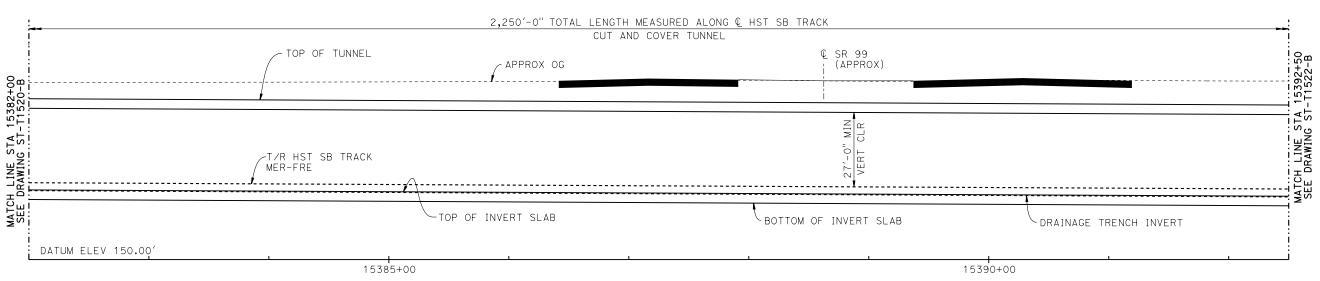

DEVELOPED LONGITUDINAL SECTION

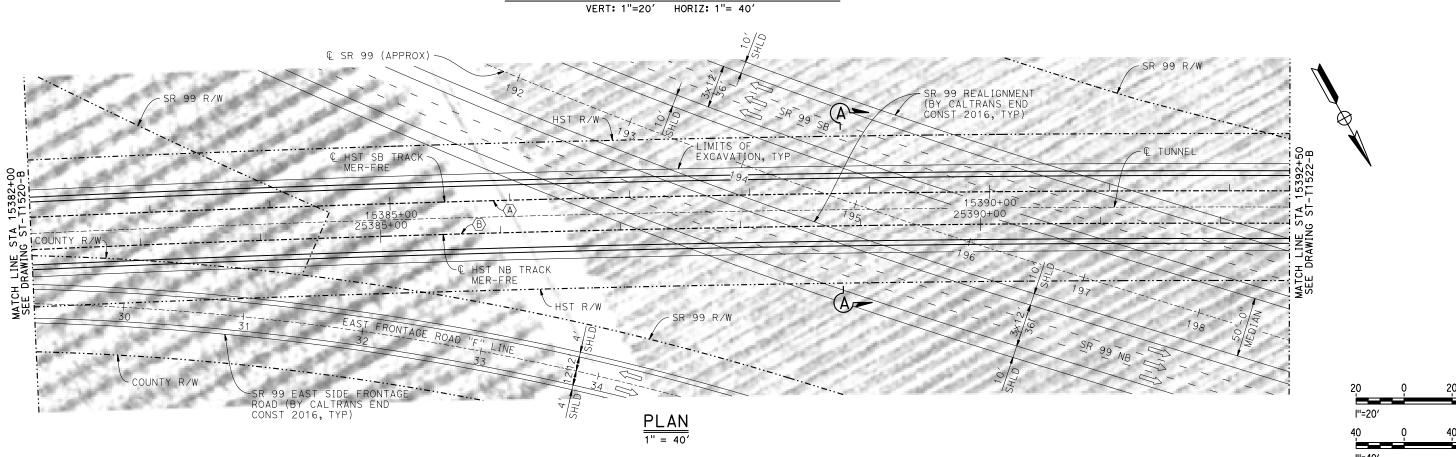

DESIGNED BY
O. EDEWOR
ORANN BY
J. C.
CHECKED BY
S. J. S.
IN CHARGE
C. LEMLEY
DATE
BY CHK APP
DESCRIPTION
DATA O 3/18/2016

RECORD SET
15% DESIGN
SUBMITTAL
NOT FOR
CONSTRUCTION





CALIFORNIA HIGH-SPEED TRAIN PROJECT MERCED TO FRESNO SECTION


CENTRAL VALLEY WYE
SR 152 (NORTH) TO ROAD 19 WYE ALTERNATIVE
GENERAL PLAN (MER-FRE)
CUT AND COVER TUNNEL AT SR 99 - 2 OF 5

| CONTRACT NO. HSR08-05 |
|---------------------------|
| DRAWING NO. ST-T1521-B |
| AS SHOWN |
| SHEET NO. |

-0.25%


TOP OF RAIL PROFILE (& HST SB TRACK)

NO SCALE

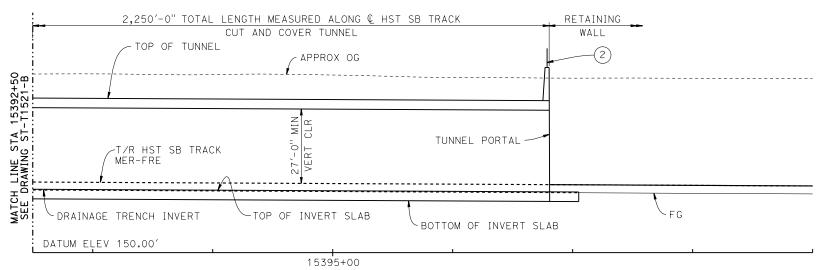

DEVELOPED LONGITUDINAL SECTION

VERT: 1"=20' HORIZ: 1"= 40'

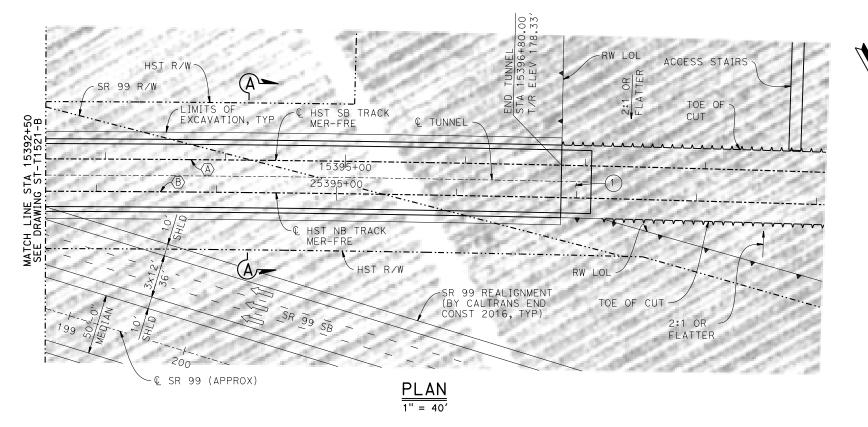

| 20 | Q | 20 | 40 |
|---------|---|----|----|
| l''=20′ | | | |
| 40 | Q | 40 | 80 |
| l''=40′ | | | |

| | | | | | | DESIGNED BY O. EDEWOR DRAWN BY J. C. | T |
|-----|------|----|-----|-----|-------------|--------------------------------------|---|
| | | | | | | CHECKED BY S. J. S. | 1 |
| | | | | | | IN CHARGE C. LEMLEY |] |
| REV | DATE | BY | СНК | APP | DESCRIPTION | 03/18/2016 | |

RECORD SET
15% DESIGN
SUBMITTAL
NOT FOR
CONSTRUCTION







CALIFORNIA HIGH-SPEED TRAIN PROJECT MERCED TO FRESNO SECTION

CENTRAL VALLEY WYE
SR 152 (NORTH) TO ROAD 19 WYE ALTERNATIVE
GENERAL PLAN (MER-FRE)
CUT AND COVER TUNNEL AT SR 99 - 3 OF 5

| CONTRACT NO. | |
|--------------|--|
| HSR08-05 | |
| DRAWING NO. | |
| ST-T1522-B | |
| SCALE | |
| AS SHOWN | |
| SHEET NO. | |
| | |

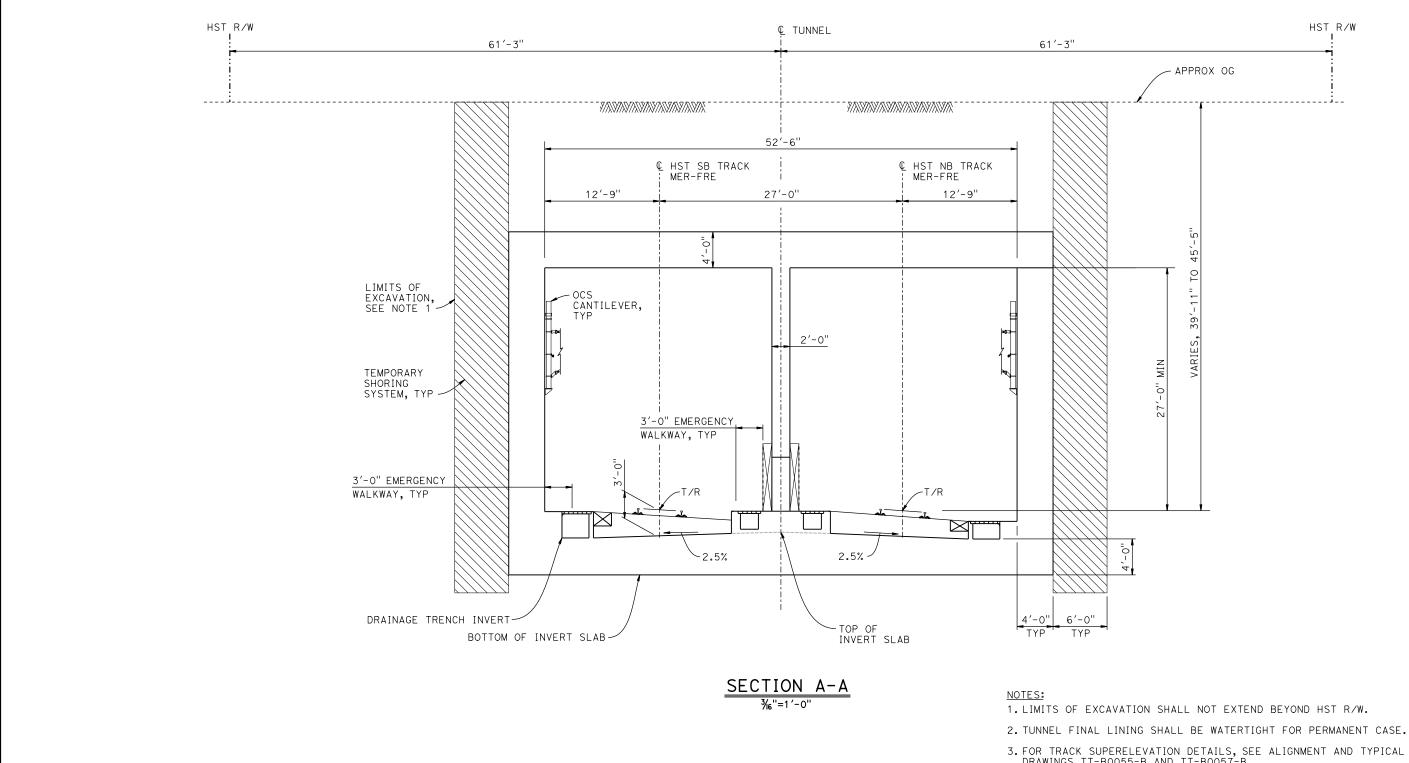

- 3. FOR TRACK SUPERELEVATION DETAILS, SEE ALIGNMENT AND TYPICAL SECTION PLANS; DRAWINGS TT-B0055-B AND TT-B0057-B.

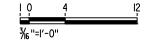

| ببا | | | | | | | | |
|------|-----|------|----|-----|-----|-------------|-----------------------|-----|
| - 20 | | | | | | | DESIGNED BY O. EDEWOR | RE |
| | | | | | | | DRAWN BY J. C. | 15 |
| | | | | | | | CHECKED BY | 81 |
| 10 | | | | | | | S. J. S. IN CHARGE | |
| 361 | | | | | | | C. LEMLEY | CON |
| D00 | REV | DATE | BY | СНК | APP | DESCRIPTION | 02/13/2015 | |

RECORD SET 15% DESIGN SUBMITTAL NOT FOR DNSTRUCTION






CALIFORNIA HIGH-SPEED TRAIN PROJECT MERCED TO FRESNO SECTION

CENTRAL VALLEY WYE SR 152 (NORTH) TO ROAD 19 WYE ALTERNATIVE TYPICAL SECTION (MER-FRE) CUT AND COVER TUNNEL AT SR 99 - 4 OF 5

| CONTRACT NO. HSRO8-05 |
|---------------------------|
| DRAWING NO. ST-T3520-B |
| SCALE AS SHOWN |
| SHEET NO. |

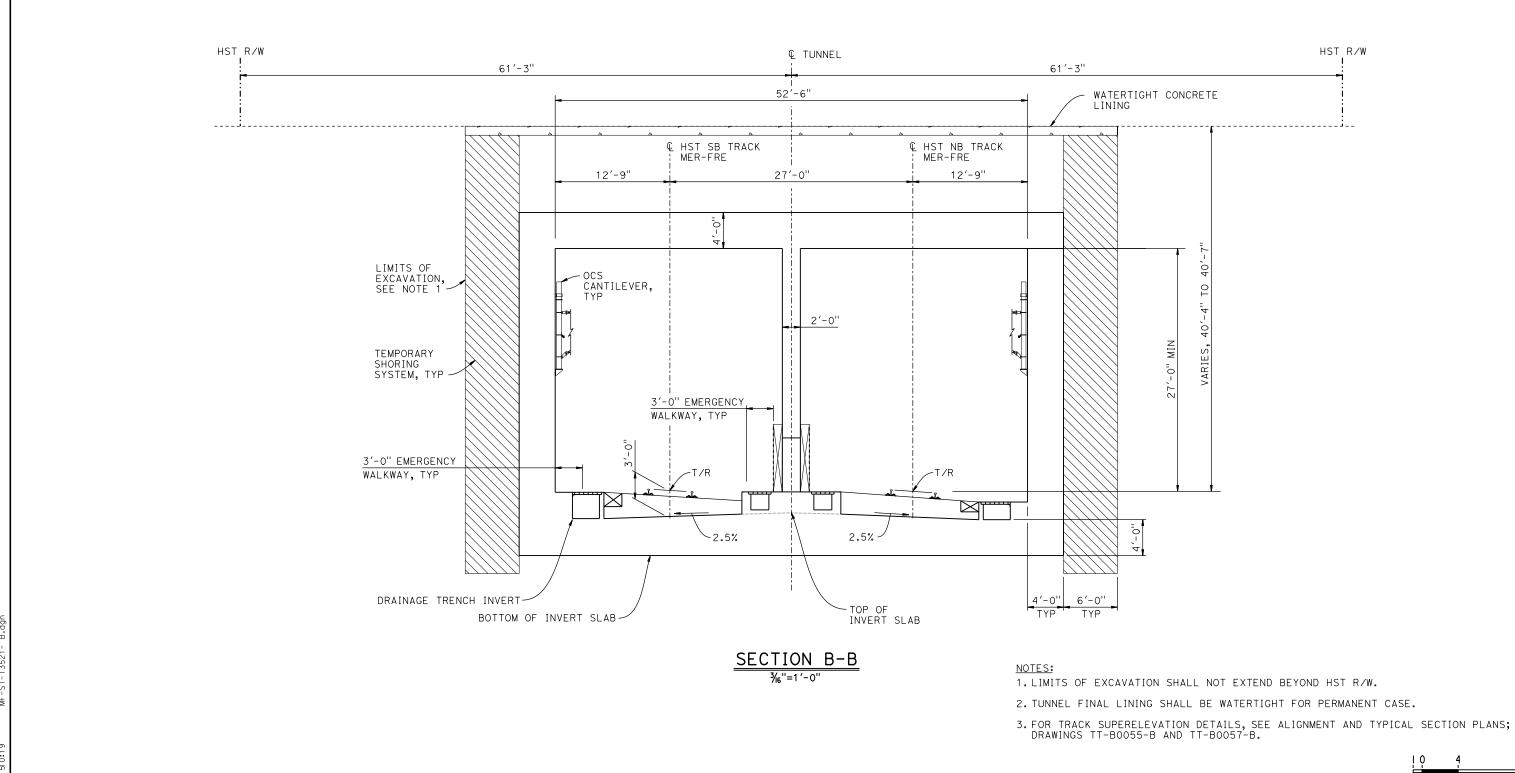

3/₆"=I′−0"

DESIGNED BY
O. EDEWOR
DRAWN BY
J. C.
CHECKED BY
S. J. S.
IN CHARGE
C. LEMLEY

DESIGNATION

RECORD SET
15% DESIGN
SUBMITTAL

NOT FOR
CONSTRUCTION

DESCRIPTION

02/13/2015

BY CHK APP








CALIFORNIA HIGH-SPEED TRAIN PROJECT MERCED TO FRESNO SECTION

CENTRAL VALLEY WYE
SR 152 (NORTH) TO ROAD 19 WYE ALTERNATIVE
TYPICAL SECTION (MER-FRE)
CUT AND COVER TUNNEL AT SR 99 - 5 OF 5

| CONTRACT NO. |
|--------------|
| HSR08-05 |
| DRAWING NO. |
| ST-T3521-B |
| SCALE |
| AS SHOWN |
| SHEET NO. |
| |

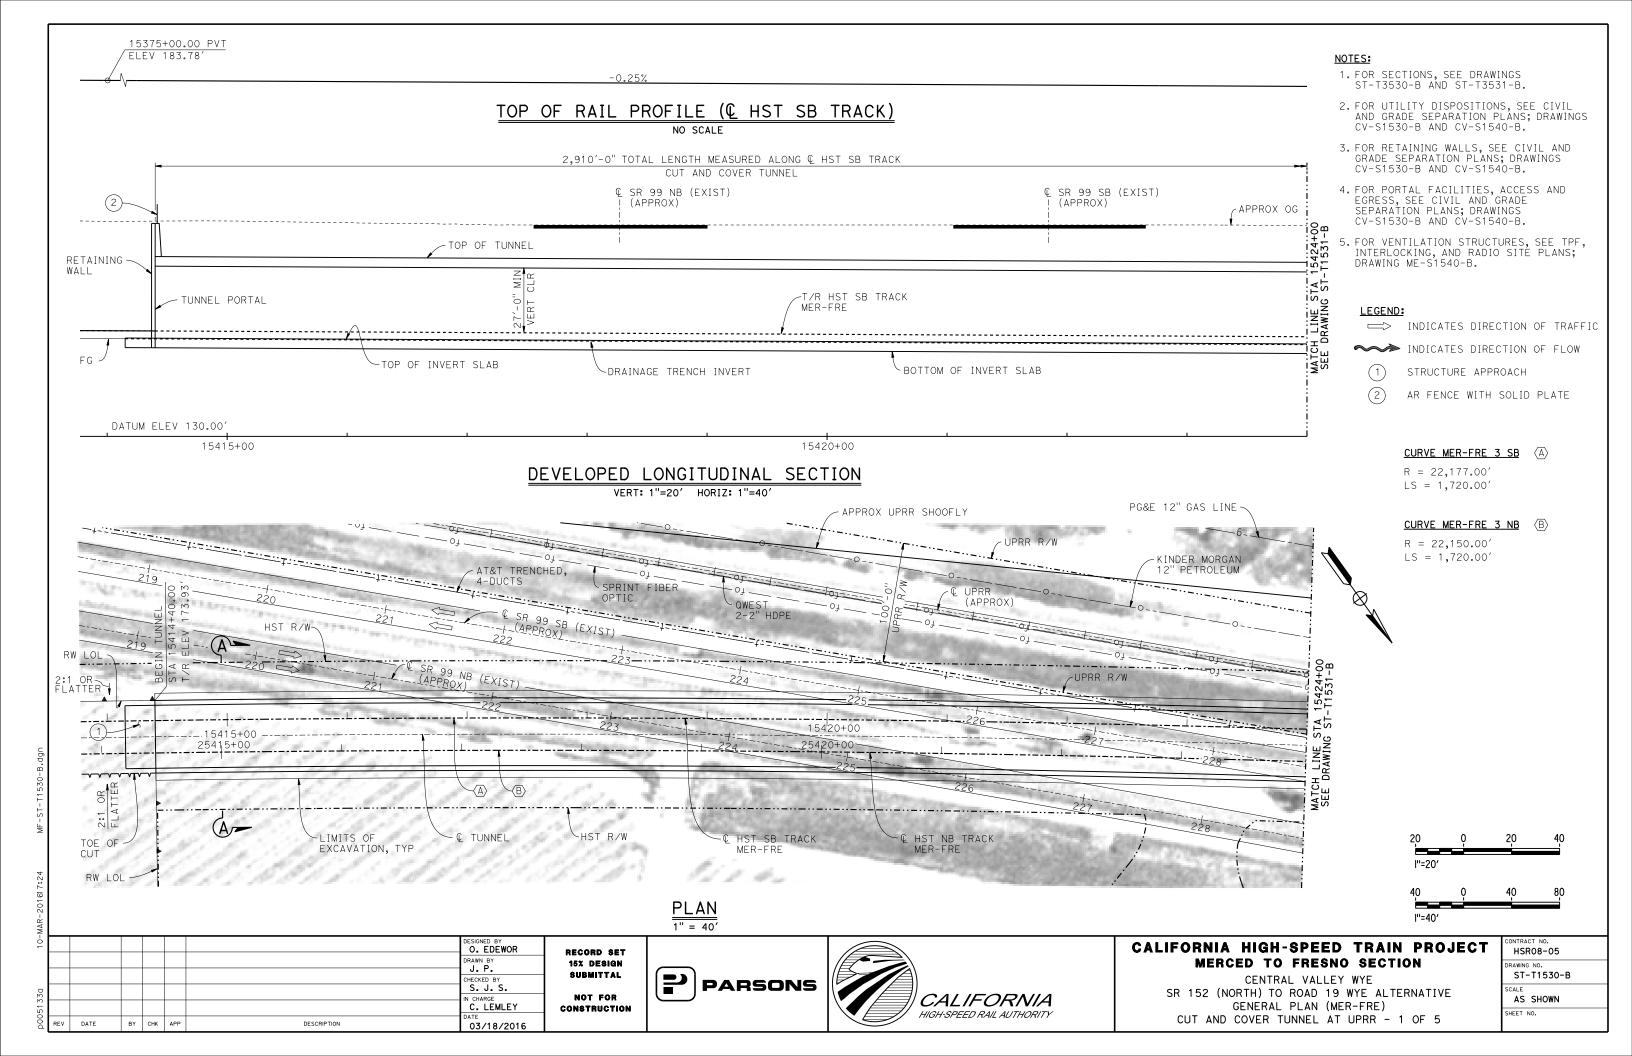

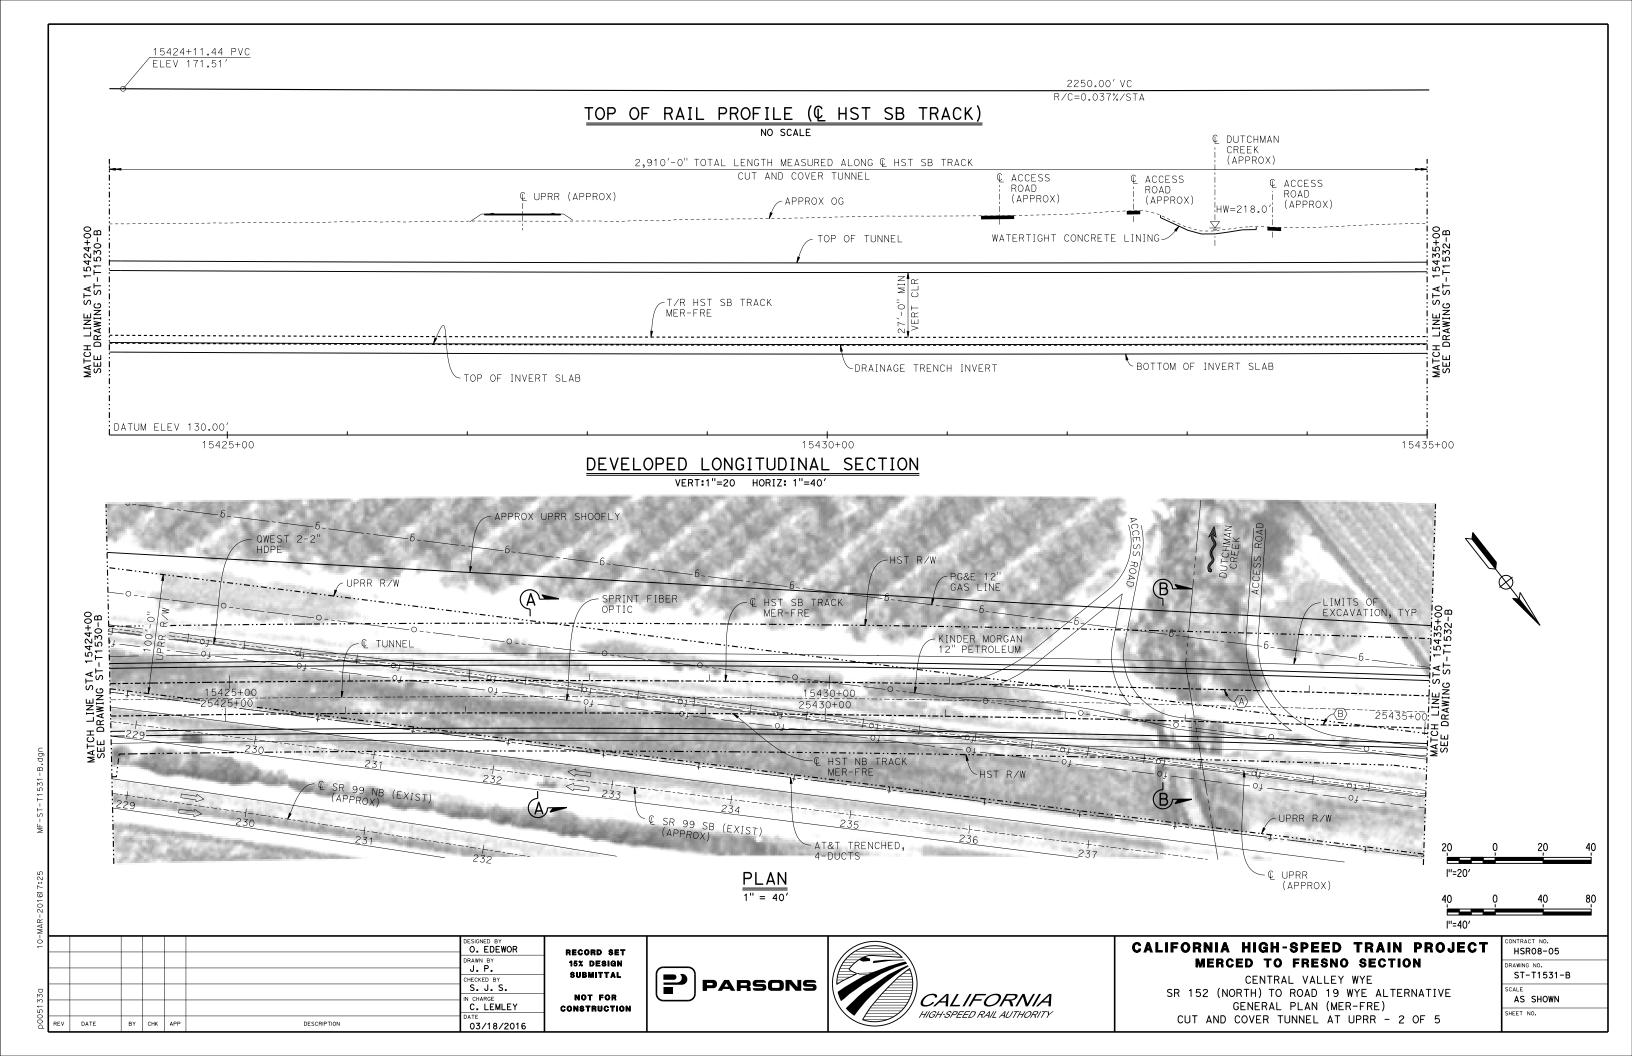

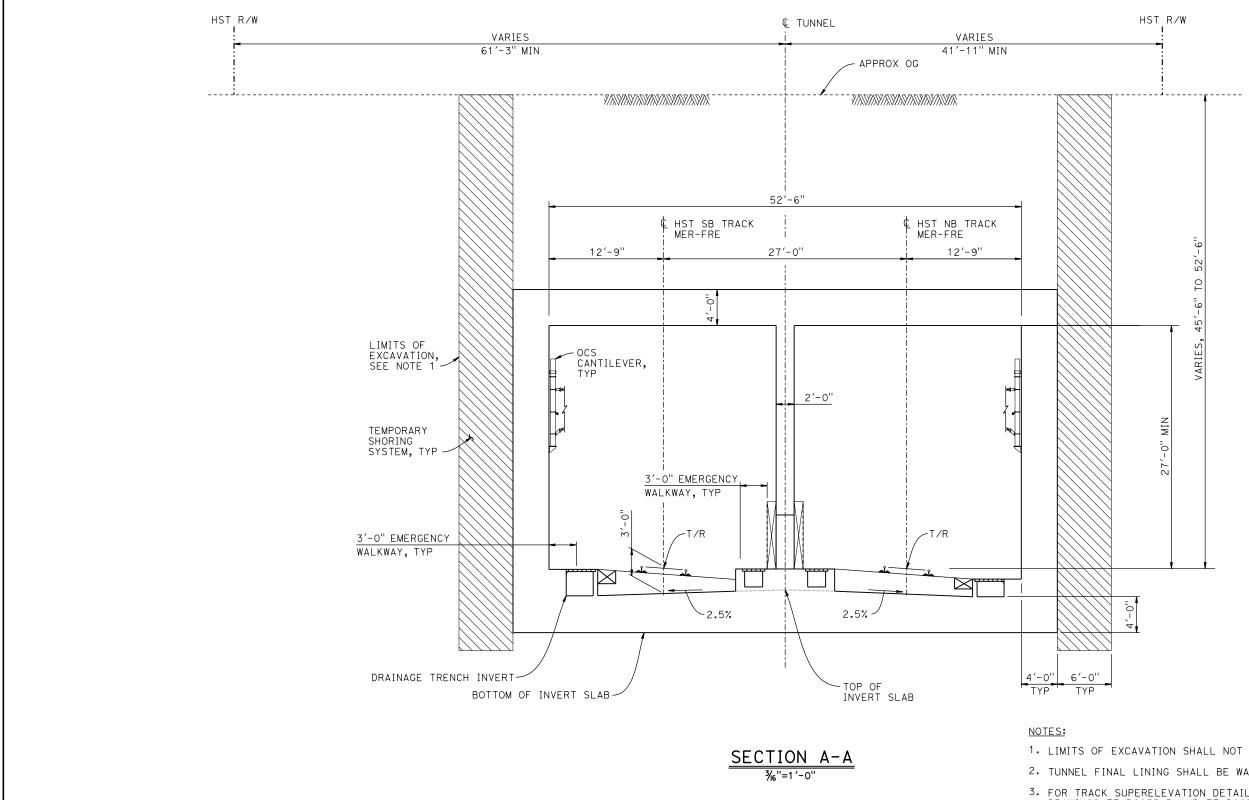

- 1. LIMITS OF EXCAVATION SHALL NOT EXTEND BEYOND HST R/W.
- 2. TUNNEL FINAL LINING SHALL BE WATERTIGHT FOR PERMANENT CASE.
- 3. FOR TRACK SUPERELEVATION DETAILS, SEE ALIGNMENT AND TYPICAL SECTION PLANS; DRAWINGS TT-B0055-B AND TT-B0057-B.



DESIGNED BY
O. EDEWOR CHECKED BY IN CHARGE
C. LEMLEY BY CHK APP DESCRIPTION 02/13/2015

RECORD SET 15% DESIGN SUBMITTAL NOT FOR CONSTRUCTION






CALIFORNIA HIGH-SPEED TRAIN PROJECT MERCED TO FRESNO SECTION

CENTRAL VALLEY WYE SR 152 (NORTH) TO ROAD 19 WYE ALTERNATIVE TYPICAL SECTION (MER-FRE) CUT AND COVER TUNNEL AT UPRR - 4 OF 5

| CONTRACT NO. |
|--------------|
| HSR08-05 |
| DRAWING NO. |
| ST-T3530-B |
| SCALE |
| AS SHOWN |
| SHEET NO. |

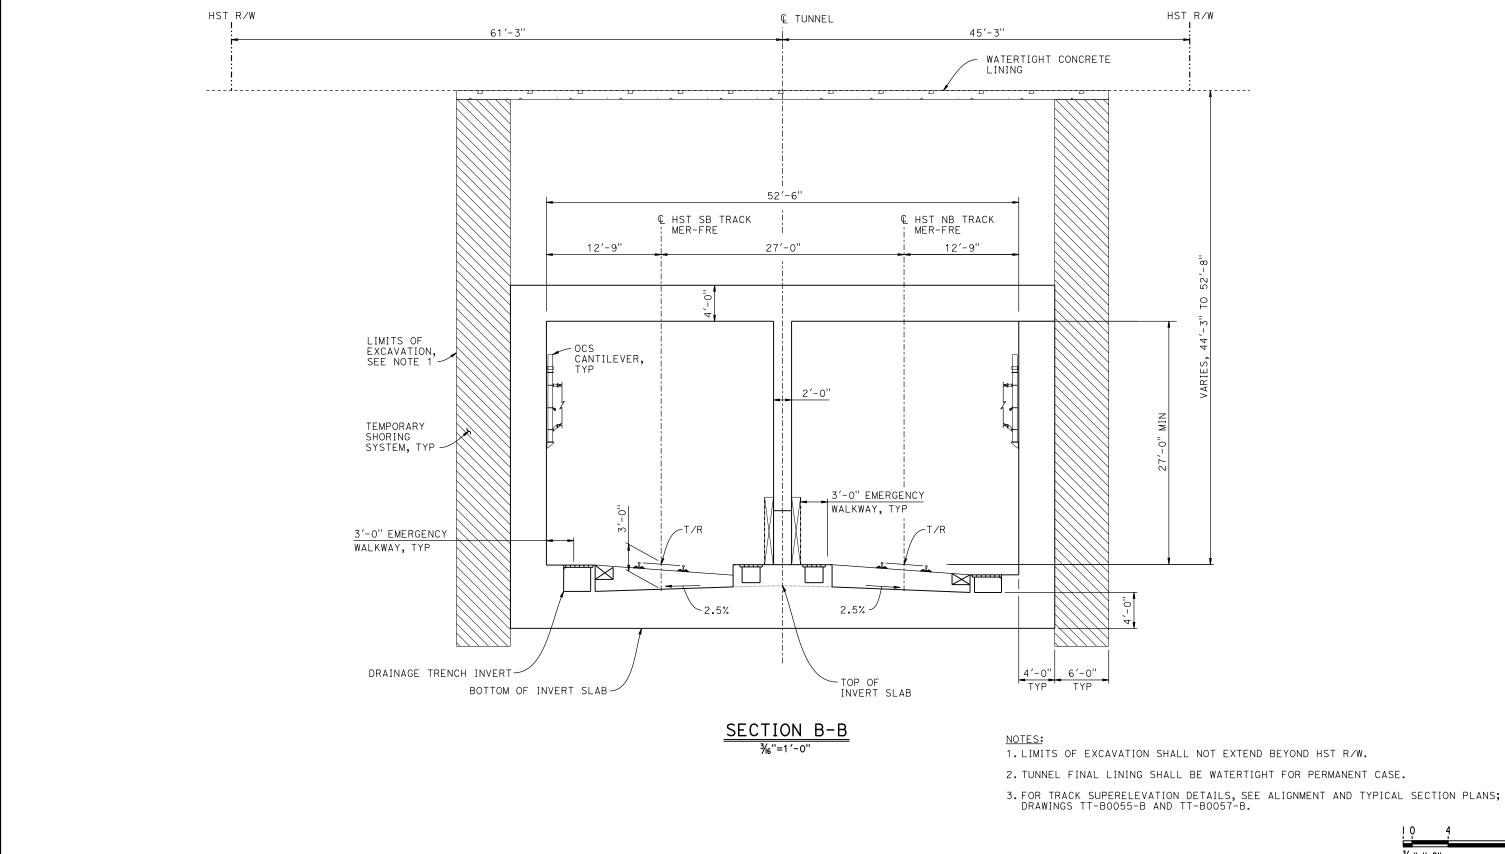

| ³/ ₁₆ ''=I'−0'' |
|----------------------------|
| |

10 4

DESIGNED BY
O. EDEWOR CHECKED BY IN CHARGE
C. LEMLEY BY CHK APP DESCRIPTION 02/13/2015

RECORD SET 15% DESIGN SUBMITTAL NOT FOR CONSTRUCTION







CALIFORNIA HIGH-SPEED TRAIN PROJECT MERCED TO FRESNO SECTION

CENTRAL VALLEY WYE SR 152 (NORTH) TO ROAD 19 WYE ALTERNATIVE TYPICAL SECTION (MER-FRE) CUT AND COVER TUNNEL AT UPRR - 5 OF 5

| CONTRACT NO. |
|--------------|
| HSR08-05 |
| DRAWING NO. |
| ST-T3531-B |
| SCALE |
| AS SHOWN |
| SHEET NO. |
| |

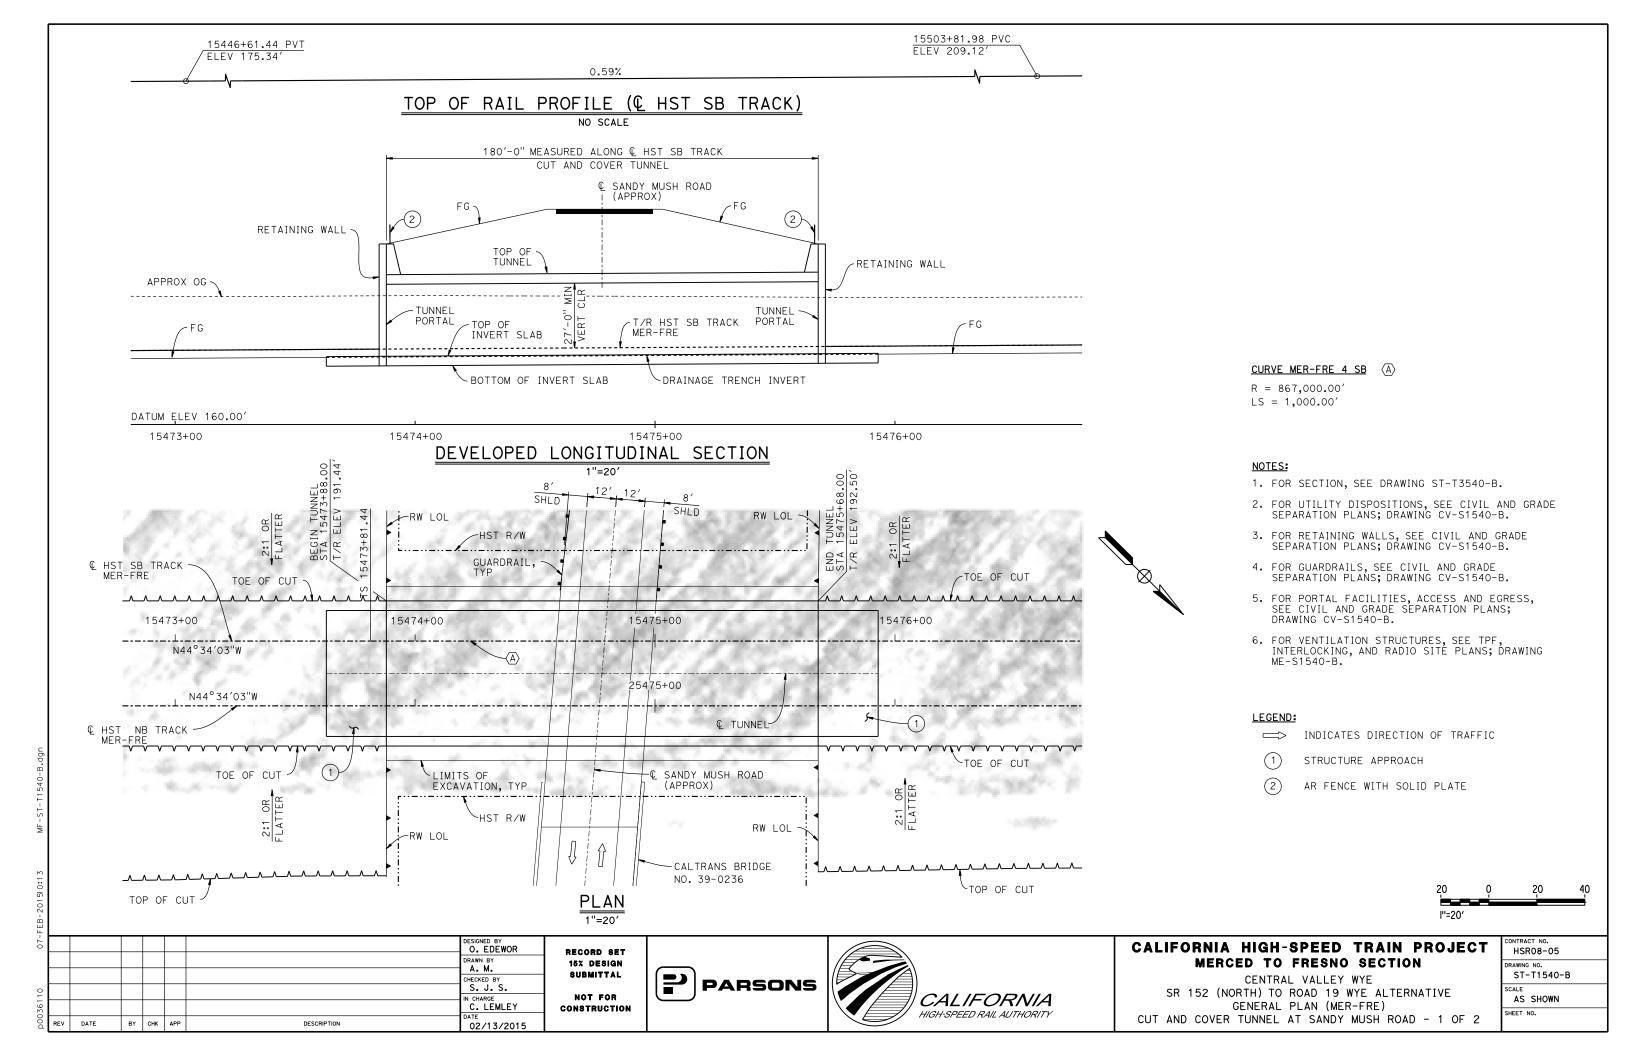


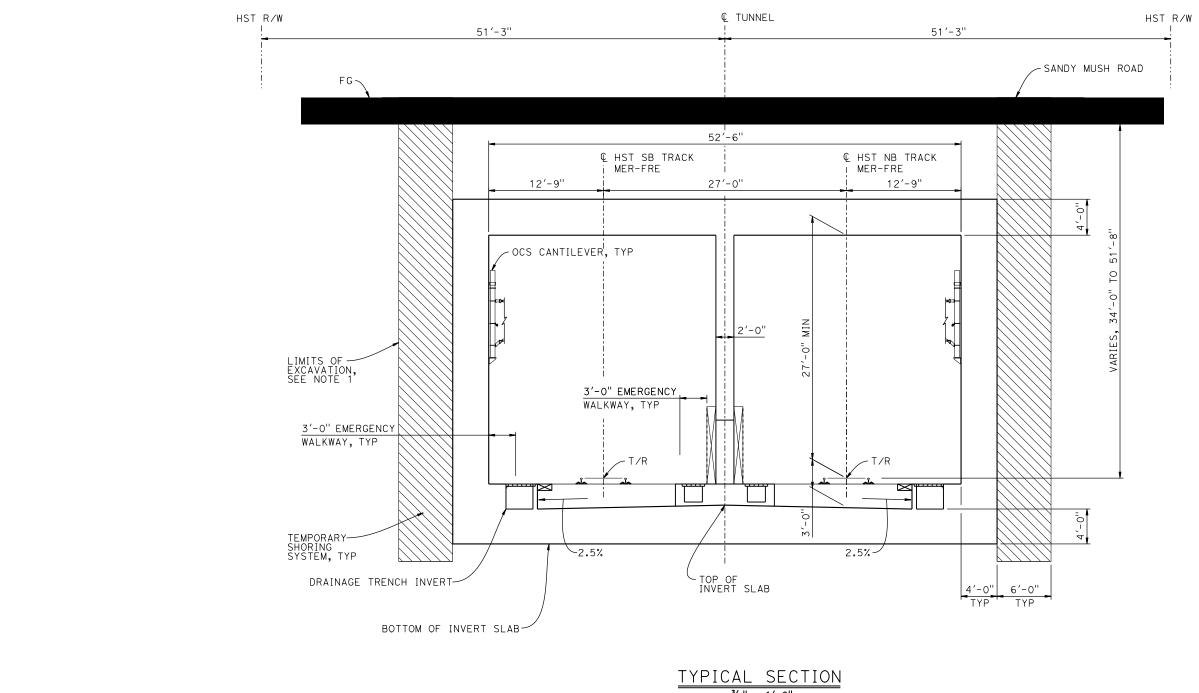

TYPICAL SECTION
3/6" = 1'-0"

NOTES:

- 1. LIMITS OF EXCAVATION SHALL NOT EXTEND BEYOND
- 2. TUNNEL FINAL LINING SHALL BE WATERTIGHT FOR PERMANENT CASE.

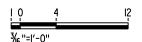

| ÷ | | | | | | | | |
|------|-----|------|----|-----|-----|-------------|-----------------------|----|
| 5 | | | | | | | DESIGNED BY O. EDEWOR | R |
| | | | | | | | DRAWN BY | 1 |
| | | | | | | | CHECKED BY | • |
| 0 | | | | | | | S. J. S. IN CHARGE | |
| 0.36 | | | | | | | C. LEMLEY | co |
| ă | REV | DATE | BY | СНК | APP | DESCRIPTION | 02/13/2015 | |

RECORD SET 15% DESIGN SUBMITTAL NOT FOR CONSTRUCTION






CALIFORNIA HIGH-SPEED TRAIN PROJECT MERCED TO FRESNO SECTION


CENTRAL VALLEY WYE SR 152 (NORTH) TO ROAD 19 WYE ALTERNATIVE TYPICAL SECTION (MER-FRE) CUT AND COVER TUNNEL AT SANDY MUSH ROAD - 2 OF 2

| CONTRACT NO. |
|--------------|
| HSR08-05 |
| DRAWING NO. |
| ST-T3540-B |
| SCALE |
| AS SHOWN |
| SHEET NO. |
| |

TOP OF RAIL PROFILE (HST NB TRACK SJD-MER)

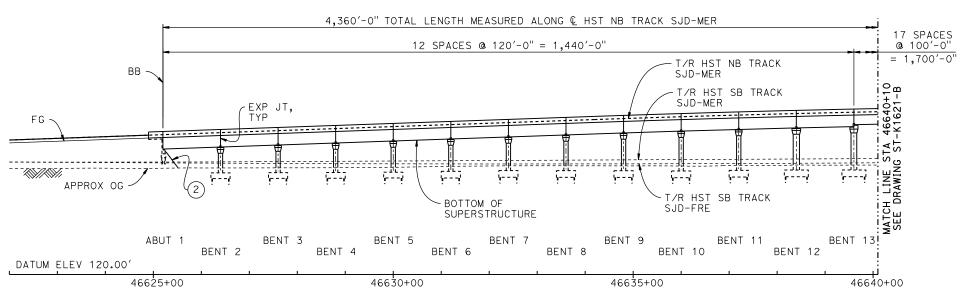

DEVELOPED ELEVATION VERT: 1" = 50' HORIZ: 1" = 100'

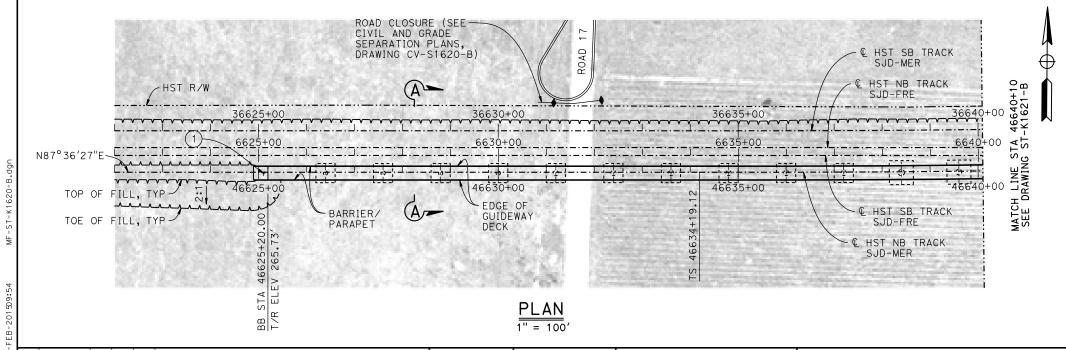

RECORD SET

15% DESIGN SUBMITTAL

NOT FOR

02/13/2015

LEGEND:

- INDICATES POINT OF MINIMUM VERTICAL CLEARANCE
- INDICATES DIRECTION OF TRAFFIC
- STRUCTURE APPROACH
- SLOPE PAVING (1/2H:1V)

TEMPORARY TRAFFIC OPENINGS


VEHICULAR TRAFFIC 1. _ TRAFFIC WILL BE DETOURED AWAY FROM THE SITE. 2. X TRAFFIC WILL PASS UNDER THE STRUCTURE ON: FALSEWORK ST OR ROAD NAME OPENING REQD AND LOCATION (HORIZ X VERT 32'X16.5' 2-WAY ROAD $17\frac{1}{2}$ 3. _ TEMP TRAFFIC LANE REDUCTION FOR FTG EXC.

NOTES:

- 1. 16" Ø PIPE PILES ASSUMED FOR ABUTMENT AND BENT FOUNDATIONS, UNLESS OTHERWISE NOTED. PILE LENGTHS
- 2. FOR SECTIONS AND BENT COLUMN SCHEDULE, SEE DRAWINGS ST-K3620-B AND ST-K3621-B.
- 3. ANY EXISTING DIRT ROAD THAT CONFLICTS WITH NEW CONSTRUCTION SHALL BE REALIGNED.
- FOR UTILITY DISPOSITIONS, SEE CIVIL AND GRADE SEPARATION PLANS; DRAWINGS CV-S1610-B AND CV-S1620-B.
- 5. FOR ROAD 17 $^1\!\!/_2$ UNDERPASS (HST SB) GENERAL PLAN AND TYPICAL SECTION, SEE DRAWING ST-K1625-B.
- 6. FOR ROAD 17 $^{1}\!\!/_{2}$ UNDERPASS GENERAL PLAN AND TYPICAL SECTION, SEE DRAWING ST-K1240-B.

CURVE SJD-MER 1 NB (A)

R = 10,386.50'LS = 1,200.00'

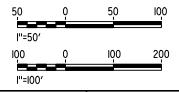

DESIGNED BY DRAWN BY
W. JOHNSEN O. EDEWOR N CHARGE C. LEMLEY CONSTRUCTION

DESCRIPTION

DATE

BY CHK APP

PARSONS




CALIFORNIA HIGH-SPEED TRAIN PROJECT MERCED TO FRESNO SECTION

CENTRAL VALLEY WYE SR 152 (NORTH) TO ROAD 19 WYE ALTERNATIVE GENERAL PLAN (SJD-MER) AERIAL #4 - NORTHBOUND OVER HST MAINLINE - 1 OF 5

HSR08-05 ST-K1620-B AS SHOWN SHEET NO.

TOP OF RAIL PROFILE (& HST NB TRACK SJD-MER)

NO SCALE

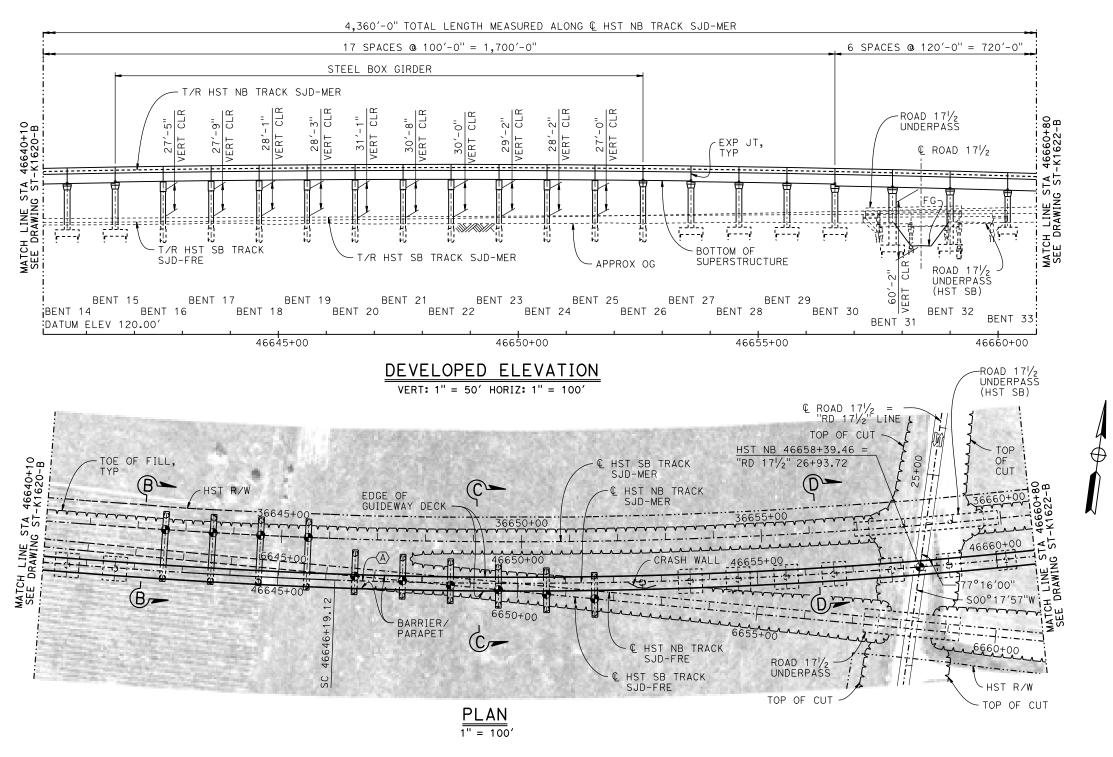

| 50 | Q | 50 | 100 |
|----------|---|-----|-----|
| l''=50′ | | | |
| 100 | Q | ΙŌΟ | 200 |
| l''=l00' | | | |

| Ĭ | | | | | | | | |
|-----|-----|------|----|-----|-----|-------------|------------------------|--------------|
| 5 | | | | | | | DESIGNED BY | RECORD SET |
| | · | | | | | | DRAWN BY W. JOHNSEN | 15% DESIGN |
| | | | | | | | CHECKED BY | SUBMITTAL |
| 2 | | | | | | | O. EDEWOR IN CHARGE | NOT FOR |
| 926 | | | | | | | C. LEMLEY | CONSTRUCTION |
| ă | REV | DATE | BY | СНК | APP | DESCRIPTION | 02/13/2015 | |

PARSONS



CALIFORNIA HIGH-SPEED TRAIN PROJECT MERCED TO FRESNO SECTION

CENTRAL VALLEY WYE
SR 152 (NORTH) TO ROAD 19 WYE ALTERNATIVE
GENERAL PLAN (SJD-MER)
AERIAL #4 - NORTHBOUND OVER HST MAINLINE - 2 OF 5

| CONTRACT NO. |
|--------------|
| HSR08-05 |
| DRAWING NO. |
| ST-K1621-B |
| SCALE |
| AS SHOWN |
| SHEET NO. |
| |

02/13/2015

DATE

BY CHK APP


DESCRIPTION


50 0 50 100 I"=50' 100 0 100 200 I"=100'


CALIFORNIA HIGH-SPEED TRAIN PROJECT MERCED TO FRESNO SECTION

CENTRAL VALLEY WYE
SR 152 (NORTH) TO ROAD 19 WYE ALTERNATIVE
GENERAL PLAN (SJD-MER)
AERIAL #4 - NORTHBOUND OVER HST MAINLINE - 3 OF 5

| CONTRACT NO. |
|--------------|
| HSR08-05 |
| DRAWING NO. |
| ST-K1622-B |
| SCALE |
| AS SHOWN |
| SHEET NO. |
| |
| |

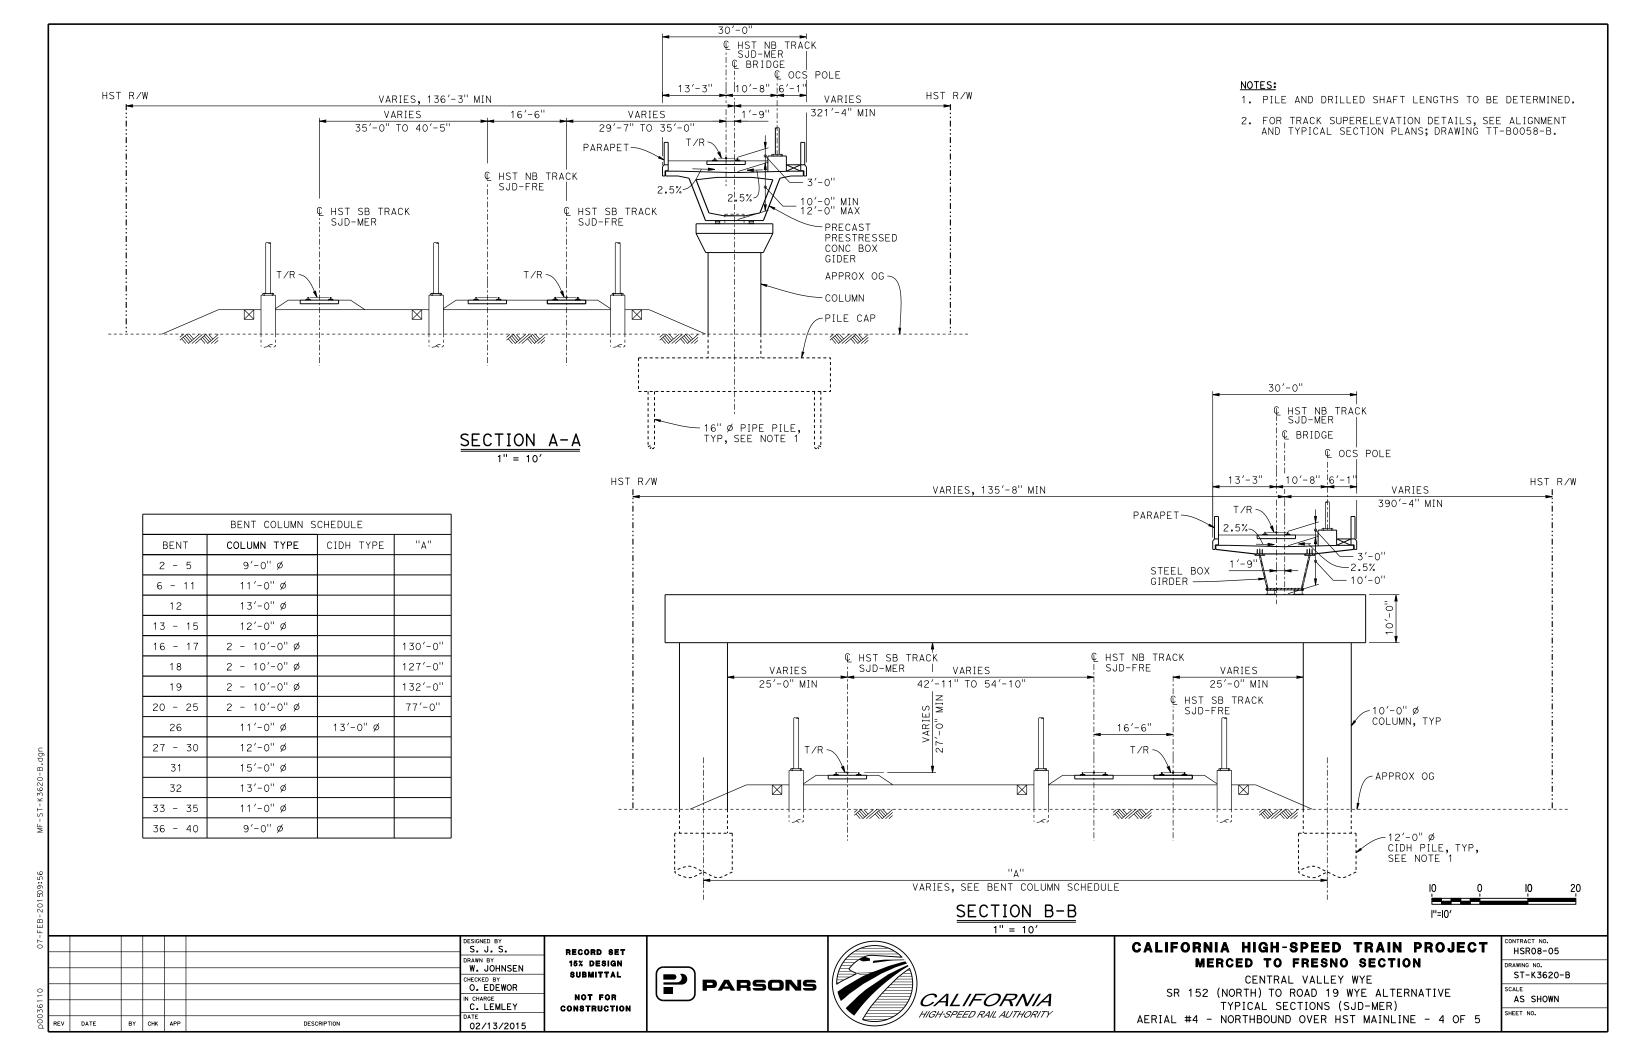

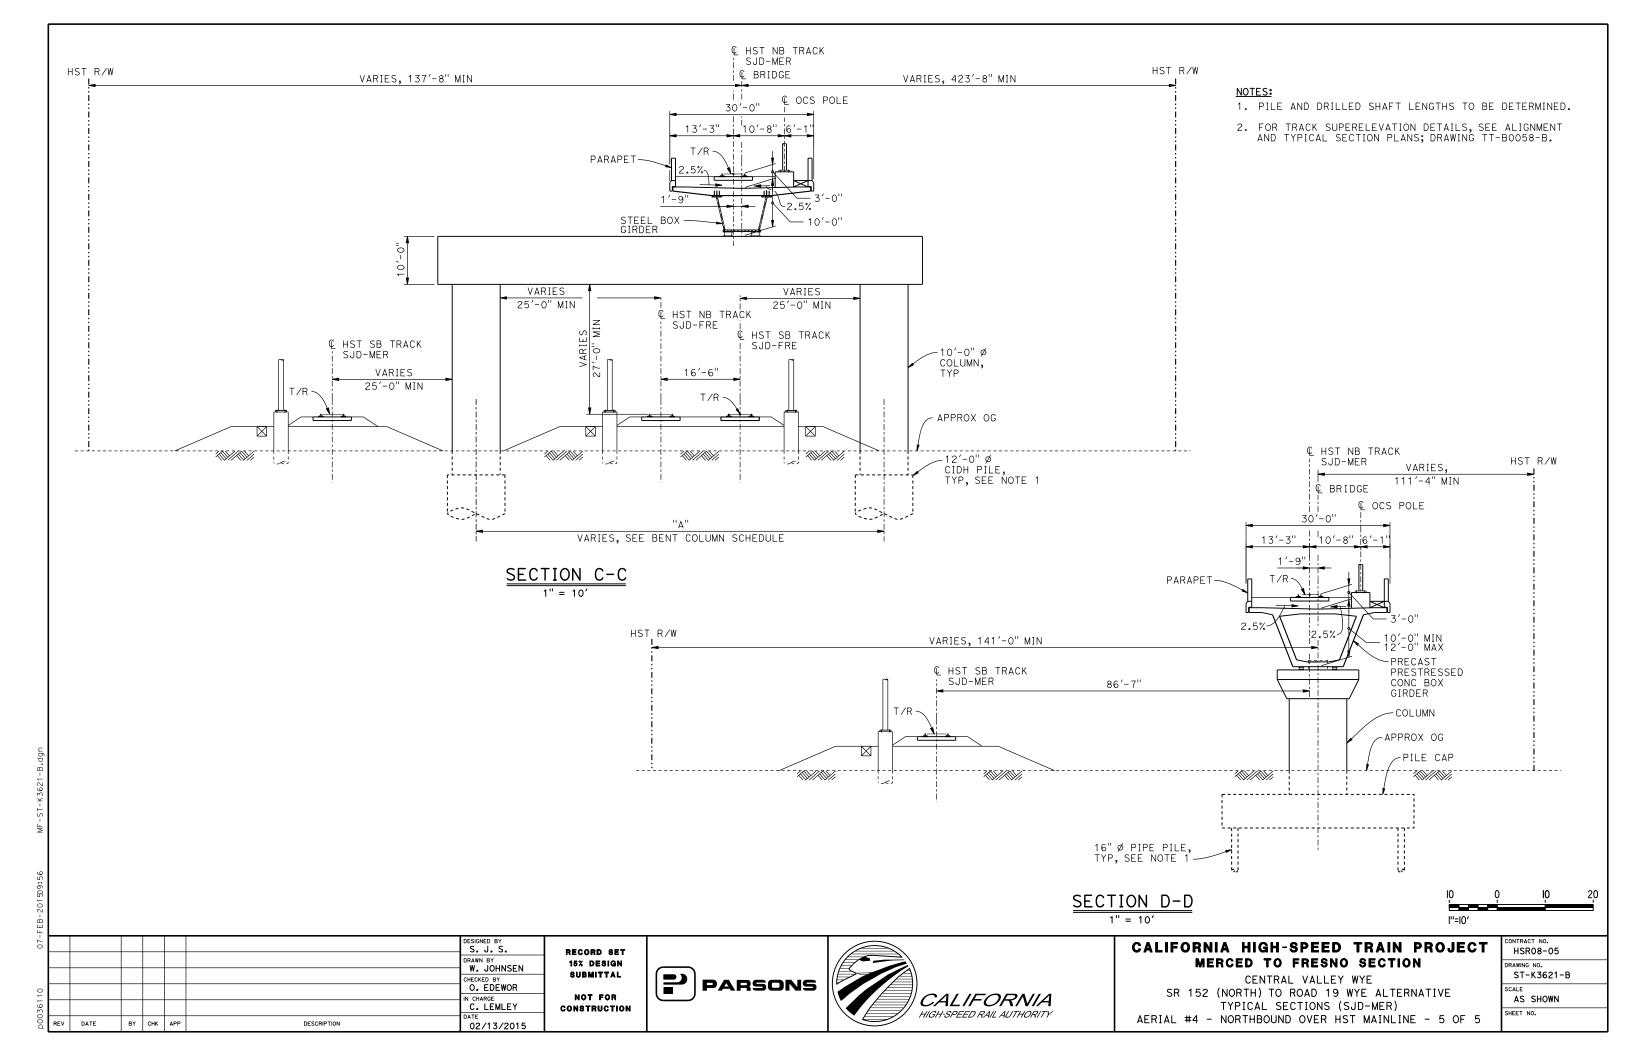

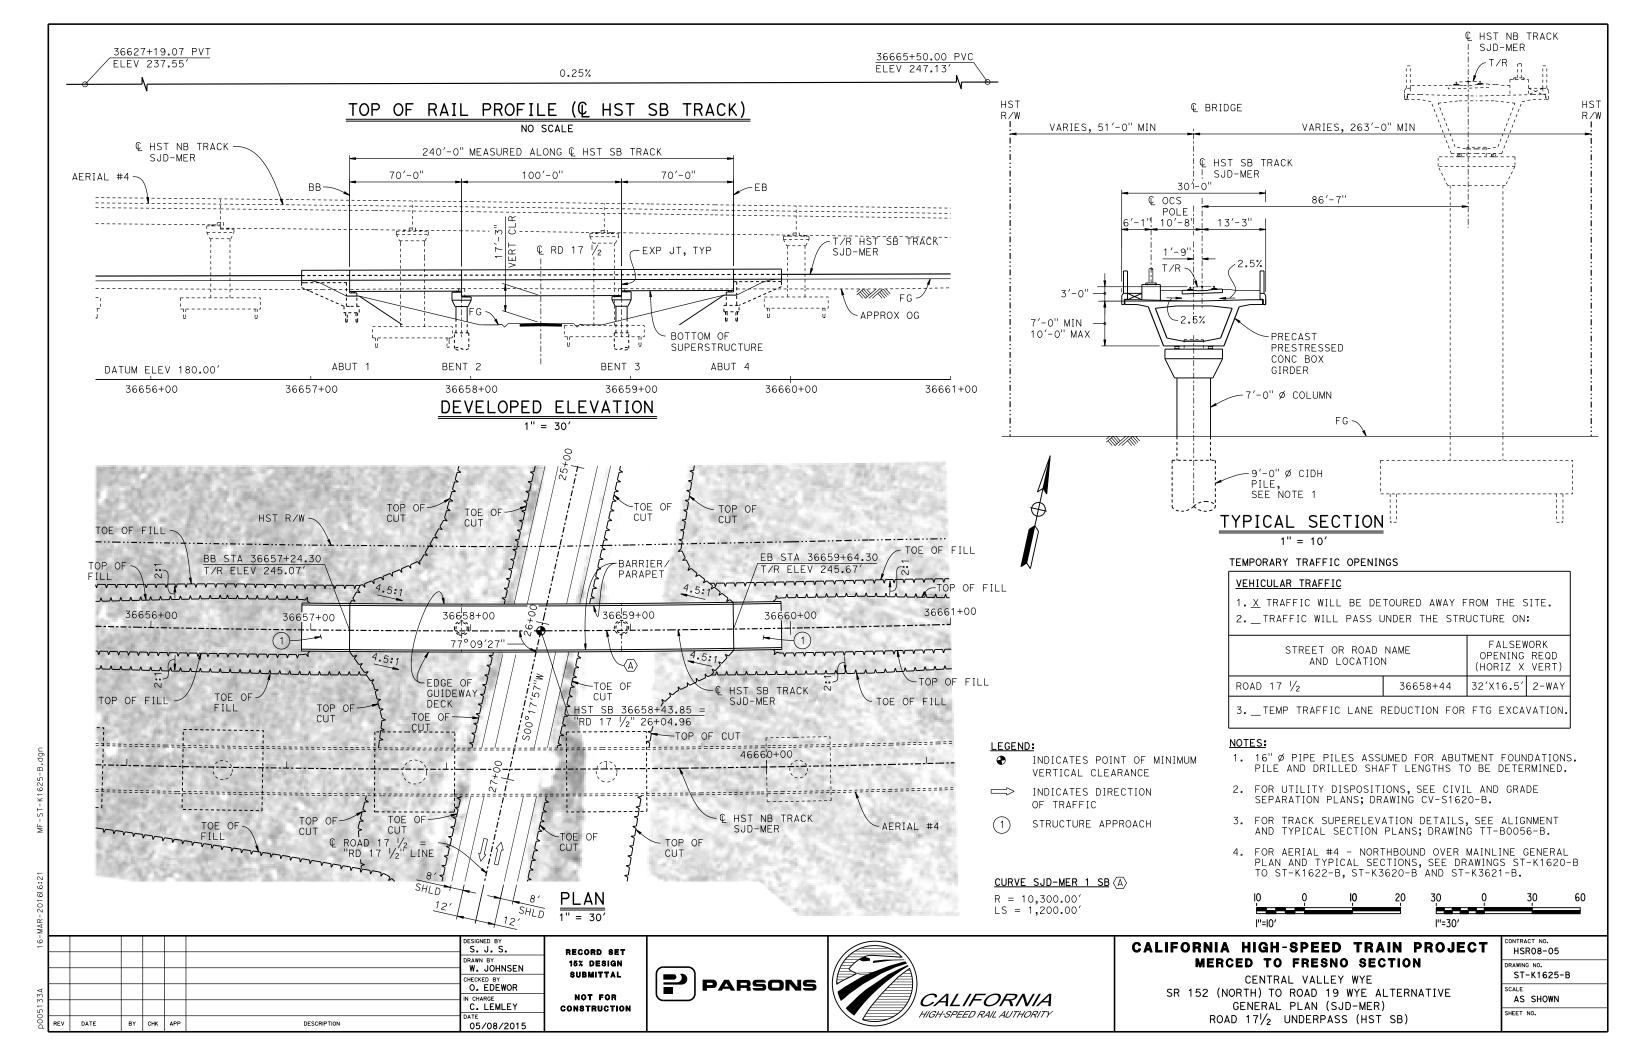

LEGEND: INDICATES POINT OF MINIMUM VERTICAL CLEARANCE 36698+25.00 PVC 36762+44.89 PVC 36709+75.00 PVT ELEV 285.25' ELEV 288.88' ELEV 292.40' INDICATES DIRECTION OF TRAFFIC -0.07% 1150.00' VC 1.31% STRUCTURE APPROACH R/C=-0.120%/STA (2) SLOPE PAVING (1/2H:1V) TOP OF RAIL PROFILE (& HST SB TRACK) NOTES: 1. 16" Ø PIPE PILES ASSUMED FOR ABUTMENT AND BENT NO SCALE FOUNDATIONS, UNLESS OTHERWISE NOTED. PILE LENGTHS TO BE DETERMINED. 1,330'-0" TOTAL LENGTH MEASURED ALONG € HST SB TRACK 2. FOR SECTIONS AND BENT COLUMN SCHEDULE, SEE BALANCED CANTILEVER DRAWING ST-K3630-B. CONSTRUCTION 3. ANY EXISTING DIRT ROAD THAT CONFLICTS WITH NEW 125'-0" 150'-0" 145'-0" 185'-0" 125'-0" 2 SPACES @ 140'-0" 120'-0" ,100'-0" CONSTRUCTION SHALL BE REALIGNED. BB 120'-0"=240'-0" 4. FOR UTILITY DISPOSITIONS, SEE CIVIL AND GRADE SEPARATION PLANS; DRAWING CV-S1630-B. **Q** SR 99 NB (APPROX) € AVE 231/2/MADISON RD 5. FOR GUARDRAILS, SEE CIVIL AND GRADE SEPARATION PLANS; (APPROX) DRAWING CV-S1630-B. T'R HST NB TRACK_EXP JT, TYP SR 99 SB HST SB TRACK, € FAIRMEAD BLVD (APPROX) (APPROX) 6. FOR RETAINING WALL, SEE CIVIL AND GRADE SEPARATION PLANS; DRAWING CV-\$1630-B. 7. FOR AERIAL #6 - NORTHBOUND OVER UPRR / SR 99 GENERAL PLAN AND TYPICAL SECTION, SEE DRAWINGS ST-K1635-B AND ST-K3635-B. - APPROX OG BOTTOM OF SUPERSTRUCTURE TEMPORARY TRAFFIC OPENINGS AERIAL #6 VEHICULAR TRAFFIC BENT 2 BENT 3 BENT 4 BENT 5 BENT 6 BENT 8 ABUT 1 ABUT 11 BENT 7 BENT 9 BENT 10 1. _ TRAFFIC WILL BE DETOURED AWAY FROM THE SITE. DATUM ELEV 150.00' 36715+00 36700+00 36705+00 36710+00 2. X TRAFFIC WILL PASS UNDER THE STRUCTURE ON: DEVELOPED ELEVATION FALSEWORK ST OR ROAD NAME OPENING REQD VERT: 1" = 50' HORIZ: 1" = 100' AND LOCATION (HORIZ X VERT) CURVE SJD-MER 1 SB (A) 100'-0" AVE 231/2/MADISON RD 36702+30 32'X16.5' 2-WAY R = 10,300.00'UPRR R/W LS = 1,200.00SR 99 37'X16.5' S BND 36708+82 ROAD CLOSURE (APPROX) (SEE CIVIL AND GRADE SR 99 36710+88 37'X16.5' N BND SEPARATION PLANS; DRAWING CV-S1630-B FAIRMEAD BLVD 36711+76 | 32'X16.5' | 2-WAY FDGF OF © HST SB TRACK SJD-MER GUIDEWAY 3. _ TEMP TRAFFIC LANE REDUCTION FOR FTG EXC. LATERAL A TOF OF FILL BARRIER. FILL TOP OF FILL, TYP TEMPORARY TRAFFIC OPENINGS RAILROAD TRAFFIC FALSEWORK OPENING REQUIRED ON: FALSEWORK NAME OF RR AND LOCATION OPENING REQD FILL (HORIZ X VERT) AERIAL #6 -TOE OF GUARDRAIL KINDER MORGAN 12" PETROLEUM UPRR 36702+17 24'X21 FILL -PG&E 8" GAS PG&E SPRINT FIBER 100 200 AT&T TRENCHED, 4 DUCTS 1" = 100' 1"=50' DESIGNED BY CALIFORNIA HIGH-SPEED TRAIN PROJECT HSR08-05 RECORD SET J. KIDWELL MERCED TO FRESNO SECTION 15% DESIGN SUBMITTAL ST-K1630-B CENTRAL VALLEY WYE O. EDEWOR **PARSONS**

CALIFORNIA

HIGH-SPEED RAIL AUTHORITY

NOT FOR

CONSTRUCTION

N CHARGE C. LEMLEY

03/18/2016


DATE

BY CHK APP

DESCRIPTION

SR 152 (NORTH) TO ROAD 19 WYE ALTERNATIVE AS SHOWN HEET NO. AERIAL #5 - SOUTHBOUND OVER UPRR / SR 99 - 1 OF 2

GENERAL PLAN (SJD-MER)

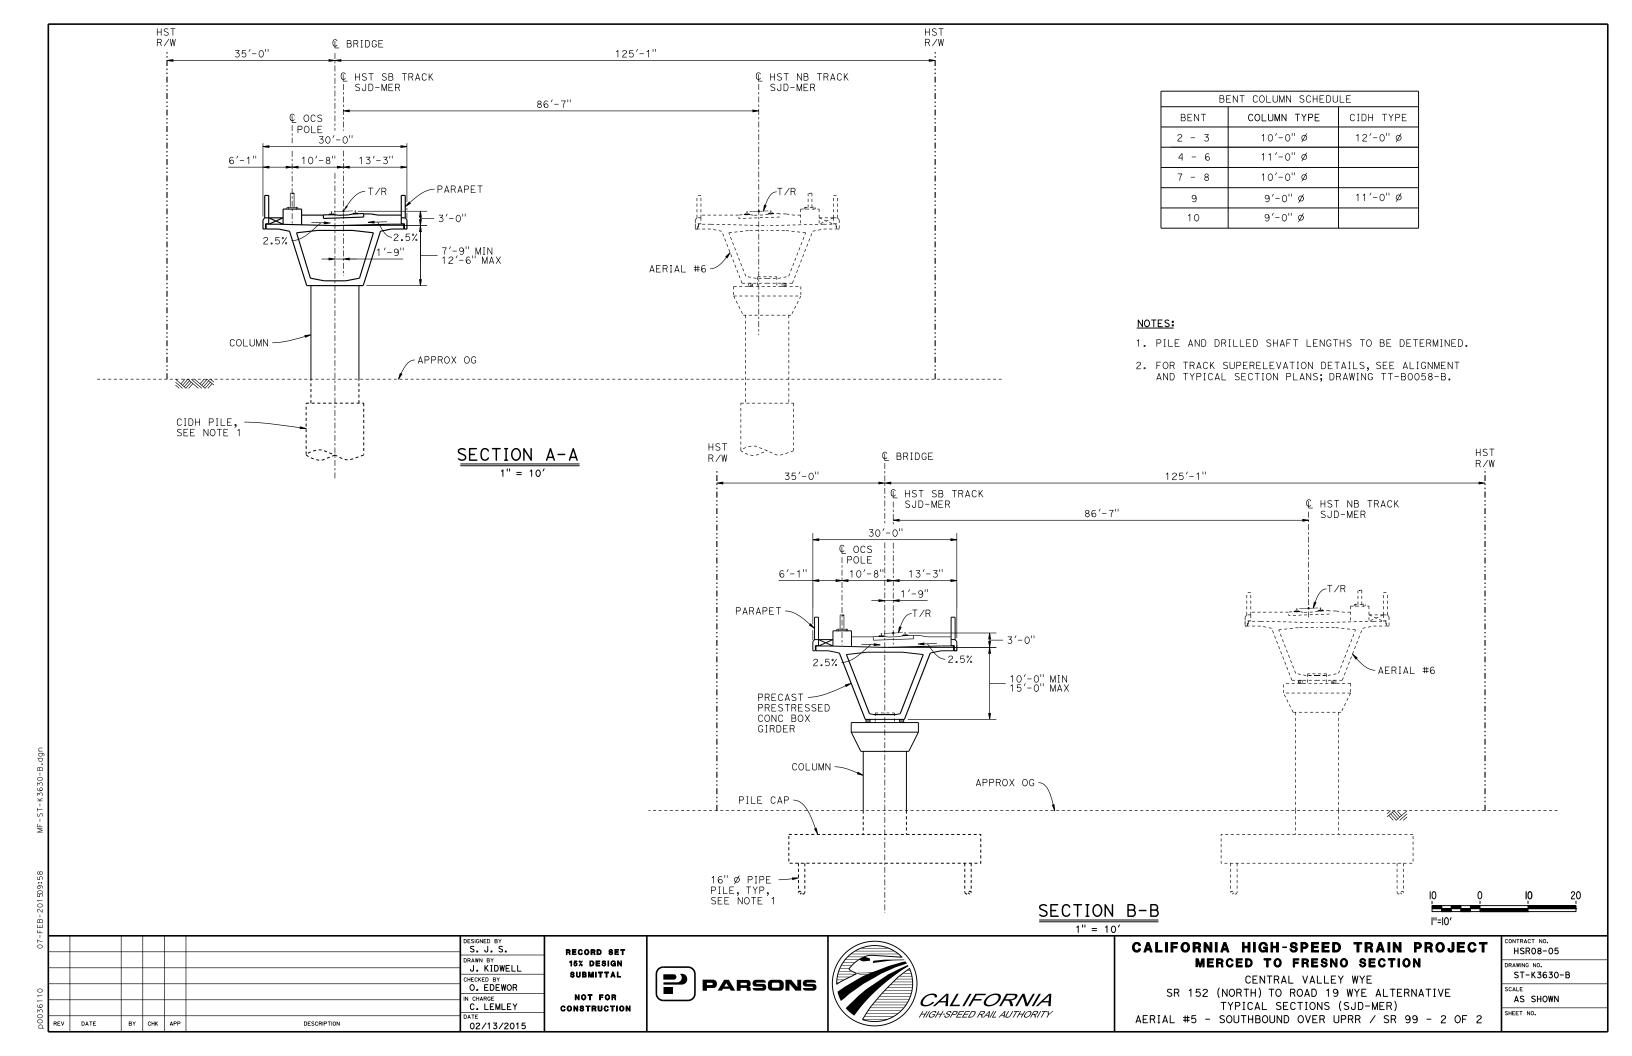

46700+03.76 PVC ELEV 285.24'

1150.00' VC

R/C=-0.119%/STA


46711+53.76 PVT
ELEV 292.34'

1150.00' VC

-0.07%


TOP OF RAIL PROFILE (& HST NB TRACK)

NO SCALE

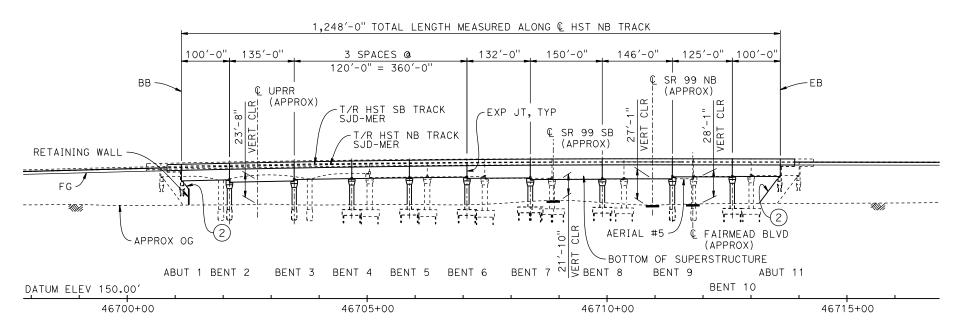

DEVELOPED ELEVATION

VERT: 1" = 50' HORIZ: 1" = 100'

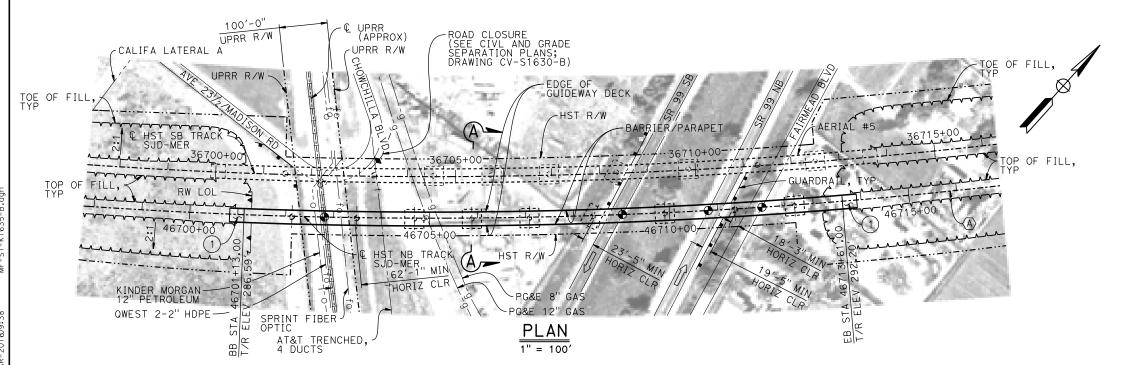

LEGEND:

- INDICATES POINT OF MINIMUM VERTICAL CLEARANCE
- 1) STRUCTURE APPROACH
- 2 SLOPE PAVING $(1\frac{1}{2}H:1V)$

NOTES:

- 1. 16" Ø PIPE PILES ASSUMED FOR ABUTMENT AND BENT FOUNDATIONS, UNLESS OTHERWISE NOTED. PILE LENGTHS TO BE DETERMINED.
- 2. FOR SECTION AND BENT COLUMN SCHEDULE, SEE DRAWING ST-K3635-B.
- 3. ANY EXISTING DIRT ROAD THAT CONFLICTS WITH NEW CONSTRUCTION SHALL BE REALIGNED.
- 4. FOR UTILITY DISPOSITIONS, SEE CIVIL AND GRADE SEPARATION PLANS; DRAWING CV-S1630-B.
- 5. FOR GUARDRAILS, SEE CIVIL AND GRADE SEPARATION PLANS; DRAWING CV-S1630-B.
- 6. FOR RETAINING WALL, SEE CIVIL AND GRADE SEPARATION PLANS; DRAWING CV-S1630-B.
- 7. FOR AERIAL #5 SOUTHBOUND OVER UPRR / SR 99 GENERAL PLAN AND TYPICAL SECTIONS, SEE DRAWINGS ST-K1630-B AND ST-K3630-B.

TEMPORARY TRAFFIC OPENINGS

| VEHICULAR TRA | <u>AFFIC</u> | | | | | | |
|---------------|--------------|-------|--------|------|--------|-----|------|
| 1 TRAFFIC | WILL | BE DE | TOURED | AWAY | / FROM | THE | SITE |
| 2. X TRAFFIC | WILL | PASS | UNDER | THE | STRUCT | URE | ON: |

| ST OR ROAD NAME AND LOCATION | | | | | | |
|---------------------------------|----------------------|-------|--|--|--|--|
| 46708+88 | 37′X16.5′ | S BND | | | | |
| 46710+94 | 37′X16.5′ | N BND | | | | |
| 46711+81 | 32′X16.5′ | 2-WAY | | | | |
| | 46708+88 46710+94 | | | | | |

^{3.} _ TEMP TRAFFIC LANE REDUCTION FOR FTG EXC.

TEMPORARY TRAFFIC OPENINGS

| RAILROAD TRAFFIC FALSEWORK OPENING REQUIRED ON: | | | | | | | |
|---|----------|---|--|--|--|--|--|
| NAME OF RR AND | | FALSEWORK OPENING REQD (HORIZ X VERT) | | | | | |
| UPRR | 46702+81 | 24′X21′ | | | | | |

CURVE SJD-MER 1 NB (A)

R = 10,386.50'LS = 1,200.00'





| | | | | | | DESIGNED BY S. J. S. | |
|-----|------|----|-----|-----|-------------|-------------------------|---|
| | | | | | | DRAWN BY J. KIDWELL | 1 |
| | | | | | | CHECKED BY | 1 |
| | | | | | _ | O. EDEWOR | ł |
| | | | | | | C. LEMLEY | |
| REV | DATE | BY | снк | APP | DESCRIPTION | DATE 03/18/2016 | |

RECORD SET
15% DESIGN
SUBMITTAL
NOT FOR
CONSTRUCTION






CALIFORNIA HIGH-SPEED TRAIN PROJECT MERCED TO FRESNO SECTION

CENTRAL VALLEY WYE
SR 152 (NORTH) TO ROAD 19 WYE ALTERNATIVE
GENERAL PLAN (SJD-MER)
AERIAL #6 - NORTHBOUND OVER UPRR / SR 99 - 1 OF 2

| CONTRACT NO. HSR08-05 |
|---------------------------|
| DRAWING NO. ST-K1635-B |
| AS SHOWN |
| SHEET NO. |

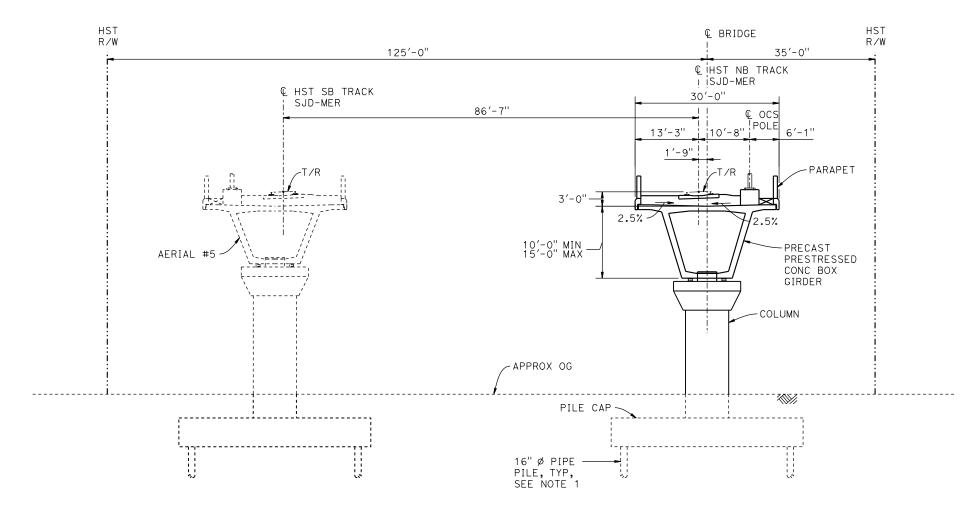

 $\frac{\text{SECTION} \quad A - A}{1" = 10'}$

| | BENT COLUMN SCH | EDULE |
|-------|-----------------|-----------|
| BENT | COLUMN TYPE | CIDH TYPE |
| 2 - 3 | 9'-0" ø | 11'-0" Ø |
| 4 - 6 | 9'-0" ø | |
| 7 - 8 | 10'-0" Ø | |
| 9 | 10'-0" ø | 12'-0" Ø |
| 10 | 9'-0" Ø | |

NOTES:

- 1. PILE AND DRILLED SHAFT LENGTHS TO BE DETERMINED.
- 2. FOR TRACK SUPERELEVATION DETAILS, SEE ALIGNMENT AND TYPICAL SECTION PLANS; DRAWING TT-B0058-B.

| IO | o O | ΙO | 20 |
|--------|--------|----|----|
| l"=l0′ | | | |

| Μ· | | | | | | | | |
|------|-----|------|----|-----|-----|-------------|----------------------|-----|
| 16- | | | | | | | DESIGNED BY S. J. S | RE |
| | | | | | | | DRAWN BY J. KIDWELL | 15 |
| ٨ | | | | | | | CHECKED BY O. EDEWOR | 81 |
| 5133 | | | | | | | IN CHARGE C. LEMLEY | CON |
| D00 | REV | DATE | BY | снк | APP | DESCRIPTION | 05/08/2015 | |

ECORD SET
15% DESIGN
SUBMITTAL
NOT FOR
INSTRUCTION





CALIFORNIA HIGH-SPEED TRAIN PROJECT MERCED TO FRESNO SECTION


CENTRAL VALLEY WYE


SR 152 (NORTH) TO ROAD 19 WYE ALTERNATIVE

TYPICAL SECTION (SJD-MER)


AERIAL #6 - NORTHBOUND OVER UPRR / SR 99 - 2 OF 2

| CONTRACT NO. |
|--------------|
| HSR08-05 |
| DRAWING NO. |
| ST-K3635-B |
| SCALE |
| AS SHOWN |
| SHEET NO. |
| |

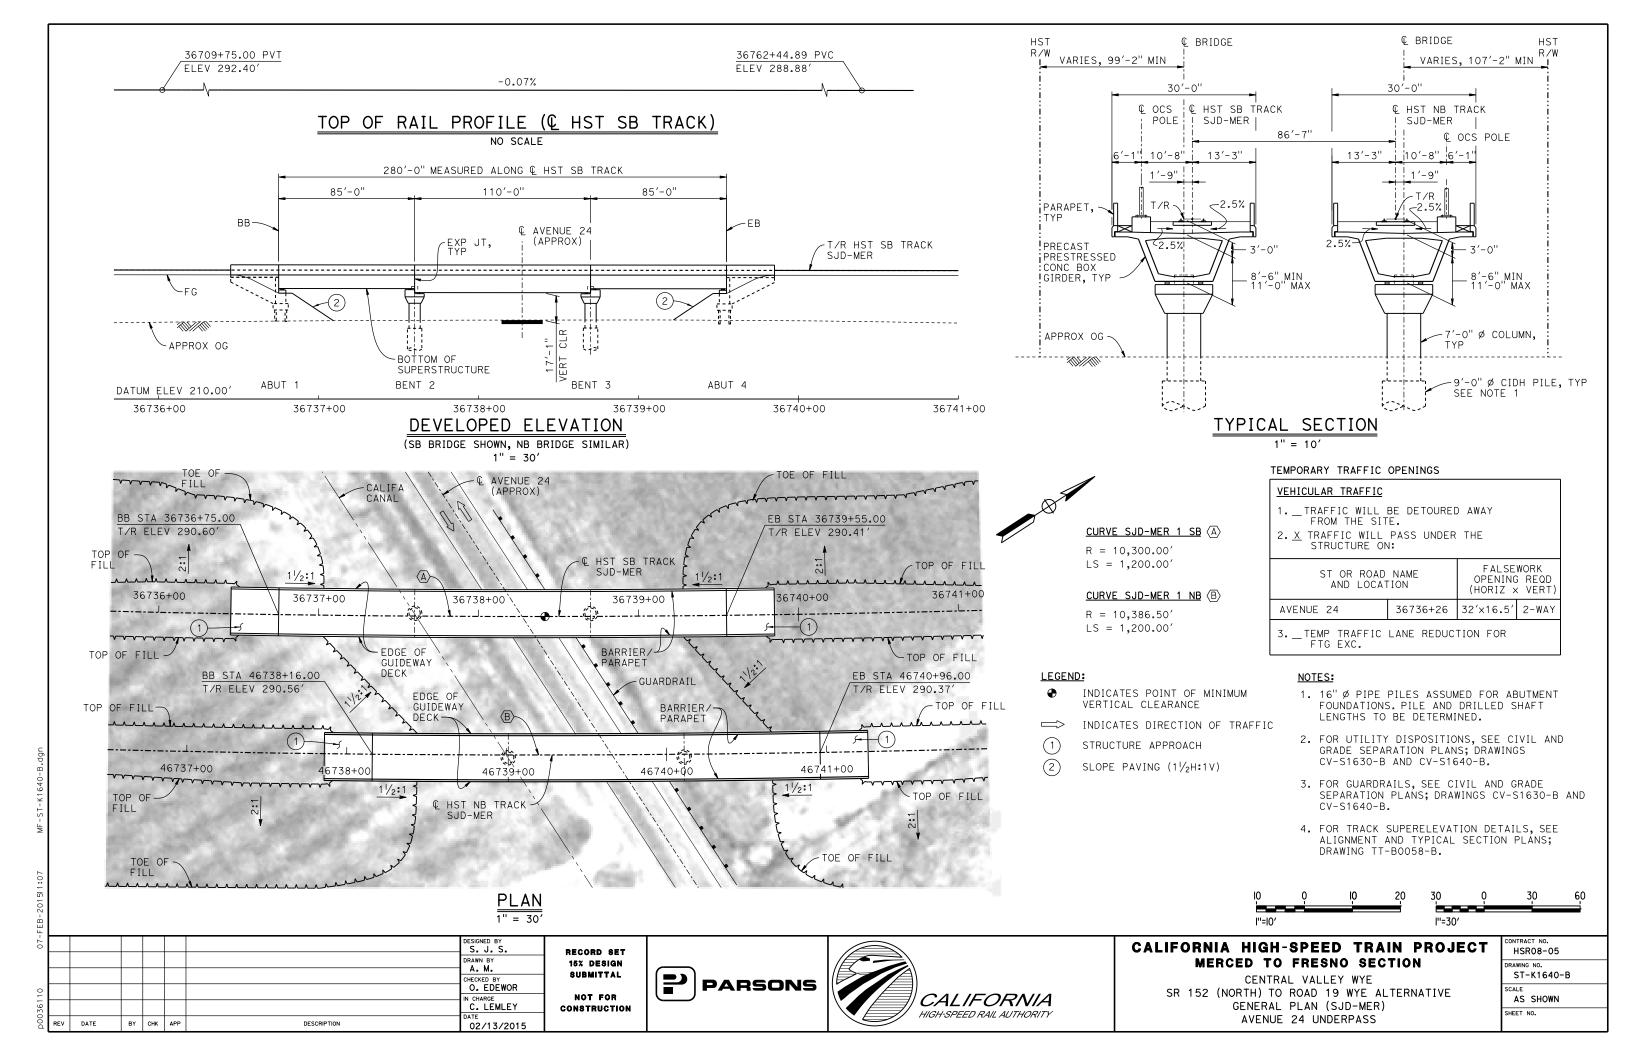

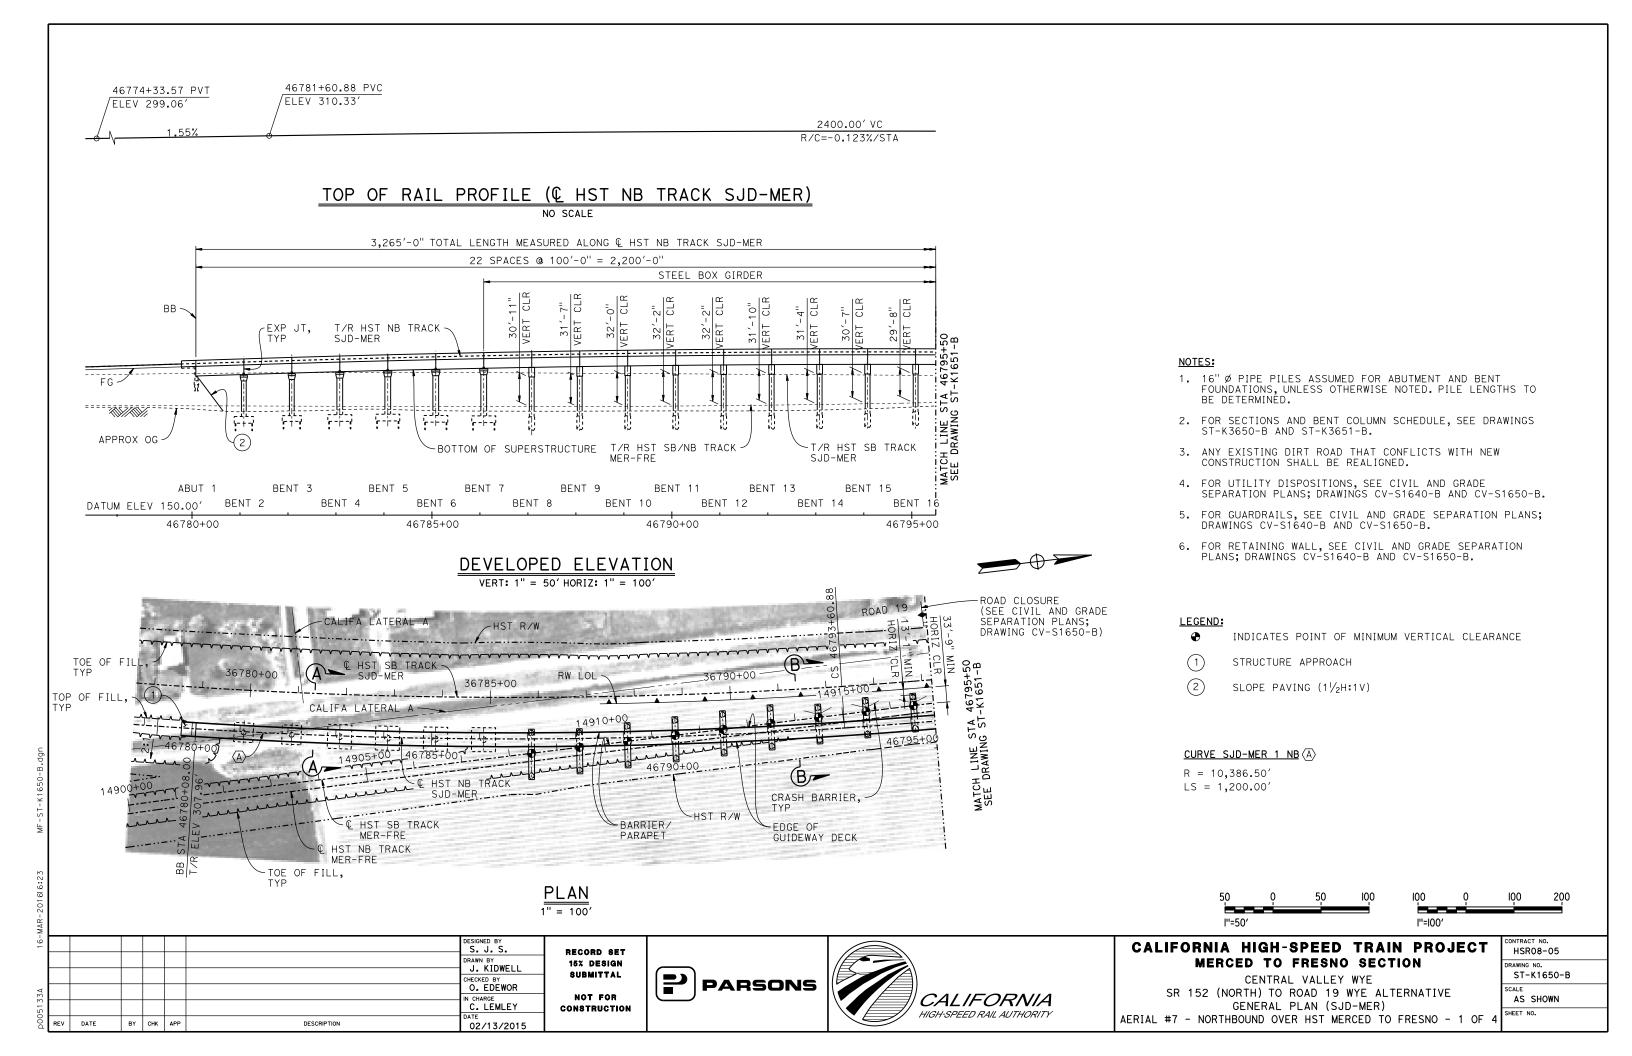


TOP OF RAIL PROFILE (HST NB TRACK SJD-MER)

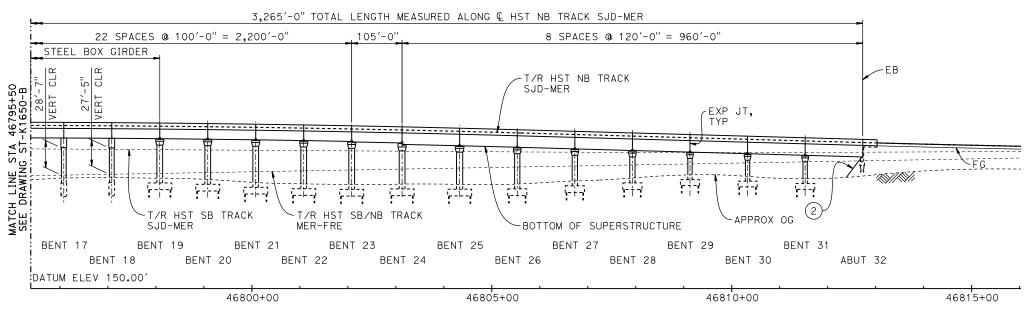

DEVELOPED ELEVATION

VERT: 1" = 50' HORIZ: 1" = 100'

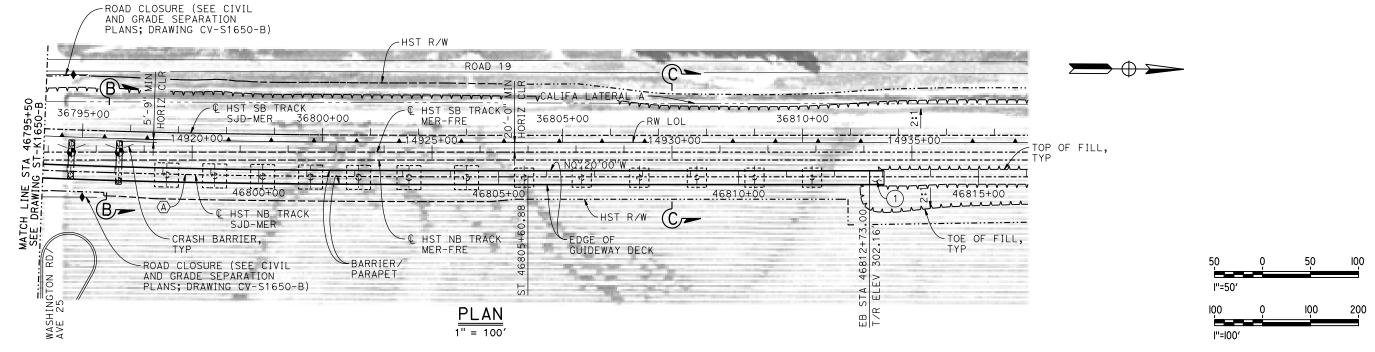

| Σ | | | | | | | | |
|-----|-----|------|----|-----|-----|-------------|---------------------|--------------|
| 16- | | | | | | | DESIGNED BY | RECORD SET |
| | | | | | | | DRAWN BY | 15% DESIGN |
| | | | | | | | CHECKED BY | SUBMITTAL |
| 33A | | | | | | | O. EDEWOR IN CHARGE | NOT FOR |
| 17 | | | | | | | C. LEMLEY | CONSTRUCTION |
| 00d | REV | DATE | BY | СНК | APP | DESCRIPTION | 02/13/2015 | |


PARSONS



CALIFORNIA HIGH-SPEED TRAIN PROJECT MERCED TO FRESNO SECTION


CENTRAL VALLEY WYE SR 152 (NORTH) TO ROAD 19 WYE ALTERNATIVE GENERAL PLAN (SJD-MER) AERIAL #7 - NORTHBOUND OVER HST MERCED TO FRESNO - 2 OF 4

| | CONTRACT NO. |
|---|--------------|
| | HSR08-05 |
| | DRAWING NO. |
| | ST-K1651-B |
| | SCALE |
| | AS SHOWN |
| 4 | SHEET NO. |
| _ | |

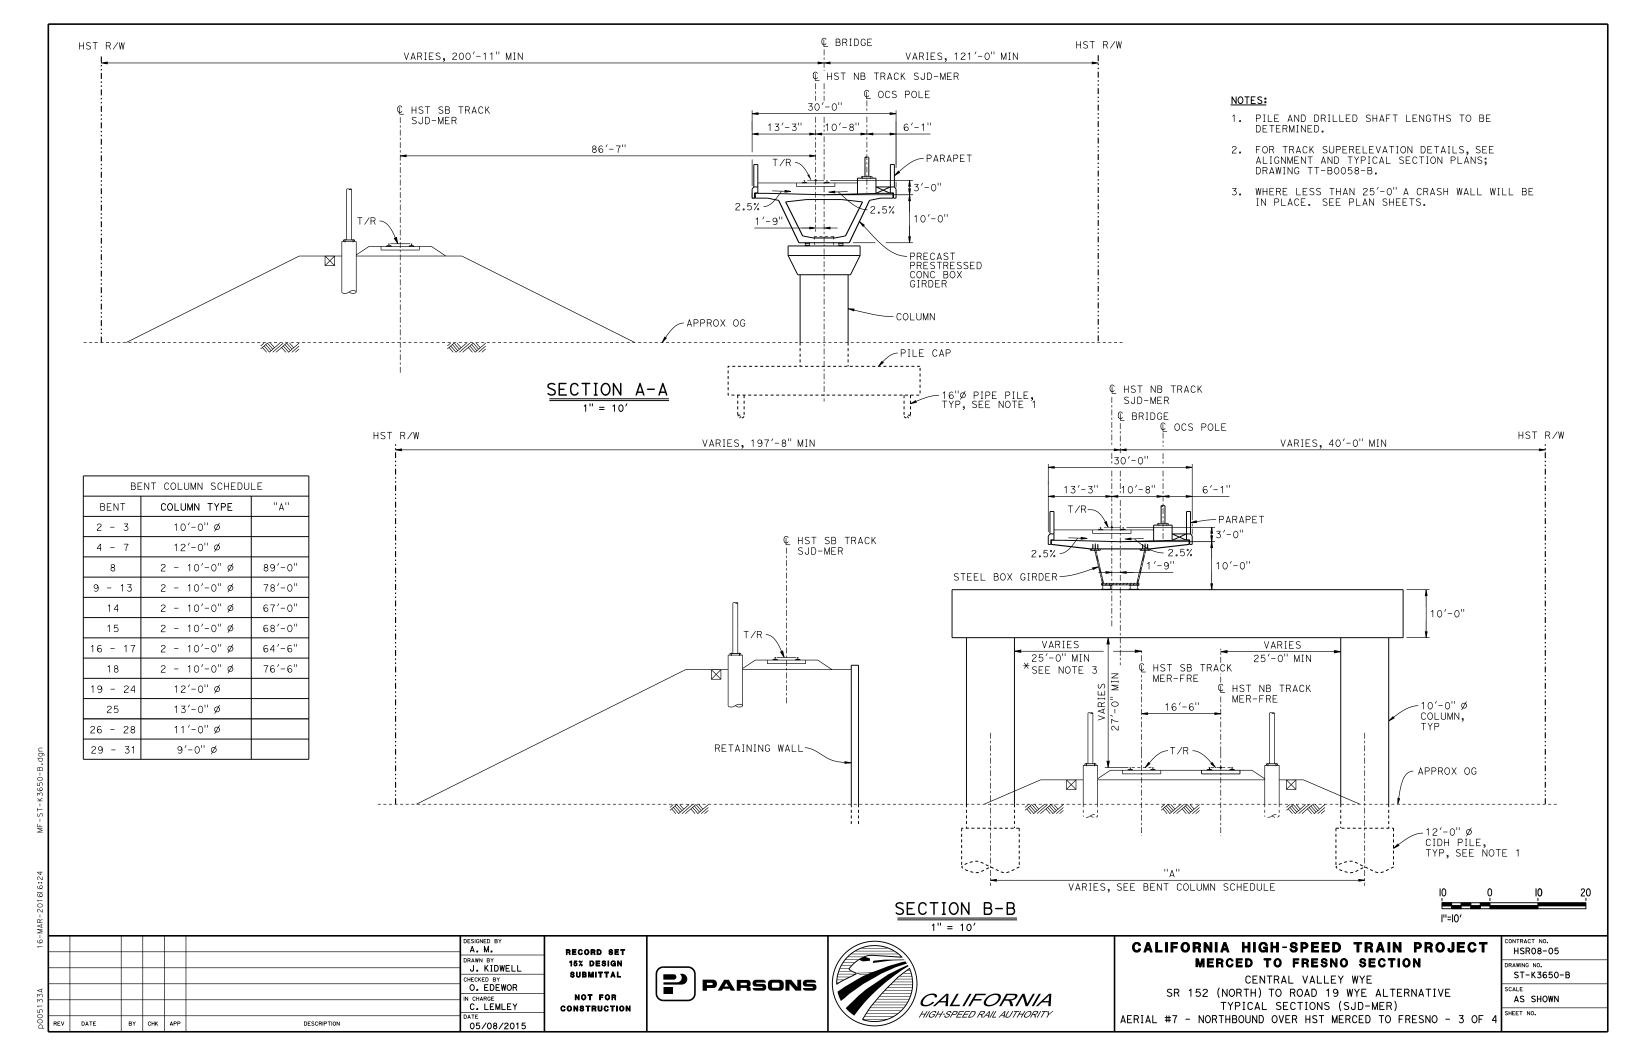


NOTES:

- 1. PILE LENGTHS TO BE DETERMINED.
- 2. FOR TRACK SUPERELEVATION DETAILS, SEE ALIGNMENT AND TYPICAL SECTION PLANS; DRAWING TT-B0058-B.

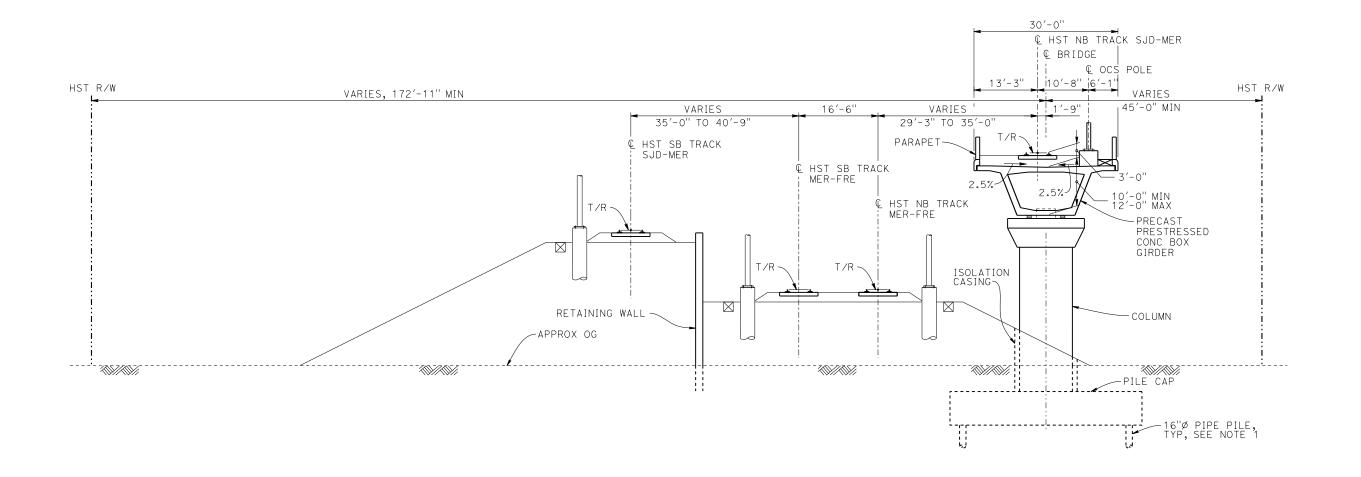

 $\frac{\text{SECTION } C-C}{1" = 10'}$

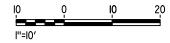

| | | | | | | DESIGNED BY A. M. | |
|-----|------|----|-----|-----|-------------|----------------------|----|
| | | | | | | J. KIDWELL |] |
| , | | | | | | CHECKED BY O. EDEWOR | 1 |
| | | | | | | IN CHARGE C. LEMLEY | co |
| REV | DATE | BY | снк | APP | DESCRIPTION | DATE 02/13/2015 | |

RECORD SET
15% DESIGN
SUBMITTAL
NOT FOR
CONSTRUCTION





CALIFORNIA HIGH-SPEED TRAIN PROJECT MERCED TO FRESNO SECTION

CENTRAL VALLEY WYE

SR 152 (NORTH) TO ROAD 19 WYE ALTERNATIVE

TYPICAL SECTION (SJD-MER)

AERIAL #7 - NORTHBOUND OVER HST MERCED TO FRESNO - 4 OF 4

| Т | CONTRACT NO. HSRO8-05 |
|---|---------------------------|
| | DRAWING NO. ST-K3651-B |
| | SCALE AS SHOWN |
| | SHEET NO. |