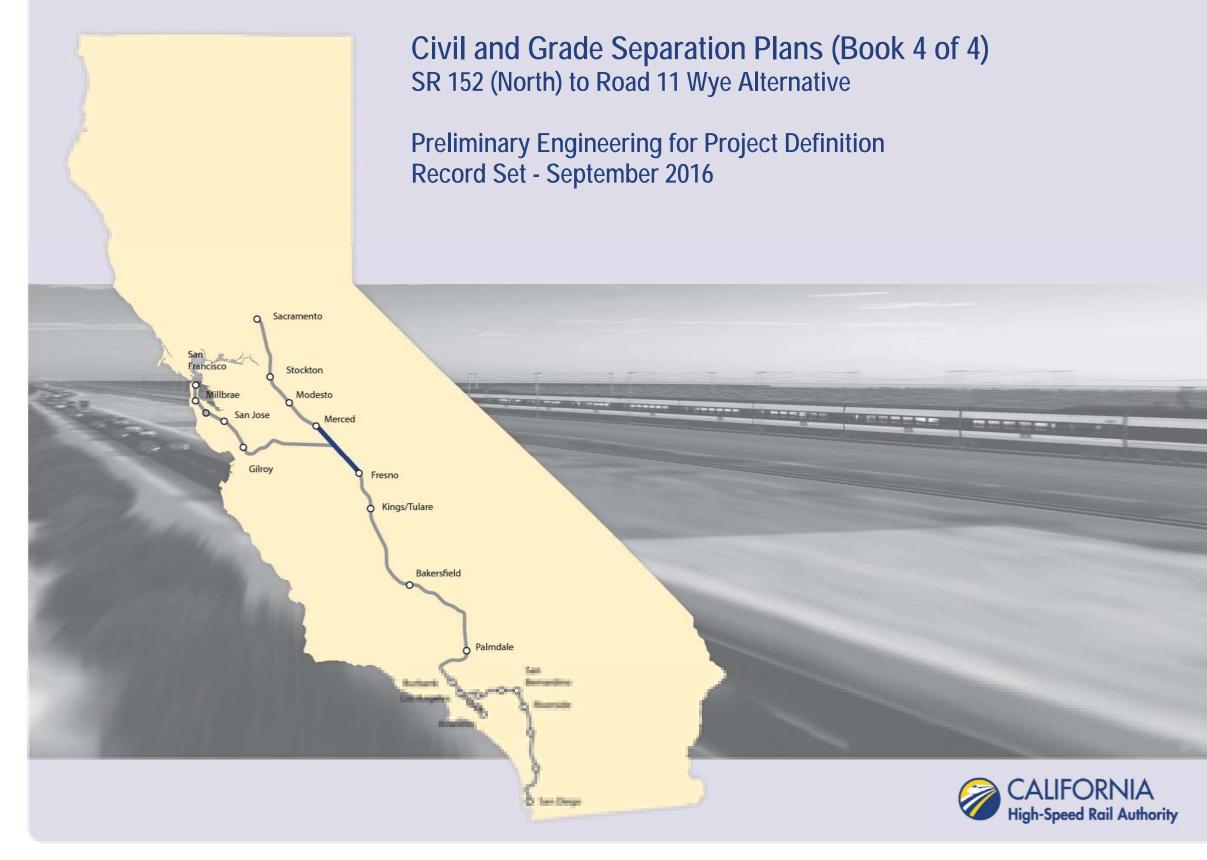
# California High-Speed Rail Authority Merced to Fresno Section: Central Valley Wye







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		11	NDEX OF DRAWINGS	
DRAWING NO.	SECTION	ALIGNMENT / PLAN SET	TITLE	DESCRIPTION
	F		GENERAL	
CV-B0001	CENTRAL VALLEY WYE	CIVIL AND GRADE SEPARATION PLANS	COVER	
CV-B0002	CENTRAL VALLEY WYE	CIVIL AND GRADE SEPARATION PLANS	INDEX OF DRAWINGS	SHEET 1 OF 17
CV-B0003	CENTRAL VALLEY WYE	CIVIL AND GRADE SEPARATION PLANS	INDEX OF DRAWINGS	SHEET 2 OF 17
CV-B0004	CENTRAL VALLEY WYE	CIVIL AND GRADE SEPARATION PLANS	INDEX OF DRAWINGS	SHEET 3 OF 17
CV-B0005	CENTRAL VALLEY WYE	CIVIL AND GRADE SEPARATION PLANS	INDEX OF DRAWINGS	SHEET 4 OF 17
CV-B0006	CENTRAL VALLEY WYE	CIVIL AND GRADE SEPARATION PLANS	INDEX OF DRAWINGS	SHEET 5 OF 17
CV-B0007	CENTRAL VALLEY WYE	CIVIL AND GRADE SEPARATION PLANS	INDEX OF DRAWINGS	SHEET 6 OF 17
CV-B0008	CENTRAL VALLEY WYE	CIVIL AND GRADE SEPARATION PLANS	INDEX OF DRAWINGS	SHEET 7 OF 17
CV-B0009	CENTRAL VALLEY WYE	CIVIL AND GRADE SEPARATION PLANS	INDEX OF DRAWINGS	SHEET 8 OF 17
CV-B0010	CENTRAL VALLEY WYE	CIVIL AND GRADE SEPARATION PLANS	INDEX OF DRAWINGS	SHEET 9 OF 17
CV-B0011	CENTRAL VALLEY WYE	CIVIL AND GRADE SEPARATION PLANS	INDEX OF DRAWINGS	SHEET 10 OF 17
CV-B0012	CENTRAL VALLEY WYE	CIVIL AND GRADE SEPARATION PLANS	INDEX OF DRAWINGS	SHEET 11 OF 17
CV-B0013	CENTRAL VALLEY WYE	CIVIL AND GRADE SEPARATION PLANS	INDEX OF DRAWINGS	SHEET 12 OF 17
CV-B0014	CENTRAL VALLEY WYE	CIVIL AND GRADE SEPARATION PLANS	INDEX OF DRAWINGS	SHEET 13 OF 17
CV-B0015	CENTRAL VALLEY WYE	CIVIL AND GRADE SEPARATION PLANS	INDEX OF DRAWINGS	SHEET 14 OF 17
CV-B0016	CENTRAL VALLEY WYE	CIVIL AND GRADE SEPARATION PLANS	INDEX OF DRAWINGS	SHEET 15 OF 17
CV-B0017	CENTRAL VALLEY WYE	CIVIL AND GRADE SEPARATION PLANS	INDEX OF DRAWINGS	SHEET 16 OF 17
CV-B0018	CENTRAL VALLEY WYE	CIVIL AND GRADE SEPARATION PLANS	INDEX OF DRAWINGS	SHEET 17 OF 17
CV-B0020	CENTRAL VALLEY WYE	CIVIL AND GRADE SEPARATION PLANS	ABBREVIATIONS	SHEET 1 OF 2
CV-B0021	CENTRAL VALLEY WYE	CIVIL AND GRADE SEPARATION PLANS	ABBREVIATIONS	SHEET 2 OF 2
CV-B4000	CENTRAL VALLEY WYE	CIVIL AND GRADE SEPARATION PLANS	LOCATION PLAN	
CV-B0030	CENTRAL VALLEY WYE	CIVIL AND GRADE SEPARATION PLANS	GENERAL NOTES	
		SR 152 (NORTH	) TO ROAD 13 WYE ALTERNATIVE	
CV-B4050-A	CENTRAL VALLEY WYE	SR 152 (NORTH) TO ROAD 13 WYE ALTERNATIVE	KEY MAP	SHEET 1 OF 4
CV-B4051-A	CENTRAL VALLEY WYE	SR 152 (NORTH) TO ROAD 13 WYE ALTERNATIVE	ΚΕΥ ΜΑΡ	SHEET 2 OF 4
CV-B4052-A	CENTRAL VALLEY WYE	SR 152 (NORTH) TO ROAD 13 WYE ALTERNATIVE	ΚΕΥ ΜΑΡ	SHEET 3 OF 4
CV-B4053-A	CENTRAL VALLEY WYE	SR 152 (NORTH) TO ROAD 13 WYE ALTERNATIVE	ΚΕΥ ΜΑΡ	SHEET 4 OF 4
CV-B0060-A	CENTRAL VALLEY WYE	SR 152 (NORTH) TO ROAD 13 WYE ALTERNATIVE	GEOMETRY DATA TABLE	SHEET 1 OF 6
CV-B0061-A	CENTRAL VALLEY WYE	SR 152 (NORTH) TO ROAD 13 WYE ALTERNATIVE	GEOMETRY DATA TABLE	SHEET 2 OF 6
CV-B0062-A	CENTRAL VALLEY WYE	SR 152 (NORTH) TO ROAD 13 WYE ALTERNATIVE	GEOMETRY DATA TABLE	SHEET 3 OF 6
CV-B0063-A	CENTRAL VALLEY WYE	SR 152 (NORTH) TO ROAD 13 WYE ALTERNATIVE	GEOMETRY DATA TABLE	SHEET 4 OF 6
CV-B0064-A	CENTRAL VALLEY WYE	SR 152 (NORTH) TO ROAD 13 WYE ALTERNATIVE	GEOMETRY DATA TABLE	SHEET 5 OF 6
CV-B0065-A	CENTRAL VALLEY WYE	SR 152 (NORTH) TO ROAD 13 WYE ALTERNATIVE	GEOMETRY DATA TABLE	SHEET 6 OF 6
CV-B0070-A	CENTRAL VALLEY WYE	SR 152 (NORTH) TO ROAD 13 WYE ALTERNATIVE	UTILITY CONFLICT TABLE	SHEET 1 OF 4
CV-B0071-A	CENTRAL VALLEY WYE	SR 152 (NORTH) TO ROAD 13 WYE ALTERNATIVE	UTILITY CONFLICT TABLE	SHEET 2 OF 4
CV-B0072-A	CENTRAL VALLEY WYE	SR 152 (NORTH) TO ROAD 13 WYE ALTERNATIVE	UTILITY CONFLICT TABLE	SHEET 3 OF 4
CV-B0073-A	CENTRAL VALLEY WYE	SR 152 (NORTH) TO ROAD 13 WYE ALTERNATIVE	UTILITY CONFLICT TABLE	SHEET 4 OF 4
CV-B0080-A	CENTRAL VALLEY WYE	SR 152 (NORTH) TO ROAD 13 WYE ALTERNATIVE	TYPICAL SECTION	SHEET 1 OF 3
CV-B0081-A	CENTRAL VALLEY WYE	SR 152 (NORTH) TO ROAD 13 WYE ALTERNATIVE	TYPICAL SECTION	SHEET 2 OF 3

p0021811 06-9	EV DATE	BY CHK APP	DESCRIPTION	DESIGNED BY S. WELLS DRAWN BY W. JOHNSEN CHECKED BY J. RAY IN CHARGE C. LEMLEY DATE 09/09/2016	RECORD SET 15% design Submittal Not for Construction	PARSONS	CALIFORNIA HIGH-SPEED RAIL AUTHORITY	CALIFORM M
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	CE	NTRA	L VA	LLEY	WYE		
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	١N	<b>IDEX</b>	OF [	DRAWI	NGS		
		SHE	ET 1	OF 1	7		

CONTRACT NO. HSR08-05 DRAWING NO. CV-B0002

SCALE NO SCALE

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CV-B0082-A	CENTRAL VALLEY WYE	SR 152 (NORTH) TO ROAD 13 WYE ALTERNATIVE	TYPICAL SECTION	SHEET 3 OF 3		
CV-S1010-A	CENTRAL VALLEY WYE	SR 152 (NORTH) TO ROAD 13 WYE ALTERNATIVE	CIVIL PLAN	SJD-FRE STA 5338+00 TO 5	5394+00	
CV-S1020-A	CENTRAL VALLEY WYE	SR 152 (NORTH) TO ROAD 13 WYE ALTERNATIVE	CIVIL PLAN	SJD-FRE STA 5394+00 TO 5	5450+00	
CV-S1030-A	CENTRAL VALLEY WYE	SR 152 (NORTH) TO ROAD 13 WYE ALTERNATIVE	CIVIL PLAN	SJD-FRE STA 5450+00 TO 5	5506+00	
CV-S1040-A	CENTRAL VALLEY WYE	SR 152 (NORTH) TO ROAD 13 WYE ALTERNATIVE	CIVIL PLAN	SJD-FRE STA 5506+00 TO 5	5562+00	
CV-S1050-A	CENTRAL VALLEY WYE	SR 152 (NORTH) TO ROAD 13 WYE ALTERNATIVE	CIVIL PLAN	SJD-FRE STA 5562+00 TO 5	5618+00	
CV-S1060-A	CENTRAL VALLEY WYE	SR 152 (NORTH) TO ROAD 13 WYE ALTERNATIVE	CIVIL PLAN	SJD-FRE STA 5618+00 TO 5	5674+00	
CV-S1070-A	CENTRAL VALLEY WYE	SR 152 (NORTH) TO ROAD 13 WYE ALTERNATIVE	CIVIL PLAN	SJD-FRE STA 5674+00 TO 5	5730+00	
CV-S1080-A	CENTRAL VALLEY WYE	SR 152 (NORTH) TO ROAD 13 WYE ALTERNATIVE	CIVIL PLAN	SJD-FRE STA 5730+00 TO 5	5786+00	
CV-S1090-A	CENTRAL VALLEY WYE	SR 152 (NORTH) TO ROAD 13 WYE ALTERNATIVE	CIVIL PLAN	SJD-FRE STA 5786+00 TO 5	5842+00	
CV-S1100-A	CENTRAL VALLEY WYE	SR 152 (NORTH) TO ROAD 13 WYE ALTERNATIVE	CIVIL PLAN	SJD-FRE STA 5842+00 TO S	5898+00	
CV-S1110-A	CENTRAL VALLEY WYE	SR 152 (NORTH) TO ROAD 13 WYE ALTERNATIVE	CIVIL PLAN	SJD-FRE STA 5898+00 TO 5	5954+00	
CV-S1120-A	CENTRAL VALLEY WYE	SR 152 (NORTH) TO ROAD 13 WYE ALTERNATIVE	CIVIL PLAN	SJD-FRE STA 5954+00 TO 6	5010+00	
CV-S1130-A	CENTRAL VALLEY WYE	SR 152 (NORTH) TO ROAD 13 WYE ALTERNATIVE	CIVIL PLAN	SJD-FRE STA 6010+00 TO 6	5066+00	
CV-S1140-A	CENTRAL VALLEY WYE	SR 152 (NORTH) TO ROAD 13 WYE ALTERNATIVE	CIVIL PLAN	SJD-FRE STA 6066+00 TO 6	5122+00	
CV-S1150-A	CENTRAL VALLEY WYE	SR 152 (NORTH) TO ROAD 13 WYE ALTERNATIVE	CIVIL PLAN	SJD-FRE STA 6122+00 TO 6	5178+00	
CV-S1160-A	CENTRAL VALLEY WYE	SR 152 (NORTH) TO ROAD 13 WYE ALTERNATIVE	CIVIL PLAN	SJD-FRE STA 6178+00 TO 6	6234+00	
CV-S1161-A	CENTRAL VALLEY WYE	SR 152 (NORTH) TO ROAD 13 WYE ALTERNATIVE	CIVIL PLAN	SJD-FRE ACCESS ROA	D	
CV-S1170-A	CENTRAL VALLEY WYE	SR 152 (NORTH) TO ROAD 13 WYE ALTERNATIVE	CIVIL PLAN	SJD-FRE STA 6234+00 TO 6	5290+00	
CV-S1180-A	CENTRAL VALLEY WYE	SR 152 (NORTH) TO ROAD 13 WYE ALTERNATIVE	CIVIL PLAN	SJD-FRE STA 6290+00 TO 6	5346+00	
CV-S1190-A	CENTRAL VALLEY WYE	SR 152 (NORTH) TO ROAD 13 WYE ALTERNATIVE	CIVIL PLAN	SJD-FRE STA 6346+00 TO 6	6402+00	
CV-S1200-A	CENTRAL VALLEY WYE	SR 152 (NORTH) TO ROAD 13 WYE ALTERNATIVE	CIVIL PLAN	SJD-FRE STA 6402+00 TO 6	6458+00	
CV-S1210-A	CENTRAL VALLEY WYE	SR 152 (NORTH) TO ROAD 13 WYE ALTERNATIVE	CIVIL PLAN	SJD-FRE STA 6458+00 TO 6	5514+00	
CV-S1220-A	CENTRAL VALLEY WYE	SR 152 (NORTH) TO ROAD 13 WYE ALTERNATIVE	CIVIL PLAN	SJD-FRE STA 6514+00 TO 6	5570+00	
CV-S1230-A	CENTRAL VALLEY WYE	SR 152 (NORTH) TO ROAD 13 WYE ALTERNATIVE	CIVIL PLAN	SJD-FRE STA 6570+00 TO 6	6626+00	
CV-S1240-A	CENTRAL VALLEY WYE	SR 152 (NORTH) TO ROAD 13 WYE ALTERNATIVE	CIVIL PLAN	SJD-FRE STA 6626+00 TO 6	6682+00	
CV-S1241-A	CENTRAL VALLEY WYE	SR 152 (NORTH) TO ROAD 13 WYE ALTERNATIVE	CIVIL PLAN	SJD-FRE ACCESS ROA	D	
CV-S1250-A	CENTRAL VALLEY WYE	SR 152 (NORTH) TO ROAD 13 WYE ALTERNATIVE	CIVIL PLAN	SJD-FRE STA 6682+00 TO 6	5738+00	
CV-S1260-A	CENTRAL VALLEY WYE	SR 152 (NORTH) TO ROAD 13 WYE ALTERNATIVE	CIVIL PLAN	SJD-FRE STA 6738+00 TO 6	5794+00	
CV-S1270-A	CENTRAL VALLEY WYE	SR 152 (NORTH) TO ROAD 13 WYE ALTERNATIVE	CIVIL PLAN	SJD-FRE STA 6794+00 TO 6	6850+00	
CV-S1280-A	CENTRAL VALLEY WYE	SR 152 (NORTH) TO ROAD 13 WYE ALTERNATIVE	CIVIL PLAN	SJD-FRE STA 6850+00 TO 6	5906+00	
CV-S1290-A	CENTRAL VALLEY WYE	SR 152 (NORTH) TO ROAD 13 WYE ALTERNATIVE	CIVIL PLAN	SJD-FRE STA 6906+00 TO 6	5962+00	
CV-S1291-A	CENTRAL VALLEY WYE	SR 152 (NORTH) TO ROAD 13 WYE ALTERNATIVE	CIVIL PLAN	SJD-FRE ACCESS ROA		
CV-S1300-A	CENTRAL VALLEY WYE	SR 152 (NORTH) TO ROAD 13 WYE ALTERNATIVE	CIVIL PLAN	SJD-FRE STA 6962+00 TO		
CV-S1310-A	CENTRAL VALLEY WYE	SR 152 (NORTH) TO ROAD 13 WYE ALTERNATIVE	CIVIL PLAN	SJD-FRE STA 7018+00 TO		
CV-S1320-A	CENTRAL VALLEY WYE	SR 152 (NORTH) TO ROAD 13 WYE ALTERNATIVE	CIVIL PLAN	SJD-FRE STA 7074+00 TO		
CV-S1330-A	CENTRAL VALLEY WYE	SR 152 (NORTH) TO ROAD 13 WYE ALTERNATIVE	CIVIL PLAN	SJD-FRE STA 7130+00 TO 71		
CV-S1410-A	CENTRAL VALLEY WYE	SR 152 (NORTH) TO ROAD 13 WYE ALTERNATIVE	CIVIL PLAN	MER-FRE STA 14946+67.02 TO		
CV-S1420-A	CENTRAL VALLEY WYE	SR 152 (NORTH) TO ROAD 13 WYE ALTERNATIVE	CIVIL PLAN	MER-FRE STA 14996+00 TO 7		
CV-S1430-A	CENTRAL VALLEY WYE	SR 152 (NORTH) TO ROAD 13 WYE ALTERNATIVE	CIVIL PLAN	MER-FRE STA 15052+00 TO 7		
CV-S1440-A	CENTRAL VALLEY WYE	SR 152 (NORTH) TO ROAD 13 WYE ALTERNATIVE	CIVIL PLAN	MER-FRE STA 15108+00 TO 7		
		DESIGNED BY S. WELLS DRAWN BY W. JOHNSEN CHECKED BY J. RAY IN CHARGE C. LEMLEY DRAWNEY CONSTRUCTION	RSONS		HIGH-SPEED TRAIN PROJECT ED TO FRESNO SECTION CENTRAL VALLEY WYE AND GRADE SEPARATION PLANS INDEX OF DRAWINGS	CONTRACT N HSR08 DRAWING NO. CV-BO SCALE NO SC SHEET NO.

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CV-S1450-A	CENTRAL VALLEY WYE	SR 152 (NORTH) TO ROAD 13 WYE ALTERNATIVE	CIVIL PLAN	MER-FRE STA 15164+00 TO 15220+00	1
CV-S1460-A	CENTRAL VALLEY WYE	SR 152 (NORTH) TO ROAD 13 WYE ALTERNATIVE	CIVIL PLAN	MER-FRE STA 15220+00 TO 15276+00	1
CV-S1470-A	CENTRAL VALLEY WYE	SR 152 (NORTH) TO ROAD 13 WYE ALTERNATIVE	CIVIL PLAN	MER-FRE STA 15276+00 TO 15332+00	1
CV-S1480-A	CENTRAL VALLEY WYE	SR 152 (NORTH) TO ROAD 13 WYE ALTERNATIVE	CIVIL PLAN	MER-FRE STA 15332+00 TO 15388+00	1
CV-S1490-A	CENTRAL VALLEY WYE	SR 152 (NORTH) TO ROAD 13 WYE ALTERNATIVE	CIVIL PLAN	MER-FRE STA 15388+00 TO 15444+00	1
CV-S1500-A	CENTRAL VALLEY WYE	SR 152 (NORTH) TO ROAD 13 WYE ALTERNATIVE	CIVIL PLAN	MER-FRE STA 15444+00 TO 15500+00	1
CV-S1510-A	CENTRAL VALLEY WYE	SR 152 (NORTH) TO ROAD 13 WYE ALTERNATIVE	CIVIL PLAN	MER-FRE STA 15500+00 TO 15556+00	1
CV-S1520-A	CENTRAL VALLEY WYE	SR 152 (NORTH) TO ROAD 13 WYE ALTERNATIVE	CIVIL PLAN	MER-FRE STA 15556+00 TO 15612+00	4
CV-S1530-A	CENTRAL VALLEY WYE	SR 152 (NORTH) TO ROAD 13 WYE ALTERNATIVE	CIVIL PLAN	MER-FRE STA 15612+00 TO 15655+00	4
CV-S1610-A	CENTRAL VALLEY WYE	SR 152 (NORTH) TO ROAD 13 WYE ALTERNATIVE	CIVIL PLAN	SJD-MER STA 36246+00 TO 36302+00	4
CV-S1620-A	CENTRAL VALLEY WYE	SR 152 (NORTH) TO ROAD 13 WYE ALTERNATIVE	CIVIL PLAN	SJD-MER STA 36302+00 TO 36358+00	4
CV-S1630-A	CENTRAL VALLEY WYE	SR 152 (NORTH) TO ROAD 13 WYE ALTERNATIVE	CIVIL PLAN	SJD-MER STA 36358+00 TO 36414+00	4
CV-S1631-A	CENTRAL VALLEY WYE	SR 152 (NORTH) TO ROAD 13 WYE ALTERNATIVE	CIVIL PLAN	SJD-MER ACCESS ROAD	1
CV-S1640-A	CENTRAL VALLEY WYE	SR 152 (NORTH) TO ROAD 13 WYE ALTERNATIVE	CIVIL PLAN	SJD-MER STA 36414+00 TO 36470+00	1
CV-S1650-A	CENTRAL VALLEY WYE	SR 152 (NORTH) TO ROAD 13 WYE ALTERNATIVE	CIVIL PLAN	SJD-MER STA 36470+00 TO 36526+00	1
CV-S1660-A	CENTRAL VALLEY WYE	SR 152 (NORTH) TO ROAD 13 WYE ALTERNATIVE	CIVIL PLAN	SJD-MER STA 36526+00 TO 36542+78.70	1
CV-R1030-A	CENTRAL VALLEY WYE	SR 152 (NORTH) TO ROAD 13 WYE ALTERNATIVE	PLAN AND PROFILE	HENRY MILLER ROAD REALIGNMENT	1
CV-R1031-A	CENTRAL VALLEY WYE	SR 152 (NORTH) TO ROAD 13 WYE ALTERNATIVE	PLAN AND PROFILE	HENRY MILLER ROAD REALIGNMENT	1
CV-R1032-A	CENTRAL VALLEY WYE	SR 152 (NORTH) TO ROAD 13 WYE ALTERNATIVE	PLAN AND PROFILE	HENRY MILLER ROAD REALIGNMENT	1
CV-R1033-A	CENTRAL VALLEY WYE	SR 152 (NORTH) TO ROAD 13 WYE ALTERNATIVE	PLAN AND PROFILE	HENRY MILLER ROAD REALIGNMENT	1
CV-R1050-A	CENTRAL VALLEY WYE	SR 152 (NORTH) TO ROAD 13 WYE ALTERNATIVE	PLAN AND PROFILE	INDIANA ROAD GRADE SEPARATION	1
CV-R1051-A	CENTRAL VALLEY WYE	SR 152 (NORTH) TO ROAD 13 WYE ALTERNATIVE	PLAN AND PROFILE	INDIANA ROAD GRADE SEPARATION	1
CV-R1090-A	CENTRAL VALLEY WYE	SR 152 (NORTH) TO ROAD 13 WYE ALTERNATIVE	PLAN AND PROFILE	COYOTE ROAD REALIGNMENT	1
CV-R1091-A	CENTRAL VALLEY WYE	SR 152 (NORTH) TO ROAD 13 WYE ALTERNATIVE	PLAN AND PROFILE	COYOTE ROAD REALIGNMENT	1
CV-R1100-A	CENTRAL VALLEY WYE	SR 152 (NORTH) TO ROAD 13 WYE ALTERNATIVE	PLAN AND PROFILE	SR 152 REALIGNMENT AT SR 59	1
CV-R1101-A	CENTRAL VALLEY WYE	SR 152 (NORTH) TO ROAD 13 WYE ALTERNATIVE	PLAN AND PROFILE	SR 152 REALIGNMENT AT SR 59	1
CV-R1102-A	CENTRAL VALLEY WYE	SR 152 (NORTH) TO ROAD 13 WYE ALTERNATIVE	PLAN AND PROFILE	SR 152 REALIGNMENT AT SR 59	1
CV-R1103-A	CENTRAL VALLEY WYE	SR 152 (NORTH) TO ROAD 13 WYE ALTERNATIVE	PLAN AND PROFILE	SR 152 REALIGNMENT AT SR 59	1
CV-R1104-A	CENTRAL VALLEY WYE	SR 152 (NORTH) TO ROAD 13 WYE ALTERNATIVE	PLAN AND PROFILE	SR 59/SR 152 EB OFF RAMP GRADE SEPARATION	1
CV-R1105-A	CENTRAL VALLEY WYE	SR 152 (NORTH) TO ROAD 13 WYE ALTERNATIVE	PLAN AND PROFILE	SR 59/SR 152 EB OFF RAMP GRADE SEPARATION	1
CV-R1106-A	CENTRAL VALLEY WYE	SR 152 (NORTH) TO ROAD 13 WYE ALTERNATIVE	PLAN AND PROFILE	SR 59/SR 152 WB ON RAMP GRADE SEPARATION	1
CV-R1107-A	CENTRAL VALLEY WYE	SR 152 (NORTH) TO ROAD 13 WYE ALTERNATIVE	PLAN AND PROFILE	SR 59/SR 152 WB ON RAMP GRADE SEPARATION	1
CV-R1108-A	CENTRAL VALLEY WYE	SR 152 (NORTH) TO ROAD 13 WYE ALTERNATIVE	PLAN AND PROFILE	SR 59/SR 152 WB OFF RAMP GRADE SEPARATION	1
CV-R1109-A	CENTRAL VALLEY WYE	SR 152 (NORTH) TO ROAD 13 WYE ALTERNATIVE	PLAN AND PROFILE	SR 59/SR 152 WB OFF RAMP GRADE SEPARATION	1
CV-R1110-A	CENTRAL VALLEY WYE	SR 152 (NORTH) TO ROAD 13 WYE ALTERNATIVE	PLAN AND PROFILE	SR 59/SR 152 EB LOOP ON RAMP	1
CV-R1111-A	CENTRAL VALLEY WYE	SR 152 (NORTH) TO ROAD 13 WYE ALTERNATIVE	PLAN AND PROFILE	ROAD 4/LINCOLN ROAD GRADE SEPARATION	ł
CV-R1112-A	CENTRAL VALLEY WYE	SR 152 (NORTH) TO ROAD 13 WYE ALTERNATIVE	PLAN AND PROFILE	ROAD 4/LINCOLN ROAD GRADE SEPARATION	1
CV-R1160-A	CENTRAL VALLEY WYE	SR 152 (NORTH) TO ROAD 13 WYE ALTERNATIVE	PLAN AND PROFILE	ROAD 9/HEMLOCK ROAD GRADE SEPARATION	1
CV-R1161-A	CENTRAL VALLEY WYE	SR 152 (NORTH) TO ROAD 13 WYE ALTERNATIVE	PLAN AND PROFILE	ROAD 9/HEMLOCK ROAD GRADE SEPARATION	1
CV-R1162-A	CENTRAL VALLEY WYE	SR 152 (NORTH) TO ROAD 13 WYE ALTERNATIVE	PLAN AND PROFILE	SR 152 REALIGNMENT AT ROAD 9	1
CV-R1163-A	CENTRAL VALLEY WYE	SR 152 (NORTH) TO ROAD 13 WYE ALTERNATIVE	PLAN AND PROFILE	SR 152 REALIGNMENT AT ROAD 9	·
		DESIGNED BY SWELLS RECORD SET		CALIFORNIA HIGH-SPEED TRA	
+		URANN BY W. JOHNSEN CHECKED BY SUBMITTAL		MERCED TO FRESNO SEC Central valley wye	TION
<u> </u>			ARSONS		PLANS
				IFORNIA INDEX OF DRAWINGS	L

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CV-R1164-A	CENTRAL VALLEY WYE	SR 152 (NORTH) TO ROAD 13 WYE ALTERNATIVE	PLAN AND PROFILE	SR 152 REALIGNMENT AT ROAD 9	
CV-R1165-A	CENTRAL VALLEY WYE	SR 152 (NORTH) TO ROAD 13 WYE ALTERNATIVE	PLAN AND PROFILE	ROAD 9/SR 152 EB OFF RAMP	
CV-R1166-A	CENTRAL VALLEY WYE	SR 152 (NORTH) TO ROAD 13 WYE ALTERNATIVE	PLAN AND PROFILE	ROAD 9/SR 152 EB ON RAMP	
CV-R1167-A	CENTRAL VALLEY WYE	SR 152 (NORTH) TO ROAD 13 WYE ALTERNATIVE	PLAN AND PROFILE	ROAD 9/SR 152 LOOP RAMP	
CV-R1168-A	CENTRAL VALLEY WYE	SR 152 (NORTH) TO ROAD 13 WYE ALTERNATIVE	PLAN AND PROFILE	ROAD 9/SR 152 WB ON RAMP	
CV-R1169-A	CENTRAL VALLEY WYE	SR 152 (NORTH) TO ROAD 13 WYE ALTERNATIVE	PLAN AND PROFILE	ROAD 9/SR 152 WB OFF RAMP	
CV-R1190-A	CENTRAL VALLEY WYE	SR 152 (NORTH) TO ROAD 13 WYE ALTERNATIVE	PLAN AND PROFILE	ROAD 12 GRADE SEPARATION	
CV-R1191-A	CENTRAL VALLEY WYE	SR 152 (NORTH) TO ROAD 13 WYE ALTERNATIVE	PLAN AND PROFILE	ROAD 12 GRADE SEPARATION	
CV-R1192-A	CENTRAL VALLEY WYE	SR 152 (NORTH) TO ROAD 13 WYE ALTERNATIVE	PLAN AND PROFILE	SR 152 REALIGNMENT AT ROAD 12	
CV-R1193-A	CENTRAL VALLEY WYE	SR 152 (NORTH) TO ROAD 13 WYE ALTERNATIVE	PLAN AND PROFILE	SR 152 REALIGNMENT AT ROAD 12	
CV-R1194-A	CENTRAL VALLEY WYE	SR 152 (NORTH) TO ROAD 13 WYE ALTERNATIVE	PLAN AND PROFILE	SR 152 REALIGNMENT AT ROAD 12	
CV-R1200-A	CENTRAL VALLEY WYE	SR 152 (NORTH) TO ROAD 13 WYE ALTERNATIVE	PLAN AND PROFILE	SR 152 REALIGNMENT AT SR 233	
CV-R1201-A	CENTRAL VALLEY WYE	SR 152 (NORTH) TO ROAD 13 WYE ALTERNATIVE	PLAN AND PROFILE	SR 152 REALIGNMENT AT SR 233	
CV-R1202-A	CENTRAL VALLEY WYE	SR 152 (NORTH) TO ROAD 13 WYE ALTERNATIVE	PLAN AND PROFILE	SR 152 REALIGNMENT AT SR 233	
CV-R1203-A	CENTRAL VALLEY WYE	SR 152 (NORTH) TO ROAD 13 WYE ALTERNATIVE	PLAN AND PROFILE	SR 233/SR 152 EB OFF RAMP	
CV-R1204-A	CENTRAL VALLEY WYE	SR 152 (NORTH) TO ROAD 13 WYE ALTERNATIVE	PLAN AND PROFILE	SR 233/SR 152 EB LOOP RAMP	
CV-R1205-A	CENTRAL VALLEY WYE	SR 152 (NORTH) TO ROAD 13 WYE ALTERNATIVE	PLAN AND PROFILE	SR 233/SR 152 WB ON RAMP	
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СV-ВОО80-В	CENTRAL VALLEY WYE	SR 152 (NORTH) TO ROAD 19 WYE ALTERNATIV	E TYPICAL SECTION	SHEET 1 OF 5	
CV-B0081-B	CENTRAL VALLEY WYE	SR 152 (NORTH) TO ROAD 19 WYE ALTERNATIV	E TYPICAL SECTION	SHEET 2 OF 5	
CV-B0082-B	CENTRAL VALLEY WYE	SR 152 (NORTH) TO ROAD 19 WYE ALTERNATIV	E TYPICAL SECTION	SHEET 3 OF 5	
CV-B0083-B	CENTRAL VALLEY WYE	SR 152 (NORTH) TO ROAD 19 WYE ALTERNATIV	E TYPICAL SECTION	SHEET 4 OF 5	
CV-B0084-B	CENTRAL VALLEY WYE	SR 152 (NORTH) TO ROAD 19 WYE ALTERNATIV	E TYPICAL SECTION	SHEET 5 OF 5	
CV-S1010-B	CENTRAL VALLEY WYE	SR 152 (NORTH) TO ROAD 19 WYE ALTERNATIV	E CIVIL PLAN	SJD-FRE STA 5338+00 TO 5394+00	
CV-S1020-B	CENTRAL VALLEY WYE	SR 152 (NORTH) TO ROAD 19 WYE ALTERNATIV	E CIVIL PLAN	SJD-FRE STA 5394+00 TO 5450+00	
CV-S1030-B	CENTRAL VALLEY WYE	SR 152 (NORTH) TO ROAD 19 WYE ALTERNATIV	E CIVIL PLAN	SJD-FRE STA 5450+00 TO 5506+00	
CV-S1040-B	CENTRAL VALLEY WYE	SR 152 (NORTH) TO ROAD 19 WYE ALTERNATIV	E CIVIL PLAN	SJD-FRE STA 5506+00 TO 5562+00	
CV-S1050-B	CENTRAL VALLEY WYE	SR 152 (NORTH) TO ROAD 19 WYE ALTERNATIV	E CIVIL PLAN	SJD-FRE STA 5562+00 TO 5618+00	
CV-S1060-B	CENTRAL VALLEY WYE	SR 152 (NORTH) TO ROAD 19 WYE ALTERNATIV	E CIVIL PLAN	SJD-FRE STA 5618+00 TO 5674+00	
CV-S1070-B	CENTRAL VALLEY WYE	SR 152 (NORTH) TO ROAD 19 WYE ALTERNATIV	E CIVIL PLAN	SJD-FRE STA 5674+00 TO 5730+00	
CV-S1080-B	CENTRAL VALLEY WYE	SR 152 (NORTH) TO ROAD 19 WYE ALTERNATIV	E CIVIL PLAN	SJD-FRE STA 5730+00 TO 5786+00	
CV-S1090-B	CENTRAL VALLEY WYE	SR 152 (NORTH) TO ROAD 19 WYE ALTERNATIV	E CIVIL PLAN	SJD-FRE STA 5786+00 TO 5842+00	
CV-S1100-B	CENTRAL VALLEY WYE	SR 152 (NORTH) TO ROAD 19 WYE ALTERNATIV	E CIVIL PLAN	SJD-FRE STA 5842+00 TO 5898+00	
CV-S1110-B	CENTRAL VALLEY WYE	SR 152 (NORTH) TO ROAD 19 WYE ALTERNATIV	E CIVIL PLAN	SJD-FRE STA 5898+00 TO 5954+00	
CV-S1111-B	CENTRAL VALLEY WYE	SR 152 (NORTH) TO ROAD 19 WYE ALTERNATIV	E CIVIL PLAN	SJD-FRE ACCESS ROAD	
CV-S1120-B	CENTRAL VALLEY WYE	SR 152 (NORTH) TO ROAD 19 WYE ALTERNATIV	E CIVIL PLAN	SJD-FRE STA 5954+00 TO 6010+00	
CV-S1130-B	CENTRAL VALLEY WYE	SR 152 (NORTH) TO ROAD 19 WYE ALTERNATIV	E CIVIL PLAN	SJD-FRE STA 6010+00 TO 6066+00	
CV-S1140-B	CENTRAL VALLEY WYE	SR 152 (NORTH) TO ROAD 19 WYE ALTERNATIV	E CIVIL PLAN	SJD-FRE STA 6066+00 TO 6122+00	
CV-S1150-B	CENTRAL VALLEY WYE	SR 152 (NORTH) TO ROAD 19 WYE ALTERNATIV	E CIVIL PLAN	SJD-FRE STA 6122+00 TO 6178+00	
CV-S1160-B	CENTRAL VALLEY WYE	SR 152 (NORTH) TO ROAD 19 WYE ALTERNATIV	E CIVIL PLAN	SJD-FRE STA 6178+00 TO 6234+00	
CV-S1161-B	CENTRAL VALLEY WYE	SR 152 (NORTH) TO ROAD 19 WYE ALTERNATIV	E CIVIL PLAN	SJD-FRE ACCESS ROAD	
CV-S1170-B	CENTRAL VALLEY WYE	SR 152 (NORTH) TO ROAD 19 WYE ALTERNATIV	E CIVIL PLAN	SJD-FRE STA 6234+00 TO 6290+00	
CV-S1180-B	CENTRAL VALLEY WYE	SR 152 (NORTH) TO ROAD 19 WYE ALTERNATIV	E CIVIL PLAN	SJD-FRE STA 6290+00 TO 6346+00	
CV-S1190-B	CENTRAL VALLEY WYE	SR 152 (NORTH) TO ROAD 19 WYE ALTERNATIV	E CIVIL PLAN	SJD-FRE STA 6346+00 TO 6402+00	
		DESIGNED BY S. WELLS DRAWN BY W. JOHNSEN CHECKED BY CHECKED BY L D DAY	PARSONS	CALIFORNIA HIGH-SPEED TRAIN PROJECT MERCED TO FRESNO SECTION CENTRAL VALLEY WYE	DRAWING NO. CV-BO
			FARSONS CALIFOR	CIVIL AND GRADE SEPARATION PLANS INDEX OF DRAWINGS	NO SC
	DESCRIPTION	C. LEMLEY CONSTRUCTION	HIGH-SPEED RAIL AUT		SHEET NO.

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		INDEX	OF DRAWINGS	
DRAWING NO.	SECTION	ALIGNMENT / PLAN SET	TITLE	DESCRIPTION
CV-S1191-B	CENTRAL VALLEY WYE	SR 152 (NORTH) TO ROAD 19 WYE ALTERNATIVE	CIVIL PLAN	SJD-FRE ACCESS ROAD
CV-S1200-B	CENTRAL VALLEY WYE	SR 152 (NORTH) TO ROAD 19 WYE ALTERNATIVE	CIVIL PLAN	SJD-FRE STA 6402+00 TO 6458+00
CV-S1210-B	CENTRAL VALLEY WYE	SR 152 (NORTH) TO ROAD 19 WYE ALTERNATIVE	CIVIL PLAN	SJD-FRE STA 6458+00 TO 6514+00
CV-S1220-B	CENTRAL VALLEY WYE	SR 152 (NORTH) TO ROAD 19 WYE ALTERNATIVE	CIVIL PLAN	SJD-FRE STA 6514+00 TO 6570+00
CV-S1230-B	CENTRAL VALLEY WYE	SR 152 (NORTH) TO ROAD 19 WYE ALTERNATIVE	CIVIL PLAN	SJD-FRE STA 6570+00 TO 6626+00
CV-S1240-B	CENTRAL VALLEY WYE	SR 152 (NORTH) TO ROAD 19 WYE ALTERNATIVE	CIVIL PLAN	SJD-FRE STA 6626+00 TO 6682+00
CV-S1250-B	CENTRAL VALLEY WYE	SR 152 (NORTH) TO ROAD 19 WYE ALTERNATIVE	CIVIL PLAN	SJD-FRE STA 6682+00 TO 6738+00
CV-S1260-B	CENTRAL VALLEY WYE	SR 152 (NORTH) TO ROAD 19 WYE ALTERNATIVE	CIVIL PLAN	SJD-FRE STA 6738+00 TO 6794+00
CV-S1270-B	CENTRAL VALLEY WYE	SR 152 (NORTH) TO ROAD 19 WYE ALTERNATIVE	CIVIL PLAN	SJD-FRE STA 6794+00 TO 6850+00
CV-S1280-B	CENTRAL VALLEY WYE	SR 152 (NORTH) TO ROAD 19 WYE ALTERNATIVE	CIVIL PLAN	SJD-FRE STA 6850+00 TO 6906+00
CV-S1290-B	CENTRAL VALLEY WYE	SR 152 (NORTH) TO ROAD 19 WYE ALTERNATIVE	CIVIL PLAN	SJD-FRE STA 6906+00 TO 6962+00
CV-S1300-B	CENTRAL VALLEY WYE	SR 152 (NORTH) TO ROAD 19 WYE ALTERNATIVE	CIVIL PLAN	SJD-FRE STA 6962+00 TO 7018+00
CV-S1301-B	CENTRAL VALLEY WYE	SR 152 (NORTH) TO ROAD 19 WYE ALTERNATIVE	CIVIL PLAN	SJD-FRE ACCESS ROAD
CV-S1310-B	CENTRAL VALLEY WYE	SR 152 (NORTH) TO ROAD 19 WYE ALTERNATIVE	CIVIL PLAN	SJD-FRE STA 7018+00 TO 7074+00
CV-S1320-B	CENTRAL VALLEY WYE	SR 152 (NORTH) TO ROAD 19 WYE ALTERNATIVE	CIVIL PLAN	SJD-FRE STA 7074+00 TO 7130+00
CV-S1330-B	CENTRAL VALLEY WYE	SR 152 (NORTH) TO ROAD 19 WYE ALTERNATIVE	CIVIL PLAN	SJD-FRE STA 7130+00 TO 7169+59.17
CV-S1410-B	CENTRAL VALLEY WYE	SR 152 (NORTH) TO ROAD 19 WYE ALTERNATIVE	CIVIL PLAN	MER-FRE STA 14715+51.00 TO 14771+00
CV-S1420-B	CENTRAL VALLEY WYE	SR 152 (NORTH) TO ROAD 19 WYE ALTERNATIVE	CIVIL PLAN	MER-FRE STA 14771+00 TO 14827+00
CV-S1430-B	CENTRAL VALLEY WYE	SR 152 (NORTH) TO ROAD 19 WYE ALTERNATIVE	CIVIL PLAN	MER-FRE STA 14827+00 TO 14883+00
CV-S1440-B	CENTRAL VALLEY WYE	SR 152 (NORTH) TO ROAD 19 WYE ALTERNATIVE	CIVIL PLAN	MER-FRE STA 14883+00 TO 14939+00
CV-S1450-B	CENTRAL VALLEY WYE	SR 152 (NORTH) TO ROAD 19 WYE ALTERNATIVE	CIVIL PLAN	MER-FRE STA 14939+00 TO 14995+00
CV-S1460-B	CENTRAL VALLEY WYE	SR 152 (NORTH) TO ROAD 19 WYE ALTERNATIVE	CIVIL PLAN	MER-FRE STA 14995+00 TO 15051+00
CV-S1470-B	CENTRAL VALLEY WYE	SR 152 (NORTH) TO ROAD 19 WYE ALTERNATIVE	CIVIL PLAN	MER-FRE STA 15051+00 TO 15107+00
CV-S1471-B	CENTRAL VALLEY WYE	SR 152 (NORTH) TO ROAD 19 WYE ALTERNATIVE	CIVIL PLAN	SJD-FRE ACCESS ROAD
CV-S1480-B	CENTRAL VALLEY WYE	SR 152 (NORTH) TO ROAD 19 WYE ALTERNATIVE	CIVIL PLAN	MER-FRE STA 15107+00 TO 15163+00
CV-S1490-B	CENTRAL VALLEY WYE	SR 152 (NORTH) TO ROAD 19 WYE ALTERNATIVE	CIVIL PLAN	MER-FRE STA 15163+00 TO 15219+00
CV-S1500-B	CENTRAL VALLEY WYE	SR 152 (NORTH) TO ROAD 19 WYE ALTERNATIVE	CIVIL PLAN	MER-FRE STA 15219+00 TO 15275+00
CV-S1510-B	CENTRAL VALLEY WYE	SR 152 (NORTH) TO ROAD 19 WYE ALTERNATIVE	CIVIL PLAN	MER-FRE STA 15275+00 TO 15331+00
CV-S1520-B	CENTRAL VALLEY WYE	SR 152 (NORTH) TO ROAD 19 WYE ALTERNATIVE	CIVIL PLAN	MER-FRE STA 15331+00 TO 15387+00
CV-S1530-B	CENTRAL VALLEY WYE	SR 152 (NORTH) TO ROAD 19 WYE ALTERNATIVE	CIVIL PLAN	MER-FRE STA 15387+00 TO 15443+00
CV-S1540-B	CENTRAL VALLEY WYE	SR 152 (NORTH) TO ROAD 19 WYE ALTERNATIVE	CIVIL PLAN	MER-FRE STA 15443+00 TO 15499+00
CV-S1550-B	CENTRAL VALLEY WYE	SR 152 (NORTH) TO ROAD 19 WYE ALTERNATIVE	CIVIL PLAN	MER-FRE STA 15499+00 TO 15555+00
CV-S1560-B	CENTRAL VALLEY WYE	SR 152 (NORTH) TO ROAD 19 WYE ALTERNATIVE	CIVIL PLAN	MER-FRE STA 15555+00 TO 15611+00
CV-S1570-B	CENTRAL VALLEY WYE	SR 152 (NORTH) TO ROAD 19 WYE ALTERNATIVE	CIVIL PLAN	MER-FRE STA 15611+00 TO 15655+00
CV-S1610-B	CENTRAL VALLEY WYE	SR 152 (NORTH) TO ROAD 19 WYE ALTERNATIVE	CIVIL PLAN	SJD-MER STA 36570+00 TO 36626+00
CV-S1620-B	CENTRAL VALLEY WYE	SR 152 (NORTH) TO ROAD 19 WYE ALTERNATIVE	CIVIL PLAN	SJD-MER STA 36626+00 TO 36682+00
CV-S1630-B	CENTRAL VALLEY WYE	SR 152 (NORTH) TO ROAD 19 WYE ALTERNATIVE	CIVIL PLAN	SJD-MER STA 36682+00 TO 36738+00
CV-S1640-B	CENTRAL VALLEY WYE	SR 152 (NORTH) TO ROAD 19 WYE ALTERNATIVE	CIVIL PLAN	SJD-MER STA 36738+00 TO 36794+00
CV-S1650-B	CENTRAL VALLEY WYE	SR 152 (NORTH) TO ROAD 19 WYE ALTERNATIVE	CIVIL PLAN	SJD-MER STA 36794+00 TO 36850+00
CV-S1660-B	CENTRAL VALLEY WYE	SR 152 (NORTH) TO ROAD 19 WYE ALTERNATIVE	CIVIL PLAN	SJD-MER STA 36850+00 TO 36857+29

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2000 RE	V DATE	вү снк	APP	DESCRIPTION	DATE 09/09/2016			HIGH-SPEED RAIL AUTHORITY	
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# NIA HIGH-SPEED TRAIN PROJECT MERCED TO FRESNO SECTION CENTRAL VALLEY WYE CIVIL AND GRADE SEPARATION PLANS INDEX OF DRAWINGS

SHEET 7 OF 17

CONTRACT NO. HSR08-05

DRAWING NO. CV-B0008

SCALE NO SCALE

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CV-R1031-B	CENTRAL VALLEY WYE	SR 152 (NORTH) TO ROAD 19 WYE ALTERNATIVE	PLAN AND PROFILE	HENR	Y MILLER ROAD REALIGNMENT	
CV-R1032-B	CENTRAL VALLEY WYE	SR 152 (NORTH) TO ROAD 19 WYE ALTERNATIVE	PLAN AND PROFILE	HENR	Y MILLER ROAD REALIGNMENT	
CV-R1033-B	CENTRAL VALLEY WYE	SR 152 (NORTH) TO ROAD 19 WYE ALTERNATIVE	PLAN AND PROFILE	HENR	Y MILLER ROAD REALIGNMENT	
CV-R1050-B	CENTRAL VALLEY WYE	SR 152 (NORTH) TO ROAD 19 WYE ALTERNATIVE	PLAN AND PROFILE	INDIA	ANA ROAD GRADE SEPARATION	
CV-R1051-B	CENTRAL VALLEY WYE	SR 152 (NORTH) TO ROAD 19 WYE ALTERNATIVE	PLAN AND PROFILE	INDIA	ANA ROAD GRADE SEPARATION	
CV-R1090-B	CENTRAL VALLEY WYE	SR 152 (NORTH) TO ROAD 19 WYE ALTERNATIVE	PLAN AND PROFILE	CC	OYOTE ROAD REALIGNMENT	
CV-R1091-B	CENTRAL VALLEY WYE	SR 152 (NORTH) TO ROAD 19 WYE ALTERNATIVE	PLAN AND PROFILE	CC	OYOTE ROAD REALIGNMENT	
CV-R1100-B	CENTRAL VALLEY WYE	SR 152 (NORTH) TO ROAD 19 WYE ALTERNATIVE	PLAN AND PROFILE	SR	152 REALIGNMENT AT SR 59	
CV-R1101-B	CENTRAL VALLEY WYE	SR 152 (NORTH) TO ROAD 19 WYE ALTERNATIVE	PLAN AND PROFILE	SR	152 REALIGNMENT AT SR 59	
CV-R1102-B	CENTRAL VALLEY WYE	SR 152 (NORTH) TO ROAD 19 WYE ALTERNATIVE	PLAN AND PROFILE	SR	152 REALIGNMENT AT SR 59	
CV-R1103-B	CENTRAL VALLEY WYE	SR 152 (NORTH) TO ROAD 19 WYE ALTERNATIVE	PLAN AND PROFILE	SR	152 REALIGNMENT AT SR 59	
CV-R1104-B	CENTRAL VALLEY WYE	SR 152 (NORTH) TO ROAD 19 WYE ALTERNATIVE	PLAN AND PROFILE	SR 59/SR 1	52 EB OFF RAMP GRADE SEPARATION	
CV-R1105-B	CENTRAL VALLEY WYE	SR 152 (NORTH) TO ROAD 19 WYE ALTERNATIVE	PLAN AND PROFILE	SR 59/SR 1	52 EB OFF RAMP GRADE SEPARATION	
CV-R1106-B	CENTRAL VALLEY WYE	SR 152 (NORTH) TO ROAD 19 WYE ALTERNATIVE	PLAN AND PROFILE	SR 59/SR -	152 WB ON RAMP GRADE SEPARATION	
CV-R1107-B	CENTRAL VALLEY WYE	SR 152 (NORTH) TO ROAD 19 WYE ALTERNATIVE	PLAN AND PROFILE	SR 59/SR -	152 WB ON RAMP GRADE SEPARATION	
CV-R1108-B	CENTRAL VALLEY WYE	SR 152 (NORTH) TO ROAD 19 WYE ALTERNATIVE	PLAN AND PROFILE	SR 59/SR 1	52 WB OFF RAMP GRADE SEPARATION	
CV-R1109-B	CENTRAL VALLEY WYE	SR 152 (NORTH) TO ROAD 19 WYE ALTERNATIVE	PLAN AND PROFILE	SR 59/SR 1	52 WB OFF RAMP GRADE SEPARATION	
CV-R1110-B	CENTRAL VALLEY WYE	SR 152 (NORTH) TO ROAD 19 WYE ALTERNATIVE	PLAN AND PROFILE	SR 5	59/SR 152 EB LOOP ON RAMP	
CV-R1111-B	CENTRAL VALLEY WYE	SR 152 (NORTH) TO ROAD 19 WYE ALTERNATIVE	PLAN AND PROFILE	ROAD 4/L	INCOLN ROAD GRADE SEPARATION	
CV-R1112-B	CENTRAL VALLEY WYE	SR 152 (NORTH) TO ROAD 19 WYE ALTERNATIVE	PLAN AND PROFILE	ROAD 4/L	INCOLN ROAD GRADE SEPARATION	
CV-R1160-B	CENTRAL VALLEY WYE	SR 152 (NORTH) TO ROAD 19 WYE ALTERNATIVE	PLAN AND PROFILE	ROAD 9/H	HEMLOCK ROAD GRADE SEPARATION	
CV-R1161-B	CENTRAL VALLEY WYE	SR 152 (NORTH) TO ROAD 19 WYE ALTERNATIVE	PLAN AND PROFILE	ROAD 9/H	HEMLOCK ROAD GRADE SEPARATION	
CV-R1162-B	CENTRAL VALLEY WYE	SR 152 (NORTH) TO ROAD 19 WYE ALTERNATIVE	PLAN AND PROFILE	SR 1	152 REALIGNMENT AT ROAD 9	
CV-R1163-B	CENTRAL VALLEY WYE	SR 152 (NORTH) TO ROAD 19 WYE ALTERNATIVE	PLAN AND PROFILE	SR 1	152 REALIGNMENT AT ROAD 9	
CV-R1164-B	CENTRAL VALLEY WYE	SR 152 (NORTH) TO ROAD 19 WYE ALTERNATIVE	PLAN AND PROFILE	SR 1	152 REALIGNMENT AT ROAD 9	
CV-R1165-B	CENTRAL VALLEY WYE	SR 152 (NORTH) TO ROAD 19 WYE ALTERNATIVE	PLAN AND PROFILE	RO	AD 9/SR 152 EB OFF RAMP	
CV-R1166-B	CENTRAL VALLEY WYE	SR 152 (NORTH) TO ROAD 19 WYE ALTERNATIVE	PLAN AND PROFILE	RC	DAD 9/SR 152 EB ON RAMP	
CV-R1167-B	CENTRAL VALLEY WYE	SR 152 (NORTH) TO ROAD 19 WYE ALTERNATIVE	PLAN AND PROFILE	R	OAD 9/SR 152 LOOP RAMP	
CV-R1168-B	CENTRAL VALLEY WYE	SR 152 (NORTH) TO ROAD 19 WYE ALTERNATIVE	PLAN AND PROFILE	RC	DAD 9/SR 152 WB ON RAMP	
CV-R1169-B	CENTRAL VALLEY WYE	SR 152 (NORTH) TO ROAD 19 WYE ALTERNATIVE	PLAN AND PROFILE	RO	AD 9/SR 152 WB OFF RAMP	
CV-R1190-B	CENTRAL VALLEY WYE	SR 152 (NORTH) TO ROAD 19 WYE ALTERNATIVE	PLAN AND PROFILE	ROAD 1	2/ELM ROAD GRADE SEPARATION	
CV-R1191-B	CENTRAL VALLEY WYE	SR 152 (NORTH) TO ROAD 19 WYE ALTERNATIVE	PLAN AND PROFILE	ROAD 1	2/ELM ROAD GRADE SEPARATION	
CV-R1200-B	CENTRAL VALLEY WYE	SR 152 (NORTH) TO ROAD 19 WYE ALTERNATIVE	PLAN AND PROFILE	SR 1	152 REALIGNMENT AT SR 233	
CV-R1201-B	CENTRAL VALLEY WYE	SR 152 (NORTH) TO ROAD 19 WYE ALTERNATIVE	PLAN AND PROFILE	SR 1	152 REALIGNMENT AT SR 233	
CV-R1202-B	CENTRAL VALLEY WYE	SR 152 (NORTH) TO ROAD 19 WYE ALTERNATIVE	PLAN AND PROFILE	SR 1	152 REALIGNMENT AT SR 233	
CV-R1203-B	CENTRAL VALLEY WYE	SR 152 (NORTH) TO ROAD 19 WYE ALTERNATIVE	PLAN AND PROFILE	SR	233/SR 152 EB OFF RAMP	
CV-R1204-B	CENTRAL VALLEY WYE	SR 152 (NORTH) TO ROAD 19 WYE ALTERNATIVE	PLAN AND PROFILE	SR	233/SR 152 EB LOOP RAMP	
CV-R1205-B	CENTRAL VALLEY WYE	SR 152 (NORTH) TO ROAD 19 WYE ALTERNATIVE	PLAN AND PROFILE	SF	R 233/SR 152 WB ON RAMP	
CV-R1210-B	CENTRAL VALLEY WYE	SR 152 (NORTH) TO ROAD 19 WYE ALTERNATIVE	PLAN AND PROFILE	SR 233/RC	DBERTSON BLVD GRADE SEPARATION	
CV-R1211-B	CENTRAL VALLEY WYE	SR 152 (NORTH) TO ROAD 19 WYE ALTERNATIVE	PLAN AND PROFILE	SR 233/RC	DBERTSON BLVD GRADE SEPARATION	
		DESIGNED BY S. WELLS DRAWN BY W. JOHNSEN CHECKED BY J. RAY IN CHARGE C. LEMLEY CONSTRUCTION		IFORNIA EED RAIL AUTHORITY	CALIFORNIA HIGH-SPEED TRAIN PROJECT MERCED TO FRESNO SECTION CENTRAL VALLEY WYE CIVIL AND GRADE SEPARATION PLANS INDEX OF DRAWINGS SHEET 8 OF 17	CONTR HS DRAWII C\ SCALE NC SHEET

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SR 233/SR 152 EI	PLAN AND PROFILE	SR 152 (NORTH) TO ROAD 19 WYE ALTERNATIVE	CENTRAL VALLEY WYE	CV-R1213-B
SR 233/SR 152 WB	PLAN AND PROFILE	SR 152 (NORTH) TO ROAD 19 WYE ALTERNATIVE	CENTRAL VALLEY WYE	CV-R1214-B
CATES COURT REA	PLAN AND PROFILE	SR 152 (NORTH) TO ROAD 19 WYE ALTERNATIVE	CENTRAL VALLEY WYE	CV-R1215-B
SR 152 REALIGNMENT	PLAN AND PROFILE	SR 152 (NORTH) TO ROAD 19 WYE ALTERNATIVE	CENTRAL VALLEY WYE	CV-R1224-B
SR 152 REALIGNMENT	PLAN AND PROFILE	SR 152 (NORTH) TO ROAD 19 WYE ALTERNATIVE	CENTRAL VALLEY WYE	CV-R1225-B
SR 152 REALIGNMENT	PLAN AND PROFILE	SR 152 (NORTH) TO ROAD 19 WYE ALTERNATIVE	CENTRAL VALLEY WYE	CV-R1226-B
ROAD 16/SR 152 EI	PLAN AND PROFILE	SR 152 (NORTH) TO ROAD 19 WYE ALTERNATIVE	CENTRAL VALLEY WYE	CV-R1227-B
ROAD 16/SR 152 EI	PLAN AND PROFILE	SR 152 (NORTH) TO ROAD 19 WYE ALTERNATIVE	CENTRAL VALLEY WYE	CV-R1228-B
ROAD 16/SR 152 W	PLAN AND PROFILE	SR 152 (NORTH) TO ROAD 19 WYE ALTERNATIVE	CENTRAL VALLEY WYE	CV-R1229-B
ROAD 16/BERENDA WAY G	PLAN AND PROFILE	SR 152 (NORTH) TO ROAD 19 WYE ALTERNATIVE	CENTRAL VALLEY WYE	CV-R1230-B
ROAD 16/BERENDA WAY G	PLAN AND PROFILE	SR 152 (NORTH) TO ROAD 19 WYE ALTERNATIVE	CENTRAL VALLEY WYE	CV-R1231-B
ROAD 16/SR 152 E	PLAN AND PROFILE	SR 152 (NORTH) TO ROAD 19 WYE ALTERNATIVE	CENTRAL VALLEY WYE	CV-R1232-B
ROAD 16/SR 152 EB	PLAN AND PROFILE	SR 152 (NORTH) TO ROAD 19 WYE ALTERNATIVE	CENTRAL VALLEY WYE	CV-R1233-B
ROAD 16/SR 152 W	PLAN AND PROFILE	SR 152 (NORTH) TO ROAD 19 WYE ALTERNATIVE	CENTRAL VALLEY WYE	CV-R1234-B
ROAD 16 CONNECTOR	PLAN AND PROFILE	SR 152 (NORTH) TO ROAD 19 WYE ALTERNATIVE	CENTRAL VALLEY WYE	CV-R1235-B
ROAD 17 1/2 GRADE	PLAN AND PROFILE	SR 152 (NORTH) TO ROAD 19 WYE ALTERNATIVE	CENTRAL VALLEY WYE	CV-R1240-B
ROAD 17 1/2 GRADE	PLAN AND PROFILE	SR 152 (NORTH) TO ROAD 19 WYE ALTERNATIVE	CENTRAL VALLEY WYE	CV-R1241-B
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ROAD 20 GRADE SE	PLAN AND PROFILE	SR 152 (NORTH) TO ROAD 19 WYE ALTERNATIVE	CENTRAL VALLEY WYE	CV-R1261-B
ROAD 22 GRADE SE	PLAN AND PROFILE	SR 152 (NORTH) TO ROAD 19 WYE ALTERNATIVE	CENTRAL VALLEY WYE	CV-R1280-B
ROAD 22 GRADE SE	PLAN AND PROFILE	SR 152 (NORTH) TO ROAD 19 WYE ALTERNATIVE	CENTRAL VALLEY WYE	CV-R1281-B
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ROAD 24 REALI	PLAN AND PROFILE	SR 152 (NORTH) TO ROAD 19 WYE ALTERNATIVE	CENTRAL VALLEY WYE	CV-R1311-B
ROAD 24 REALI	PLAN AND PROFILE	SR 152 (NORTH) TO ROAD 19 WYE ALTERNATIVE	CENTRAL VALLEY WYE	CV-R1312-B
AVENUE 20 1/2 GRADI	PLAN AND PROFILE	SR 152 (NORTH) TO ROAD 19 WYE ALTERNATIVE	CENTRAL VALLEY WYE	CV-R1313-B
AVENUE 20 1/2 GRADI	PLAN AND PROFILE	SR 152 (NORTH) TO ROAD 19 WYE ALTERNATIVE	CENTRAL VALLEY WYE	CV-R1314-B
AVENUE 20 REAL	PLAN AND PROFILE	SR 152 (NORTH) TO ROAD 19 WYE ALTERNATIVE	CENTRAL VALLEY WYE	CV-R1320-B
AVENUE 20 REAL	PLAN AND PROFILE	SR 152 (NORTH) TO ROAD 19 WYE ALTERNATIVE	CENTRAL VALLEY WYE	CV-R1321-B
ROAD 19 1/2 AND FAIRLANE	PLAN AND PROFILE	SR 152 (NORTH) TO ROAD 19 WYE ALTERNATIVE	CENTRAL VALLEY WYE	CV-R1420-B
ROAD 19 REALI	PLAN AND PROFILE	SR 152 (NORTH) TO ROAD 19 WYE ALTERNATIVE	CENTRAL VALLEY WYE	CV-R1460-B
ROAD 19 REALI	PLAN AND PROFILE	SR 152 (NORTH) TO ROAD 19 WYE ALTERNATIVE	CENTRAL VALLEY WYE	CV-R1461-B
MINTURN ROAD/ROAD 15 G	PLAN AND PROFILE	SR 152 (NORTH) TO ROAD 19 WYE ALTERNATIVE	CENTRAL VALLEY WYE	CV-R1510-B
MINTURN ROAD/ROAD 15 G	PLAN AND PROFILE	SR 152 (NORTH) TO ROAD 19 WYE ALTERNATIVE	CENTRAL VALLEY WYE	CV-R1511-B
MINTURN ROAD/ROAD 15 G	PLAN AND PROFILE	SR 152 (NORTH) TO ROAD 19 WYE ALTERNATIVE	CENTRAL VALLEY WYE	CV-R1512-B
FRONTAGE ROAD AT M	PLAN AND PROFILE	SR 152 (NORTH) TO ROAD 19 WYE ALTERNATIVE	CENTRAL VALLEY WYE	CV-R1513-B
GENERAL NO	STAGE CONSTRUCTION PLAN	SR 152 (NORTH) TO ROAD 19 WYE ALTERNATIVE	CENTRAL VALLEY WYE	CV-I0001-B
SR 59/SR 152 ST/	STAGE CONSTRUCTION PLAN	SR 152 (NORTH) TO ROAD 19 WYE ALTERNATIVE	CENTRAL VALLEY WYE	СV-I4100-В
SR 59/SR 152 STA	STAGE CONSTRUCTION PLAN	SR 152 (NORTH) TO ROAD 19 WYE ALTERNATIVE	CENTRAL VALLEY WYE	CV-I4101-B
		DESIGNED BY		
CALIFOR		DRAWN BY LLS RECORD SET		
	ARSONS	W. JUHNSEN BURMITTAL		
	CALI	UN CHARGE NOT FOR C. LEMLEY CONSTRUCTION		
D RAIL AUTHORITY	I V HIGH-SPEEL			1

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CENTRAL VALLEY WYE CIVIL AND GRADE SEPARATION PLANS	
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	INDEX OF DRAWINGS			
DESCRIPTIO	TITLE	ALIGNMENT / PLAN SET	SECTION	DRAWING NO.
SR 59/SR 152 STA	STAGE CONSTRUCTION PLAN	SR 152 (NORTH) TO ROAD 19 WYE ALTERNATIVE	CENTRAL VALLEY WYE	CV-I4102-B
SR 59/SR 152 STA	STAGE CONSTRUCTION PLAN	SR 152 (NORTH) TO ROAD 19 WYE ALTERNATIVE	CENTRAL VALLEY WYE	CV-I4103-B
ROAD 9/SR 152 ST	STAGE CONSTRUCTION PLAN	SR 152 (NORTH) TO ROAD 19 WYE ALTERNATIVE	CENTRAL VALLEY WYE	CV-I4160-B
ROAD 9/SR 152 STA	STAGE CONSTRUCTION PLAN	SR 152 (NORTH) TO ROAD 19 WYE ALTERNATIVE	CENTRAL VALLEY WYE	CV-I4161-B
ROAD 9/SR 152 STA	STAGE CONSTRUCTION PLAN	SR 152 (NORTH) TO ROAD 19 WYE ALTERNATIVE	CENTRAL VALLEY WYE	CV-I4162-B
ROAD 9/SR 152 STA	STAGE CONSTRUCTION PLAN	SR 152 (NORTH) TO ROAD 19 WYE ALTERNATIVE	CENTRAL VALLEY WYE	CV-I4163-B
SR 233/SR 152 ST	STAGE CONSTRUCTION PLAN	SR 152 (NORTH) TO ROAD 19 WYE ALTERNATIVE	CENTRAL VALLEY WYE	CV-I4210-B
SR 233/SR 152 STA	STAGE CONSTRUCTION PLAN	SR 152 (NORTH) TO ROAD 19 WYE ALTERNATIVE	CENTRAL VALLEY WYE	CV-I4211-B
SR 233/SR 152 STA	STAGE CONSTRUCTION PLAN	SR 152 (NORTH) TO ROAD 19 WYE ALTERNATIVE	CENTRAL VALLEY WYE	CV-I4212-B
SR 233/SR 152 STA	STAGE CONSTRUCTION PLAN	SR 152 (NORTH) TO ROAD 19 WYE ALTERNATIVE	CENTRAL VALLEY WYE	CV-I4213-B
SR 233/SR 152 STA	STAGE CONSTRUCTION PLAN	SR 152 (NORTH) TO ROAD 19 WYE ALTERNATIVE	CENTRAL VALLEY WYE	CV-I4214-B
ROAD 16/SR 152 ST	STAGE CONSTRUCTION PLAN	SR 152 (NORTH) TO ROAD 19 WYE ALTERNATIVE	CENTRAL VALLEY WYE	CV-I4230-B
ROAD 16/SR 152 ST	STAGE CONSTRUCTION PLAN	SR 152 (NORTH) TO ROAD 19 WYE ALTERNATIVE	CENTRAL VALLEY WYE	CV-I4231-B
ROAD 16/SR 152 ST	STAGE CONSTRUCTION PLAN	SR 152 (NORTH) TO ROAD 19 WYE ALTERNATIVE	CENTRAL VALLEY WYE	CV-I4232-B
ROAD 16/SR 152 ST	STAGE CONSTRUCTION PLAN	SR 152 (NORTH) TO ROAD 19 WYE ALTERNATIVE	CENTRAL VALLEY WYE	CV-I4233-B
SR 99 TUNNEL STA	STAGE CONSTRUCTION PLAN	SR 152 (NORTH) TO ROAD 19 WYE ALTERNATIVE	CENTRAL VALLEY WYE	CV-I4520-B
SR 99 TUNNEL STA	STAGE CONSTRUCTION PLAN	SR 152 (NORTH) TO ROAD 19 WYE ALTERNATIVE	CENTRAL VALLEY WYE	CV-I4521-B
SR 99 TUNNEL STA	STAGE CONSTRUCTION PLAN	SR 152 (NORTH) TO ROAD 19 WYE ALTERNATIVE	CENTRAL VALLEY WYE	CV-I4522-B
SR 99 TUNNEL STA	STAGE CONSTRUCTION PLAN	SR 152 (NORTH) TO ROAD 19 WYE ALTERNATIVE	CENTRAL VALLEY WYE	CV-I4523-B
	TO ROAD 13 WYE ALTERNATIVE	AVENUE 21		
SHEET 1 OF	KEY MAP	AVENUE 21 TO ROAD 13 WYE ALTERNATIVE	CENTRAL VALLEY WYE	CV-B4050-C
SHEET 2 OF	KEY MAP	AVENUE 21 TO ROAD 13 WYE ALTERNATIVE	CENTRAL VALLEY WYE	CV-B4051-C
SHEET 3 OF	KEY MAP	AVENUE 21 TO ROAD 13 WYE ALTERNATIVE	CENTRAL VALLEY WYE	CV-B4052-C
SHEET 4 OF	KEY MAP	AVENUE 21 TO ROAD 13 WYE ALTERNATIVE	CENTRAL VALLEY WYE	CV-B4053-C
SHEET 1 OF	GEOMETRY DATA TABLE	AVENUE 21 TO ROAD 13 WYE ALTERNATIVE	CENTRAL VALLEY WYE	CV-B0060-C
SHEET 2 OF	GEOMETRY DATA TABLE	AVENUE 21 TO ROAD 13 WYE ALTERNATIVE	CENTRAL VALLEY WYE	CV-B0061-C
SHEET 1 OF	UTILITY CONFLICT TABLE	AVENUE 21 TO ROAD 13 WYE ALTERNATIVE	CENTRAL VALLEY WYE	CV-B0070-C
SHEET 2 OF	UTILITY CONFLICT TABLE	AVENUE 21 TO ROAD 13 WYE ALTERNATIVE	CENTRAL VALLEY WYE	CV-B0071-C
SHEET 3 OF	UTILITY CONFLICT TABLE	AVENUE 21 TO ROAD 13 WYE ALTERNATIVE	CENTRAL VALLEY WYE	CV-B0072-C
SHEET 4 OF	UTILITY CONFLICT TABLE	AVENUE 21 TO ROAD 13 WYE ALTERNATIVE	CENTRAL VALLEY WYE	CV-B0073-C
SHEET 1 OF	TYPICAL SECTION	AVENUE 21 TO ROAD 13 WYE ALTERNATIVE	CENTRAL VALLEY WYE	CV-B0080-C
SHEET 2 OF	TYPICAL SECTION	AVENUE 21 TO ROAD 13 WYE ALTERNATIVE	CENTRAL VALLEY WYE	CV-B0081-C
SJD-FRE STA 5338+00	CIVIL PLAN	AVENUE 21 TO ROAD 13 WYE ALTERNATIVE	CENTRAL VALLEY WYE	CV-S1010-C
SJD-FRE STA 5394+00	CIVIL PLAN	AVENUE 21 TO ROAD 13 WYE ALTERNATIVE	CENTRAL VALLEY WYE	CV-S1020-C
SJD-FRE STA 5450+00	CIVIL PLAN	AVENUE 21 TO ROAD 13 WYE ALTERNATIVE	CENTRAL VALLEY WYE	CV-S1030-C
SJD-FRE ACCESS	CIVIL PLAN	AVENUE 21 TO ROAD 13 WYE ALTERNATIVE	CENTRAL VALLEY WYE	CV-S1031-C
SJD-FRE STA 5506+00	CIVIL PLAN	AVENUE 21 TO ROAD 13 WYE ALTERNATIVE	CENTRAL VALLEY WYE	CV-S1040-C
SJD-FRE STA 5562+00	CIVIL PLAN	AVENUE 21 TO ROAD 13 WYE ALTERNATIVE	CENTRAL VALLEY WYE	CV-S1050-C
SJD-FRE STA 5618+00	CIVIL PLAN	AVENUE 21 TO ROAD 13 WYE ALTERNATIVE	CENTRAL VALLEY WYE	CV-S1060-C
SJD-FRE STA 5674+00	CIVIL PLAN	AVENUE 21 TO ROAD 13 WYE ALTERNATIVE	CENTRAL VALLEY WYE	CV-S1070-C
SJD-FRE STA 5730+00	CIVIL PLAN	AVENUE 21 TO ROAD 13 WYE ALTERNATIVE	CENTRAL VALLEY WYE	CV-S1080-C
CALIFORM		S. WELLS RECORD SET		
M		DRAWN BY W. JOHNSEN SUBMITTAL		
	ARSONS			
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	CONTRACT NO.
NIA HIGH-SPEED TRAIN PROJ Merced to Fresno Section	ECI HSR08-05
CENTRAL VALLEY WYE	DRAWING NO. CV-B0011
CIVIL AND GRADE SEPARATION PLANS	SCALE NO SCALE
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		INDE	X OF DRAWINGS		
DRAWING NO.	SECTION	ALIGNMENT / PLAN SET	TITLE	DESCRIPTION	
CV-S1090-C	CENTRAL VALLEY WYE	AVENUE 21 TO ROAD 13 WYE ALTERNATIVE	CIVIL PLAN	SJD-FRE STA 5786+00 TO 5842+00	
CV-S1100-C	CENTRAL VALLEY WYE	AVENUE 21 TO ROAD 13 WYE ALTERNATIVE	CIVIL PLAN	SJD-FRE STA 5842+00 TO 5898+00	
CV-S1110-C	CENTRAL VALLEY WYE	AVENUE 21 TO ROAD 13 WYE ALTERNATIVE	CIVIL PLAN	SJD-FRE STA 5898+00 TO 5954+00	
CV-S1120-C	CENTRAL VALLEY WYE	AVENUE 21 TO ROAD 13 WYE ALTERNATIVE	CIVIL PLAN	SJD-FRE STA 5954+00 TO 6010+00	
CV-S1121-C	CENTRAL VALLEY WYE	AVENUE 21 TO ROAD 13 WYE ALTERNATIVE	CIVIL PLAN	SJD-FRE ACCESS ROAD	
CV-S1130-C	CENTRAL VALLEY WYE	AVENUE 21 TO ROAD 13 WYE ALTERNATIVE	CIVIL PLAN	SJD-FRE STA 6010+00 TO 6066+00	
CV-S1140-C	CENTRAL VALLEY WYE	AVENUE 21 TO ROAD 13 WYE ALTERNATIVE	CIVIL PLAN	SJD-FRE STA 6066+00 TO 6122+00	
CV-S1150-C	CENTRAL VALLEY WYE	AVENUE 21 TO ROAD 13 WYE ALTERNATIVE	CIVIL PLAN	SJD-FRE STA 6122+00 TO 6178+00	
CV-S1160-C	CENTRAL VALLEY WYE	AVENUE 21 TO ROAD 13 WYE ALTERNATIVE	CIVIL PLAN	SJD-FRE STA 6178+00 TO 6234+00	
CV-S1161-C	CENTRAL VALLEY WYE	AVENUE 21 TO ROAD 13 WYE ALTERNATIVE	CIVIL PLAN	SJD-FRE ACCESS ROAD	
CV-S1170-C	CENTRAL VALLEY WYE	AVENUE 21 TO ROAD 13 WYE ALTERNATIVE	CIVIL PLAN	SJD-FRE STA 6234+00 TO 6290+00	
CV-S1180-C	CENTRAL VALLEY WYE	AVENUE 21 TO ROAD 13 WYE ALTERNATIVE	CIVIL PLAN	SJD-FRE STA 6290+00 TO 6346+00	
CV-S1190-C	CENTRAL VALLEY WYE	AVENUE 21 TO ROAD 13 WYE ALTERNATIVE	CIVIL PLAN	SJD-FRE STA 6346+00 TO 6402+00	
CV-S1200-C	CENTRAL VALLEY WYE	AVENUE 21 TO ROAD 13 WYE ALTERNATIVE	CIVIL PLAN	SJD-FRE STA 6402+00 TO 6458+00	
CV-S1210-C	CENTRAL VALLEY WYE	AVENUE 21 TO ROAD 13 WYE ALTERNATIVE	CIVIL PLAN	SJD-FRE STA 6458+00 TO 6514+00	
CV-S1220-C	CENTRAL VALLEY WYE	AVENUE 21 TO ROAD 13 WYE ALTERNATIVE	CIVIL PLAN	SJD-FRE STA 6514+00 TO 6570+00	
CV-S1230-C	CENTRAL VALLEY WYE	AVENUE 21 TO ROAD 13 WYE ALTERNATIVE	CIVIL PLAN	SJD-FRE STA 6570+00 TO 6626+00	
CV-S1231-C	CENTRAL VALLEY WYE	AVENUE 21 TO ROAD 13 WYE ALTERNATIVE	CIVIL PLAN	SJD-FRE ACCESS ROAD	
CV-S1240-C	CENTRAL VALLEY WYE	AVENUE 21 TO ROAD 13 WYE ALTERNATIVE	CIVIL PLAN	SJD-FRE STA 6626+00 TO 6682+00	
CV-S1250-C	CENTRAL VALLEY WYE	AVENUE 21 TO ROAD 13 WYE ALTERNATIVE	CIVIL PLAN	SJD-FRE STA 6682+00 TO 6738+00	
CV-S1260-C	CENTRAL VALLEY WYE	AVENUE 21 TO ROAD 13 WYE ALTERNATIVE	CIVIL PLAN	SJD-FRE STA 6738+00 TO 6794+00	
CV-S1261-C	CENTRAL VALLEY WYE	AVENUE 21 TO ROAD 13 WYE ALTERNATIVE	CIVIL PLAN	SJD-FRE ACCESS ROAD	
CV-S1270-C	CENTRAL VALLEY WYE	AVENUE 21 TO ROAD 13 WYE ALTERNATIVE	CIVIL PLAN	SJD-FRE STA 6794+00 TO 6850+00	
CV-S1280-C	CENTRAL VALLEY WYE	AVENUE 21 TO ROAD 13 WYE ALTERNATIVE	CIVIL PLAN	SJD-FRE STA 6850+00 TO 6906+00	
CV-S1290-C	CENTRAL VALLEY WYE	AVENUE 21 TO ROAD 13 WYE ALTERNATIVE	CIVIL PLAN	SJD-FRE STA 6906+00 TO 6962+00	
CV-S1291-C	CENTRAL VALLEY WYE	AVENUE 21 TO ROAD 13 WYE ALTERNATIVE	CIVIL PLAN	SJD-FRE ACCESS ROAD	
CV-S1300-C	CENTRAL VALLEY WYE	AVENUE 21 TO ROAD 13 WYE ALTERNATIVE	CIVIL PLAN	SJD-FRE STA 6962+00 TO 7018+00	
CV-S1310-C	CENTRAL VALLEY WYE	AVENUE 21 TO ROAD 13 WYE ALTERNATIVE	CIVIL PLAN	SJD-FRE STA 7018+00 TO 7074+00	
CV-S1320-C	CENTRAL VALLEY WYE	AVENUE 21 TO ROAD 13 WYE ALTERNATIVE	CIVIL PLAN	SJD-FRE STA 7074+00 TO 7130+00	
CV-S1330-C	CENTRAL VALLEY WYE	AVENUE 21 TO ROAD 13 WYE ALTERNATIVE	CIVIL PLAN	SJD-FRE STA 7130+00 TO 7147+86.07	
CV-S1410-C	CENTRAL VALLEY WYE	AVENUE 21 TO ROAD 13 WYE ALTERNATIVE	CIVIL PLAN	MER-FRE STA 14840+00 TO 14896+00	
CV-S1420-C	CENTRAL VALLEY WYE	AVENUE 21 TO ROAD 13 WYE ALTERNATIVE	CIVIL PLAN	MER-FRE STA 14896+00 TO 14952+00	
CV-S1430-C	CENTRAL VALLEY WYE	AVENUE 21 TO ROAD 13 WYE ALTERNATIVE	CIVIL PLAN	MER-FRE STA 14952+00 TO 15008+00	
CV-S1440-C	CENTRAL VALLEY WYE	AVENUE 21 TO ROAD 13 WYE ALTERNATIVE	CIVIL PLAN	MER-FRE STA 15008+00 TO 15064+00	
CV-S1450-C	CENTRAL VALLEY WYE	AVENUE 21 TO ROAD 13 WYE ALTERNATIVE	CIVIL PLAN	MER-FRE STA 15064+00 TO 15120+00	
CV-S1460-C	CENTRAL VALLEY WYE	AVENUE 21 TO ROAD 13 WYE ALTERNATIVE	CIVIL PLAN	MER-FRE STA 15120+00 TO 15176+00	
CV-S1470-C	CENTRAL VALLEY WYE	AVENUE 21 TO ROAD 13 WYE ALTERNATIVE	CIVIL PLAN	MER-FRE STA 15176+00 TO 15232+00	
CV-S1480-C	CENTRAL VALLEY WYE	AVENUE 21 TO ROAD 13 WYE ALTERNATIVE	CIVIL PLAN	MER-FRE STA 15232+00 TO 15288+00	
CV-S1490-C	CENTRAL VALLEY WYE	AVENUE 21 TO ROAD 13 WYE ALTERNATIVE	CIVIL PLAN	MER-FRE STA 15288+00 TO 15344+00	
CV-S1500-C	CENTRAL VALLEY WYE	AVENUE 21 TO ROAD 13 WYE ALTERNATIVE	CIVIL PLAN	MER-FRE STA 15344+00 TO 15400+00	
CV-S1510-C	CENTRAL VALLEY WYE	AVENUE 21 TO ROAD 13 WYE ALTERNATIVE	CIVIL PLAN	MER-FRE STA 15400+00 TO 15456+00	
		DESIGNED BY S. WELLS RECORD SET		CALIFORNIA HIGH-SPEED TRAIN PROJECT	CONTRACT N
		W. JOHNSEN 15% DESIGN		MERCED TO FRESNO SECTION	DRAWING NO. CV-BO
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DRAWING NO.	SECTION	ALIGNMENT / PLAN SET	TITLE	DESCRIPTION	
CV-S1520-C	CENTRAL VALLEY WYE	AVENUE 21 TO ROAD 13 WYE ALTERNATIVE	CIVIL PLAN	MER-FRE STA 15456+00 TO 15512+00	
CV-S1530-C	CENTRAL VALLEY WYE	AVENUE 21 TO ROAD 13 WYE ALTERNATIVE	CIVIL PLAN	MER-FRE STA 15512+00 TO 15568+00	
CV-S1540-C	CENTRAL VALLEY WYE	AVENUE 21 TO ROAD 13 WYE ALTERNATIVE	CIVIL PLAN	MER-FRE STA 15568+00 TO 15624+00	
CV-S1550-C	CENTRAL VALLEY WYE	AVENUE 21 TO ROAD 13 WYE ALTERNATIVE	CIVIL PLAN	MER-FRE STA 15624+00 TO 15655+00	
CV-S1610-C	CENTRAL VALLEY WYE	AVENUE 21 TO ROAD 13 WYE ALTERNATIVE	CIVIL PLAN	SJD-MER STA 36268+00 TO 36324+00	
CV-S1620-C	CENTRAL VALLEY WYE	AVENUE 21 TO ROAD 13 WYE ALTERNATIVE	CIVIL PLAN	SJD-MER STA 36324+00 TO 36380+00	
CV-S1630-C	CENTRAL VALLEY WYE	AVENUE 21 TO ROAD 13 WYE ALTERNATIVE	CIVIL PLAN	SJD-MER STA 36380+00 TO 36436+00	
CV-S1640-C	CENTRAL VALLEY WYE	AVENUE 21 TO ROAD 13 WYE ALTERNATIVE	CIVIL PLAN	SJD-MER STA 36436+00 TO 36492+00	
CV-S1650-C	CENTRAL VALLEY WYE	AVENUE 21 TO ROAD 13 WYE ALTERNATIVE	CIVIL PLAN	SJD-MER STA 36492+00 TO 36548+00	
CV-S1660-C	CENTRAL VALLEY WYE	AVENUE 21 TO ROAD 13 WYE ALTERNATIVE	CIVIL PLAN	SJD-MER STA 36548+00 TO 36567+19	
CV-R1030-C	CENTRAL VALLEY WYE	AVENUE 21 TO ROAD 13 WYE ALTERNATIVE	PLAN AND PROFILE	HENRY MILLER ROAD REALIGNMENT	
CV-R1031-C	CENTRAL VALLEY WYE	AVENUE 21 TO ROAD 13 WYE ALTERNATIVE	PLAN AND PROFILE	HENRY MILLER ROAD REALIGNMENT	
CV-R1032-C	CENTRAL VALLEY WYE	AVENUE 21 TO ROAD 13 WYE ALTERNATIVE	PLAN AND PROFILE	HENRY MILLER ROAD REALIGNMENT	
CV-R1033-C	CENTRAL VALLEY WYE	AVENUE 21 TO ROAD 13 WYE ALTERNATIVE	PLAN AND PROFILE	HENRY MILLER ROAD REALIGNMENT	
CV-R1050-C	CENTRAL VALLEY WYE	AVENUE 21 TO ROAD 13 WYE ALTERNATIVE	PLAN AND PROFILE	INDIANA ROAD GRADE SEPARATION	
CV-R1051-C	CENTRAL VALLEY WYE	AVENUE 21 TO ROAD 13 WYE ALTERNATIVE	PLAN AND PROFILE	INDIANA ROAD GRADE SEPARATION	
CV-R1052-C	CENTRAL VALLEY WYE	AVENUE 21 TO ROAD 13 WYE ALTERNATIVE	PLAN AND PROFILE	HUTCHINS ROAD CONNECTOR	
CV-R1053-C	CENTRAL VALLEY WYE	AVENUE 21 TO ROAD 13 WYE ALTERNATIVE	PLAN AND PROFILE	HUTCHINS ROAD REALIGNMENT	
CV-R1054-C	CENTRAL VALLEY WYE	AVENUE 21 TO ROAD 13 WYE ALTERNATIVE	PLAN AND PROFILE	HUTCHINS ROAD REALIGNMENT	
CV-R1120-C	CENTRAL VALLEY WYE	AVENUE 21 TO ROAD 13 WYE ALTERNATIVE	PLAN AND PROFILE	ROAD 4/LINCOLN ROAD GRADE SEPARATION	
CV-R1121-C	CENTRAL VALLEY WYE	AVENUE 21 TO ROAD 13 WYE ALTERNATIVE	PLAN AND PROFILE	ROAD 4/LINCOLN ROAD GRADE SEPARATION	
CV-R1122-C	CENTRAL VALLEY WYE	AVENUE 21 TO ROAD 13 WYE ALTERNATIVE	PLAN AND PROFILE	ROAD 4/ LINCOLN ROAD CONNECTOR	
CV-R1123-C	CENTRAL VALLEY WYE	AVENUE 21 TO ROAD 13 WYE ALTERNATIVE	PLAN AND PROFILE	AVENUE 21 REALIGNMENT AT ROAD 4	
CV-R1160-C	CENTRAL VALLEY WYE	AVENUE 21 TO ROAD 13 WYE ALTERNATIVE	PLAN AND PROFILE	ROAD 9/HEMLOCK ROAD GRADE SEPARATION	
CV-R1161-C	CENTRAL VALLEY WYE	AVENUE 21 TO ROAD 13 WYE ALTERNATIVE	PLAN AND PROFILE	ROAD 9/HEMLOCK ROAD GRADE SEPARATION	
CV-R1162-C	CENTRAL VALLEY WYE	AVENUE 21 TO ROAD 13 WYE ALTERNATIVE	PLAN AND PROFILE	ROAD 9/AVENUE 21 CONNECTOR	
CV-R1180-C	CENTRAL VALLEY WYE	AVENUE 21 TO ROAD 13 WYE ALTERNATIVE	PLAN AND PROFILE	AVENUE 21 REALIGNMENT AT ROAD 11	
CV-R1200-C	CENTRAL VALLEY WYE	AVENUE 21 TO ROAD 13 WYE ALTERNATIVE	PLAN AND PROFILE	ROBERTSON BLVD GRADE SEPARATION	
CV-R1201-C	CENTRAL VALLEY WYE	AVENUE 21 TO ROAD 13 WYE ALTERNATIVE	PLAN AND PROFILE	ROBERTSON BLVD GRADE SEPARATION	
CV-R1202-C	CENTRAL VALLEY WYE	AVENUE 21 TO ROAD 13 WYE ALTERNATIVE	PLAN AND PROFILE	AVENUE 21/ROBERTSON BLVD CONNECTOR	
CV-R1203-C	CENTRAL VALLEY WYE	AVENUE 21 TO ROAD 13 WYE ALTERNATIVE	PLAN AND PROFILE	AVENUE 21 REALIGNMENT AT ROBERTSON BLVD	
CV-R1220-C	CENTRAL VALLEY WYE	AVENUE 21 TO ROAD 13 WYE ALTERNATIVE	PLAN AND PROFILE	AVENUE 21 REALIGNMENT AT ROAD 15	
CV-R1230-C	CENTRAL VALLEY WYE	AVENUE 21 TO ROAD 13 WYE ALTERNATIVE	PLAN AND PROFILE	ROAD 16 GRADE SEPARATION	
CV-R1231-C	CENTRAL VALLEY WYE	AVENUE 21 TO ROAD 13 WYE ALTERNATIVE	PLAN AND PROFILE	ROAD 16 GRADE SEPARATION	
CV-R1260-C	CENTRAL VALLEY WYE	AVENUE 21 TO ROAD 13 WYE ALTERNATIVE	PLAN AND PROFILE	ROAD 19 GRADE SEPARATION	
CV-R1261-C	CENTRAL VALLEY WYE	AVENUE 21 TO ROAD 13 WYE ALTERNATIVE	PLAN AND PROFILE	ROAD 19 GRADE SEPARATION	
CV-R1262-C	CENTRAL VALLEY WYE	AVENUE 21 TO ROAD 13 WYE ALTERNATIVE	PLAN AND PROFILE	AVENUE 21/ROAD 19 CONNECTOR	
CV-R1270-C	CENTRAL VALLEY WYE	AVENUE 21 TO ROAD 13 WYE ALTERNATIVE	PLAN AND PROFILE	FAIRMEAD BOULEVARD REALIGNMENT	
CV-R1290-C	CENTRAL VALLEY WYE	AVENUE 21 TO ROAD 13 WYE ALTERNATIVE	PLAN AND PROFILE	ROAD 22 GRADE SEPARATION	
CV-R1291-C	CENTRAL VALLEY WYE	AVENUE 21 TO ROAD 13 WYE ALTERNATIVE	PLAN AND PROFILE	ROAD 22 GRADE SEPARATION	
CV-R1292-C	CENTRAL VALLEY WYE	AVENUE 21 TO ROAD 13 WYE ALTERNATIVE	PLAN AND PROFILE	ROAD 22 GRADE SEPARATION	
			RSONS	IFORNIA INDEX OF DEAMINGS	ECT
1		C. LEMLEY CONSTRUCTION		INDEX OF DRAWINGS	SHEET NO

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			INDEX OF DRAWINGS	
DRAWING NO.	SECTION	ALIGNMENT / PLAN SET	TITLE	DESCRIPTION
CV-R1300-C	CENTRAL VALLEY WYE	AVENUE 21 TO ROAD 13 WYE ALTERNATIVE	PLAN AND PROFILE	AVENUE 20 1/2 GRADE SEPARATION
CV-R1301-C	CENTRAL VALLEY WYE	AVENUE 21 TO ROAD 13 WYE ALTERNATIVE	PLAN AND PROFILE	AVENUE 20 1/2 GRADE SEPARATION
CV-R1310-C	CENTRAL VALLEY WYE	AVENUE 21 TO ROAD 13 WYE ALTERNATIVE	PLAN AND PROFILE	ROAD 24 REALIGNMENT
CV-R1311-C	CENTRAL VALLEY WYE	AVENUE 21 TO ROAD 13 WYE ALTERNATIVE	PLAN AND PROFILE	ROAD 24 REALIGNMENT
CV-R1430-C	CENTRAL VALLEY WYE	AVENUE 21 TO ROAD 13 WYE ALTERNATIVE	PLAN AND PROFILE	ROAD 14 GRADE SEPARATION
CV-R1431-C	CENTRAL VALLEY WYE	AVENUE 21 TO ROAD 13 WYE ALTERNATIVE	PLAN AND PROFILE	ROAD 14 GRADE SEPARATION
CV-R1432-C	CENTRAL VALLEY WYE	AVENUE 21 TO ROAD 13 WYE ALTERNATIVE	PLAN AND PROFILE	AVENUE 21 1/2 GRADE SEPARATION
CV-R1433-C	CENTRAL VALLEY WYE	AVENUE 21 TO ROAD 13 WYE ALTERNATIVE	PLAN AND PROFILE	AVENUE 21 1/2 GRADE SEPARATION
CV-R1470-C	CENTRAL VALLEY WYE	AVENUE 21 TO ROAD 13 WYE ALTERNATIVE	PLAN AND PROFILE	AVENUE 25/WASHINGTON ROAD UNDERPASS
CV-R1471-C	CENTRAL VALLEY WYE	AVENUE 21 TO ROAD 13 WYE ALTERNATIVE	PLAN AND PROFILE	ROAD 13 REALIGNMENT
CV-R1490-C	CENTRAL VALLEY WYE	AVENUE 21 TO ROAD 13 WYE ALTERNATIVE	PLAN AND PROFILE	VISTA AVENUE/ROAD 13 REALIGNMENT
CV-R1491-C	CENTRAL VALLEY WYE	AVENUE 21 TO ROAD 13 WYE ALTERNATIVE	PLAN AND PROFILE	VISTA AVENUE/ROAD 13 REALIGNMENT
CV-R1500-C	CENTRAL VALLEY WYE	AVENUE 21 TO ROAD 13 WYE ALTERNATIVE	PLAN AND PROFILE	CROSS ROAD REALIGNMENT
CV-R1501-C	CENTRAL VALLEY WYE	AVENUE 21 TO ROAD 13 WYE ALTERNATIVE	PLAN AND PROFILE	CROSS ROAD REALIGNMENT
CV-R1502-C	CENTRAL VALLEY WYE	AVENUE 21 TO ROAD 13 WYE ALTERNATIVE	PLAN AND PROFILE	CROSS ROAD REALIGNMENT
CV-R1510-C	CENTRAL VALLEY WYE	AVENUE 21 TO ROAD 13 WYE ALTERNATIVE	PLAN AND PROFILE	ROAD 11 REALIGNMENT
CV-R1511-C	CENTRAL VALLEY WYE	AVENUE 21 TO ROAD 13 WYE ALTERNATIVE	PLAN AND PROFILE	ROAD 11 REALIGNMENT
CV-R1512-C	CENTRAL VALLEY WYE	AVENUE 21 TO ROAD 13 WYE ALTERNATIVE	PLAN AND PROFILE	ROAD 11 REALIGNMENT
CV-R1630-C	CENTRAL VALLEY WYE	AVENUE 21 TO ROAD 13 WYE ALTERNATIVE	PLAN AND PROFILE	AVENUE 21 1/2 SJD-MER GRADE SEPARATION
CV-R1631-C	CENTRAL VALLEY WYE	AVENUE 21 TO ROAD 13 WYE ALTERNATIVE	PLAN AND PROFILE	AVENUE 21 1/2 SJD-MER GRADE SEPARATION
CV-R1632-C	CENTRAL VALLEY WYE	AVENUE 21 TO ROAD 13 WYE ALTERNATIVE	PLAN AND PROFILE	ROAD 12 CONNECTOR ROAD
CV-I0001-C	CENTRAL VALLEY WYE	AVENUE 21 TO ROAD 13 WYE ALTERNATIVE	STAGE CONSTRUCTION PLAN	GENERAL NOTES
		SR 152 (NORT	H) TO ROAD 11 WYE ALTERNATIVE	
CV-B4050-D	CENTRAL VALLEY WYE	SR 152 (NORTH) TO ROAD 11 WYE ALTERNATIVE	KEY MAP	SHEET 1 OF 4
CV-B4051-D	CENTRAL VALLEY WYE	SR 152 (NORTH) TO ROAD 11 WYE ALTERNATIVE	KEY MAP	SHEET 2 OF 4
CV-B4052-D	CENTRAL VALLEY WYE	SR 152 (NORTH) TO ROAD 11 WYE ALTERNATIVE	KEY MAP	SHEET 3 OF 4
CV-B4053-D	CENTRAL VALLEY WYE	SR 152 (NORTH) TO ROAD 11 WYE ALTERNATIVE	KEY MAP	SHEET 4 OF 4
CV-B0060-D	CENTRAL VALLEY WYE	SR 152 (NORTH) TO ROAD 11 WYE ALTERNATIVE	GEOMETRY DATA TABLE	SHEET 1 OF 6
CV-B0061-D	CENTRAL VALLEY WYE	SR 152 (NORTH) TO ROAD 11 WYE ALTERNATIVE	GEOMETRY DATA TABLE	SHEET 2 OF 6
CV-B0062-D	CENTRAL VALLEY WYE	SR 152 (NORTH) TO ROAD 11 WYE ALTERNATIVE	GEOMETRY DATA TABLE	SHEET 3 OF 6
CV-B0063-D	CENTRAL VALLEY WYE	SR 152 (NORTH) TO ROAD 11 WYE ALTERNATIVE	GEOMETRY DATA TABLE	SHEET 4 OF 6
CV-B0064-D	CENTRAL VALLEY WYE	SR 152 (NORTH) TO ROAD 11 WYE ALTERNATIVE	GEOMETRY DATA TABLE	SHEET 5 OF 6
CV-B0065-D	CENTRAL VALLEY WYE	SR 152 (NORTH) TO ROAD 11 WYE ALTERNATIVE	GEOMETRY DATA TABLE	SHEET 6 OF 6
CV-B0070-D	CENTRAL VALLEY WYE	SR 152 (NORTH) TO ROAD 11 WYE ALTERNATIVE	UTILITY CONFLICT TABLE	SHEET 1 OF 4
CV-B0071-D	CENTRAL VALLEY WYE	SR 152 (NORTH) TO ROAD 11 WYE ALTERNATIVE	UTILITY CONFLICT TABLE	SHEET 2 OF 4
CV-B0072-D	CENTRAL VALLEY WYE	SR 152 (NORTH) TO ROAD 11 WYE ALTERNATIVE	UTILITY CONFLICT TABLE	SHEET 3 OF 4
CV-B0073-D	CENTRAL VALLEY WYE	SR 152 (NORTH) TO ROAD 11 WYE ALTERNATIVE	UTILITY CONFLICT TABLE	SHEET 4 OF 4
CV-B0080-D	CENTRAL VALLEY WYE	SR 152 (NORTH) TO ROAD 11 WYE ALTERNATIVE	TYPICAL SECTION	SHEET 1 OF 3
CV-B0081-D	CENTRAL VALLEY WYE	SR 152 (NORTH) TO ROAD 11 WYE ALTERNATIVE	TYPICAL SECTION	SHEET 2 OF 3
CV-B0082-D	CENTRAL VALLEY WYE	SR 152 (NORTH) TO ROAD 11 WYE ALTERNATIVE	TYPICAL SECTION	SHEET 3 OF 3

J. RAY UN CHARGE C. LEWLEY C.	p0021811 06-	Image: Second	IN CHARGE C. LEMLEY DATE		PARSONS		INDEX OF DRAWINGS	CONTRACT NO. HSR08-( DRAWING NO. CV-BOO SCALE NO SCAI SHEET NO.
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		INDE	K OF DRAWINGS	
DRAWING NO.	SECTION	ALIGNMENT / PLAN SET	TITLE	DESCRIPTION
CV-S1010-D	CENTRAL VALLEY WYE	SR 152 (NORTH) TO ROAD 11 WYE ALTERNATIVE	CIVIL PLAN	SJD-FRE STA 5338+00 TO 5394+00
CV-S1020-D	CENTRAL VALLEY WYE	SR 152 (NORTH) TO ROAD 11 WYE ALTERNATIVE	CIVIL PLAN	SJD-FRE STA 5394+00 TO 5450+00
CV-S1030-D	CENTRAL VALLEY WYE	SR 152 (NORTH) TO ROAD 11 WYE ALTERNATIVE	CIVIL PLAN	SJD-FRE STA 5450+00 TO 5506+00
CV-S1040-D	CENTRAL VALLEY WYE	SR 152 (NORTH) TO ROAD 11 WYE ALTERNATIVE	CIVIL PLAN	SJD-FRE STA 5506+00 TO 5562+00
CV-S1050-D	CENTRAL VALLEY WYE	SR 152 (NORTH) TO ROAD 11 WYE ALTERNATIVE	CIVIL PLAN	SJD-FRE STA 5562+00 TO 5618+00
CV-S1060-D	CENTRAL VALLEY WYE	SR 152 (NORTH) TO ROAD 11 WYE ALTERNATIVE	CIVIL PLAN	SJD-FRE STA 5618+00 TO 5674+00
CV-S1070-D	CENTRAL VALLEY WYE	SR 152 (NORTH) TO ROAD 11 WYE ALTERNATIVE	CIVIL PLAN	SJD-FRE STA 5674+00 TO 5730+00
CV-S1080-D	CENTRAL VALLEY WYE	SR 152 (NORTH) TO ROAD 11 WYE ALTERNATIVE	CIVIL PLAN	SJD-FRE STA 5730+00 TO 5786+00
CV-S1090-D	CENTRAL VALLEY WYE	SR 152 (NORTH) TO ROAD 11 WYE ALTERNATIVE	CIVIL PLAN	SJD-FRE STA 5786+00 TO 5842+00
CV-S1100-D	CENTRAL VALLEY WYE	SR 152 (NORTH) TO ROAD 11 WYE ALTERNATIVE	CIVIL PLAN	SJD-FRE STA 5842+00 TO 5898+00
CV-S1110-D	CENTRAL VALLEY WYE	SR 152 (NORTH) TO ROAD 11 WYE ALTERNATIVE	CIVIL PLAN	SJD-FRE STA 5898+00 TO 5954+00
CV-S1120-D	CENTRAL VALLEY WYE	SR 152 (NORTH) TO ROAD 11 WYE ALTERNATIVE	CIVIL PLAN	SJD-FRE STA 5954+00 TO 6010+00
CV-S1130-D	CENTRAL VALLEY WYE	SR 152 (NORTH) TO ROAD 11 WYE ALTERNATIVE	CIVIL PLAN	SJD-FRE STA 6010+00 TO 6066+00
CV-S1140-D	CENTRAL VALLEY WYE	SR 152 (NORTH) TO ROAD 11 WYE ALTERNATIVE	CIVIL PLAN	SJD-FRE STA 6066+00 TO 6122+00
CV-S1150-D	CENTRAL VALLEY WYE	SR 152 (NORTH) TO ROAD 11 WYE ALTERNATIVE	CIVIL PLAN	SJD-FRE STA 6122+00 TO 6178+00
CV-S1160-D	CENTRAL VALLEY WYE	SR 152 (NORTH) TO ROAD 11 WYE ALTERNATIVE	CIVIL PLAN	SJD-FRE STA 6178+00 TO 6234+00
CV-S1170-D	CENTRAL VALLEY WYE	SR 152 (NORTH) TO ROAD 11 WYE ALTERNATIVE	CIVIL PLAN	SJD-FRE STA 6234+00 TO 6290+00
CV-S1180-D	CENTRAL VALLEY WYE	SR 152 (NORTH) TO ROAD 11 WYE ALTERNATIVE	CIVIL PLAN	SJD-FRE STA 6290+00 TO 6346+00
CV-S1190-D	CENTRAL VALLEY WYE	SR 152 (NORTH) TO ROAD 11 WYE ALTERNATIVE	CIVIL PLAN	SJD-FRE STA 6346+00 TO 6402+00
CV-S1200-D	CENTRAL VALLEY WYE	SR 152 (NORTH) TO ROAD 11 WYE ALTERNATIVE	CIVIL PLAN	SJD-FRE STA 6402+00 TO 6458+00
CV-S1210-D	CENTRAL VALLEY WYE	SR 152 (NORTH) TO ROAD 11 WYE ALTERNATIVE	CIVIL PLAN	SJD-FRE STA 6458+00 TO 6514+00
CV-S1220-D	CENTRAL VALLEY WYE	SR 152 (NORTH) TO ROAD 11 WYE ALTERNATIVE	CIVIL PLAN	SJD-FRE STA 6514+00 TO 6570+00
CV-S1230-D	CENTRAL VALLEY WYE	SR 152 (NORTH) TO ROAD 11 WYE ALTERNATIVE	CIVIL PLAN	SJD-FRE STA 6570+00 TO 6626+00
CV-S1240-D	CENTRAL VALLEY WYE	SR 152 (NORTH) TO ROAD 11 WYE ALTERNATIVE	CIVIL PLAN	SJD-FRE STA 6626+00 TO 6682+00
CV-S1241-D	CENTRAL VALLEY WYE	SR 152 (NORTH) TO ROAD 11 WYE ALTERNATIVE	CIVIL PLAN	SJD-FRE ACCESS ROAD
CV-S1250-D	CENTRAL VALLEY WYE	SR 152 (NORTH) TO ROAD 11 WYE ALTERNATIVE	CIVIL PLAN	SJD-FRE STA 6682+00 TO 6738+00
CV-S1260-D	CENTRAL VALLEY WYE	SR 152 (NORTH) TO ROAD 11 WYE ALTERNATIVE	CIVIL PLAN	SJD-FRE STA 6738+00 TO 6794+00
CV-S1270-D	CENTRAL VALLEY WYE	SR 152 (NORTH) TO ROAD 11 WYE ALTERNATIVE	CIVIL PLAN	SJD-FRE STA 6794+00 TO 6850+00
CV-S1280-D	CENTRAL VALLEY WYE	SR 152 (NORTH) TO ROAD 11 WYE ALTERNATIVE	CIVIL PLAN	SJD-FRE STA 6850+00 TO 6906+00
CV-S1290-D	CENTRAL VALLEY WYE	SR 152 (NORTH) TO ROAD 11 WYE ALTERNATIVE	CIVIL PLAN	SJD-FRE STA 6906+00 TO 6962+00
CV-S1291-D	CENTRAL VALLEY WYE	SR 152 (NORTH) TO ROAD 11 WYE ALTERNATIVE	CIVIL PLAN	SJD-FRE ACCESS ROAD
CV-S1300-D	CENTRAL VALLEY WYE	SR 152 (NORTH) TO ROAD 11 WYE ALTERNATIVE	CIVIL PLAN	SJD-FRE STA 6962+00 TO 7018+00
CV-S1310-D	CENTRAL VALLEY WYE	SR 152 (NORTH) TO ROAD 11 WYE ALTERNATIVE	CIVIL PLAN	SJD-FRE STA 7018+00 TO 7074+00
CV-S1320-D	CENTRAL VALLEY WYE	SR 152 (NORTH) TO ROAD 11 WYE ALTERNATIVE	CIVIL PLAN	SJD-FRE STA 7074+00 TO 7130+00
CV-S1330-D	CENTRAL VALLEY WYE	SR 152 (NORTH) TO ROAD 11 WYE ALTERNATIVE	CIVIL PLAN	SJD-FRE STA 7130+00 TO 7170+94.51
CV-S1410-D	CENTRAL VALLEY WYE	SR 152 (NORTH) TO ROAD 11 WYE ALTERNATIVE	CIVIL PLAN	MER-FRE STA 15009+29.27 TO 15052+00
CV-S1420-D	CENTRAL VALLEY WYE	SR 152 (NORTH) TO ROAD 11 WYE ALTERNATIVE	CIVIL PLAN	MER-FRE STA 15052+00 TO 15108+00
CV-S1430-D	CENTRAL VALLEY WYE	SR 152 (NORTH) TO ROAD 11 WYE ALTERNATIVE	CIVIL PLAN	MER-FRE STA 15108+00 TO 15164+00
CV-S1440-D	CENTRAL VALLEY WYE	SR 152 (NORTH) TO ROAD 11 WYE ALTERNATIVE	CIVIL PLAN	MER-FRE STA 15164+00 TO 15220+00
CV-S1441-D	CENTRAL VALLEY WYE	SR 152 (NORTH) TO ROAD 11 WYE ALTERNATIVE	CIVIL PLAN	MER-FRE ACCESS ROAD

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-90						DESIGNED BY	RECORD SET		CALIFOR
						DRAWN BY W. JOHNSEN	15% DESIGN		N
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811						IN CHARGE	NOT FOR		(
021			_			C. LEMLEY	CONSTRUCTION	HIGH-SPEED RAIL AUTHORITY	
d	EV DATE	BY	СНК	APP	DESCRIPTION	09/09/2016			

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# RNIA HIGH-SPEED TRAIN PROJECT MERCED TO FRESNO SECTION CENTRAL VALLEY WYE CIVIL AND GRADE SEPARATION PLANS INDEX OF DRAWINGS SHEET 14 OF 17

CONTRACT NO. HSR08-05

DRAWING NO. CV-B0015

SCALE NO SCALE

		INDE	X OF DRAWINGS	
DRAWING NO.	SECTION	ALIGNMENT / PLAN SET	TITLE	DESCRIPTION
CV-S1450-D	CENTRAL VALLEY WYE	SR 152 (NORTH) TO ROAD 11 WYE ALTERNATIVE	CIVIL PLAN	MER-FRE STA 15220+00 TO 15276+00
CV-S1460-D	CENTRAL VALLEY WYE	SR 152 (NORTH) TO ROAD 11 WYE ALTERNATIVE	CIVIL PLAN	MER-FRE STA 15276+00 TO 15332+00
V-S1470-D	CENTRAL VALLEY WYE	SR 152 (NORTH) TO ROAD 11 WYE ALTERNATIVE	CIVIL PLAN	MER-FRE STA 15332+00 TO 15388+00
CV-S1480-D	CENTRAL VALLEY WYE	SR 152 (NORTH) TO ROAD 11 WYE ALTERNATIVE	CIVIL PLAN	MER-FRE STA 15388+00 TO 15444+00
CV-S1490-D	CENTRAL VALLEY WYE	SR 152 (NORTH) TO ROAD 11 WYE ALTERNATIVE	CIVIL PLAN	MER-FRE STA 15444+00 TO 15500+00
CV-S1500-D	CENTRAL VALLEY WYE	SR 152 (NORTH) TO ROAD 11 WYE ALTERNATIVE	CIVIL PLAN	MER-FRE STA 15500+00 TO 15556+00
CV-S1510-D	CENTRAL VALLEY WYE	SR 152 (NORTH) TO ROAD 11 WYE ALTERNATIVE	CIVIL PLAN	MER-FRE STA 15556+00 TO 15612+00
CV-S1520-D	CENTRAL VALLEY WYE	SR 152 (NORTH) TO ROAD 11 WYE ALTERNATIVE	CIVIL PLAN	MER-FRE STA 15612+00 TO 15655+00
CV-S1610-D	CENTRAL VALLEY WYE	SR 152 (NORTH) TO ROAD 11 WYE ALTERNATIVE	CIVIL PLAN	SJD-MER STA 36134+00.59 TO 36184+00
CV-S1620-D	CENTRAL VALLEY WYE	SR 152 (NORTH) TO ROAD 11 WYE ALTERNATIVE	CIVIL PLAN	SJD-MER STA 36184+00 TO 36240+00
CV-S1630-D	CENTRAL VALLEY WYE	SR 152 (NORTH) TO ROAD 11 WYE ALTERNATIVE	CIVIL PLAN	SJD-MER STA 36240+00 TO 36296+00
CV-S1640-D	CENTRAL VALLEY WYE	SR 152 (NORTH) TO ROAD 11 WYE ALTERNATIVE	CIVIL PLAN	SJD-MER STA 36296+00 TO 36352+00
CV-S1650-D	CENTRAL VALLEY WYE	SR 152 (NORTH) TO ROAD 11 WYE ALTERNATIVE	CIVIL PLAN	SJD-MER STA 36352+00 TO 36408+00
CV-S1660-D	CENTRAL VALLEY WYE	SR 152 (NORTH) TO ROAD 11 WYE ALTERNATIVE	CIVIL PLAN	SJD-MER STA 36408+00 TO 36457+64.63
CV-R1030-D	CENTRAL VALLEY WYE	SR 152 (NORTH) TO ROAD 11 WYE ALTERNATIVE	PLAN AND PROFILE	HENRY MILLER ROAD REALIGNMENT
CV-R1031-D	CENTRAL VALLEY WYE	SR 152 (NORTH) TO ROAD 11 WYE ALTERNATIVE	PLAN AND PROFILE	HENRY MILLER ROAD REALIGNMENT
CV-R1032-D	CENTRAL VALLEY WYE	SR 152 (NORTH) TO ROAD 11 WYE ALTERNATIVE	PLAN AND PROFILE	HENRY MILLER ROAD REALIGNMENT
CV-R1033-D	CENTRAL VALLEY WYE	SR 152 (NORTH) TO ROAD 11 WYE ALTERNATIVE	PLAN AND PROFILE	HENRY MILLER ROAD REALIGNMENT
CV-R1050-D	CENTRAL VALLEY WYE	SR 152 (NORTH) TO ROAD 11 WYE ALTERNATIVE	PLAN AND PROFILE	INDIANA ROAD GRADE SEPARATION
CV-R1051-D	CENTRAL VALLEY WYE	SR 152 (NORTH) TO ROAD 11 WYE ALTERNATIVE	PLAN AND PROFILE	INDIANA ROAD GRADE SEPARATION
CV-R1090-D	CENTRAL VALLEY WYE	SR 152 (NORTH) TO ROAD 11 WYE ALTERNATIVE	PLAN AND PROFILE	COYOTE ROAD REALIGNMENT
CV-R1091-D	CENTRAL VALLEY WYE	SR 152 (NORTH) TO ROAD 11 WYE ALTERNATIVE	PLAN AND PROFILE	COYOTE ROAD REALIGNMENT
CV-R1100-D	CENTRAL VALLEY WYE	SR 152 (NORTH) TO ROAD 11 WYE ALTERNATIVE	PLAN AND PROFILE	SR 152 REALIGNMENT AT SR 59
CV-R1101-D	CENTRAL VALLEY WYE	SR 152 (NORTH) TO ROAD 11 WYE ALTERNATIVE	PLAN AND PROFILE	SR 152 REALIGNMENT AT SR 59
CV-R1102-D	CENTRAL VALLEY WYE	SR 152 (NORTH) TO ROAD 11 WYE ALTERNATIVE	PLAN AND PROFILE	SR 152 REALIGNMENT AT SR 59
CV-R1103-D	CENTRAL VALLEY WYE	SR 152 (NORTH) TO ROAD 11 WYE ALTERNATIVE	PLAN AND PROFILE	SR 152 REALIGNMENT AT SR 59
CV-R1104-D	CENTRAL VALLEY WYE	SR 152 (NORTH) TO ROAD 11 WYE ALTERNATIVE	PLAN AND PROFILE	SR 59/SR 152 EB OFF RAMP GRADE SEPARATION
CV-R1105-D	CENTRAL VALLEY WYE	SR 152 (NORTH) TO ROAD 11 WYE ALTERNATIVE	PLAN AND PROFILE	SR 59/SR 152 EB OFF RAMP GRADE SEPARATION
CV-R1106-D	CENTRAL VALLEY WYE	SR 152 (NORTH) TO ROAD 11 WYE ALTERNATIVE	PLAN AND PROFILE	SR 59/SR 152 WB ON RAMP GRADE SEPARATION
CV-R1107-D	CENTRAL VALLEY WYE	SR 152 (NORTH) TO ROAD 11 WYE ALTERNATIVE	PLAN AND PROFILE	SR 59/SR 152 WB ON RAMP GRADE SEPARATION
CV-R1108-D	CENTRAL VALLEY WYE	SR 152 (NORTH) TO ROAD 11 WYE ALTERNATIVE	PLAN AND PROFILE	SR 59/SR 152 WB OFF RAMP GRADE SEPARATION
CV-R1109-D	CENTRAL VALLEY WYE	SR 152 (NORTH) TO ROAD 11 WYE ALTERNATIVE	PLAN AND PROFILE	SR 59/SR 152 WB OFF RAMP GRADE SEPARATION
CV-R1110-D	CENTRAL VALLEY WYE	SR 152 (NORTH) TO ROAD 11 WYE ALTERNATIVE	PLAN AND PROFILE	SR 59/SR 152 EB LOOP ON RAMP
CV-R1111-D	CENTRAL VALLEY WYE	SR 152 (NORTH) TO ROAD 11 WYE ALTERNATIVE	PLAN AND PROFILE	ROAD 4/LINCOLN ROAD GRADE SEPARATION
CV-R1112-D	CENTRAL VALLEY WYE	SR 152 (NORTH) TO ROAD 11 WYE ALTERNATIVE	PLAN AND PROFILE	ROAD 4/LINCOLN ROAD GRADE SEPARATION
CV-R1160-D	CENTRAL VALLEY WYE	SR 152 (NORTH) TO ROAD 11 WYE ALTERNATIVE	PLAN AND PROFILE	ROAD 9/HEMLOCK ROAD GRADE SEPARATION
CV-R1161-D	CENTRAL VALLEY WYE	SR 152 (NORTH) TO ROAD 11 WYE ALTERNATIVE	PLAN AND PROFILE	ROAD 9/HEMLOCK ROAD GRADE SEPARATION
CV-R1162-D	CENTRAL VALLEY WYE	SR 152 (NORTH) TO ROAD 11 WYE ALTERNATIVE	PLAN AND PROFILE	SR 152 REALIGNMENT AT ROAD 9
CV-R1163-D	CENTRAL VALLEY WYE	SR 152 (NORTH) TO ROAD 11 WYE ALTERNATIVE	PLAN AND PROFILE	SR 152 REALIGNMENT AT ROAD 9
CV-R1164-D	CENTRAL VALLEY WYE	SR 152 (NORTH) TO ROAD 11 WYE ALTERNATIVE	PLAN AND PROFILE	SR 152 REALIGNMENT AT ROAD 9

p0021811 06-S	REV	DATE	BY	СНК	APP	DESCRIPTION	DESIGNED BY S. WELLS DRAWN BY W. JOHNSEN CHECKED BY J. RAY IN CHARGE C. LEMLEY DATE 09/09/2016	RECORD SET 15% DESIGN Submittal Not for Construction	PARSONS	CALIFORNIA HIGH-SPEED RAIL AUTHORITY	CALIFO
ă	REV	DATE	Вт	CHK	APP	DESCRIPTION	09/09/2016				

# RNIA HIGH-SPEED TRAIN PROJECT MERCED TO FRESNO SECTION CENTRAL VALLEY WYE CIVIL AND GRADE SEPARATION PLANS INDEX OF DRAWINGS SHEET 15 OF 17

CONTRACT NO. HSR08-05

SHEET NO.

# DRAWING NO. CV-B0016

SCALE NO SCALE

		INDE	X OF DRAWINGS	
DRAWING NO.	SECTION	ALIGNMENT / PLAN SET	TITLE	DESCRIPTION
CV-R1165-D	CENTRAL VALLEY WYE	SR 152 (NORTH) TO ROAD 11 WYE ALTERNATIVE	PLAN AND PROFILE	ROAD 9/SR 152 EB OFF RAMP
CV-R1166-D	CENTRAL VALLEY WYE	SR 152 (NORTH) TO ROAD 11 WYE ALTERNATIVE	PLAN AND PROFILE	ROAD 9/SR 152 EB ON RAMP
CV-R1167-D	CENTRAL VALLEY WYE	SR 152 (NORTH) TO ROAD 11 WYE ALTERNATIVE	PLAN AND PROFILE	ROAD 9/SR 152 LOOP RAMP
CV-R1168-D	CENTRAL VALLEY WYE	SR 152 (NORTH) TO ROAD 11 WYE ALTERNATIVE	PLAN AND PROFILE	ROAD 9/SR 152 WB ON RAMP
CV-R1169-D	CENTRAL VALLEY WYE	SR 152 (NORTH) TO ROAD 11 WYE ALTERNATIVE	PLAN AND PROFILE	ROAD 9/SR 152 WB OFF RAMP
CV-R1190-D	CENTRAL VALLEY WYE	SR 152 (NORTH) TO ROAD 11 WYE ALTERNATIVE	PLAN AND PROFILE	ROAD 12 GRADE SEPARATION
CV-R1191-D	CENTRAL VALLEY WYE	SR 152 (NORTH) TO ROAD 11 WYE ALTERNATIVE	PLAN AND PROFILE	ROAD 12 GRADE SEPARATION
CV-R1192-D	CENTRAL VALLEY WYE	SR 152 (NORTH) TO ROAD 11 WYE ALTERNATIVE	PLAN AND PROFILE	SR 152 REALIGNMENT AT ROAD 12
CV-R1193-D	CENTRAL VALLEY WYE	SR 152 (NORTH) TO ROAD 11 WYE ALTERNATIVE	PLAN AND PROFILE	SR 152 REALIGNMENT AT ROAD 12
CV-R1194-D	CENTRAL VALLEY WYE	SR 152 (NORTH) TO ROAD 11 WYE ALTERNATIVE	PLAN AND PROFILE	SR 152 REALIGNMENT AT ROAD 12
CV-R1200-D	CENTRAL VALLEY WYE	SR 152 (NORTH) TO ROAD 11 WYE ALTERNATIVE	PLAN AND PROFILE	SR 152 REALIGNMENT AT SR 233
CV-R1201-D	CENTRAL VALLEY WYE	SR 152 (NORTH) TO ROAD 11 WYE ALTERNATIVE	PLAN AND PROFILE	SR 152 REALIGNMENT AT SR 233
CV-R1202-D	CENTRAL VALLEY WYE	SR 152 (NORTH) TO ROAD 11 WYE ALTERNATIVE	PLAN AND PROFILE	SR 152 REALIGNMENT AT SR 233
V-R1203-D	CENTRAL VALLEY WYE	SR 152 (NORTH) TO ROAD 11 WYE ALTERNATIVE	PLAN AND PROFILE	SR 233/SR 152 EB OFF RAMP
CV-R1204-D	CENTRAL VALLEY WYE	SR 152 (NORTH) TO ROAD 11 WYE ALTERNATIVE	PLAN AND PROFILE	SR 233/SR 152 EB LOOP RAMP
CV-R1205-D	CENTRAL VALLEY WYE	SR 152 (NORTH) TO ROAD 11 WYE ALTERNATIVE	PLAN AND PROFILE	SR 233/SR 152 WB ON RAMP
CV-R1210-D	CENTRAL VALLEY WYE	SR 152 (NORTH) TO ROAD 11 WYE ALTERNATIVE	PLAN AND PROFILE	SR 233/ROBERTSON BLVD GRADE SEPARATION
CV-R1211-D	CENTRAL VALLEY WYE	SR 152 (NORTH) TO ROAD 11 WYE ALTERNATIVE	PLAN AND PROFILE	SR 233/ROBERTSON BLVD GRADE SEPARATION
CV-R1212-D	CENTRAL VALLEY WYE	SR 152 (NORTH) TO ROAD 11 WYE ALTERNATIVE	PLAN AND PROFILE	SR 233/SR 152 EB ON RAMP
CV-R1213-D	CENTRAL VALLEY WYE	SR 152 (NORTH) TO ROAD 11 WYE ALTERNATIVE	PLAN AND PROFILE	SR 233/SR 152 EB ON RAMP
CV-R1214-D	CENTRAL VALLEY WYE	SR 152 (NORTH) TO ROAD 11 WYE ALTERNATIVE	PLAN AND PROFILE	SR 233/SR 152 WB OFF RAMP
CV-R1224-D	CENTRAL VALLEY WYE	SR 152 (NORTH) TO ROAD 11 WYE ALTERNATIVE	PLAN AND PROFILE	SR 152 REALIGNMENT AT ROAD 16
CV-R1225-D	CENTRAL VALLEY WYE	SR 152 (NORTH) TO ROAD 11 WYE ALTERNATIVE	PLAN AND PROFILE	SR 152 REALIGNMENT AT ROAD 16
CV-R1226-D	CENTRAL VALLEY WYE	SR 152 (NORTH) TO ROAD 11 WYE ALTERNATIVE	PLAN AND PROFILE	SR 152 REALIGNMENT AT ROAD 16
CV-R1227-D	CENTRAL VALLEY WYE	SR 152 (NORTH) TO ROAD 11 WYE ALTERNATIVE	PLAN AND PROFILE	ROAD 16/SR 152 EB OFF RAMP
CV-R1228-D	CENTRAL VALLEY WYE	SR 152 (NORTH) TO ROAD 11 WYE ALTERNATIVE	PLAN AND PROFILE	ROAD 16/SR 152 EB OFF RAMP
CV-R1229-D	CENTRAL VALLEY WYE	SR 152 (NORTH) TO ROAD 11 WYE ALTERNATIVE	PLAN AND PROFILE	ROAD 16/SR 152 WB ON RAMP
CV-R1230-D	CENTRAL VALLEY WYE	SR 152 (NORTH) TO ROAD 11 WYE ALTERNATIVE	PLAN AND PROFILE	ROAD 16 GRADE SEPARATION
CV-R1231-D	CENTRAL VALLEY WYE	SR 152 (NORTH) TO ROAD 11 WYE ALTERNATIVE	PLAN AND PROFILE	ROAD 16 GRADE SEPARATION
CV-R1232-D	CENTRAL VALLEY WYE	SR 152 (NORTH) TO ROAD 11 WYE ALTERNATIVE	PLAN AND PROFILE	ROAD 16/SR 152 EB ON RAMP
CV-R1233-D	CENTRAL VALLEY WYE	SR 152 (NORTH) TO ROAD 11 WYE ALTERNATIVE	PLAN AND PROFILE	ROAD 16/SR 152 EB LOOP RAMP
CV-R1234-D	CENTRAL VALLEY WYE	SR 152 (NORTH) TO ROAD 11 WYE ALTERNATIVE	PLAN AND PROFILE	ROAD 16/SR 152 WB OFF RAMP
CV-R1235-D	CENTRAL VALLEY WYE	SR 152 (NORTH) TO ROAD 11 WYE ALTERNATIVE	PLAN AND PROFILE	ROAD 16 CONNECTOR REALIGNMENT
CV-R1240-D	CENTRAL VALLEY WYE	SR 152 (NORTH) TO ROAD 11 WYE ALTERNATIVE	PLAN AND PROFILE	ROAD 17 1/2 GRADE SEPARATION
CV-R1241-D	CENTRAL VALLEY WYE	SR 152 (NORTH) TO ROAD 11 WYE ALTERNATIVE	PLAN AND PROFILE	ROAD 17 1/2 GRADE SEPARATION
CV-R1242-D	CENTRAL VALLEY WYE	SR 152 (NORTH) TO ROAD 11 WYE ALTERNATIVE	PLAN AND PROFILE	ROAD 17 1/2 GRADE SEPARATION
CV-R1250-D	CENTRAL VALLEY WYE	SR 152 (NORTH) TO ROAD 11 WYE ALTERNATIVE	PLAN AND PROFILE	FAIRMEAD BOULEVARD REALIGNMENT
CV-R1260-D	CENTRAL VALLEY WYE	SR 152 (NORTH) TO ROAD 11 WYE ALTERNATIVE	PLAN AND PROFILE	ROAD 20 GRADE SEPARATION
CV-R1261-D	CENTRAL VALLEY WYE	SR 152 (NORTH) TO ROAD 11 WYE ALTERNATIVE	PLAN AND PROFILE	ROAD 20 GRADE SEPARATION
CV-R1280-D	CENTRAL VALLEY WYE	SR 152 (NORTH) TO ROAD 11 WYE ALTERNATIVE	PLAN AND PROFILE	ROAD 22 GRADE SEPARATION

S											
-90							DESIGNE S.	WELLS	RECORD SET		CALIFOR
							DRAWN W.	JOHNSEN	15% DESIGN		N
-  -							CHECKE		SUBMITTAL		
1811							IN CHAF		NOT FOR Construction		
p0021	REV	DATE	BY	снк	APP	DESCF	DATE	/09/2016	CONSTRUCTION	HIGH-SPEED RAIL AUTHORITY	
L							00/	/03/2010			

# RNIA HIGH-SPEED TRAIN PROJECT MERCED TO FRESNO SECTION CENTRAL VALLEY WYE CIVIL AND GRADE SEPARATION PLANS INDEX OF DRAWINGS SHEET 16 OF 17

CONTRACT NO. HSR08-05 DRAWING NO. CV-B0017

# SCALE NO SCALE

	INDEX OF DRAWINGS					
DRAWING NO.	SECTION	ALIGNMENT / PLAN SET	TITLE	DESCRIPTION		
CV-R1281-D	CENTRAL VALLEY WYE	SR 152 (NORTH) TO ROAD 11 WYE ALTERNATIVE	PLAN AND PROFILE	ROAD 22 GRADE SEPARATION		
CV-R1290-D	CENTRAL VALLEY WYE	SR 152 (NORTH) TO ROAD 11 WYE ALTERNATIVE	PLAN AND PROFILE	AVENUE 22 REALIGNMENT		
CV-R1310-D	CENTRAL VALLEY WYE	SR 152 (NORTH) TO ROAD 11 WYE ALTERNATIVE	PLAN AND PROFILE	ROAD 24 REALIGNMENT		
CV-R1311-D	CENTRAL VALLEY WYE	SR 152 (NORTH) TO ROAD 11 WYE ALTERNATIVE	PLAN AND PROFILE	ROAD 24 REALIGNMENT		
CV-R1312-D	CENTRAL VALLEY WYE	SR 152 (NORTH) TO ROAD 11 WYE ALTERNATIVE	PLAN AND PROFILE	ROAD 24 REALIGNMENT		
CV-R1313-D	CENTRAL VALLEY WYE	SR 152 (NORTH) TO ROAD 11 WYE ALTERNATIVE	PLAN AND PROFILE	AVENUE 20 1/2 GRADE SEPARATION		
CV-R1314-D	CENTRAL VALLEY WYE	SR 152 (NORTH) TO ROAD 11 WYE ALTERNATIVE	PLAN AND PROFILE	AVENUE 20 1/2 GRADE SEPARATION		
CV-R1320-D	CENTRAL VALLEY WYE	SR 152 (NORTH) TO ROAD 11 WYE ALTERNATIVE	PLAN AND PROFILE	AVENUE 20 REALIGNMENT		
CV-R1321-D	CENTRAL VALLEY WYE	SR 152 (NORTH) TO ROAD 11 WYE ALTERNATIVE	PLAN AND PROFILE	AVENUE 20 REALIGNMENT		
CV-R1450-D	CENTRAL VALLEY WYE	SR 152 (NORTH) TO ROAD 11 WYE ALTERNATIVE	PLAN AND PROFILE	AVENUE 25 GRADE SEPARATION		
CV-R1451-D	CENTRAL VALLEY WYE	SR 152 (NORTH) TO ROAD 11 WYE ALTERNATIVE	PLAN AND PROFILE	AVENUE 25 GRADE SEPARATION		
CV-R1490-D	CENTRAL VALLEY WYE	SR 152 (NORTH) TO ROAD 11 WYE ALTERNATIVE	PLAN AND PROFILE	ATHLONE ROAD REALIGNMENT		
CV-R1491-D	CENTRAL VALLEY WYE	SR 152 (NORTH) TO ROAD 11 WYE ALTERNATIVE	PLAN AND PROFILE	ATHLONE ROAD REALIGNMENT		
CV-R1630-D	CENTRAL VALLEY WYE	SR 152 (NORTH) TO ROAD 11 WYE ALTERNATIVE	PLAN AND PROFILE	ROAD 10 REALIGNMENT		
CV-R1631-D	CENTRAL VALLEY WYE	SR 152 (NORTH) TO ROAD 11 WYE ALTERNATIVE	PLAN AND PROFILE	ROAD 10 REALIGNMENT		
CV-R1632-D	CENTRAL VALLEY WYE	SR 152 (NORTH) TO ROAD 11 WYE ALTERNATIVE	PLAN AND PROFILE	AVENUE 23 1/2 GRADE SEPARATION		
CV-R1633-D	CENTRAL VALLEY WYE	SR 152 (NORTH) TO ROAD 11 WYE ALTERNATIVE	PLAN AND PROFILE	AVENUE 23 1/2 GRADE SEPARATION		
CV-R1650-D	CENTRAL VALLEY WYE	SR 152 (NORTH) TO ROAD 11 WYE ALTERNATIVE	PLAN AND PROFILE	ROAD 11 REALIGNMENT		
CV-R1651-D	CENTRAL VALLEY WYE	SR 152 (NORTH) TO ROAD 11 WYE ALTERNATIVE	PLAN AND PROFILE	ROAD 11 REALIGNMENT		
CV-I0001-D	CENTRAL VALLEY WYE	SR 152 (NORTH) TO ROAD 11 WYE ALTERNATIVE	STAGE CONSTRUCTION PLAN	GENERAL NOTES		
CV-I4100-D	CENTRAL VALLEY WYE	SR 152 (NORTH) TO ROAD 11 WYE ALTERNATIVE	STAGE CONSTRUCTION PLAN	SR 59/SR 152 STAGE 1 OF 4		
CV-I4101-D	CENTRAL VALLEY WYE	SR 152 (NORTH) TO ROAD 11 WYE ALTERNATIVE	STAGE CONSTRUCTION PLAN	SR 59/SR 152 STAGE 2 OF 4		
CV-I4102-D	CENTRAL VALLEY WYE	SR 152 (NORTH) TO ROAD 11 WYE ALTERNATIVE	STAGE CONSTRUCTION PLAN	SR 59/SR 152 STAGE 3 OF 4		
CV-I4103-D	CENTRAL VALLEY WYE	SR 152 (NORTH) TO ROAD 11 WYE ALTERNATIVE	STAGE CONSTRUCTION PLAN	SR 59/SR 152 STAGE 4 OF 4		
CV-I4160-D	CENTRAL VALLEY WYE	SR 152 (NORTH) TO ROAD 11 WYE ALTERNATIVE	STAGE CONSTRUCTION PLAN	ROAD 9/SR 152 STAGE 1 OF 4		
CV-I4161-D	CENTRAL VALLEY WYE	SR 152 (NORTH) TO ROAD 11 WYE ALTERNATIVE	STAGE CONSTRUCTION PLAN	ROAD 9/SR 152 STAGE 2 OF 4		
CV-I4162-D	CENTRAL VALLEY WYE	SR 152 (NORTH) TO ROAD 11 WYE ALTERNATIVE	STAGE CONSTRUCTION PLAN	ROAD 9/SR 152 STAGE 3 OF 4		
CV-I4163-D	CENTRAL VALLEY WYE	SR 152 (NORTH) TO ROAD 11 WYE ALTERNATIVE	STAGE CONSTRUCTION PLAN	ROAD 9/SR 152 STAGE 4 OF 4		
CV-I4210-D	CENTRAL VALLEY WYE	SR 152 (NORTH) TO ROAD 11 WYE ALTERNATIVE	STAGE CONSTRUCTION PLAN	SR 233/SR 152 STAGE 1 OF 5		
CV-I4211-D	CENTRAL VALLEY WYE	SR 152 (NORTH) TO ROAD 11 WYE ALTERNATIVE	STAGE CONSTRUCTION PLAN	SR 233/SR 152 STAGE 2 OF 5		
CV-I4212-D	CENTRAL VALLEY WYE	SR 152 (NORTH) TO ROAD 11 WYE ALTERNATIVE	STAGE CONSTRUCTION PLAN	SR 233/SR 152 STAGE 3 OF 5		
CV-I4213-D	CENTRAL VALLEY WYE	SR 152 (NORTH) TO ROAD 11 WYE ALTERNATIVE	STAGE CONSTRUCTION PLAN	SR 233/SR 152 STAGE 4 OF 5		
CV-I4214-D	CENTRAL VALLEY WYE	SR 152 (NORTH) TO ROAD 11 WYE ALTERNATIVE	STAGE CONSTRUCTION PLAN	SR 233/SR 152 STAGE 5 OF 5		
CV-14230-D	CENTRAL VALLEY WYE	SR 152 (NORTH) TO ROAD 11 WYE ALTERNATIVE	STAGE CONSTRUCTION PLAN	ROAD 16/SR 152 STAGE 1 OF 4		
CV-I4231-D	CENTRAL VALLEY WYE	SR 152 (NORTH) TO ROAD 11 WYE ALTERNATIVE	STAGE CONSTRUCTION PLAN	ROAD 16/SR 152 STAGE 2 OF 4		
CV-I4232-D	CENTRAL VALLEY WYE	SR 152 (NORTH) TO ROAD 11 WYE ALTERNATIVE	STAGE CONSTRUCTION PLAN	ROAD 16/SR 152 STAGE 3 OF 4		
CV-I4233-D	CENTRAL VALLEY WYE	SR 152 (NORTH) TO ROAD 11 WYE ALTERNATIVE	STAGE CONSTRUCTION PLAN	ROAD 16/SR 152 STAGE 4 OF 4		

				DESIGNED BY	RECORD SET			CALIFOR
	_			DRAWN BY W. JOHNSEN	15% DESIGN			M
	_			CHECKED BY	SUBMITTAL	PARSONS		
	_	_		J. RAY	NOT FOR			С
				C. LEMLEY	CONSTRUCTION		HIGH-SPEED RAIL AUTHORITY	
DATE B	r снк	APP	DESCRIPTION	09/09/2016				

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### RNIA HIGH-SPEED TRAIN PROJECT MERCED TO FRESNO SECTION CENTRAL VALLEY WYE CIVIL AND GRADE SEPARATION PLANS INDEX OF DRAWINGS SHEET 17 OF 17

CONTRACT NO. HSR08-05

DRAWING NO. CV-B0018

SCALE NO SCALE

	( <u> </u>		( <u> </u>	
AB	AGGREGATE BASE	САА	CABLE ANCHOR ASSEMBLY	
ABBC	ASBESTOS BONDED BITUMINOUS COATED	CAP	CORRUGATED ALUMINUM PIPE	
ABM	AIR-BLOWN MORTAR	CAPA	CORRUGATED ALUMINUM PIPE ARCH	
ABN	ABANDON	CAS	CONSTRUCTION AREA SIGN	
ABUT	ABUTMENT	СВ	CONCRETE BARRIER	
AC	ASPHALT CONCRETE	CBW	CONCRETE BLOCK WALL	
ACB	ASPHALT CONCRETE BASE	C-C	CENTER TO CENTER	
ACP	ASBESTOS CEMENT PIPE	CHSRA	CALIFORNIA HIGH-SPEED RAIL	
ADL	ADDED DEAD LOAD		AUTHORITY (SEE AUTHORITY)	
ADJ	ADJUST	CHSR	CALIFORNIA HIGH-SPEED RAIL	
AFES	ALTERNATIVE FLARED END SECTION	CHST	CALIFORNIA HIGH-SPEED TRAIN	
AHD	AHEAD	CG	CENTER OF GRAVITY	
ALT	ALTERNATE	CHNL	CHANNEL	
AM	TIME FROM MIDNIGHT TO NOON	CI	CAST IRON	
AP	ALTERNATIVE PIPE	CIDH	CAST-IN-DRILLED-HOLE	
APC	ALTERNATIVE PIPE CULVERT	CIP	CAST-IN-PLACE, CAST IRON PIPE	
APPROX	APPROXIMATE	CIPCP	CAST-IN-PLACE CONCRETE PIPE	
APU	ALTERNATIVE PIPE UNDERDRAIN	CISS	CAST-IN-STEEL SHELL	
AR	ACCESS RESTRICTION	CJP	COMPLETE JOINT PENETRATION	
ARS	ACCELERATION RESPONSE SPECTRUM	CL	CHAIN LINK, CLASS	
AS	AGGREGATE SUBBASE	CL-6	CHAIN LINK FENCE (6 FT)	
ASRP	ALUMINUM SPIRAL RIB PIPE	CLR	CLEAR, CLEARANCE	
ASSY	ASSEMBLY	CM	CORRUGATED METAL	
ATC	AUTOMATIC TRAIN CONTROL	CMP	CORRUGATED METAL PIPE	
ATPB	ASPHALT TREATED PERMEABLE BASE	CO	COUNTY	
ATPM	ASPHALT TREATED PERMEABLE MATERIAL	COL	COLUMN	
AUTHORITY			CONCRETE	
AVE	AVENUE	COND	CONDUIT	
AVG	AVERAGE	CONN	CONNECTOR	
@	AT	CONST	CONSTRUCT, CONSTRUCTION	
	( <u> </u>	CONT	CONTINUOUS	
BAGR		COORD	COORDINATE	
	BRIDGE APPROACH GUARD RAILING	CP	CANDLEPOWER	
BB B-B	BEGINNING OF BRIDGE	CP1	CONSTRUCTION PACKAGE 1	
B-B BC	BACK-TO-BACK BEGIN HORIZONTAL CURVE	CR CRCP	CREEK CONTINUOUS REINFORCED CONCRETE PAV	
BCR	BEGIN CURB RETURN	CRSP	CONCRETED ROCK SLOPE PROTECTION	
BEG	BEGIN CORD RETORN BEGIN	CRZ		
BIT CTD	BITUMINOUS COATED	CS	CLEAR RECOVERY ZONE	
BITCTD	BACK	CSP	CURVE SPIRAL POINT CORRUGATED STEEL PIPE	
BKF	BACKFILL	CSPA	CORRUGATED STEEL PIPE ARCH	
BLDG	BUILDING	СТВ	CORROGATED STEEL FIFE ARCH CEMENT TREATED BASE	
BLDG		СТРВ		
BLWD	BRIDGE-LOG MILE BOULEVARD	СТРВ	CEMENT TREATED PERMEABLE BASE CEMENT TREATED PERMEABLE MATERIAL	
BLVD				
	BENCH MARK	CTRS CULV		
BOT	BOTTOM		CULVERT	
BNSF BR	BNSF RAILWAY	¢_	CENTERLINE	
BRG	BRIDGE			
BRG	BEARING REGIN TUNNEL	D	DEPTH	
BTU	BEGIN TUNNEL BRITISH THERMAL UNIT		DEPTH DOWNDRAIN	
BVC	BRITISH THERMAL UNIT BEGIN VERTICAL CURVE	DD DBL		
BW	BARBED WIRE	DEC	DOUBLE DEGREE	
DW	DARDED WIRE	DEG	DELINEATOR	
			DESIGNED BY S. WELLS RECORD SET	
			DRAWN BY Wa JOHNSEN 15% DESIGN	
1 1			J. RAY	
			IN CHARGE NOT FOR C. LEMLEY CONSTRUCTION	

		( <u>d</u> continued)	
	DET	DETAIL, DETOUR	FNTB
	DF	DOUGLAS FIR, DIRECT FIXATION	FOB
	DI	DRAINAGE INLET, DROP INLET	FOC
	DIA	DIAMETER	FR RD
	DIAPH	DIAPHRAGM	FRE
	DIST	DISTANCE, DISTRICT	FS
	DMBB	DOUBLE METAL BEAM BARRIER	FSBT
	DR	DRIVE	FTG
	DTBB	DOUBLE THRIE BEAM BARRIER	FWBT
	DWY	DRIVEWAY	FWY
		( E )	
	_		
	E	EAST	G
	EA	ACTUAL SUPERELEVATION	
	EASE	EASEMENT	GA
	EB	END OF BRIDGE, EASTBOUND	GALV
	EC	END HORIZONTAL CURVE	GP
	ECR	END CURB RETURN	GR
	ED	EDGE DRAIN	GRDR
	EDC	EDGE DRAIN CLEANOUT	GSP
	EDO	EDGE DRAIN OUTLET	GTR
	EDV	EDGE DRAIN VENT	
	ELEC	ELECTROLIER	
	ELECT	ELECTRIC	Н
	ELEV	ELEVATION	H, HR
	ЕМВ	EMBANKMENT	HD
	ENGR	ENGINEER	HDWL
	EOD	EDGE OF DECK	HEX HD
	EP	EDGE OF PAVEMENT	НИА
	EQ	EQUATION	HORIZ
	ES	EDGE OF SHOULDER	HP
	ET	END TUNNEL	HPS
	ETW	EDGE OF TRAVELED WAY	HS
	EU	UNBALANCED SUPERELEVATION	HSR
	EVC		
т		END VERTICAL CURVE	HST
IT	EW	ENDWALL	HW
	EXC	EXCAVATION	
	EXIST, (E)		
	EXP	EXPANSION, EXPRESSWAY	HWM
	EXP JT	EXPANSION JOINT	HWY
	EXT	EXTERIOR	
		F	IB
	F & C	FRAME AND COVER	ID
	F & G	FRAME AND GRATE	IF
	FB	FLOOR BEAM	INT
	FDN	FOUNDATION	INV
	FEBT	FACING EASTBOUND TRAFFIC	
			IRR
	FES	FLARED END SECTION	IS
	FF	FILTER FABRIC	
	FG	FINISHED GRADE	107
	FH	FIRE HYDRANT	JCT
	FIG	FIGURE	JP
	FL	FLOW LINE	JPCP

PARSONS



HOUR
HORIZONTAL DRAIN
HEADWALL
HEXAGONAL HEAD
HOT MIXED ASPHA
HORIZONTAL
HINGE POINT, HOR
HIGH PERFORMANCE
HIGH STRENGTH
HIGH-SPEED RAIL
HIGH-SPEED TRAIN
HEADWALL,
100-YR HIGH WATE
OTHERWISE)
HIGH WATER MARK
HIGHWAY
T
IMPORTED BORROW
INSIDE DIAMETER
INSIDE FACE
INTERIOR
INVERT
IRRIGATION
INTERLOCKING SIT

$\square$		J
JUNCT	ION	
JOINT	POLE	

CALIFORNIA HIGH-SPEED RAIL AUTHORITY

( <u>F CONTINUED</u> )		( J CONTIN	UED)
FACING NORTHBOUND TRAFFIC	JS	JUNCTION STRUCTU	JRE
FREE ON BOARD	JT	JOINT	
FACE OF CONCRETE			
FRONTAGE ROAD			)
FRESNO	L	LENGTH	
FAR SIDE, FINISHED SURFACE	LAT	LATITUDE	
FACING SOUTHBOUND TRAFFIC	LCB	LEAN CONCRETE B	ASE
FOOTING	LLT	LAST LONG TIE	
FACING WESTBOUND TRAFFIC	LN	LANE	
FREEWAY	LOC	LOCATION	
G	LOL	LAYOUT LINE	
	LONG	LONGITUDE	
GRADE, ACCELERATION DUE TO	LONGIT	LONGITUDINAL	
GRAVITY	LS	LUMP SUM, LENGTH	I OF SPIRAL
GAGE	LT	LEFT	
GALVANIZED	LVC	LENGTH OF VERTIC	JAL CURVE
GRADING PLANE		M	
GUARD RAILING			
GIRDER	MAINT	MAINTENANCE	
GALVANIZED STEEL PIPE GUTTER	MAX MB	MAXIMUM	
GOTTER	MBB	METAL BEAM METAL BEAM BARR	IED
(H)	MBGR	METAL BEAM GUAR	
HEIGHT	MED	METAL BEAM GOAR	D RAILING
HOUR	MER	MERCED	
HORIZONTAL DRAIN	MEN	MERCED TO FRESH	0
HEADWALL	MH	MANHOLE	0
HEXAGONAL HEAD	MIN	MINIMUM	
HOT MIXED ASPHALT	MISC	MISCELLANEOUS	
HORIZONTAL		MISCELLANEOUS IF	ON AND STEEL
HINGE POINT, HORSEPOWER	MKR	MARKER	
HIGH PERFORMANCE STEEL	MOD	MODIFIED, MODIFY	
HIGH STRENGTH	MON	MONUMENT	
HIGH-SPEED RAIL	MOW	MAINTENANCE-OF-W	WAY FACILITY
HIGH-SPEED TRAIN	MP	METAL PLATE	
HEADWALL,	MPGR	METAL PLATE GUA	RD RAILING
100-YR HIGH WATER (UNLESS NOTED	MPH	MILES PER HOUR	
OTHERWISE)	MR	MOVEMENT RATING	
HIGH WATER MARK	MSE	MECHANICALLY STA	ABILIZED EARTH
HIGHWAY	MTL	MATERIAL	
T		( N	
IMPORTED BORROW	Ν	NORTH	
INSIDE DIAMETER	NB	NORTHBOUND	
INSIDE FACE	NC	NORMAL CROWN	
INTERIOR	NIC	NOT IN CONTRACT	
INVERT	NO.	NUMBER (MUST HAV	
IRRIGATION	NOS.	NUMBERS (MUST H	
INTERLOCKING SITE	NPS	NOMINAL PIPE SIZ	Ł
	NS	NEAR SIDE	
	NTS	NOT TO SCALE	
JUNCTION		0	
JOINT POLE JOINTED PLAIN CONCRETE PAVEMENT	OBLR	OBLITERATE	
			CONTRACT NO.
CALIFORNIA HIGH-SPE Merced to fre			HSR08-05
CENTRAL VA			DRAWING NO. CV-B0020
CIVIL AND GRADE SE		LANS	SCALE NO SCALE
ABBREVIA			NU SCALE SHEET NO.
SHEET 1	UF 2		

## ( O CONTINUED )

ΡVΙ

PVMT

PVT

QTY

R

R & D

R & S

R/C

RCA

RCB

RCP

RCPA

REINF

RD

REL

REPL

RET

REV

RDWY

RM

RΡ

RR

RSP

RΤ

RTE

RW

R/W

RWY

S

SAE

SALV

SAPP

W. JOHNSEN

CHECKED BY

IN CHARGE C. LEMLEY

08/12/2016

SB

DESCRIPTION

	( U CONTINUED )
OC	OVERCROSSING
OCS	OVERHEAD CONTACT SYSTEM
OD	OUTSIDE DIAMETER
OF	OUTSIDE FACE
OG	ORIGINAL GROUND
OGAC	OPEN GRADED ASPHALT CONCRETE
OH	OVERHEAD
0-0	
OPP	OPPOSITE
	( <u> </u>
Р	PAGE
PAP	PERFORATED ALUMINUM PIPE
РВ	PULL BOX, PHASE BREAK
PC	POINT OF CURVATURE, PRECAST
PCC	POINT OF COMPOUND CURVE.
	PORTLAND CEMENT CONCRETE
РСР	PERFORATED CONCRETE PIPE,
	PRESTRESSED CONCRETE PIPE
PCVC	POINT OF COMPOUND VERTICAL CURVE
PED	PEDESTRIAN
	PEDESTRIAN OVERCROSSING
	PEDESTRIAN UNDERCROSSING
	PERMEABLE MATERIAL
PG	PROFILE GRADE
PG&E	PACIFIC GAS AND ELECTRIC
PI	POINT OF INTERSECTION
PITO	POINT OF INTERSECTION TURNOUT
PJP	PARTIAL JOINT PENETRATION
Æ, PL	PLATE
P/L	PROPERTY LINE
РМ	POST MILE,
	TIME FROM NOON TO MIDNIGHT
PN	PAVING NOTCH
POB	POINT OF BEGINNING
POC	POINT OF HORIZONTAL CURVE
POE	POINT OF END
POT	POINT OF TANGENT
POVC	POINT OF VERTICAL CURVE
PP	PIPE PILE, PLASTIC PIPE,
	POWER POLE
PPL	PREFORMED PERMEABLE LINER
PPP	PERFORATED PLASTIC PIPE
PRC	POINT OF REVERSE CURVE
PRF	PAVEMENT REINFORCING FABRIC
PRVC	POINT OF REVERSE VERTICAL CURVE
PS&E	PLANS, SPECIFICATIONS AND ESTIMATES
PS, P/S	POINT OF SWITCH, PRESTRESSED,
	PARALLELING STATION
PSP	PERFORATED STEEL PIPE
PT	POINT OF TANGENCY
PVC	POLYVINYL CHLORIDE,
	POINT OF VERTICAL CURVE

(P CONTINUED)
POINT OF VERTICAL INTERSECTION PAVEMENT
POINT OF VERTICAL TANGENT
QUANTITY
R
RADIUS
REMOVE AND DISPOSE
REMOVE AND SALVAGE
RATE OF CHANGE
REINFORCED CONCRETE ARCH
REINFORCED CONCRETE BOX
REINFORCED CONCRETE PIPE
REINFORCED CONCRETE PIPE ARCH ROAD
REINFORCED, REINFORCEMENT,
REINFORCING
RELOCATE
REPLACEMENT
RETAINING
REVISED
ROADWAY
ROAD-MIXED
RADIUS POINT,
REFERENCE POINT
RAILROAD
ROCK SLOPE PROTECTION
RIGHT
ROUTE
REDWOOD, RETAINING WALL
RIGHT-OF-WAY
RAILWAY
( <u> </u>
SOUTH, SUPPLEMENT
STRUCTURE APPROACH EMBANKMENT
SALVAGE
STRUCTURAL ALUMINUM PLATE PIPE
SOUTHBOUND
SAND CUSHION, SPIRAL CURVE POINT
SLOTTED CORRUGATED STEEL PIPE
STORM DRAIN
SECOND, SECTION
SEPARATION
SUBGRADE
SHOULDER
SHEET SIMILAR
JIVILAN

(S CONTINUED) SAN JOSE TO MERCED SAN JOAQUIN VALLEY STATION LINE SELECTED MATERIAL SPEC SPECIAL, SPECIFICATIONS SLOTTED PLASTIC PIPE STATE ROUTE STANDALONE RADIO SITE SLOPE STAKE, SUBSTATION SSBM STRAP AND SADDLE BRACKET METHOD STRUCTURAL SECTION DRAIN SSPA STRUCTURAL STEEL PLATE ARCH SSPP STRUCTURAL STEEL PLATE PIPE SSPPA STRUCTURAL STEEL PLATE PIPE ARCH SSRP STEEL SPIRAL RIB PIPE STREET, SPIRAL TANGENT POINT STATION STBB SINGLE THRIE BEAM BARRIER STANDARD STRUCTURE SURF SURFACING SIDEWALK, SOUND WALL SEWER SWITCHING STATION SYMMETRICAL SURFACE 4 SIDES SEMI-TANGENT TABLET TANGENT THRIE BEAM BARRIER TO BE DETERMINED TIMBER TOP OF CURB, TRAIN CONTROL TRAFFIC CONTROL BOX TEMPORARY CONSTRUCTION EASEMENT TELEPHONE TEMP TEMPORARY TOP OF GRADE TECHNICAL MEMORANDUM

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CALIFORNIA

HIGH-SPEED RAIL AUTHORITY

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VITRIF	IED CL
VERTIC	CAL
VIADUO	СТ
VOLUM	-

W	WEST, WIDTH
WB	WESTBOUND
WCB	WORLD COORI
WH	WEEP HOLE
WM	WIRE MESH
WS	WATER SURF.
WSP	WELDED STE
WT	WEIGHT
W∨	WATER VALV
WW	WINGWALL
WWLOL	WINGWALL LA

CR	ROSS SECT
CR	ROSSING
CR	ROSSOVER
(	
YE	AR

YEAR	
YEARS	5

		DESIGNED BY S. WELLS DRAWN BY W. JOHNSEN I5% DESIGN		
ICAL CURVE				
ORIDE,	SJD	SAN JOSE DIRIDON STATION		
GENCY	SIM	SIMILAR	TRK	TRACK
TEEL PIPE	SHT	SHEET	TRANS	TRANSITION
STATION	SHLD	SHOULDER	T/R	TOP OF RAIL
CH, PRESTRESSED,	SG	SUBGRADE	TPSS	TRACTION POWER SUBSTATION
ICATIONS AND ESTIMATES	SEP	SEPARATION	ТРМ	TREATED PERMEABLE MATERIAL
RSE VERTICAL CURVE	SEC	SECOND, SECTION	TPF	TRACTION POWER FACILITY
FORCING FABRIC	SD	STORM DRAIN	TPB	TREATED PERMEABLE BASE
RSE CURVE	SCSP	SLOTTED CORRUGATED STEEL PIPE	TP	TELEPHONE POLE
_ASTIC PIPE	SC	SAND CUSHION, SPIRAL CURVE POINT	ТОТ	TOTAL

SUBMITTAL

NOT FOR

CONSTRUCTION

REV DATE BY CHK APP

# (T CONTINUED)

SE, TRAFFIC SIGNAL, STEEL, TANGENT SPIRAL POINT

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THERWISE NOTED

CIFIC RAILROAD UNIVERSAL CROSSOVER

V

ED, VALVE

JRVE LAY PIPE

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RDINATE BEARING

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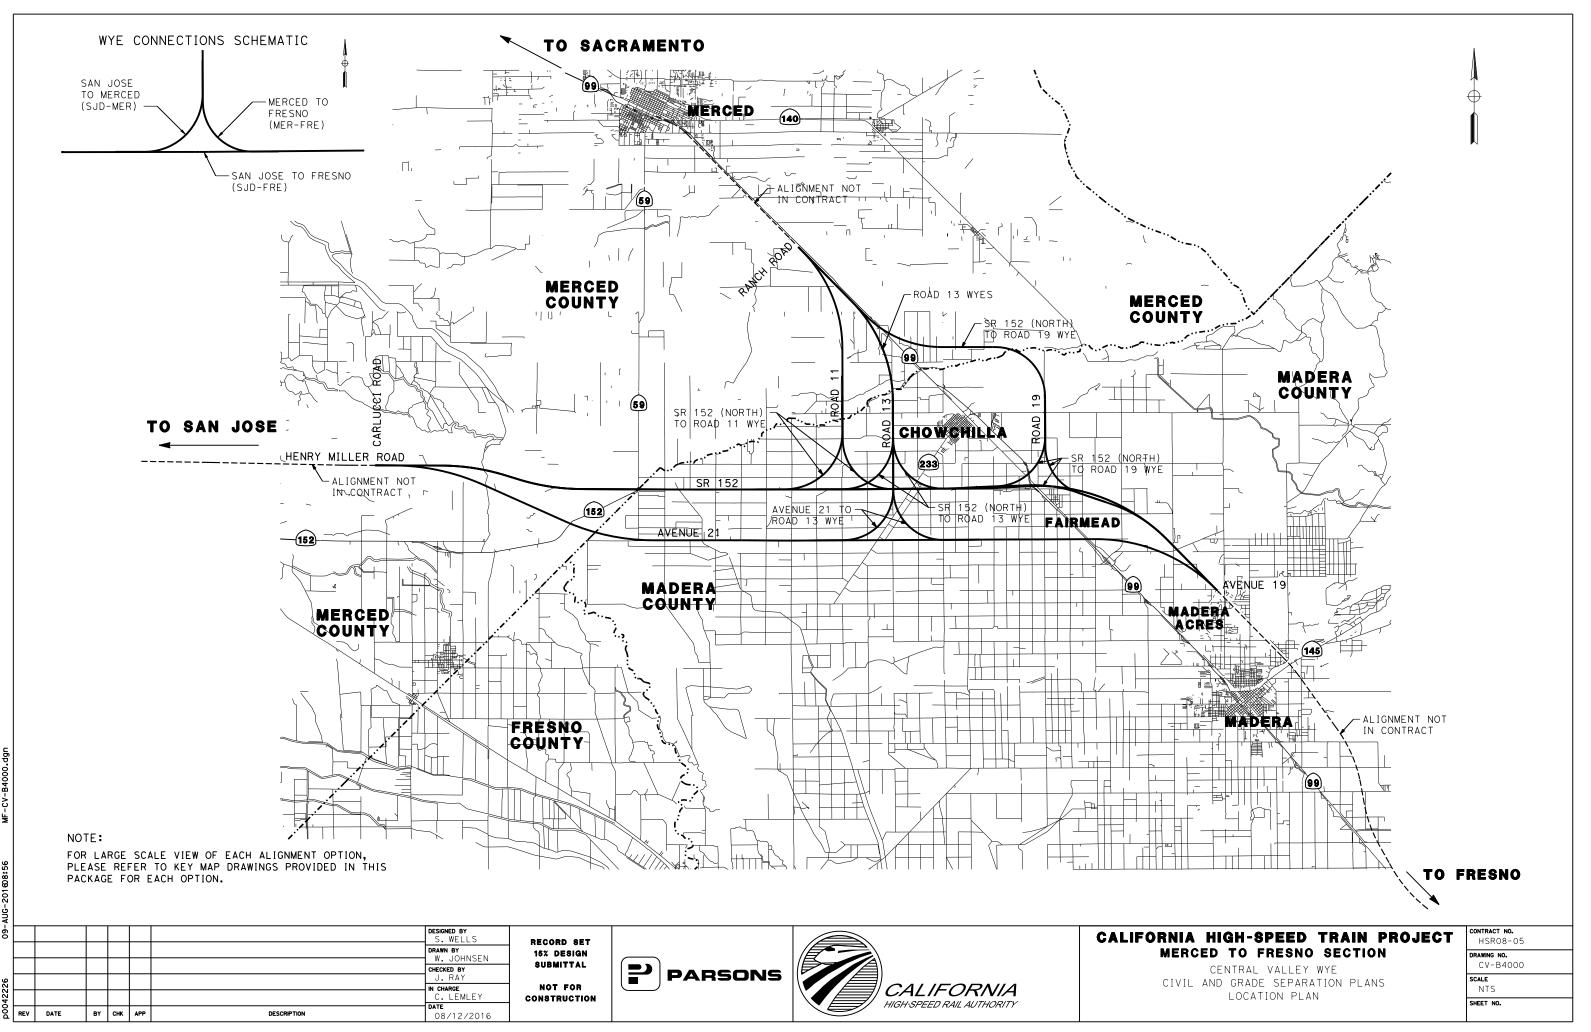
### CALIFORNIA HIGH-SPEED TRAIN PROJECT MERCED TO FRESNO SECTION CENTRAL VALLEY WYE

CIVIL AND GRADE SEPARATION PLANS ABBREVIATIONS SHEET 2 OF 2

ONTRACT NO. HSR08-05 RAWING NO.

CV-B0021

NO SCALE



VUG-201608:56 MF-CV-B400

### **GENERAL NOTES:**

201

- 1. DESIGN IS BASED ON THE FOLLOWING STANDARDS:
  - CALIFORNIA HIGH-SPEED RAIL AUTHORITY DIRECTIVE DRAWINGS FOR HIGH-SPEED RAIL PROJECT FACILITIES
  - CALTRANS HIGHWAY DESIGN MANUAL FOR STATE HIGHWAY FACILITIES LOCAL AGENCY STANDARDS FOR ALL OTHER FACILITIES
- 2. THE HORIZONTAL CONTROL DATUM IS NAD 83. ALL ELEVATIONS ARE BASED ON NAVD 88.
- 3. ALL MAJOR UTILITIES ARE SHOWN ON THE PLANS. PLEASE REFERENCE THE SECTION UTILITY REPORT FOR A DISCUSSION OF HIGH VS. LOW RISK AND MINOR UTILITIES.
- 4. RETAINING WALL TYPES ARE NOT SHOWN DUE TO CURRENT LACK OF GEOTECHNICAL BORINGS. TT CAN BE ASSUMED FOR COST PURPOSES THAT ALL FILL RETAINING WALLS ARE MSE AND THAT ALL CUT RETAINING WALLS ARE SOIL NAIL. PRELIMINARY RETAINING WALL TYPES WILL BE FINALIZED BASED ON SUBSEQUENT GEOTECHNICAL EXPLORATION.
- 5. MAJOR WATERCOURSES, IRRIGATION CANALS, AND BODIES OF WATER ARE SHOWN ON THE PLANS. FOR FURTHER INFORMATION REGARDING DRAINAGE DESIGN, PLEASE REFER TO THE FOLLOWING:
  - HYDROLOGY AND HYDRAULICS REPORT
     FLOODPLAIN IMPACTS ASSESSMENT REPORT

  - STORM WATER MANAGEMENT REPORT
  - STRUCTURE, VIADUCT AND TUNNEL PLANS (FOR FLOW DIRECTION)
- 6. WHERE PROPOSED ROADWAY R/W AND ROADWAY TCE LINES CROSS PERPENDICULAR TO EXISTING ROADWAY R/W LINES, IT IS ASSUMED THESE LINES SHOW A DEMARCATION OF CONSTRUCTION LIMITS. THEY ARE NOT INTENDED TO BE CONSTRUED AS A JURISDICTIONAL TRANSFER.
- 7. EMERGENCY VEHICLE ACCESS SHALL BE MAINTAINED AT ALL TIMES.
- 8. CUL-DE-SACS WERE DESIGNED BASED ON MERCED COUNTY STANDARD (ST-12).
- 9. METAL BEAM GUARD RAILING WAS DESIGNED PER CALTRANS STANDARD PLANS (A77) AND AASHTO ROADSIDE DESIGN GUIDE (TABLE 5-10).

20042226 09-/ 22		BY	СНК	APP	DESCRIPTION	DESIGNED BY S. WELLS DRAWN BY W. JOHNSEN CHECKED BY J. RAY IN CHARGE C. LEMLEY DATE OR (12/2016	RECORD SET 15% design Submittal Not for Construction	PARSONS	CALIFORNIA HIGH-SPEED RAIL AUTHORITY	CALIFO
C RE	V DATE	BY	СНК	APP	DESCRIPTION	08/12/2016				

# RNIA HIGH-SPEED TRAIN PROJECT MERCED TO FRESNO SECTION CENTRAL VALLEY WYE

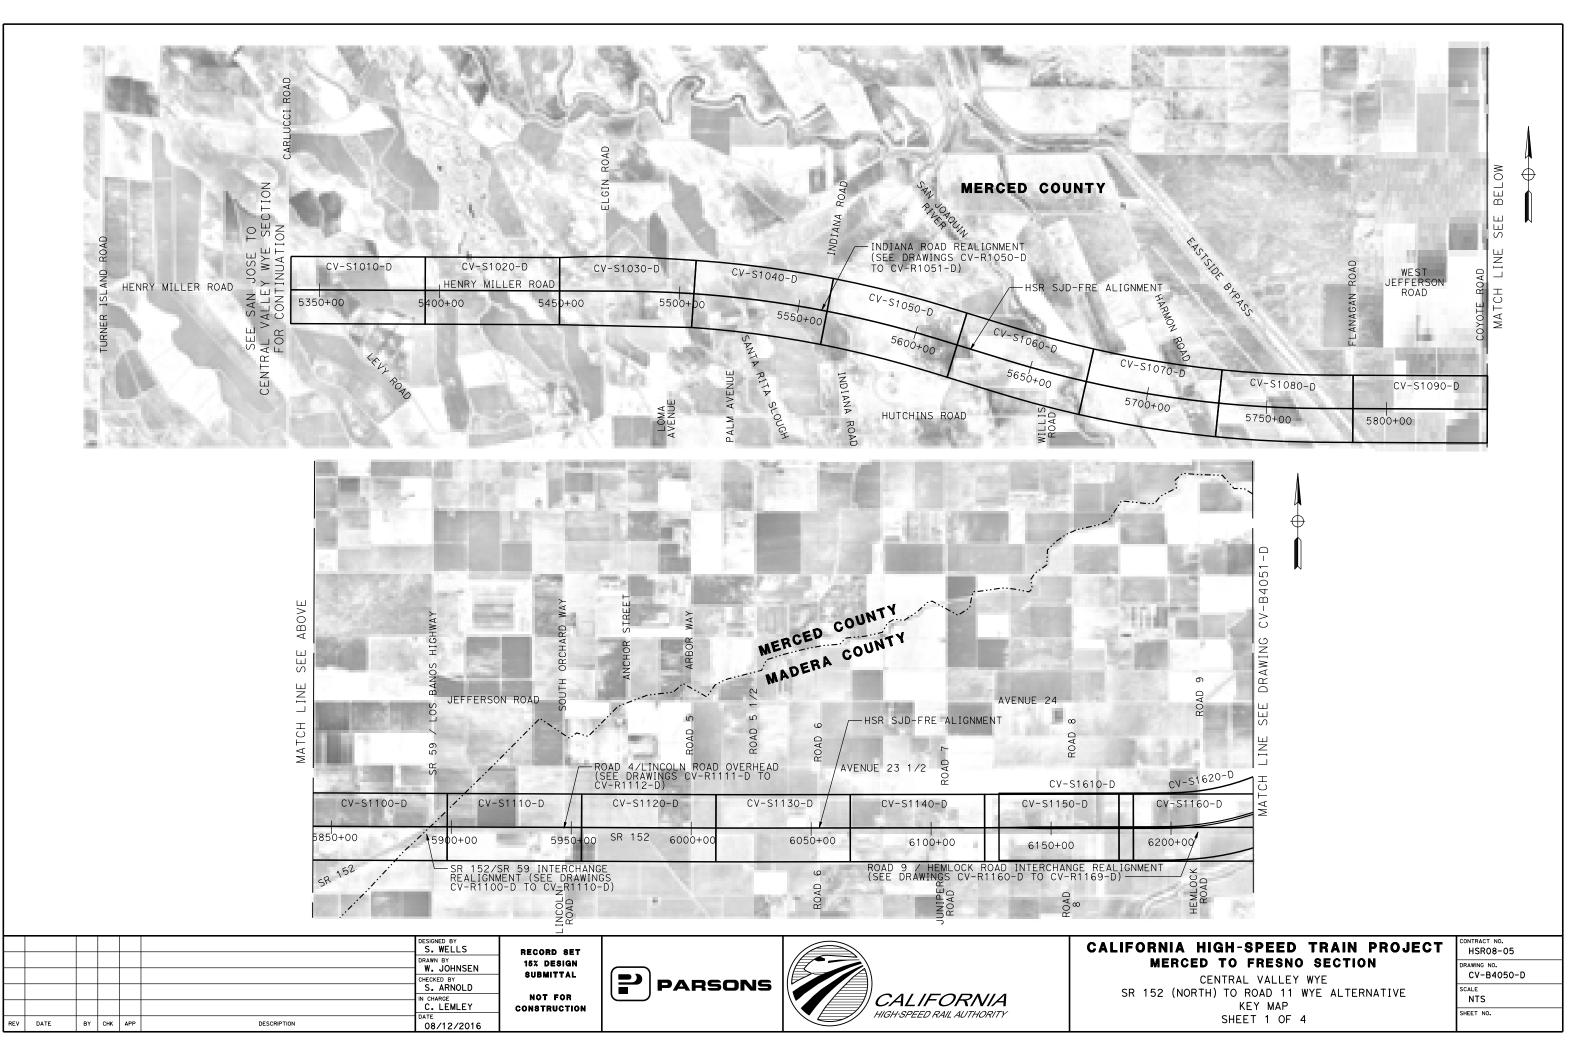
CIVIL AND GRADE SEPARATION PLANS GENERAL NOTES

NTRACT NO HSR08-05

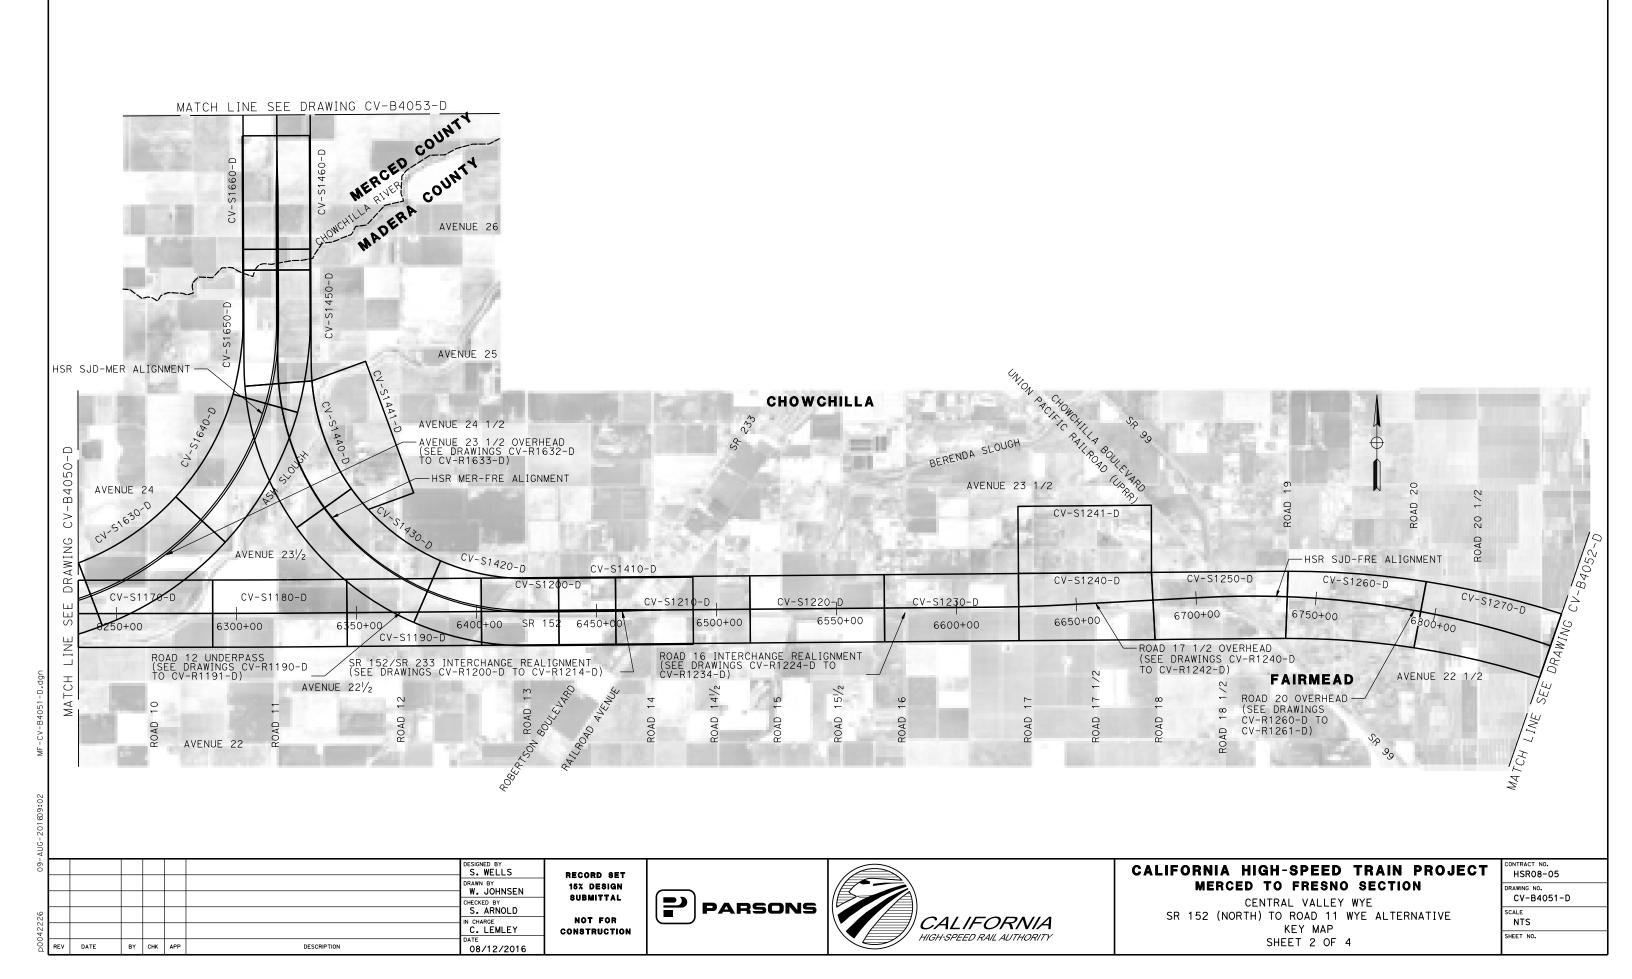
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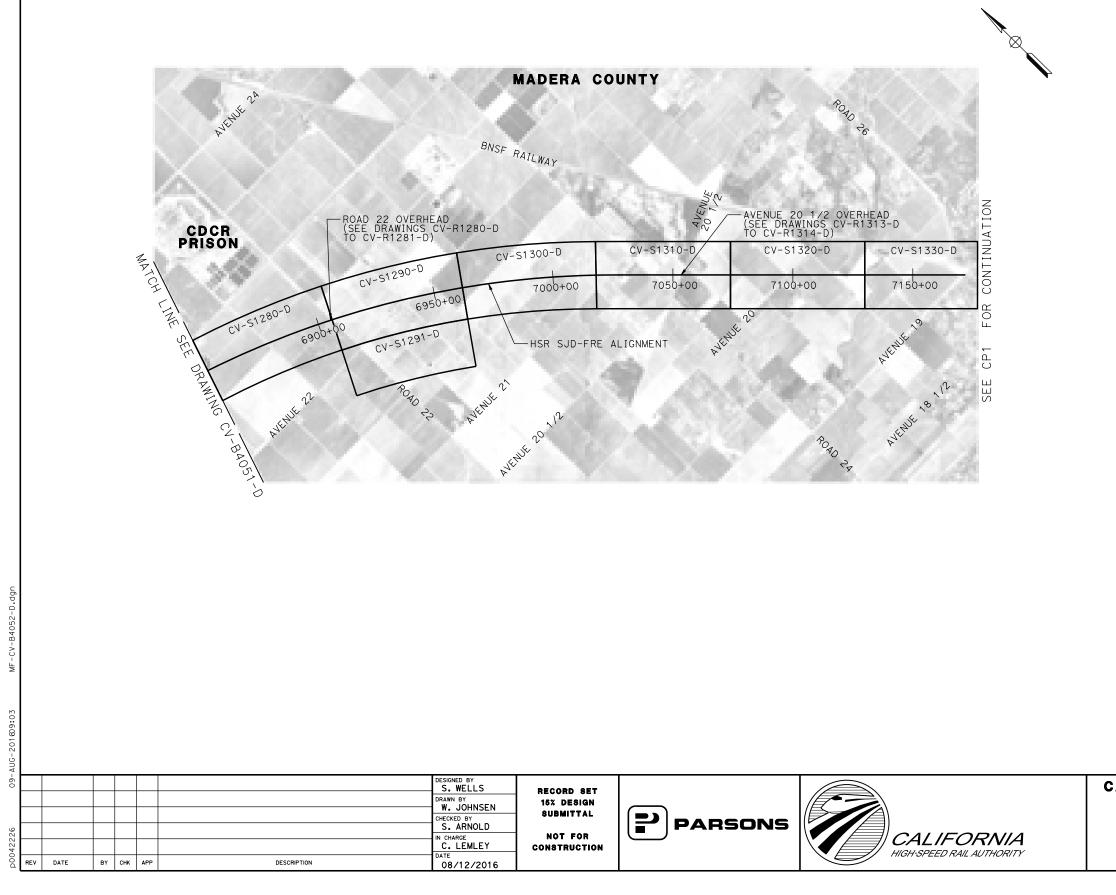
CV-B0030

NO SCALE



16-AUG-201610:54





# CALIFORNIA HIGH-SPEED TRAIN PROJECT MERCED TO FRESNO SECTION CENTRAL VALLEY WYE SR 152 (NORTH) TO ROAD 11 WYE ALTERNATIVE KEY MAP SHEET 3 OF 4

ONTRACT NO. HSR08-05

DRAWING NO.
CV-B4052-D
SCALE
NTS

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CALIFORNIA HIGH-SPEED TRAIN PROJECT MERCED TO FRESNO SECTION CENTRAL VALLEY WYE SR 152 (NORTH) TO ROAD 11 WYE ALTERNATIVE KEY MAP SHEET 4 OF 4

CONTRACT NO. HSR08-05

-D

DRAWING NO. CV-B4053
SCALE NTS
SHEET NO.

ROAD "ALIGNMENT NAME"	CURVE NO.		BC	PI	СС	EC	RADIUS (FT)	DELTA $ riangle  ext{DELTA}$	DEGREE OF CURVATURE (ARC)	LENGTH (FT)	TANGEN (FT)
		STATION	45+25.89	51+56.52		57+85.49	10,000.00	7°13′01''	0° 34′23''	1,259.60	630.63
	030-01	NORTHING	1858106.10	1858106.10	1848106.10	1858026.88		RIGHT			
HENRY MILLER ROAD		EASTING	6525127.39	6525758.03	6525127.39	6526383.67					
"HENRY MILLER RD"		STATION	107+69.71	111+45.55		115+04.08	1,400.00	30°03′16"	4° 05′33''	734.37	375.8
	030-02	NORTHING	1857400.72	1857353.51	1858789.63	1857499.38		LEFT			
		EASTING	6531328.40	6531701.26	6531504.28	6532047.64					
		STATION	24+12.02	36+20.81		46+85.09	2,700.00	48°14′09''	2° 07 ′ 19''	2,273.07	1,208.
	050-01	NORTHING	1855871.61	1857038.63	1856575.18	1858050.89		LEFT			
INDIANA ROAD	-	EASTING	6532459.79	6532774.78	6529853.07	6532114.10					
"INDIANA RD"		STATION	50+03.45	58+17.71		65+50.00	2,000.00	44°18′20''	2° 51 ′53''	1,546.55	814.2
	050-02	NORTHING	1858317.49	1858999.37	1859410.61	1859798.19		RIGHT			
		EASTING	6531940.1	6531495.06	6533614.94	6531652.85					
		STATION	13+00.00	18+01.57		20+86.97	500.00	90°10′48''	1 1° 27′33''	786.97	501.
COYOTE ROAD "COYOTE RD"	090-01	NORTHING	1852469.88	1852971.46	1852469.88	1852969.88		RIGHT			
		EASTING	6558672.51	6558672.51	6559172.51	6559174.08					
		STATION	12+03.86	14+20.96		16+37.98	9,700.00	2°33′51.22″	0° 35′26.44″	434.12	217.
	100-01	NORTHING	1850801.75	1850900.75	1842169.09	1850991.01		RIGHT			
		EASTING	6559575.36	6559768.57	6563998.84	6559966.01					
		STATION	22+10.04	53+19.69		83+68.55	17,999.00	19°36′15.24″	0°19′05.98″	6,158.51	3,109
SR 152 REALIGNMENT AT SR 59 "SR 152/SR 59"	100-02	NORTHING	1851228.85	1852521.7	1834859.18	1852790.71		RIGHT			
31( 132/31( 33		EASTING	6560486.29	6563314.44	6567969.48	6566412.44					
		STATION	93+42.18	97+71.35		101+99.97	9,700.00	5°04′00.52"	0° 35′26.44″	857.80	429.
	100-03	NORTHING	1852874.94	1852912.06	1843211.30	1852911.28		RIGHT			
		EASTING	6567382.41	6567809.98	6568221.53	6568239.16					
		STATION	26+96.94	28+32.35		29+67.75	17,921.00	0°51′56.88"	0°19′10.97″	270.81	135.
	101-01	NORTHING	1851353.47	1851395.65	1834323.78	1851435.87		RIGHT			
		EASTING	6560962.29	6561090.96	6566543.68	6561220.25					
		STATION	33+03.48	36+84.30		40+61.06	3,000.00	14°28′07.46"	1° 54′35.49''	757.58	380.
	101-02	NORTHING	1851535.6	1851648.72	1848671.01	1851667.40		RIGHT			
EB SR 152 TO NB SR 59 RAMP	-	EASTING	6561540.84	6561904.46	6562431.98	6562284.82					
"EB OFF RAMP"		STATION	46+06.33	58+06.44		64+91.40	1,200.00	90°00′19.45"	4° 46′28.73''	1,885.07	1,200
	101-03	NORTHING	1851694.15	1851753.02	1852892.70	1852951.68		LEFT			
		EASTING	6562829.43	6564028.1	6562770.57	6563969.12					
		STATION	78+16.20	78+94.50		79+72.76	3,000.00	2°59′24.27″	1° 54′35.49''	156.56	78.3
	101-04	NORTHING	1854274.88	1854353.09	1854422.33	1854431.38		RIGHT			
		EASTING	6563904.01	6563900.16	6566900.38	6563900.39					
		STATION	37+27.63	38+77.64		40+27.63	18,077.00	0°57′03.14''	0°19′01.03''	300.00	150.
	102-01	NORTHING	1851874.32	1851927.78	1834984.69	1851978.92		RIGHT			
		EASTING	6561865.11	6562005.26	6568308.60	6562146.28					
		STATION	40+27.63	41+11.19		41+94.72	3,594.62	2°39′47.43″	1° 35′38.16"	167.08	83.5
SB SR 59 TO WB SR 152 RAMP "WB ON RAMP"	102-02	NORTHING	1851978.92	1852007.4	1855358.23	1852039.51		LEFT			
		EASTING	6562146.28	6562224.84	6560920.91	6562301.98					
		STATION	49+38.86	57+28.63		63+59.29	1,305.00	62°21′49.18"	4°23′25.73''	1,420.43	789.
	102-03	NORTHING	1852325.41	1852628.85	1853530.25	1853415.56		LEFT			
		EASTING	6562989.01	6563718.16	6562487.62	6563787.57					

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226 09-4							DESIGNED BY S. WELLS DRAWN BY W. JOHNSEN CHECKED BY J. RAY	RECORD SET 15% design Submittal Not for	PARSONS		CALIFORNI MEI SR 152
p0042	REV	DATE	BY	снк	APP	DESCRIPTION	C. LEMLEY DATE 08/12/2016	CONSTRUCTION		HIGH-SPEED RAIL AUTHORITY	

NIA HIGH-SPEED TRAIN PROJECT IERCED TO FRESNO SECTION

CENTRAL VALLEY WYE (NORTH) TO ROAD 11 WYE ALTERNATIVE GEOMETRY DATA TABLE SHEET 1 OF 6

CONTRAC	T NO.
HSR	08-05
DRAWING	NO.

CV-B0060-D

NO SCALE

ROAD "ALIGNMENT NAME"	CURVE NO.		BC	ΡI	СС	EC	RADIUS (FT)	DELTA riangle TA	DEGREE OF CURVATURE (ARC)	LENGTH (FT)	TANGENT (FT)
		STATION	52+03.54	53+67.46		55+31.05	3,000.00	6°15′17.78''	1°54′35.49''	327.51	163.92
WB SR 152 TO NB SR 59 RAMP "WB OFF RAMP"	103-01	NORTHING	1853976.13	1853812.6	1854183.46	1853651.29		LEFT			
	-	EASTING	6563936.73	6563948.06	6566929.56	6563977.13					
		STATION	55+31.05	63+97.93		69+59.47	1,000.00	81°50′33.51″	5°43′46.48″	1,428.42	866.88
	103-02	NORTHING	1853651.29	1852798.16	1853828.68	1852829.33		LEFT			
	-	EASTING	6563977.13	6564130.91	6564961.27	6564997.23					
		STATION	77+47.81	80+63.60		83+79.32	18,077.00	2°00′05.77"	0°19′01.03″	631.51	315.79
	103-03	NORTHING	1852857.67	1852869.02	1834792.36	1852869.35		RIGHT			
SB SR 59 TO EB SR 152 LOOP ON RAMP "EB LOOP RAMP"		EASTING	6565785.06	6566100.64	6566435.00	6566416.43					
		STATION	45+66.64			50+57.29	150.00	187°24′58.88″	38°11′49.87″	490.65	0.00
SB SR 59 TO EB SR 152 LOOP ON RAMP	104-01	NORTHING	1851816.07		1851950.65	1852092.65		RIGHT			
		EASTING	6563300.54		6563234.29	6563185.97					
		STATION	53+88.24	54+71.80		55+55.31	2,570.00	3°43′28.19''	2°13′45.87″	167.06	83.56
	104-02	NORTHING	1852199.27	1852226.18	1849766.26	1852247.91		RIGHT			
		EASTING	6563499.28	6563578.38	6564327.17	6563659.07					
		STATION	55+55.31	57+05.36		58+55.41	17,921.00	0°57′34.14″	0°19′10.97″	300.11	150.06
	104-03	NORTHING	1852247.91	1852286.91	1834943.04	1852323.49		RIGHT			
		EASTING	6563659.07	6563803.97	6568317.82	6563949.50					
		STATION	14+30.85	18+97.60		23+61.75	5,100.00	10°27′29.06"	1°07′24.41″	930.89	466.74
	160-01	NORTHING	1852856.89	1852856.05	1847756.90	1852770.49		RIGHT			
		EASTING	6592662.51	6593129.26	6592653.25	6593588.09					
		STATION	31+86.42	36+65.87		41+42.52	5,100.00	10°44′28.52″	1°07′24.41″	956.10	479.45
	160-02	NORTHING	1852619.33	1852531.44	1857632.91	1852532.94		LEFT			
SR 152 REALIGNMENT AT ROAD 9		EASTING	6594398.79	6594870.12	6595333.63	6595349.57					
"SR 152/ROAD 9"	160-03	STATION	52+03.02	56+66.40		61+27.24	5,100.00	10°22′59.34"	1°07′24.41″	924.22	463.38
		NORTHING	1852536.25	1852537.7	1857636.23	1852622.64		LEFT			
		EASTING	6596410.07	6596873.45	6596394.13	6597328.98					
		STATION	69+37.21	74+00.59		78+61.43	5,100.00	10°22′59.34"	1°07′24.41″	924.22	463.38
	160-04	NORTHING	1852771.11	1852856.05	1847757.52	1852857.5		RIGHT			
	-	EASTING	6598125.22	6598580.75	6599060.06	6599044.13					
		STATION	25+62.64	28+26.67		30+89.34	3,000.00	10°03′32.93"	1° 54′35.49″	526.70	264.03
	161-01	NORTHING	1852632.87	1852562.61	1849741.01	1852448.99		RIGHT			
ROAD 9/SR 152 EB OFF RAMP	-	EASTING	6593767.2	6594021.71	6592968.96	6594260.03					
"EB OFF RAMP"		STATION	38+53.84	41+86.88		45+09.29	1,500.00	25°02′11.73″	3°49′10.99"	655.46	333.04
	161-02	NORTHING	1852119.98	1851976.65	1853473.97	1851974.01		LEFT			
	-	EASTING	6594950.11	6595250.74	6595595.65	6595583.77					
		STATION	46+58.21	49+60.83		52+55.44	1,500.00	22°48′44.95″	3°49′10.99''	597.23	302.62
	162-01	NORTHING	1851984.11	1851984.11	1853484.11	1852101.44		LEFT			
ROAD 9/SR 152 EB ON RAMP	F	EASTING	6595983.41	6596286.03	6595983.41	6596564.98					
"EB ON RAMP"		STATION	62+99.90	65+91.52		68+81.32	3,000.00	11°06′15.69"	1°54′35.49″	581.42	291.62
ROAD 9/SR 152 EB ON RAMP "EB ON RAMP"	162-02	NORTHING	1852506.39	1852619.46	1849741.06	1852678.64		RIGHT			
	-	EASTING	6597527.74	6597796.56	6598690.89	6598082.11					



- AL							
-60			DESIGNED BY	RECORD SET			CALIFORNIA HIGH-SPEED TRAIN PROJECT
			DRAWN BY W. JOHNSEN	15% DESIGN			MERCED TO FRESNO SECTION
			CHECKED BY	SUBMITTAL	PARSONS		CENTRAL VALLEY WYE
226			J. RAY	NOT FOR			SR 152 (NORTH) TO ROAD 11 WYE ALTERNATIVE
0423			C. LEMLEY	CONSTRUCTION		HIGH-SPEED RAIL AUTHORITY	GEOMETRY DATA TABLE
Öd	REV DATE BY CHK	APP DESCRIPTION	08/12/2016				SHEET 2 OF 6

CONTRACT NO. HSR08-05 DRAWING NO. CV-B0061-D

SCALE NO SCALE

ROAD "ALIGNMENT NAME"	CURVE NO.		BC	PI	сс	EC	RADIUS (FT)	DELTA $ riangle  ext{DELTA}$	DEGREE OF CURVATURE (ARC)	LENGTH (FT)	TANGE (FT)
		STATION	35+12.64	35+84.78		36+25.88	72.00	90°06′45.82″	79°34′38.90″	113.24	72.14
	163-01	NORTHING	1852074.00	1852001.86	1852074.43	1852002.43		RIGHT			
		EASTING	6595855.99	6595855.56	6595783.99	6595783.42					
		STATION	37+87.02	66+21.04		43+87.16	200.00	171°55′35.46"	28°38′52.40″	600.14	2,834
ROAD 9/SR 152 EB LOOP RAMP "FB LOOP RAMP"	163-02	NORTHING	1852003.71	1852026.15	1852203.70	1852401.94		RIGHT			
		EASTING	6595622.28	6592788.35	6595623.86	6595597.34					
		STATION	45+73.35	47+38.32		49+02.96	3,000.00	6°17′42.07''	1°54′35.49″	329.61	164.
	163-03	NORTHING	1852426.63	1852448.5	1849453.12	1852452.32		RIGHT			
		EASTING	6595781.89	6595945.41	6596179.69	6596110.33					
		STATION	29+35.25	34+55.35		39+65.22	3,000.00	19°40′15''	1° 54′35''	1,029.97	520.
	164-01	NORTHING	1852746.97	1852661.88	1855706.55	1852754.47		LEFT			
ROAD 9/SR 152 WB ON RAMP		EASTING	6594167.03	6594680.13	6594657.86	6595191.92					
"WB ON RAMP"		STATION	42+15.63	43+50.22		44+84.09	1,500.00	10°15′16''	3° 49′11''	268.46	134.
	164-02	NORTHING	1852799.04	1852823.00	1851323.00	1852823.00		RIGHT			
		EASTING	6595438.33	6595570.77	6595705.36	6595705.36					
		STATION	64+97.60	65+49.41		66+01.18	1,500.00	3° 57′24''	3° 49′11''	103.59	51.
	165-01	NORTHING	1852835.00	1852835.00	1854335.00	1852838.58		LEFT			
ROAD 9/SR 152 WB OFF RAMP	-	EASTING	6597675.09	6597726.91	6597675.09	6597778.60					
"WB OFF RAMP"		STATION	68+52.53	70+08.53		71+64.43	5,177.00	3° 27′07''	1° 06′24''	311.91	156.
	165-02	NORTHING	1852855.92	1852866.69	1847691.26	1852868.06		RIGHT			
		EASTING	6598029.34	6598184.97	6598386.57	6598340.97					
		STATION	16+58.51	19+93.30		23+28.03	20,000.00	1° 55′05''	0°17′11''	669.52	334.
	190-01	NORTHING	1852891.29	1852893.15	1832891.60	1852883.80		RIGHT			
		EASTING	6608708.28	6609043.06	6608819.08	6609377.72					
		STATION	29+28.03	32+56.66		35+85.22	20,000.00	1° 52′58''	0°17′11''	657.19	328.
	190-02	NORTHING	1852867.04	1852857.86	1872859.24	1852859.48		LEFT			
SR 152 REALIGNMENT AT ROAD 12	-	EASTING	6609977.49	6610305.99	6610536.13	6610634.61					
"SR 152/ROAD 12"		STATION	55+07.23	58+54.27		62+01.23	20,000.00	1° 59′17''	0°17′11''	694.00	347.
	190-03	NORTHING	1852868.94	1852870.65	1872868.70	1852884.40		LEFT			
	-	EASTING	6612556.59	6612903.62	6612458.12	6613250.39					
		STATION	68+01.23	71+42.10		74+82.91	20,000.00	1° 57′10''	0°17′11''	681.67	340.
	190-04	NORTHING	1852908.17	1852921.67	1832923.86	1852923.56		RIGHT			
		EASTING	6613849.92	6614190.52	6614642.19	6614531.38					
		STATION	102+81.31	106+94.07		111+05.02	5,088.50	9°16′29.19"	1°07′33.55″	823.70	412.
	200-01	NORTHING	1852936.63	1852938.67	1847848.20	1852874.15	,	RIGHT			
		EASTING	6617571.49	6617984.24	6617596.55	6618391.92					
		STATION	120+30.32	124+39.39		128+46.71	5,100.00	9°10′18.20''	1°07′24.41″	816.39	409.
	200-02	NORTHING	1852729.52	1852665.58	1857766.83	1852666.85		LEFT			
CD 152 DEAL IONNENT AT CD 277		EASTING	6619305.85	6619709.89	6620103.02	6620118.96					
SR 152 REALIGNMENT AT SR 233 "SR 152/SR 233"		STATION	139+46.65	143+98.52		148+48.04	5,100.00	10°07′35.70"	1°07′24.41″	901.39	451.
	200-03	NORTHING	1852670.29	1852671.70	1857770.27	1852752.54	-,	LEFT			
		EASTING	6621218.89	6621670.76	6621202.96	6622115.34					
		STATION	155+40.07	159+48.84		163+55.87	5,088.50	9°11′08.76''	1° 07′33.55″	815.80	408.
	200-04	NORTHING	1852876.35	1852949.48	1847869.94	1852957.47	-,	RIGHT			
		EASTING	6622796.21	6623198.39	6623706.54	6623607.09					
		STATION	13+02.73	15+74.24	0020100.04	18+42.45	2,000.00	15°27′43.13''	2° 51′53.24''	539.72	271.
SR 233/SR 152 EB OFF RAMP	201-01	NORTHING	1852725.08	1852655.69	1850791.51	1852518.82	2,000.00	RIGHT		555.12	
"EB OFF RAMP"		EASTING	6618732.18	6618994.67	6618221.00	6619229.16		N10III			

Image: style	CALIFORNIA HIGH-SPEED RAIL AUTHORITY	ALIFORNIA HIGH-SPEED TRAIN PROJECT MERCED TO FRESNO SECTION CENTRAL VALLEY WYE SR 152 (NORTH) TO ROAD 11 WYE ALTERNATIVE GEOMETRY DATA TABLE SHEET 3 OF 6
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30062-MF-CV-22-NOV-201615:08

p0021811

CONTRACT NO. HSR08-05 DRAWING NO. CV-B0062-D SCALE NO SCALE

ROAD "ALIGNMENT NAME"	CURVE NO.		BC	ΡI	СС	EC	RADIUS (FT)	DELTA A	DEGREE OF CURVATURE (ARC)	LENGTH (FT)	TANGEI (FT)
		STATION	10+00.00	10+86.90		11+39.78	93.00	86°06′50.38"	61° 36′30.11″	139.78	86.90
	202-01	NORTHING	1852116.15	1852044.25	1852168.37	1852088.05		RIGHT			
		EASTING	6620190.24	6620141.45	6620113.28	6620066.40					
		STATION	13+02.25	19+40.71		18+09.14	200.00	145°12′47.90″	28°38′52.40″	506.89	638.4
SR 233/SR 152 EB LOOP RAMP "EB LOOP RAMP"	202-02	NORTHING	1852169.95	1852491.79	1852342.68	1852542.06		RIGHT			
		EASTING	6619926.08	6619374.67	6620026.90	6620011.15					
		STATION	22+51.67	23+35.24		24+18.76	3,000.00	3°11′28.67″	1° 54′35.49''	167.10	83.5
	202-03	NORTHING	1852576.90	1852583.48	1849586.22	1852585.42		RIGHT			
		EASTING	6620452.30	6620535.61	6620688.52	6620619.16					
		STATION	16+72.81	22+15.00		27+45.61	3,000.00	20° 29′20''	1° 54′35''	1,072.80	542.
	203-01	NORTHING	1852867.39	1852793.36	1855839.30	1852912.03		LEFT			
SR 233/SR 152 WB ON RAMP		EASTING	6618965.65	6619502.76	6619375.23	6620031.81					
"WB ON RAMP"		STATION	31+35.85	32+43.86		33+45.37	350.00	34°17′55''	16°22′13''	209.52	108.
	203-02	NORTHING	1852997.44	1853021.07	1852655.92	1852981.22		RIGHT			
	-	EASTING	6620412.59	6620517.98	6620489.19	6620618.36					
		STATION	12+18.03	15+67.22		18+50.52	600.00	60°23′53.55"	9° 32′57.47''	632.49	349.
	210-01	NORTHING	1851893.73	1851717.71	1852411.92	1851892.98		LEFT			
SR 233/SR 152 EB ON RAMP "EB ON RAMP" SR 233/SR 152 WB OFF RAMP	-	EASTING	6620323.95	6620625.53	6620626.40	6620927.55					
		STATION	29+50.66	34+43.98		39+28.54	3,000.00	18°40′34.42″	1° 54′35.49''	977.88	493.
	210-02	NORTHING	1852445.17	1852692.78	1849850.44	1852790.72	,	RIGHT			
	-	EASTING	6621879.08	6622305.75	6623384.86	6622789.25					
		STATION	37+30.21	38+77.53		40+19.14	600.00	27° 35′29''	9° 32′57''	288.94	147.
	211-01	NORTHING	1852847.48	1852793.11	1853405.13	1852808.35		LEFT			
		EASTING	6620987.67	6621124.60	6621209.10	6621271.14					
"WB OFF RAMP"		STATION	52+23.14	54+44.03		56+64.66	5,177.00	4° 53′11''	1° 06′24''	441.52	220.
	211-02	NORTHING	1852932.83	1852955.67	1847783.58	1852959.71	,	RIGHT			
		EASTING	6622468.68	6622688.39	6623003.95	6622909.25					
		STATION	14+25.89	19+02.52		23+76.40	5,100.00	10°40′42.20″	1°07′24.41″	950.50	476.
	220-01	NORTHING	1853031.56	1853042.05	1847932.80	1852964.06	-,	RIGHT			
		EASTING	6629753.42	6630229.94	6629865.63	6630700.14					
		STATION	28+57.10	33+02.66		37+45.96	5,100.00	9° 59′09.18''	1° 07′24.41″	888.86	445.
	220-02	NORTHING	1852885.4	1852812.49	1857916.66	1852816.91	, , , , , , , , , , , , , , , , , , , ,	LEFT			
SR 152 REALIGNMENT AT ROAD 16		EASTING	6631174.37	6631613.92	6632008.89	6632059.46					
"SR 152/ROAD 16"		STATION	48+64.72	53+03.74		57+40.60	5,100.00	9°50′24.30''	1°07′24.41″	875.88	439.
	220-03	NORTHING	1852828.00	1852832.36	1857927.75	1852911.67	-,	LEFT			
		EASTING	6633178.16	6633617.16	6633127.59	6634048.96					
		STATION	63+83.13	68+31.57		72+77.70	5,100.00	10°03′00.07"	1°07′24.41″	894.57	448.
	220-04	NORTHING	1853027.75	1853108.76	1848011.67	1853111.57		RIGHT			
		EASTING	6634680.92	6635121.98	6635602.29	6635570.4					
		STATION	16+67.72	23+35.36		29+95.16	5,000.00	15°12′40.64″	1°08′45.30″	1,327.44	667.
	221-01	NORTHING	1852981.15	1852877.22	1848042.10	1852603.89		RIGHT		.,	
		EASTING	6629993.95	6630653.46	6629215.62	6631262.59					
ROAD 16/SR 152 EB OFF RAMP "EB OFF RAMP"		STATION	34+96.52	38+17.64	0020210102	41+29.21	1,500.00	24°10′00.28''	3°49′10.99″	632.68	321.
	221-02	NORTHING	1852398.63	1852267.17	1853767.17	1852267.17	.,000100	LEFT			
	221-02										

22-N0							DESIGNED BY S. WELLS DRAWN BY W. JOHNSEN CHECKED BY J. RAY	RECORD SET 15% design Submittal	PARSONS		CALIFORN
p0021811	REV	V DATE	BY	СНК	APP	DESCRIPTION	D. RAT IN CHARGE C. LEMLEY DATE 09/09/2016	NOT FOR Construction		CALIFORNIA HIGH-SPEED RAIL AUTHORITY	SR 152

# NIA HIGH-SPEED TRAIN PROJECT MERCED TO FRESNO SECTION

CENTRAL VALLEY WYE 52 (NORTH) TO ROAD 11 WYE ALTERNATIVE GEOMETRY DATA TABLE SHEET 4 OF 6

CONTRAC	T NO.
HSR	05-05
DRAWING	NO.

CV-B0063-D

NO SCALE

		DESIGNED BY									
		EASTING	6646962.95	6647041.43	6649261.46	6647127.26					
	250-03	NORTHING	1853410.83	1853317.26	1855338.75	1853230.38		LEFT			
		STATION	23+95.89	25+18.01		26+40.00	3,000.00	4° 39′44''	1° 54′35''	244.11	122.
		EASTING	6646485.81	6646671.97	6644531.17	6646829.67					
FAIRMEAD BLVD REALIGNMENT 2	250-02	NORTHING	1853917.63	1853757.74	1851641.81	1853569.73		RIGHT			
		STATION	16+98.79	19+44.19		21+88.49	3,000.00	9°21′10''	1° 54′35″	489.71	245.
		EASTING	6646152.11	6646238.46	6648286.31	6646331.67					
	250-01	NORTHING	1854217.48	1854130.08	1856325.85	1854050.03		LEFT			
		STATION	12+50.00	13+72.86		14+95.59	3,000.00	4° 41 ′26''	1° 54′35''	245.59	122.
		EASTING	6642202.58	6642405.80	6642697.56	6642693.18					
	240-02	NORTHING	1852850.57	1853053.78	1852355.59	1853055.58		RIGHT			
"RD 17 1/2"		STATION	60+75.88	63+63.26		66+21.28	700.00	44° 38′30''	8° 11 ′06''	545.40	287.
ROAD 17 1/2		EASTING	6640581.25	6640571.74	6641281.24	6641776.21					
	240-01	NORTHING	1852923.08	1851219.73	1852919.17	1852424.20		LEFT			
		STATION	38+19.65	55+23.03		54+72.90	700.00	135°19′11''	8°11′06″	1,653.24	1,703
		EASTING	6633310.69	6633434.91	6633583.01	6633583.01					
	233-02	NORTHING	1853520.92	1853440.26	1853940.26	1853440.26		LEFT			
"RD 16 CONNECTOR"		STATION	17+26.67	18+74.78		20+14.65	500.00	32°59′59''	11°27′33''	287.98	148.
ROAD 16 CONNECTOR		EASTING	6632960.46	6633108.57	6632960.46	6633232.78					
ROAD 16/SR 152 WB OFF RAMP "WB OFF RAMP" 232	233-01	NORTHING	1853652.19	1853652.19	1853152.19	1853571.52		RIGHT			
		STATION	13+45.79	14+93.90		16+33.77	500.00	32°59′59''	11°27′33"	287.98	148.
		EASTING	6634421.48	6634619.25	6634927.82	6634817.92					
	232-02	NORTHING	1853092.55	1853111.99	1847940.37	1853116.21	,	RIGHT			
		STATION	61+34.77	63+33.48		65+32.00	5,177.00	4°23′46.86''	1°06′24.25″	397.24	198.
		EASTING	6633247.64	6633590.78	6633247.64	6633932.28					
	232-01	NORTHING	1853010.91	1853010.91	1860010.91	1853044.48	.,	LEFT			
		STATION	49+57.47	53+00.61		56+43.20	7,000.00	5° 36′46.15''	0°49′06.64″	685.74	343.
		EASTING	6632661.85	6632770.16	6632968.73	6632879.00					
	231-03	NORTHING	1852727.64	1852738.77	1849743.37	1852742.03	,	RIGHT			
		STATION	43+46.98	44+55.87		45+64.66	3,000.00	4°09′26.29''	1° 54′35.49''	217.68	108.
"EB LOOP RAMP"		EASTING	6632375.81		6632375.81	6632355.35					
ROAD 16/SR 152 EB LOOP RAMP	231-02	NORTHING	1852297.17		1852497.17	1852696.12	20000	RIGHT			,,,,,,,,,,,,,,,,,,,,,,,,,,,,,,,,,,,,,,,
		STATION	34+31.05			40+38.88	200.00	174°07′43.56″	28°38′52.40″	607.82	3,900
		EASTING	6632596.67	6632596.67	6632526.67	6632526.67					
	231-01	NORTHING	1852367.17	1852297.17	1852367.17	1852297.17		RIGHT			
		STATION	31+70.24	32+40.24		32+80.20	70.00	90°00′00.00''	81°51′04.01″	109.96	70.0
		EASTING	6633876.18	6634239.29	6635239.54	6634638.67					
	230-02	NORTHING	1852668.7	1852853.95	1849996.39	1852935.60	0,000.00	RIGHT		010.01	
ROAD 16/SR 152 EB ON RAMP "EB ON RAMP"		STATION	55+18.08	59+25.72	0002024.20	63+28.39	3,000.00	15°28′32.72"	1° 54′35.49''	810.31	407.6
	230-01	EASTING	6632824.23	6633112.66	6632824.23	6633369.58					
	230-01	NORTHING	1852279.17	1852279.17	1853479.17	1852410.24	1,200.00	LEFT	- TO 20:13	500.11	200.
		STATION	43+83.24	46+71.67	0031094.00	49+49.35	1,200.00	27°01′47.16″	4°46′28.73''	566.11	288.
	222-02	EASTING	6630920.31	6631307.00	6631694.86	6631694.86					
	222-02	STATION NORTHING	25+90.18 1853028.96	29+78.04 1852998.91	1862998.91	33+65.52 1852998.91	10,000.00	4 26 32 LEFT	0 34 23	775,33	387.
ROAD 16/SR 152 WB ON RAMP "WB ON RAMP"		EASTING	6630294.90	6630445.21	6630205.95	6630595.08	10,000,00	4° 26′ 32''	0° 34′23''	776 77	707
	222-01	NORTHING	1853068.53	1853065.87	1848045.32	1853054.22		RIGHT			
		STATION	19+63.41	21+13.74	4.0.400.45.70	22+63.98	5,024.00	3°25′40''	1° 08′26''	300.57	150.
							. ,		-0 / U		
"ALIGNMENT NAME"	1						(FT)		1	(FT)	(FT

22-NOV-201615:12 MF-CV-B0064-D.

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p0021

CENTRAL VALLEY WYE SR 152 (NORTH) TO ROAD 11 WYE ALTERNATIVE GEOMETRY DATA TABLE SHEET 5 OF 6 HSRUS-US DRAWING NO. CV-B0064-D SCALE NO SCALE SHEET NO.

DRNIA	HI	GH-	SPEED	TRAIN	PROJECT
MERCI	ED	то	FRESNO	SECTIO	N

-	CONTRACT NO.
	HSR05-05
	DRAWING NO.
	CV-B0064-

ROAD "ALIGNMENT NAME"	CURVE NO.		BC	PI	СС	EC	RADIUS (FT)	DELTA A	DEGREE OF CURVATURE (ARC)	LENGTH (FT)	TANGEI (FT)
		STATION	27+78.31	35+81.73		43+06.23	2,000.00	43° 46′18''	2° 51 ′53''	1,527.92	803.4
	310-01	NORTHING	1839905.08	1839902.68	1841905.07	1840456.73		LEFT			
AVENUE 20 1/2		EASTING	6675844.57	6676647.98	6675850.55	6677229.80					
"AVE 20 1/2"		STATION	49+74.10	53+43.44		57+04.54	2,000.00	20° 55′ 32''	2° 51 ′53''	730.44	369.3
	310-02	NORTHING	1840917.31	1841172.01	1839468.97	1841314.39		RIGHT			
		EASTING	6677713.45	6677980.91	6679092.70	6678321.70					
		STATION	13+01.85	24+70.25		31+54.79	1,200.00	88°28′17''	4° 46′29''	1,852.94	1,168
	311-01	NORTHING	1842114.13	1840945.76	1842122.67	1840922.90		LEFT			
ROAD 24 REALIGNMENT		EASTING	6675261.67	6675269.98	6676461.64	6676438.16					
"RD 24"		STATION	35+52.49	37+81.87		39+87.13	550.00	45°16′44''	10°25′03''	434.65	229.
	311-02	NORTHING	1840915.12	1840910.63	1840365.22	1840744.52		RIGHT			
		EASTING	6676835.79	6677065.13	6676825.03	6677223.32					
		STATION	11+69.34	14+64.90		17+28.66	700.00	45° 46′52''	8°11′06''	559.32	295.
	320-01	NORTHING	1837282.83	1837284.39	1836582.84	1837073.66		RIGHT			
AVENUE 20		EASTING	6678557.18	6678852.73	6678560.87	6679059.97					
"AVE 20"		STATION	36+78.85	39+59.61		42+12.86	700.00	43° 42′35''	8°11′06''	534.01	280.
ATHLONE ROAD "ATHLONE RD"	320-02	NORTHING	1835683.20	1835483.02	1835192.38	1835202.30		RIGHT			
		EASTING	6680427.38	6680624.24	6679928.29	6680628.22					
		STATION	10+47.64	11+88.56		13+26.83	883.00	19°12′13''	6°52′42''	279.19	140.
	490-01	NORTHING	1890129.09	1890270.01	1890129.09	1890403.09		LEFT			
		EASTING	6605546.84	6605546.84	6604713.84	660550.49					
		STATION	35+72.76	37+12.01		38+48.72	883.00	18°58′53''	6°52′42''	275.96	139.
	490-02	NORTHING	1892524.04	1892655.55	1892798.04	1892794.81		RIGHT			
		EASTING	6604761.75	6604715.94	6605548.39	6604715.40					
		STATION	72+00.00	77+52.59		80+66.52	550.00	90°16′07''	10°25′03''	866.52	552.
	630-01	NORTHING	1854317.60	1854870.18	1854320.18	1854870.18		RIGHT			
ROAD 10		EASTING	6601027.69	6601025.09	6601577.68	6601577.68					
"RD 10"	-	STATION	89+13.19	94+65.36		97+79.30	550.00	90°13′32''	10°25′03''	866.10	552.
	630-02	NORTHING	1854870.18	1854870.18	1855420.18	1855422.34		LEFT			
		EASTING	6602424.36	6602976.53	6602424.36	6602974.35					
AVENUE 23 1/2	-	STATION	59+27.08	60+68.67		62+10.23	8,000.00	2°01′41″	0°42′58''	283.15	141.
"AVE 23 1/2"	631-01	NORTHING	1855494.02	1855494.58				LEFT			
		EASTING	6603401.15	6603542.74	6603369.65			<b>.</b>			
		STATION	21+12.14	23+63.43			550.00		10°25′03''	471.42	251.
	650-01	NORTHING	1862111.14	1862362.42				LEFT			
		EASTING	6606272.65	6606272.65	6605722.65						
		STATION	29+86.46	32+36.52	1007000.15		550.00		10~25′03"	469.39	250.
ROAD 11 "RD 11"	650-02	NORTHING	1862790.67	1862954.36	1863493.96       1855500.15       LEFT         6603369.65       6603684.23						
		EASTING	6605778.11	6605589.07	6606138.15		550.00	E4940(00)		400.00	
		STATION	38+85.82	41+50.06	1007070 11	43+78.48	550.00	51°19′20"	10°25′03"	492.66	264.
	650-03	NORTHING	1863634.38	1863898.62	1863636.41	1864064.51		RIGHT			
		EASTING	6605586.56	6605585.58	6606136.56	6605791.25	550.00			404.21	
		STATION	47+22.08	49+87.29	4.00.4700.77	52+16.32	550.00	51°29′14"	10°25′03"	494.24	265.
	650-04	NORTHING	1864280.23	1864446.74	1864708.33	1864711.94		LEFT			
		EASTING	6606058.70	6606265.13	6605713.39	6606263.38					<u> </u>

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17-						DESIGNED BY S. WELLS	RECORD SET			CALIFORN
			-			DRAWN BY W. JOHNSEN	15% DESIGN Submittal			MEI
86						CHECKED BY J. RAY	NOT FOR	PARSONS		SR 152
0354						IN CHARGE C. LEMLEY DATE	CONSTRUCTION		CALIFORNIA HIGH-SPEED RAIL AUTHORITY	
g	REV DATE	BY	СНК	APP	DESCRIPTION	11/18/2016				

# NIA HIGH-SPEED TRAIN PROJECT IERCED TO FRESNO SECTION

CENTRAL VALLEY WYE (NORTH) TO ROAD 11 WYE ALTERNATIVE GEOMETRY DATA TABLE SHEET 6 OF 6

CONTRACT NO. HSR05-05 DRAWING NO. CV-B0065-D

SCALE NO SCALE

Utility Type	Conflict ID #	U+ility	Description	Approximate Location of Conflict	Potential Project Impact	Sheet #
	JVC-2	Electric Overhead	115 KV, crossing at Eastside Bypass	5786+10		CV-S1080-D +o CV-S1090-D
	JVC-3	Electric Overhead	70 KV, west side of Road 4 / Lincoln Road	5945+70		CV-S1110-D
				6315+85		CV-S1180-D
	WYH-1	Electric Overhead	115 KV, east side of Road 11	36359+50		CV-S1650-D
Electrical Utility >60KV	W0/11_0	Electric Overhead		6420+35	High Risk	CV-S1200-D
	WYH-2	Electric Uverneda	115 KV, west side of Road 13	15065+55		CV-S1420-D
	WYH-7	Electric Overhead	230 KV	6883+50 to 6930+85		CV-S1280-D to CV-S1290-D
	WYH-16	Electric Overhead	115 KV, north side of Sandy Mush Road	15496+00		CV-S1490-D
	G30	Natural Gas	12", west side of UPRR	15626+00 to 15655+00		CV-S1520-D
	G52	Natural Gas	8" line on west side of Fairmead Blvd	6718+10		CV-S1250-D
	G51	Natural Gas	12" line on west side of Fairmead Blvd	6718+25		CV-S1250-D
Natural Gas Line	WYH-8	Natural Gas	4" feeder main on west side of Road 22	6905+20	High Risk	CV-S1280-D to CV-S1291-D
	WYH-8	Natural Gas	4" feeder main on north side of Avenue 22	6938+90		CV-S1290-D
	G4	Natural Gas	4" feeder line at unknown location on west side of Road 4 (Lincoln Rd)	5946+35		CV-S1110-D
	JVC-8	Challenger Pipeline	8-inch, high pressure natural gas gathering steel line on east side of Harmon Road.	5724+30		CV-S1070-D
Petroleum Products	P2	Petroleum	12.75" OD 0.219" WT X-60 high pressure, east side of UPRR ROW	6717+85	High Risk	CV-S1250-D
	JVC-65	Irrigation Ditch #40	Unknown flow, irrigation infrastructure	5348+00		CV-S1010-D
	JVC-66	West San Juan Drain No.1	Max flow - 20 cfs, irrigation infrastructure	5361+10		CV-S1010-D
	JVC-137	Irrigation Ditch #41		5378+70		CV-S1010-D
Water Infrastructure	JVC-38	Irrigation Ditch #42	Unknown flow, irrigation infrastructure	5391+70	Low Risk	CV-S1010-D
	JVC-39	San Juan Canal	Max flow - 80 cfs, irrigation infrastructure	5399+50		CV-S1020-D
	JVC-40	San Juan Drain	Unknown flow, irrigation infrastructure	5419+00		CV-S1020-D
	JVC-85	Irrigation Ditch #43	Max flow - 80 cfs, irrigation infrastructure	5427+90		CV-S1020-D

REV DA	E BY CHK AP	PP	DESCRIPTION	DESIGNED BY S. WELLS DRAWN BY W. JOHNSEN CHECKED BY S. ARNOLD IN CHARGE C. LEMLEY DATE 08/12/2016	RECORD SET 15% design Submittal Not for Construction	PARSONS	CALIFORNIA HIGH-SPEED RAIL AUTHORITY	CALIFORNIA HIGH-SPEED TRAIN PROJECT MERCED TO FRESNO SECTION CENTRAL VALLEY WYE SR 152 (NORTH) TO ROAD 11 WYE ALTERNATIVE UTILITY CONFLICT TABLE SHEET 1 OF 4	DRAWING CV- SCALE	R08-
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NOTES:

1. ALL CONFLICTS ARE TRANSVERSE UNLESS OTHERWISE NOTED. ALL PIPE SIZES ARE SHOWN IN INCHES IN DIAMETER.

2. REFER TO THE 15% UTILITY REPORT FOR ADDITIONAL UTILITY INFORMATION.

3. REFER TO THE 15% HYDROLOGY AND HYDRAULICS REPORT FOR ADDITIONAL WATER CROSSING INFORMATION.

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Utility Type	Conflict ID #	Utility	Description	Approximate Location of Conflict	Potential Project Impact	Sheet #
	JVC-41	Temple Santa Rita Canal		5436+95		CV-S1020-D
	JVC-42	West Santa Rita Drain		5446+30		CV-S1020-D
	JVC-67	Drain No. 2		5494+60		CV-S1030-D
	JVC-68	Escano Branch Ditch		5496+90		CV-S1030-D
	JVC-138	Drain No. 3		5509+15		CV-S1040-D
	JVC-45	Orchard Ditch	5521+70           5522+75           5527+90           5535+55           5544+75           5564+20           5564+75           5564+75           5573+20           5594+40           5594+40           5596+00 to 5596+75           5623+55           5646+00           5646+00           Max flow - 40 cfs, irrigation infrastructure           5567+20 to 5570+40	5521+70		CV-S1040-D
	JVC-70	Santa Rita Slough		5522+75		CV-S1040-D
	JVC-71	Santa Rita Drain No. 1		5527+90		CV-S1040-D
	JVC-72	Drain No. 4		5535+55		CV-S1040-D
	JVC-73	Santa Rita Drain No.1A		5544+75		CV-S1040-D
	JVC-86	Drain No.5		5564+20		CV-S1050-D
	JVC-88	Santa Rita Ditch		5564+75		CV-S1050-D
Water Infrastructure	JVC-87	Island Field Drain		5573+20	Low Risk	CV-S1050-D
	JVC-12	Lucerne Ditch		5594+40	LOW KISK	CV-S1050-D
	JVC-148	Historical Wood Slough		5596+00 to 5596+75		CV-S1050-D
	JVC-13	Wood Slough		5623+55		CV-S1060-D
	JVC-147	Irrigation Ditch #57		5646+00		CV-S1060-D
	JVC-74	Riverside Canal		5666+55		CV-S1060-D
	JVC-98	San Joaquin River			CV-S1060-D	
	JVC-101A	Irrigation Ditch #59		5676+40		CV-S1070-D
	JVC-101	Mariposa Slough	N 74	5685+85		CV-S1070-D
	JVC-15A	Irrigation Ditch #48	N/A	5771+70		CV-S1080-D
	JVC-15	Eastside Bypass		5772+10 to 5783+85		CV-S1080-D
	JVC-15B	Irrigation Ditch #49		5783+90		CV-S1080-D
	JVC-46	Chowchilla Canal	Unknown flow, concrete lined irrigation infrastructure	5976+00		CV-S1120-D
	JVC-77	Ash Slough	N/A	6276+40 to 6282+40		CV-S1170-D

# NOTES:

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3. REFER TO THE 15% HYDROLOGY AND HYDRAULICS REPORT FOR ADDITIONAL WATER CROSSING INFORMATION.

REV DAT	re by ch	CHK A	APP DESCRIPTION	DESIGNED BY S. WELLS DRAWN BY W. JOHNSEN CHECKED BY S. ARNOLD IN CHARCE C. LEMLEY DATE 08/12/2016	RECORD SET 15% design Submittal Not for Construction	PARSONS	CALIFORNIA HIGH-SPEED RAIL AUTHORITY	CALIFORNIA HIGH-SPEED TRAIN PROJECT MERCED TO FRESNO SECTION CENTRAL VALLEY WYE SR 152 (NORTH) TO ROAD 11 WYE ALTERNATIVE UTILITY CONFLICT TABLE	CONTRACT NO. HSR08-05 DRAWING NO. CV-B0071-D SCALE NO SCALE SHEET NO.
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Utility Type	Conflict ID #	Utility	Description	Approximate Location of Conflict	Potential Project Impact	Sheet #
	JVC-80	Road 11 Canal	Max flow - 24 cfs, irrigation infrastructure	6316+30		CV-S1180-D
		/C-82 Bethel Canal		6406+55	-	CV-S1200-D
	JVC-82		Max flow - 40 cfs, irrigation infrastructure	15079+50		CV-S1420-D
	JVC-133	Berenda Canal	Max flow - 875 cfs, irrigation infrastructure	6478+40		CV-S1210-D
	JVC-120	Berenda Pipeline	42" M.C.P., Unknown flow, buried irrigation infrastructure, east side of Road 15	6526+85	Low Risk	CV-S1220-D
	JVC-111	Berenda Slough	N/A	6544+00 to 6547+65		CV-S1220-D
	JVC-113	Califa Canal	Unknown flow, irrigation infrastructure	6737+80		CV-S1250-D
	WYH-17	Lat 32.2	Max flow - 600 cfs, irrigation infrastructure	6876+70		CV-S1280-D
Water Infrastructure	JVC-130	Berenda Creek	N/A	7011+10 +0 7011+55		CV-S1300-D
	JVC-129	24.2-8.9-1.0	Max flow - 320 cfs, irrigation infrastructure	7098+35		CV-S1320-D
	JVC-143	24.2-8.9	Unknown flow, irrigation infrastructure	7117+00		CV-S1320-D
	JVC-134	Dry Creek	N/A	7129+75 to 7130+60		CV-S1320-D to CV-S1330-D
	JVC-131	24.2	Max flow - 990 cfs, irrigation infrastructure	7168+00		CV-S1330-D
	JVC-106	Ash Main Canal	Unknown flow, irrigation infrastructure	15185+60		CV-S1440-D
	JVC-106A	Tarabini Pipeline	Unknown flow, irrigation infrastructure	36266+00		CV-S1630-D
	JVC-106A	Tarabini Pipeline	Unknown flow, irrigation infrastructure	36312+40	1	CV-S1640-D
	JVC-77	Ash Slough	N/A	15183+00 to 15185+00	1	CV-S1440-D



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REV DATE	BY CHK APP	DESCRIPTION	DESIGNED BY S. WELLS DRAWN BY W. JOHNSEN CHECKED BY S. ARNOLD IN CHARGE C. LEMLEY DATE 08/12/2016	RECORD SET 15% DESIGN Submittal Not for Construction	PARSONS	CALIFORNIA HIGH-SPEED RAIL AUTHORITY	CALIFORNIA HIGH-SPEED TRAIN PROJECT MERCED TO FRESNO SECTION CENTRAL VALLEY WYE SR 152 (NORTH) TO ROAD 11 WYE ALTERNATIVE UTILITY CONFLICT TABLE	CONTRACT NO. HSRO8-05 DRAWING NO. CV-B0072-D SCALE NO SCALE SHEET NO.
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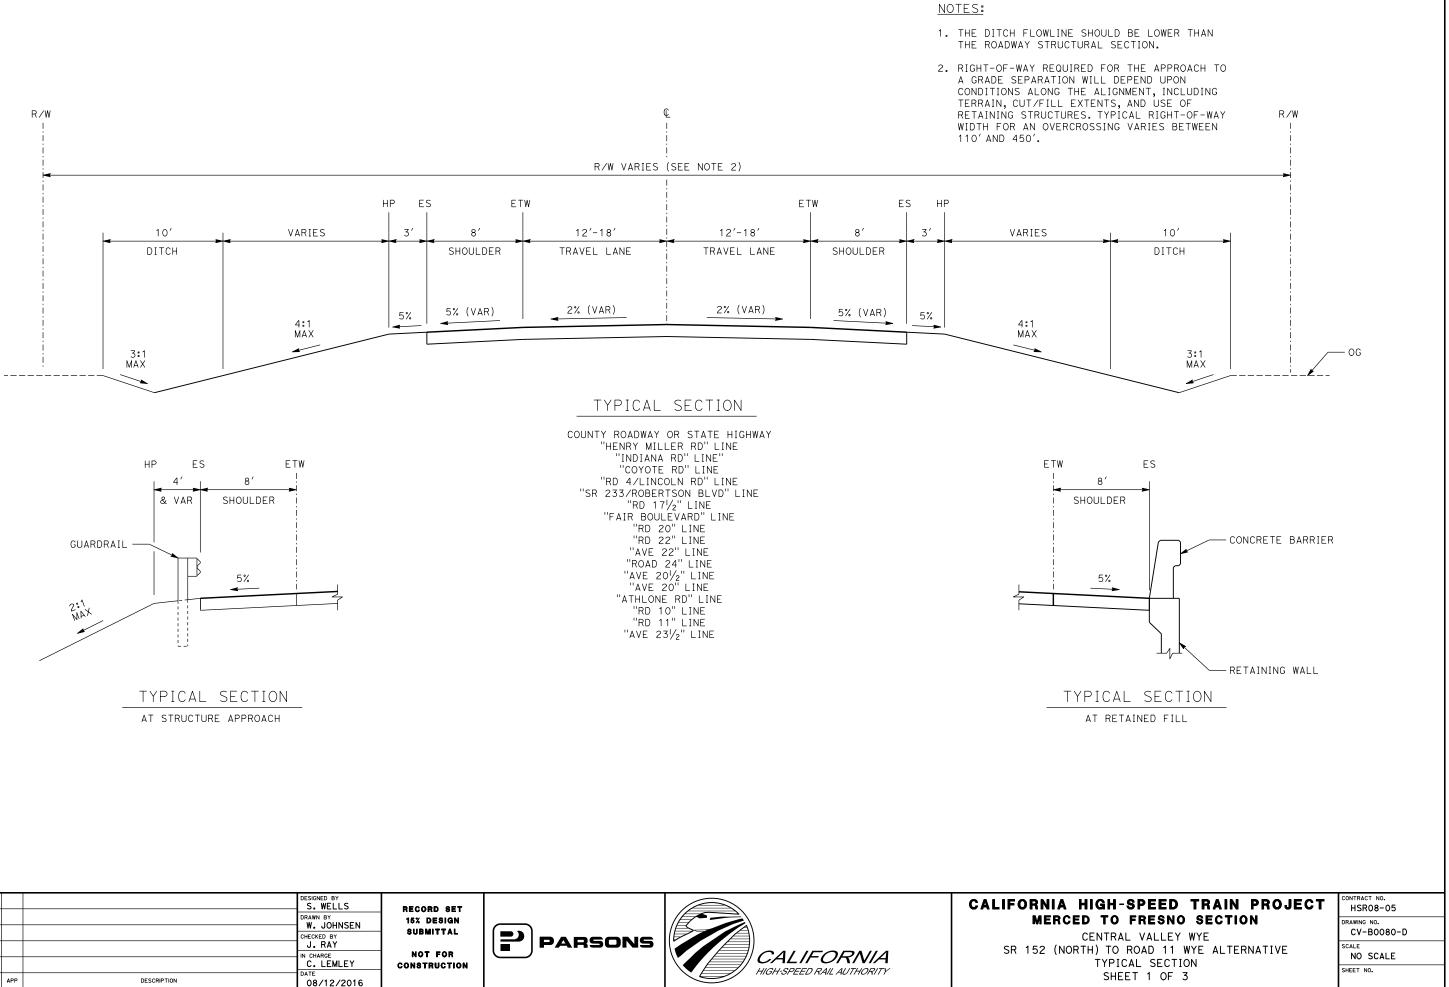
Utility Type	Conflict ID #	U+iIi+y	Description	Approximate Location of Conflict	Potential Project Impact	Sheet #
				15268+60 to 15269+40		CV-S1450-D
	JVC-107	Chowchilla River	N/A	36409+20 +0 36410+00		CV-S1660-D
				15255+75		CV-S1450-D
	JVC-107A	Chowchilla River Pipeline B	Unknown flow, irrigation infrastructure	36396+40		CV-S1650-D
				15215+70		CV-S1440-D
	JVC-107B	Justin Canal	Unknown flow, irrigation infrastructure	36356+20		CV-S1650-D
Water Infrastructure		Lat 4		15295+10	Low Risk	CV-S1460-D
	JVC-108		Max flow - 600 cfs, irrigation infrastructure	36435+75		CV-S1660-D
	JVC-145	Lat 3	Max flow - 600 cfs, irrigation infrastructure	15388+75		CV-S1480-D
	JVC-145A	Unnamed Canal	Unknown flow, irrigation infrastructure	15415+40		CV-S1480-D
	JVC-109	Lat 2	Max flow - 600 cfs, irrigation infrastructure, south side of Cross Road	15441+65		CV-S1480-D
	JVC-110	Dutchman Creek	NZA	15481+50		CV-S1490-D
	JVC-105	Deadman's Creek	NZA	15577+30		CV-S1510-D
			Non- Fried	15582+50		
Storm Water Infrastructure			None Found			
Wastewater Infrastructure			None Found			
	Т97	Fiber Optic	Underground Trenched Ducts with Fiber Optic, east side of Fairmead Blvd.	6718+65		CV-S1250-D
	Т99	Eibar Optio	Buried cable, north side of Avenue 25	15229+40		CV-S1450-D
		Fiber Optic	buried cubie, nor in side of Avenue 25	36370+00		CV-S1650-D
Communication Facilities	F9	Fiber Optic	Underground 2-2"HDPE, west side of UPRR	6717+45	Low Risk	CV-S1250-D
	F11	Fiber Optic	Underground telephone, west side of UPRR	6717+70		CV-S1250-D
	JVC-56	Copper Cable	Buried cable. Runs North-South on the West side of Elgin Road right-of-way. 12 Pair.	5468+20		CV-S1030-D
	JVC-57	Copper Cable	Buried cable. Runs North-South on the East side of Indiana Road right-of-way. 6 Pair.	5565+00		CV-S1050-D

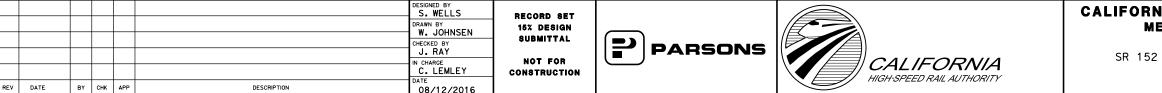
	HIGH-SPEED TRAIN PROJECT ED TO FRESNO SECTION CENTRAL VALLEY WYE DRTH) TO ROAD 11 WYE ALTERNATIVE UTILITY CONFLICT TABLE SHEET 4 OF 4	HSR08-05 DRAWING NO. CV-B0073-D SCALE NO SCALE SHEET NO.
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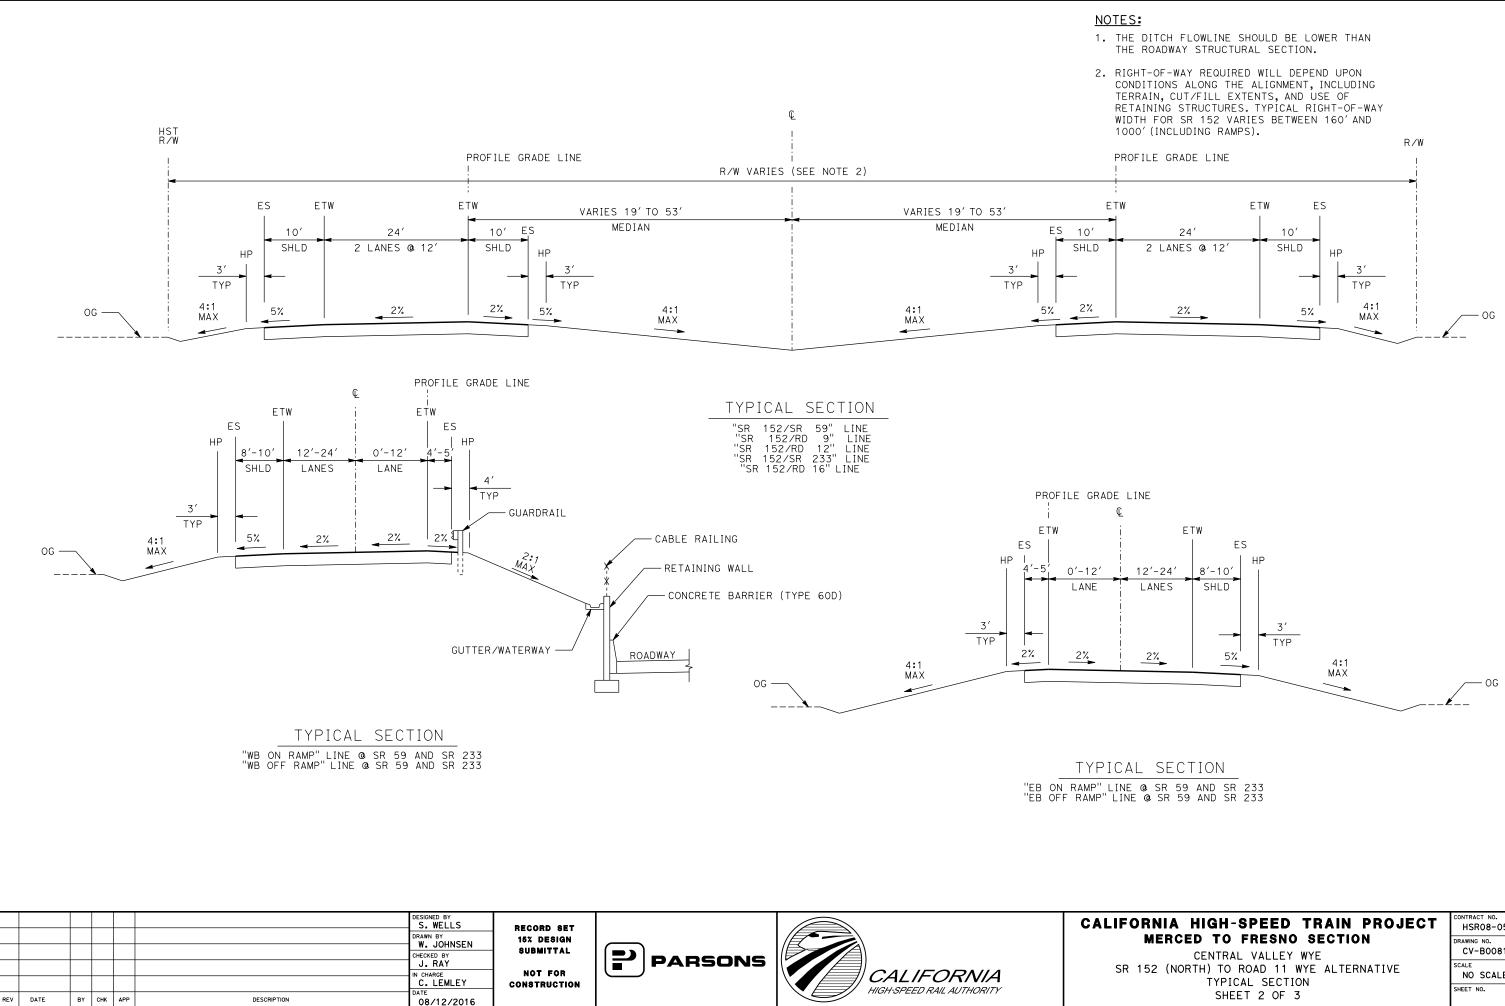
NOTES:

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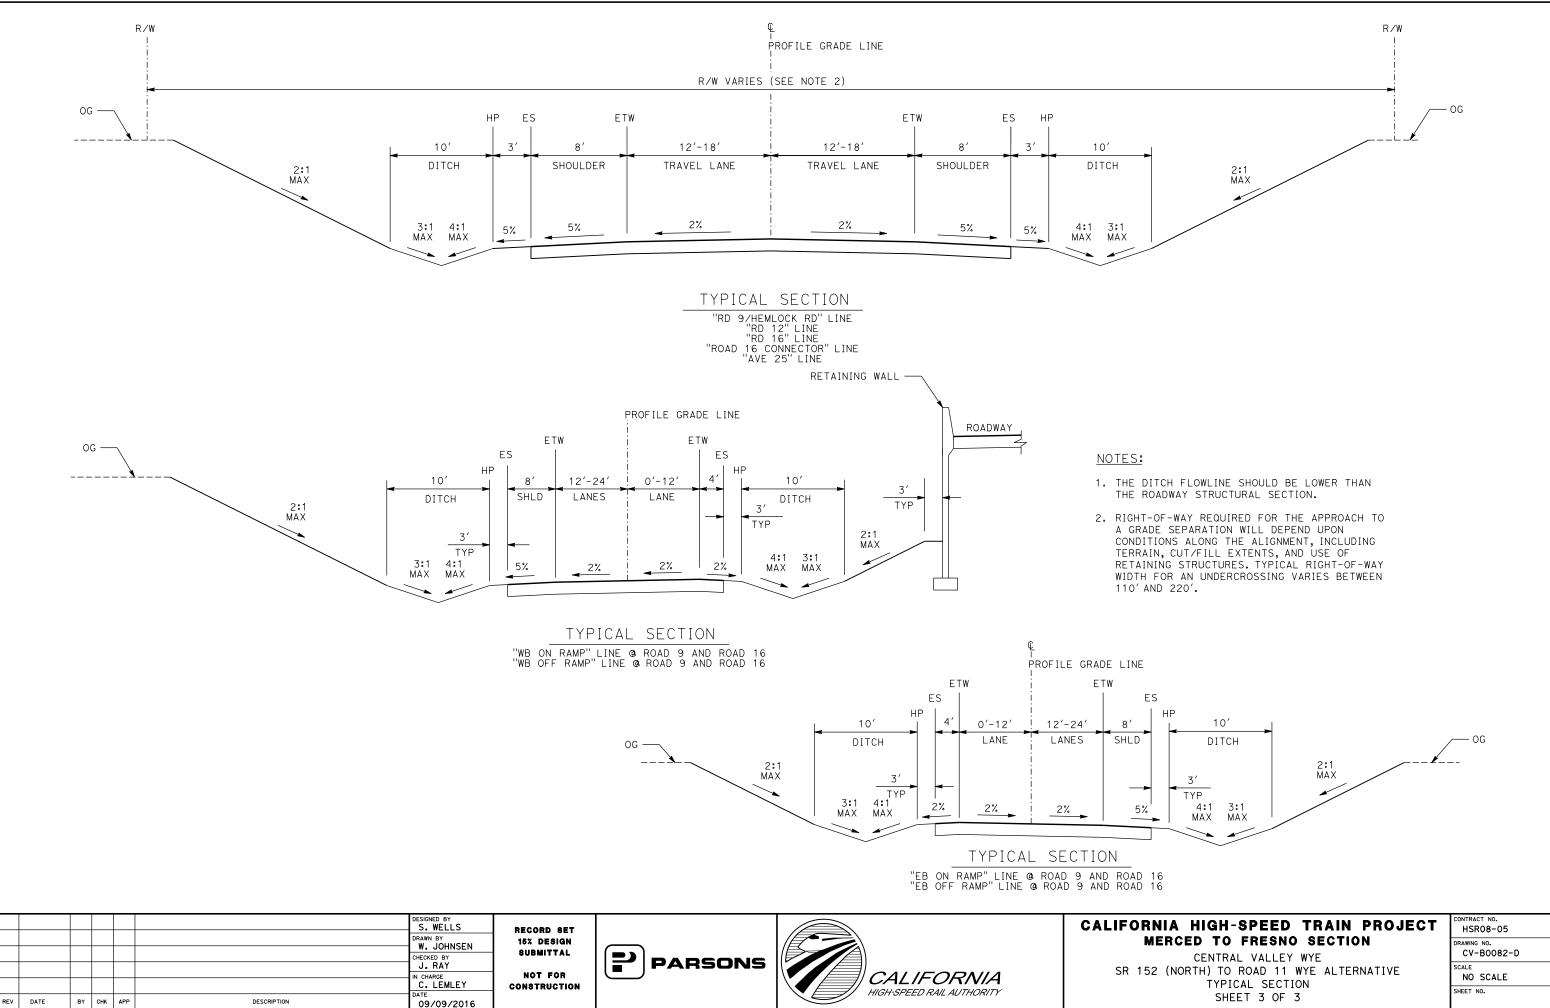
3. REFER TO THE 15% HYDROLOGY AND HYDRAULICS REPORT FOR ADDITIONAL WATER CROSSING INFORMATION.

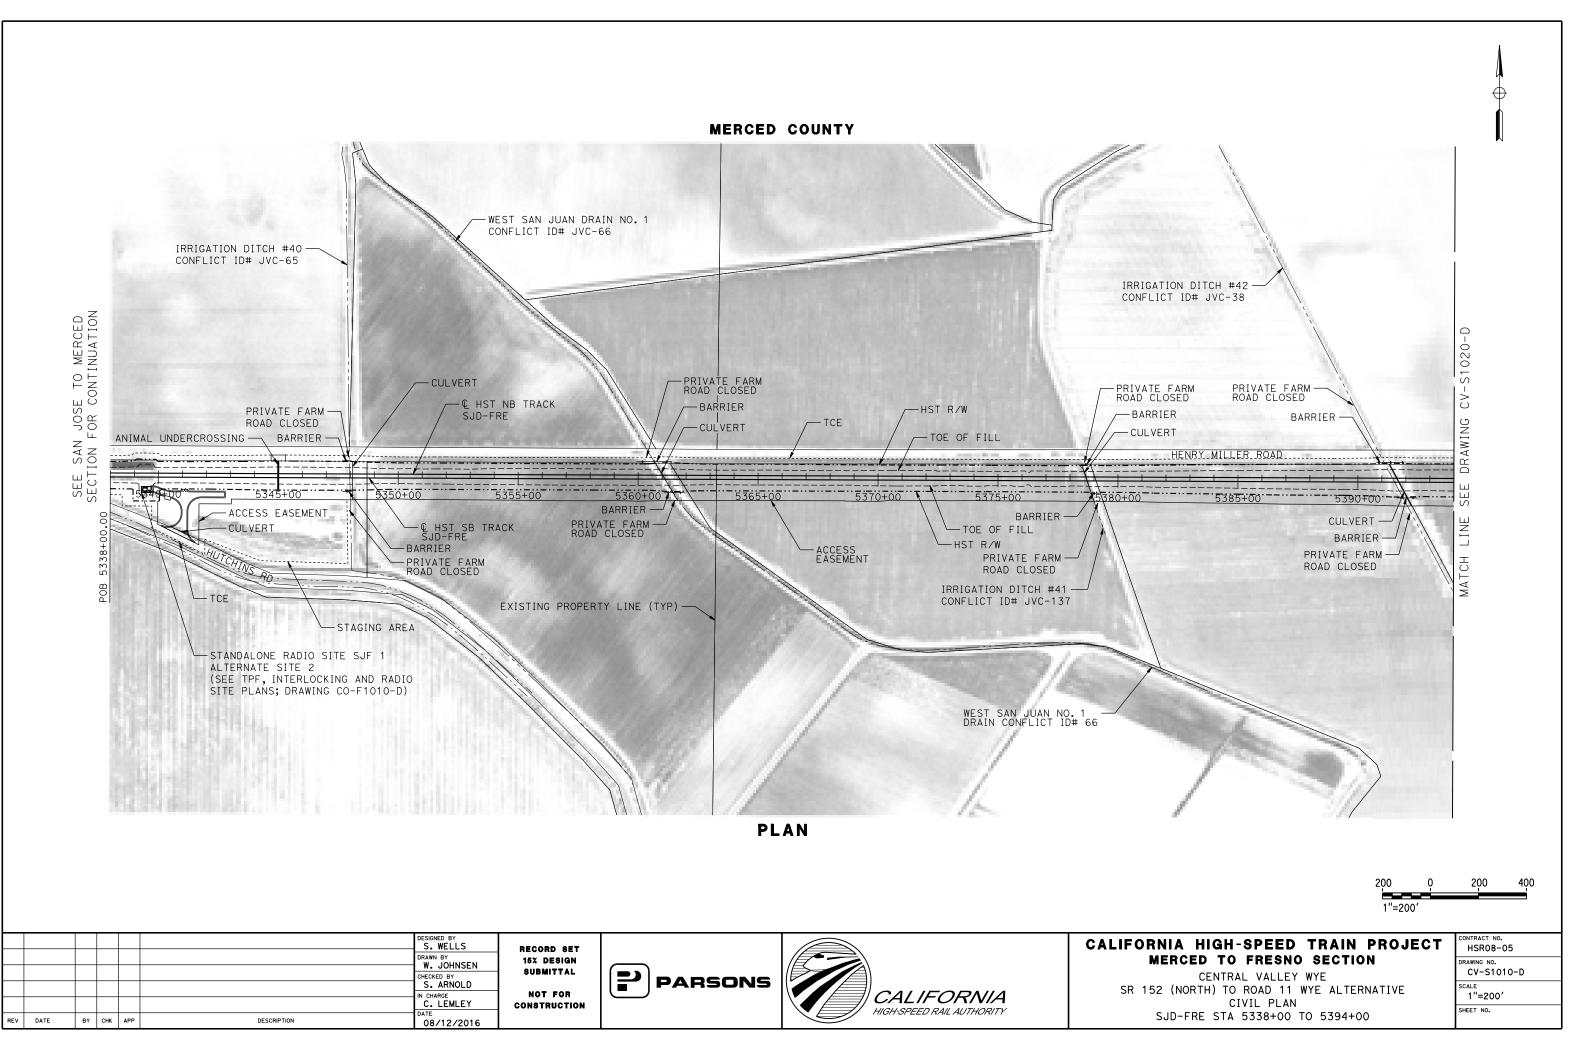




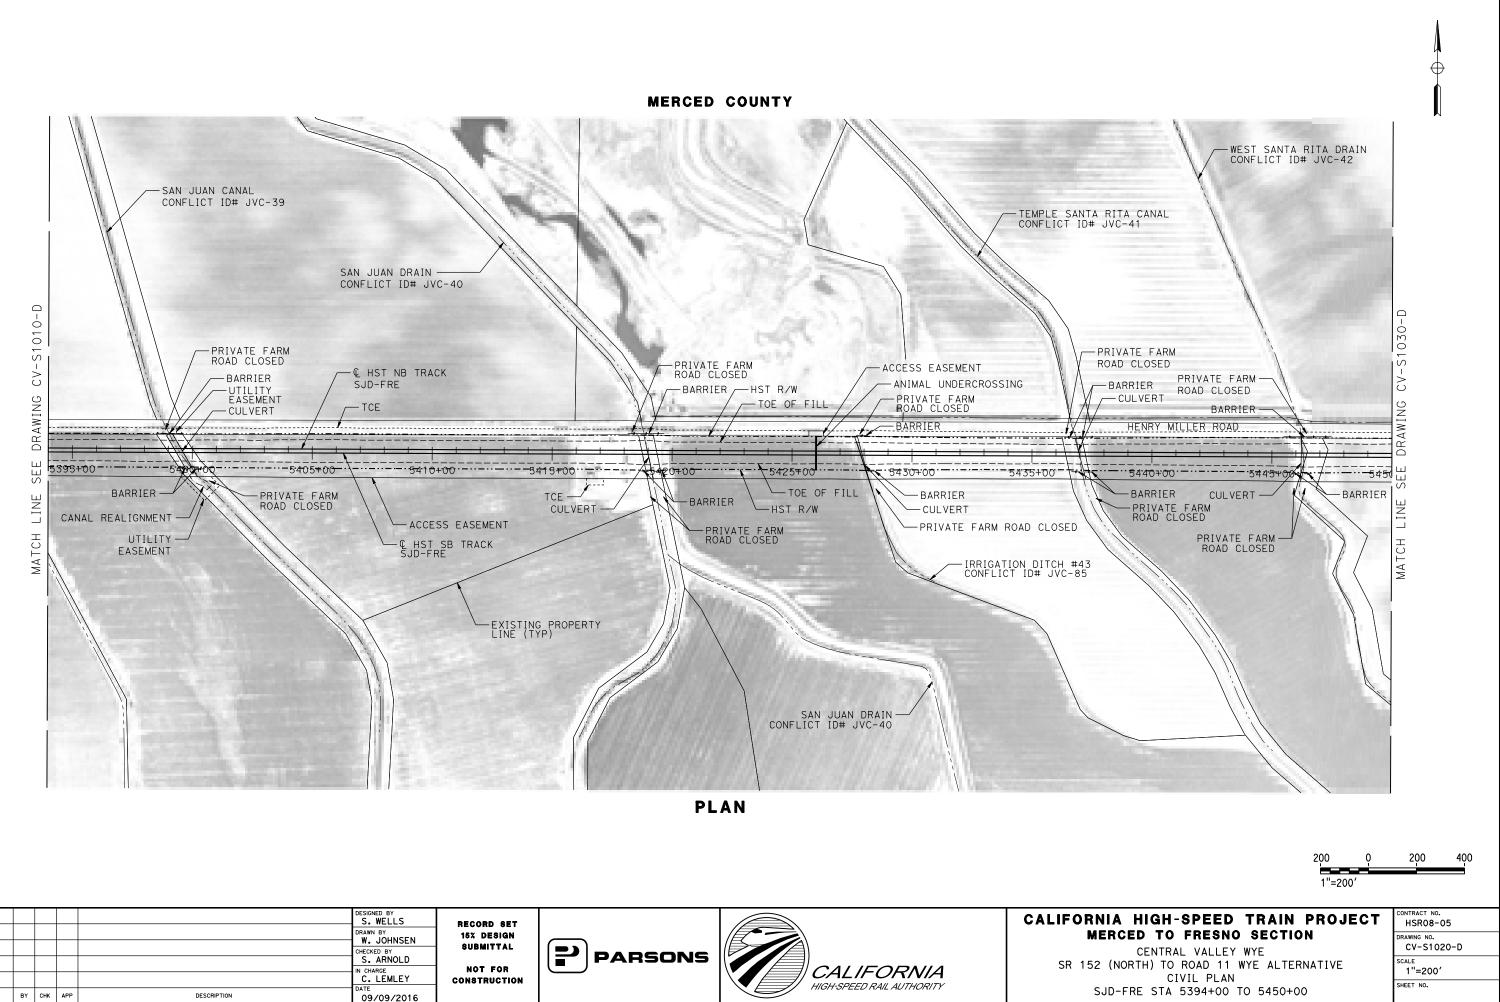


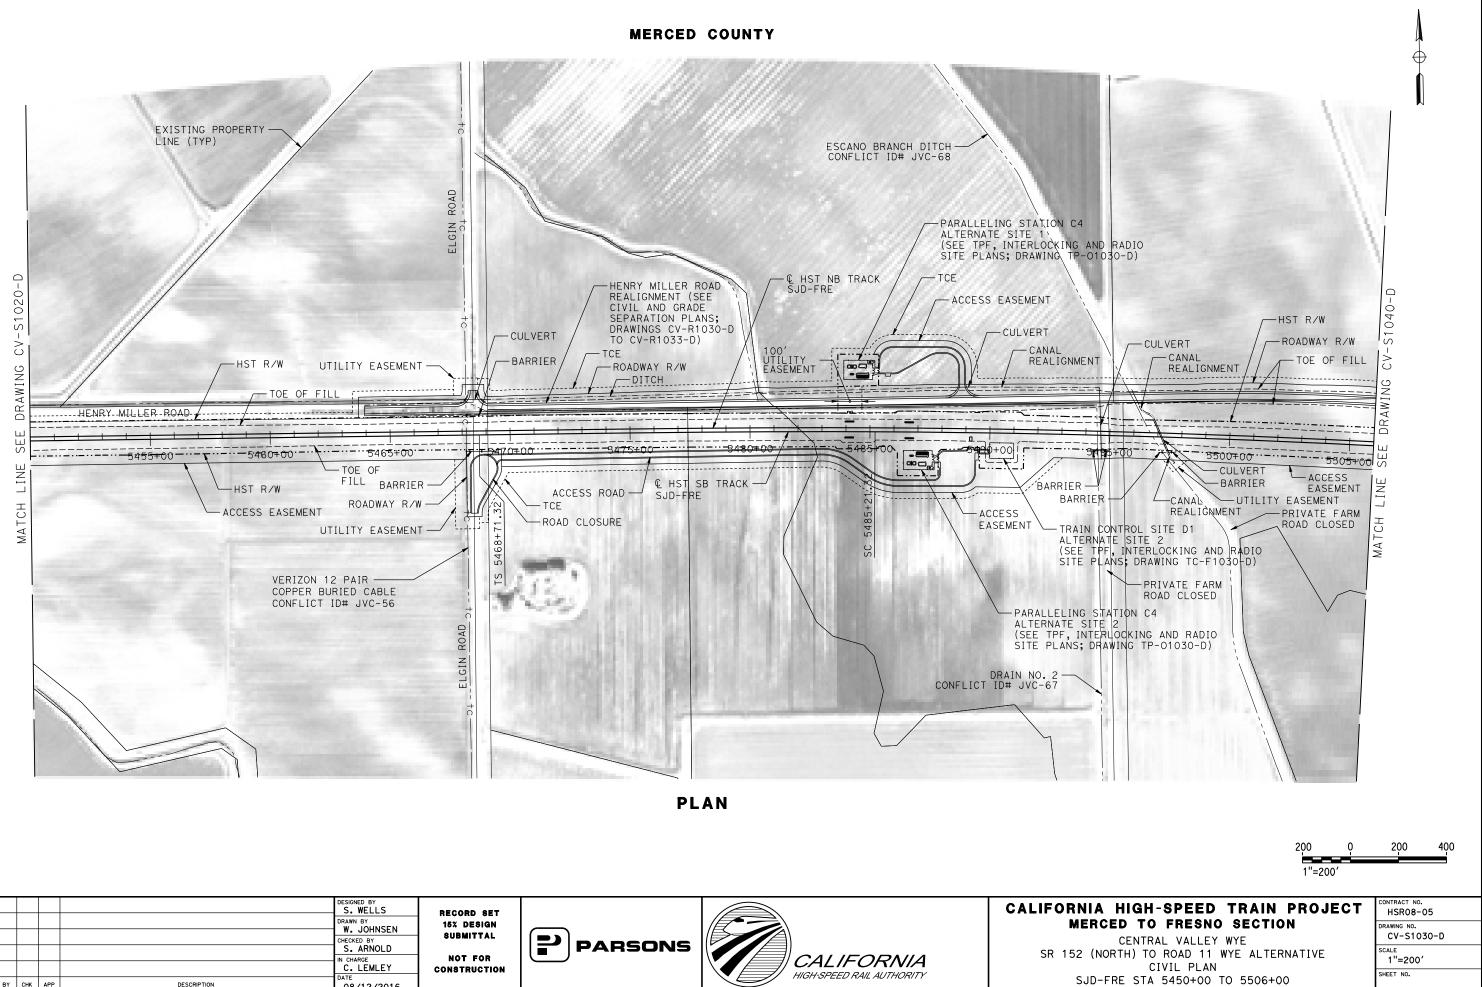
NIA HIGH-SPEED TRAIN PROJECT	CONTRACT NO. HSR08-05
MERCED TO FRESNO SECTION CENTRAL VALLEY WYE	DRAWING NO. CV-B0081-D
52 (NORTH) TO ROAD 11 WYE ALTERNATIVE TYPICAL SECTION	SCALE NO SCALE
SHEET 2 OF 3	SHEET NO.

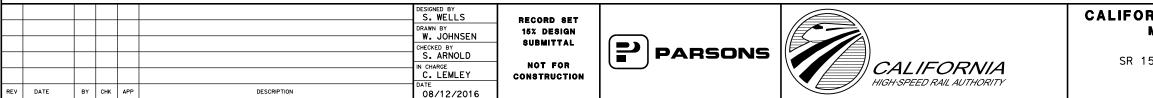


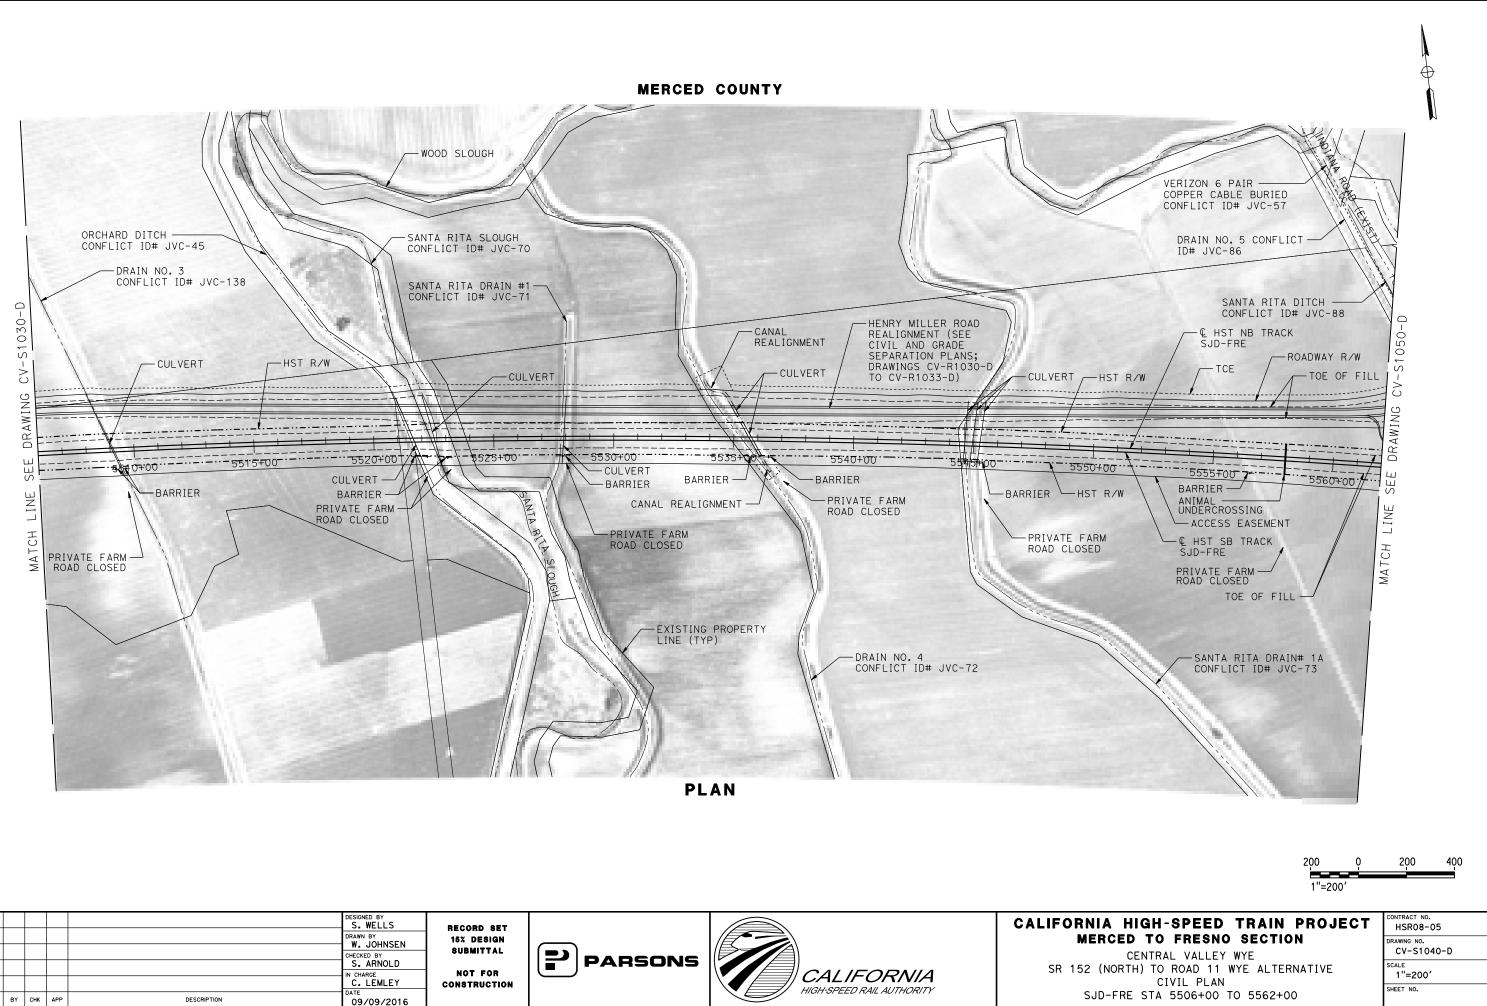


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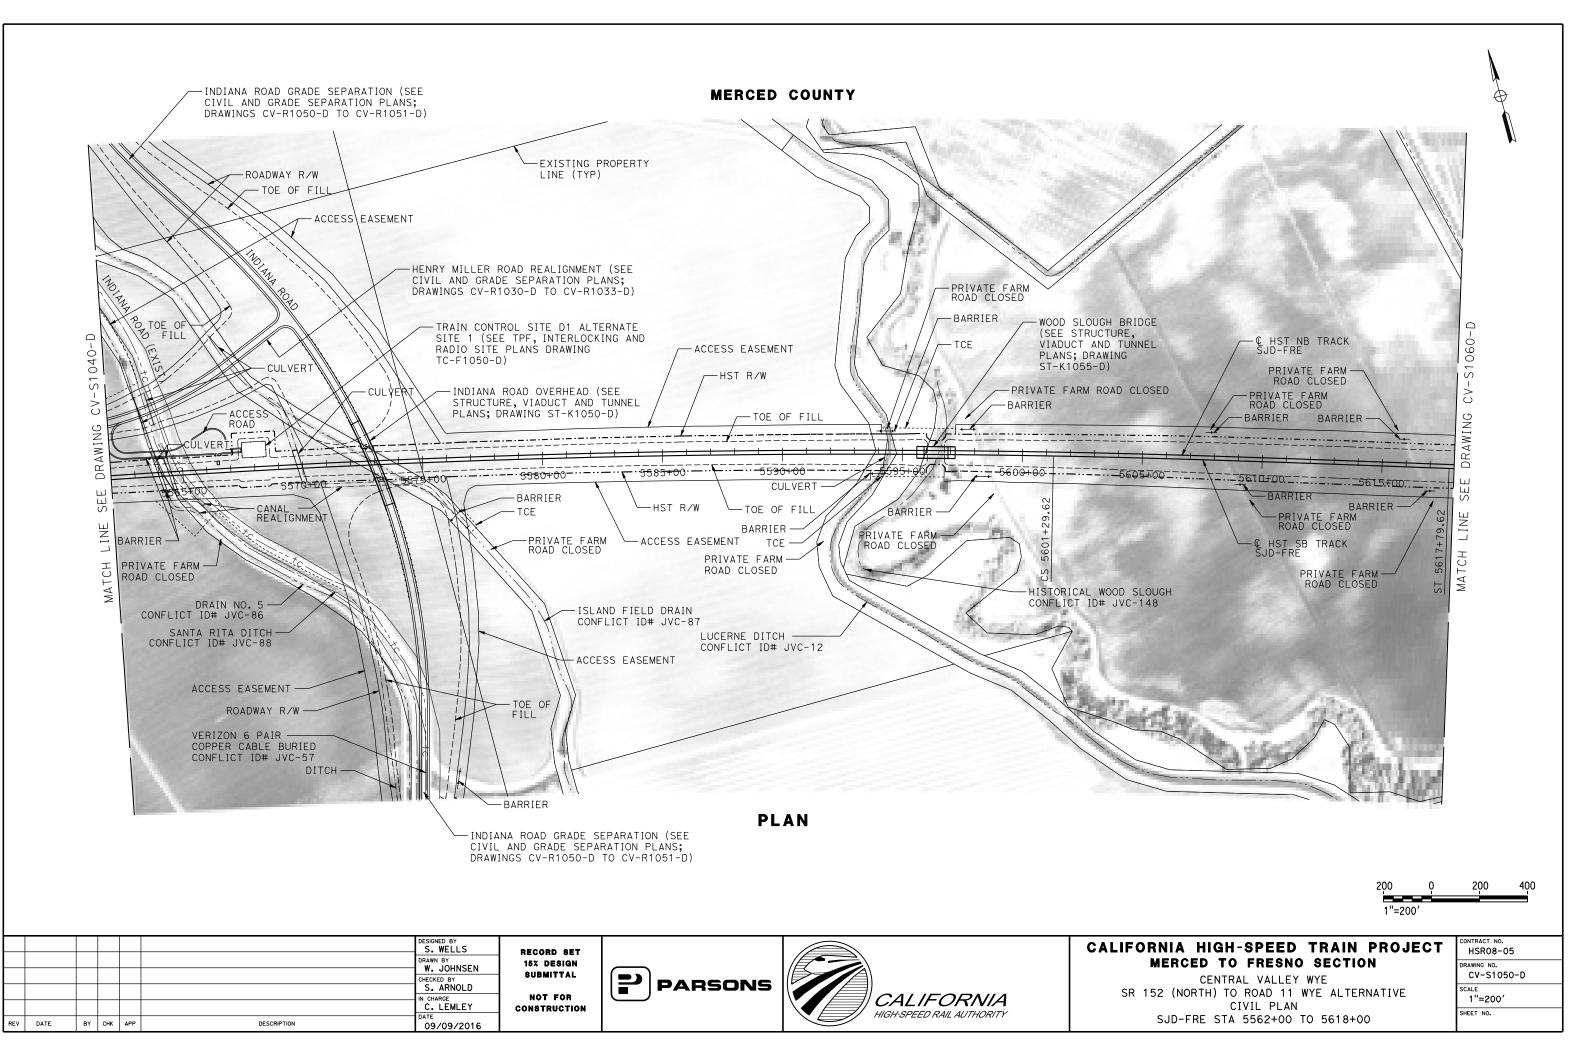










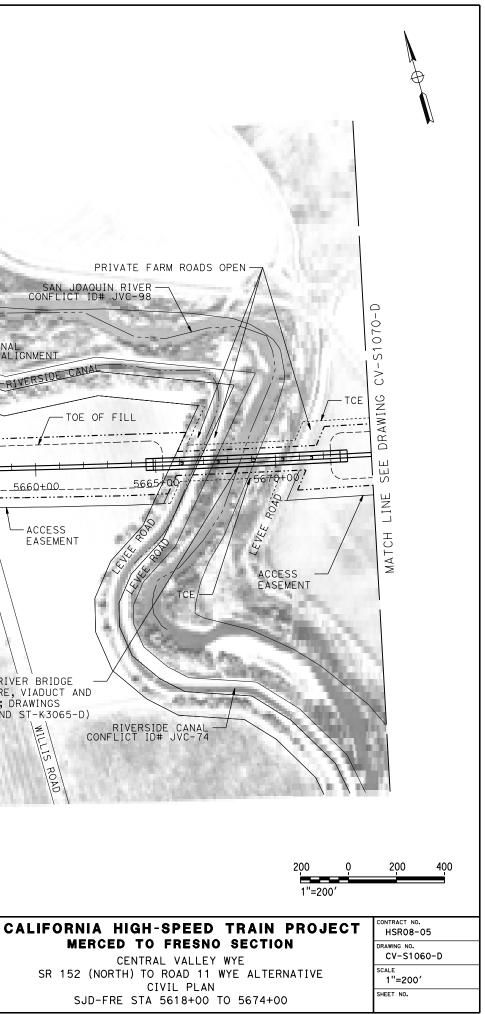


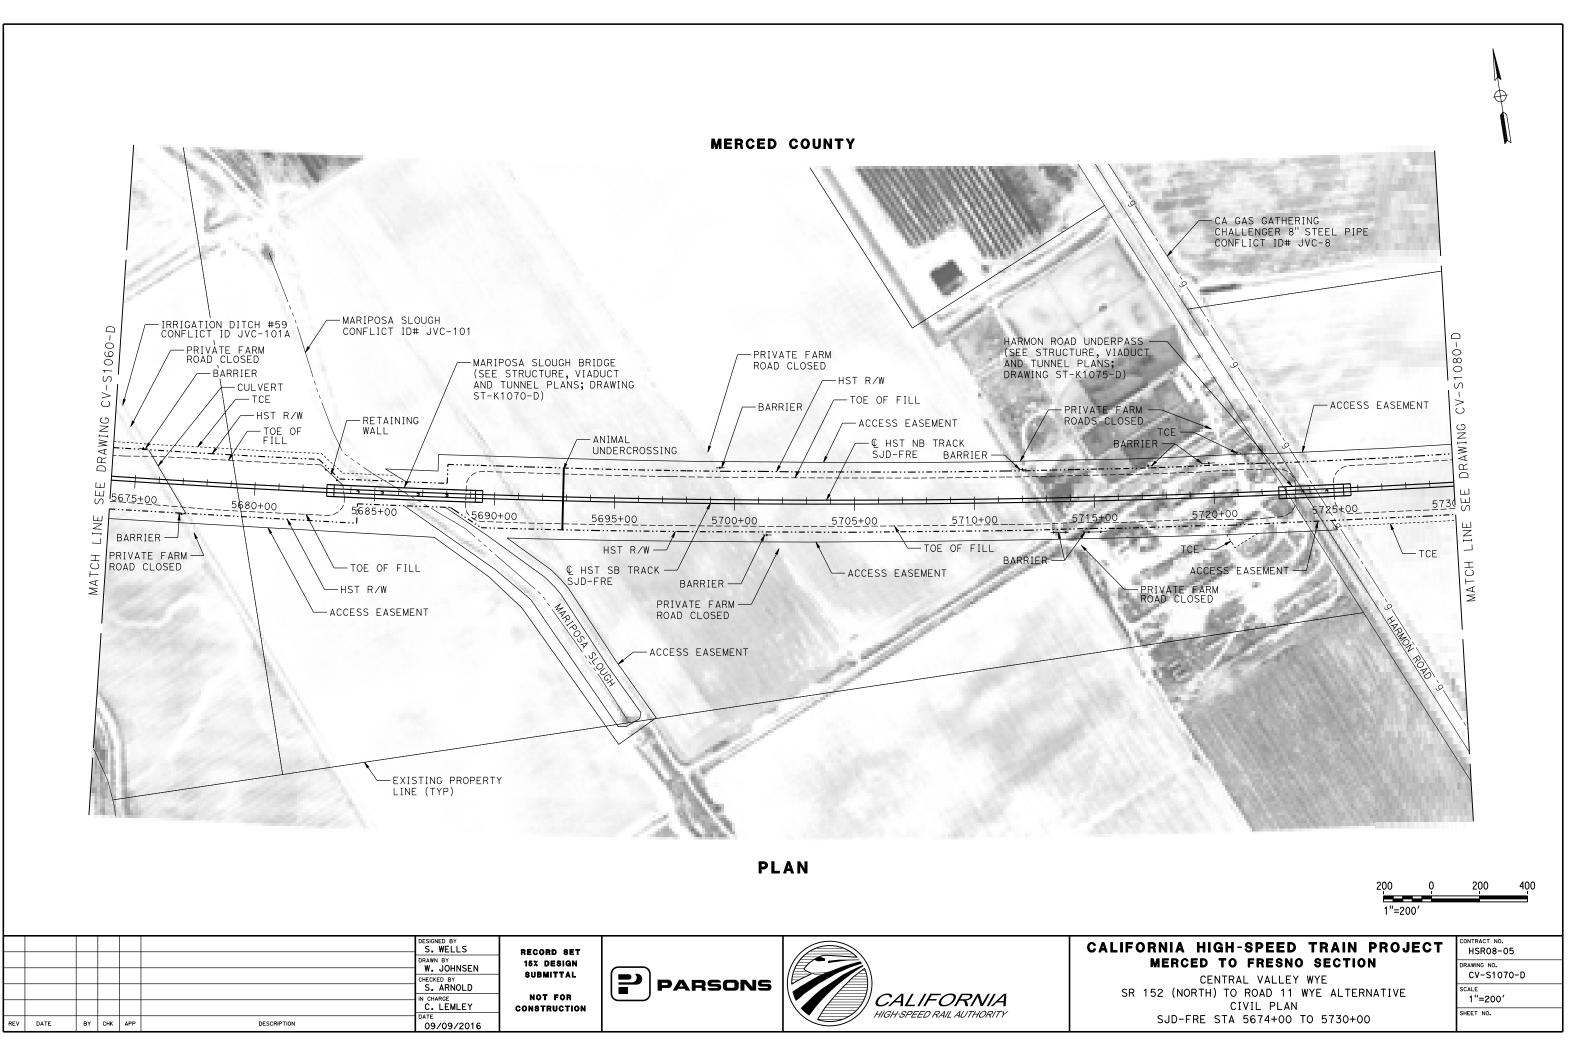
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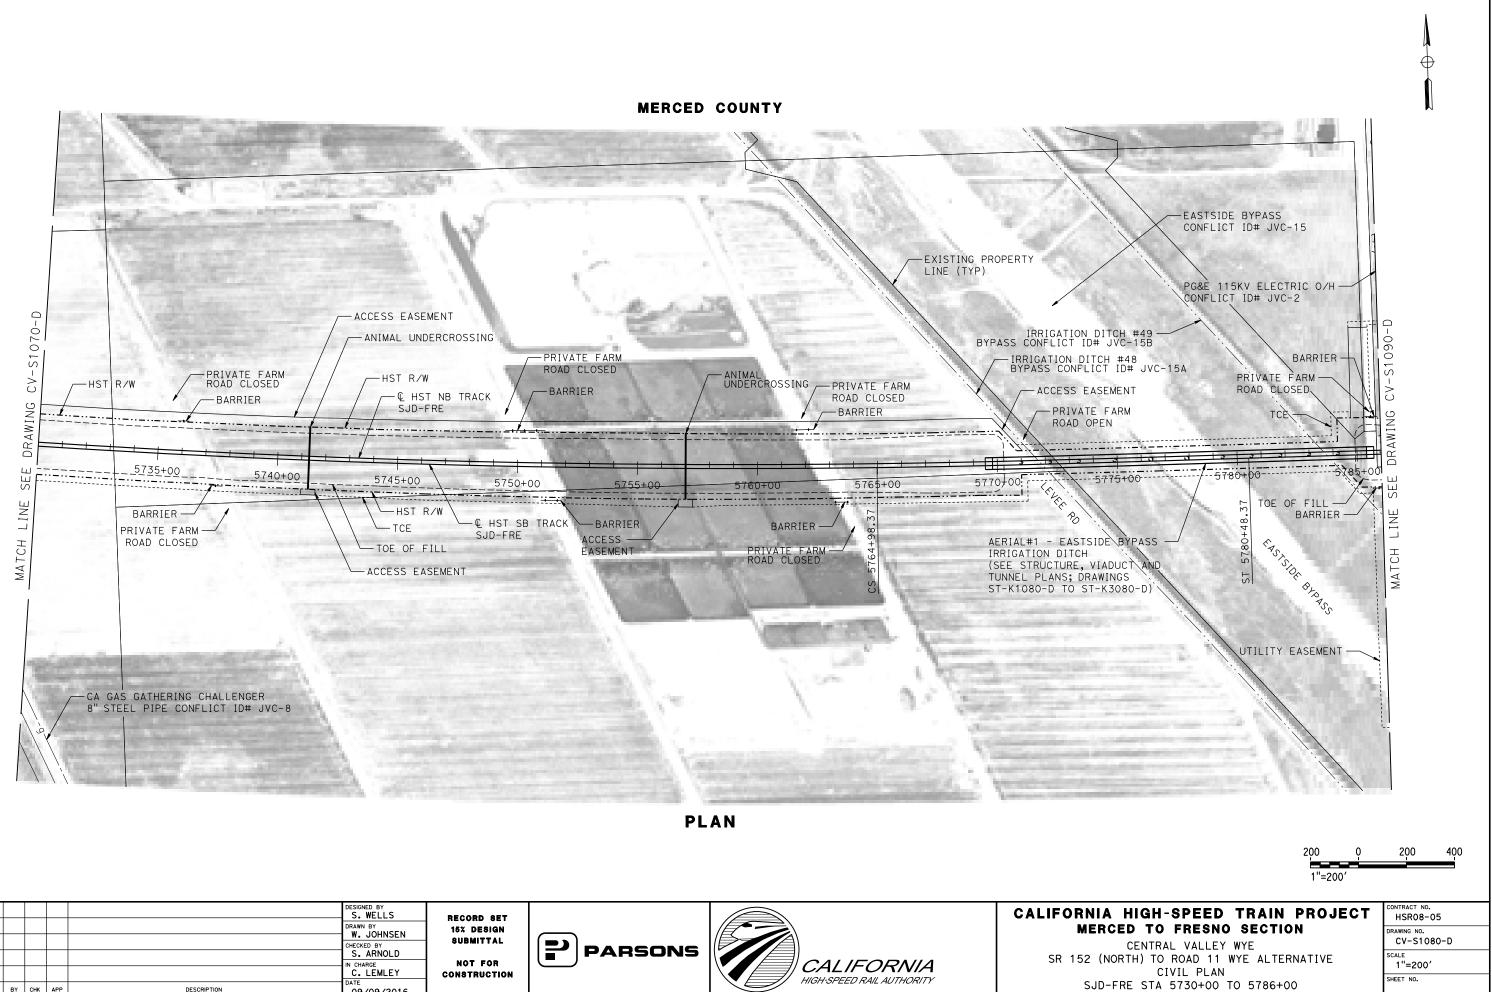
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**MERCED COUNTY** and the second JOAQUIN RIVER STANDALONE RADIO SITE SJF ALTERNATE SITE 2 (SEE TPF, INTERLOCKING AND RADIO SITE PLANS; DRAWING CO-F1060-D)  $\Box$ -€ HST NB TRACK SJD-FRE CV-S1050-ACCESS ROAD ACCESS EASEMEN CANAL REALIGNMENT PRIVATE FARM ROAD CLOSED -ACCESS EASEMENT TCE -HST R/W BARRIER PRIVATE FARM ROAD CLOSED DRAWING -CULVERT - TOE OF FILL \_..\_./\_. -CULVERT ш SE \_\_\_\_562.0±0.0\_ 5625±00----5630+00---5635+00 <u>5660+00</u> <u>\_5655+00</u>\_ 5640+00 -56<u>45+</u>0 5650+00 LINE ן ביידי - TOE OF FILL BARRIER -ACCESS -ACCESS EASEMENT UTILITY EASEMENT MATCH EASEMENT ò UTILITY EASEMENT PRIVATE FARM -ROAD CLOSED 5632 - TCE -HST R/W 564 -CANAL REALIGNMENT LS ACCESS EASEMENT WILLIS ROAD UNDERPASS -(SEE STRUCTURE, VIADUCT AND TUNNEL PLANS; DRAWING L HST SB TRACK -IRRIGATION DITCH #57 SJD-FRE CONFLICT ID# JVC-147 ST-K1060-D) EXISTING PROPERTY -STANDALONE RADIO SITE SJF 4 ALTERNATE SITE 1 (SEE TPF, INTERLOCKING AND RADIO SITE PLANS; DRAWING LINE (TYP) SAN JOAQUIN RIVER BRIDGE WOOD SLOUGH (SEE STRUCTURE, VIADUCT AND TUNNEL PLANS; DRAWINGS CO-F1060-D) CONFLICT ID# JVC-13 ST-K1065-D AND ST-K3065-D) WILL 10 PLAN

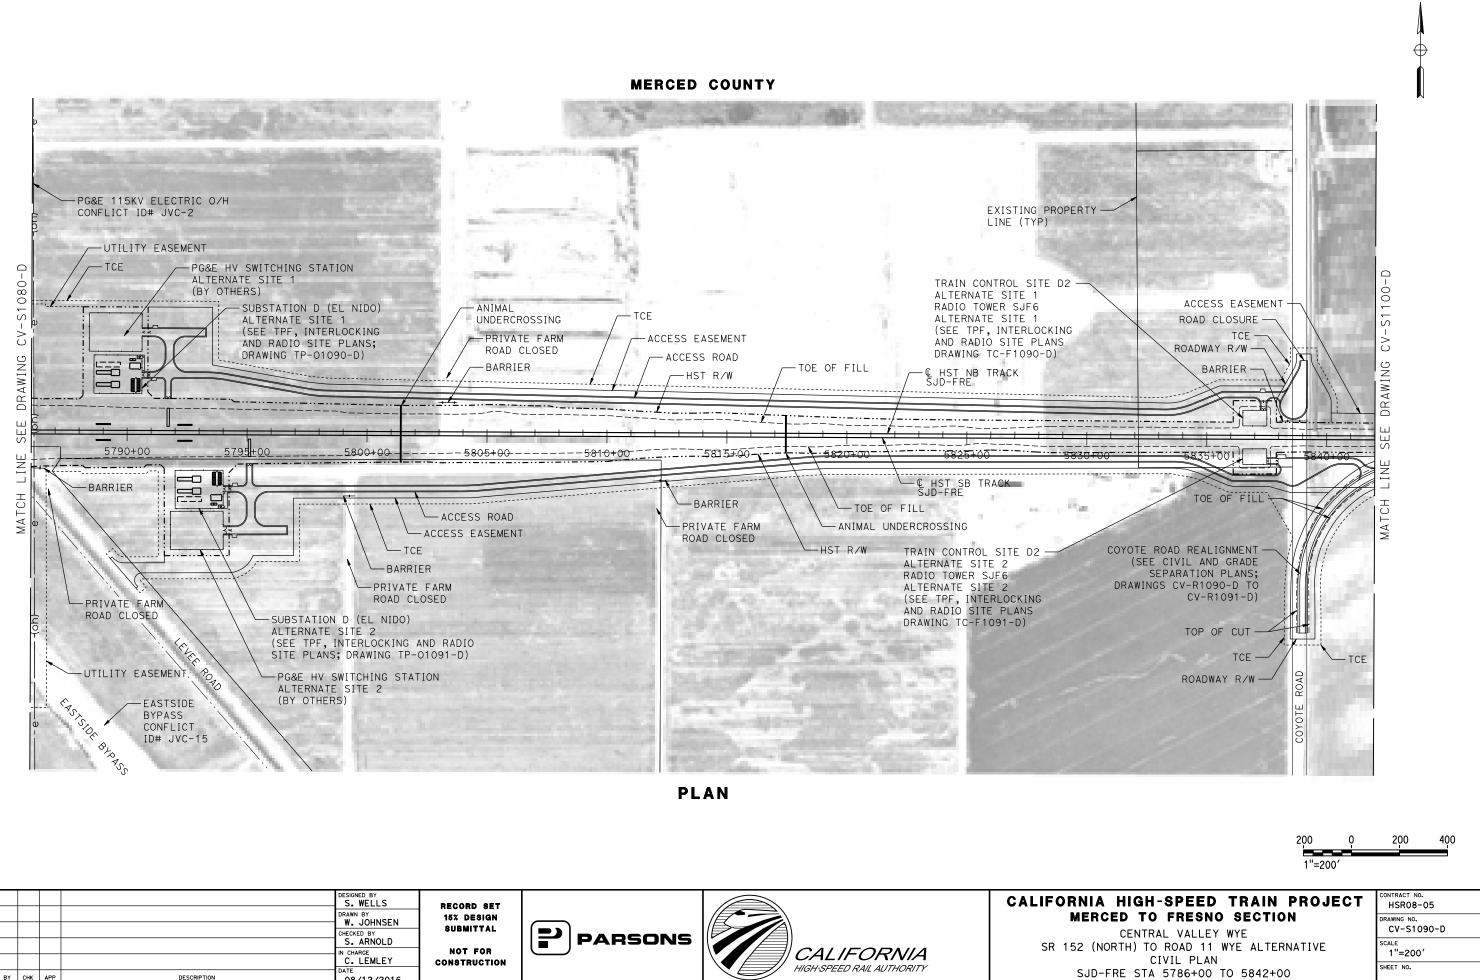
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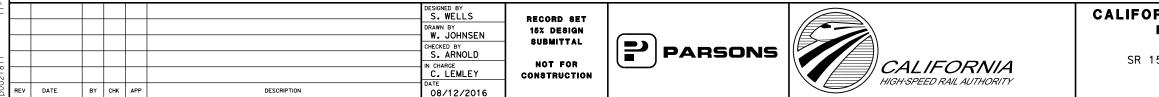


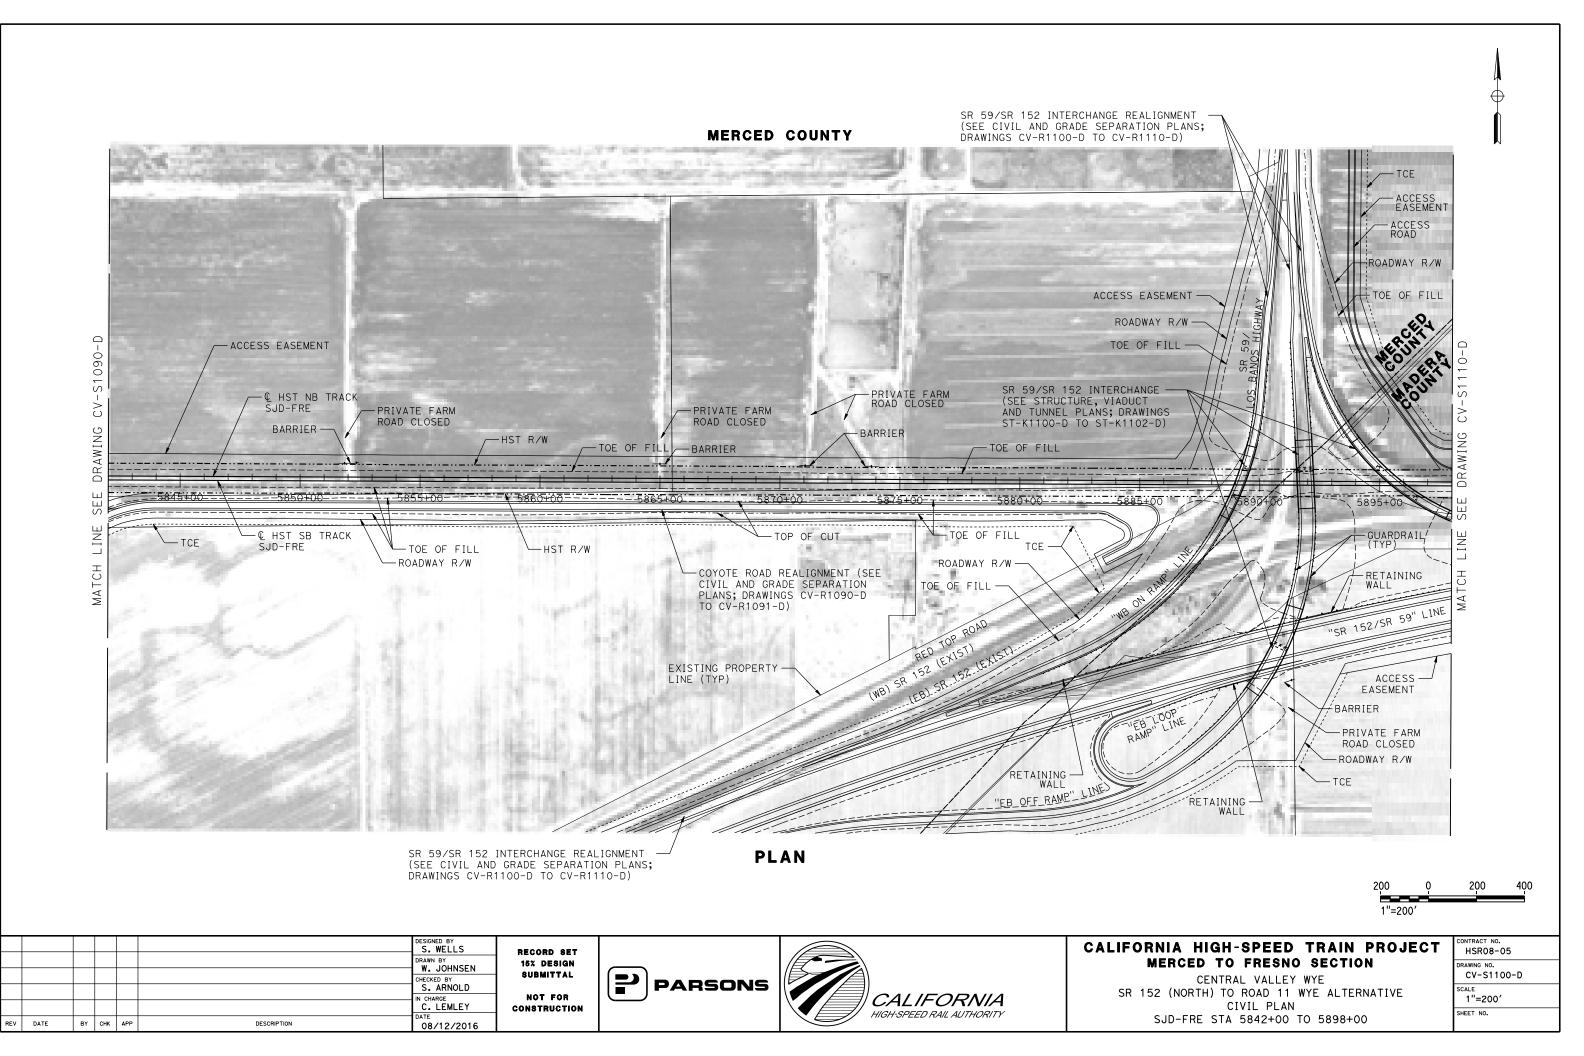


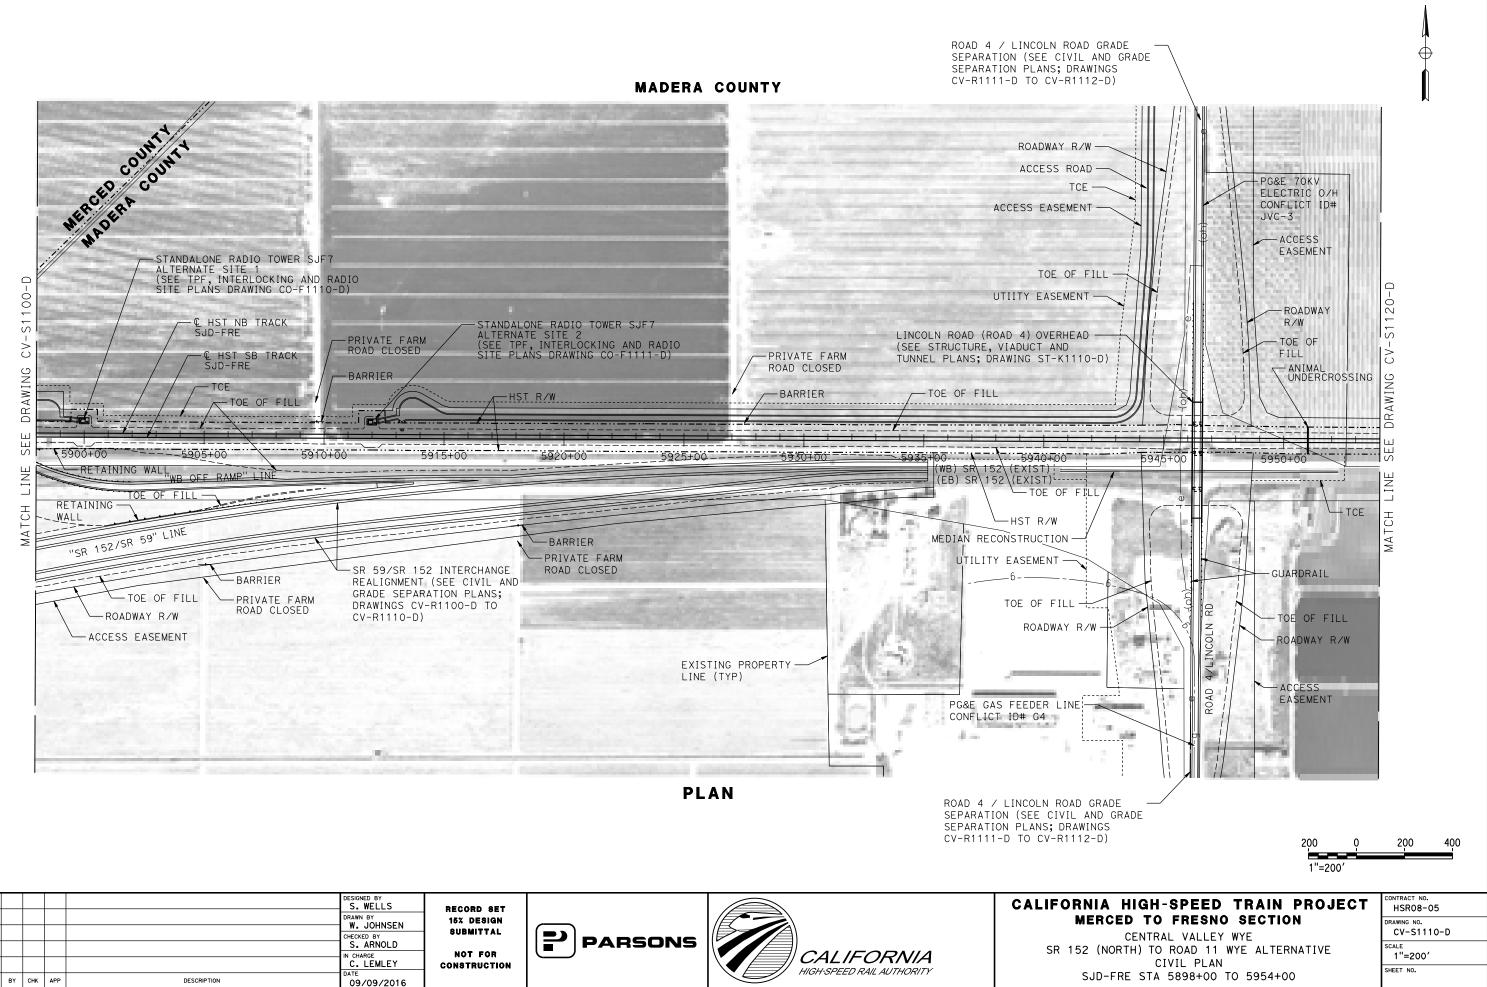


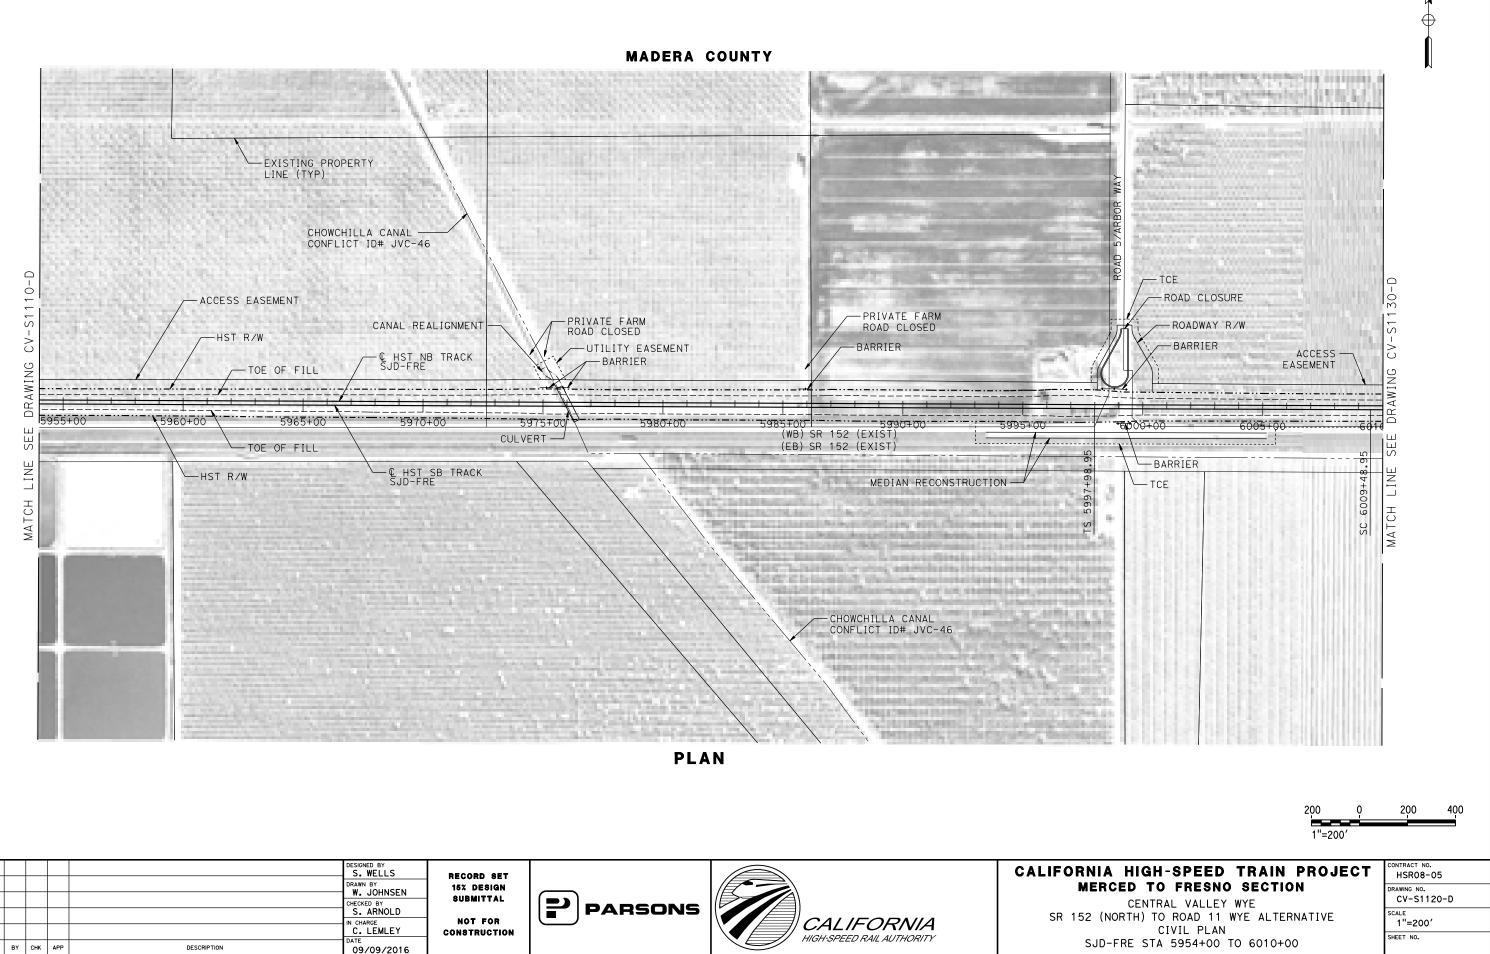
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					CHECKED BY S. ARNOLD	NOT FOR	PARSONS	CALIFORNIA	SR 15
REV	DATE	BY	СНК АРР	DESCRIPTION	C. LEMLEY DATE 09/09/2016	CONSTRUCTION		HIGH-SPEED RAIL AUTHORITY	

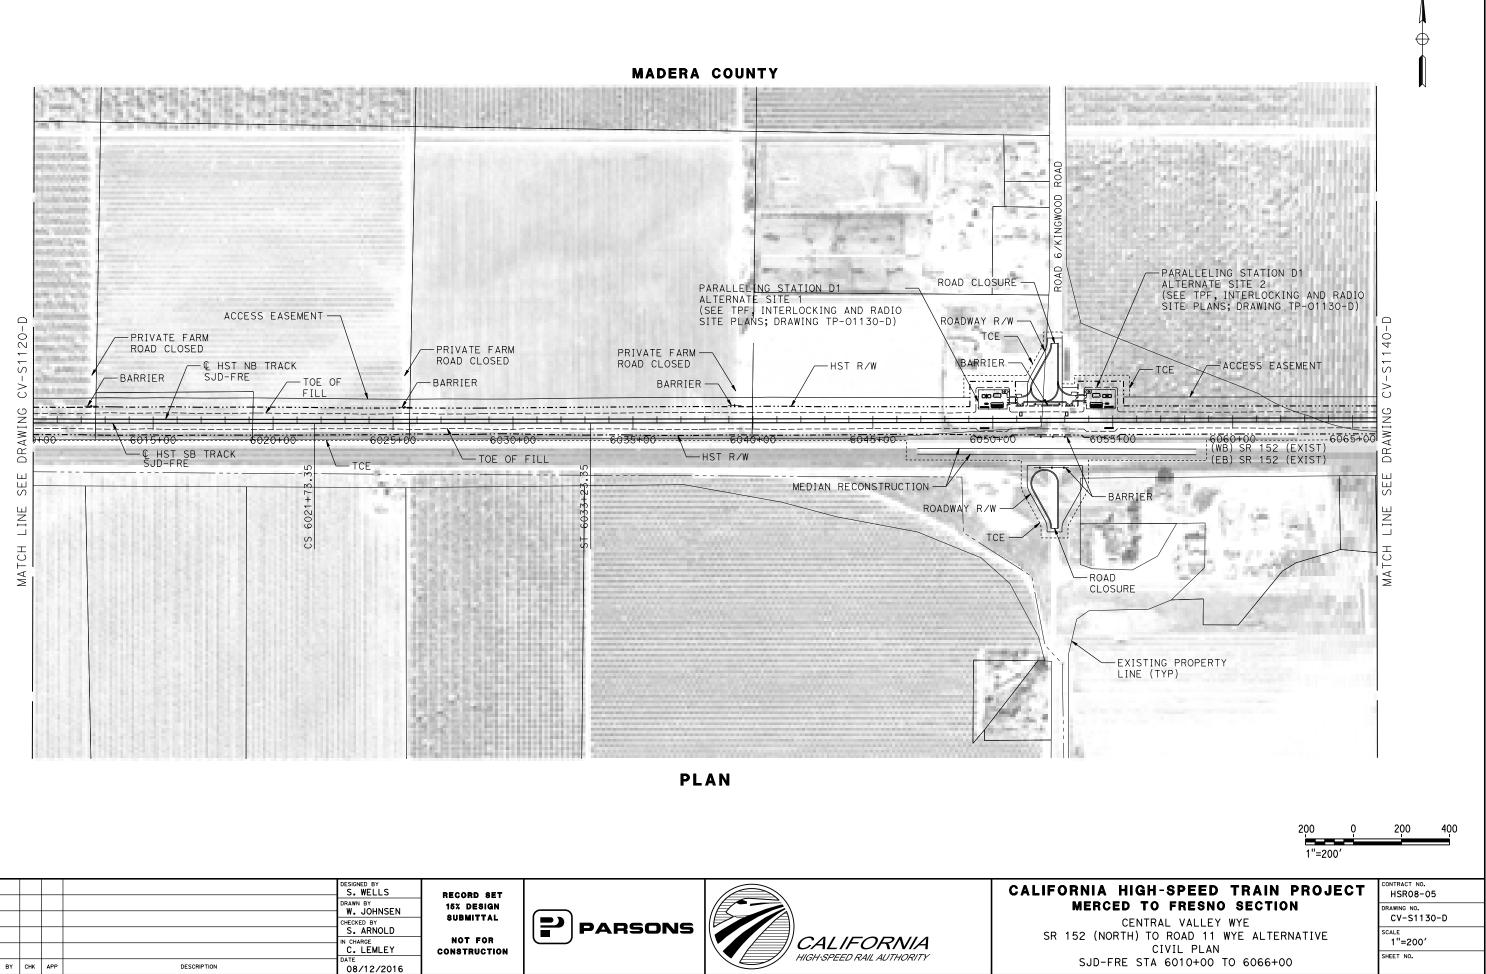




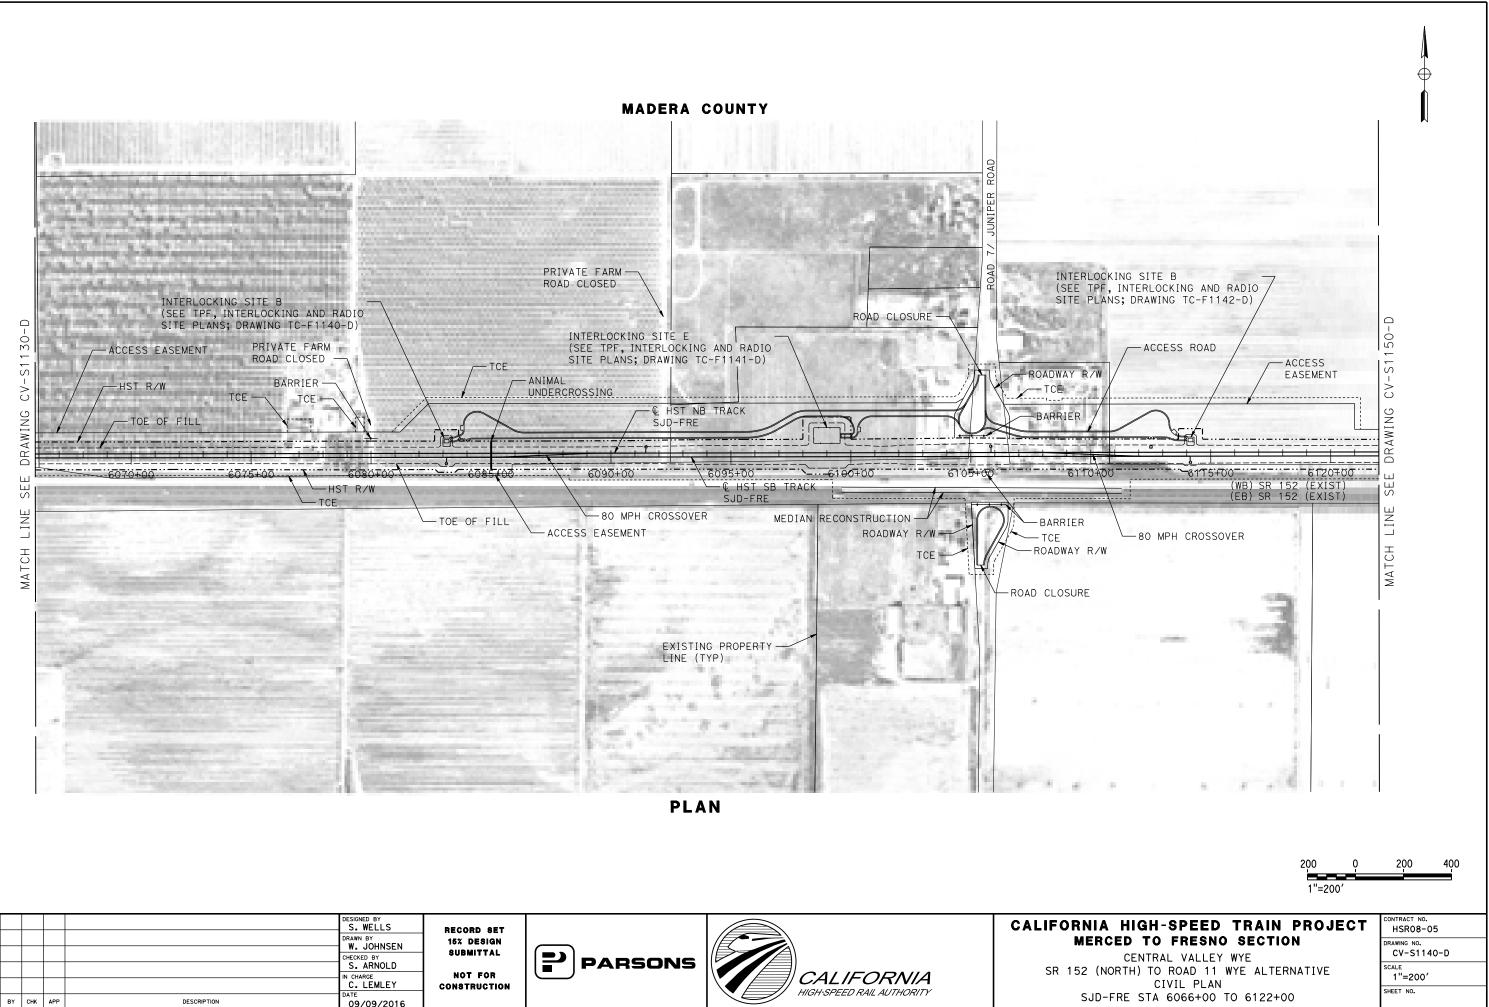


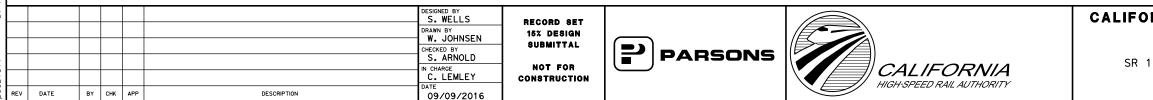






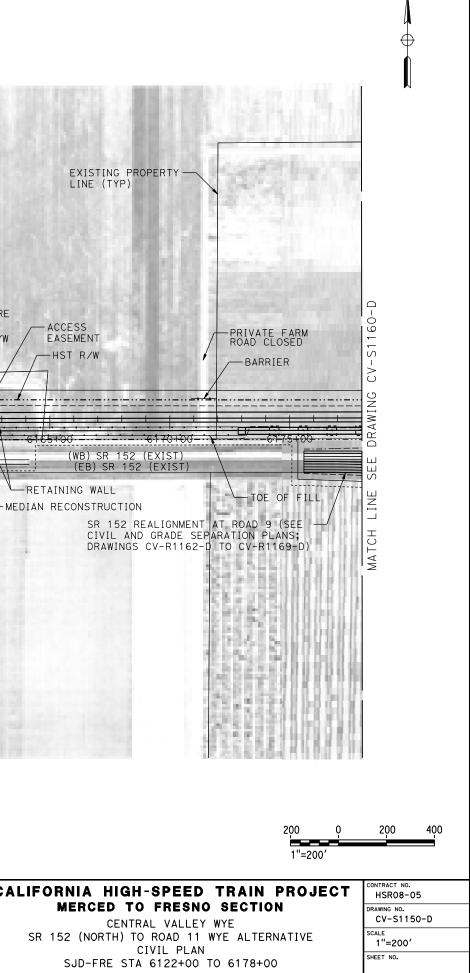
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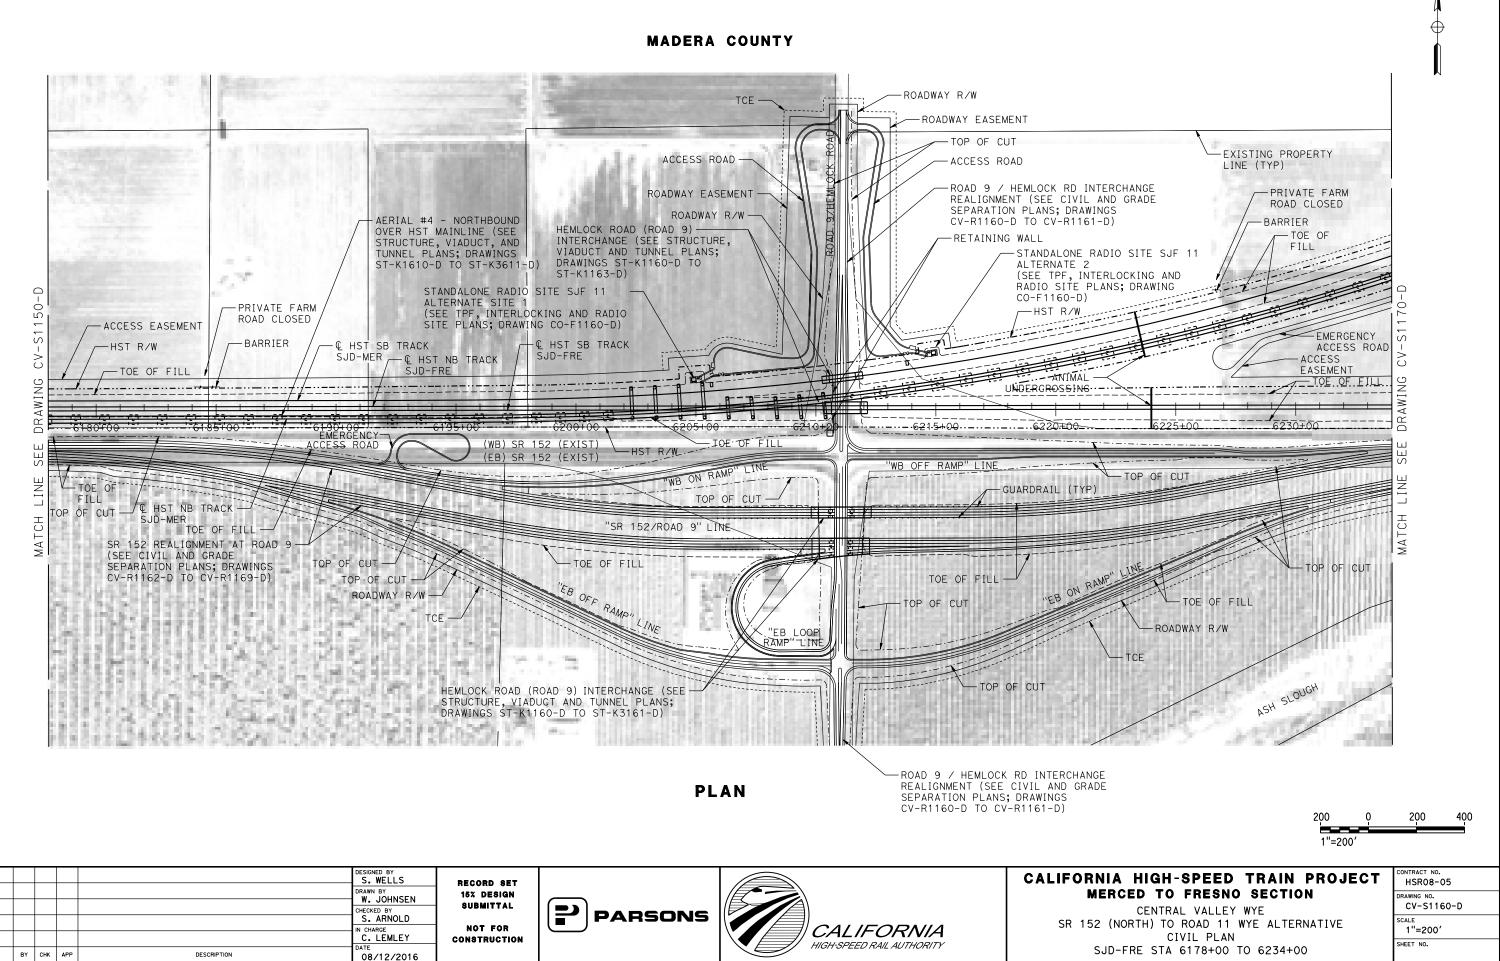


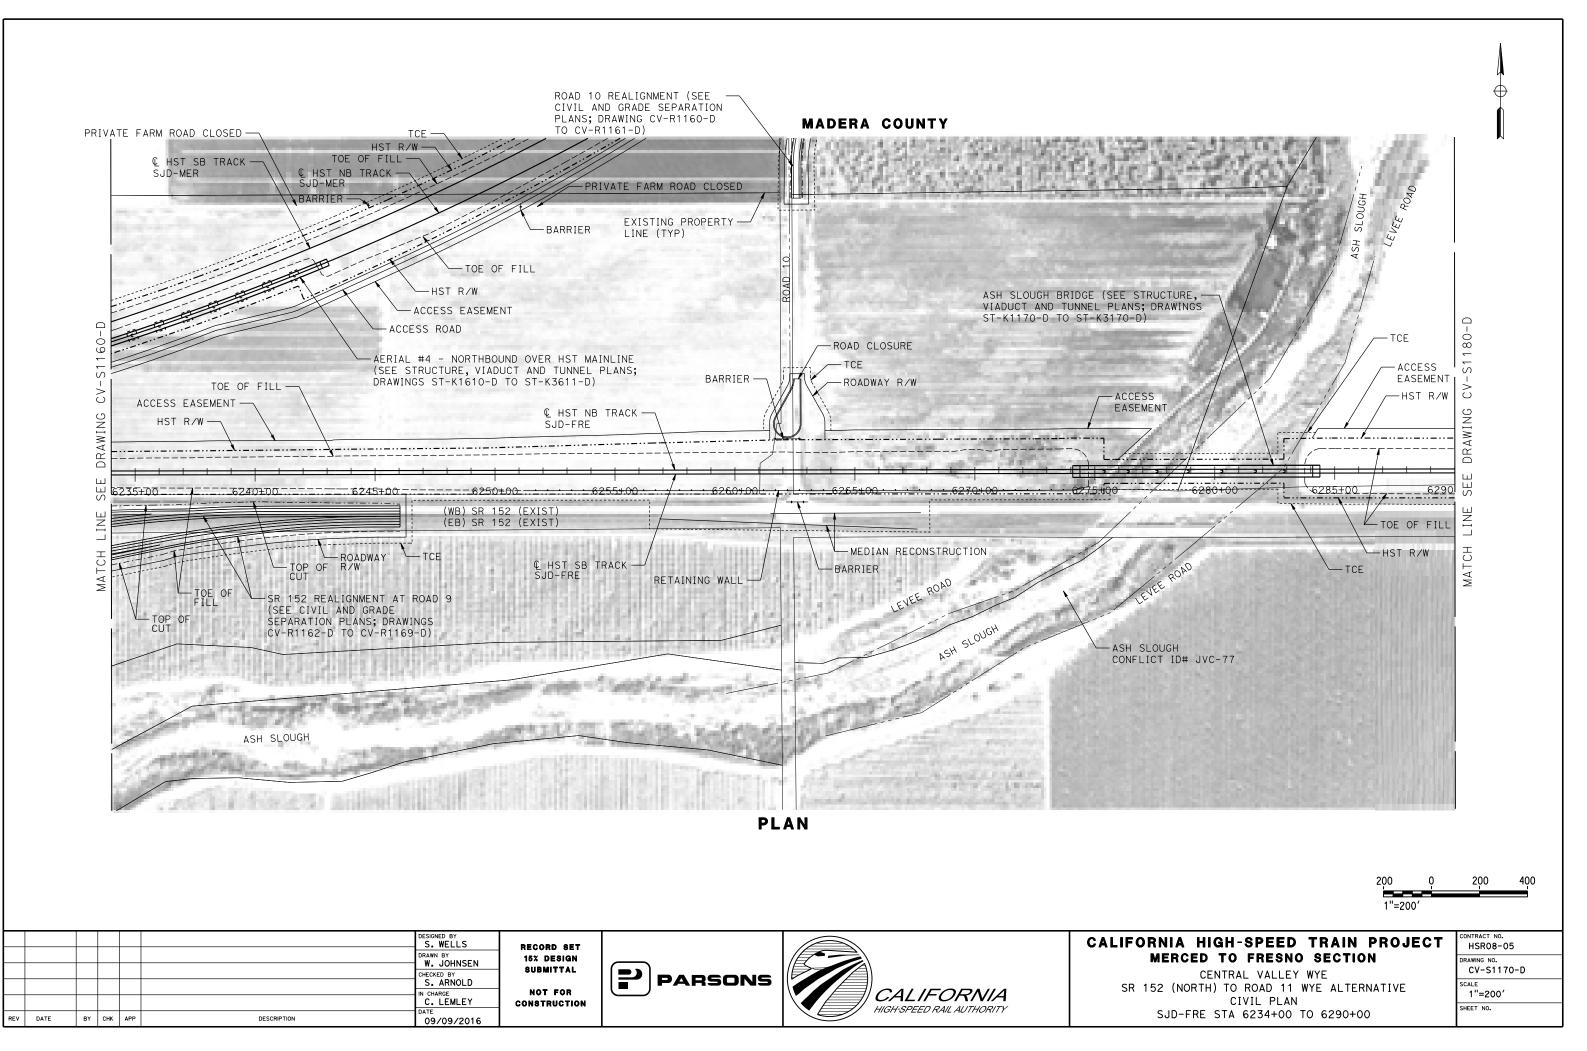


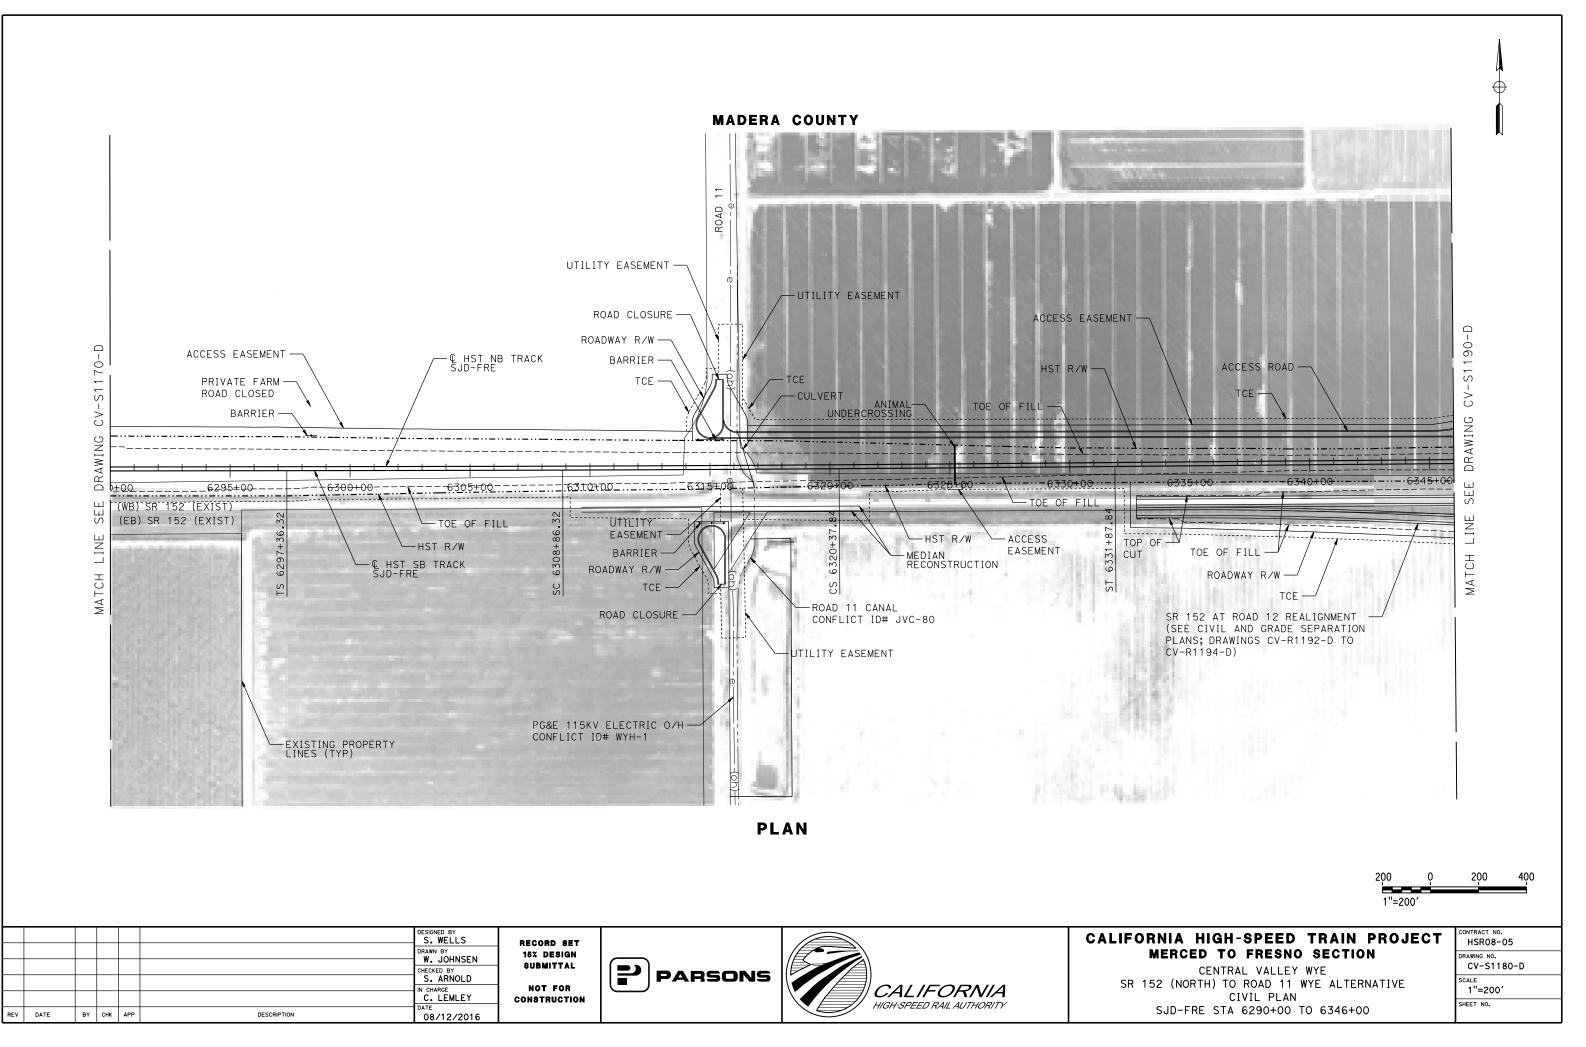
MADERA COUNTY 1000 -INTERLOCKING SITE AA (SEE TPF, INTERLOCKING AND RADIO SITE PLANS; DRAWING TC-F1150-D) ACCESS EASEMENT INTERLOCKING SITE B (SEE TPF, INTERLOCKING AND RADIO SITE PLANS; DRAWING TC-F1151-D) - ACCESS EASEMENT - TCE PRIVATE FARM ROAD CLOSED CV-S1140-D -ROAD CLOSURE - TOE OF -ROADWAY R/W PRIVATE FARM-ROAD CLOSED ACCESS -PRIVATE FARM ROAD CLOSED — -BARRIER BARRIER ROAD -HST R/W DRAWING - - - -6125+00 6130+00 6135+00 SEE - TOE OF FILL - € HST NB TRACK - RETAINING WALL SJD-FRE MATCH LINE BARRIER -HST R/W -€ HST SB TRACK - TCE TCE -SJD-FRE ROADWAY R/W ROAD CLOSURE PLAN

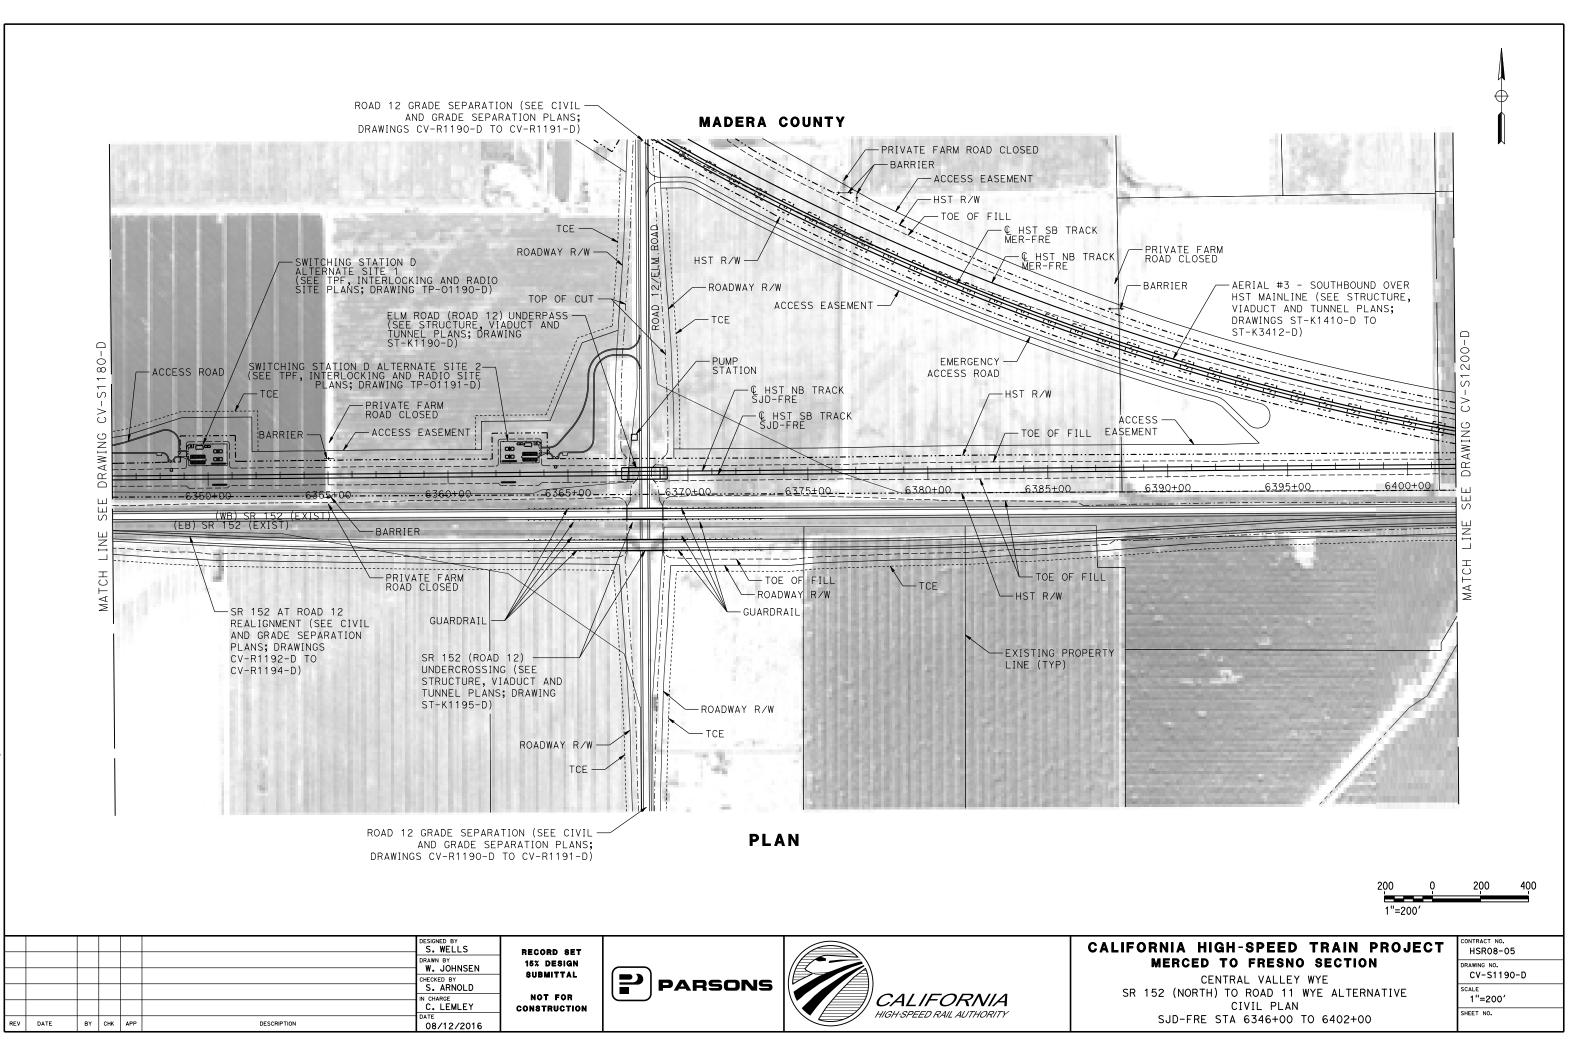
Ę							DESIGNED BY	RECORD SET			CALIFOR
							W. JOHNSEN	15% DESIGN			
-							CHECKED BY S. ARNOLD	SUBMITTAL	PARSONS		CD 15
2181							IN CHARGE C. LEMLEY	NOT FOR CONSTRUCTION			SR 15
000	REV	DATE	BY	снк	APP	DESCRIPTION	DATE 08/12/2016			HIGH-SPEED RAIL AUTHORITY	



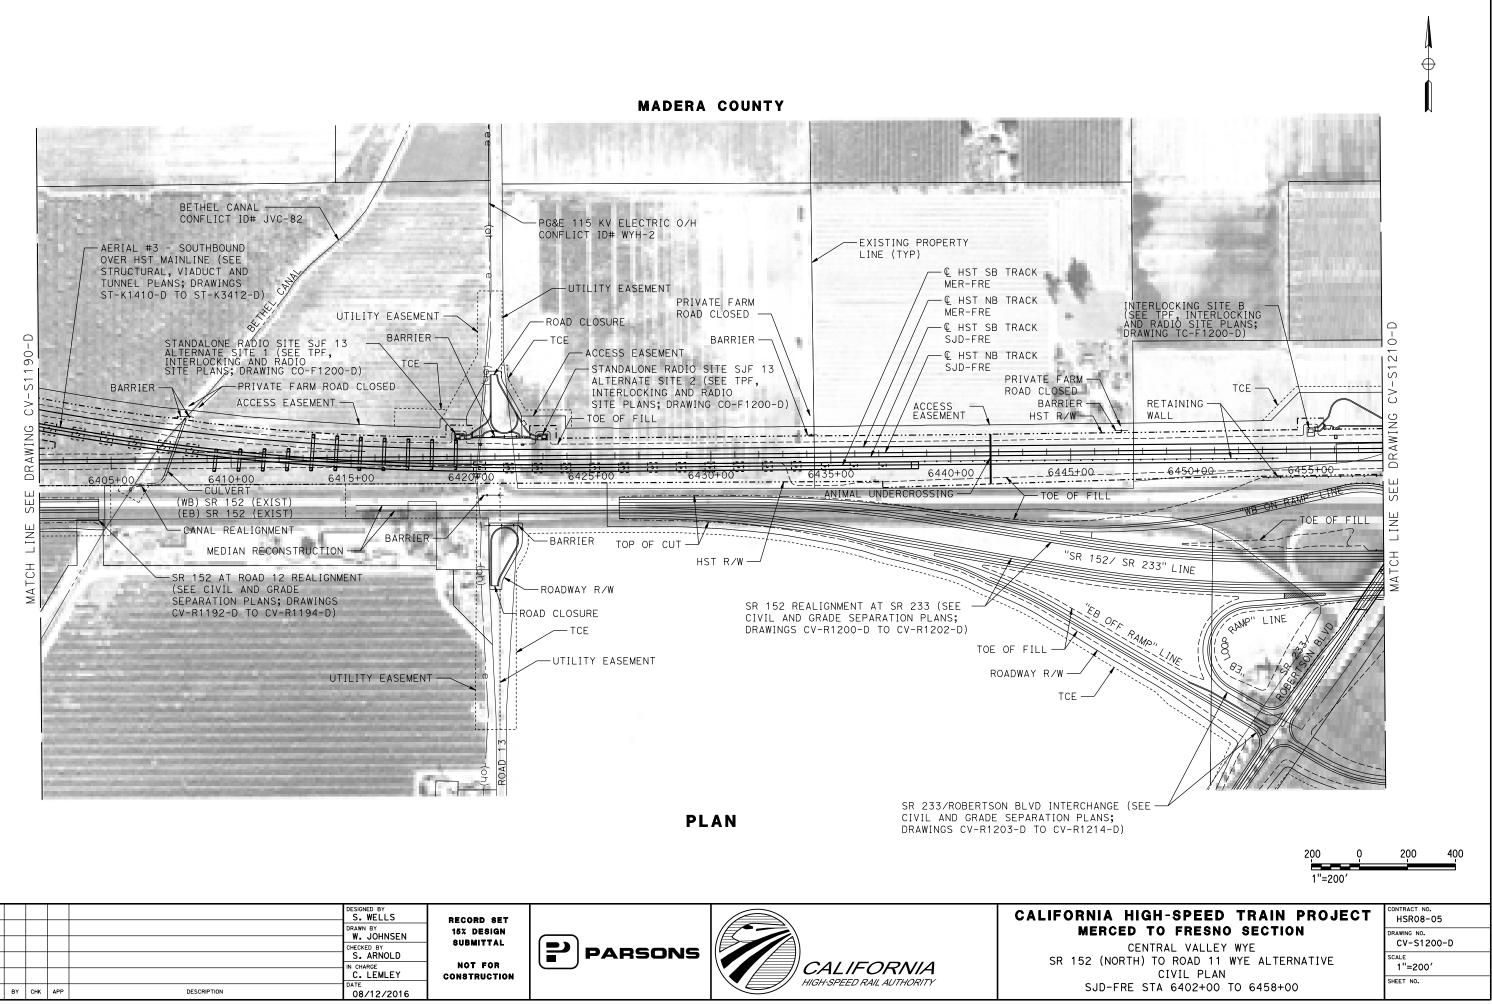




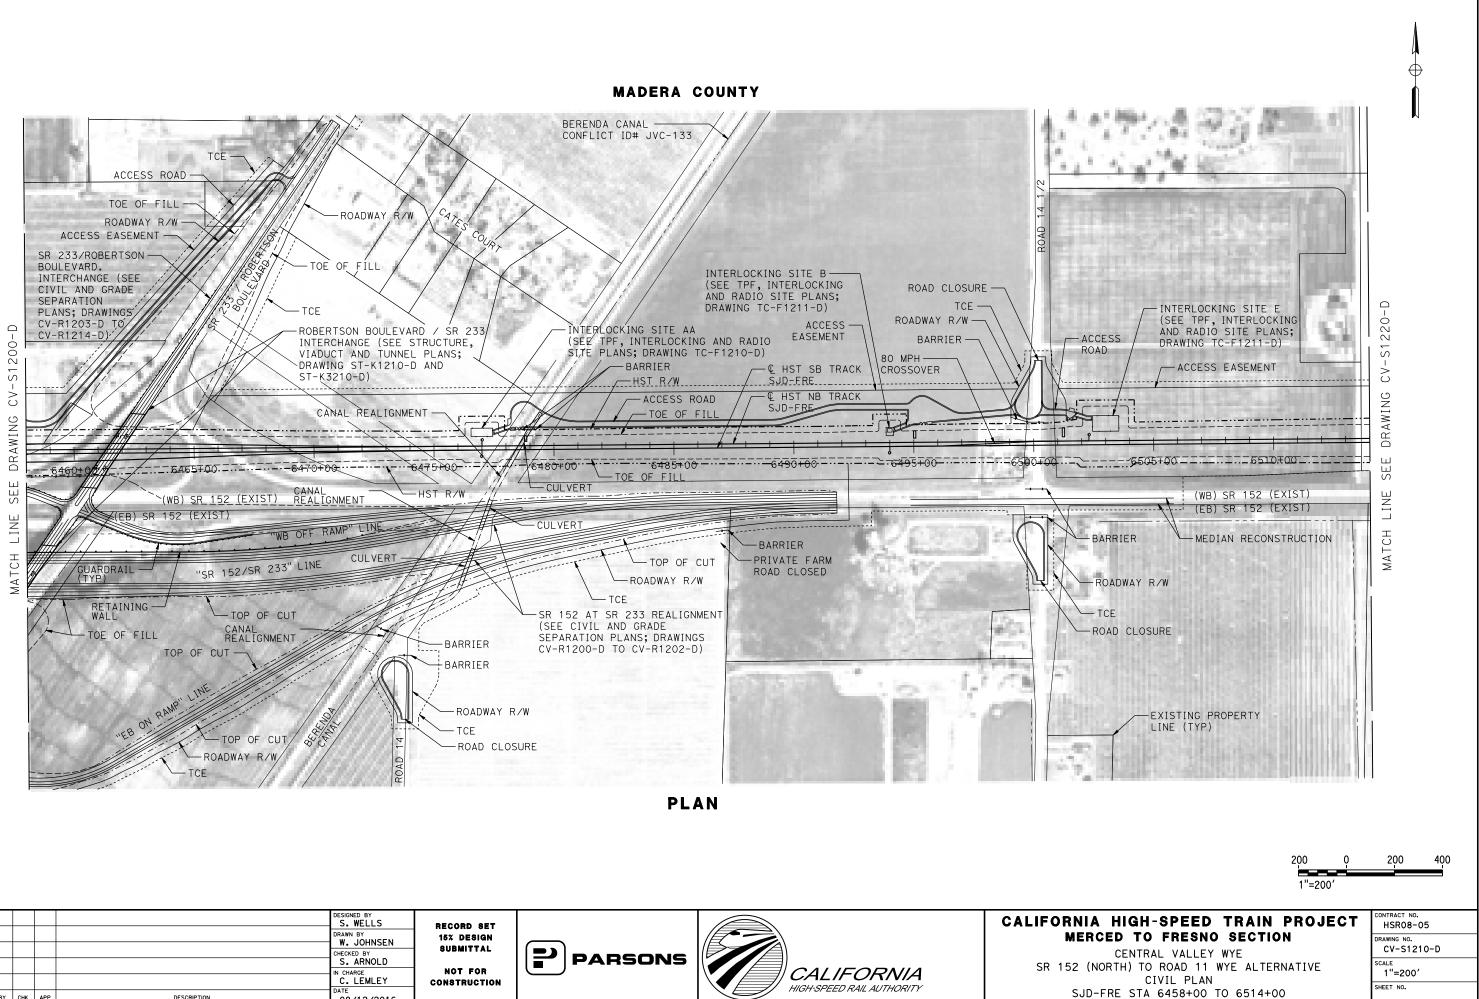


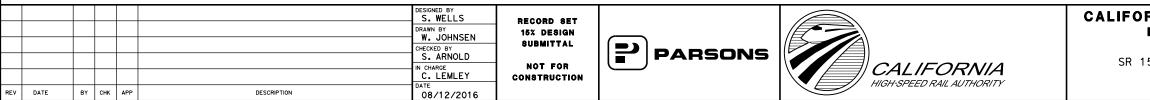


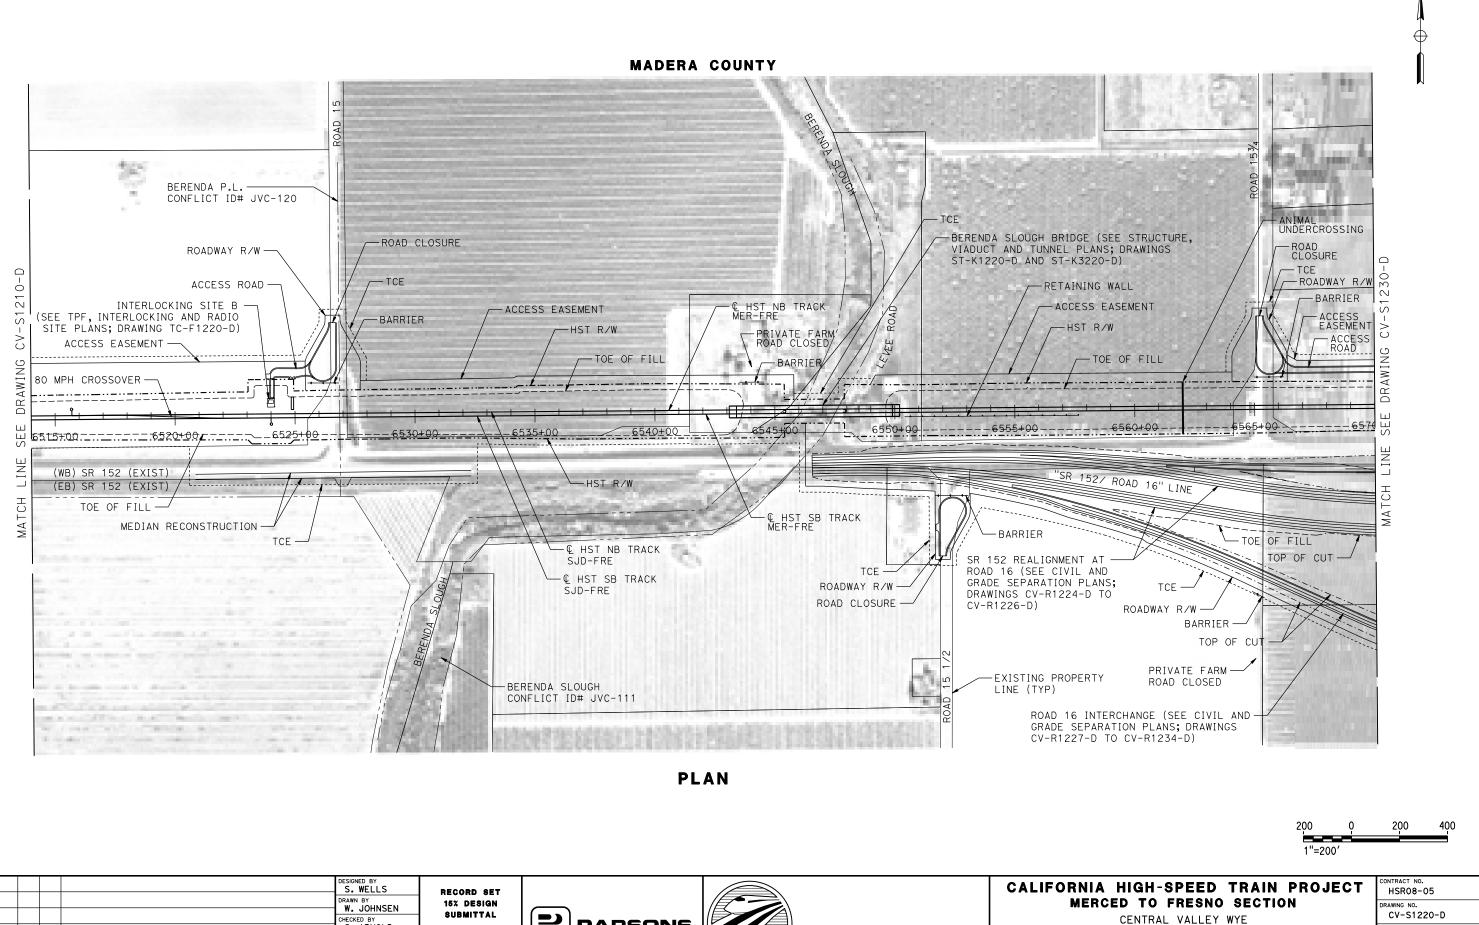
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RFV DATE

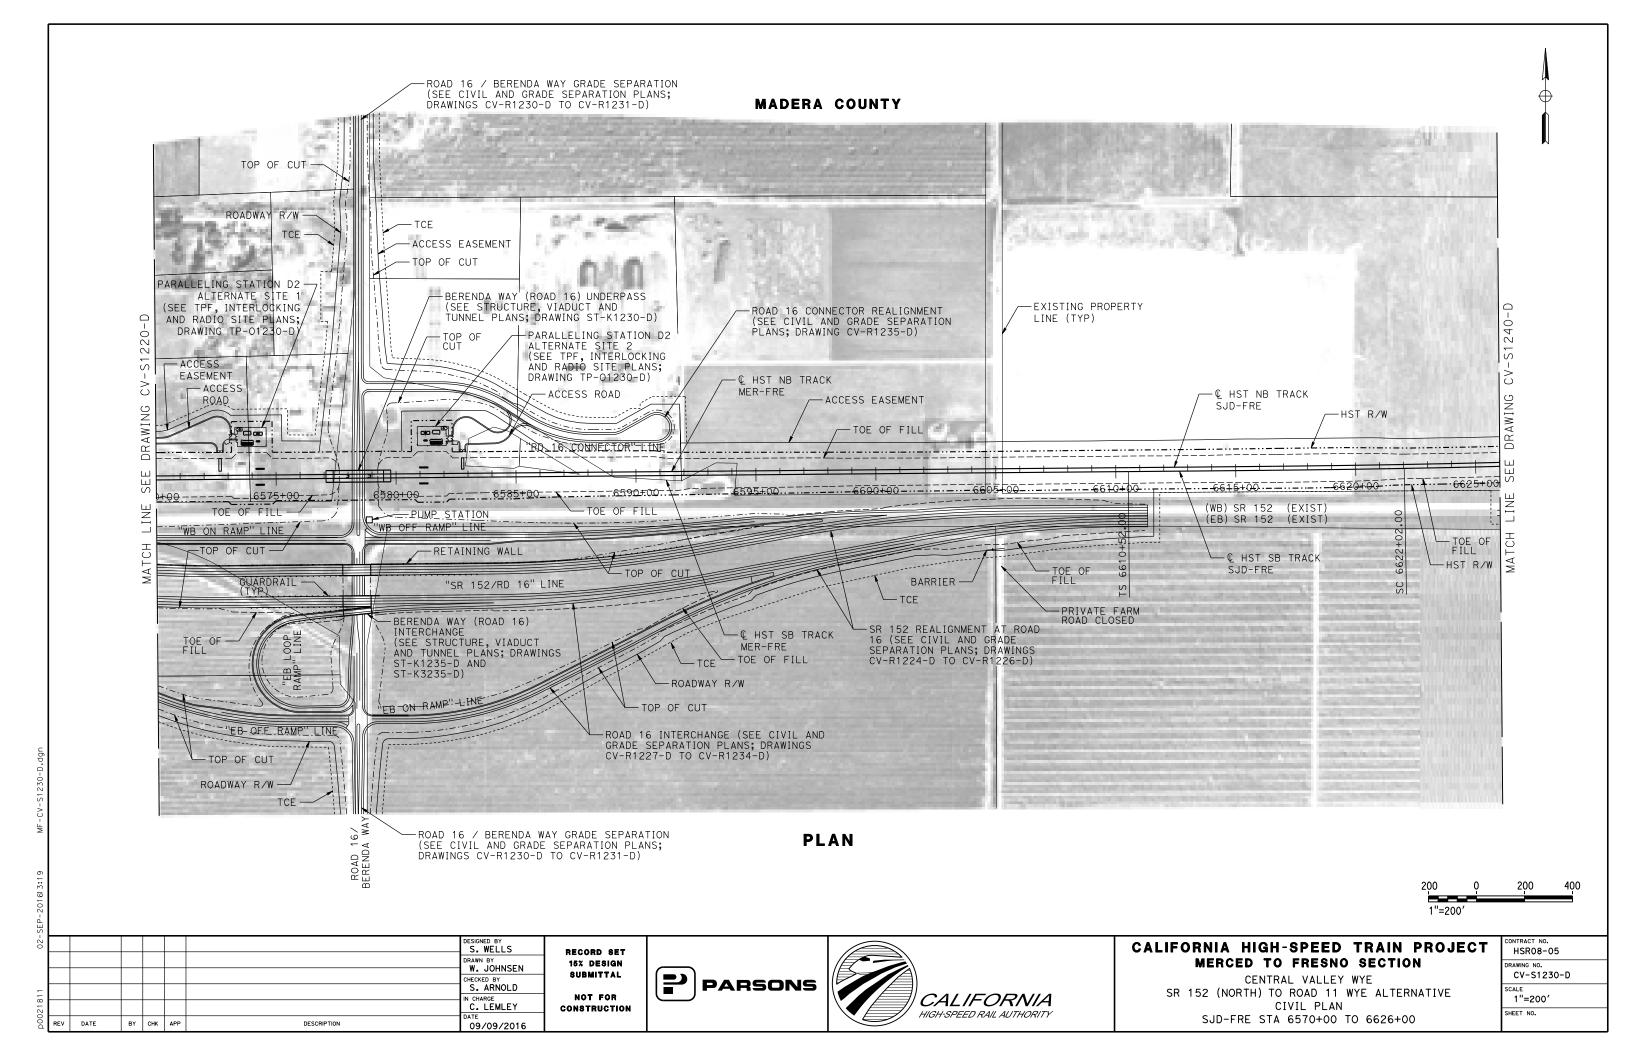




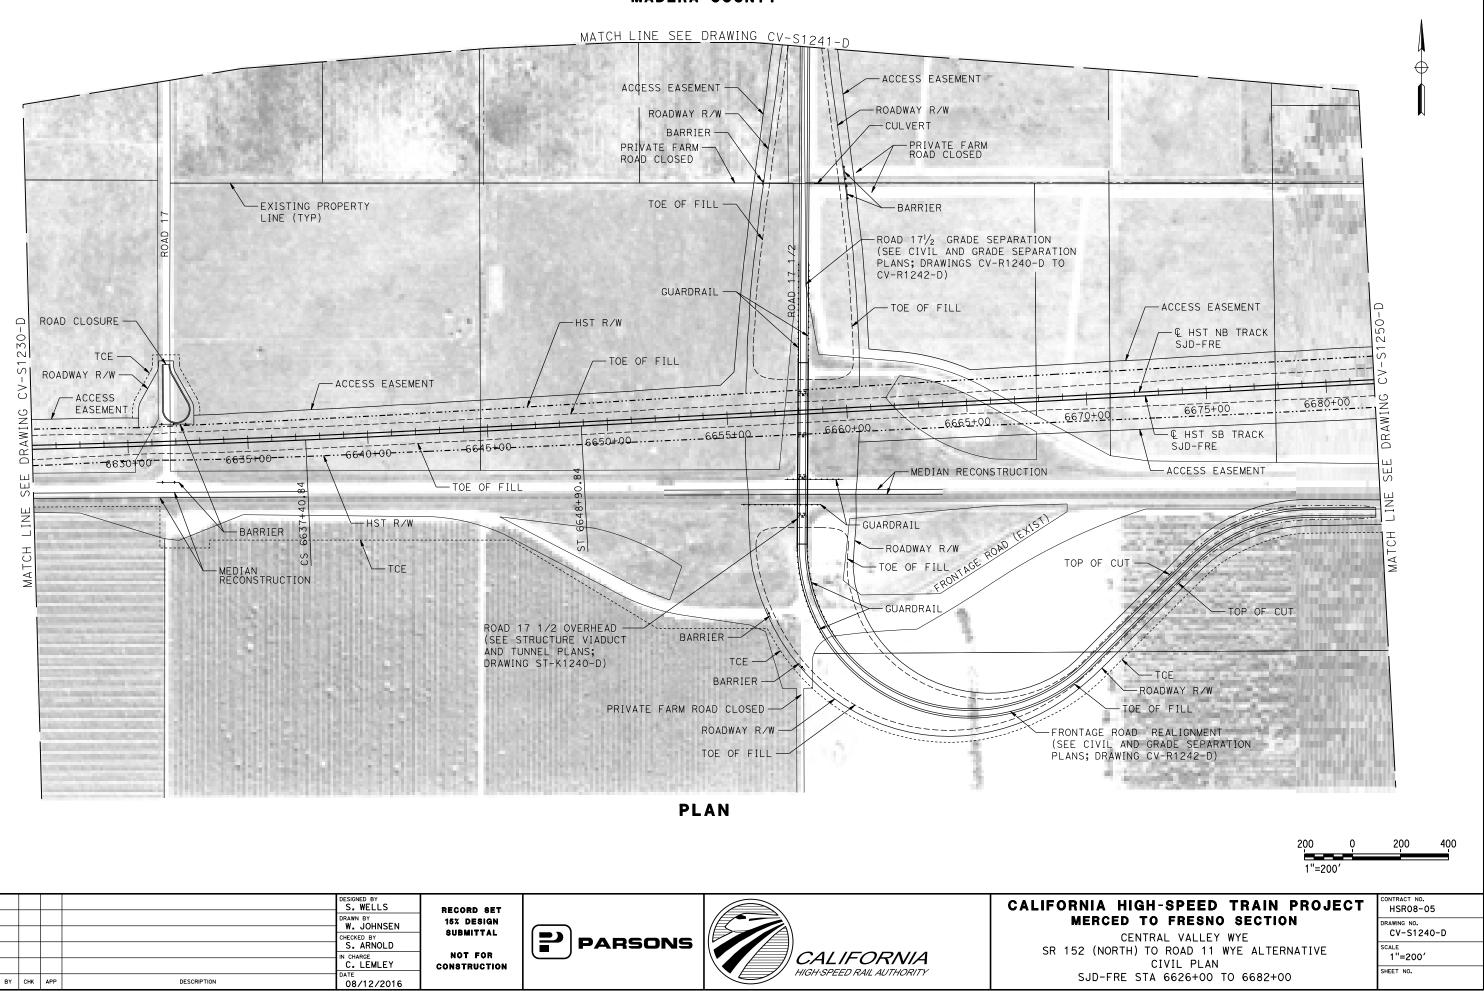


CENTRAL VALLEY WYE CHECKED BY S. ARNOLD PARSONS SR 152 (NORTH) TO ROAD 11 WYE ALTERNATIVE NOT FOR IN CHARGE C. LEMLEY CALIFORNIA CIVIL PLAN CONSTRUCTION HIGH-SPEED RAIL AUTHORITY SJD-FRE STA 6514+00 TO 6570+00 REV DATE BY CHK APP DESCRIPTION 09/09/2016

CALE 1"=200' SHEET NO.







						DESIGNED BY S. WELLS DRAWN BY W. JOHNSEN CHECKED BY	RECORD SET 15% design Submittal			CALIFORI M
						S. ARNOLD	NOT FOR Construction	PARSONS	CALIFORNIA	SR 152
REV	DATE	BY	снк	APP	DESCRIPTION	DATE 08/12/2016	1		HIGH-SPEED RAIL AUTHORITY	9

MADERA COUNTY



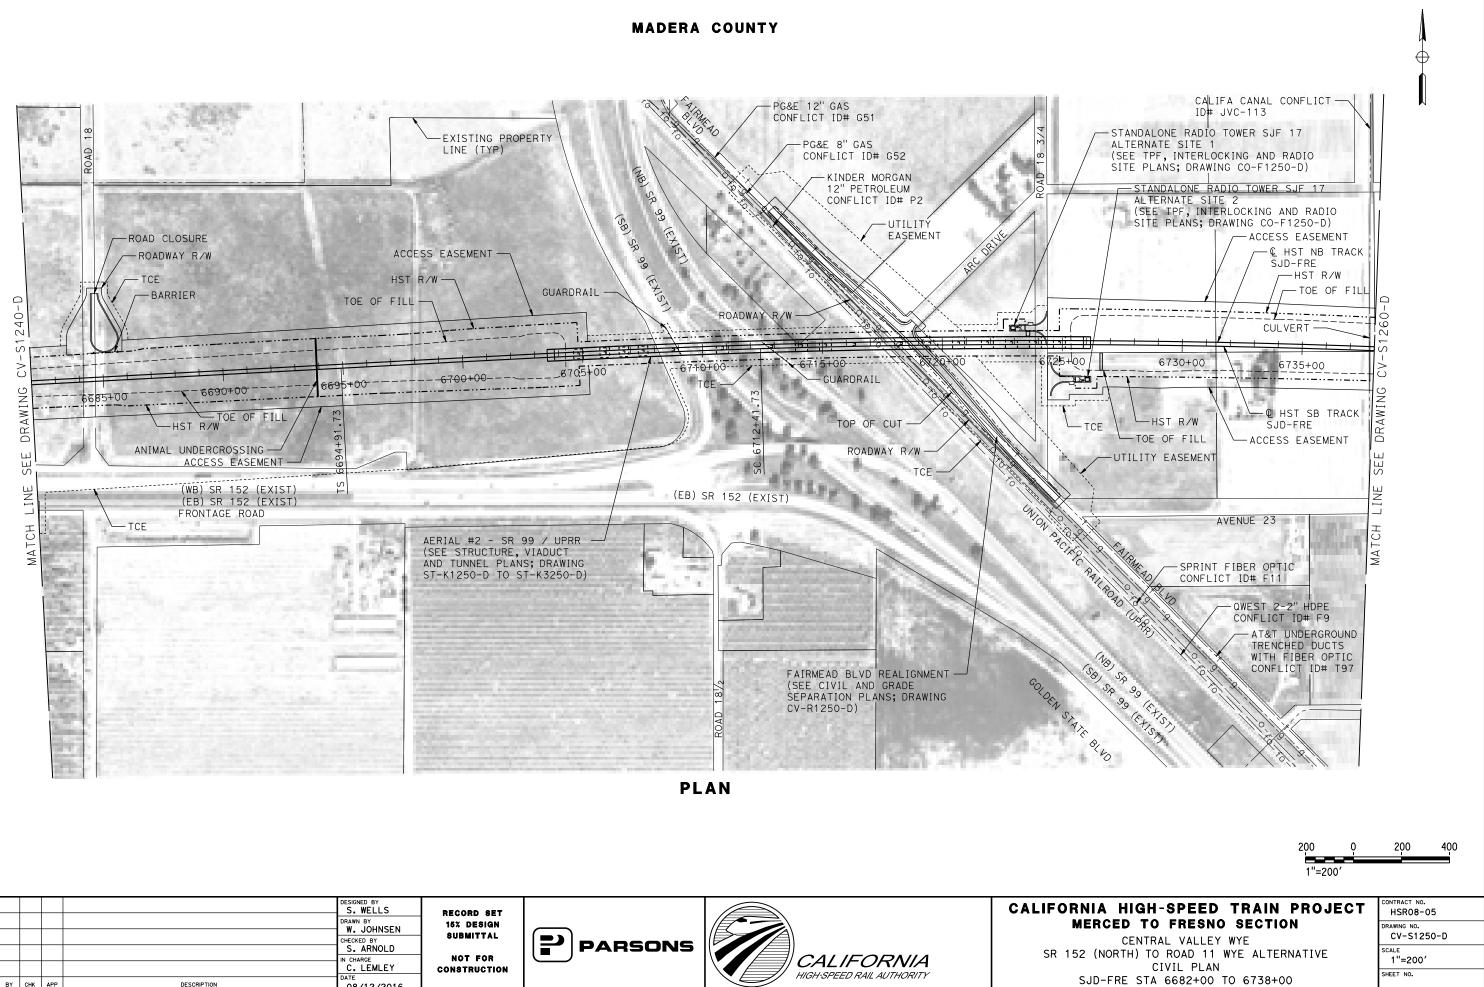
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REV DATE

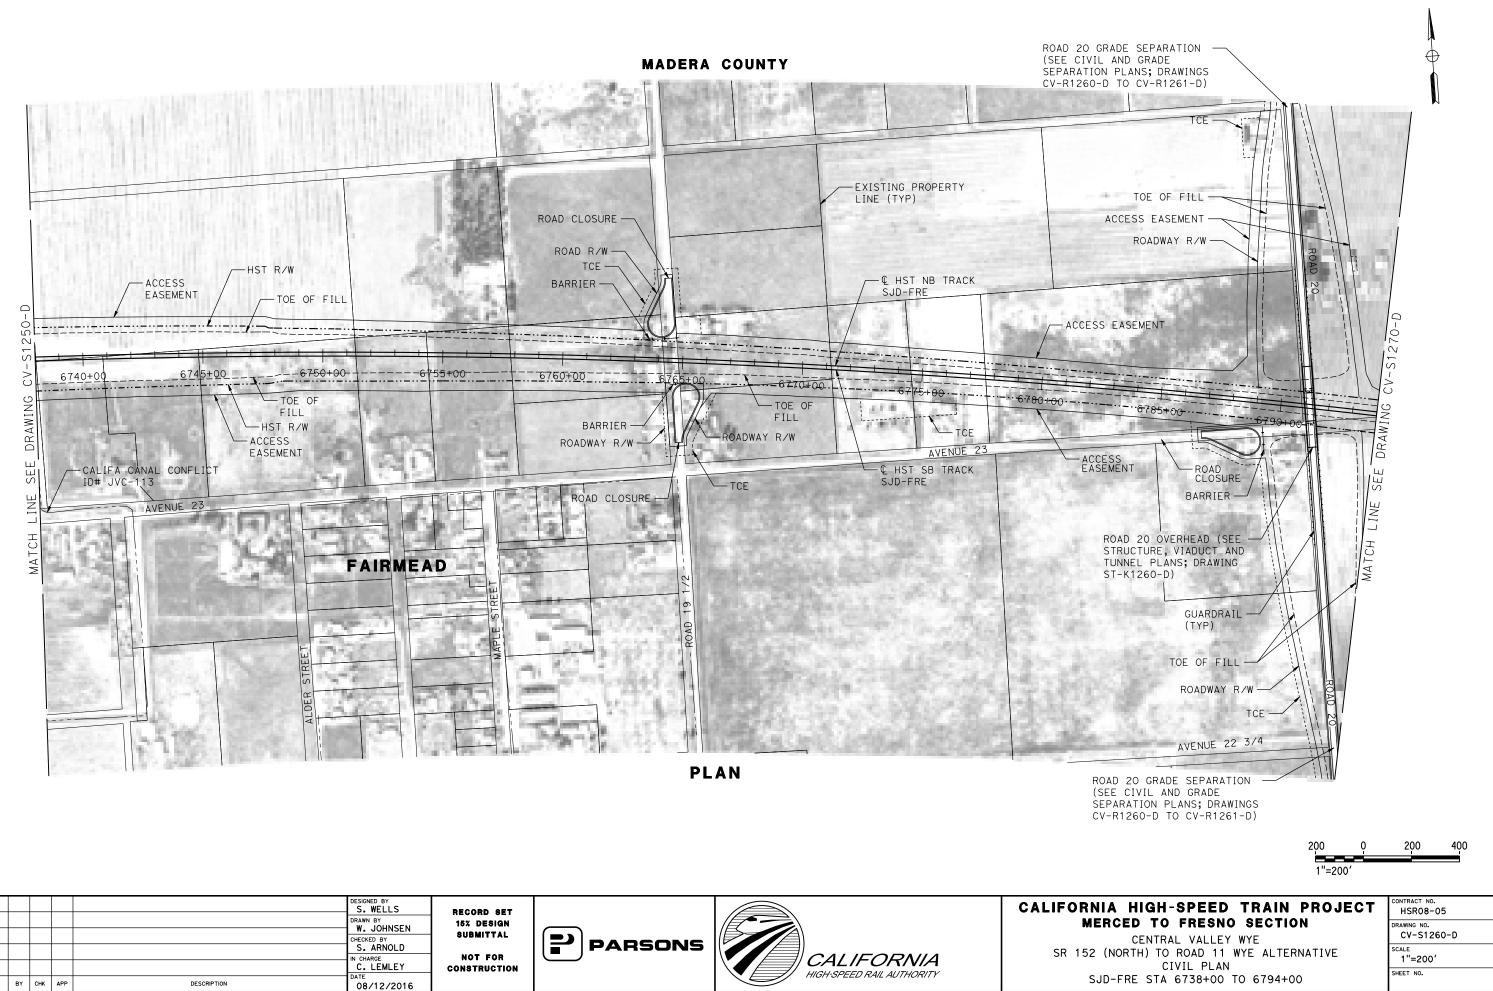
ВҮ СНК АРР

DESCRIPTION

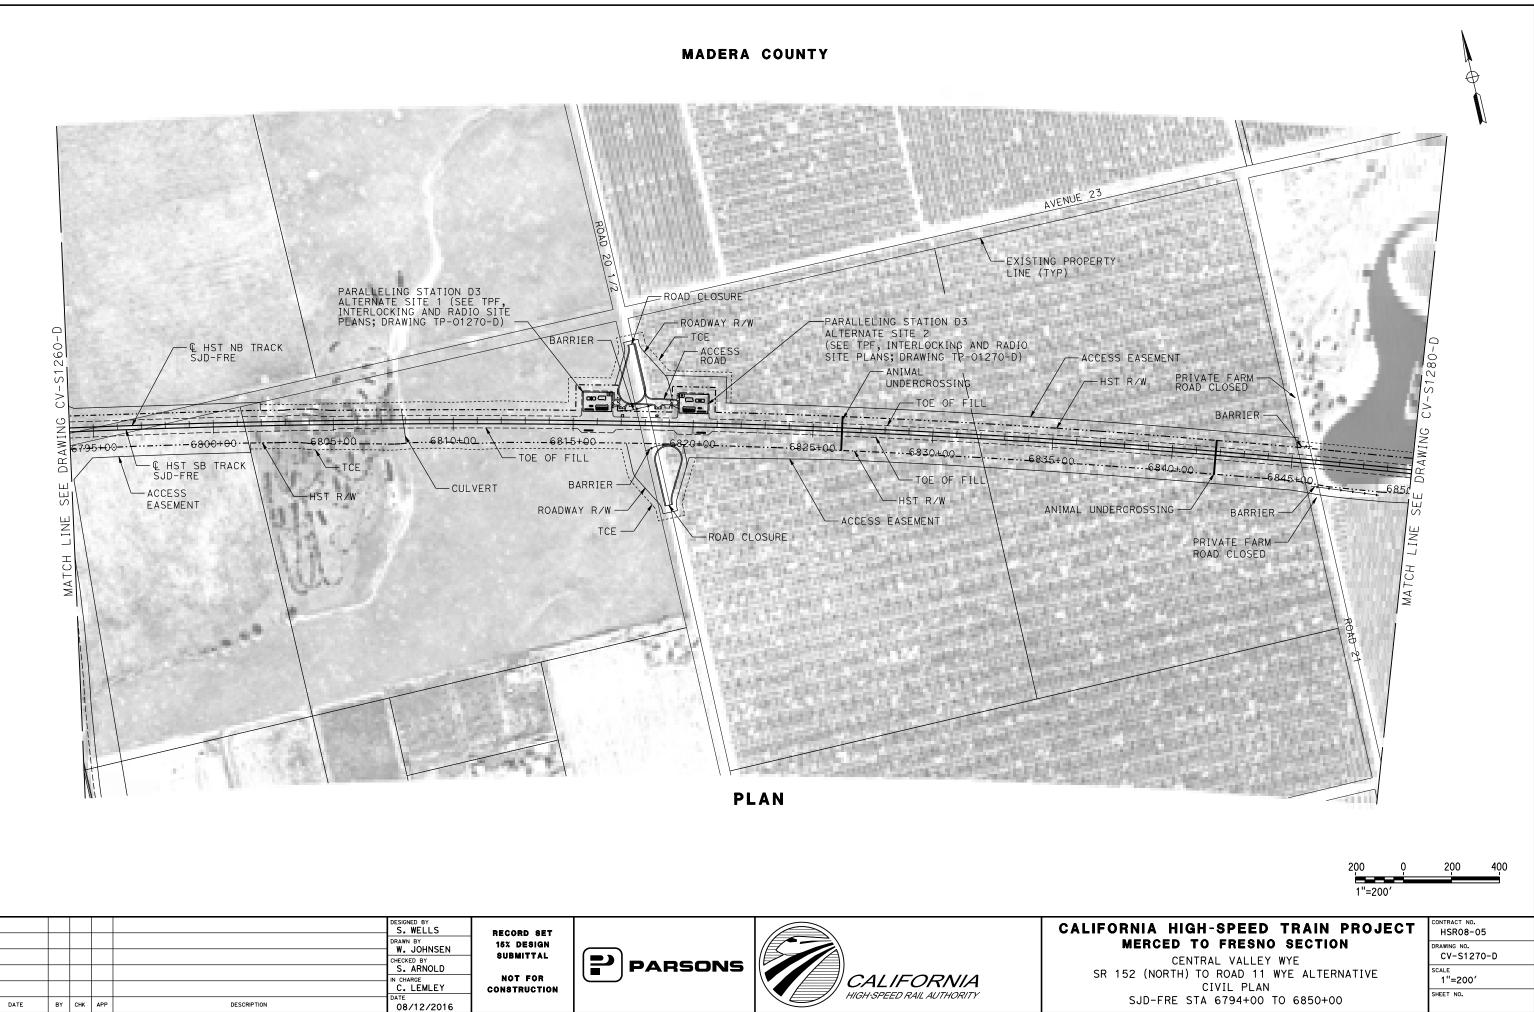
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C. Phys			
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	SPEED TRAIN	N PROJECT	CONTRACT NO. HSR08-05
CENTRA	FRESNO SECT		DRAWING NO. CV-S1241-D SCALE
CI	ROAD 11 WYE ALT VIL PLAN E ACCESS ROAD	ERNATIVE	1"=200'



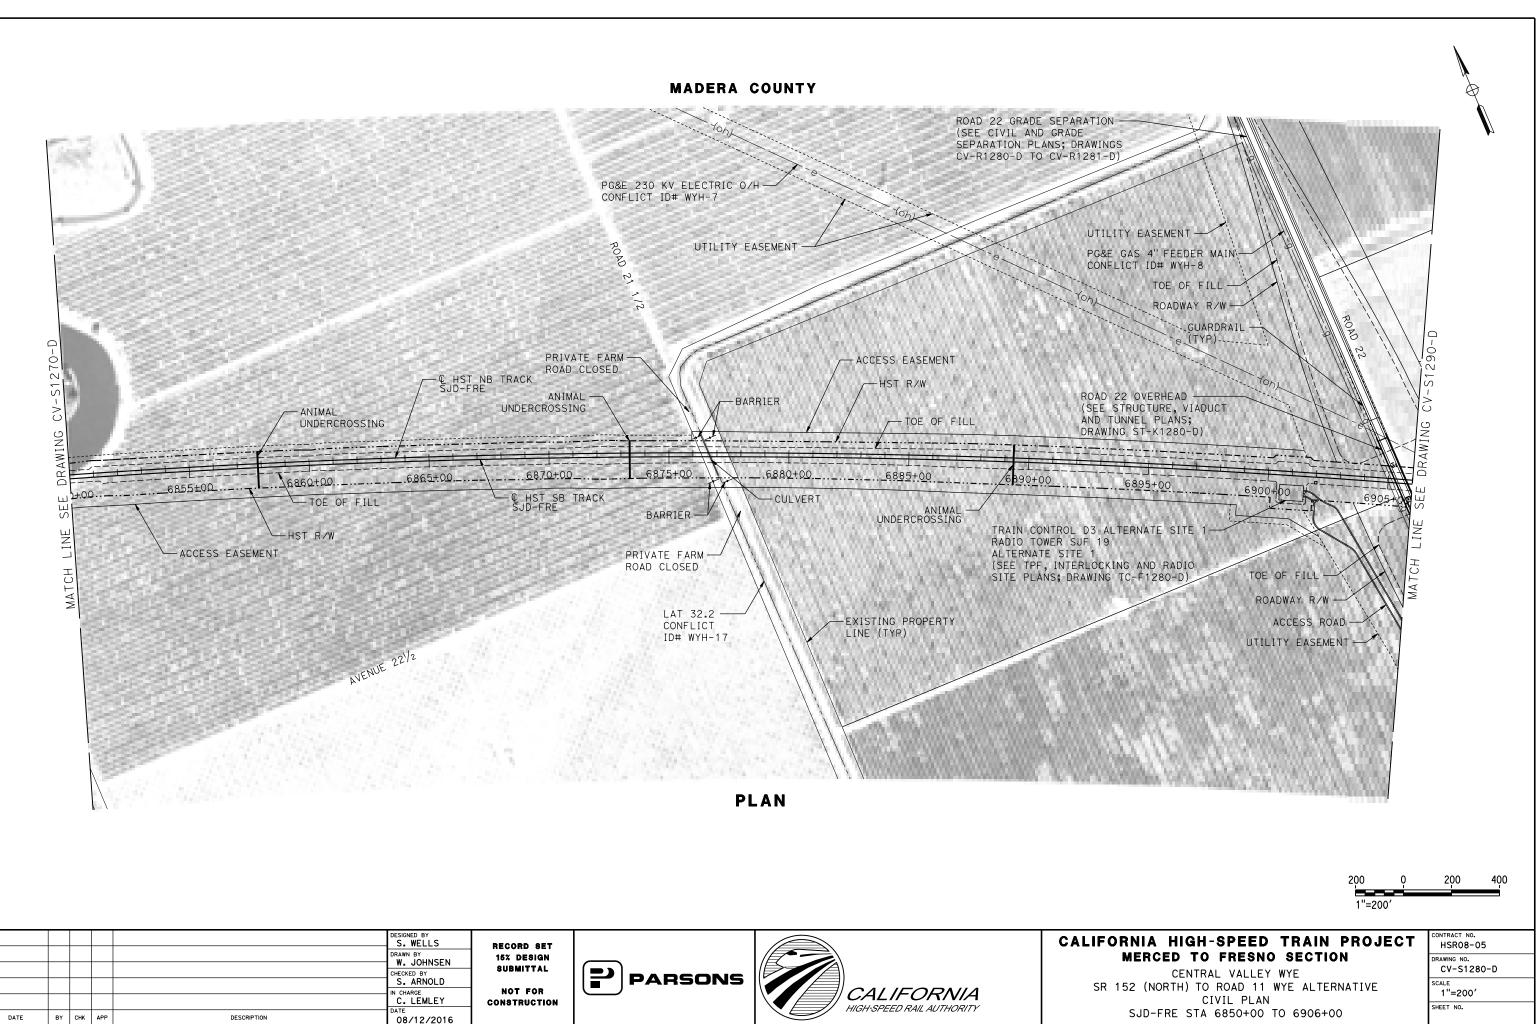
		_	_	DESIGNED BY S. WELLS DRAWN BY W. JOHNSEN	RECORD SET 15% Design			CALIFOR
EV	DATE E	вү снк	IK APP	CHECKED BY S. ARNOLD IN CHARGE C. LEMLEY DATE 08/12/2016	SUBMITTAL NOT FOR Construction	PARSONS	CALIFORNIA HIGH-SPEED RAIL AUTHORITY	SR 15



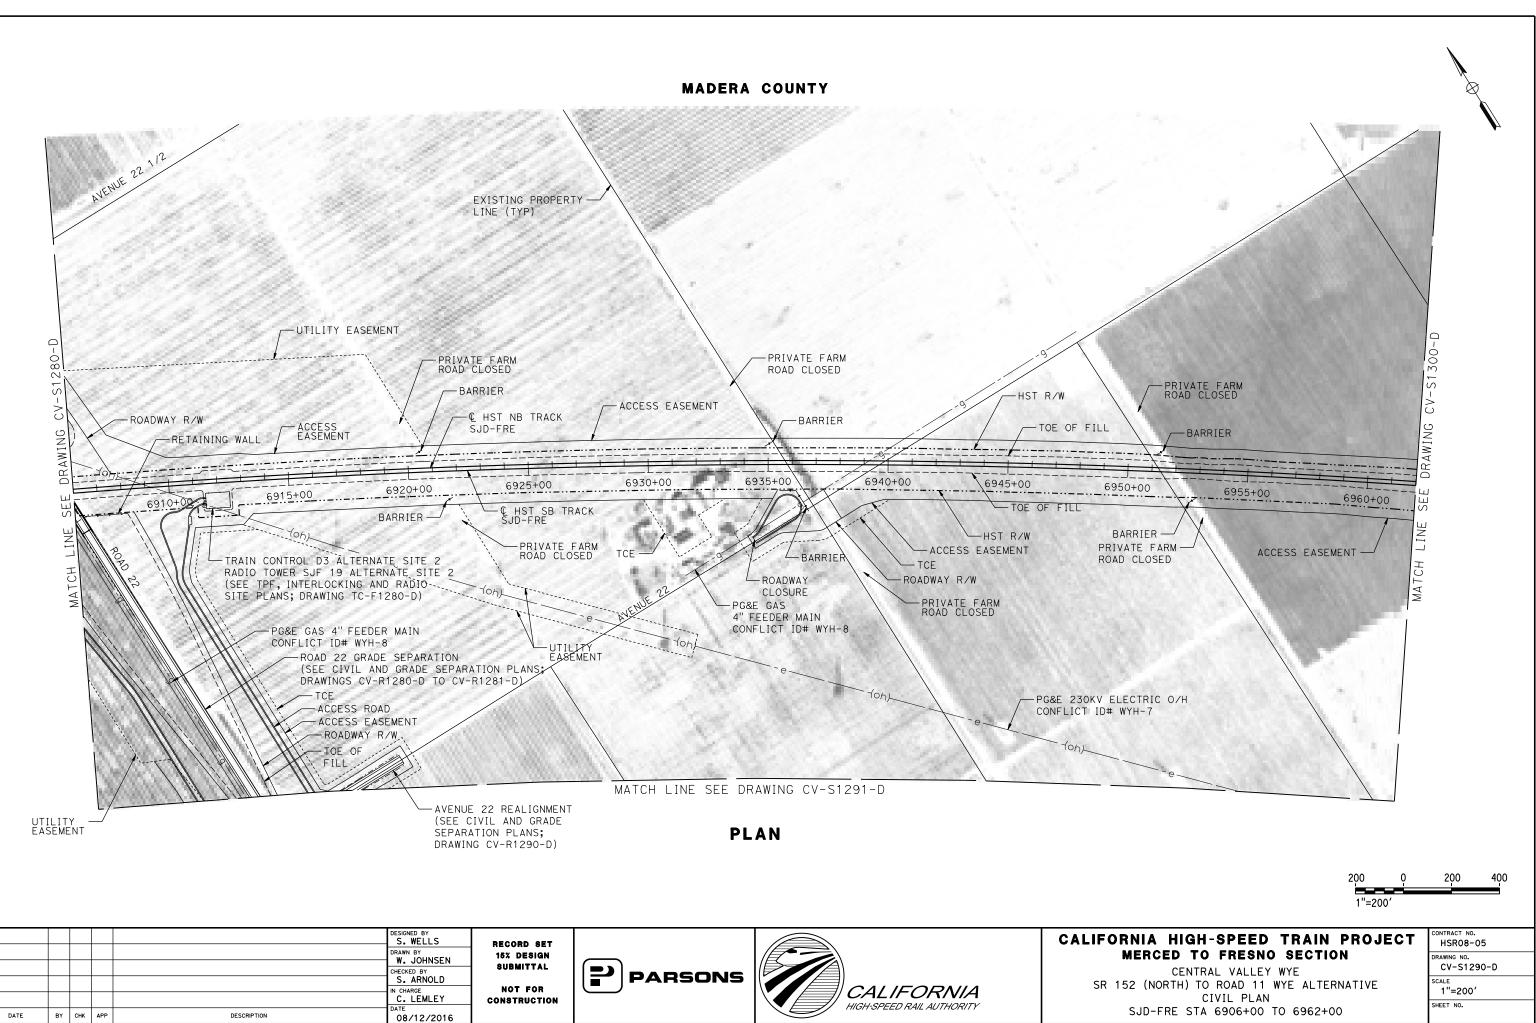
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						W. JOHNSEN	15% DESIGN		₽
						CHECKED BY S. ARNOLD	SUBMITTAL		CD 45
⊢						IN CHARGE C. LEMLEY	NOT FOR CONSTRUCTION	CALIFORNIA	SR 15
REV	DATE	BY	снк	APP	DESCRIPTION	DATE 08/12/2016		HIGH-SPEED RAIL AUTHORITY	



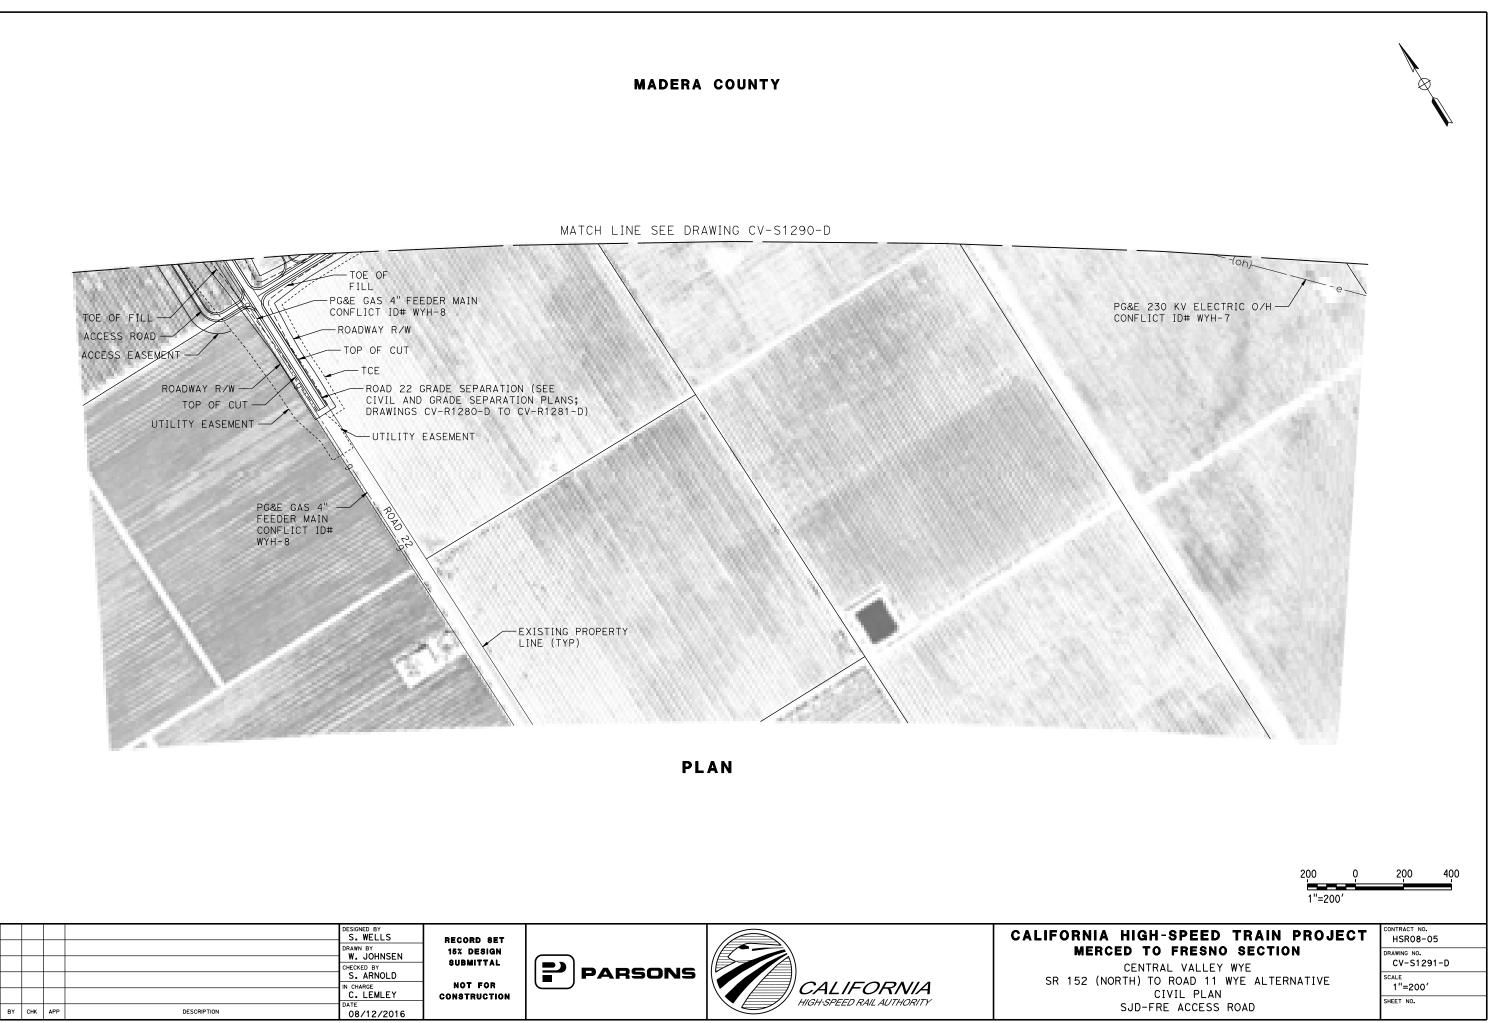
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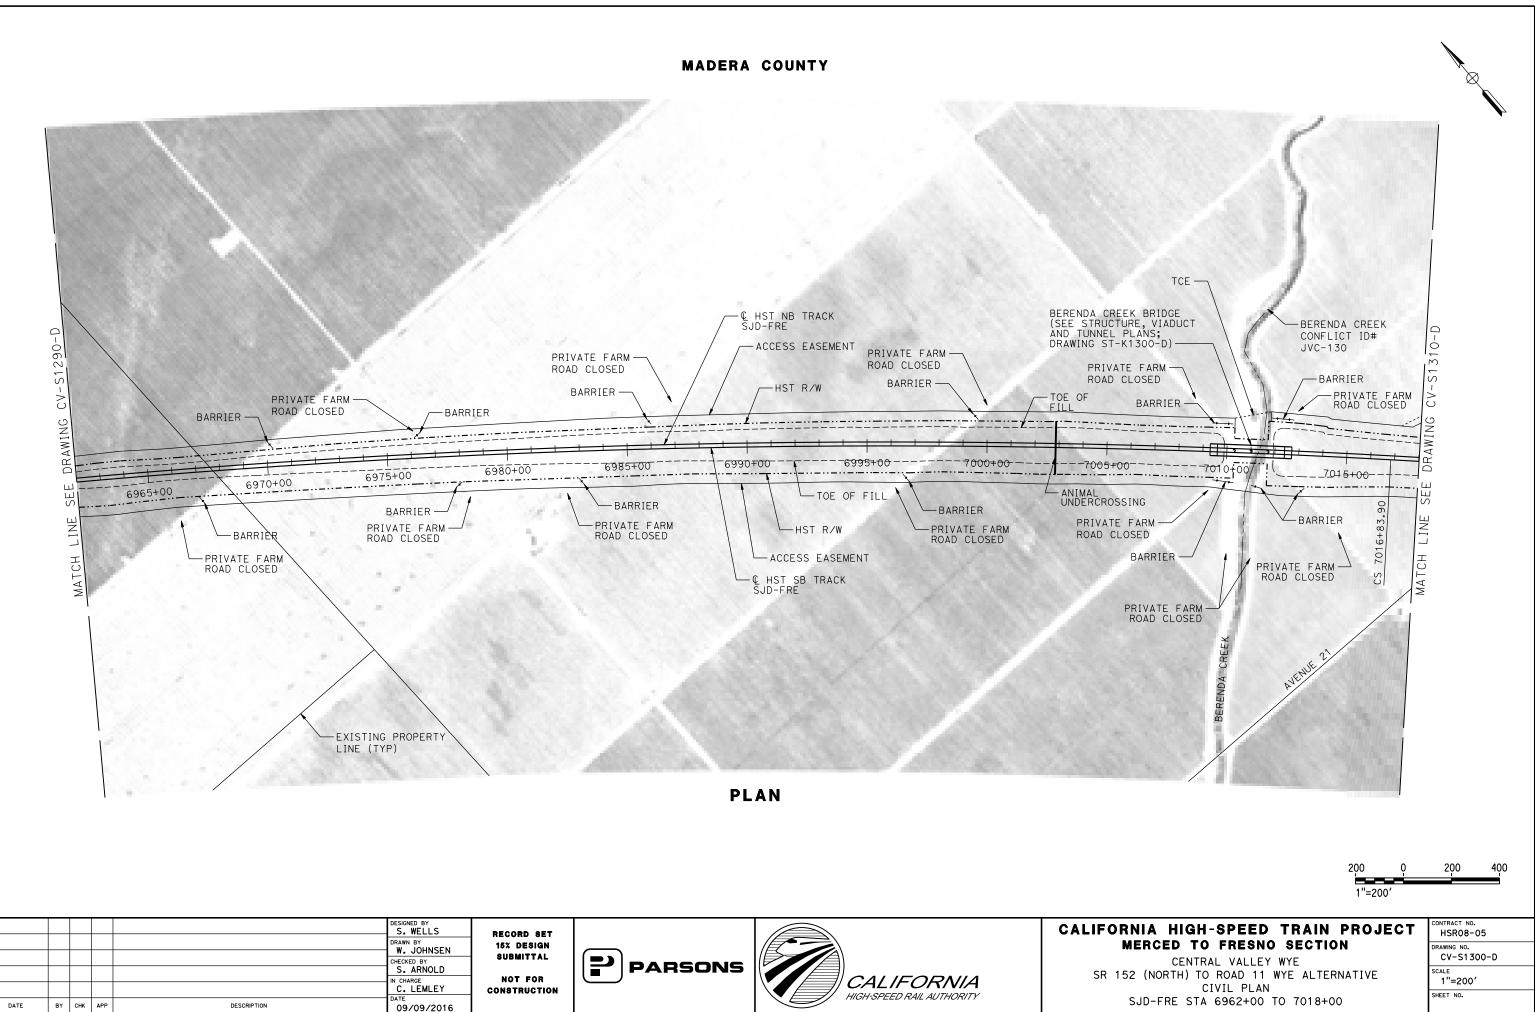


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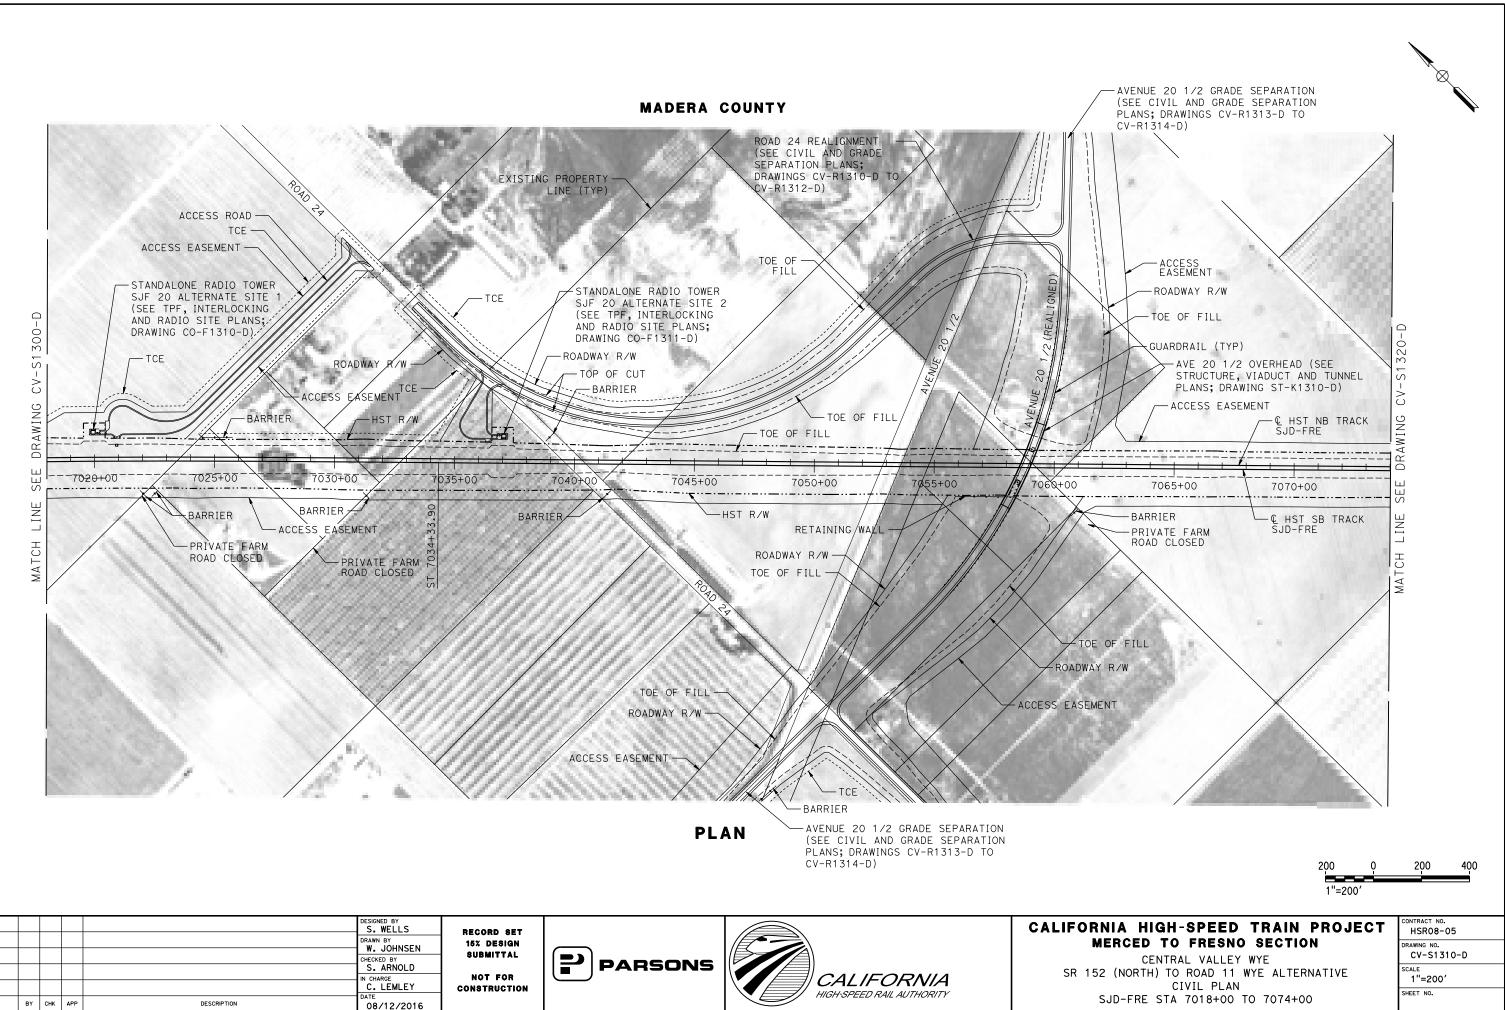


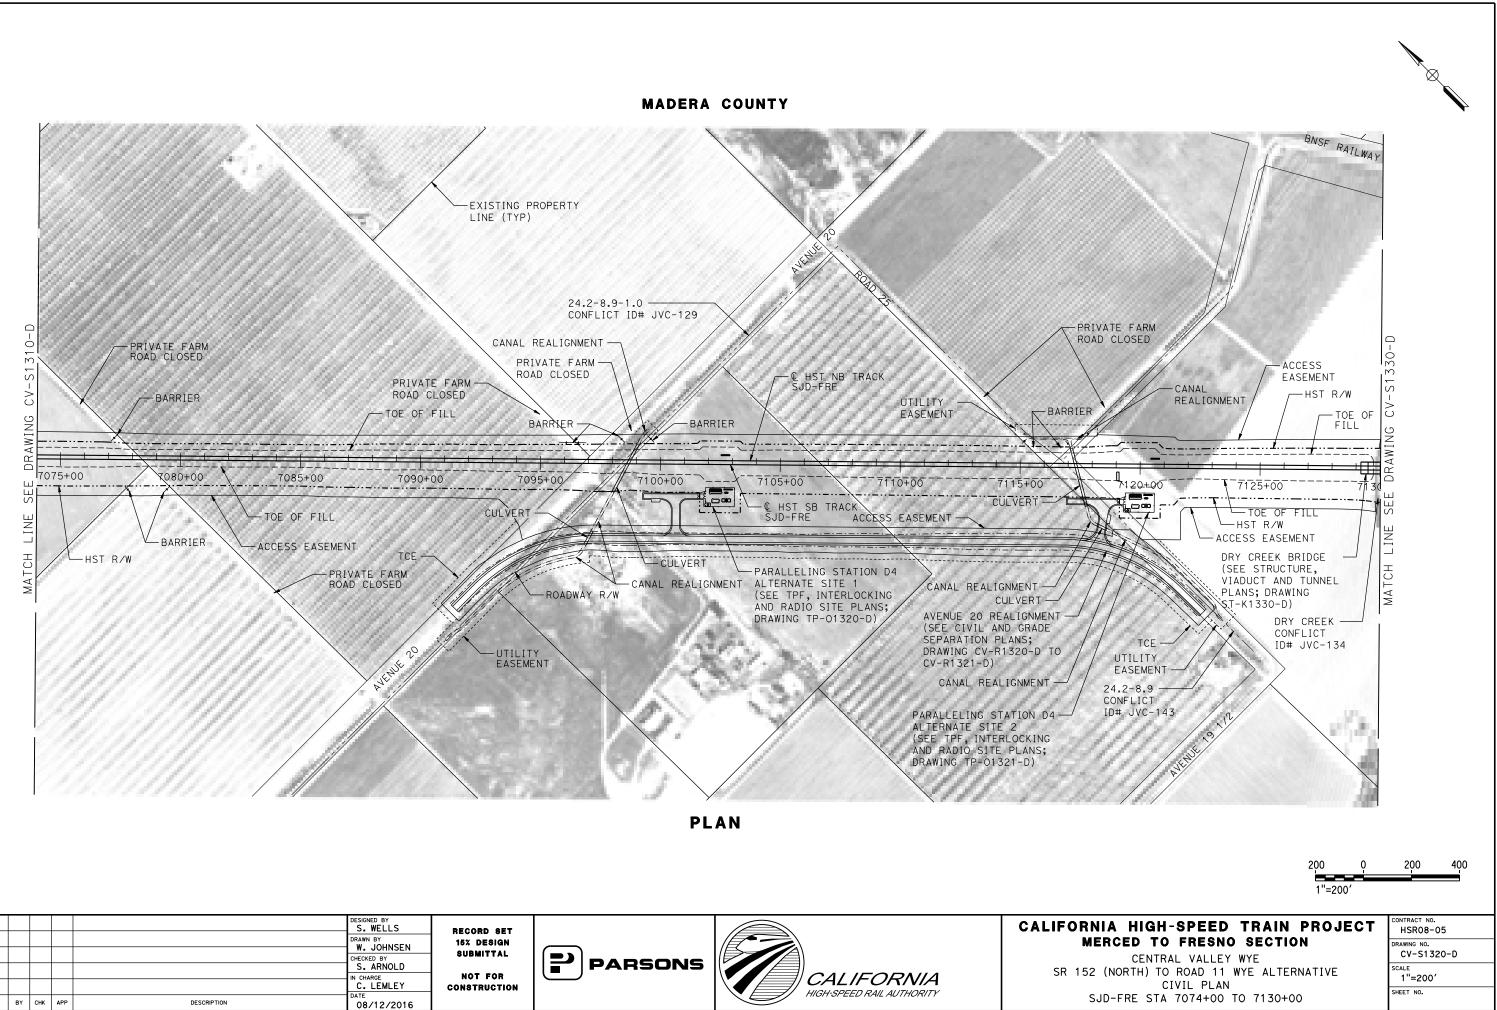
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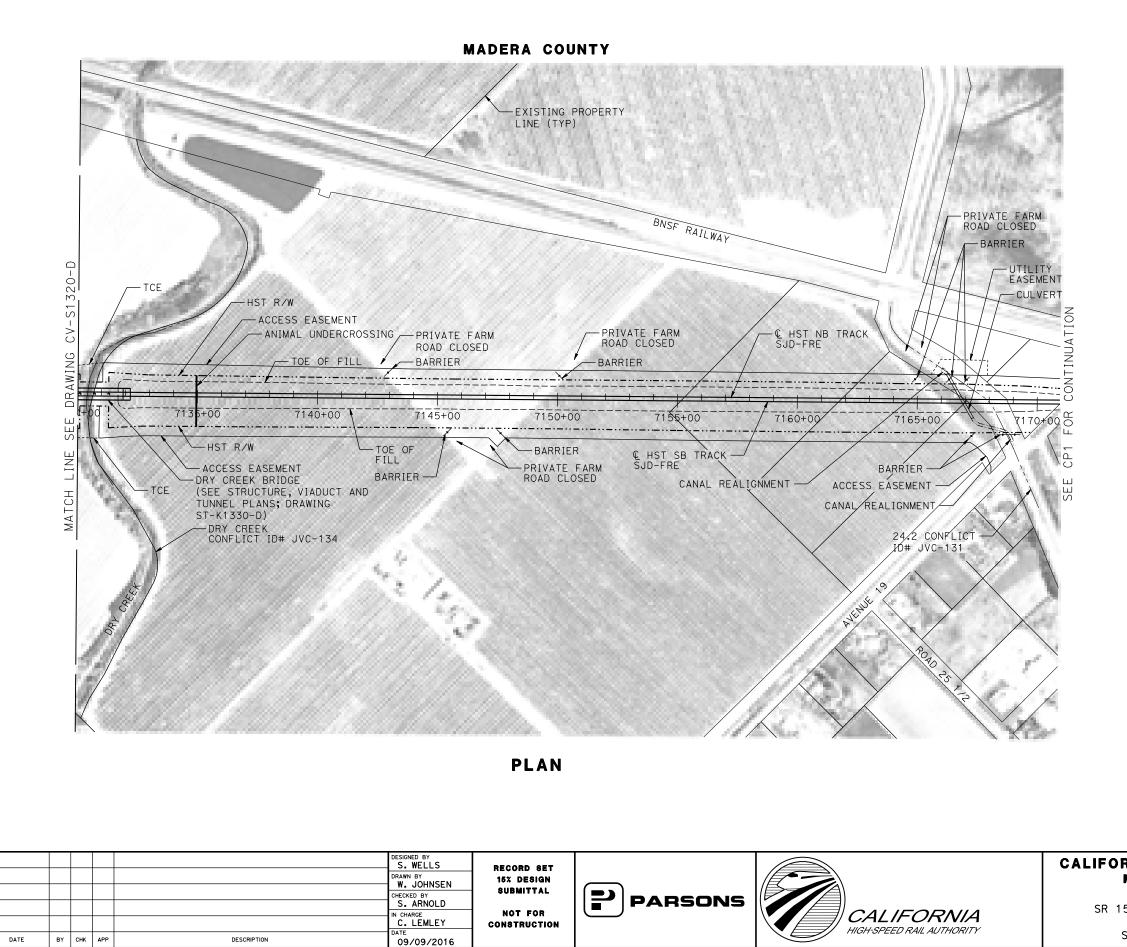


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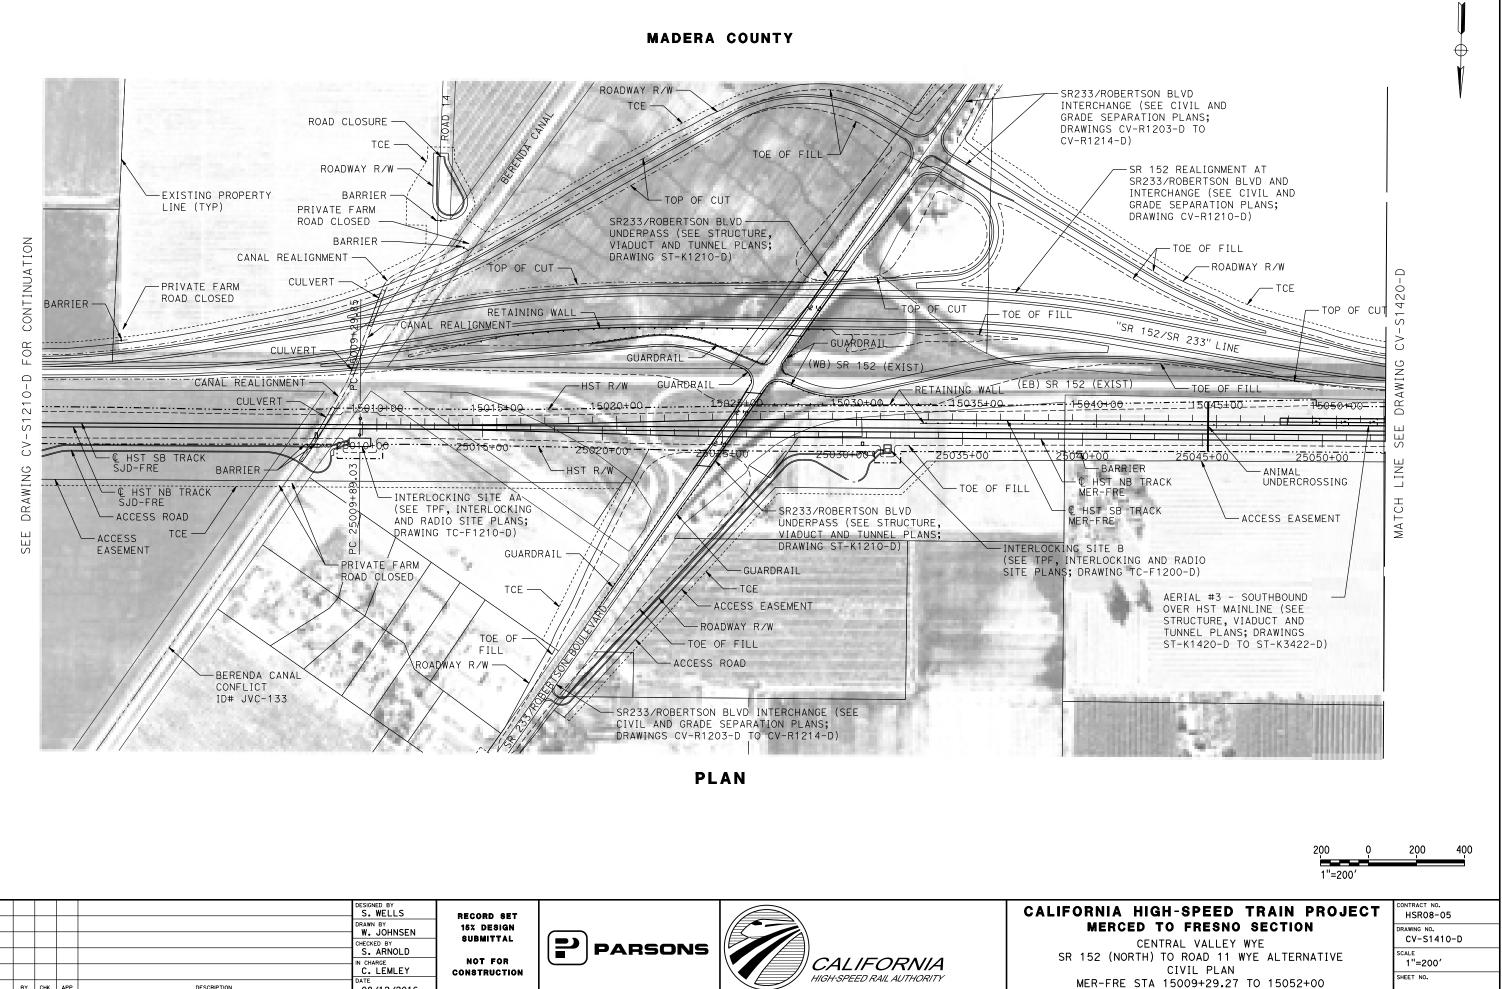
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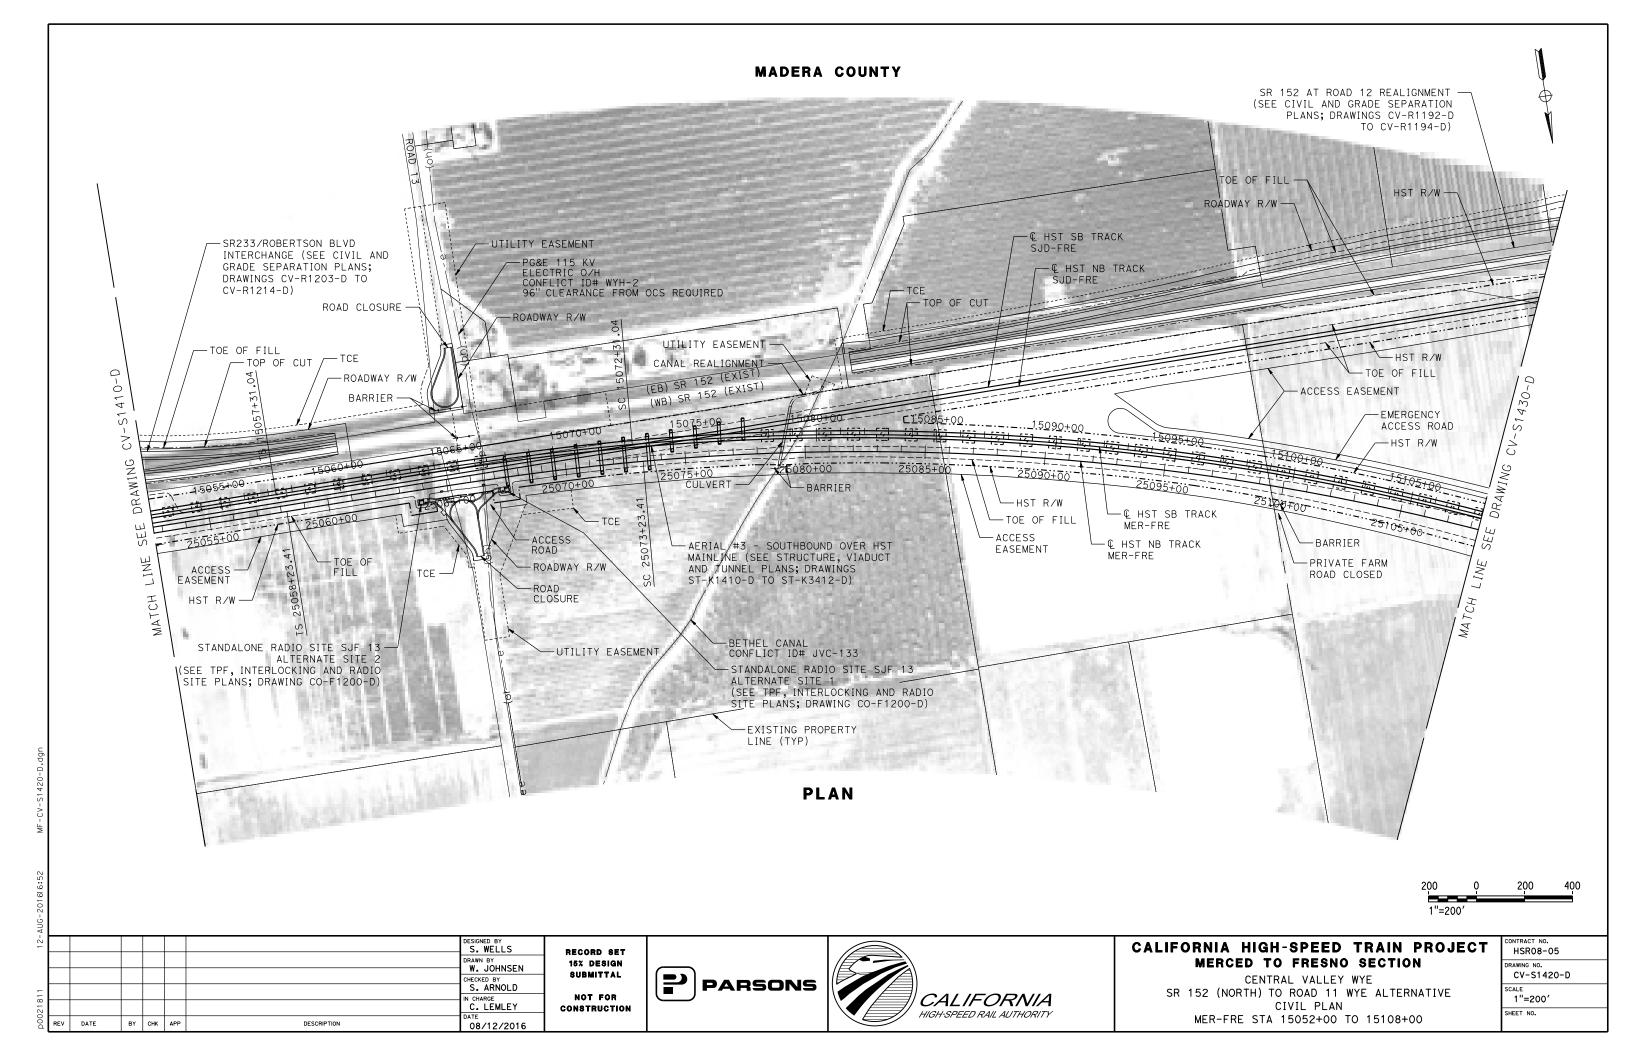
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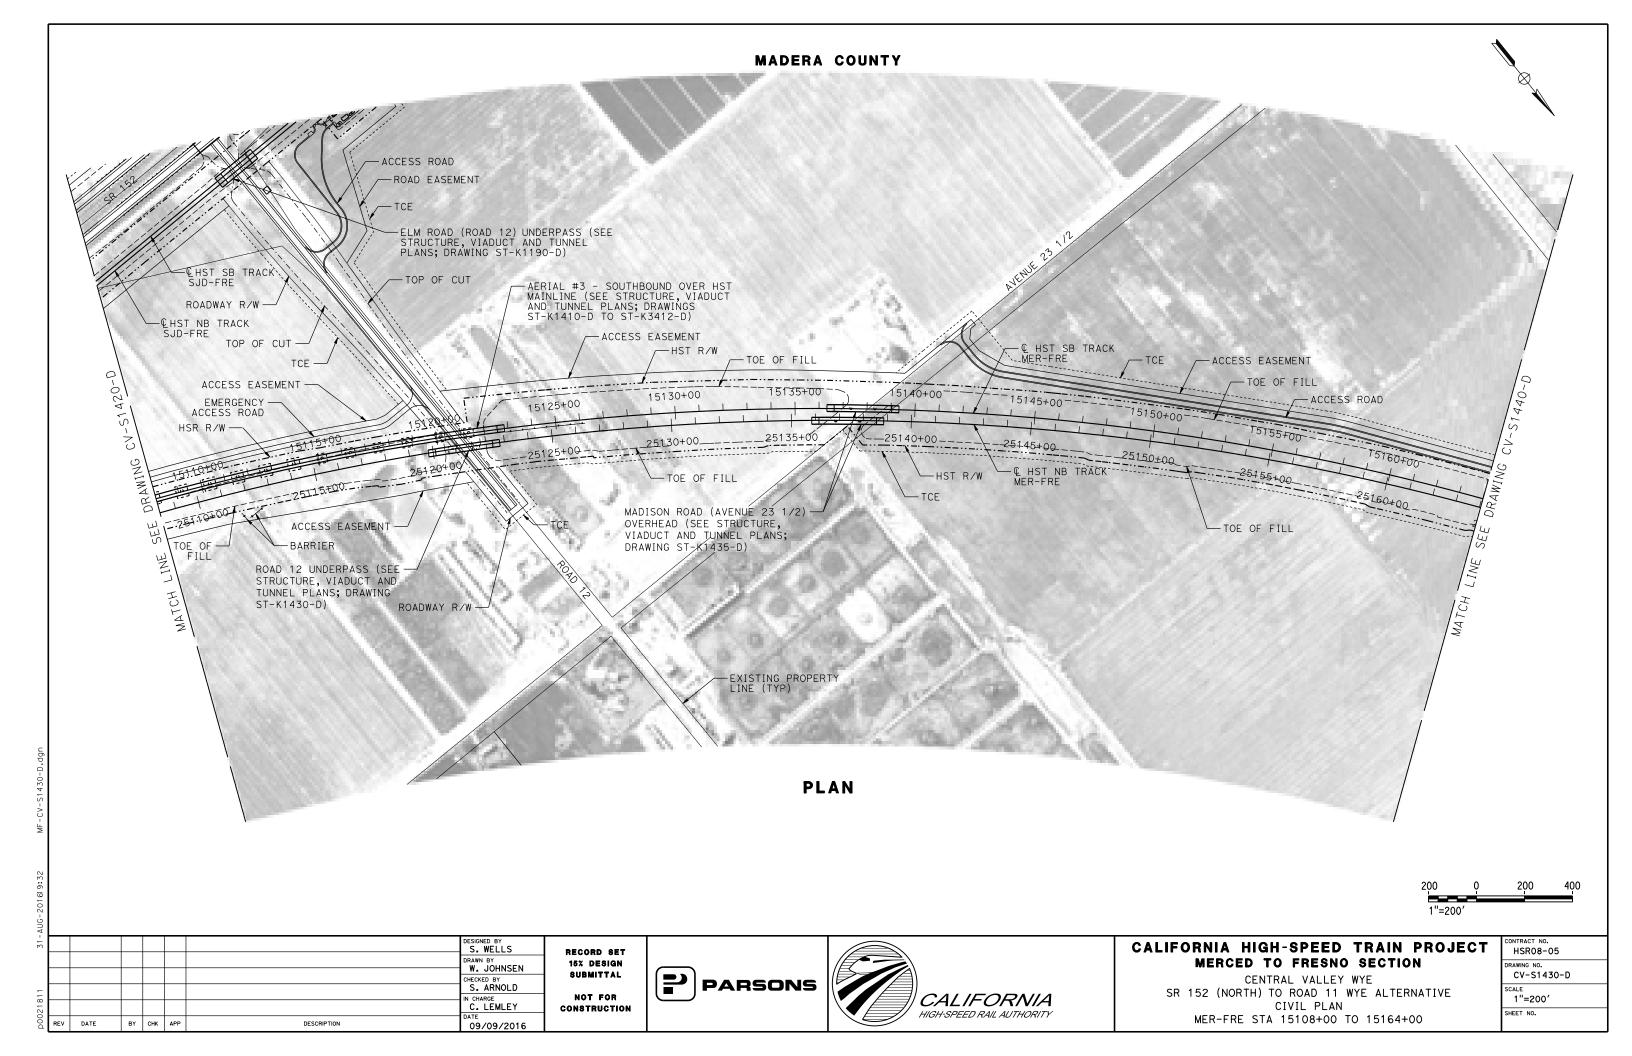
1"=200'	
RNIA HIGH-SPEED TRAIN PROJECT	CONTRACT NO. HSR08-05
MERCED TO FRESNO SECTION CENTRAL VALLEY WYE	DRAWING NO. CV-S1330-D
52 (NORTH) TO ROAD 11 WYE ALTERNATIVE	SCALE 1"=200'
SJD-FRE STA 7130+00 TO 7170+94.51	SHEET NO.

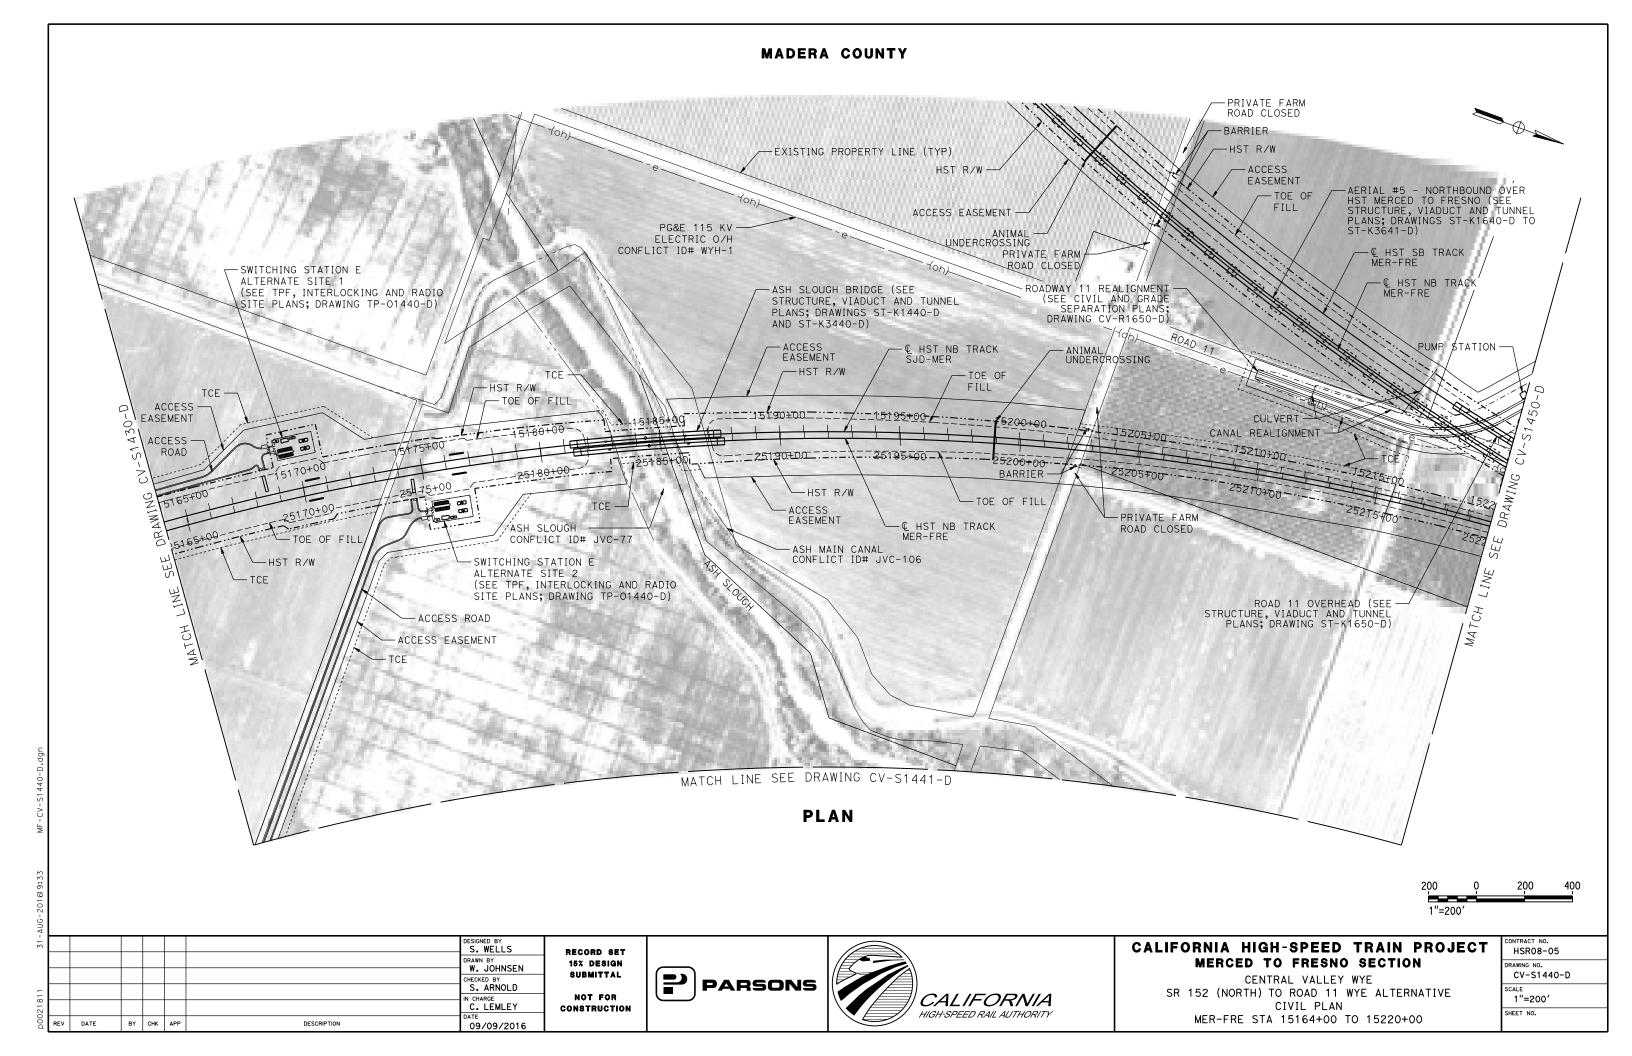


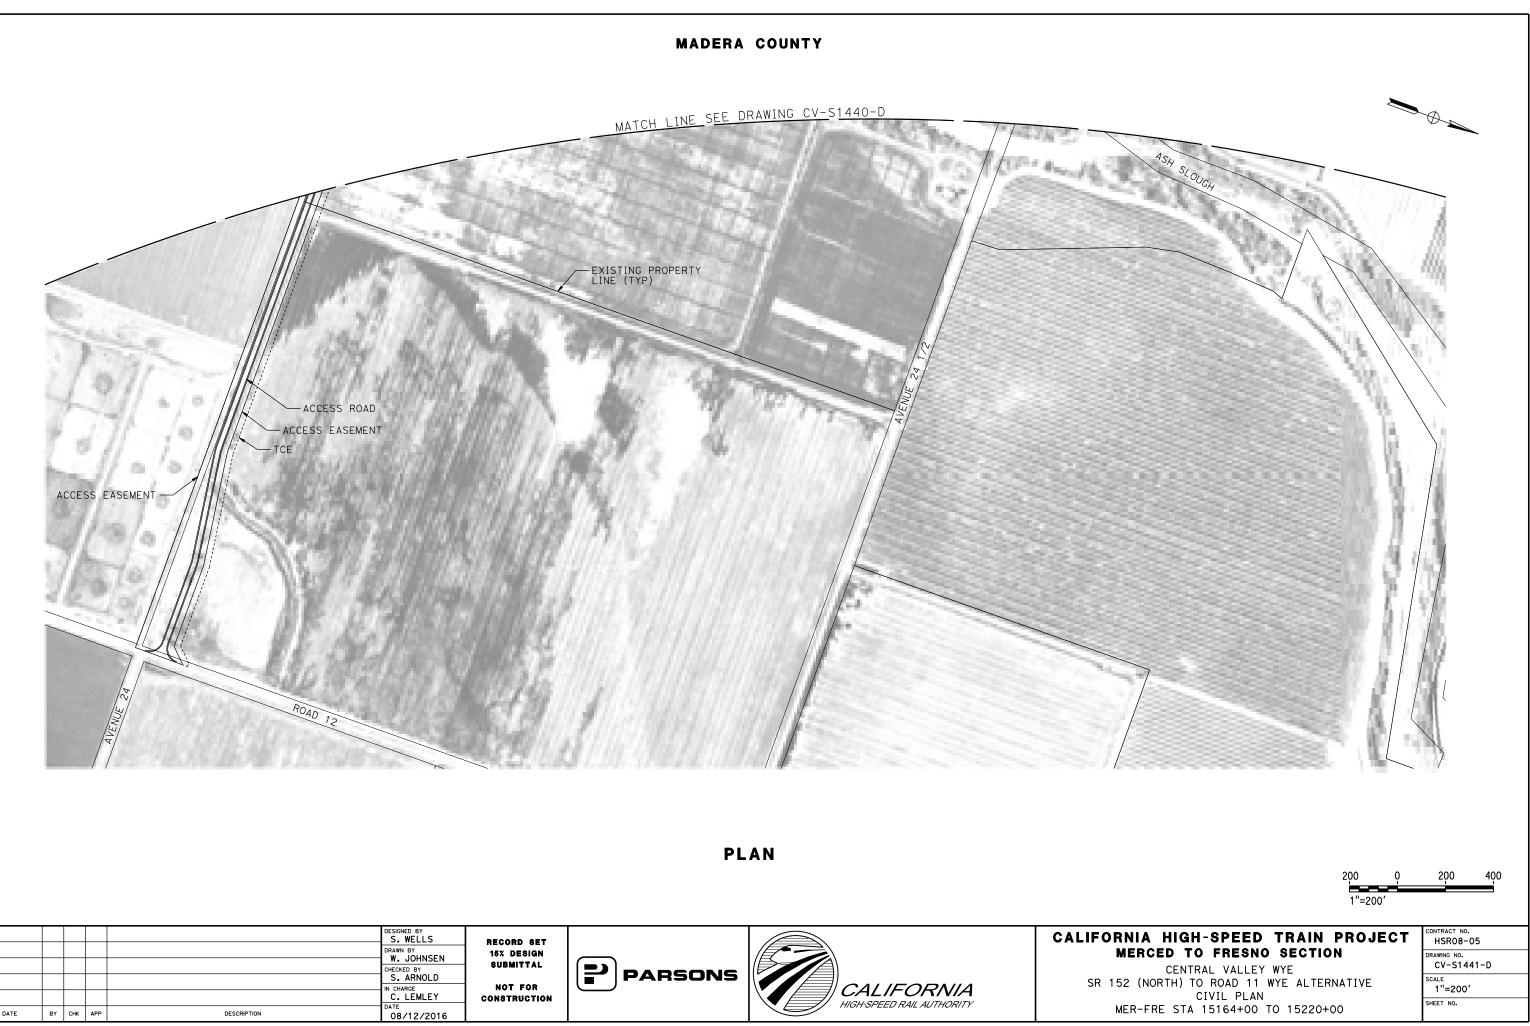


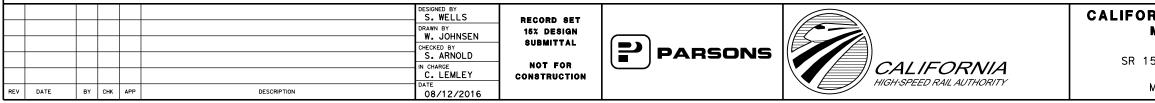
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RE	EV DATE	BY	СНК	APP	IN CHARGE C. LEMLEY DATE 08/12/2016	NOT FOR Construction		CALIFORNIA HIGH-SPEED RAIL AUTHORITY	ME

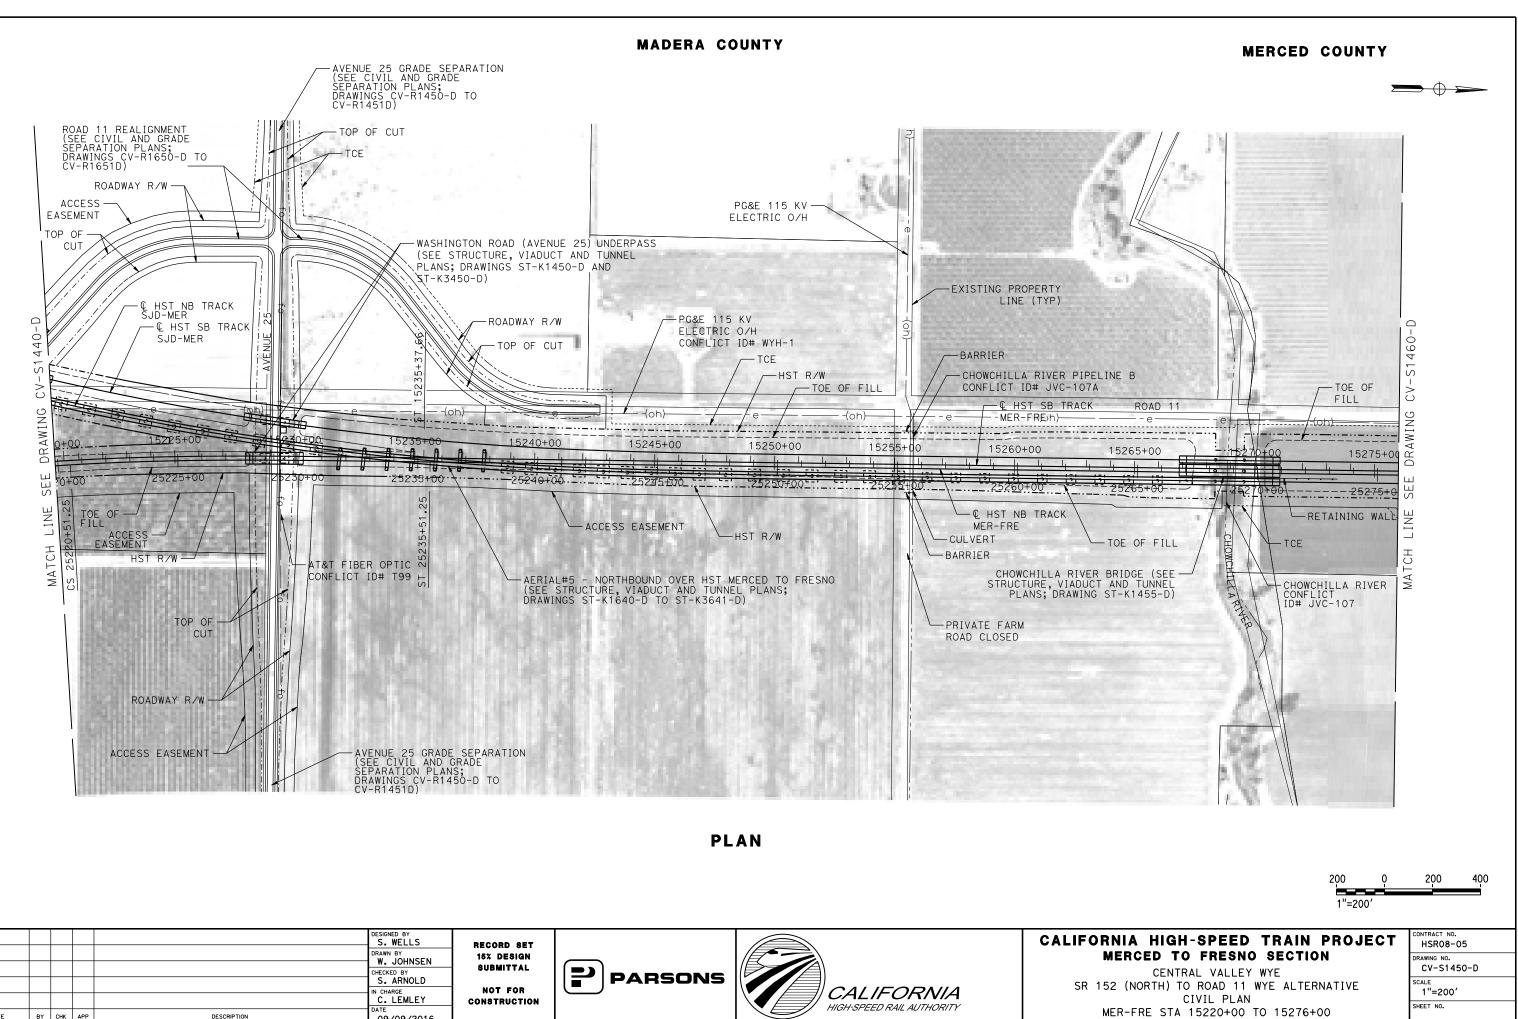




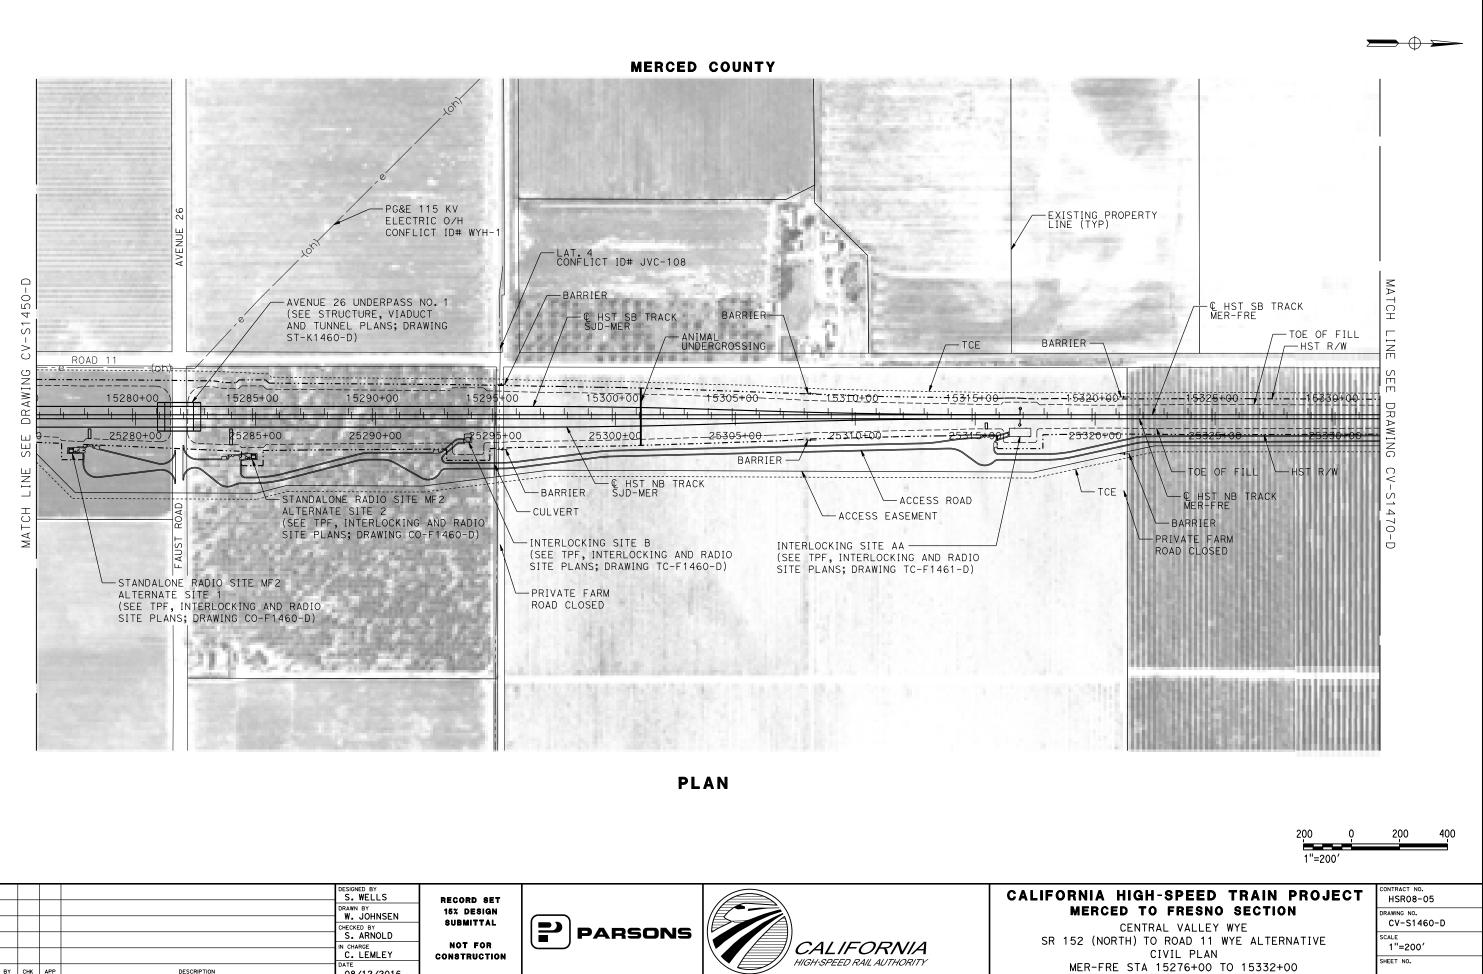


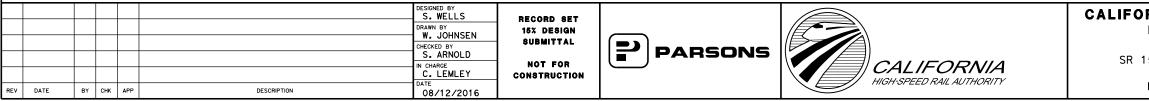


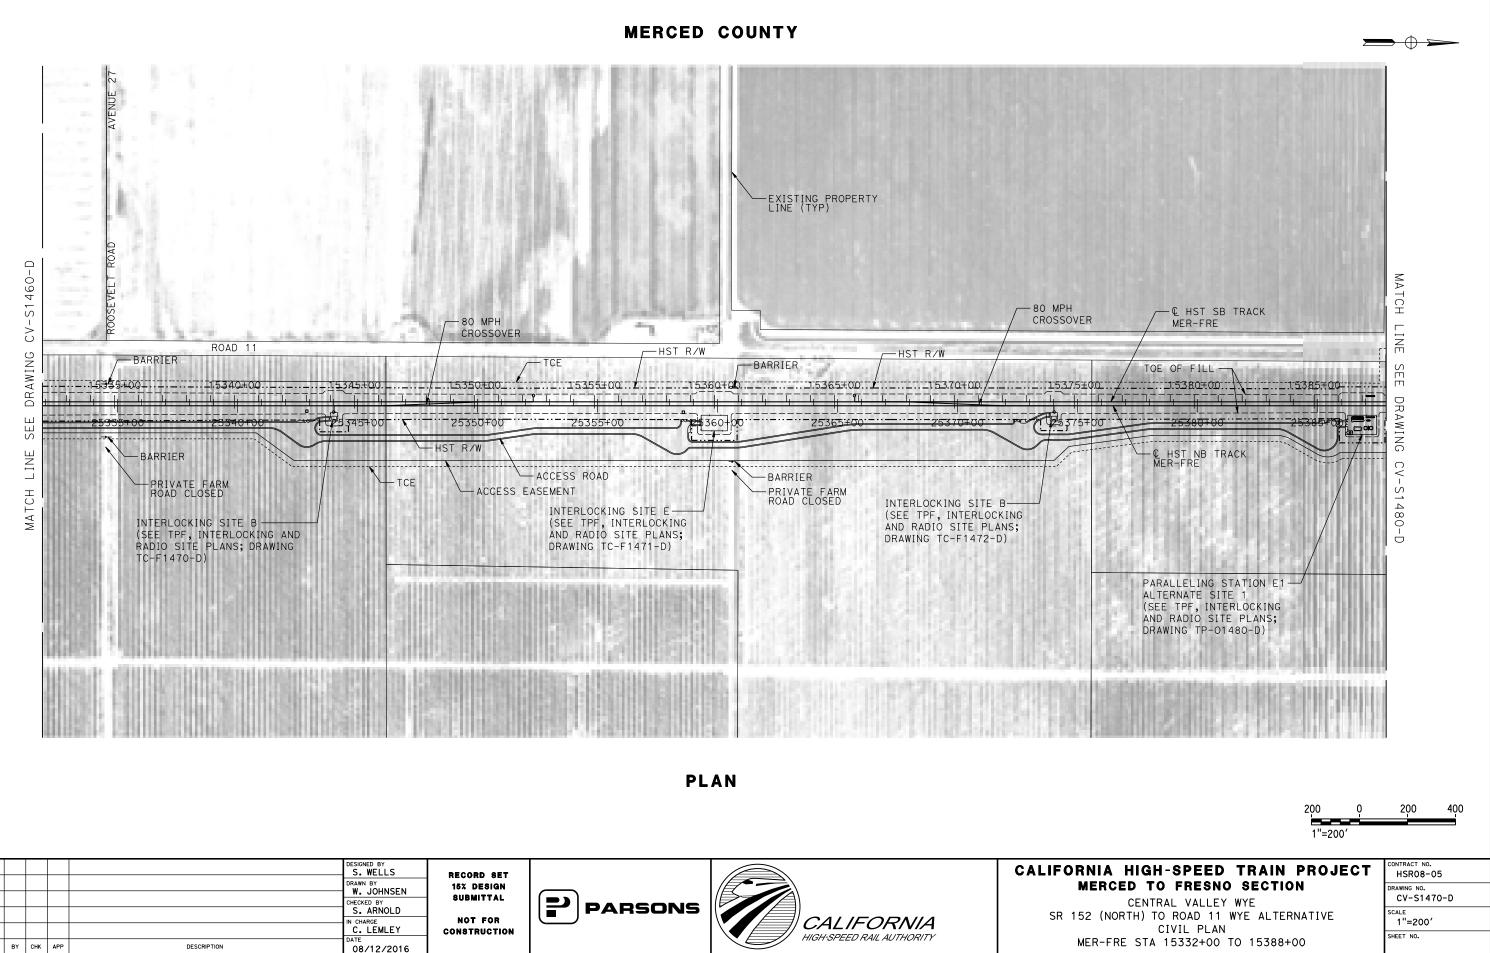




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						S. ARNOLD	NOT FOR Construction	PARSONS	CALIFORNIA	SR 15
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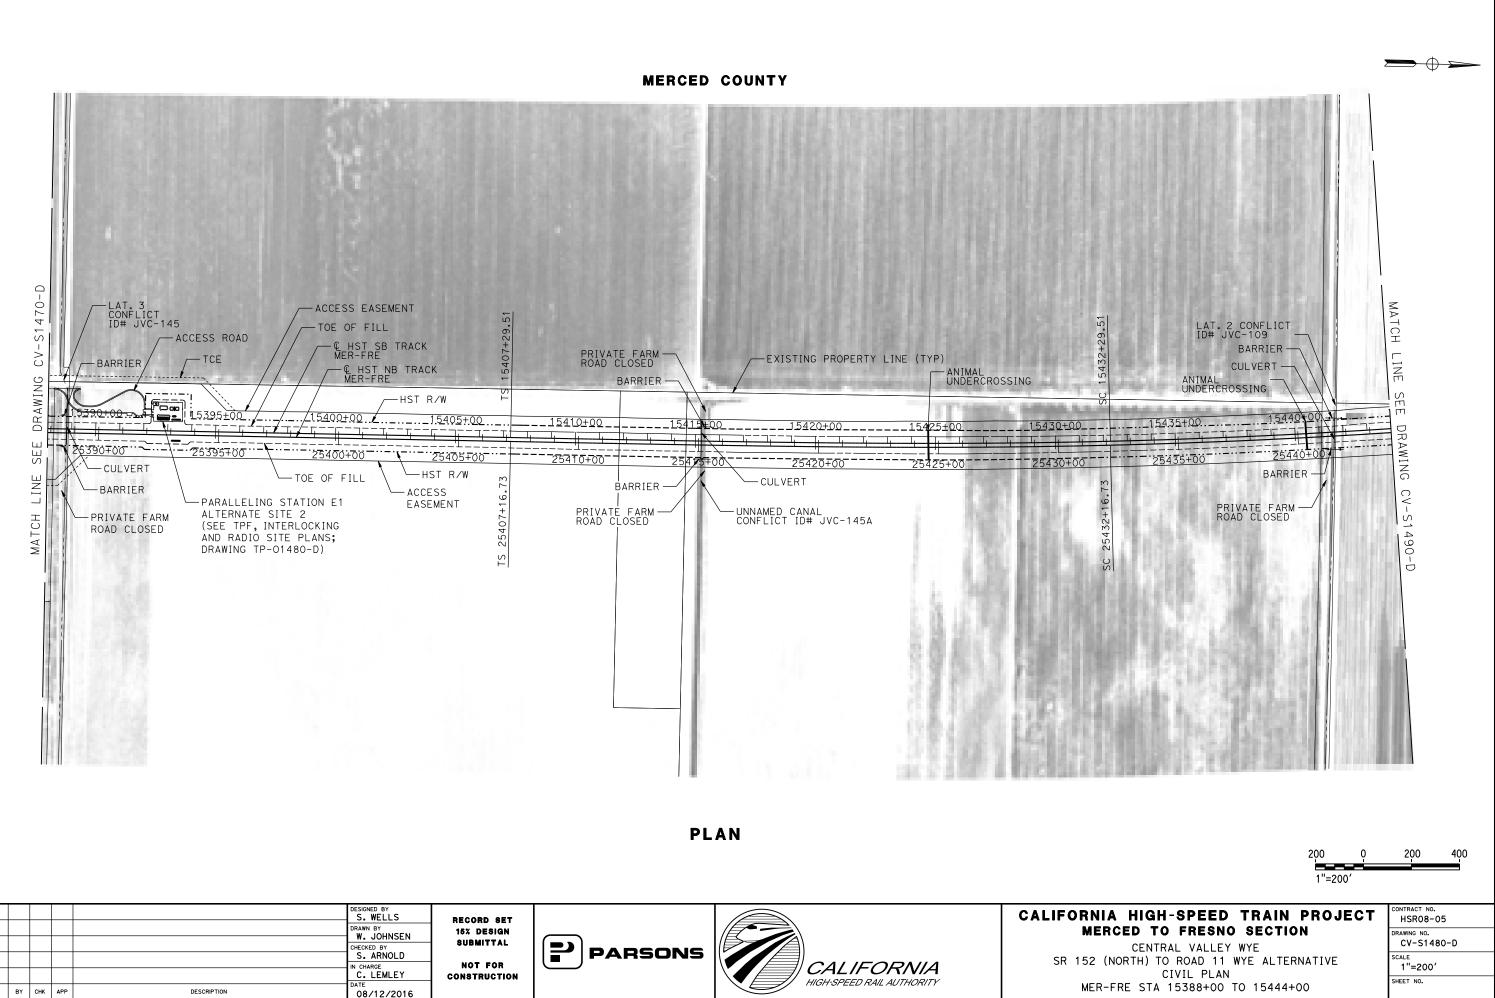




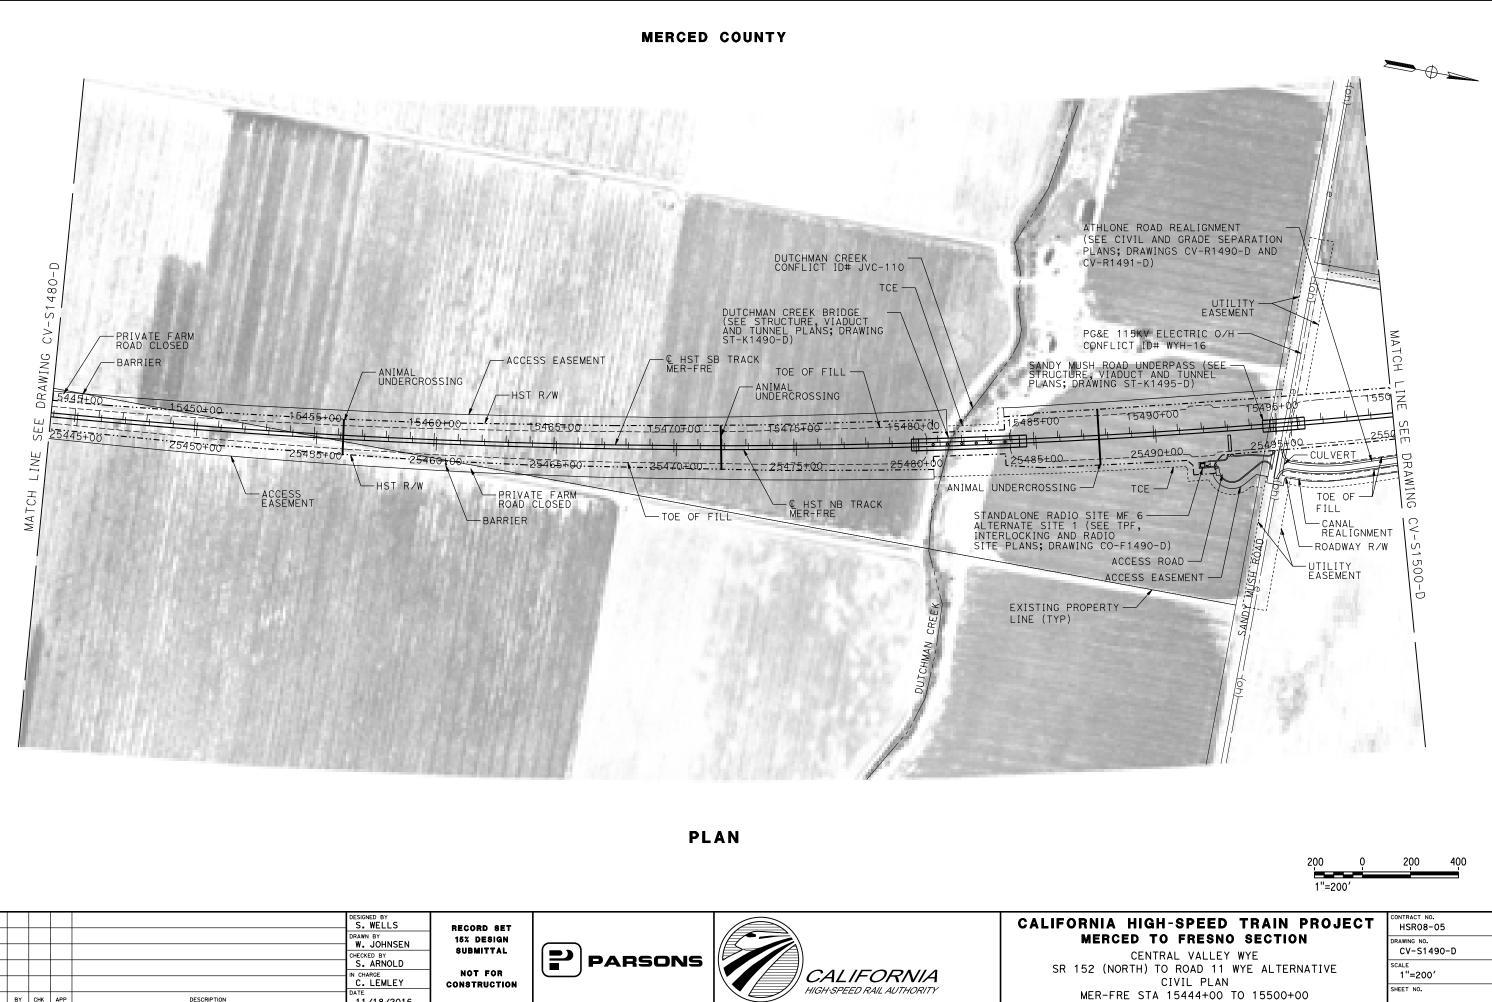


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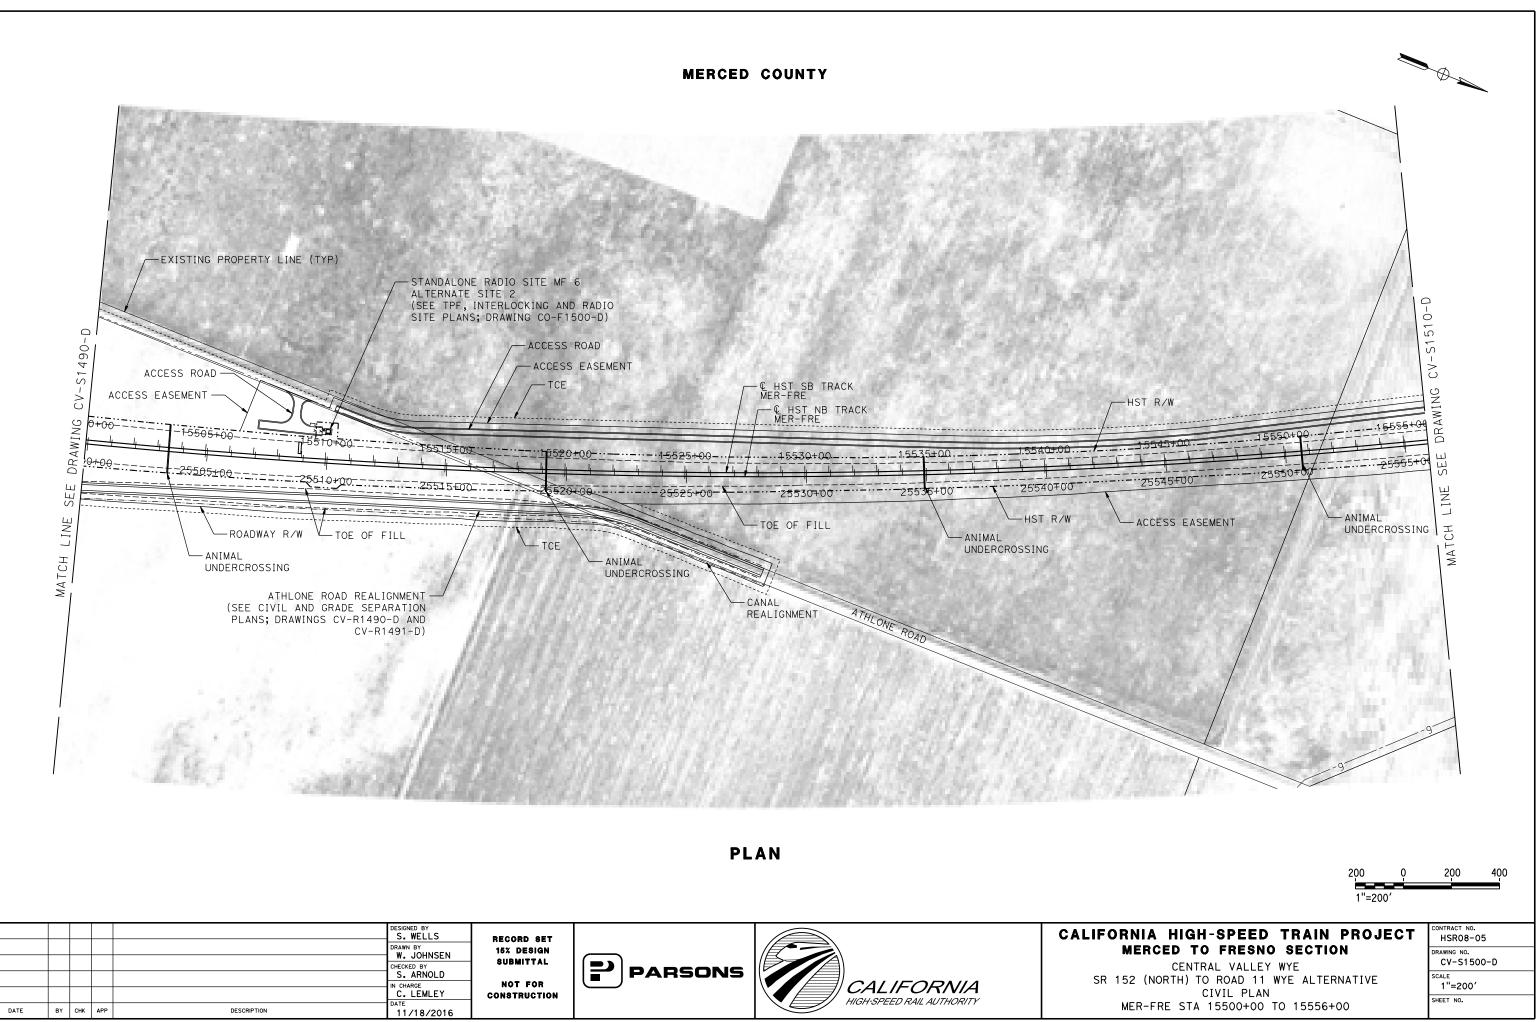
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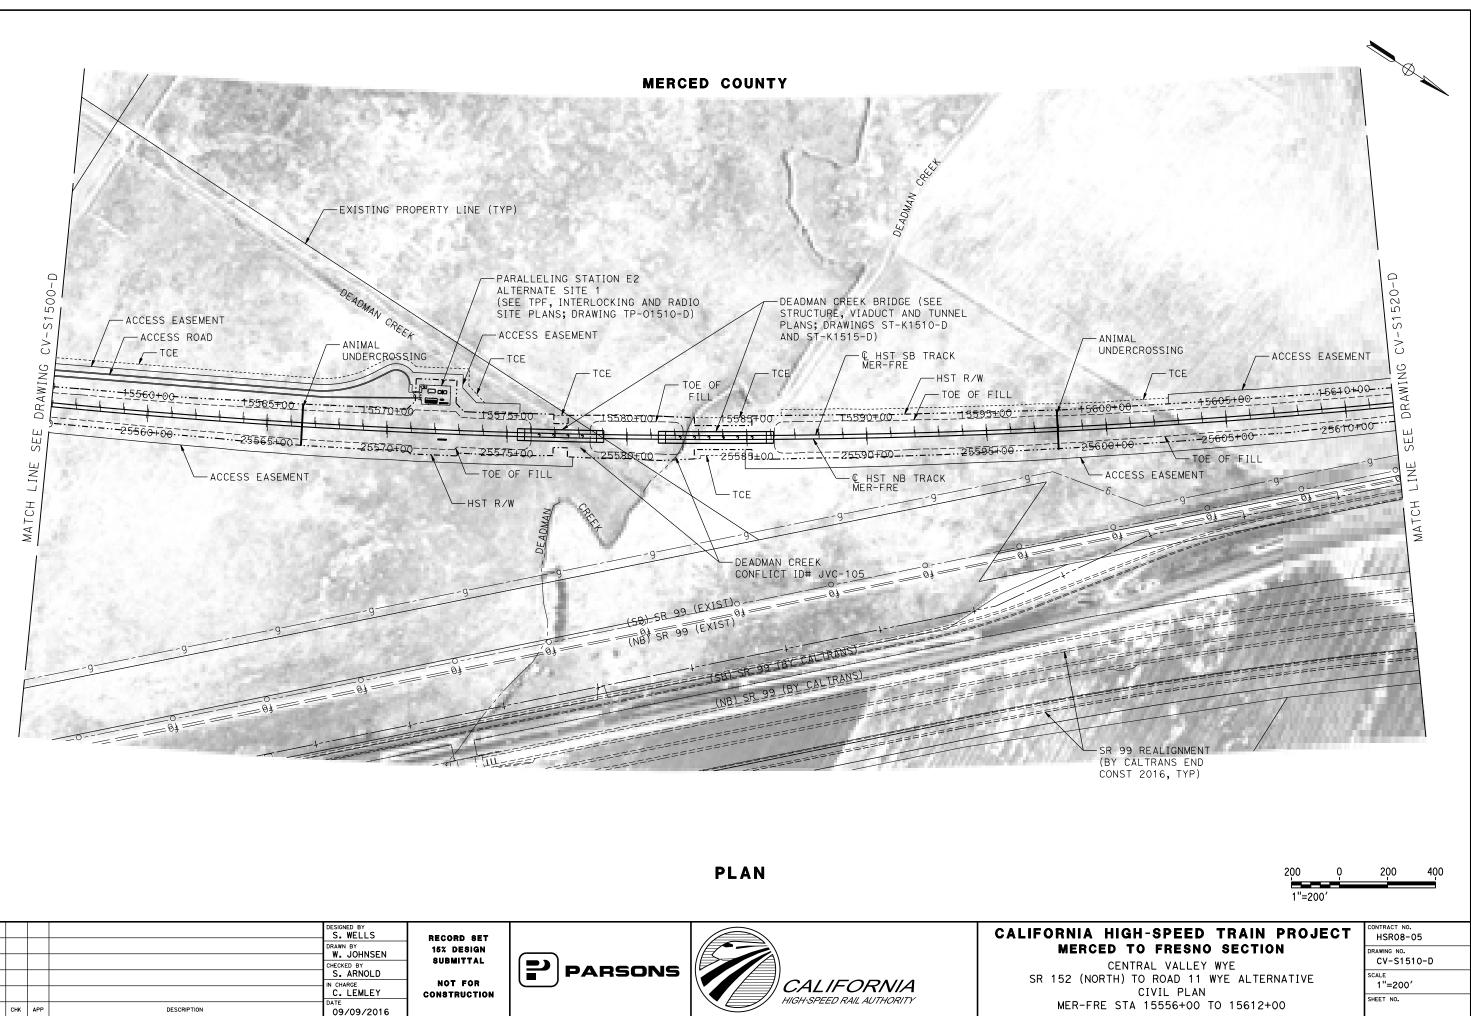
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REV	DATE	BY	СНК	. AP	PP	DESCRIPTION	CHECKED BY S. ARNOLD IN CHARGE C. LEMLEY DATE 08/12/2016	SUBMITTAL NOT FOR Construction	PARSONS	CALIFORNIA HIGH-SPEED RAIL AUTHORITY	SR 152 MEF



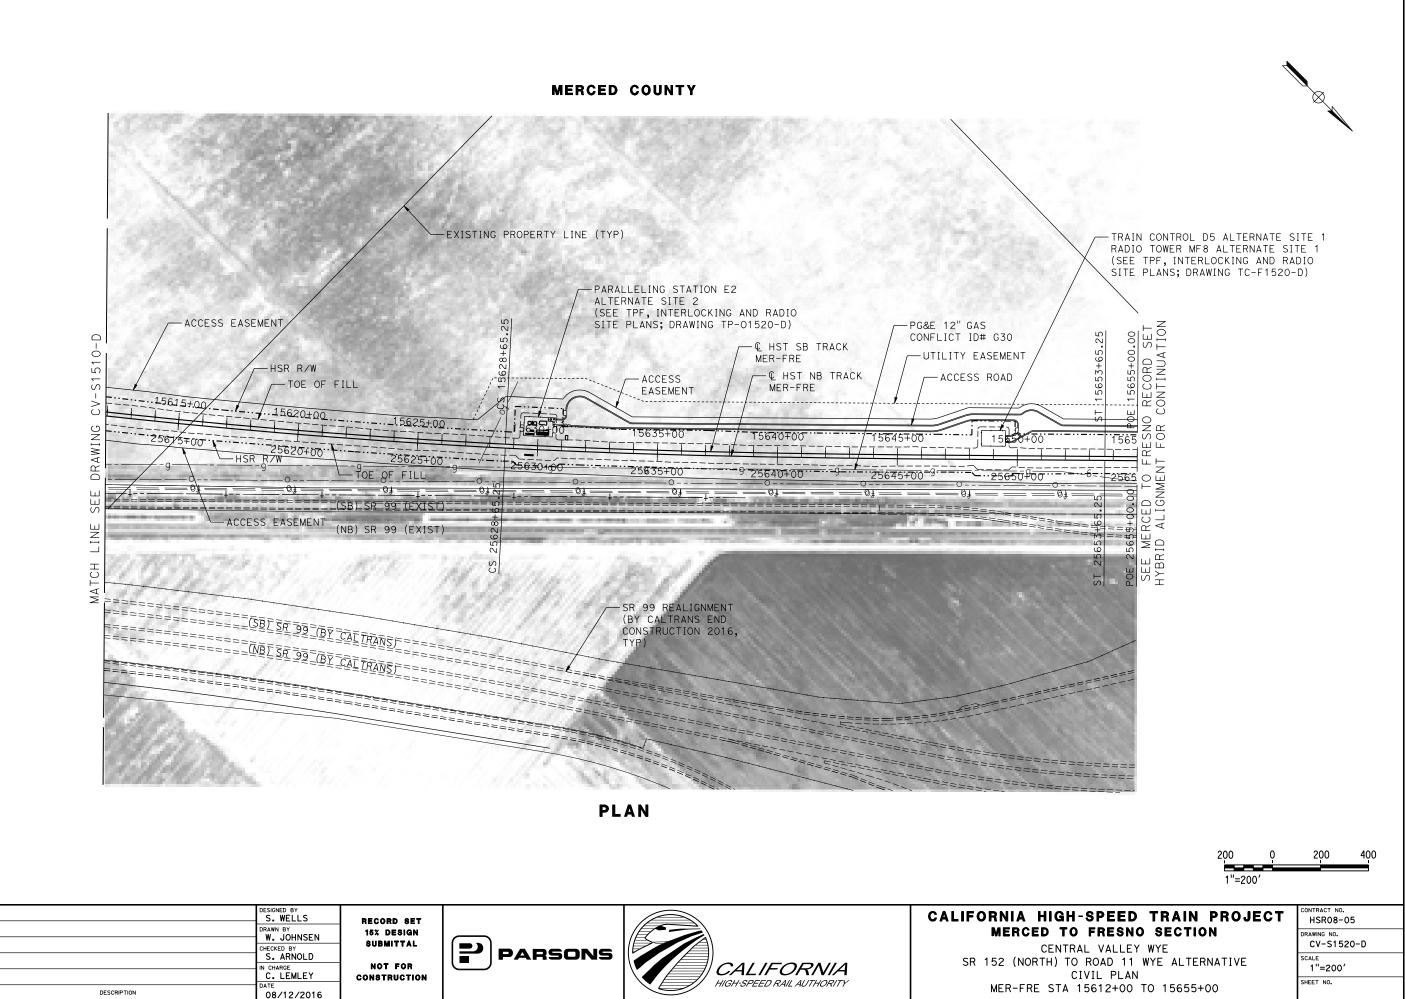
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				-	CHECKED BY S. ARNOLD IN CHARGE C. LEMLEY	NOT FOR Construction	PARSONS	CALIFORNIA	SR 15
F	EV DATE	вү снк	APP	DESCRIPTION	DATE 11/18/2016			HIGH-SPEED RAIL AUTHORITY	M



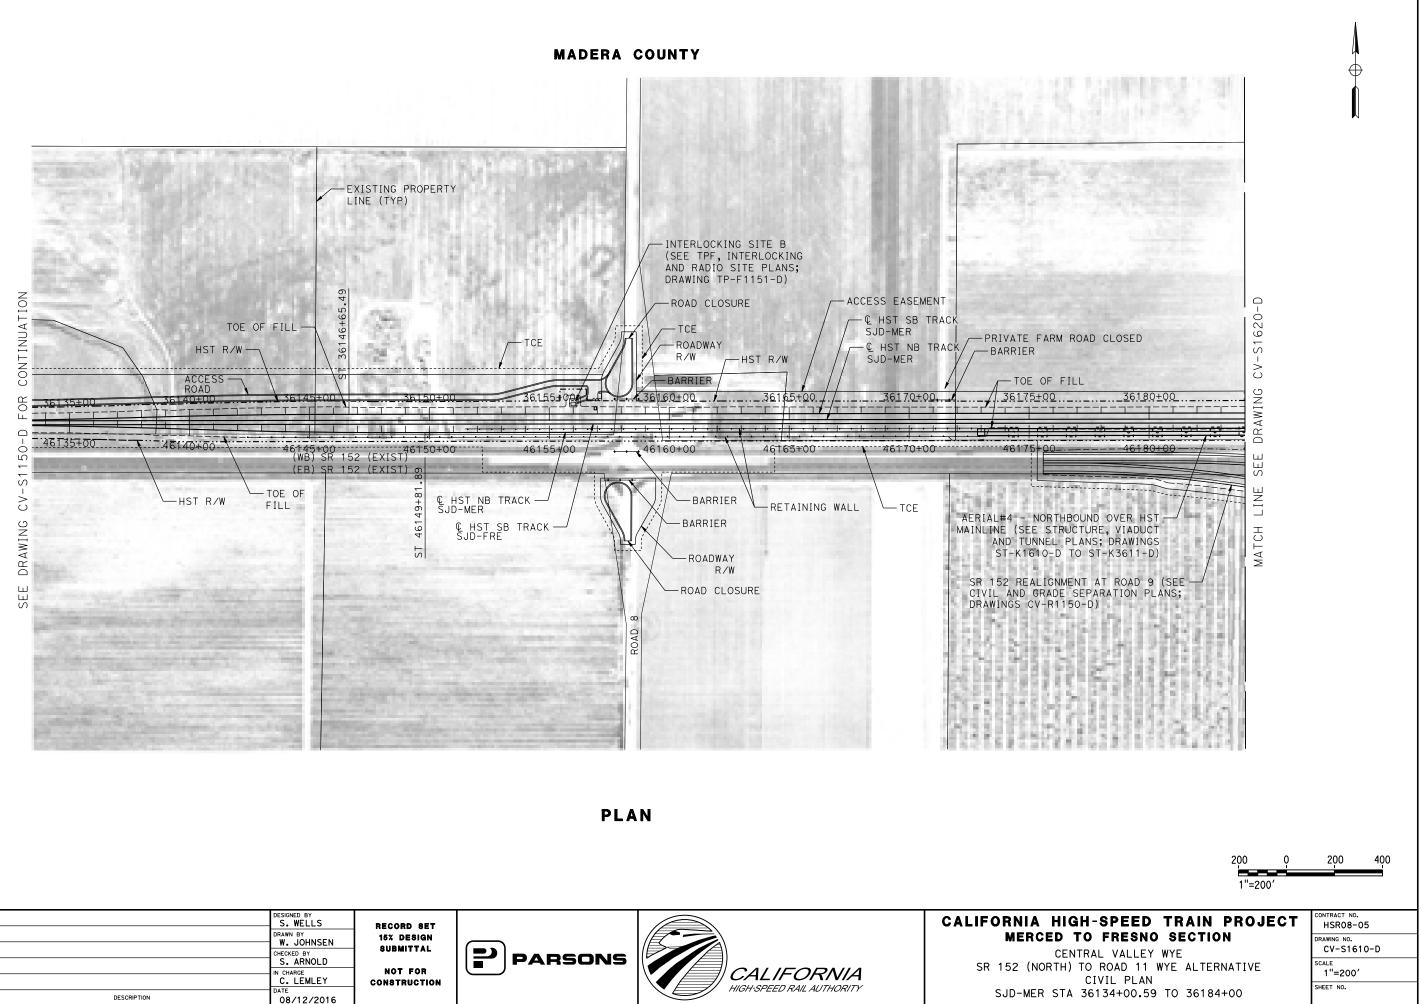
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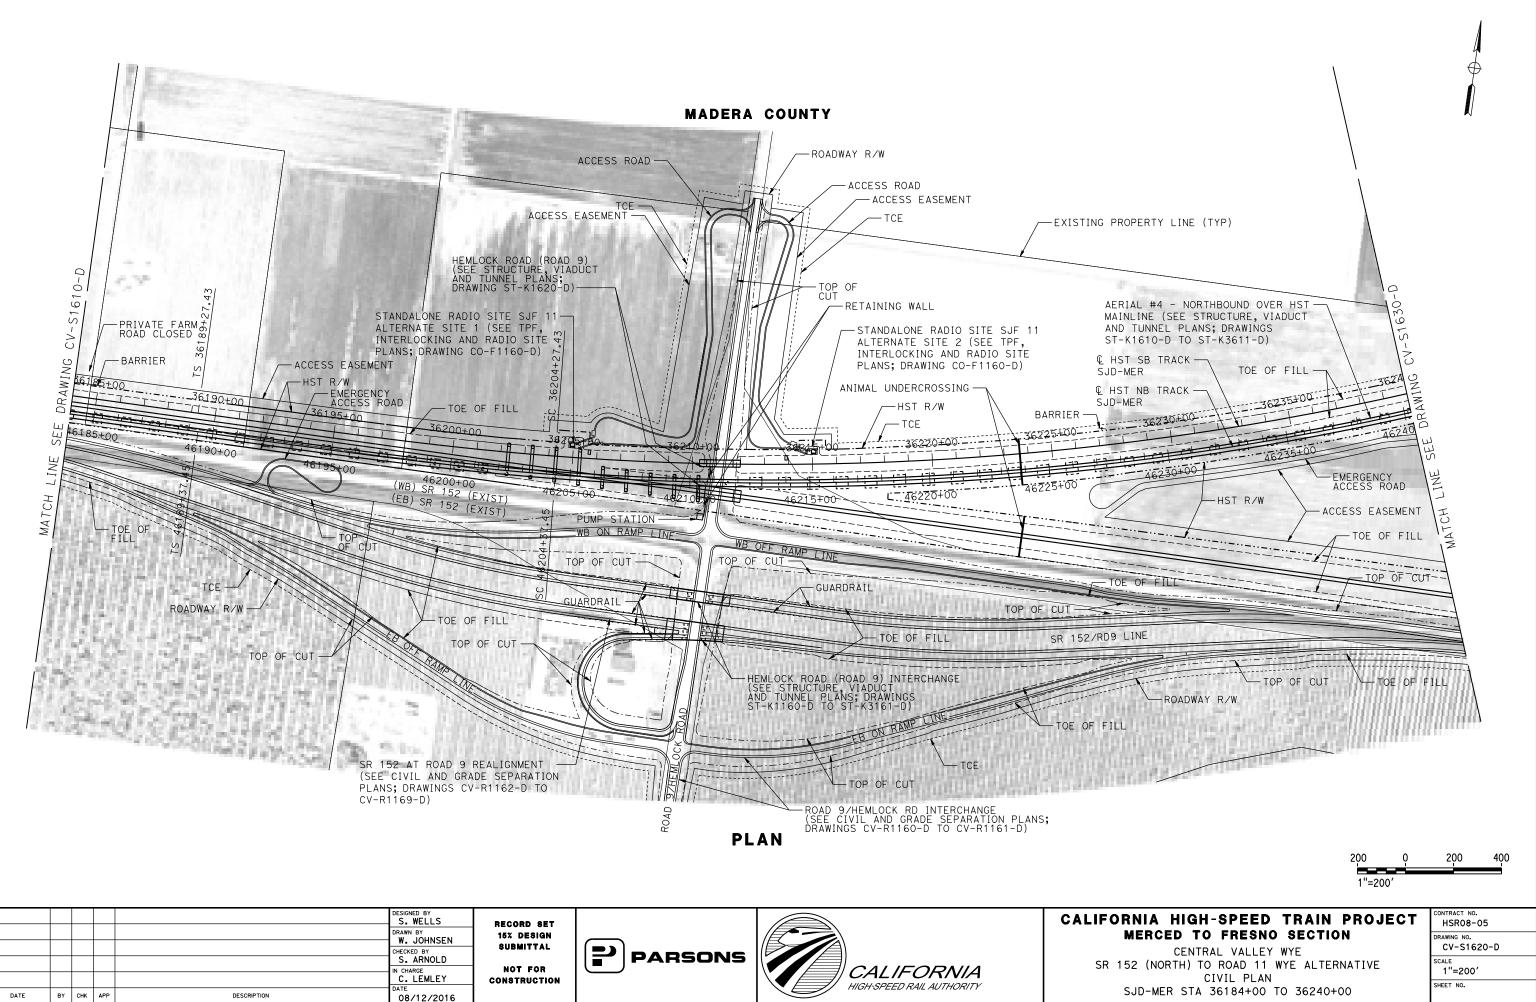


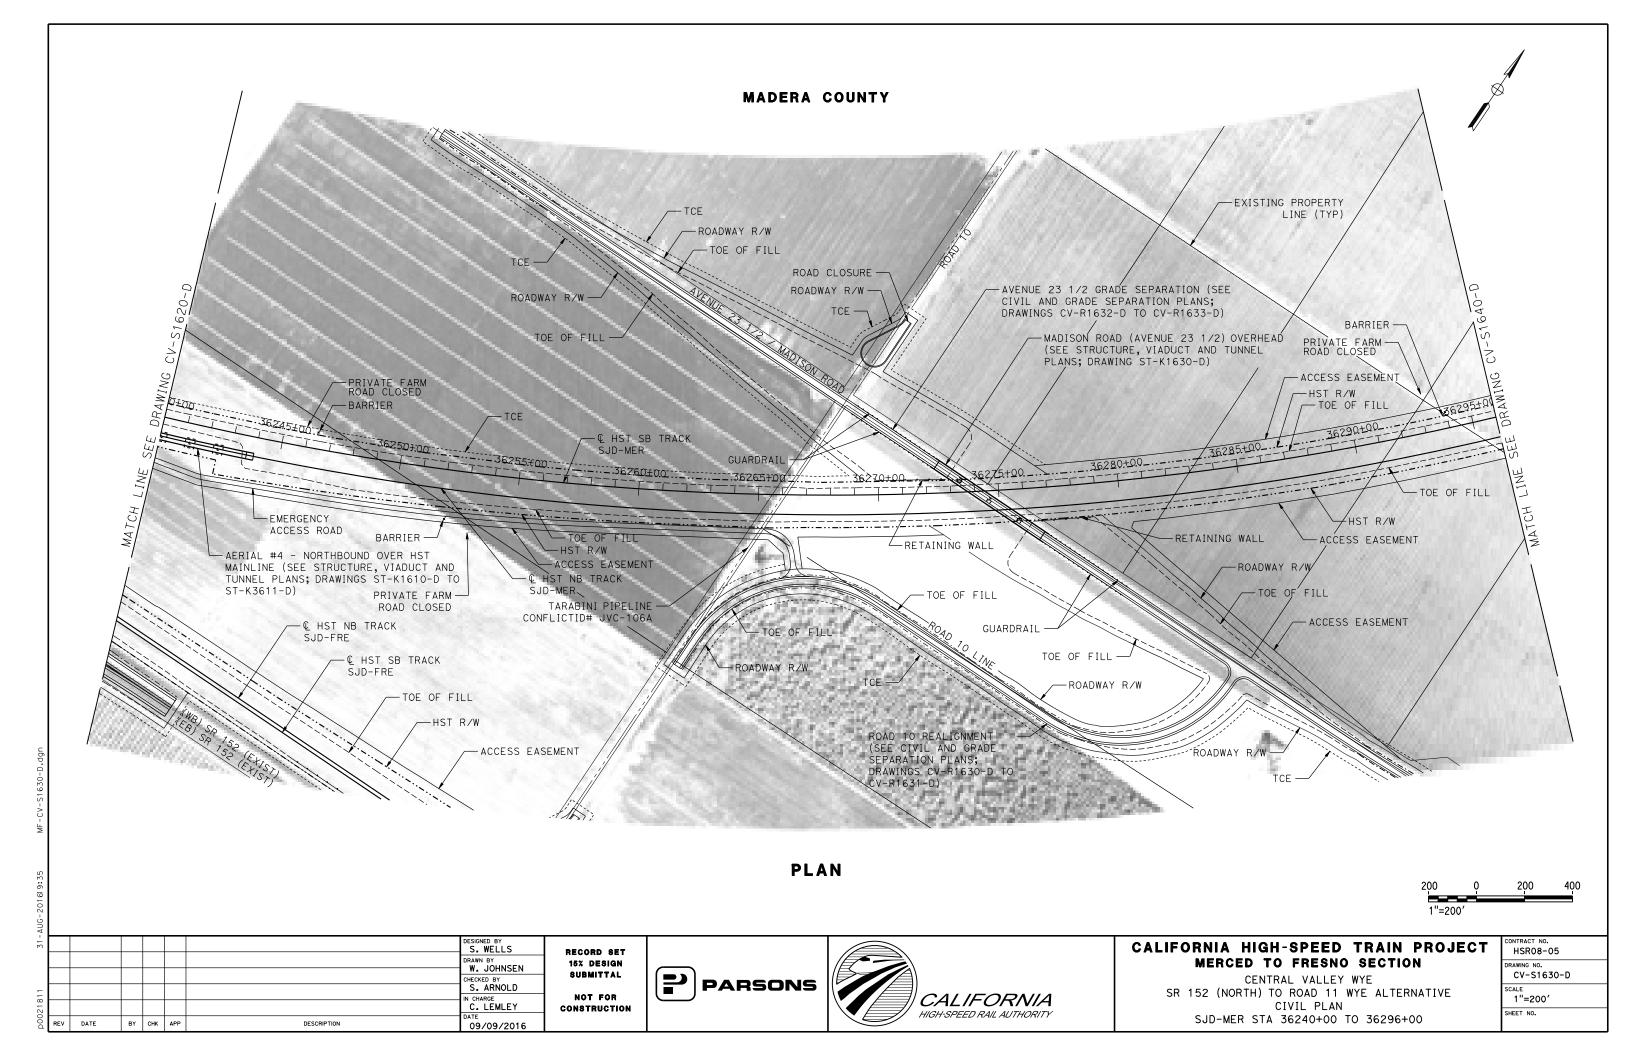
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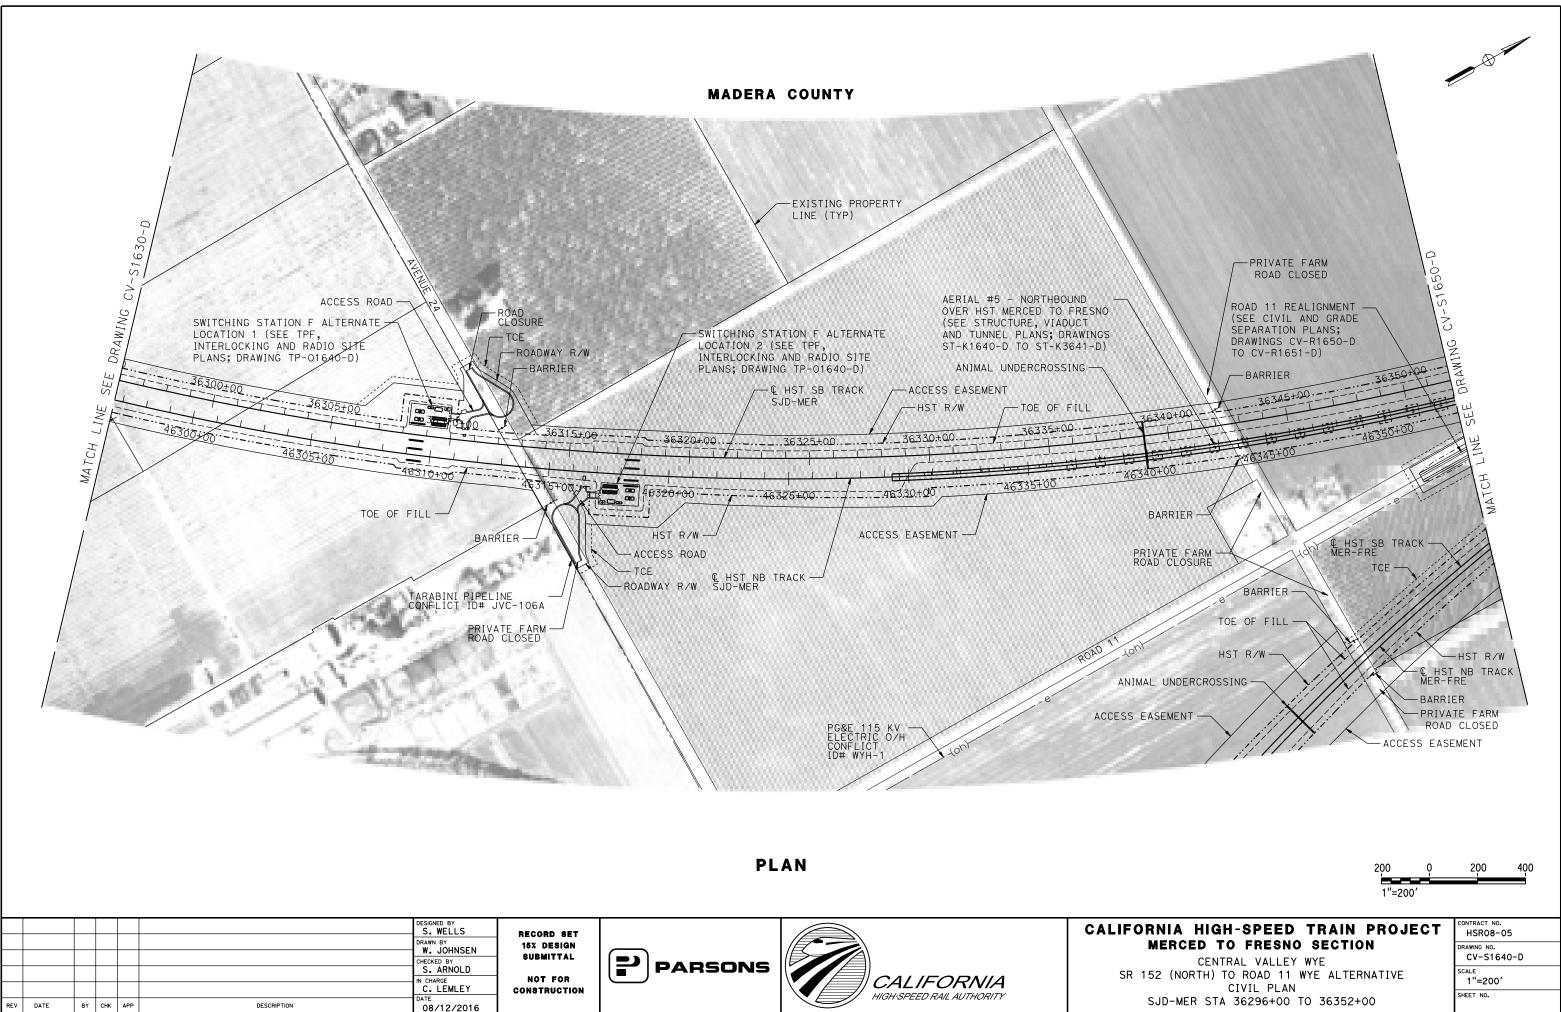


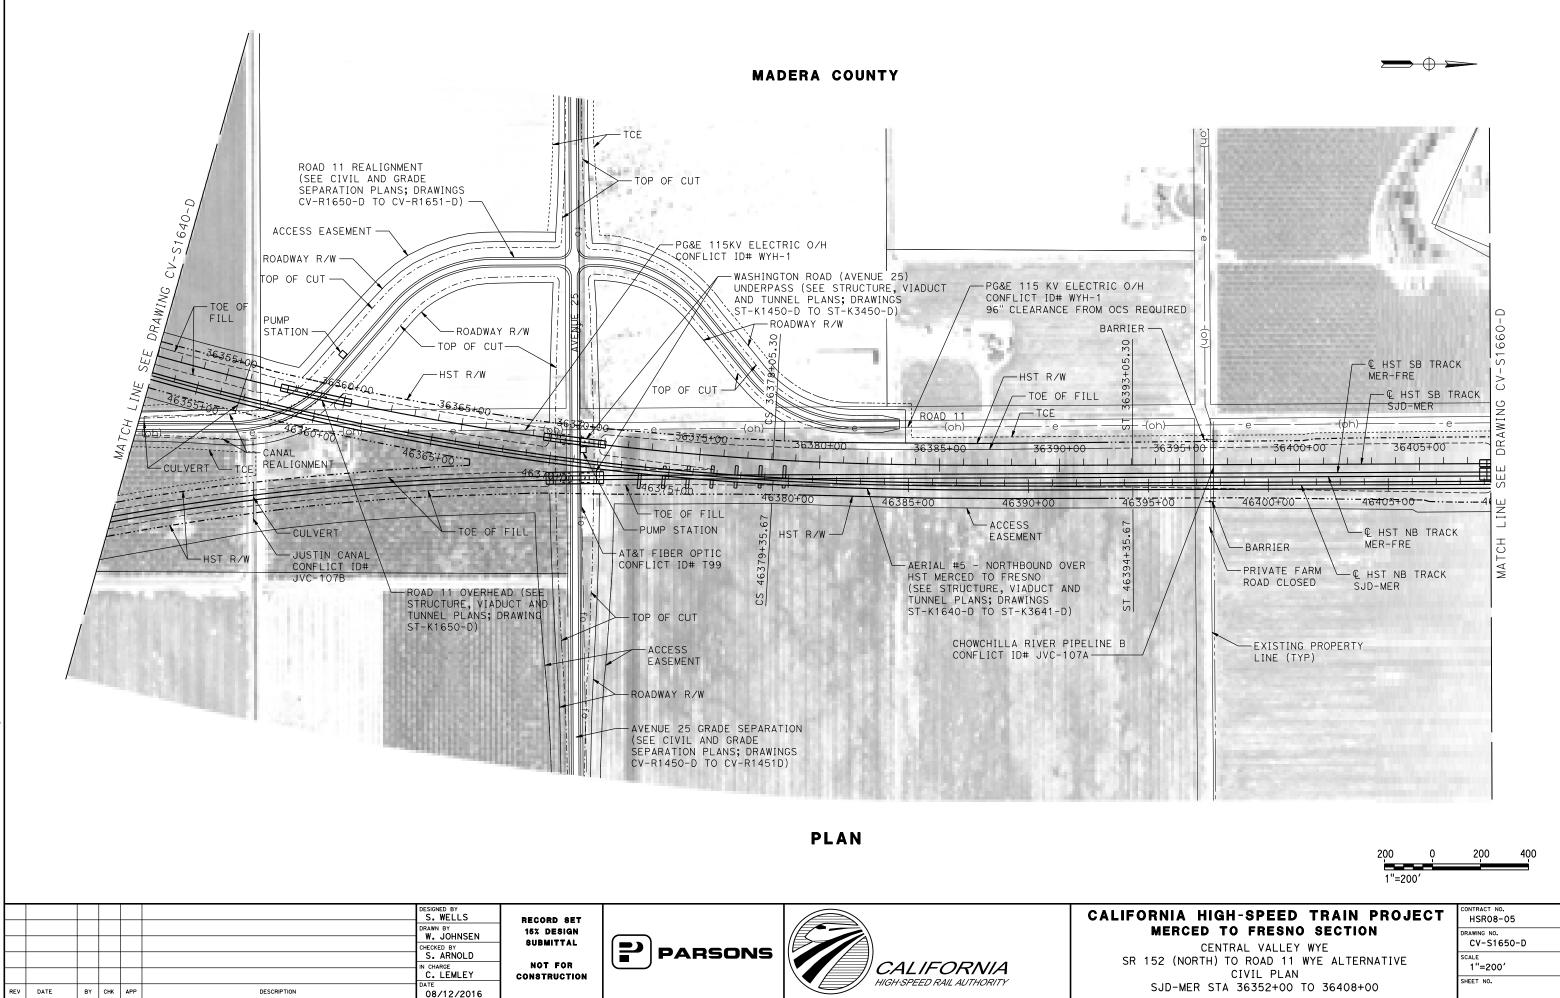


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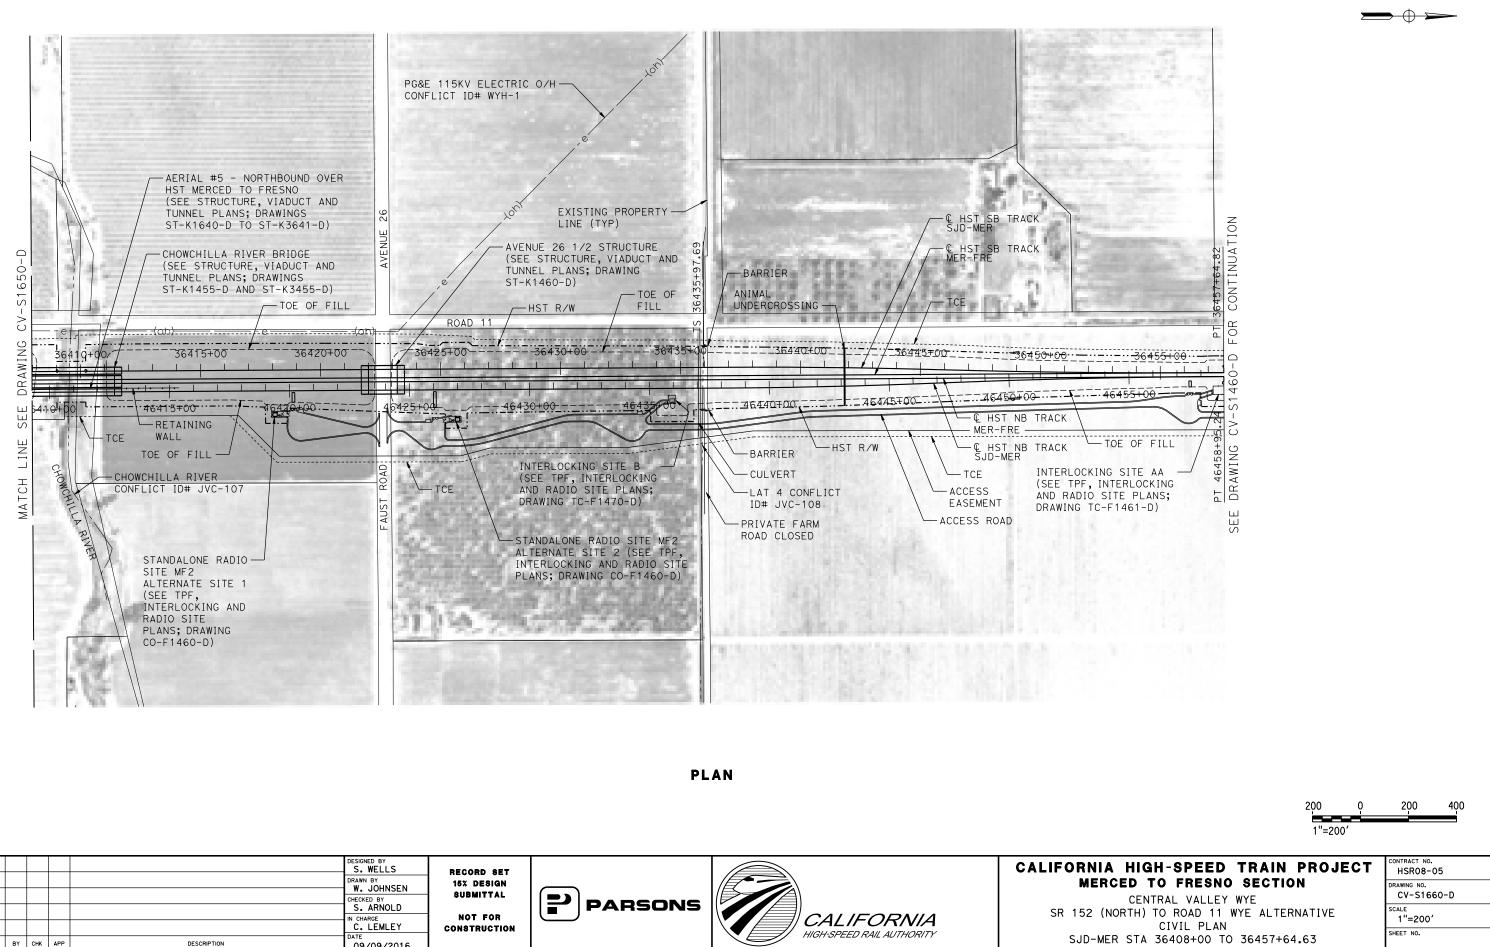




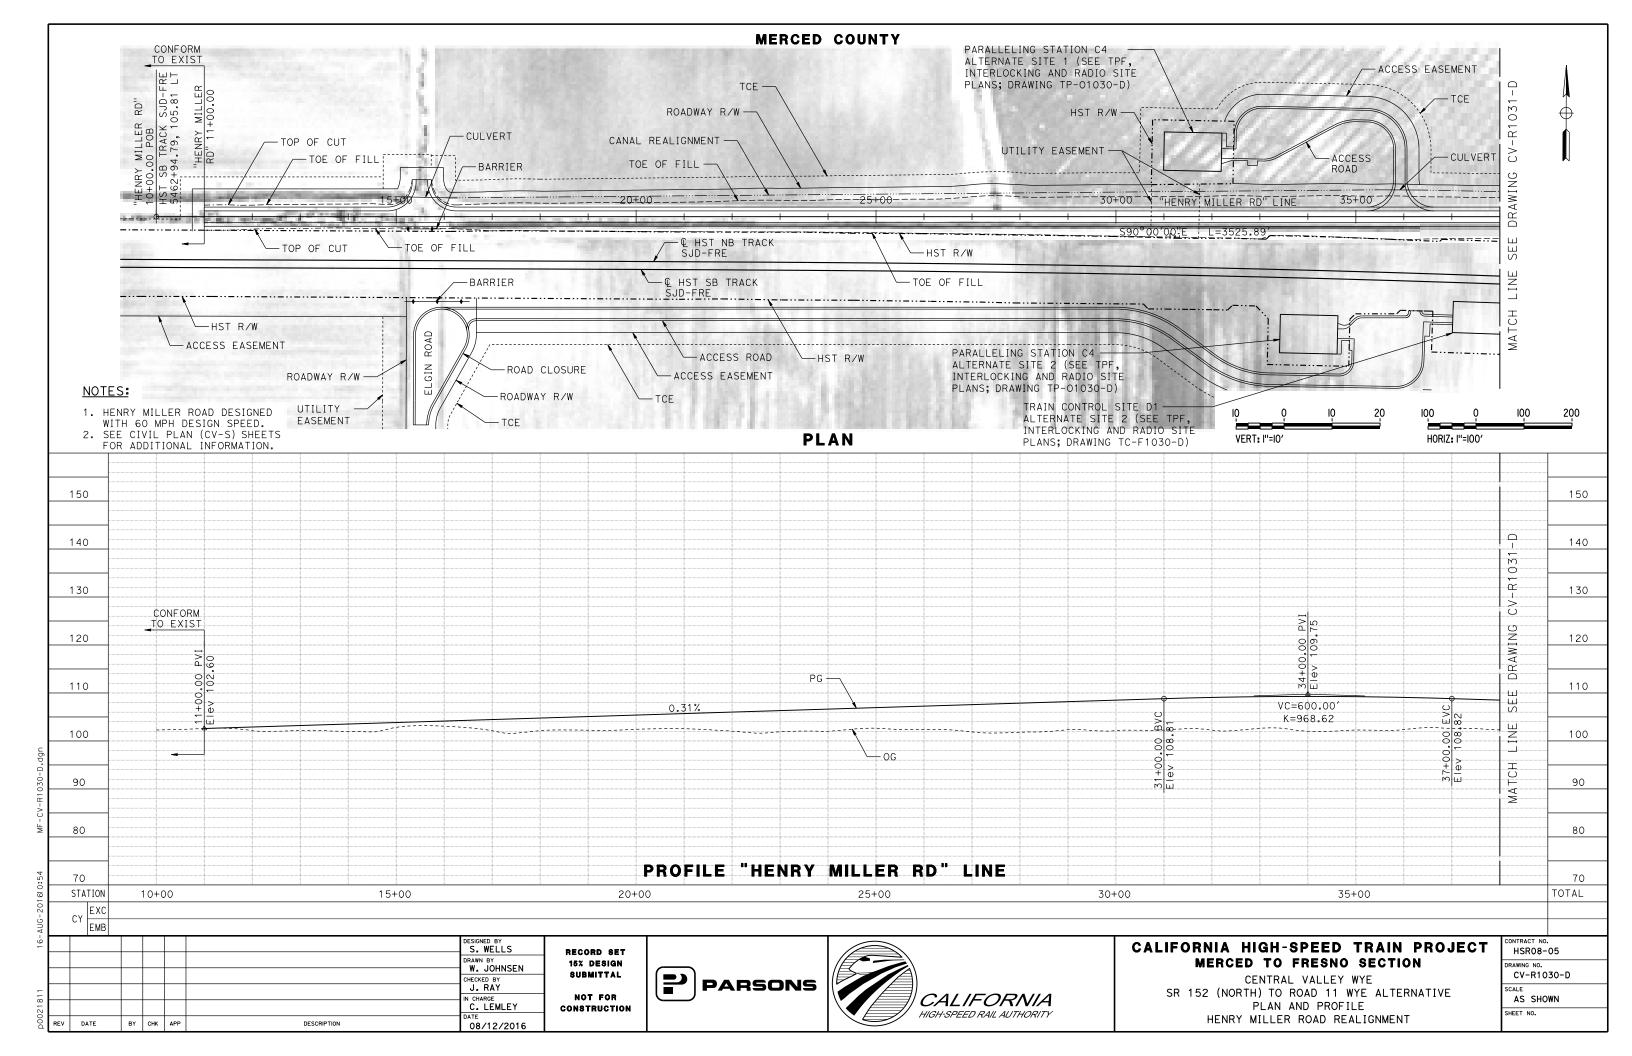


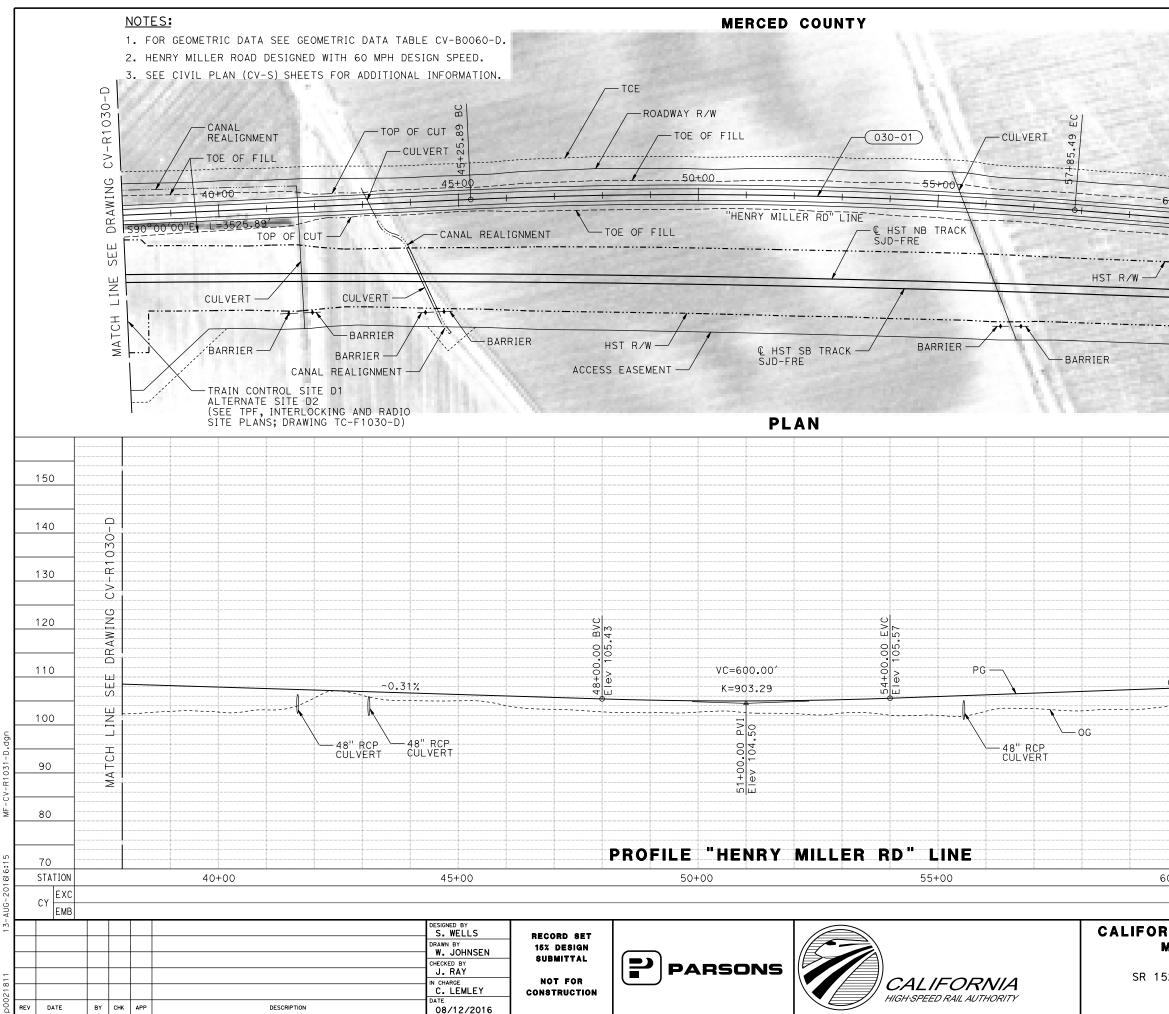


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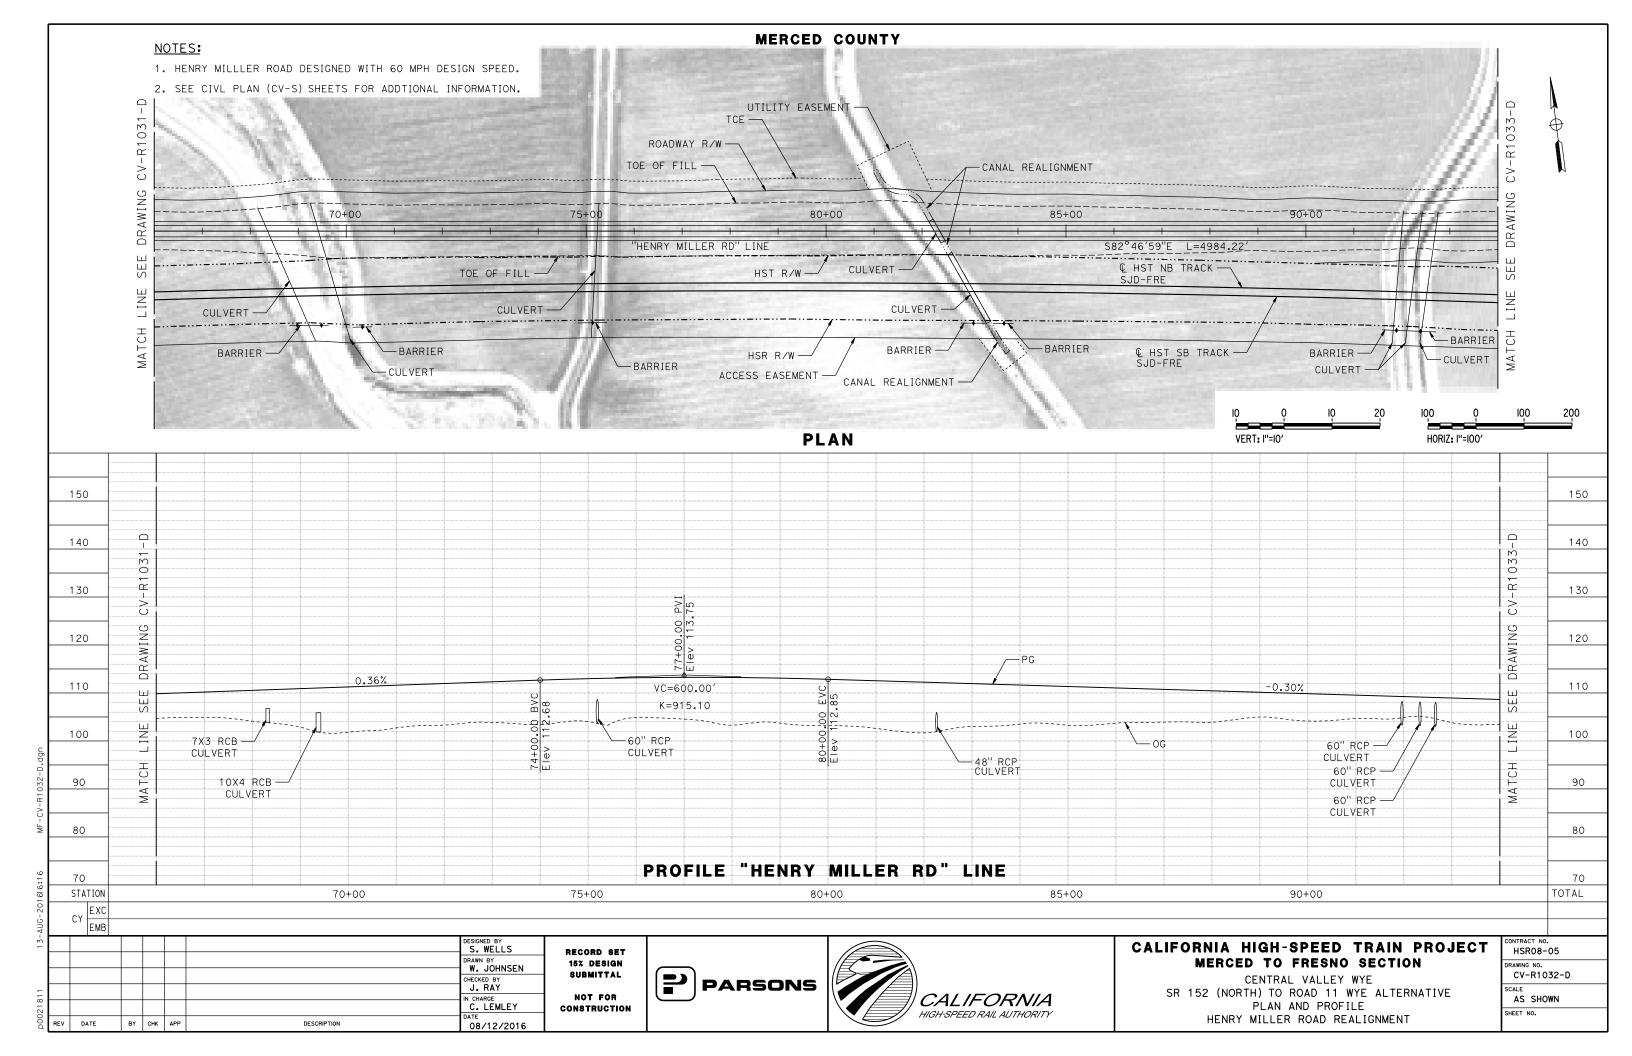


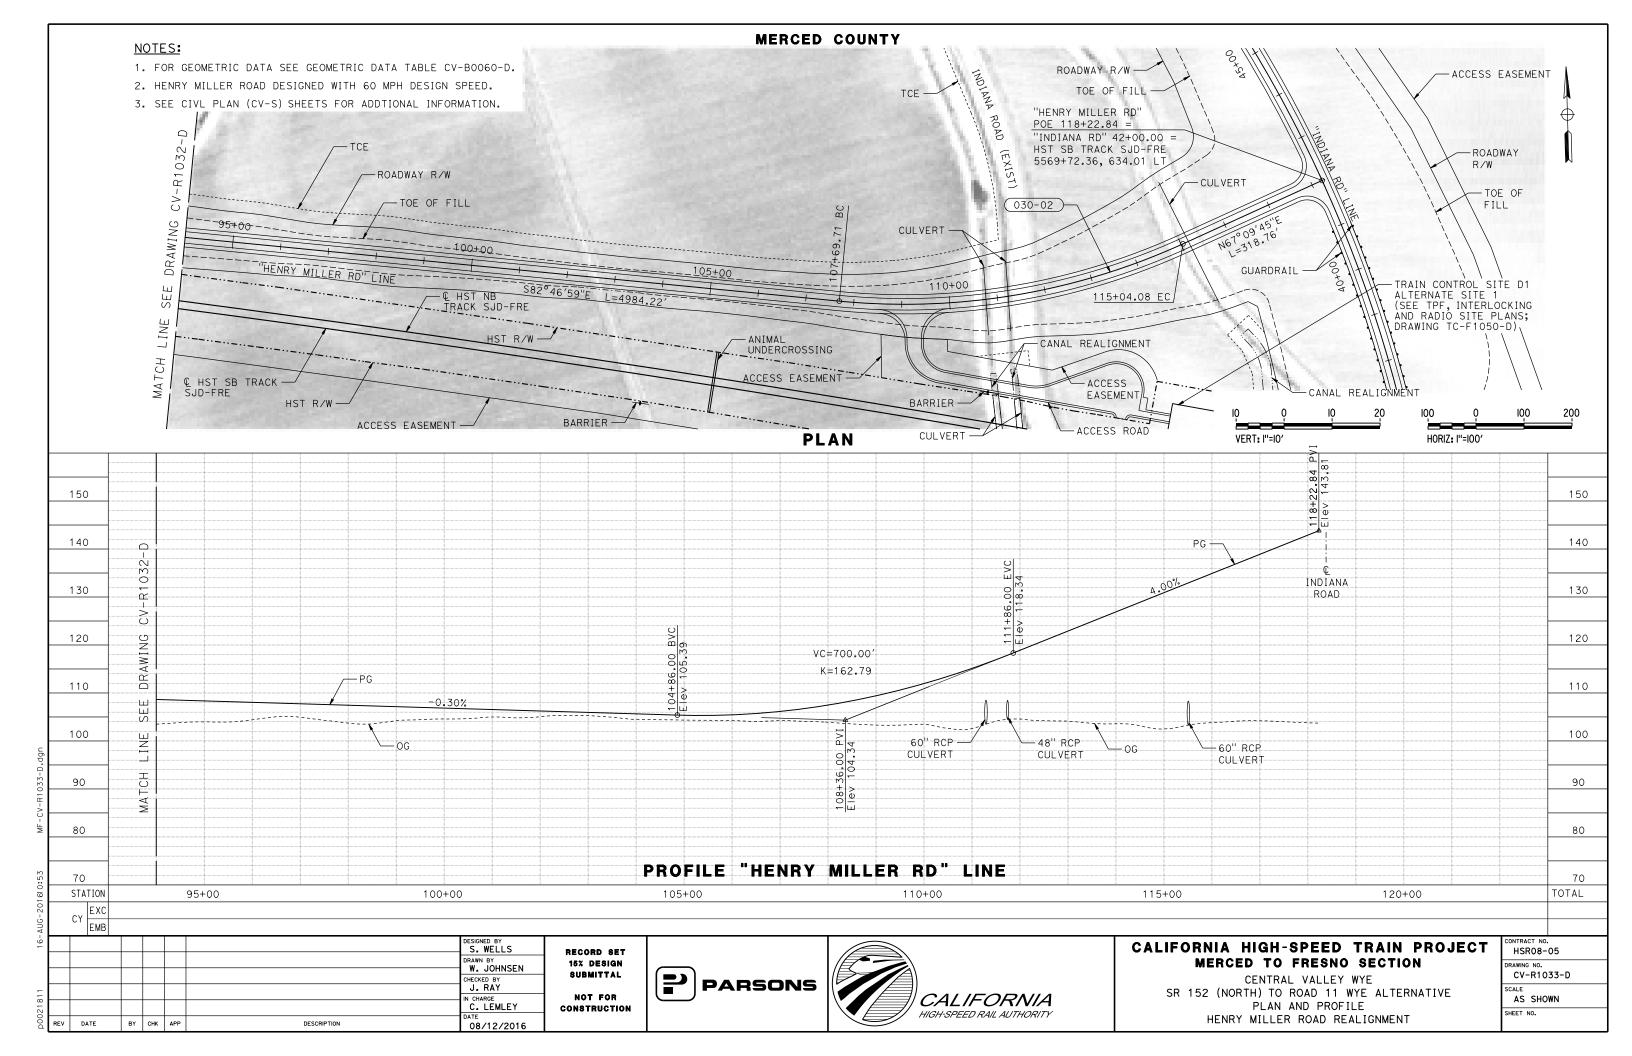
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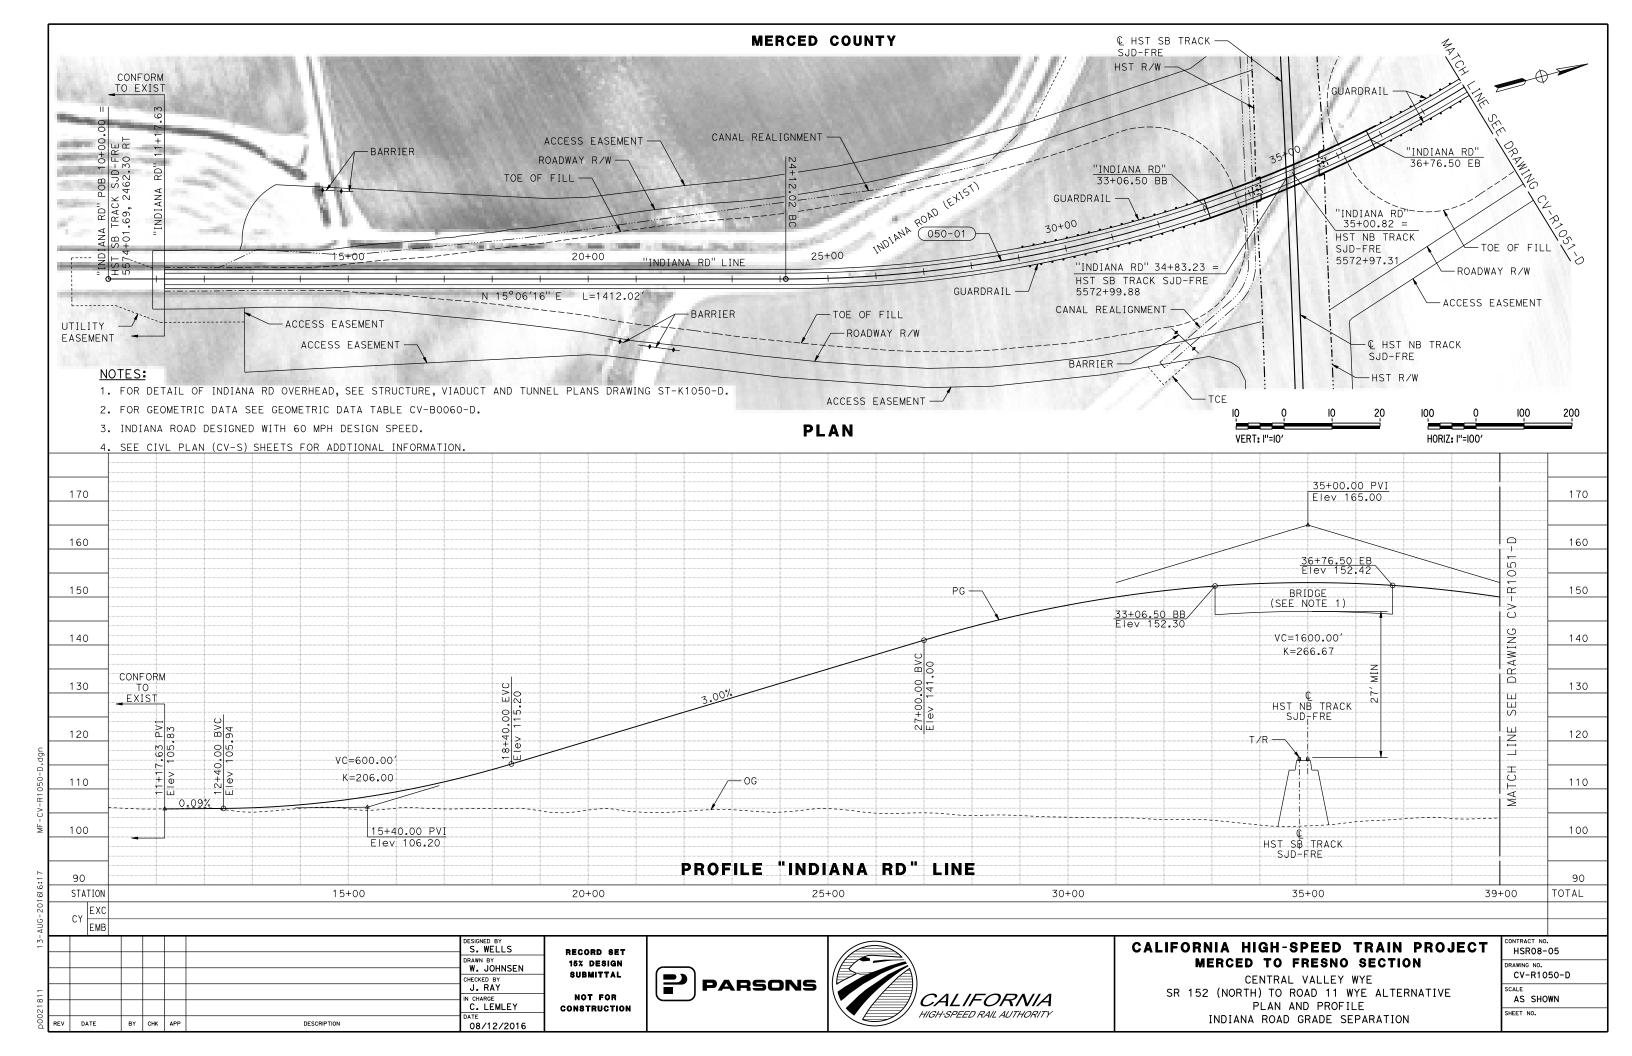


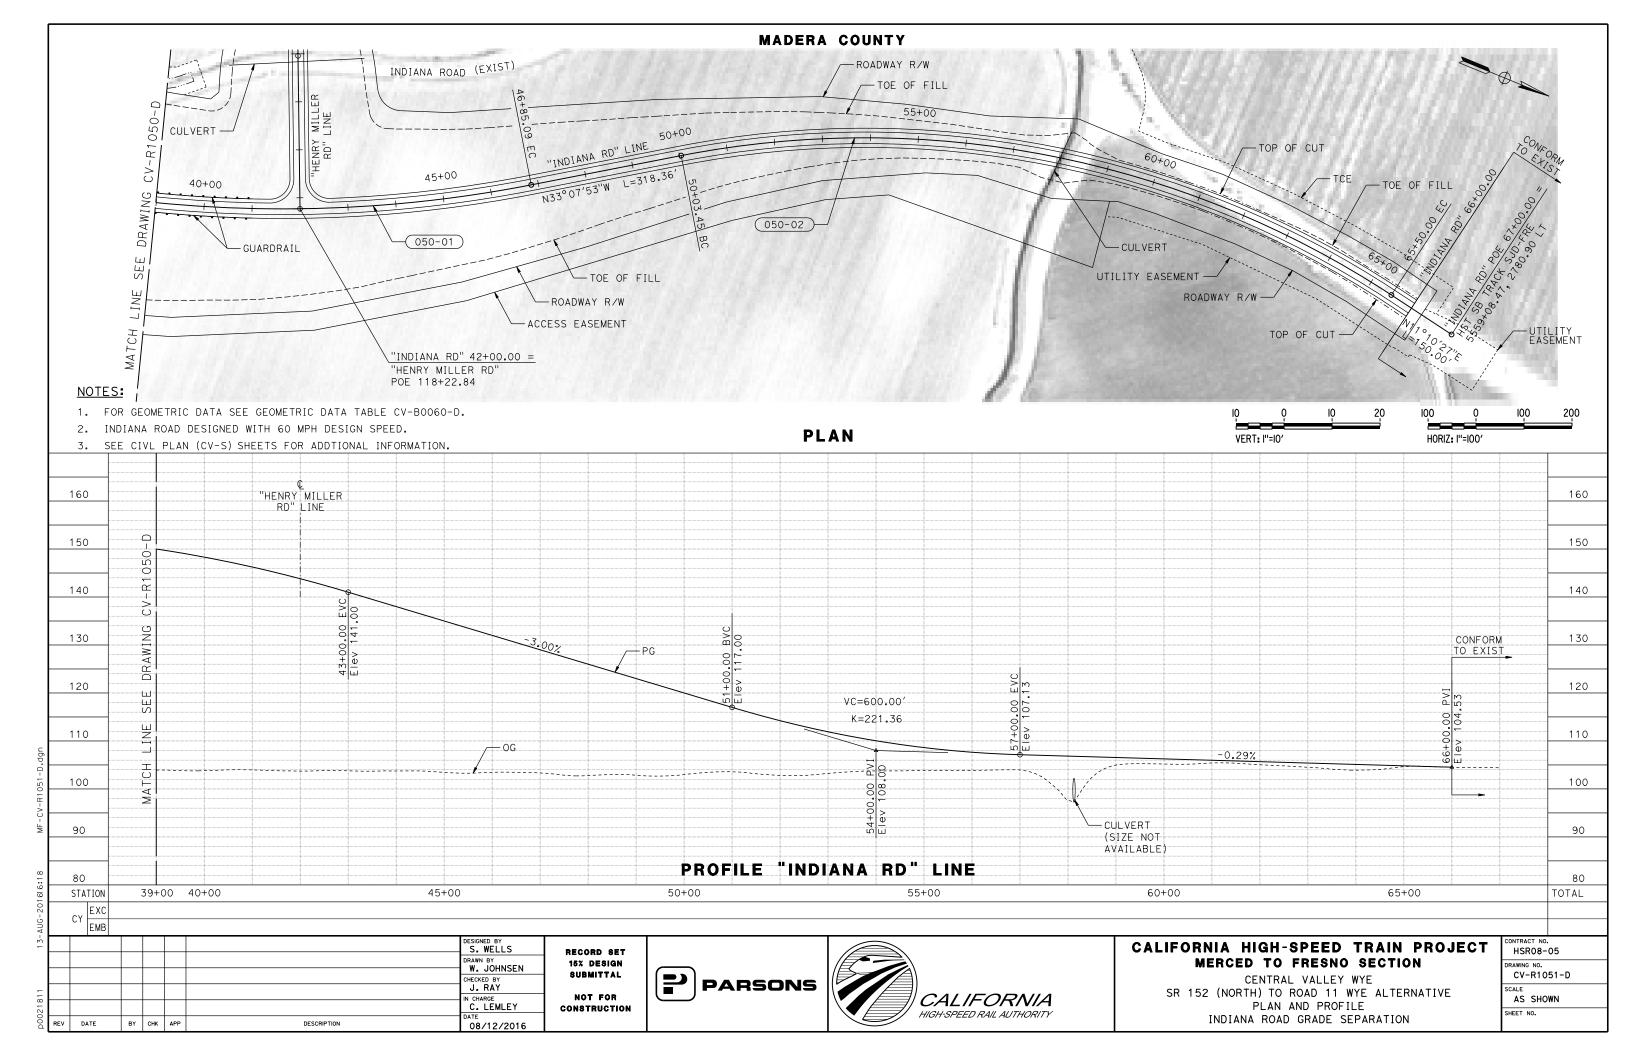


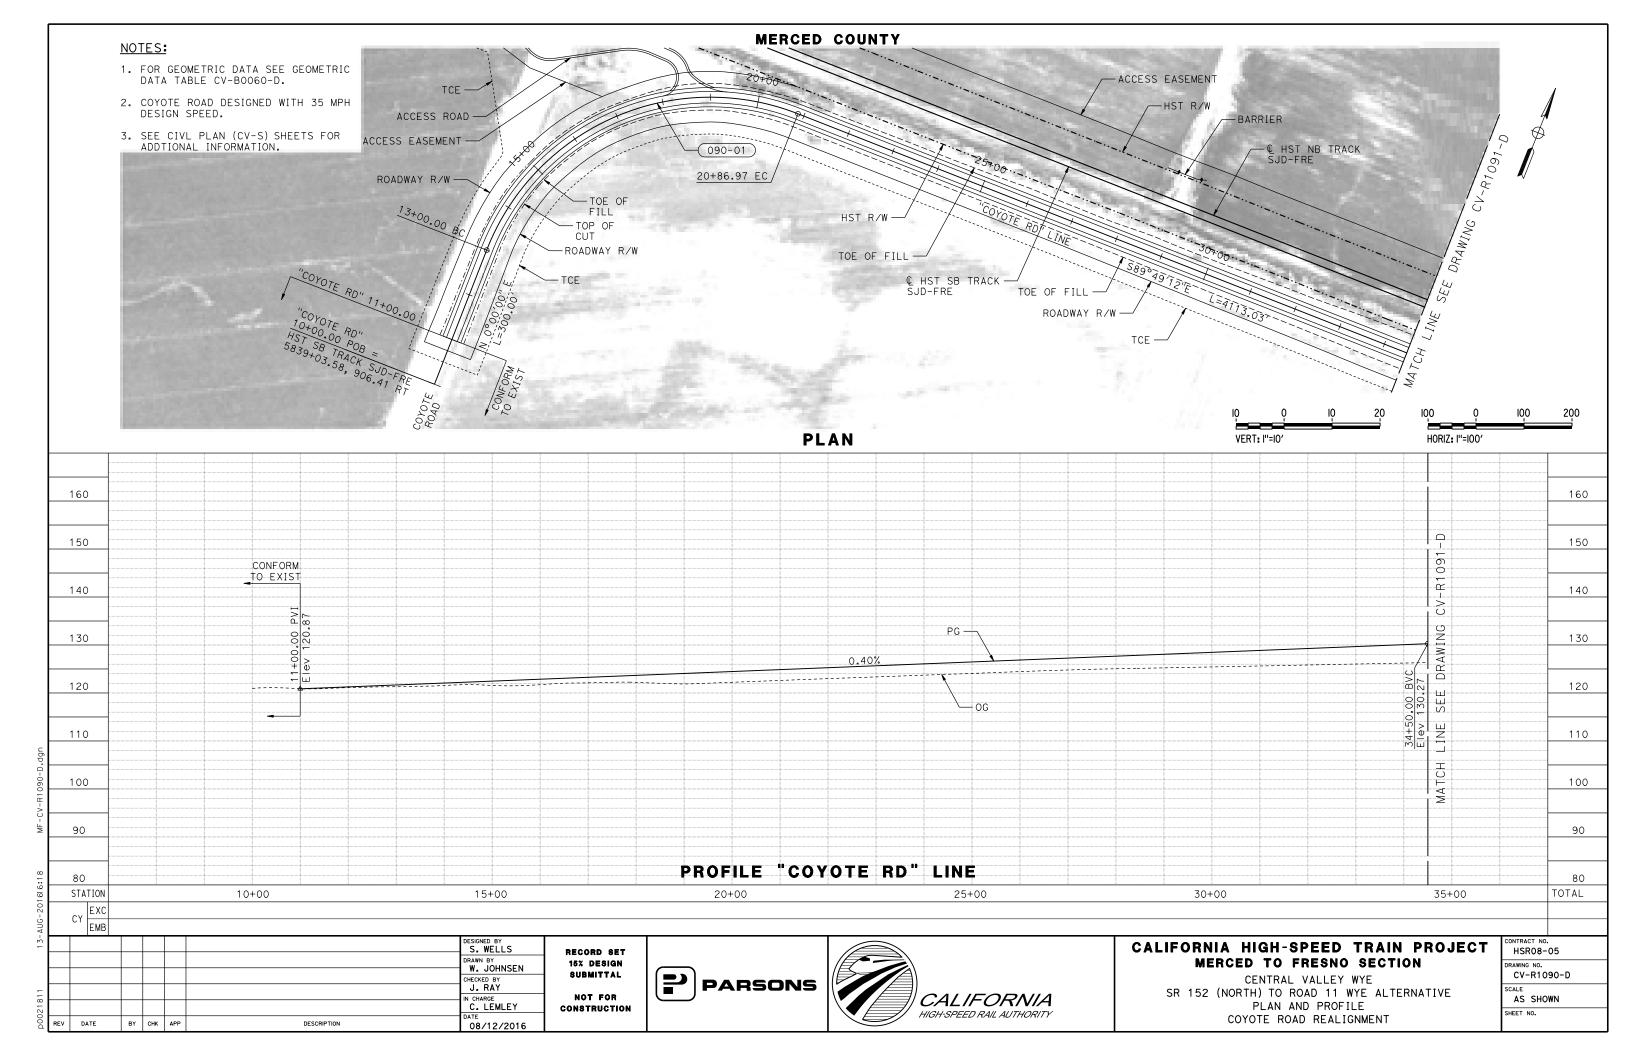
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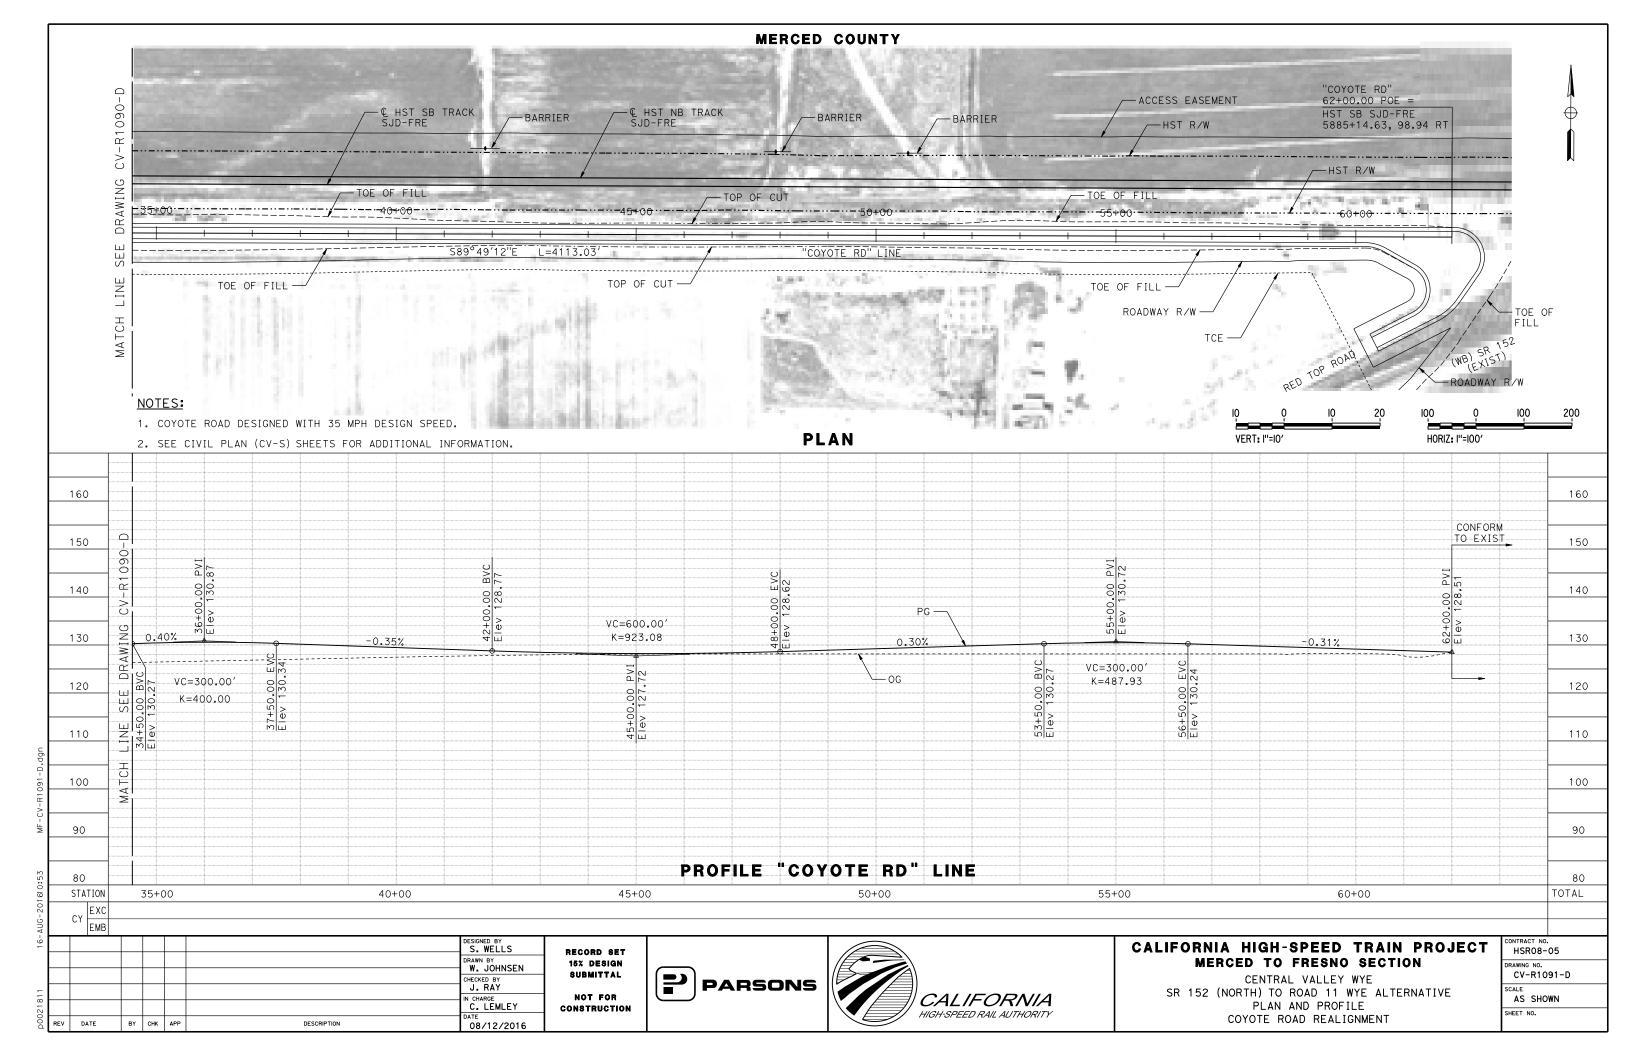


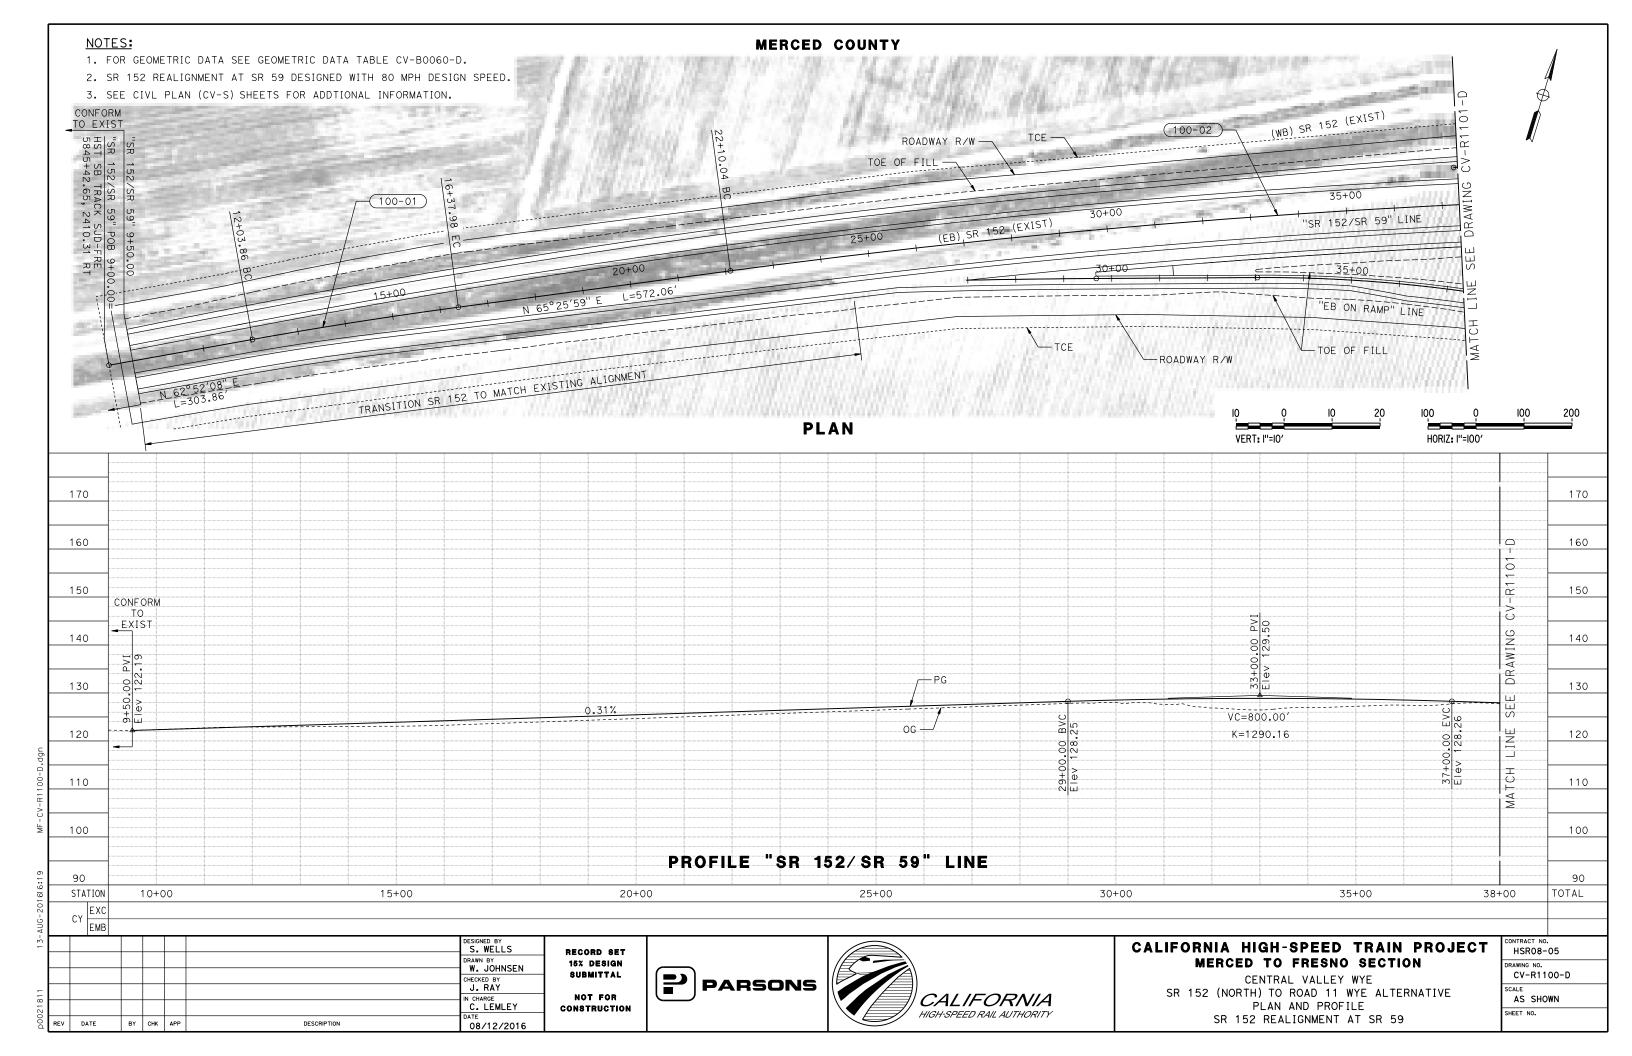


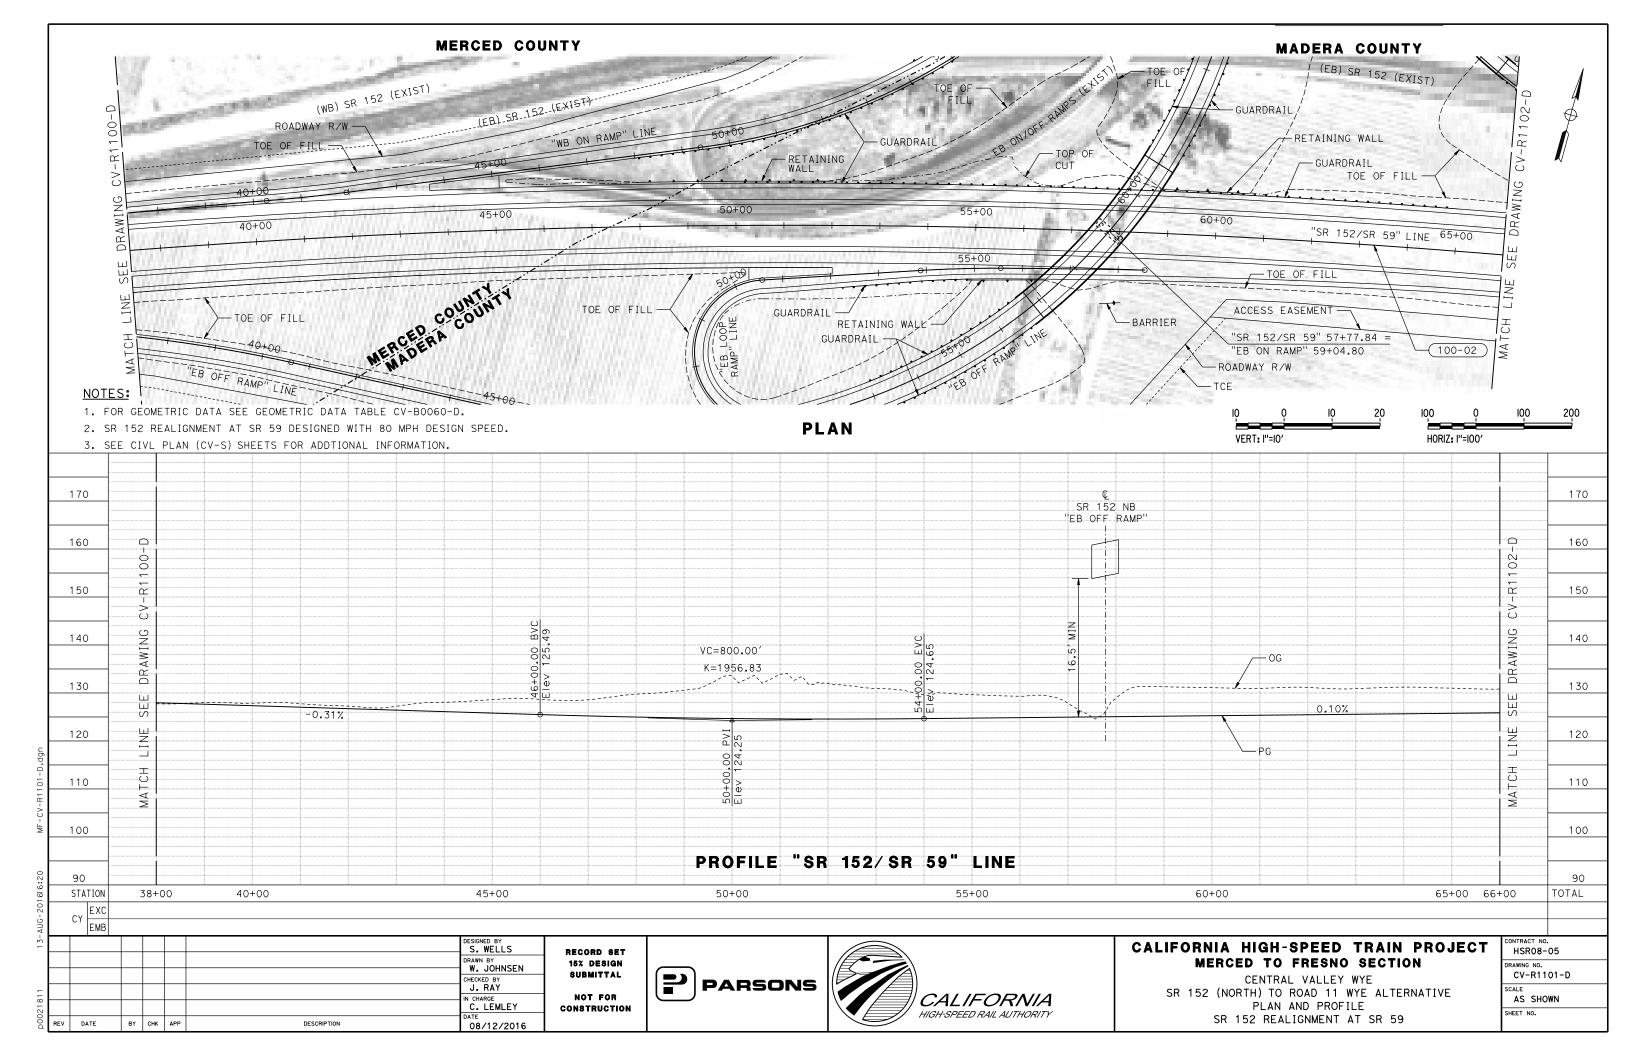


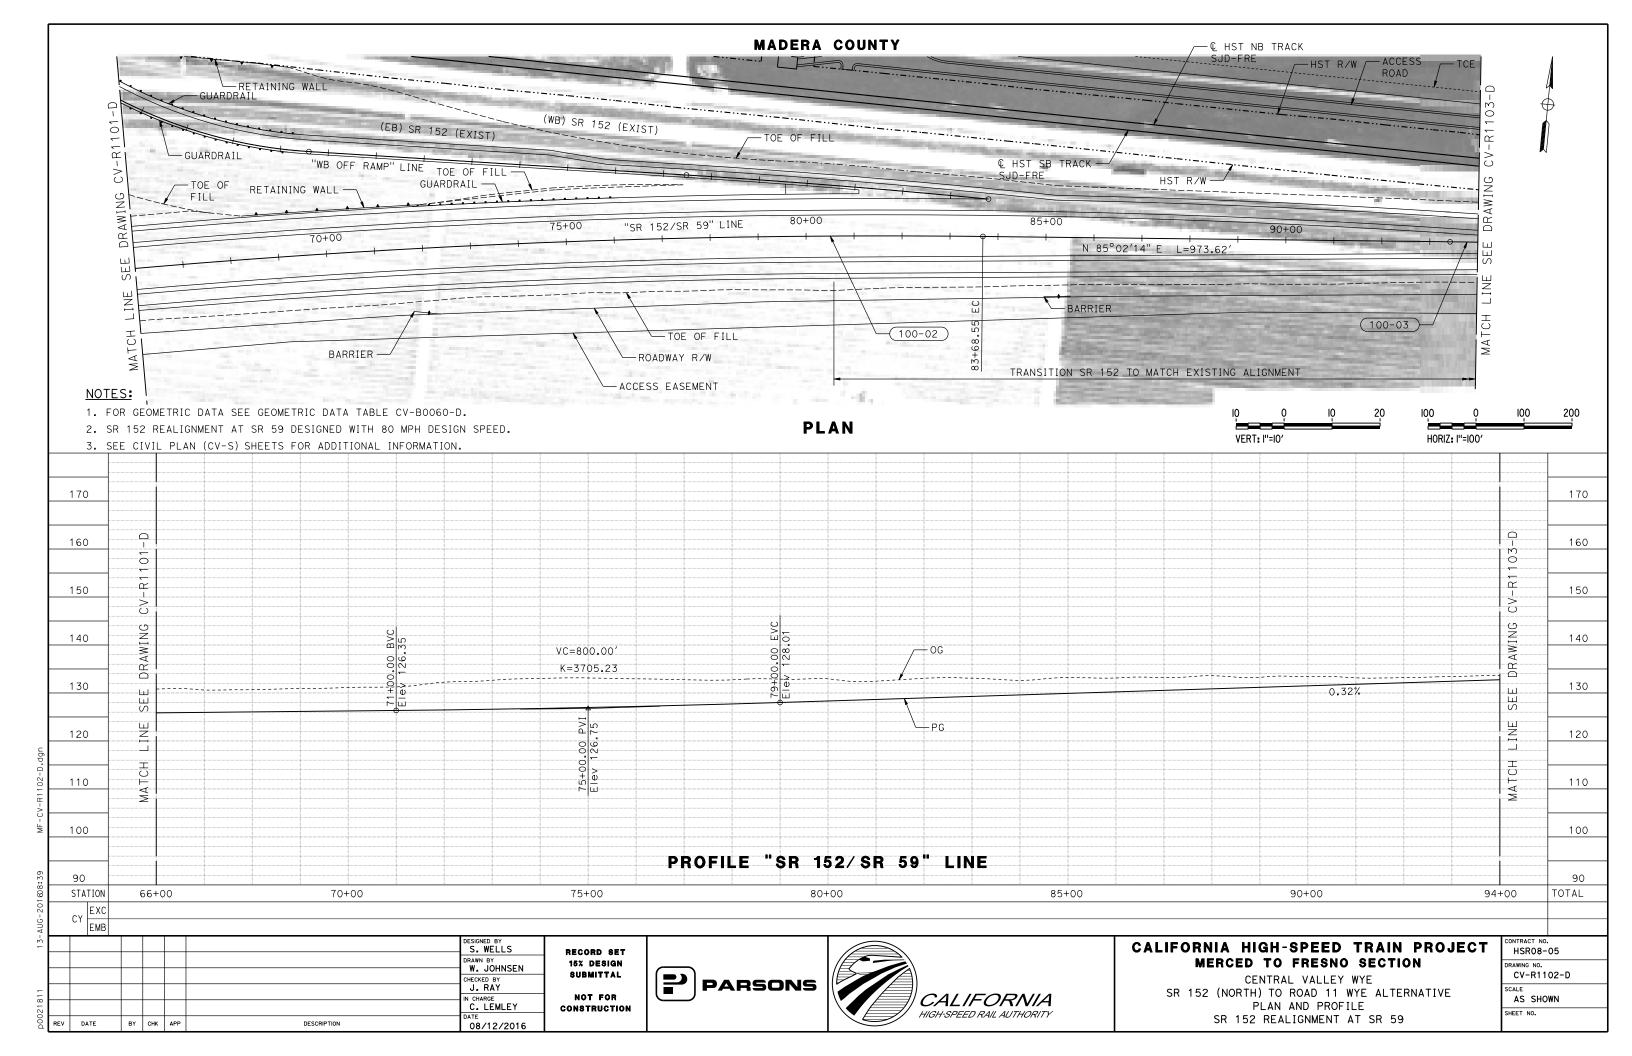


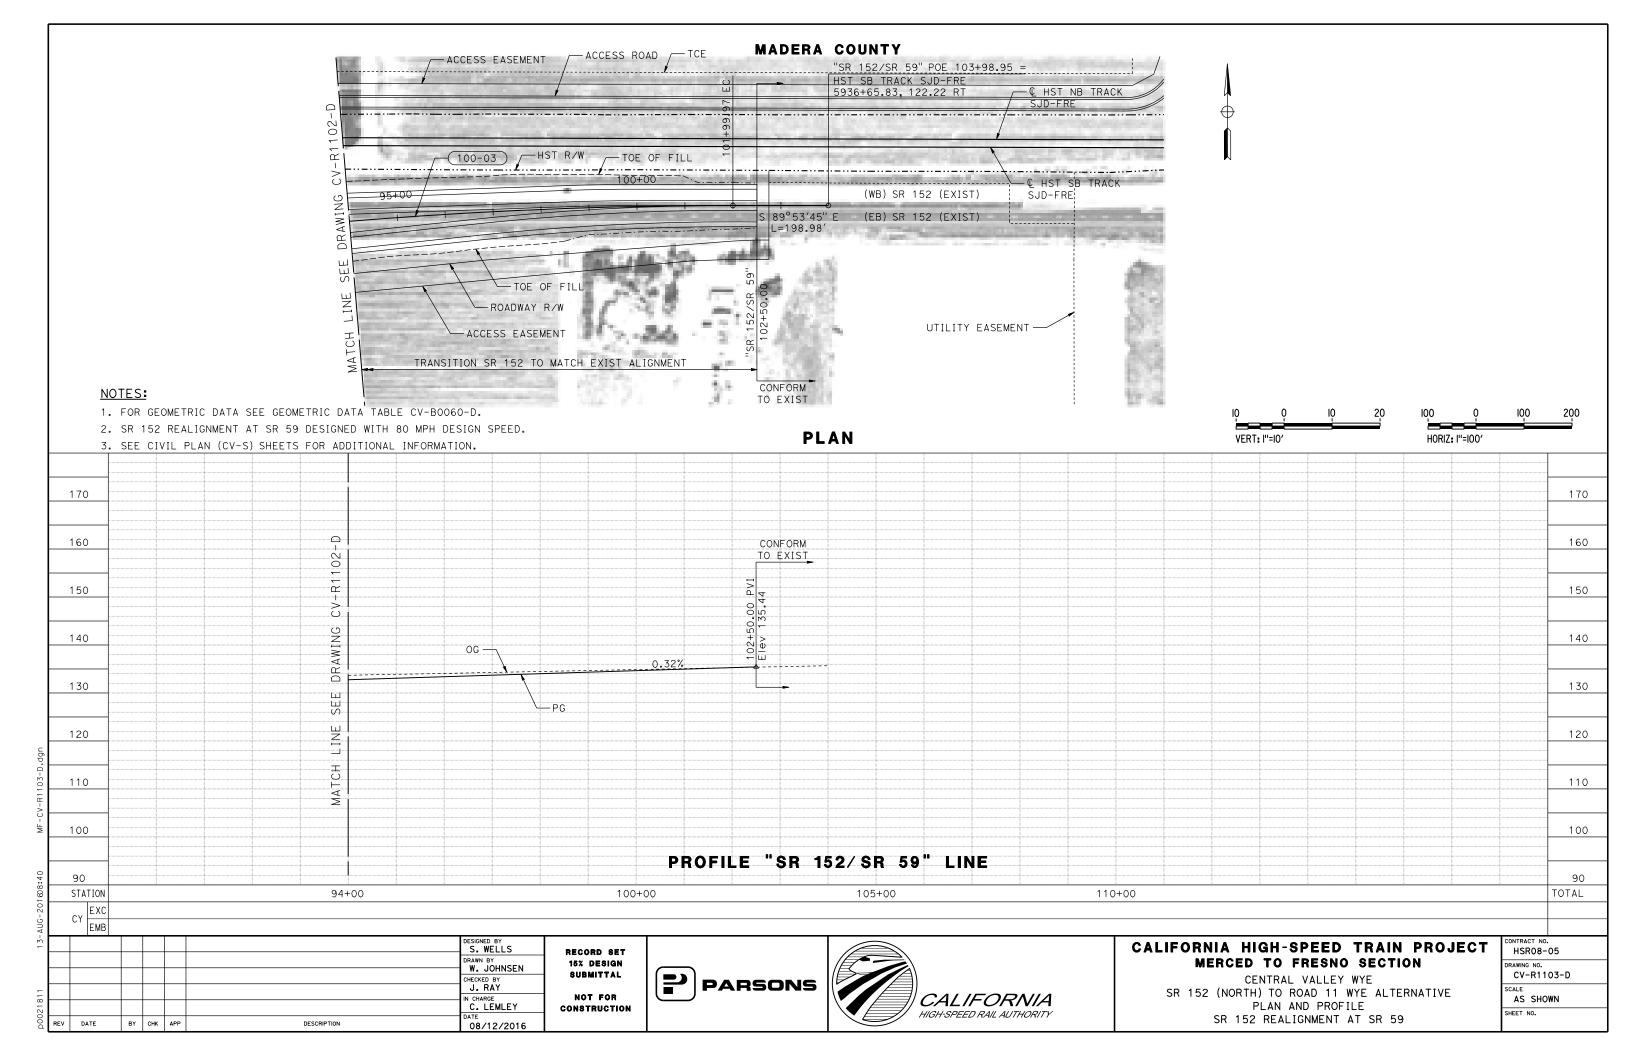


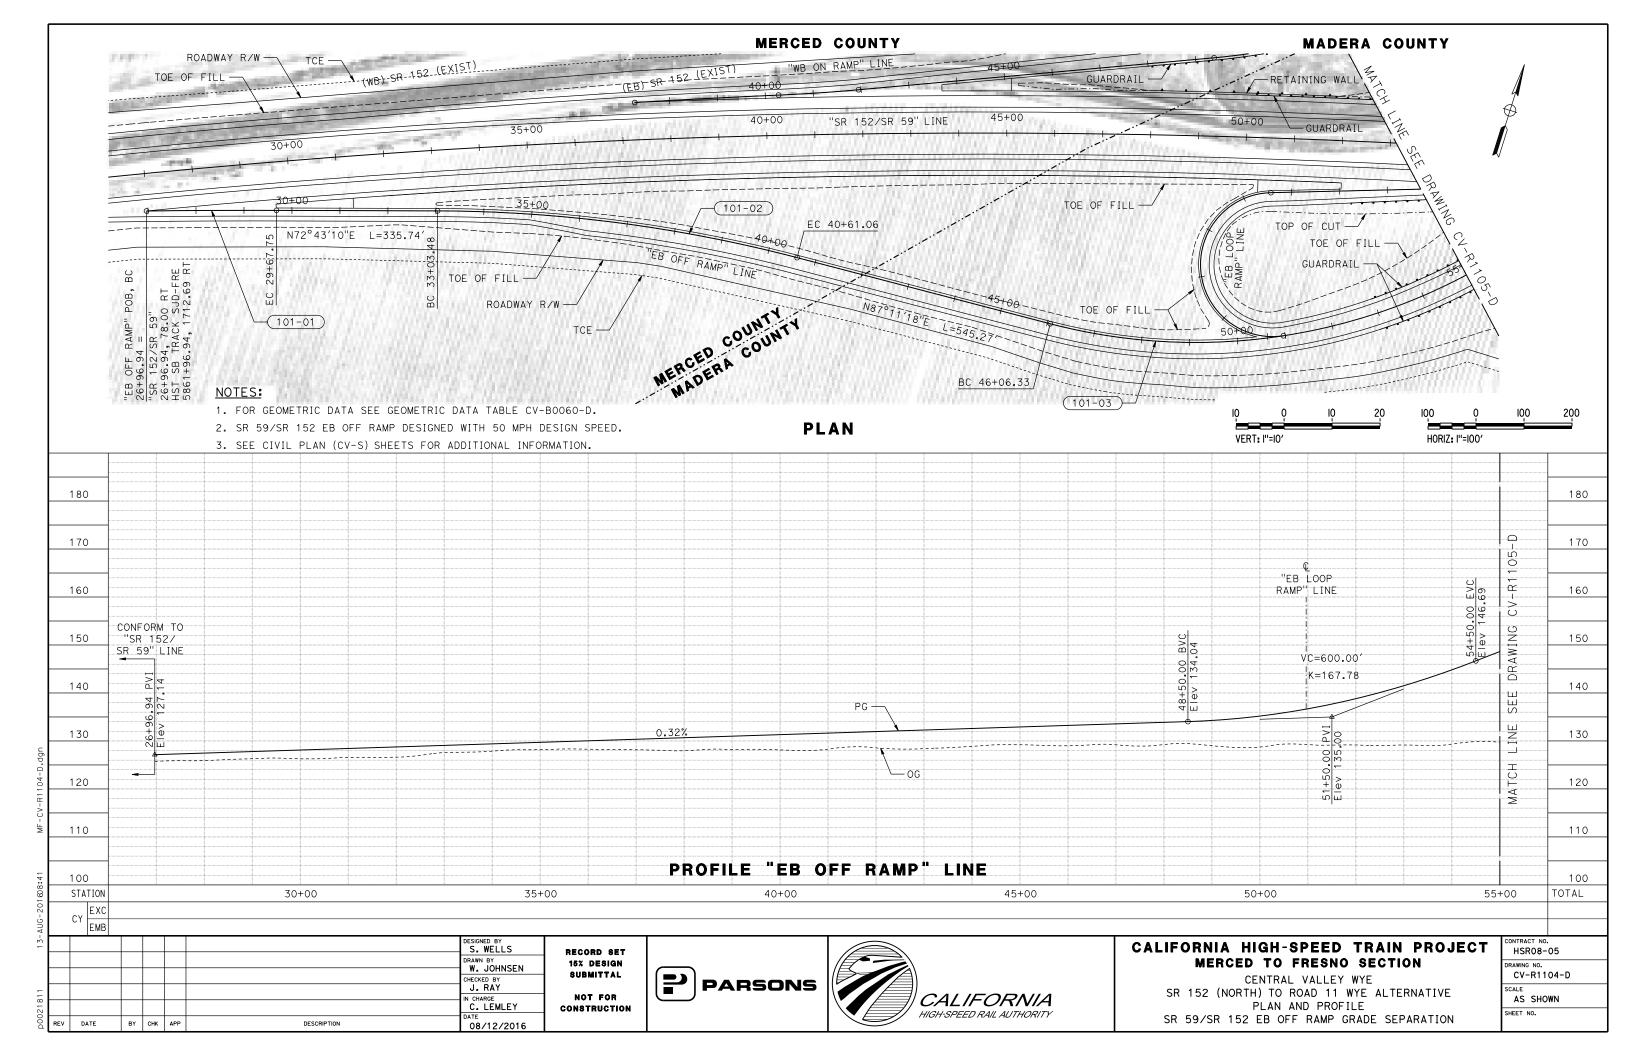


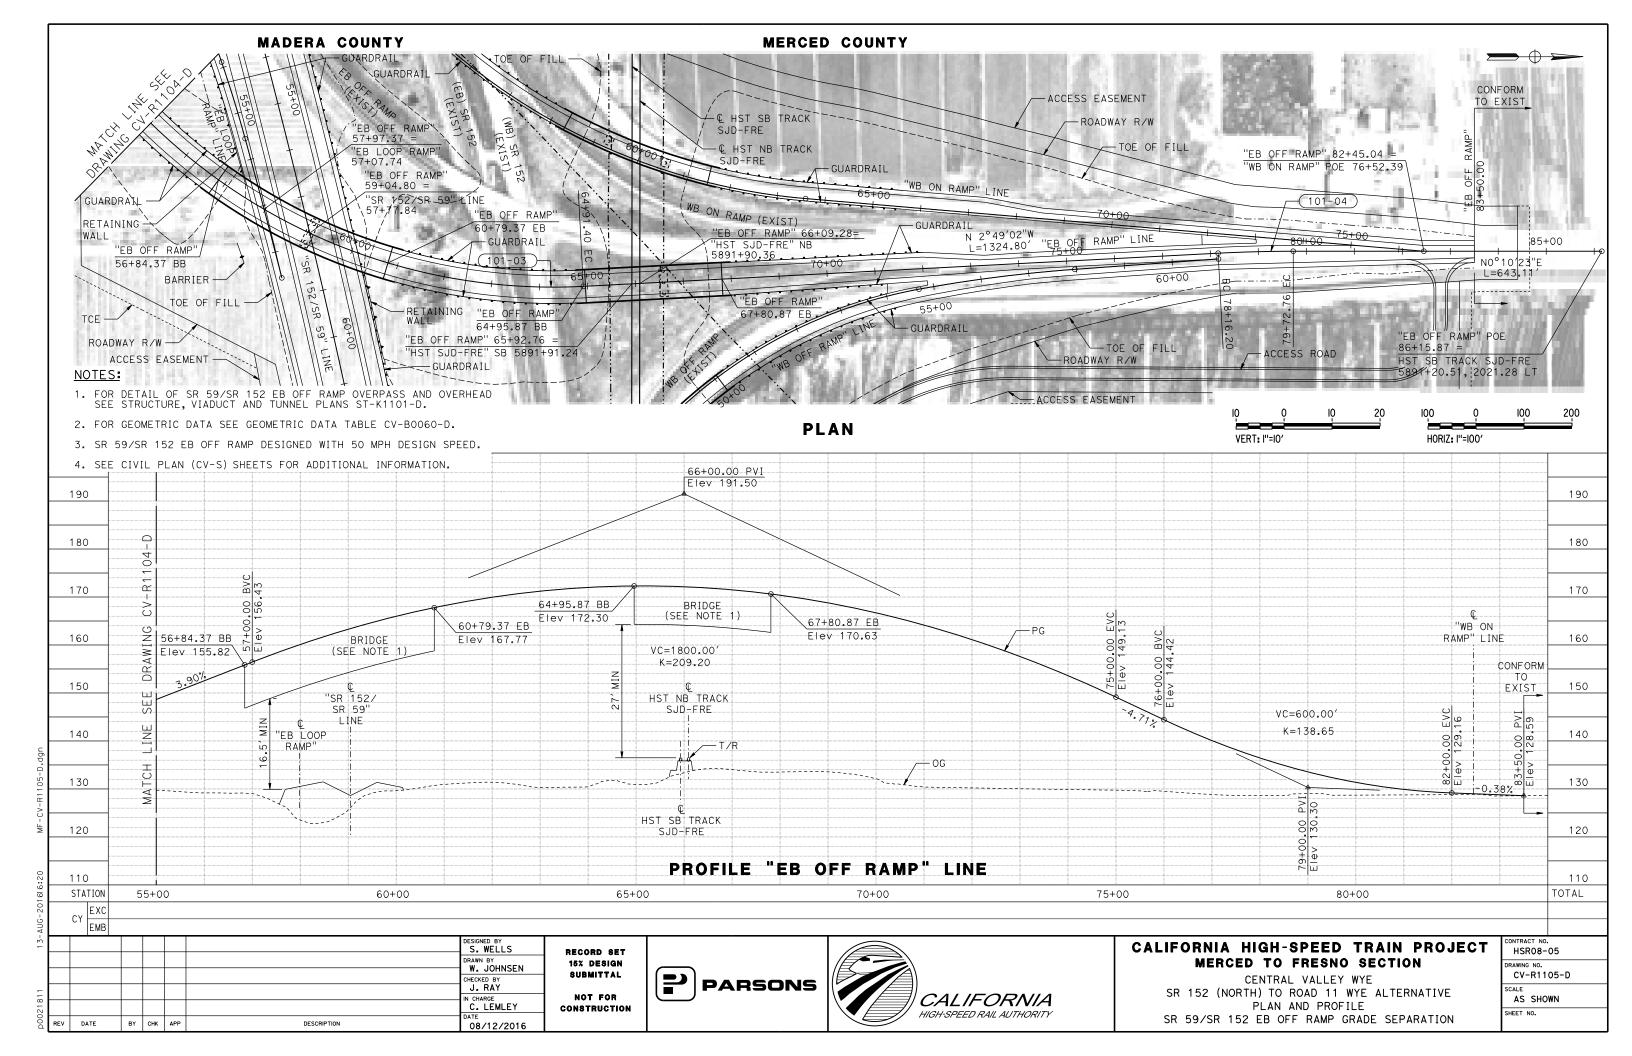


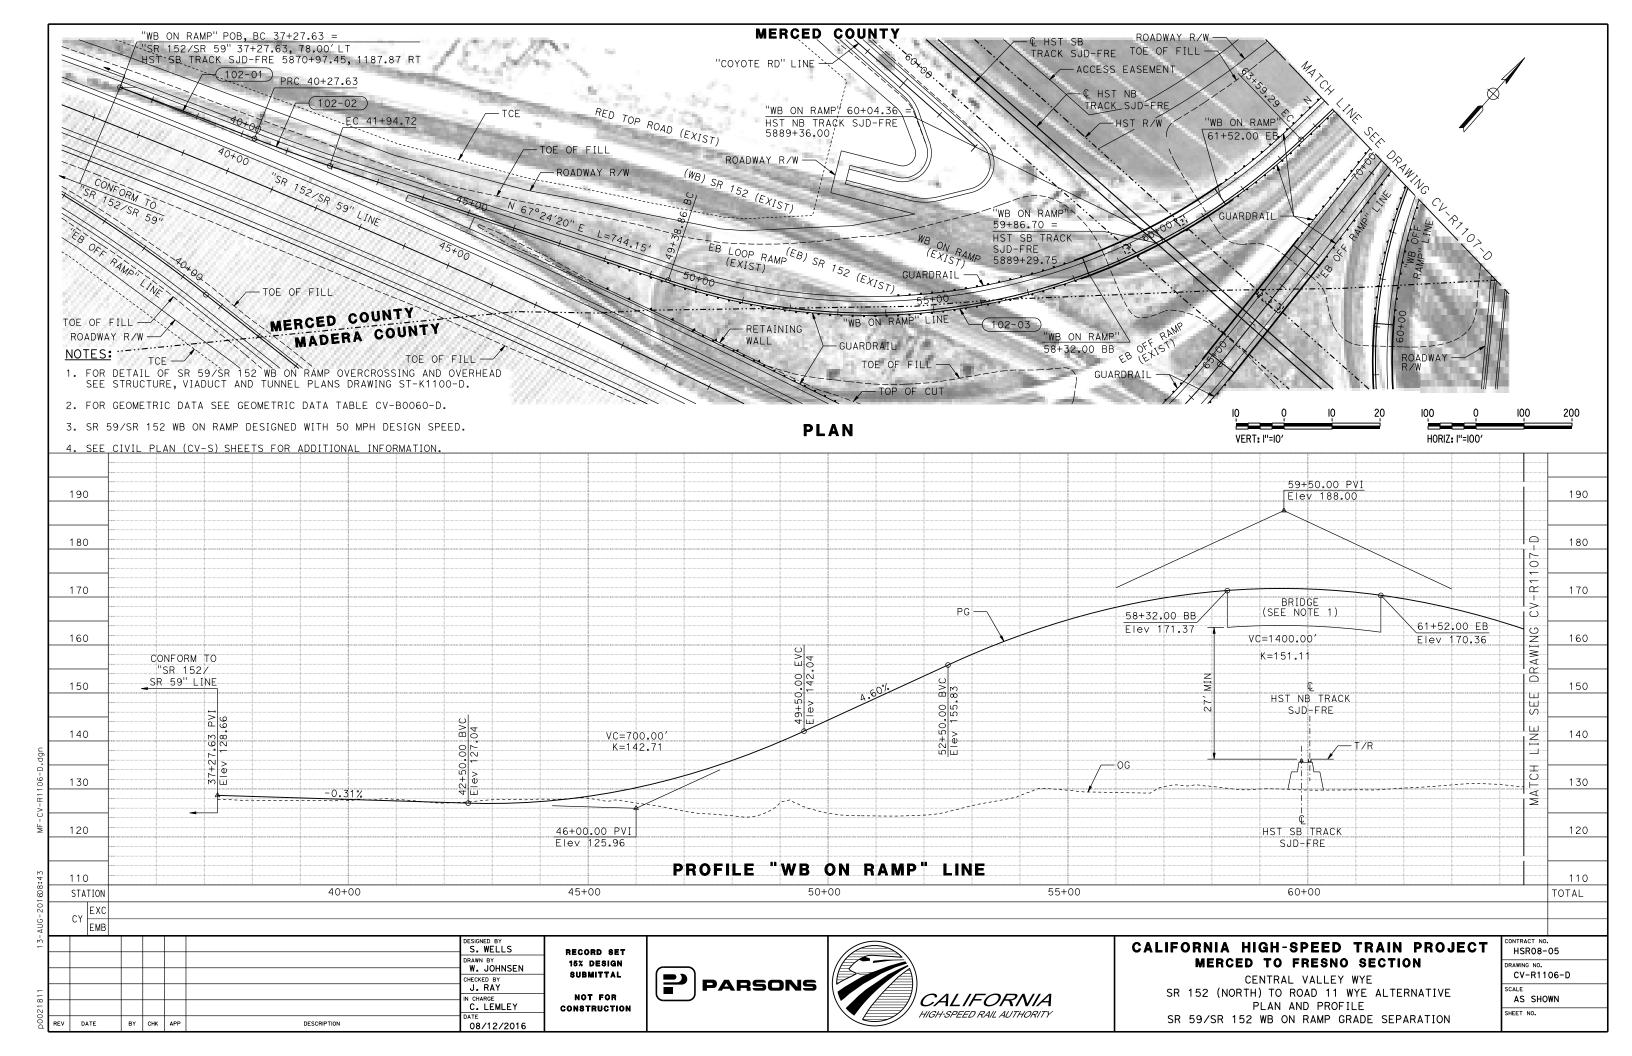


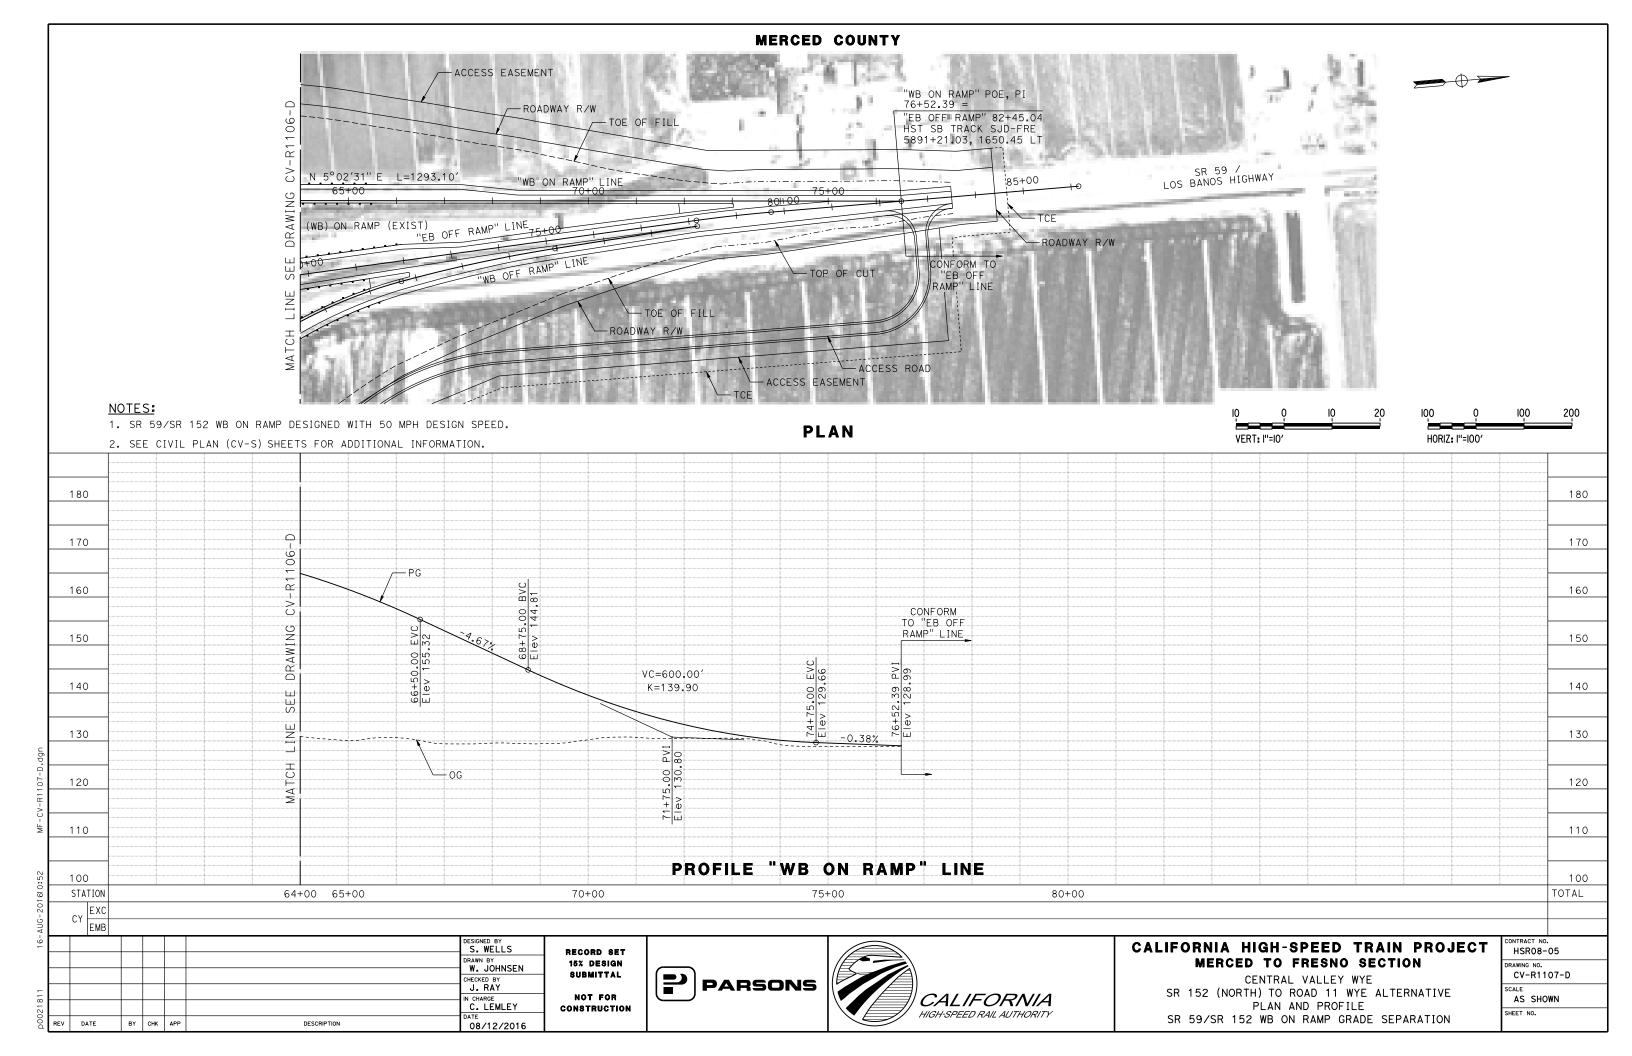


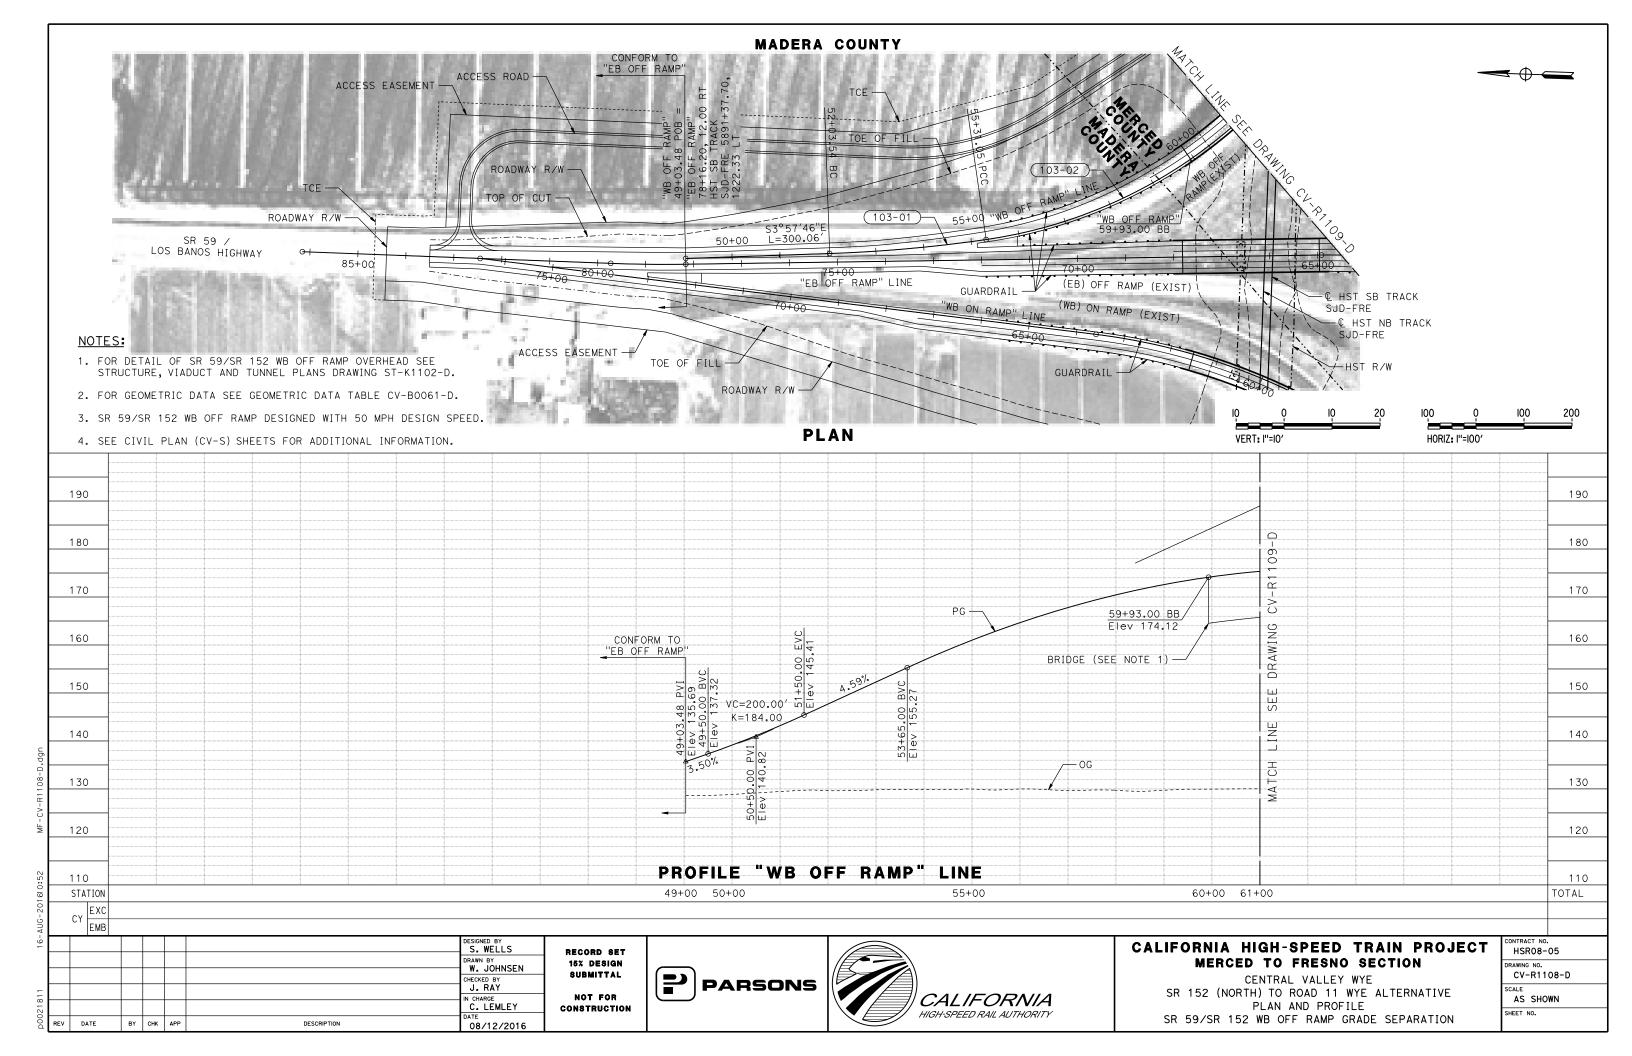


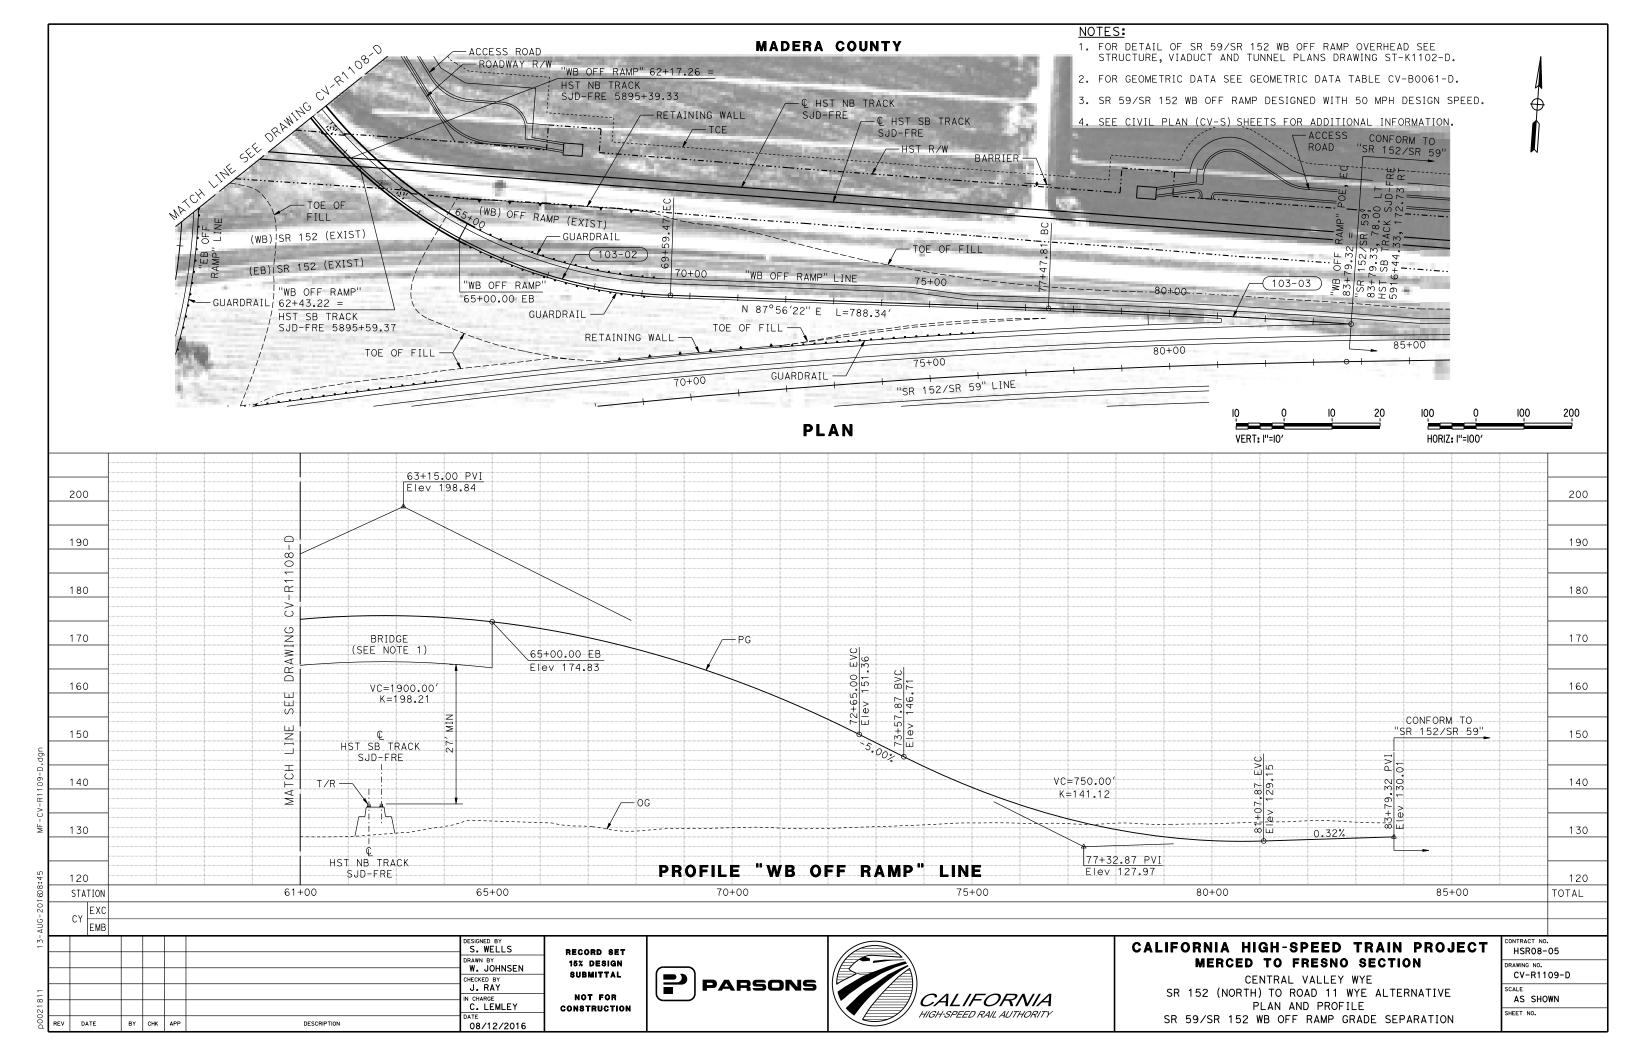


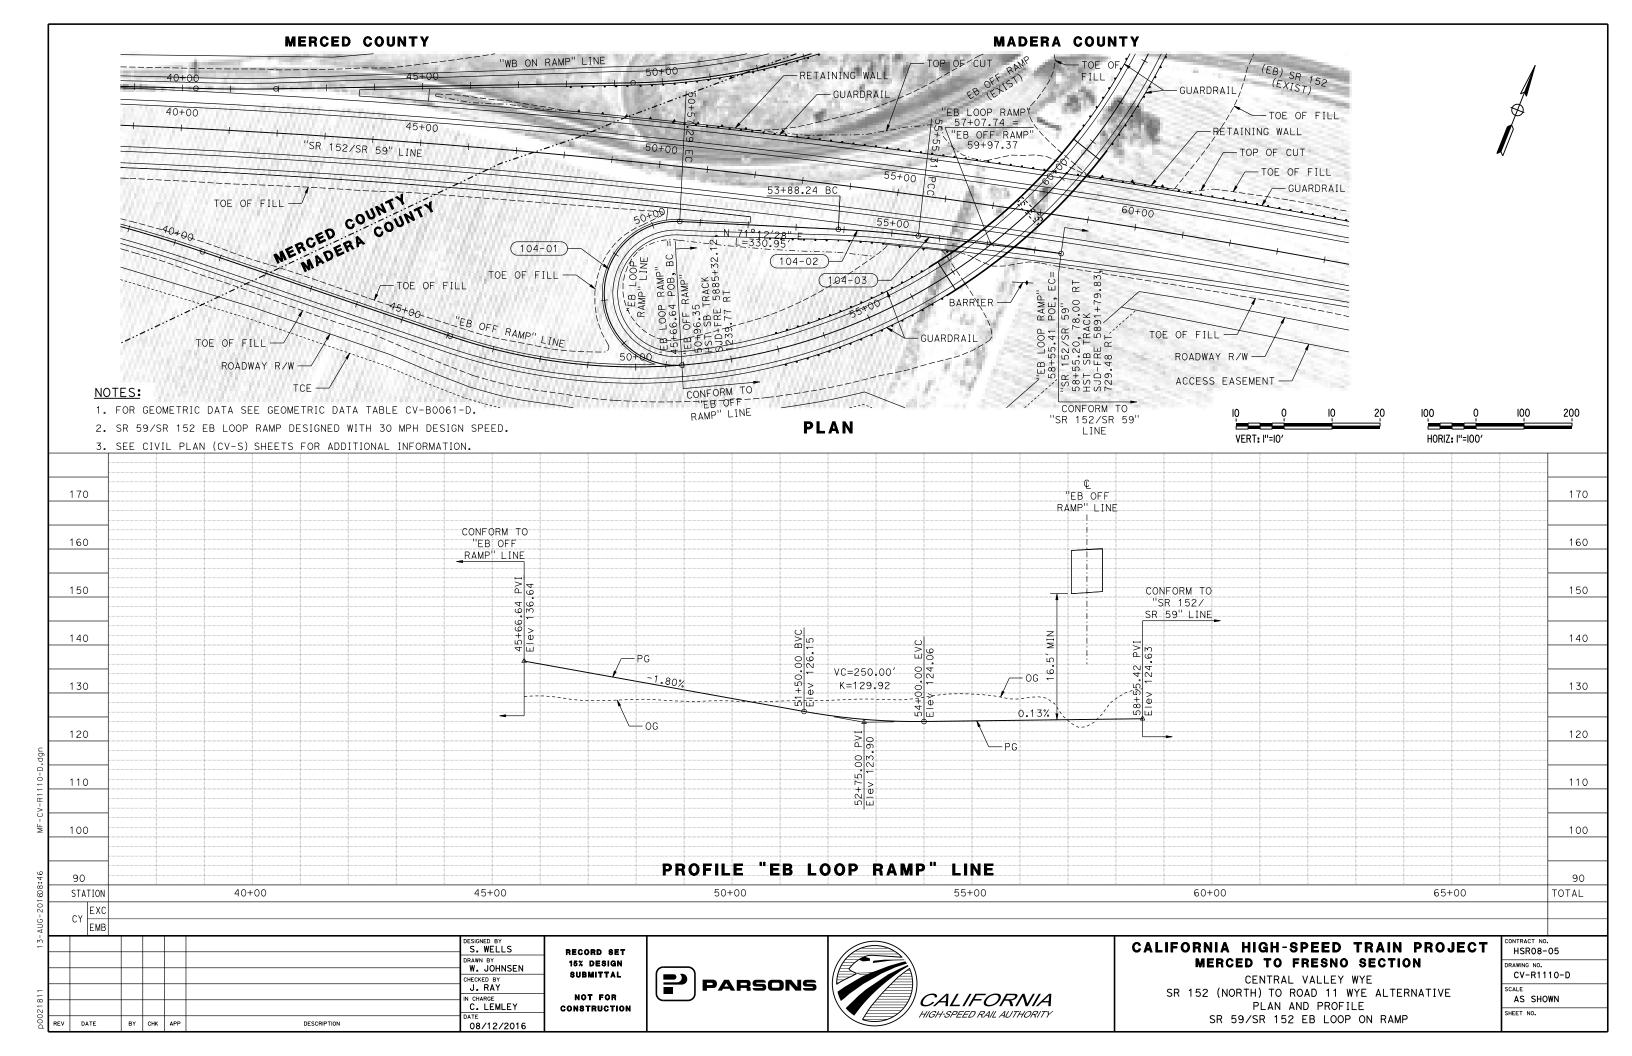


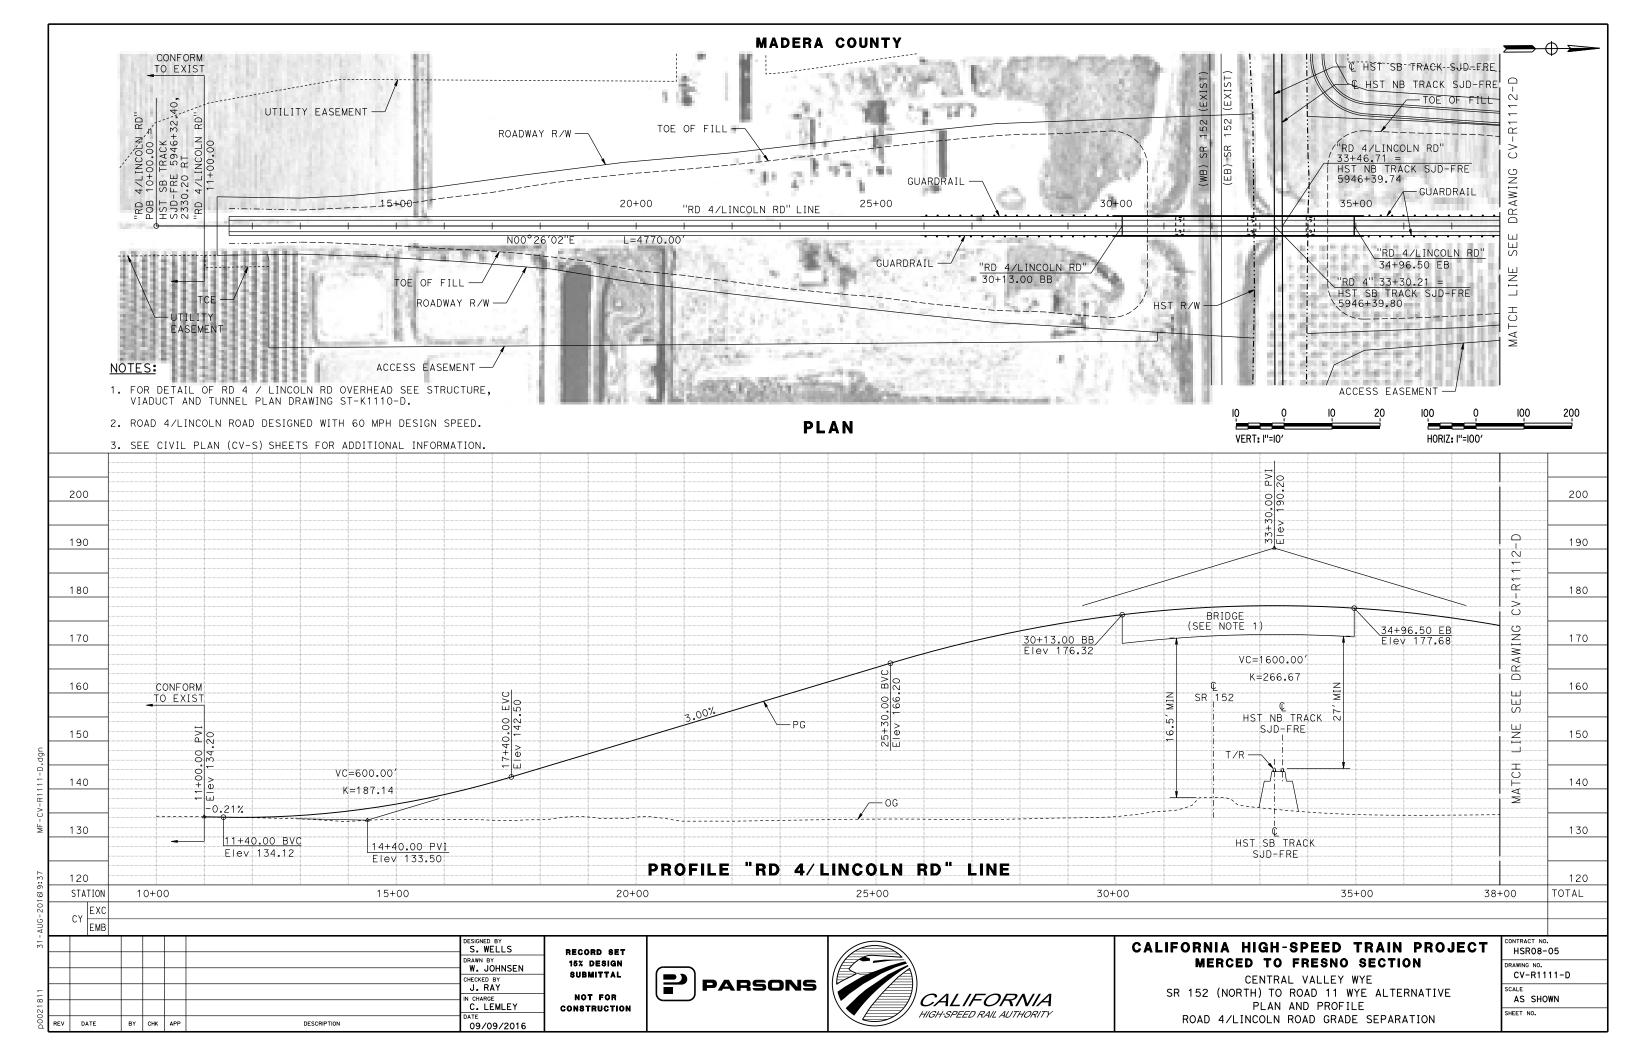


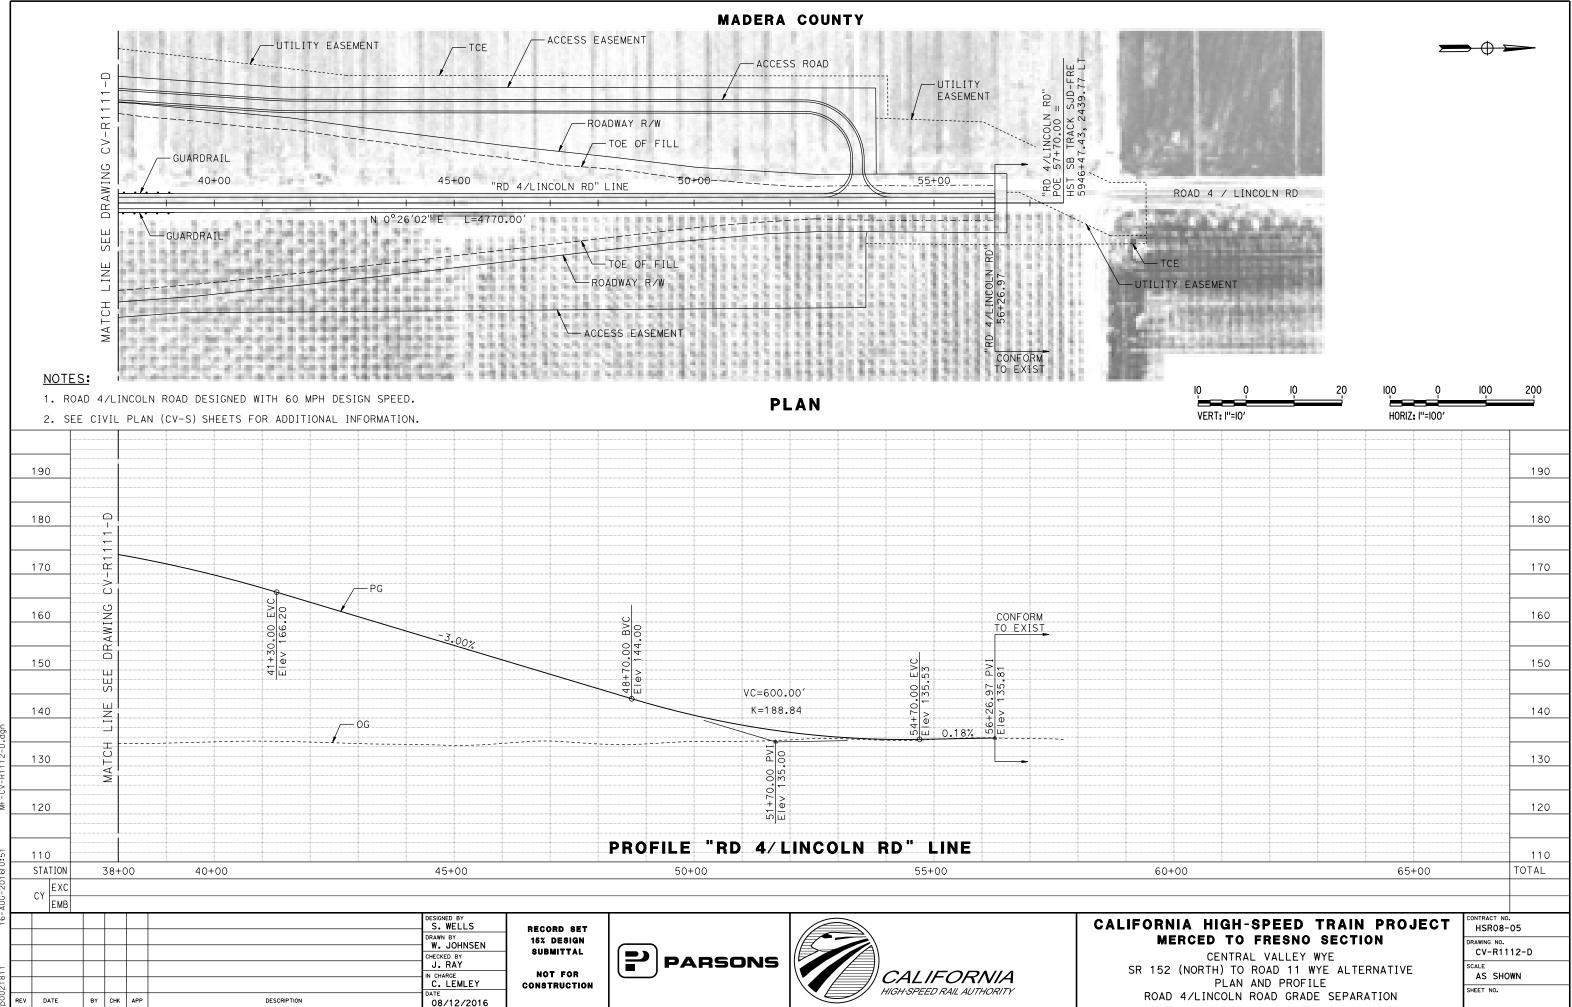


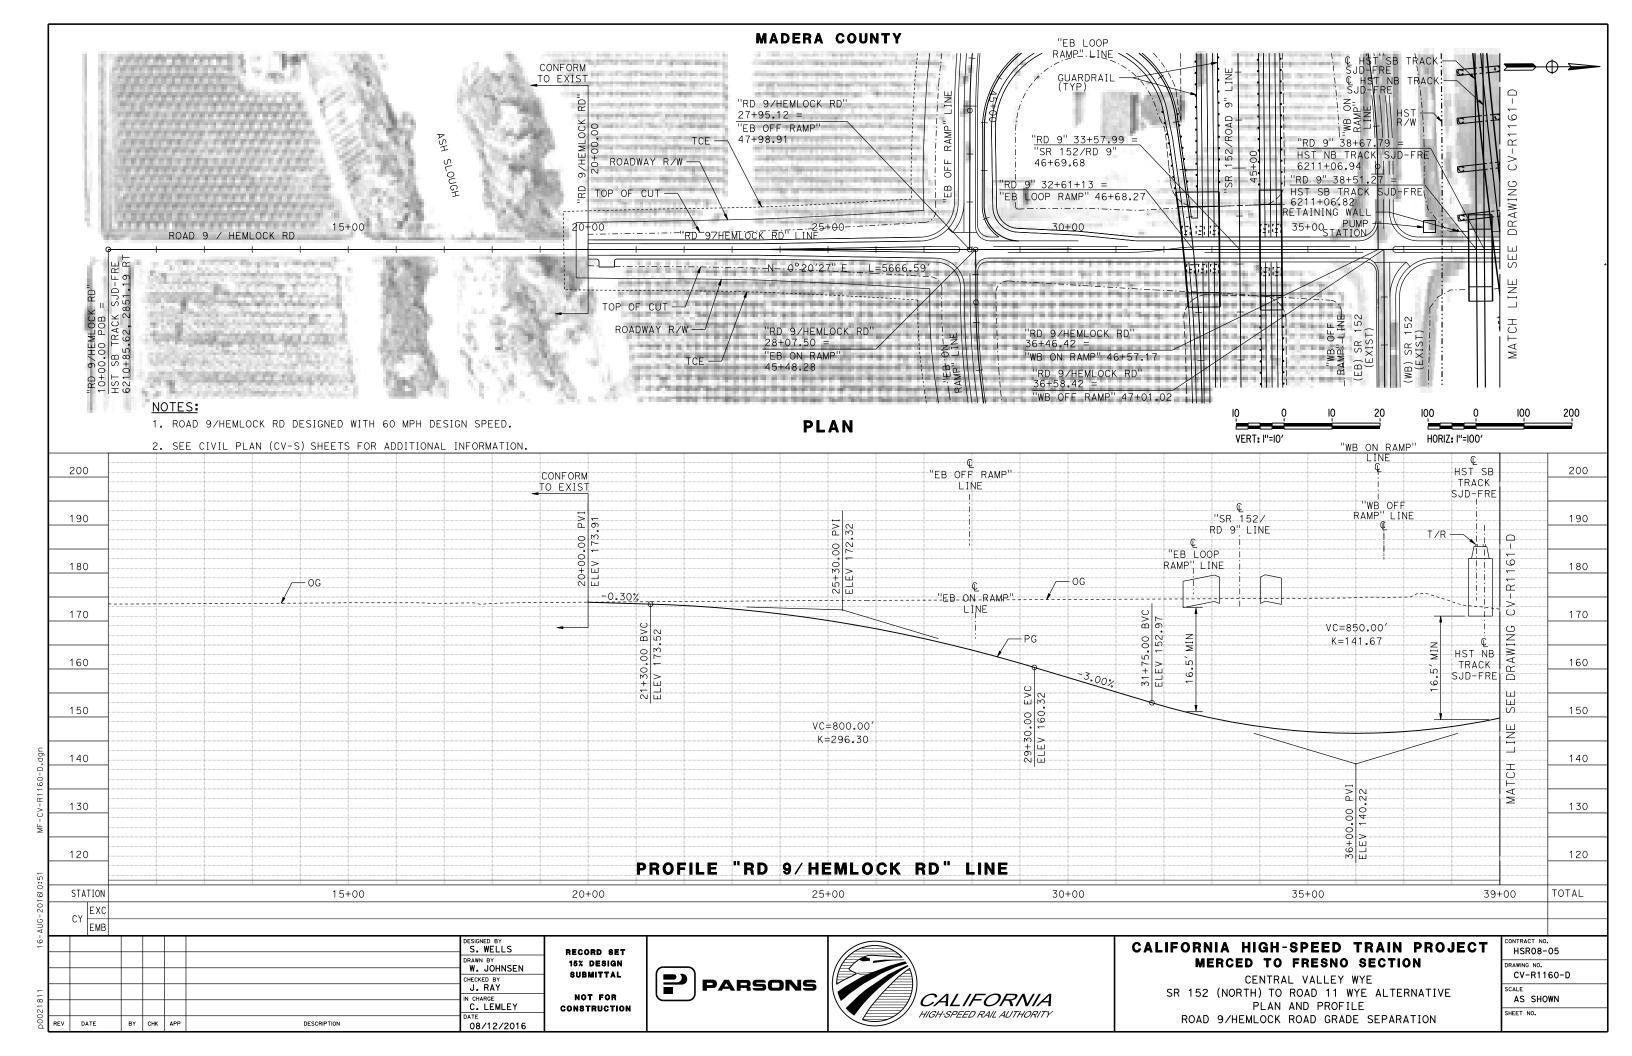


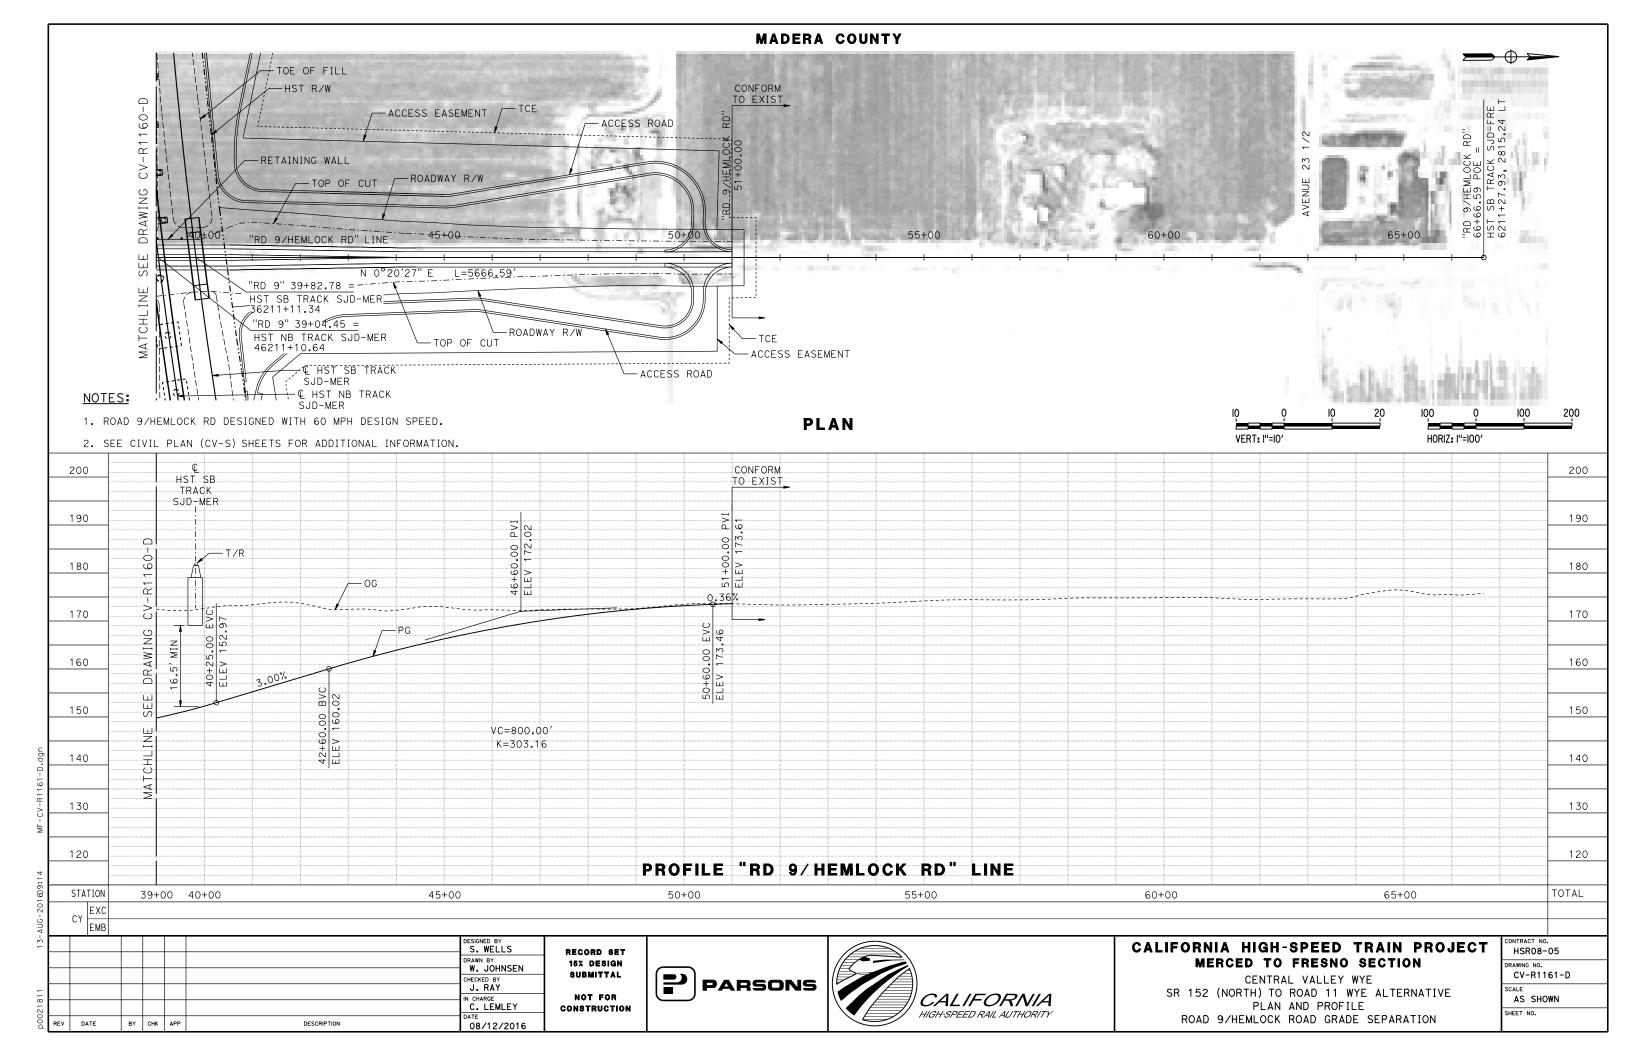


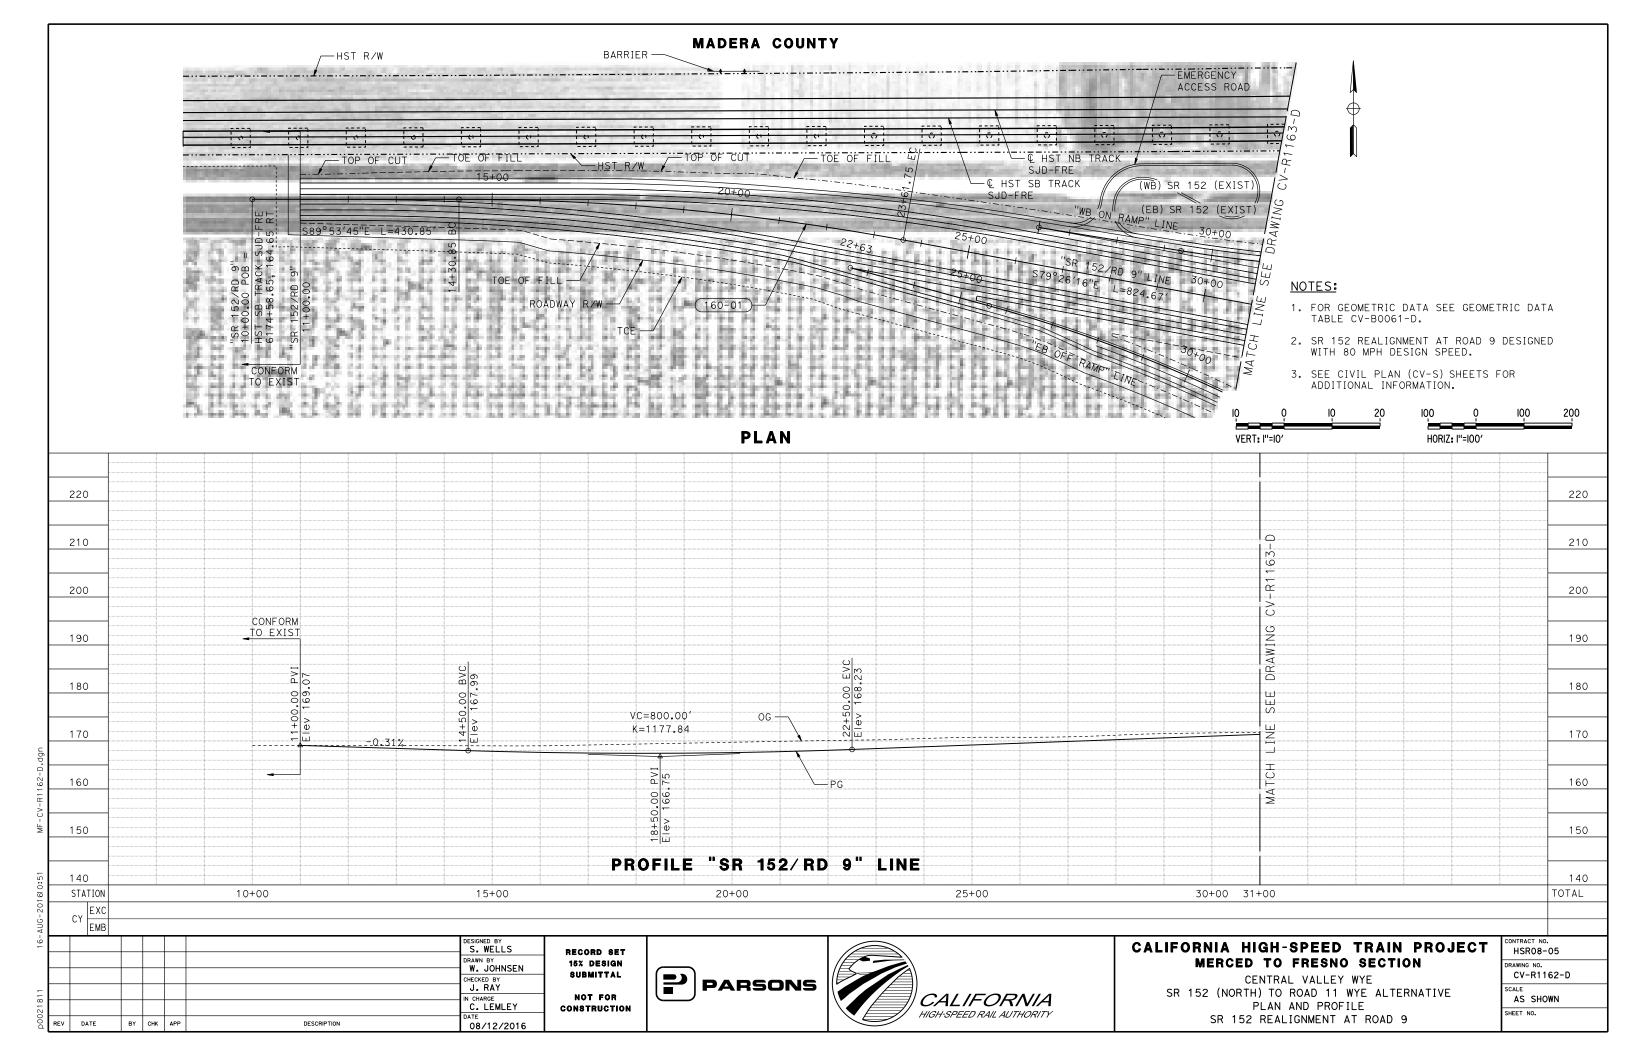


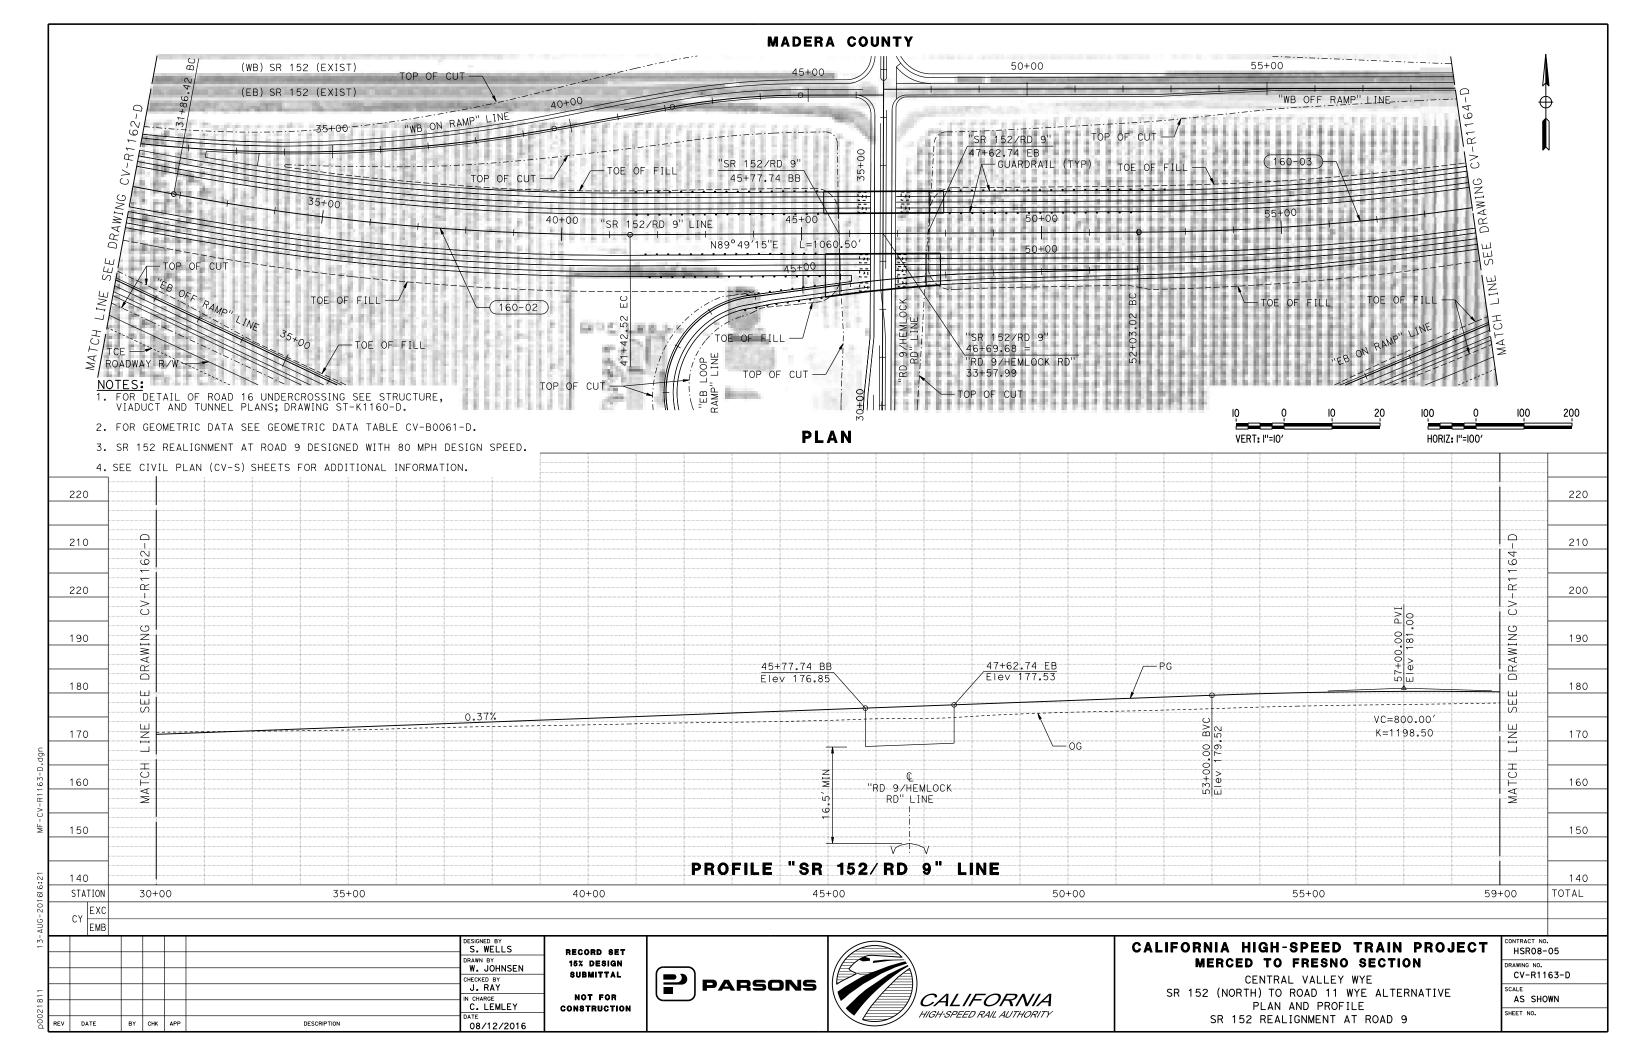


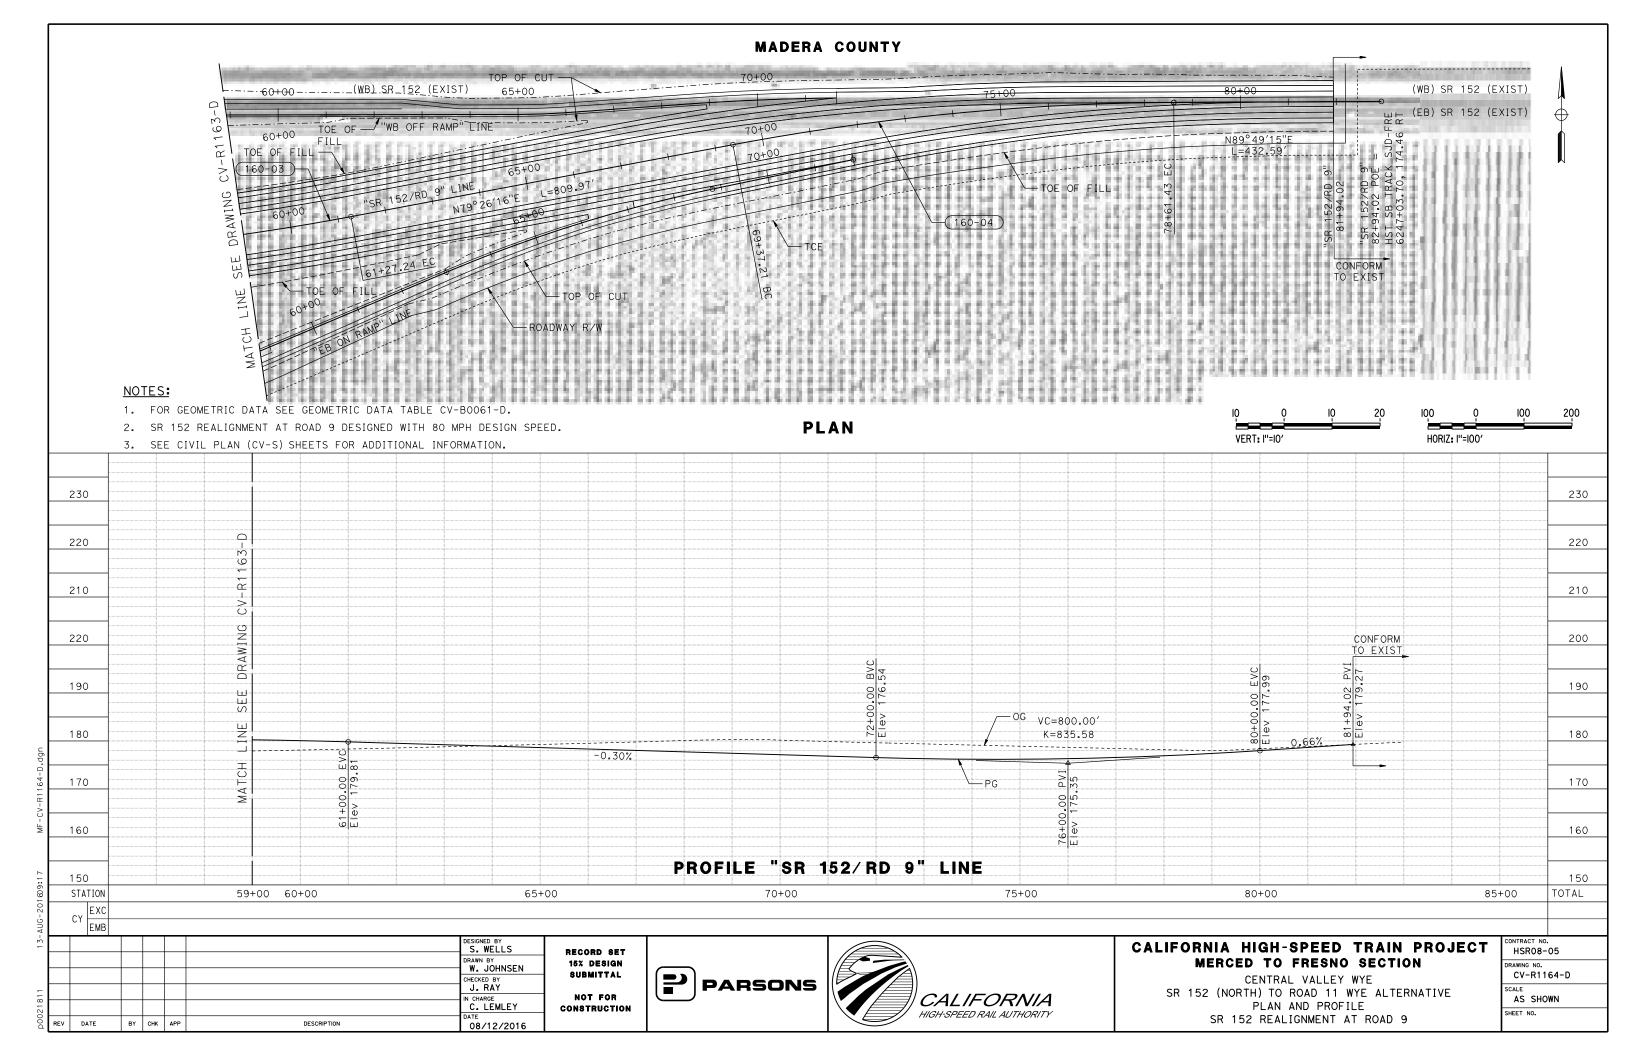


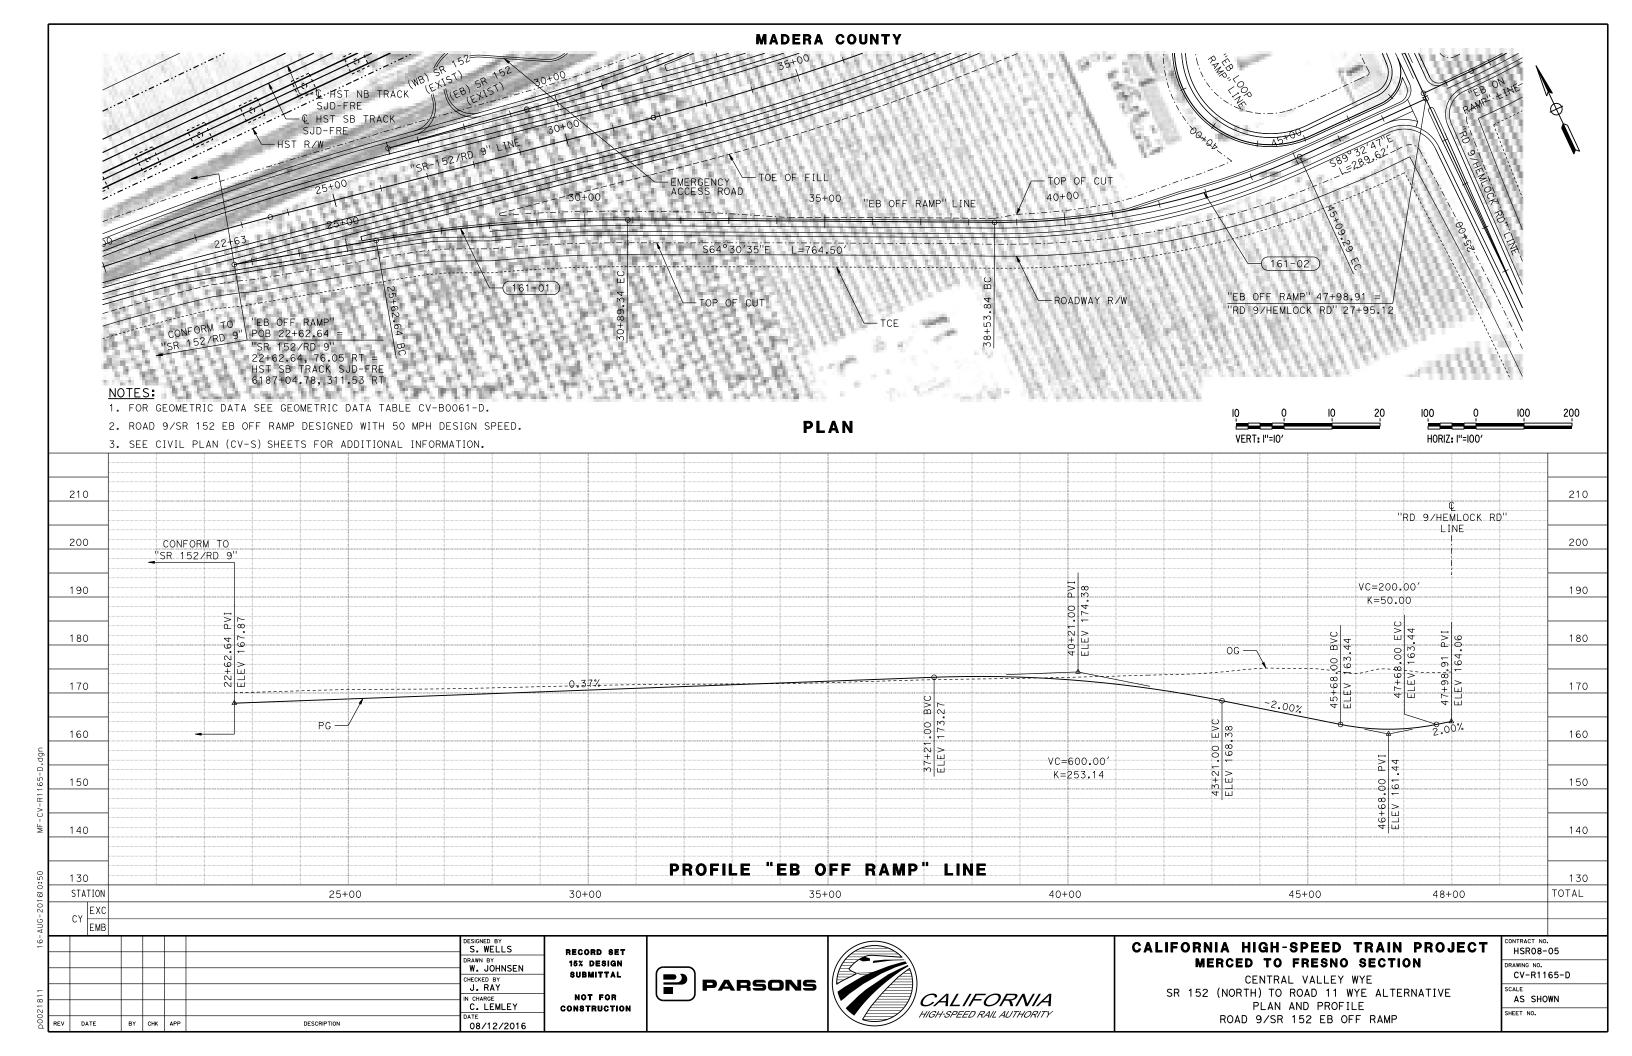


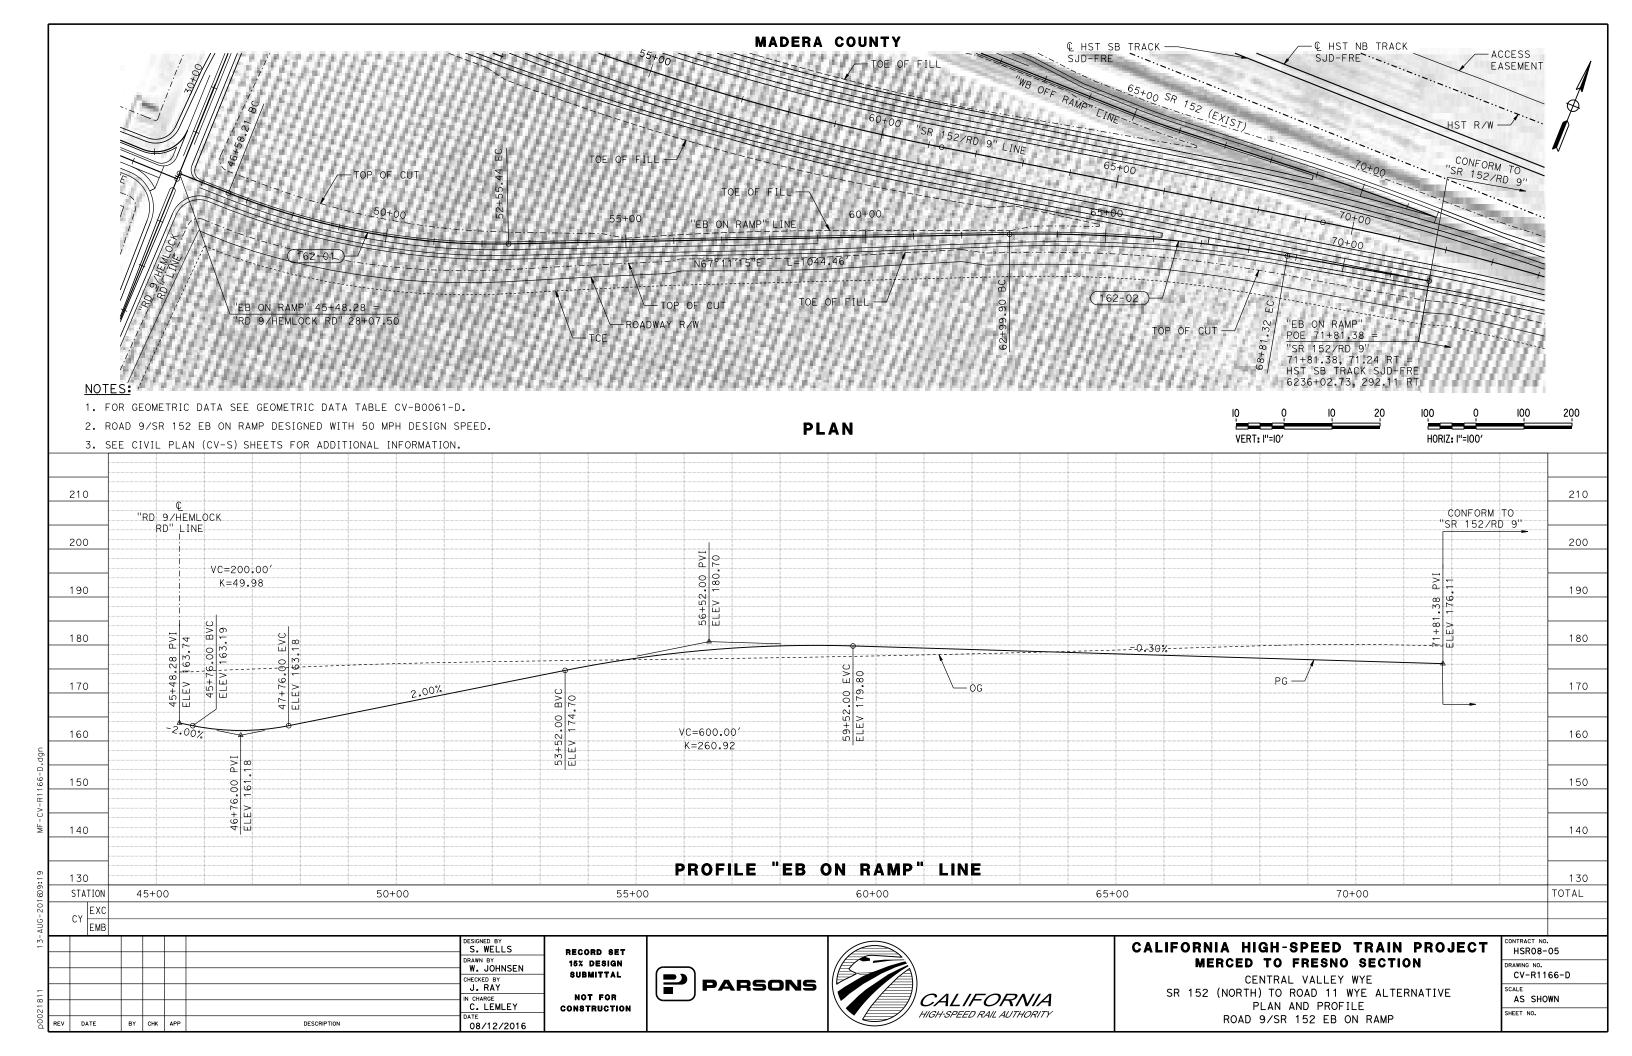


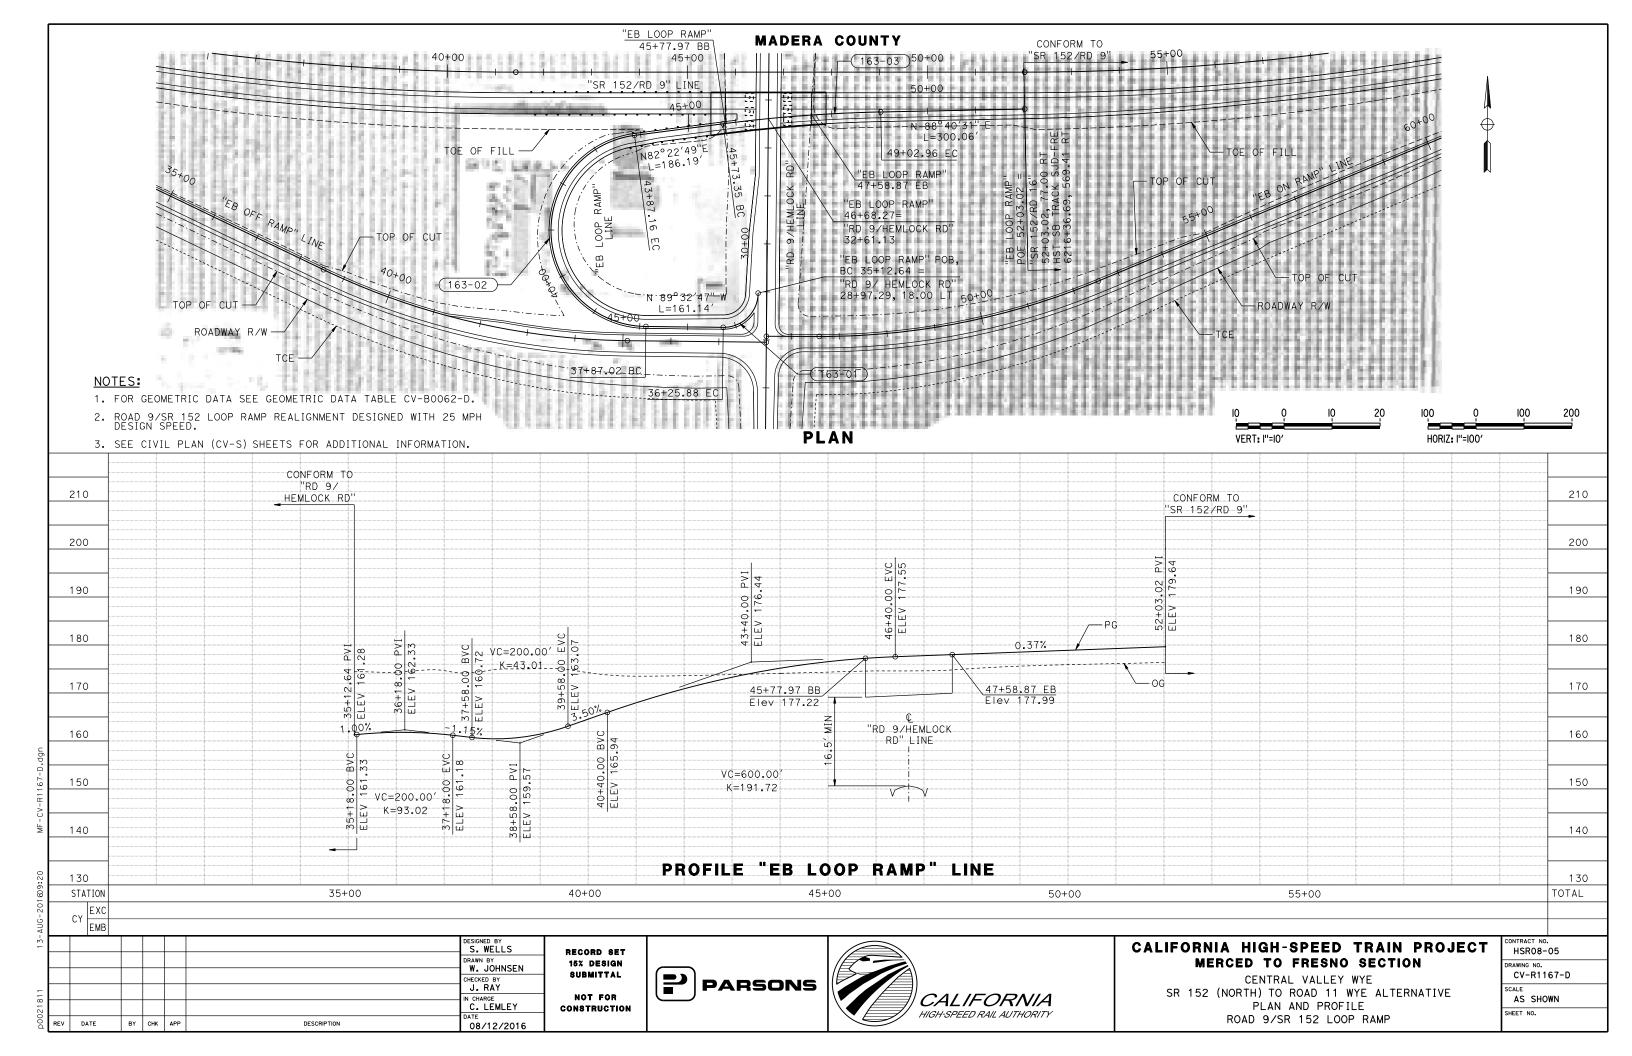


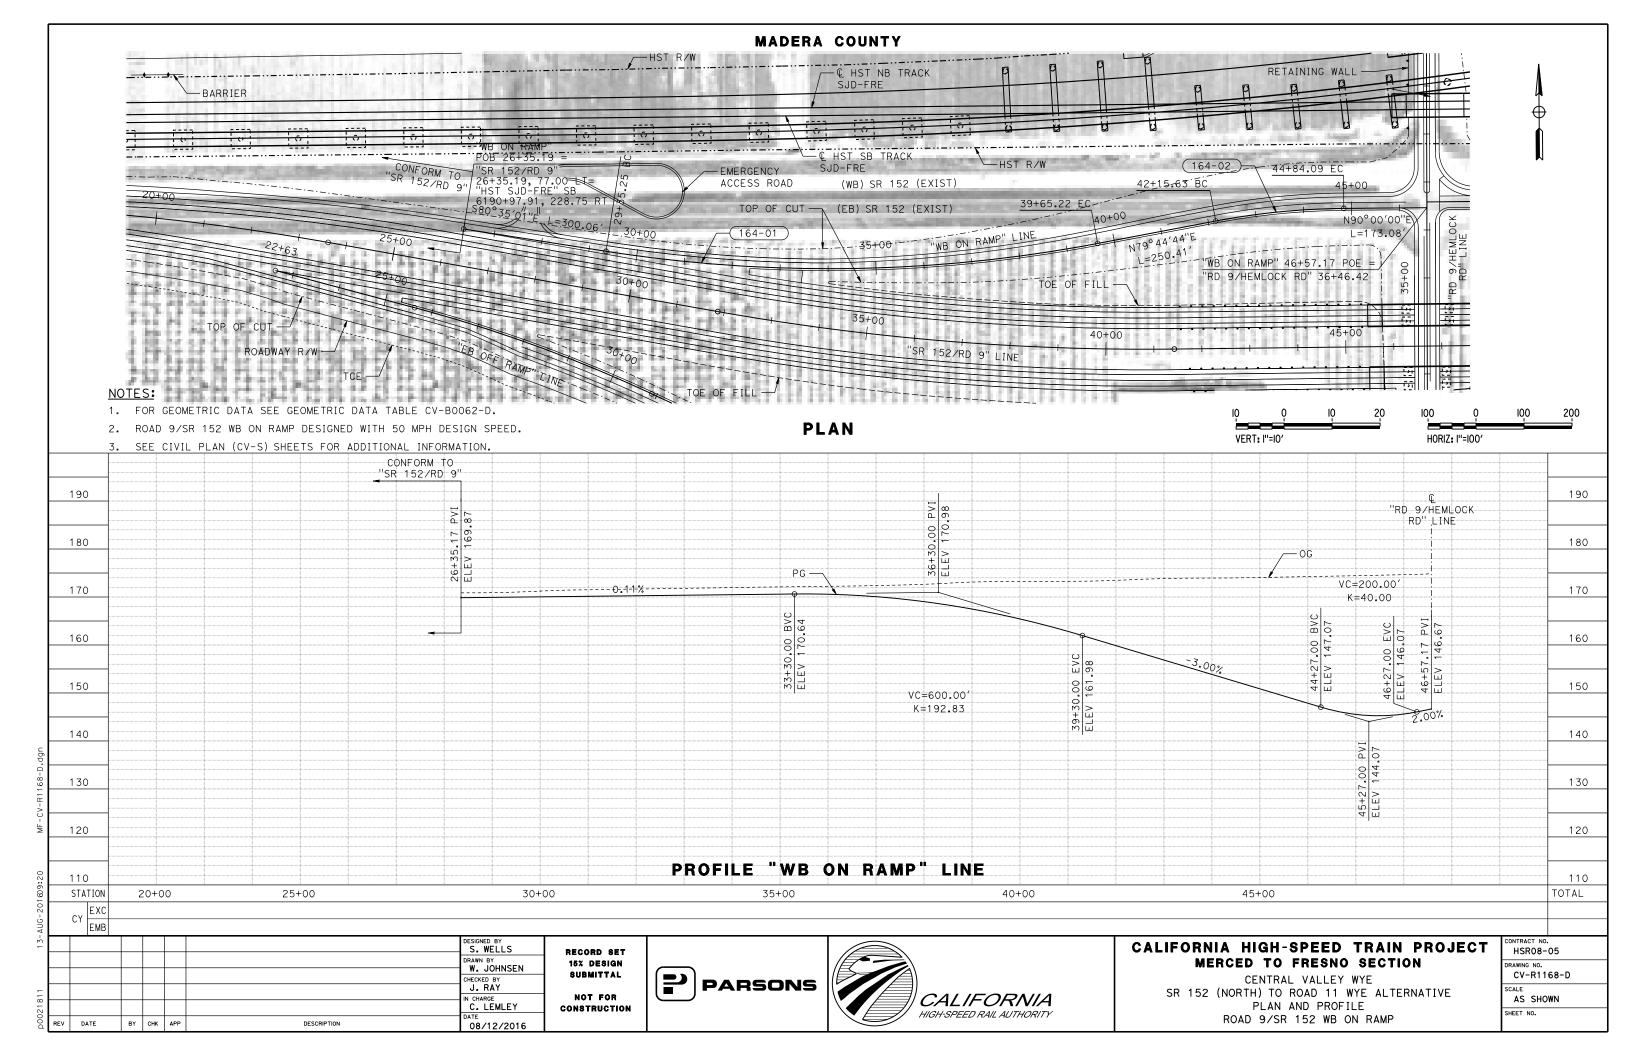


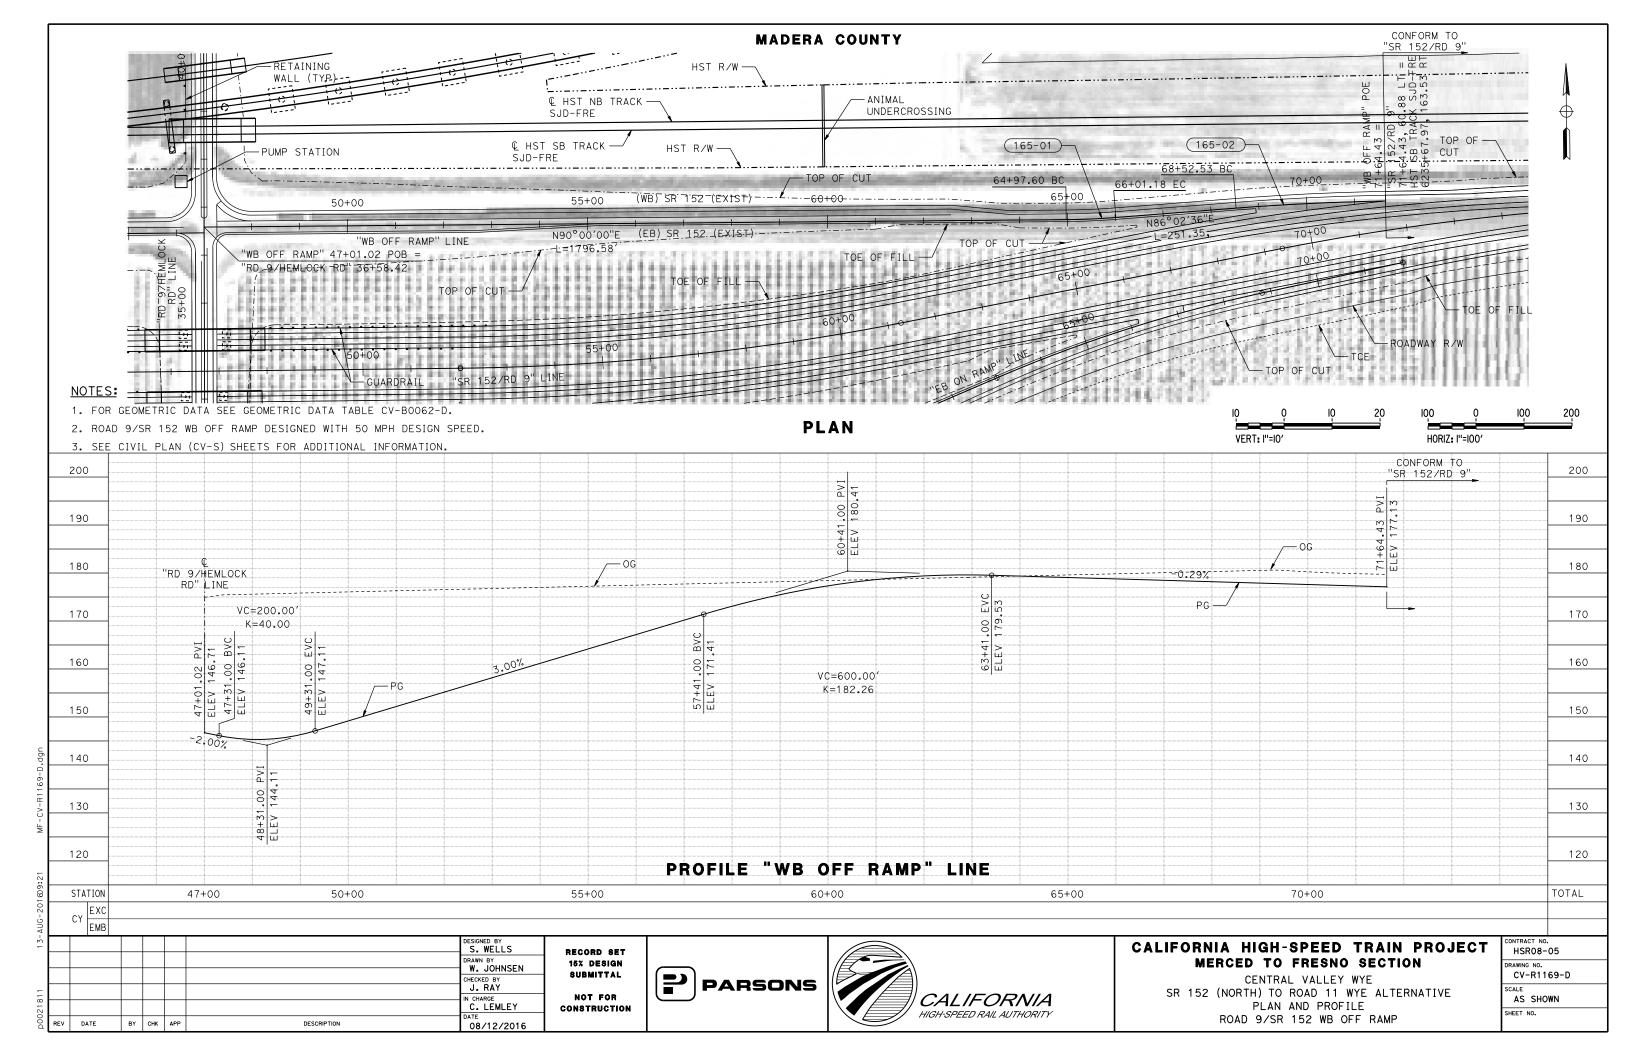


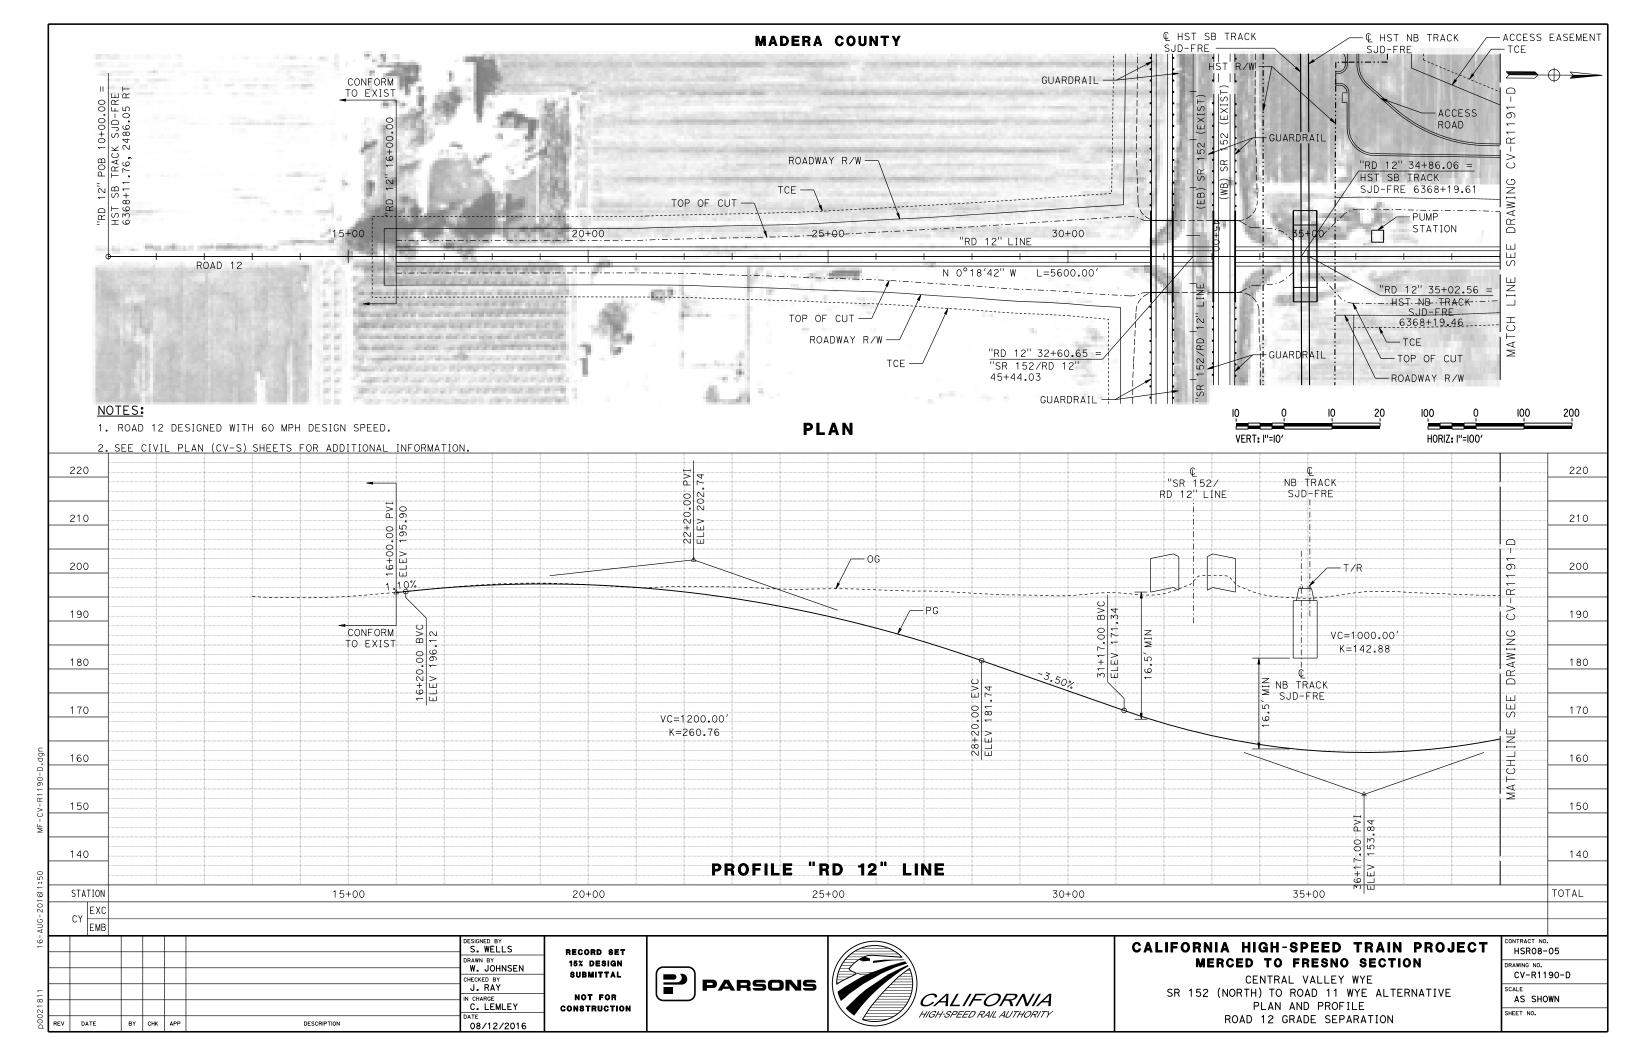


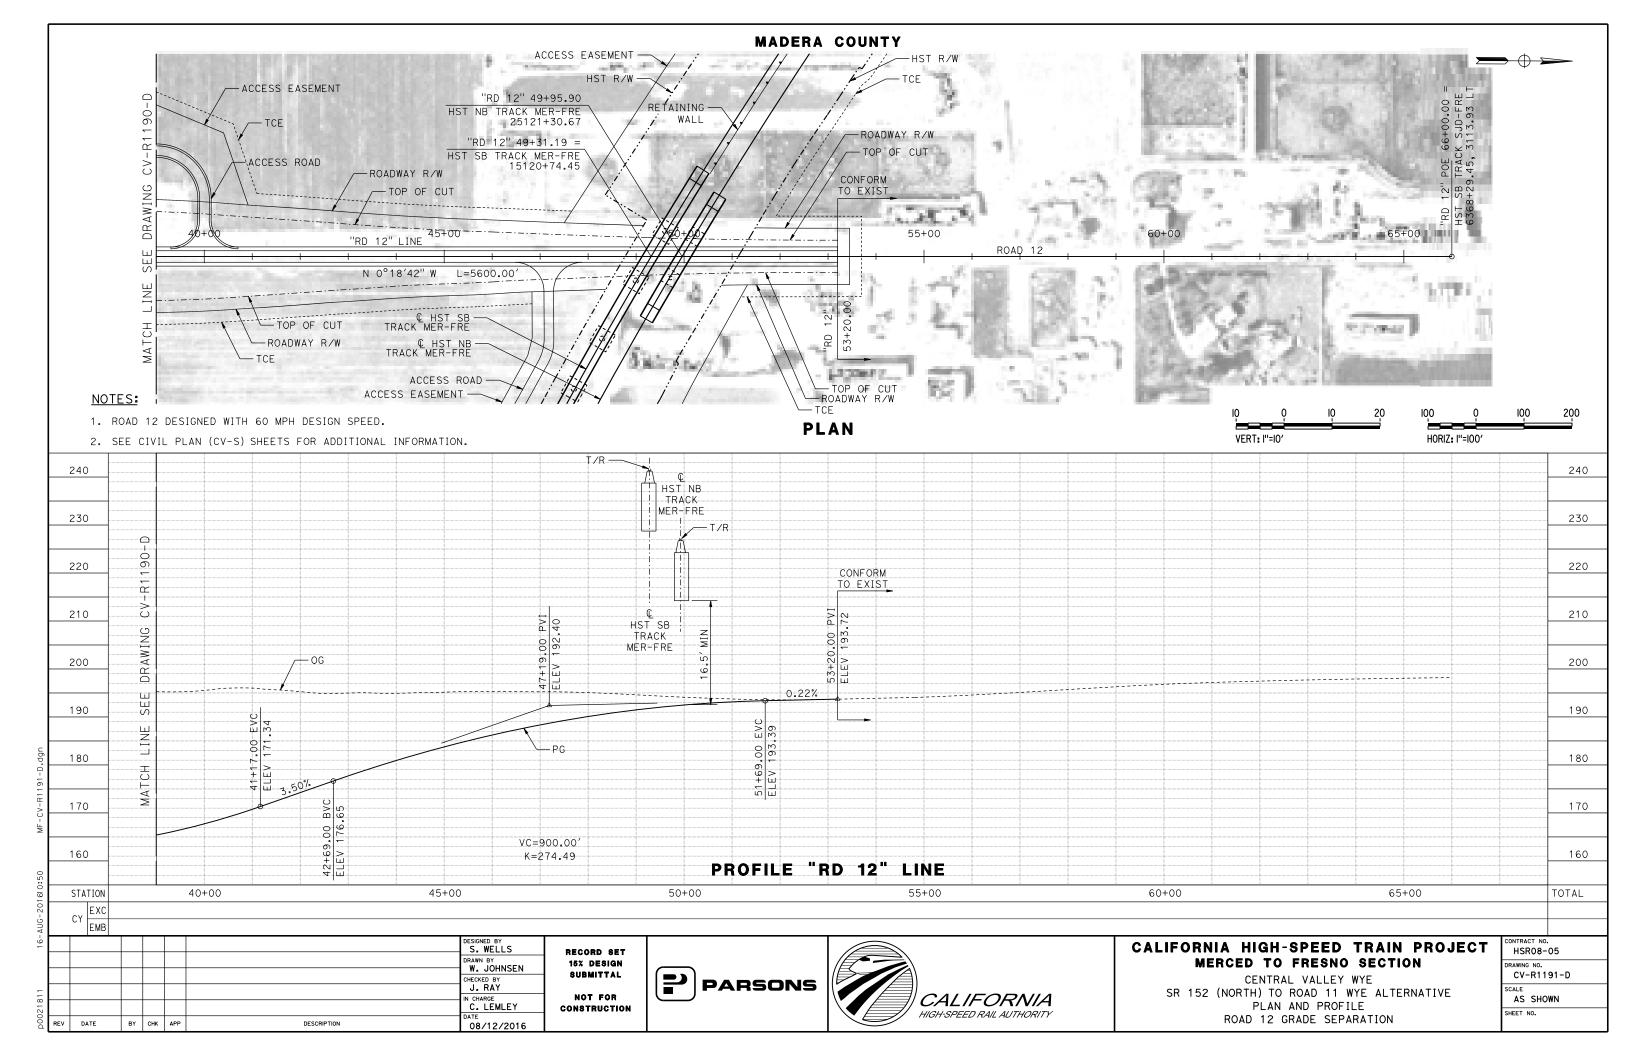


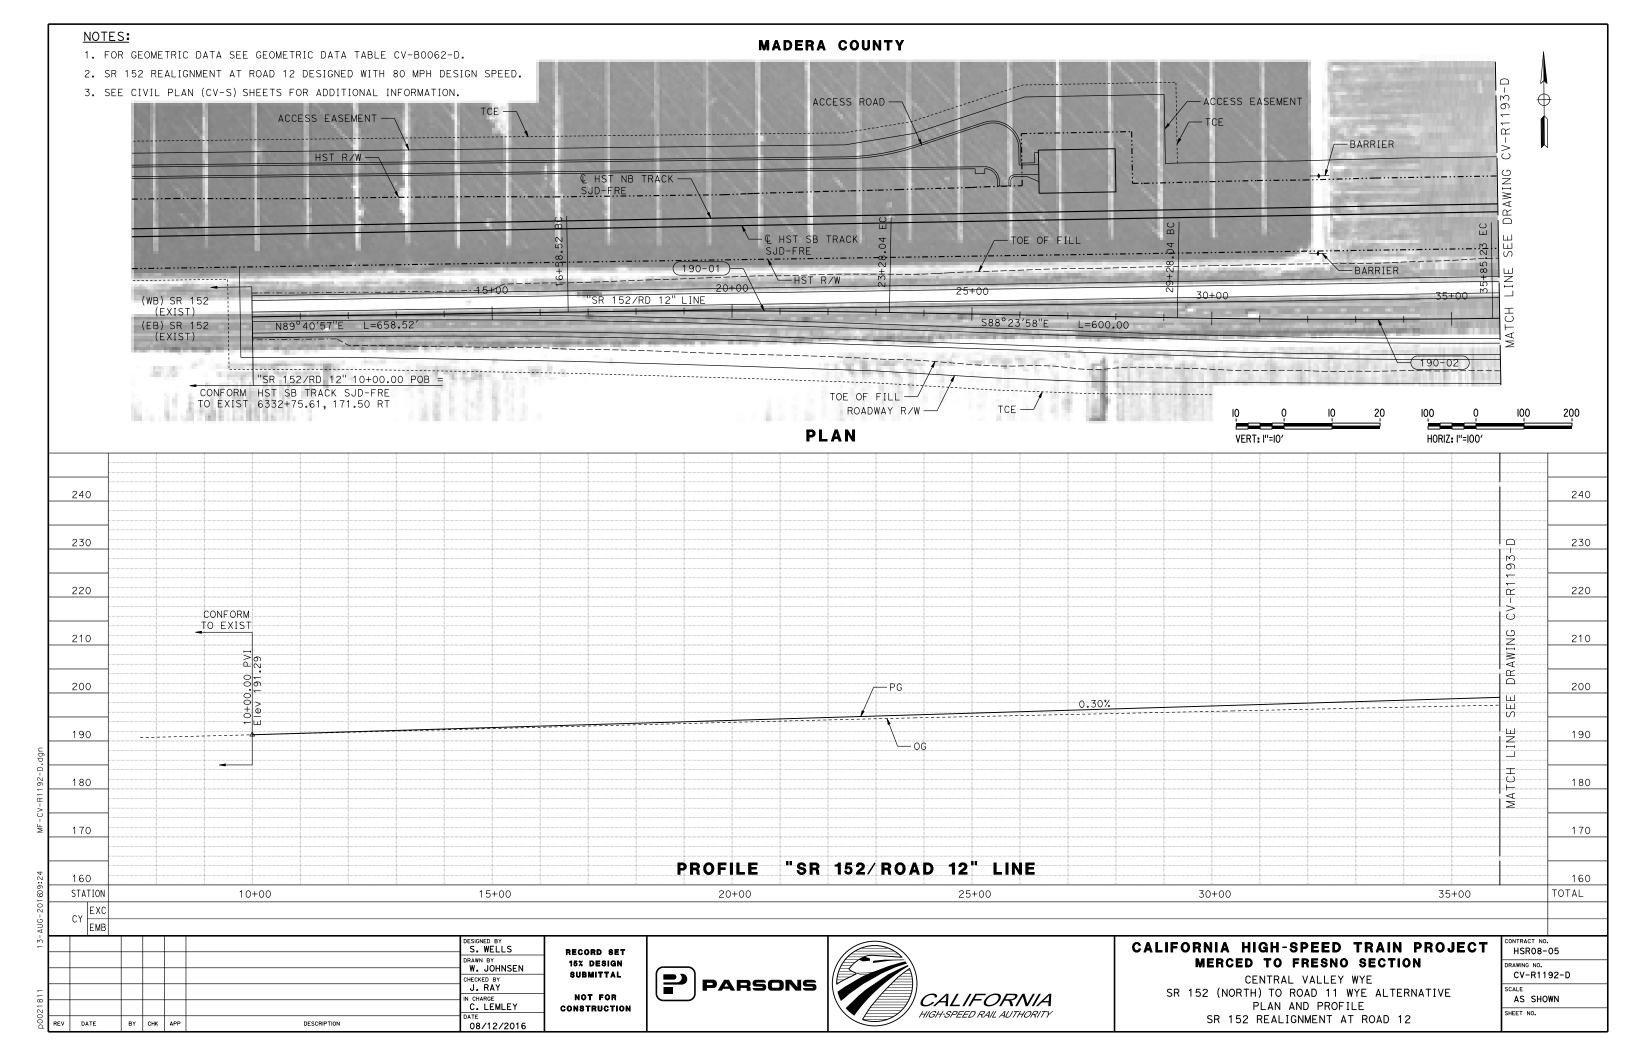


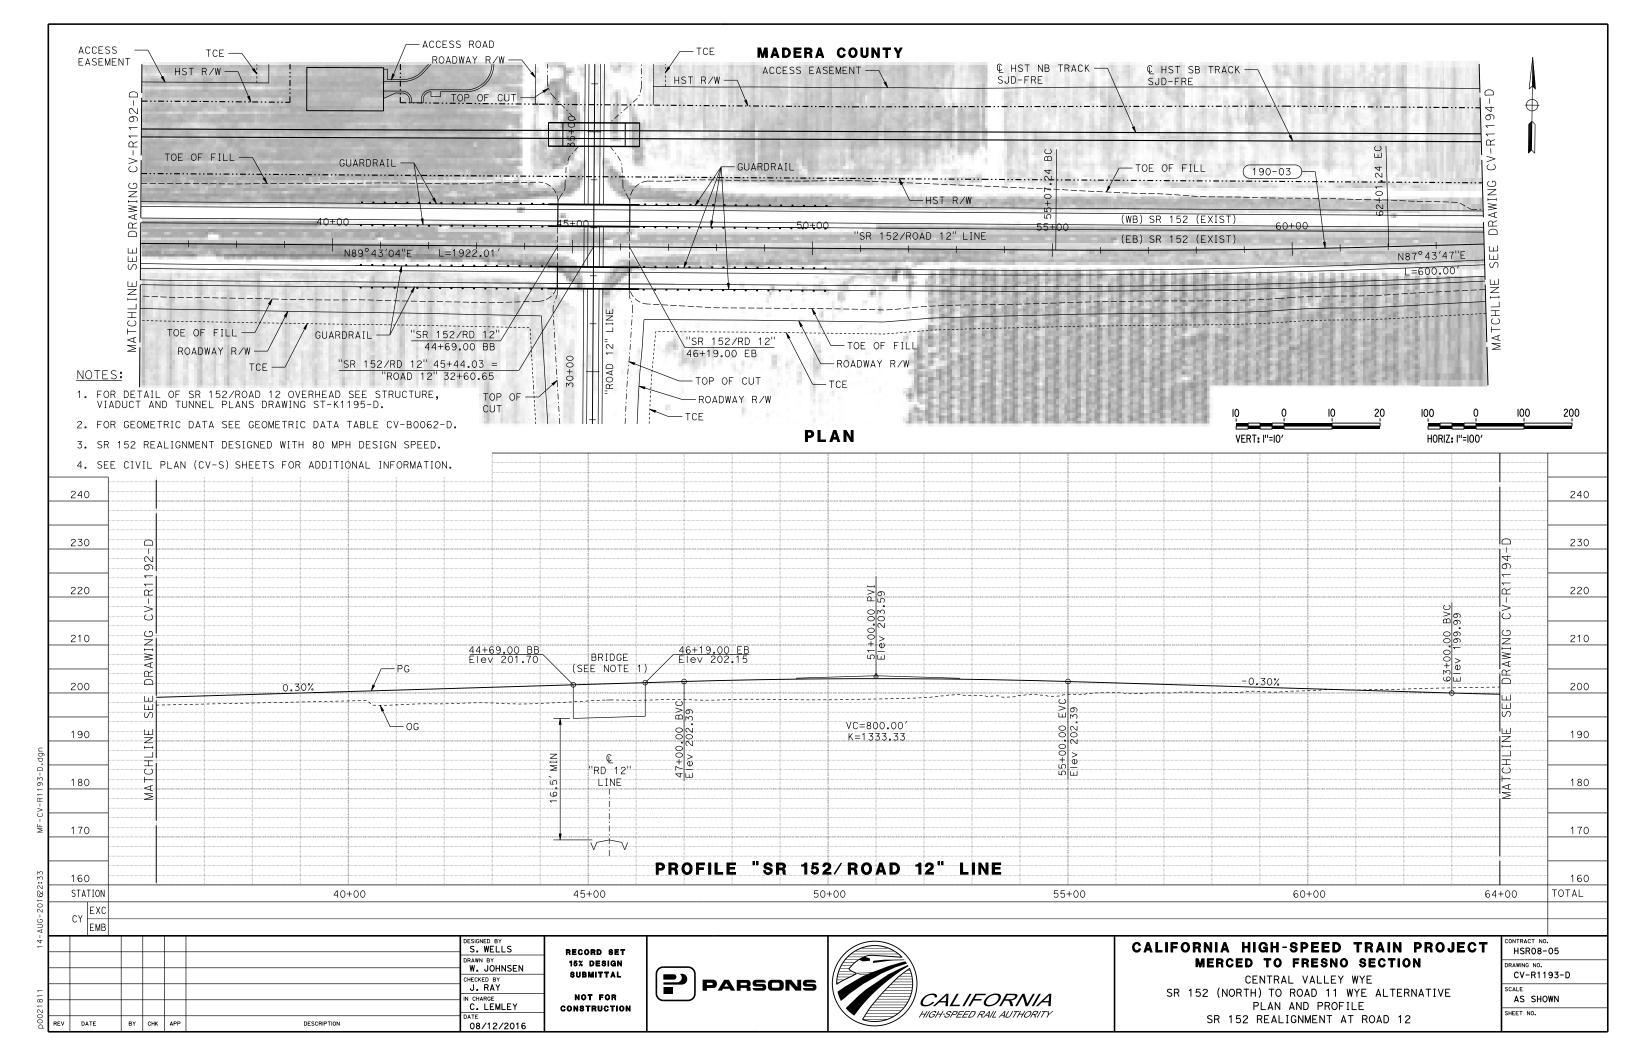


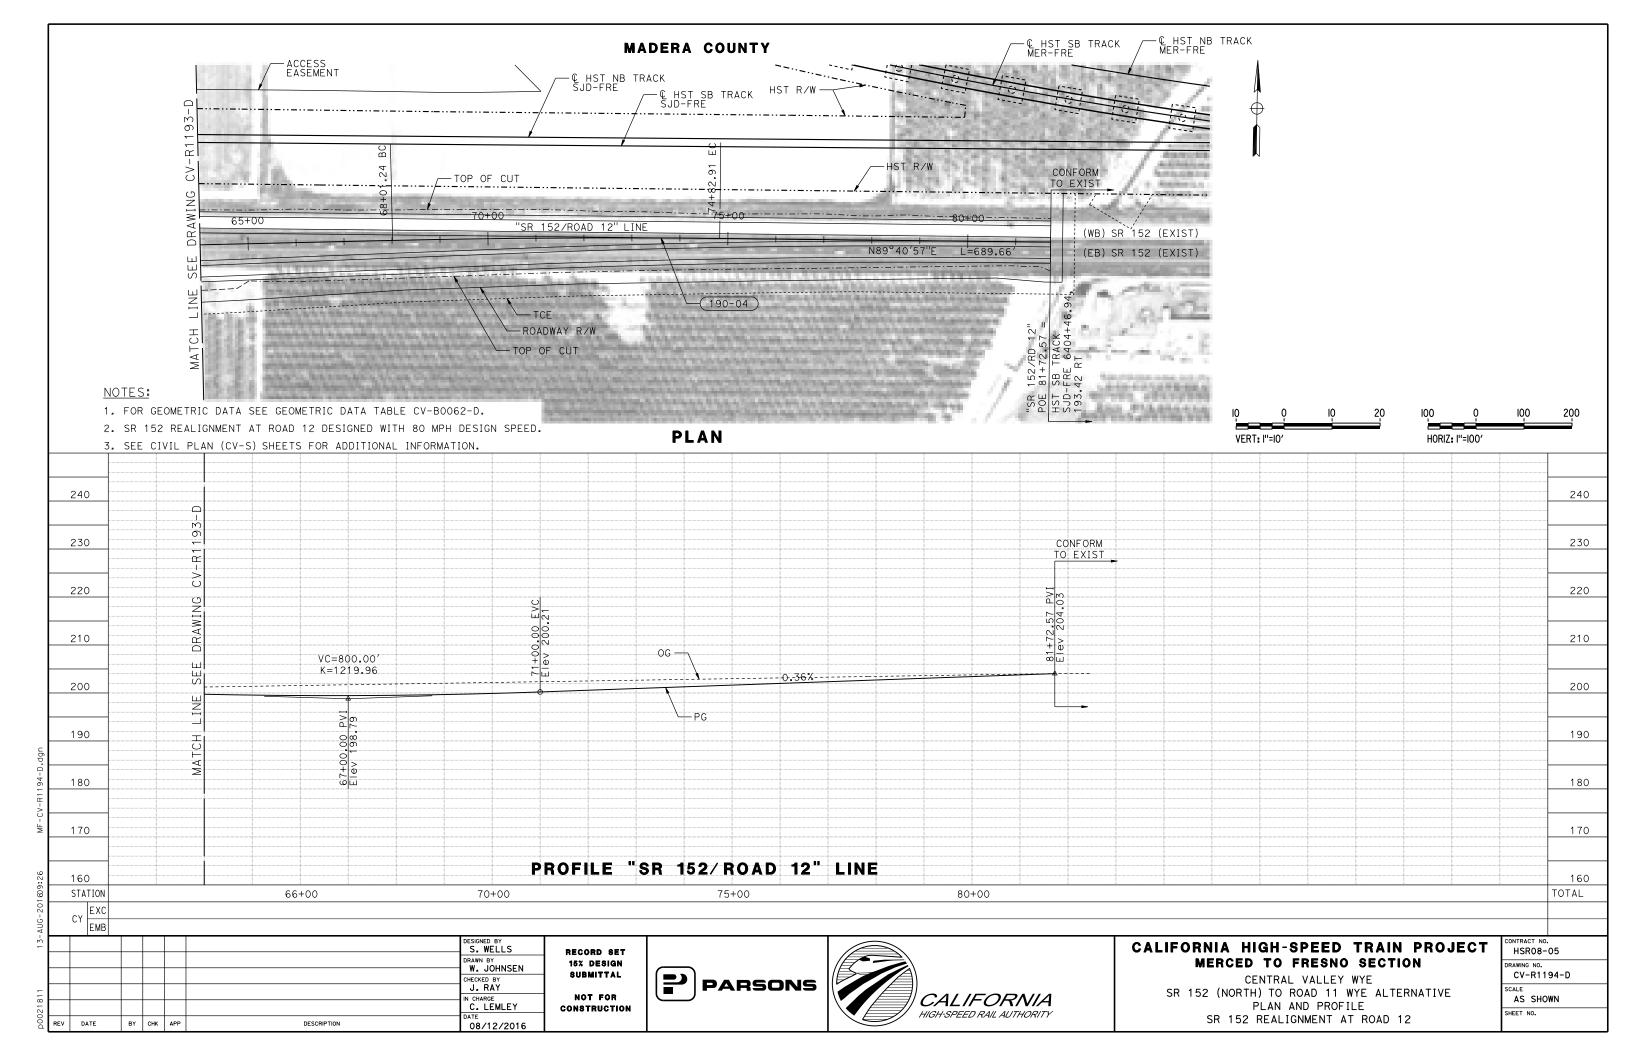


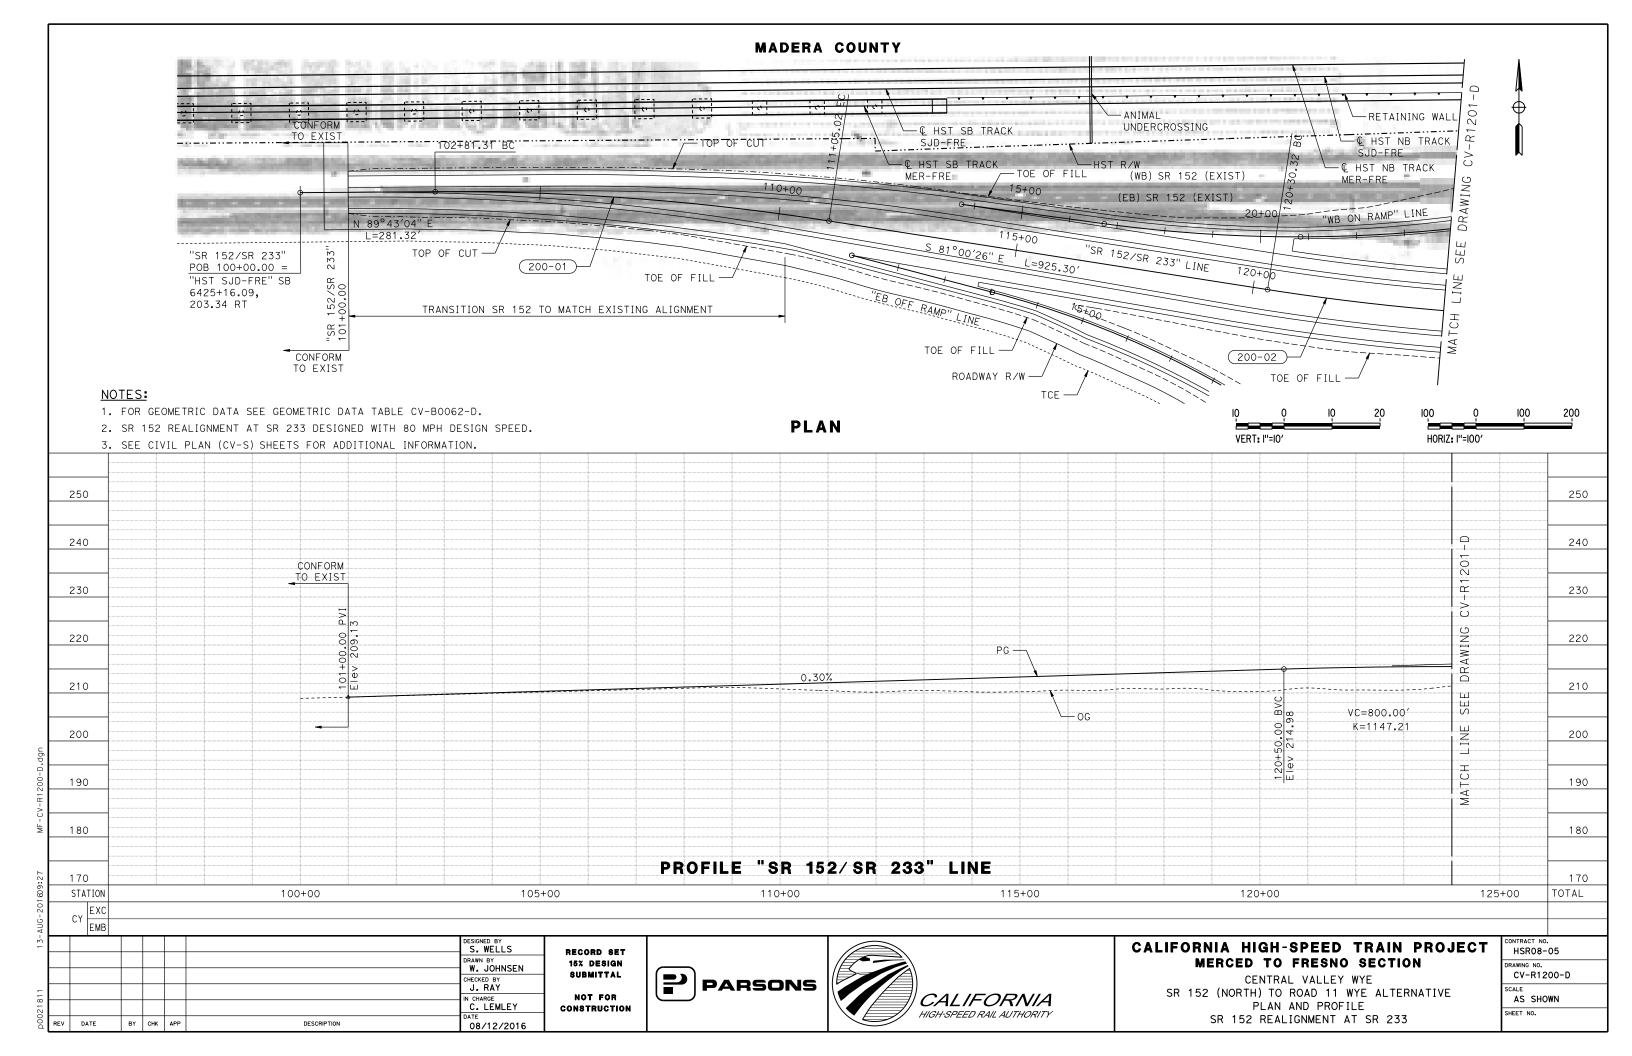


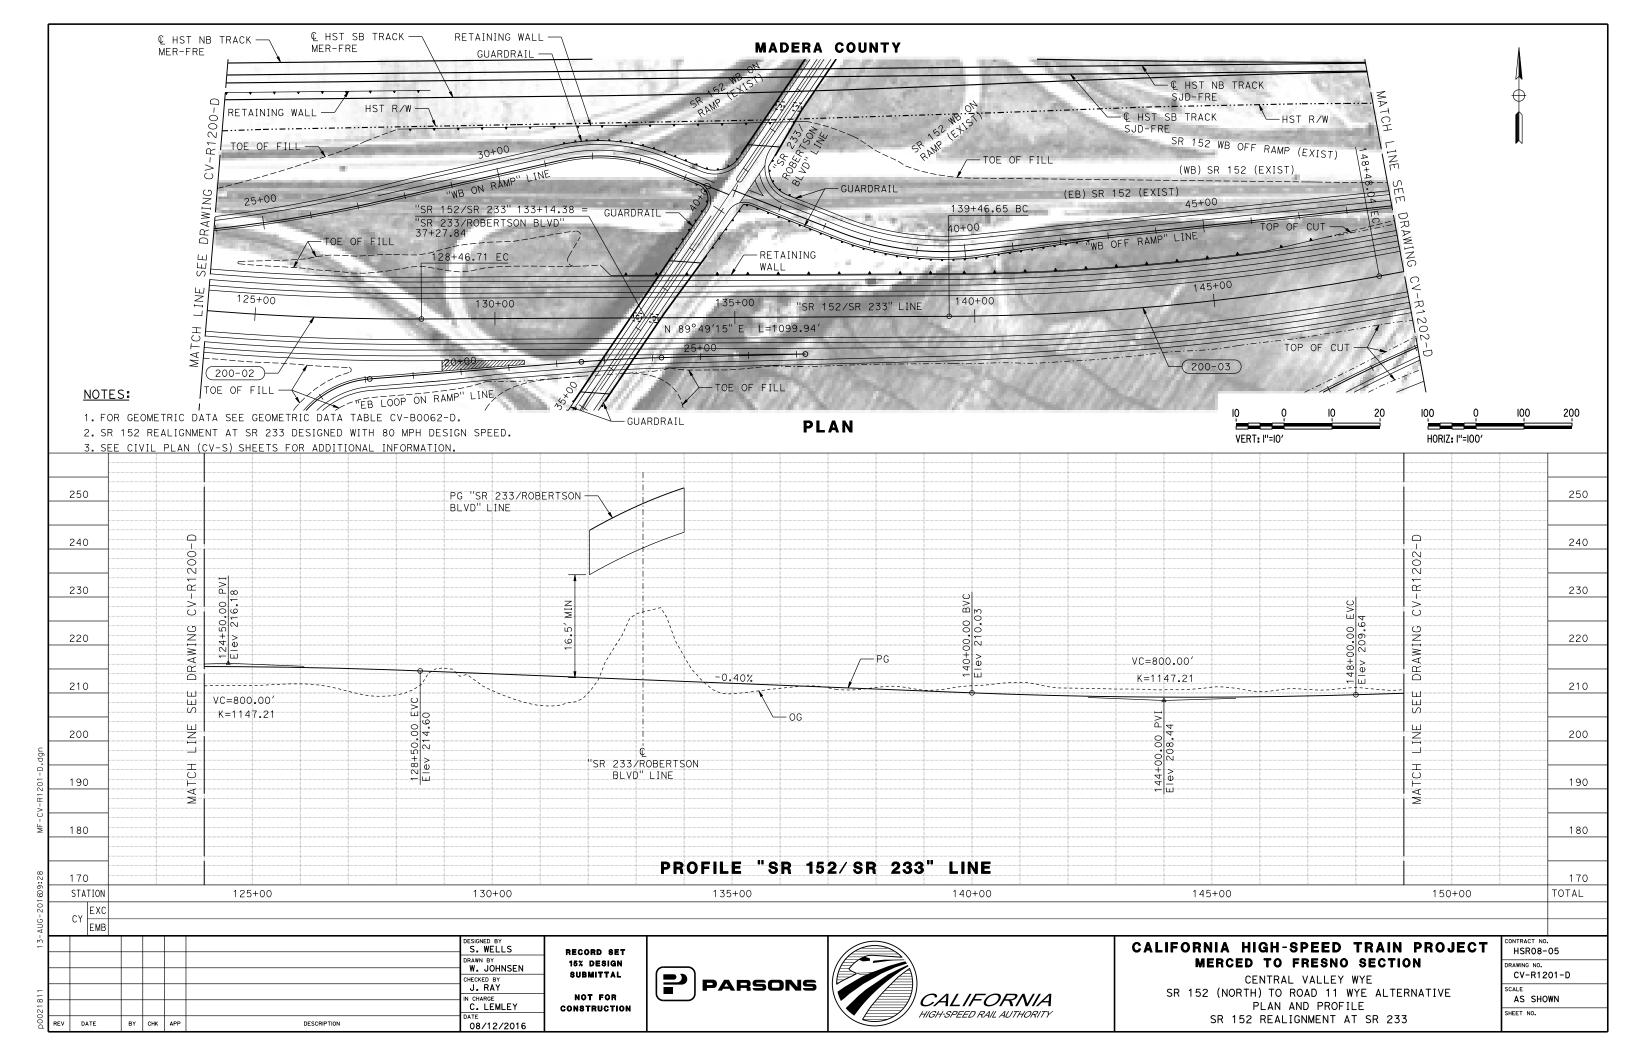


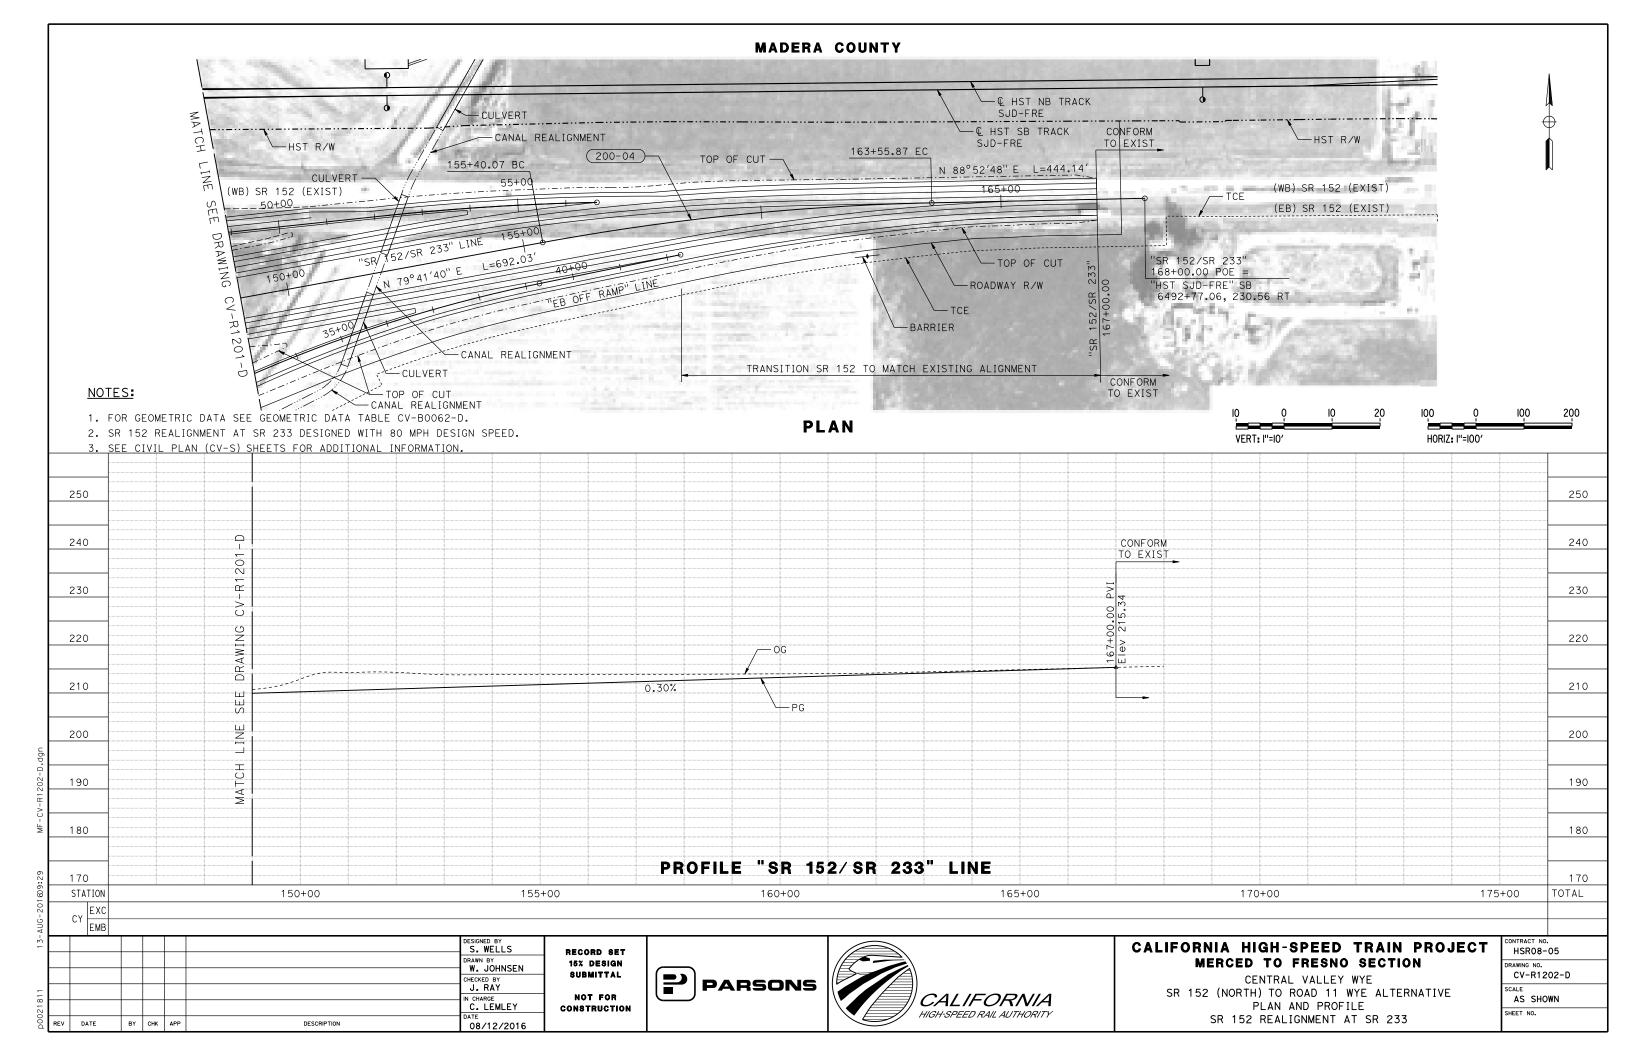


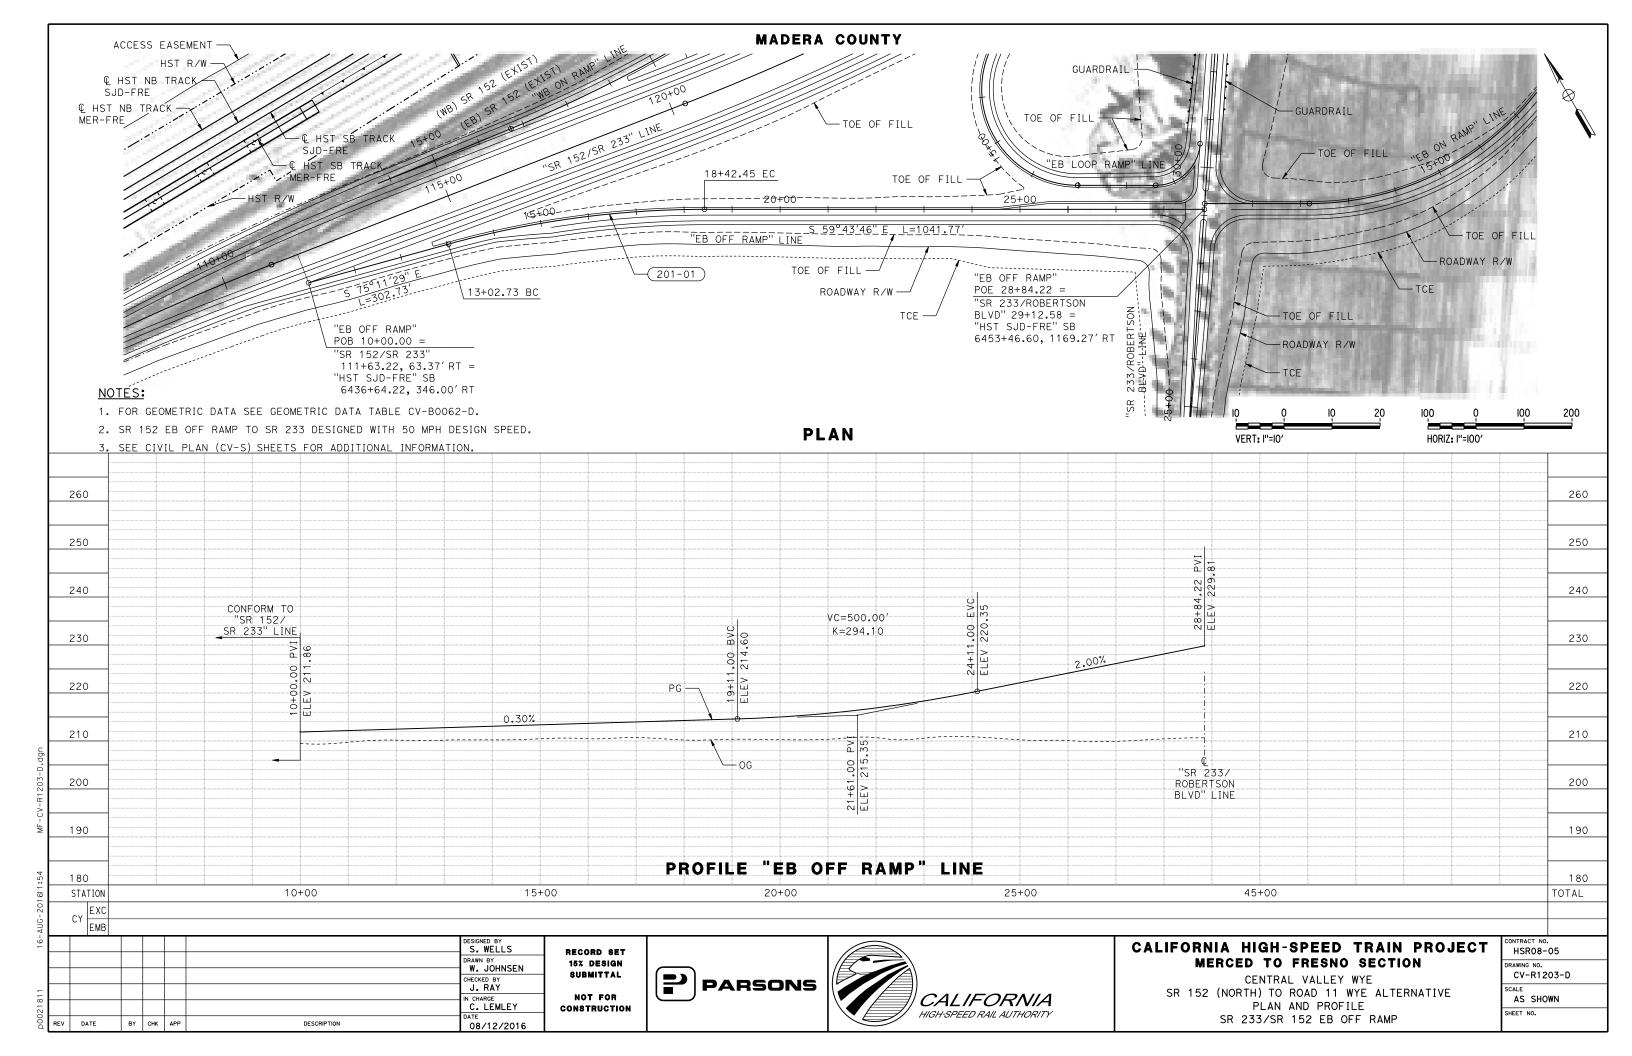


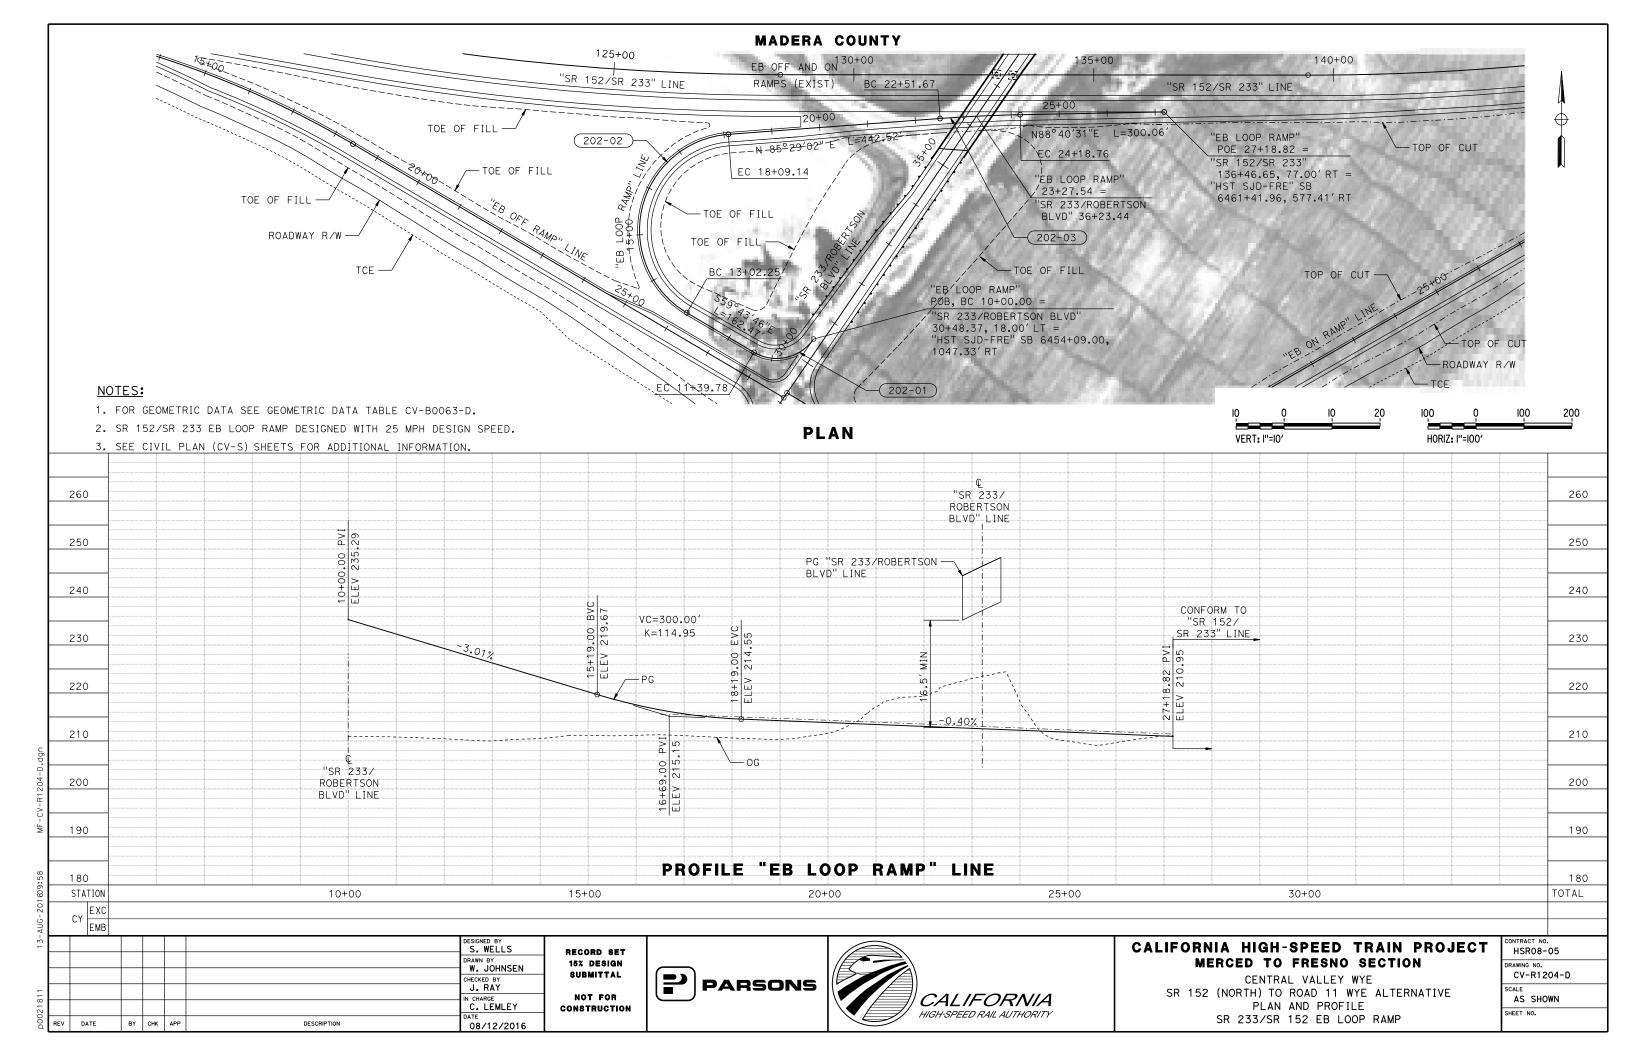


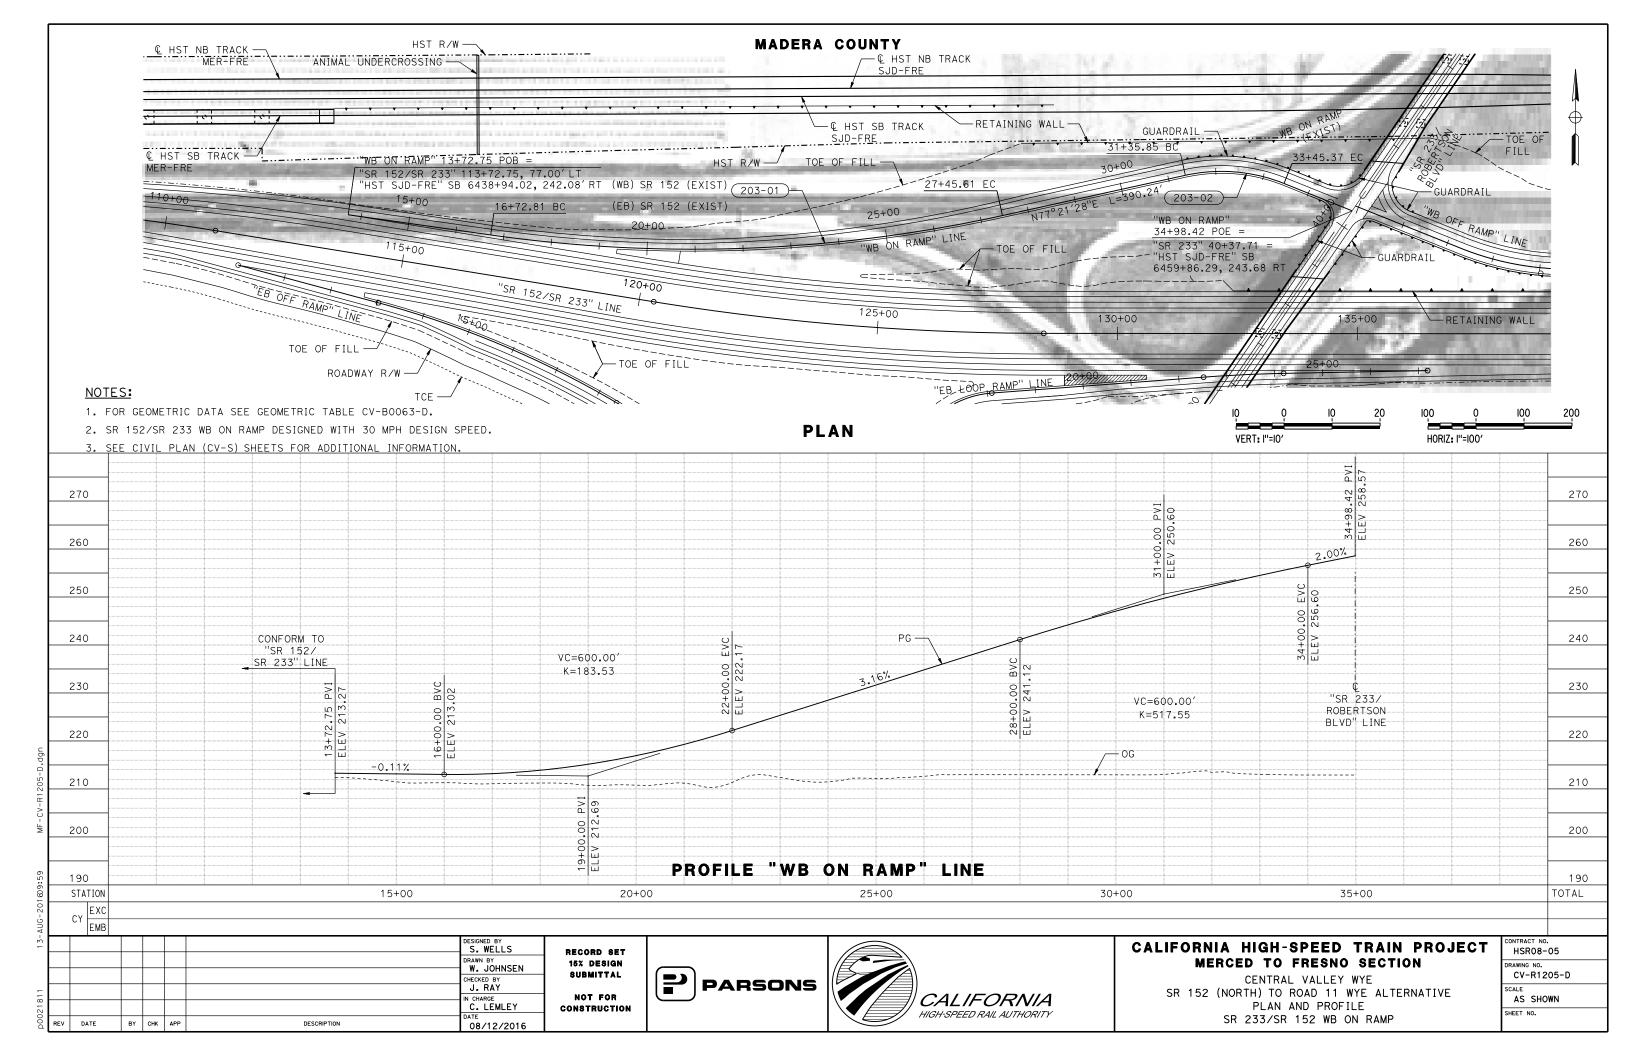


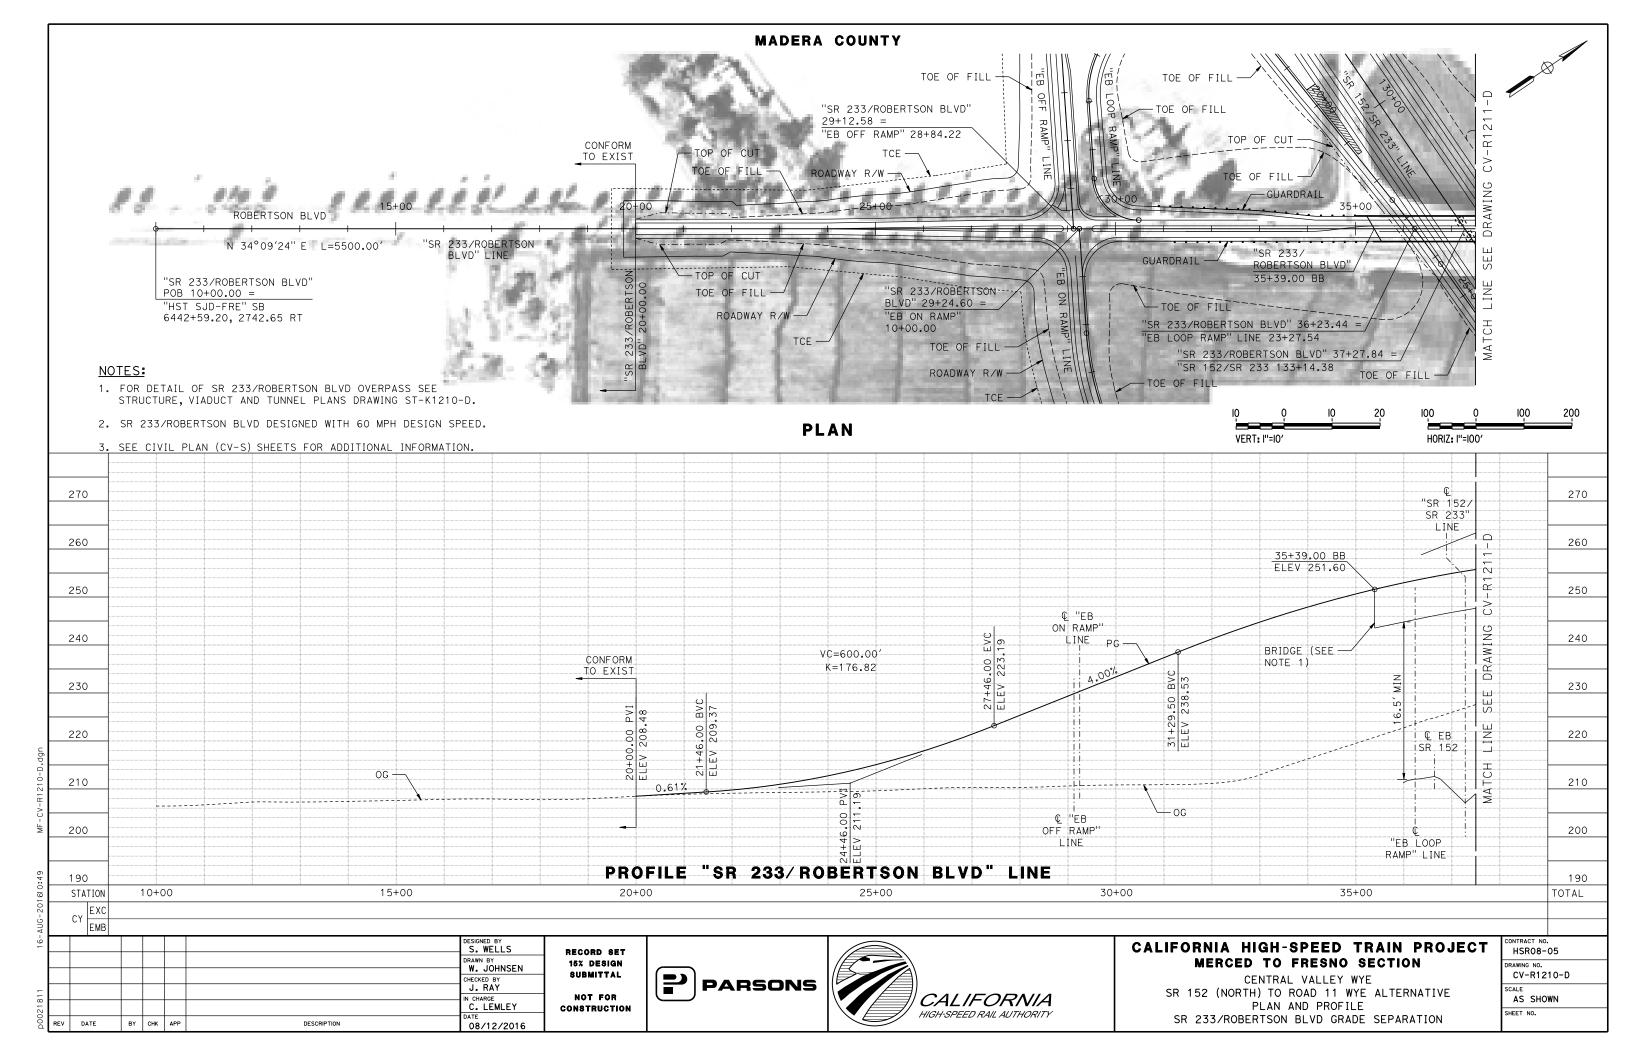


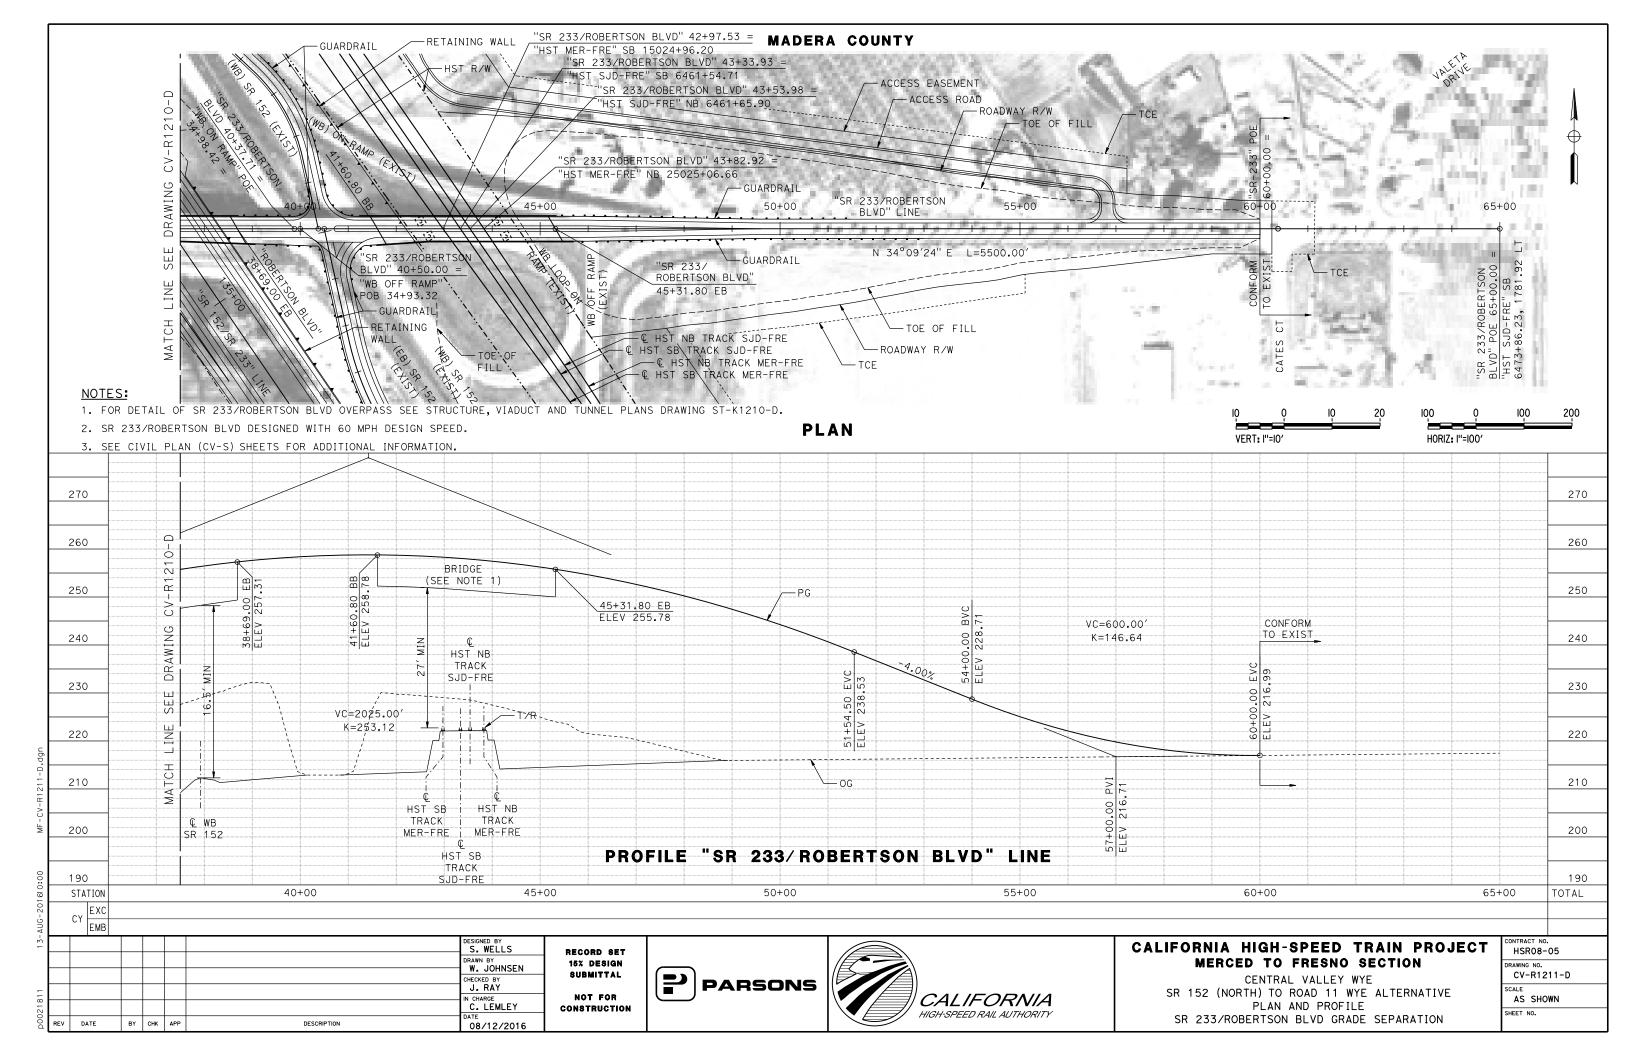


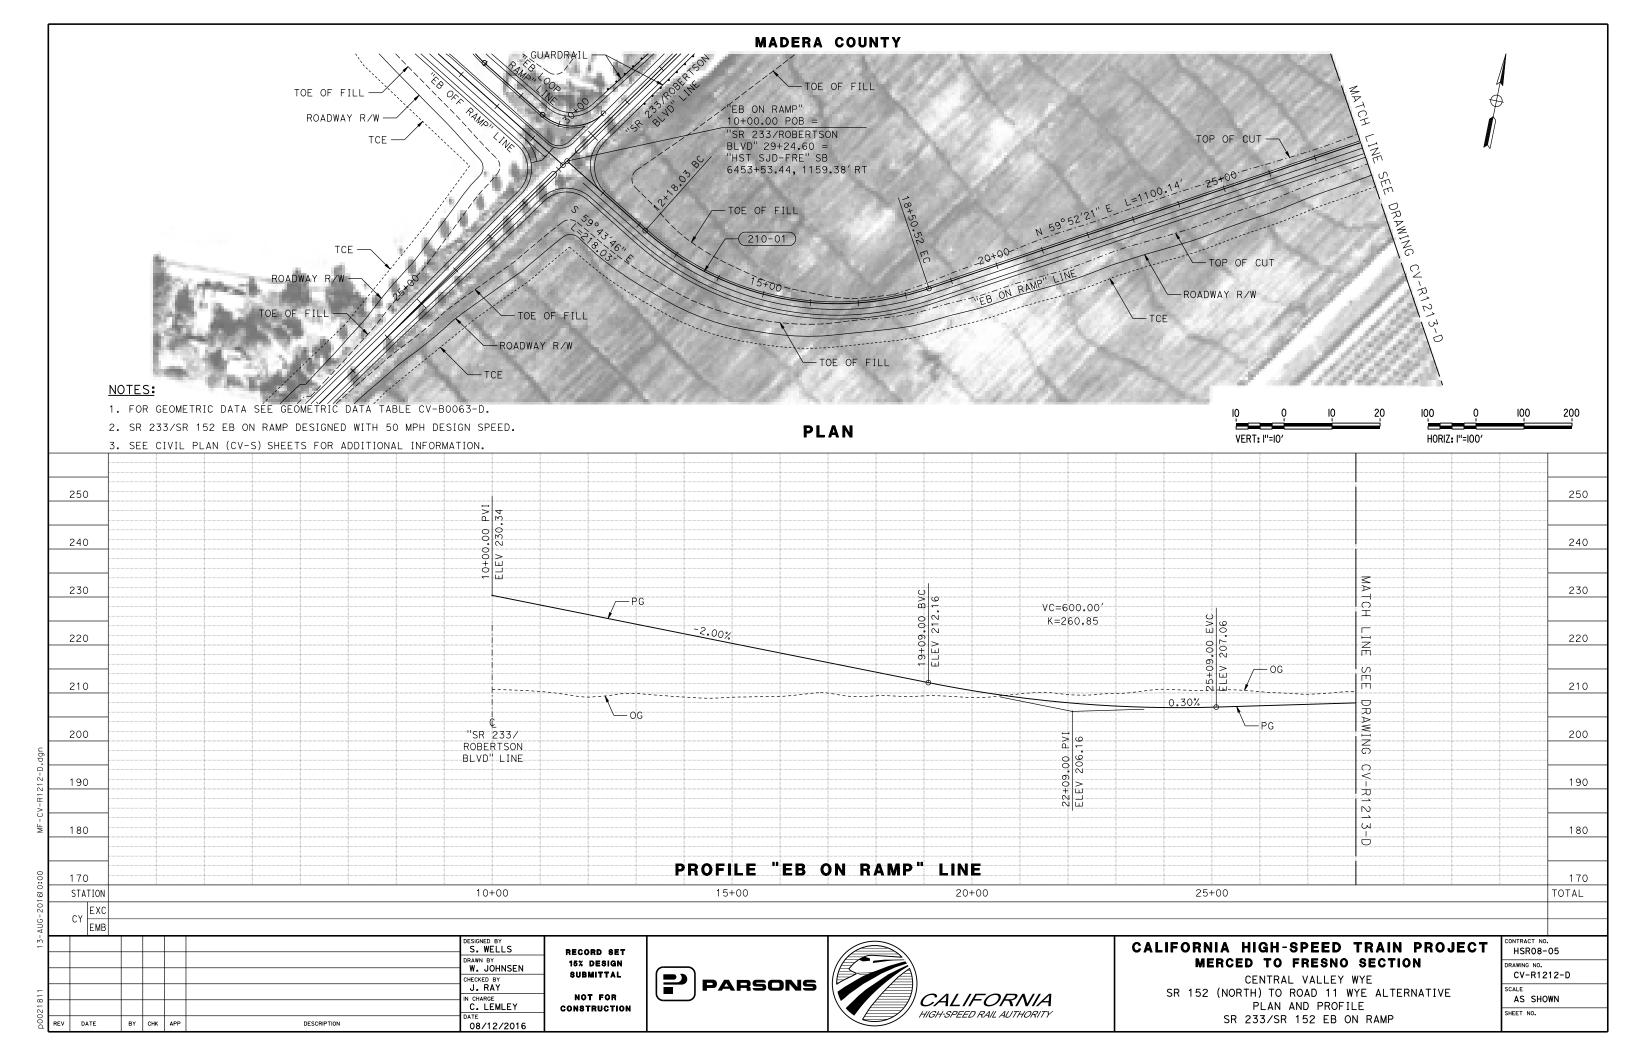


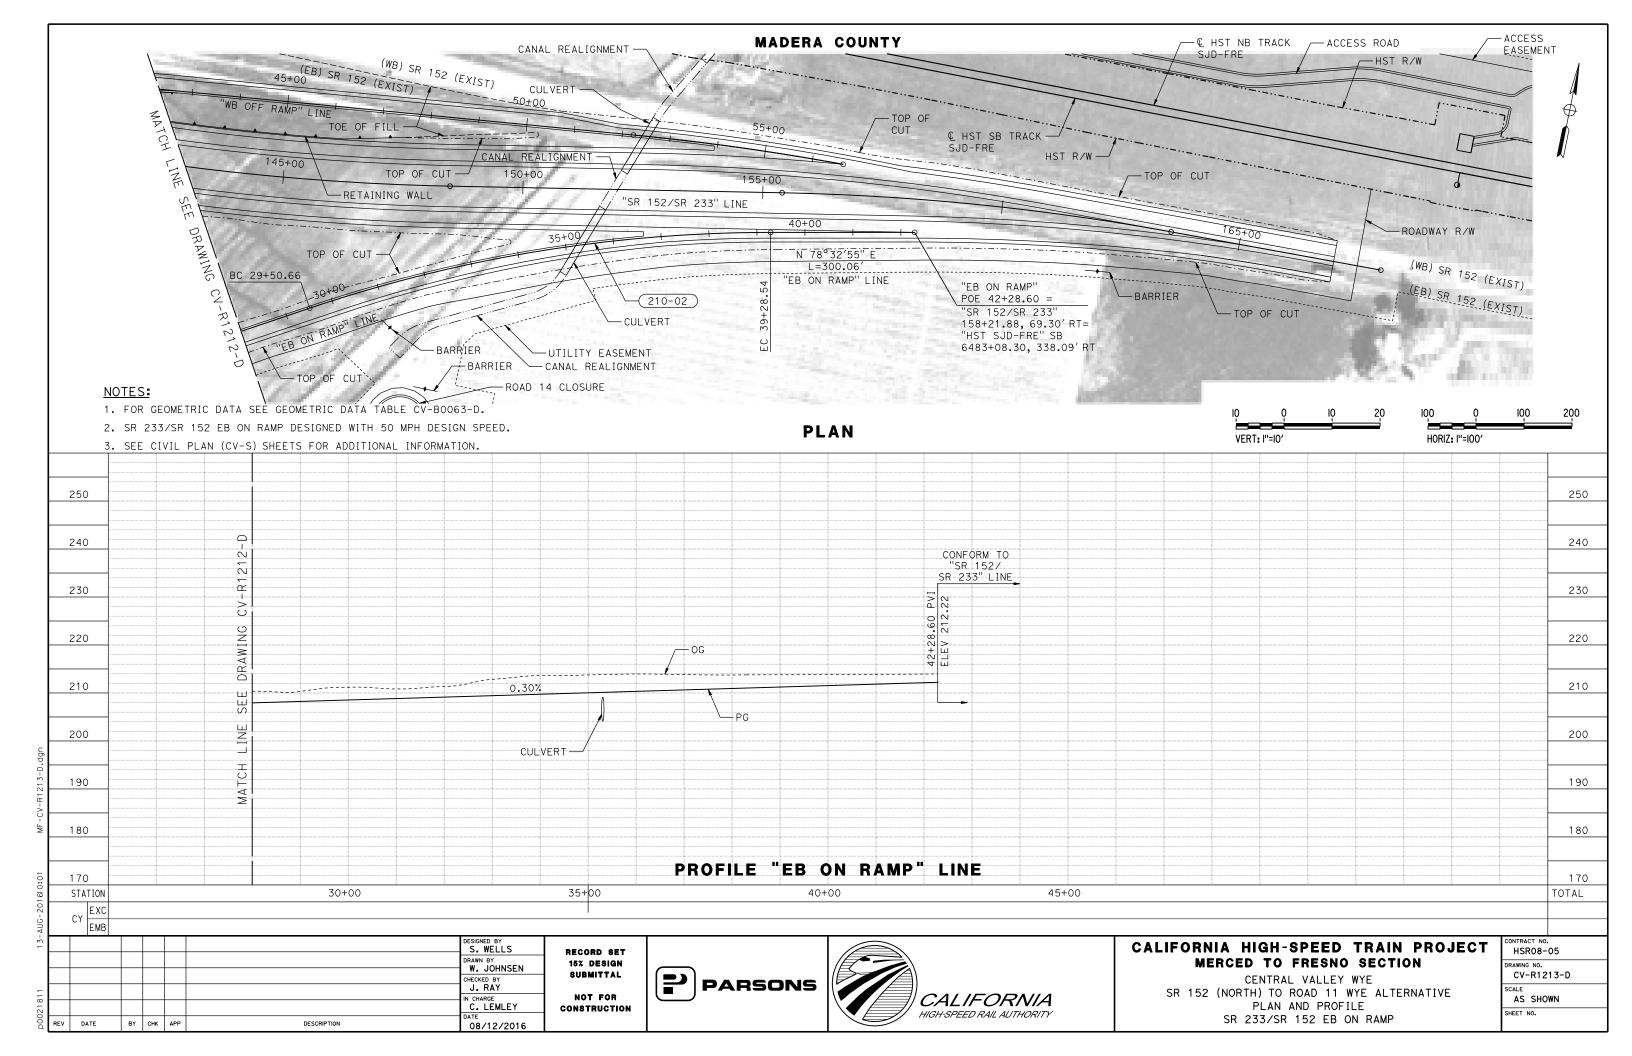


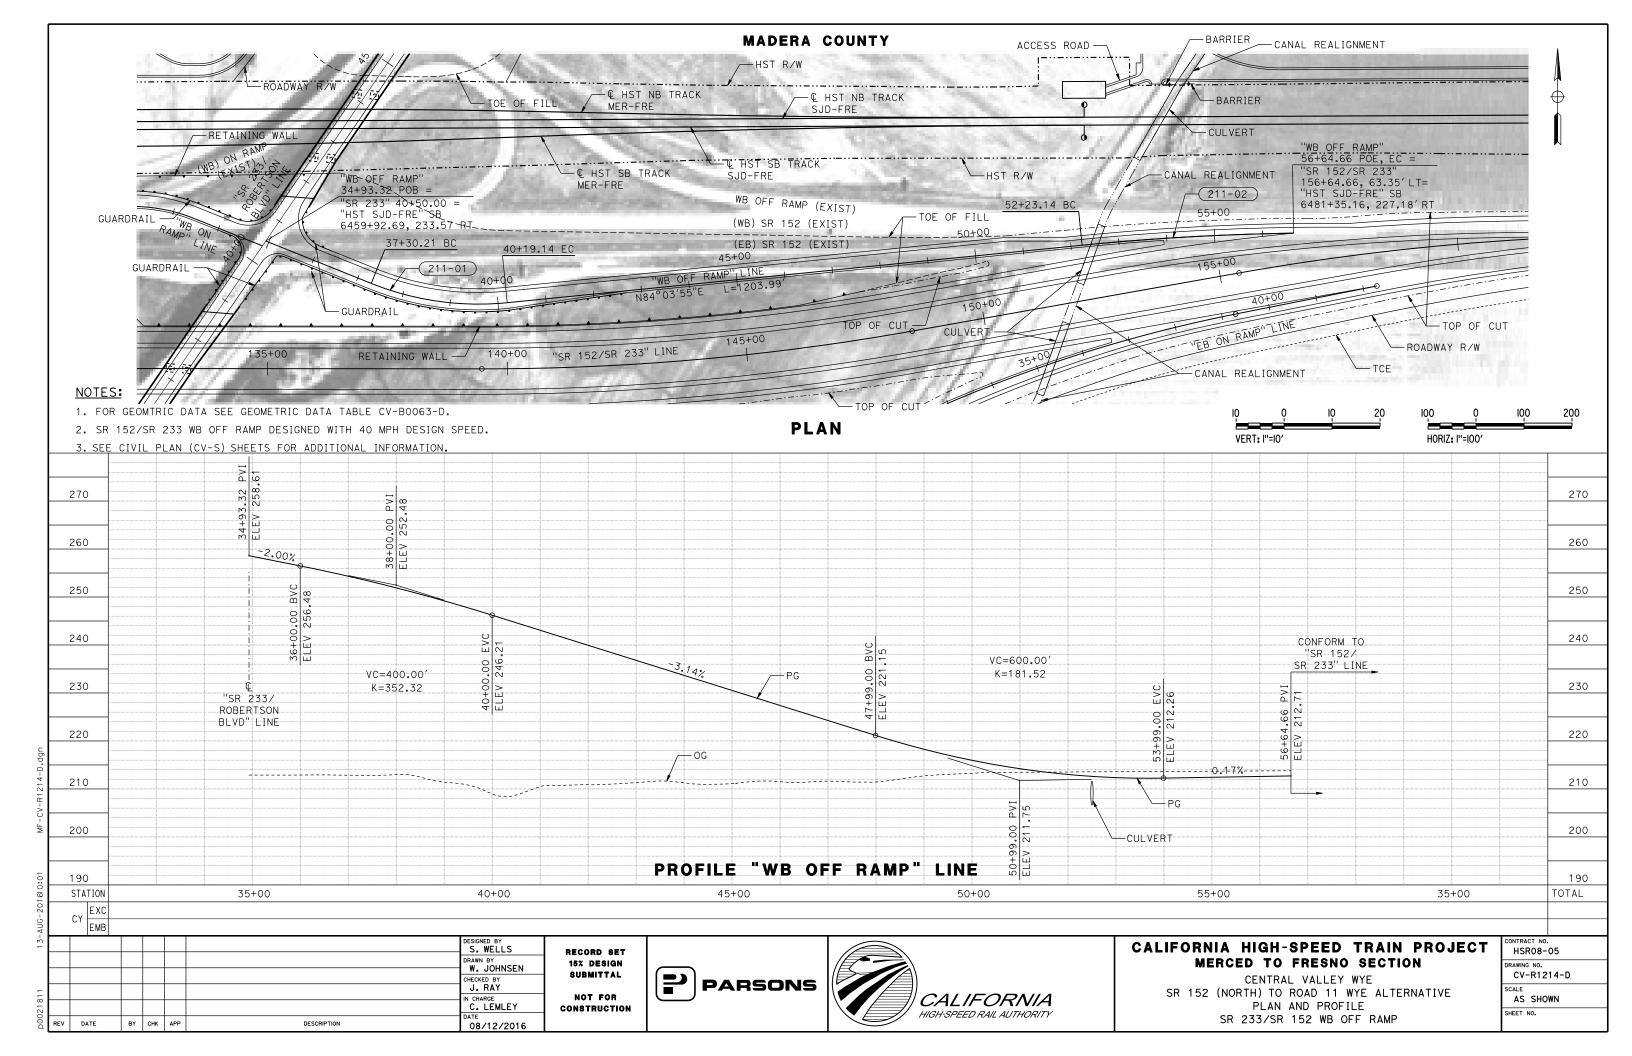


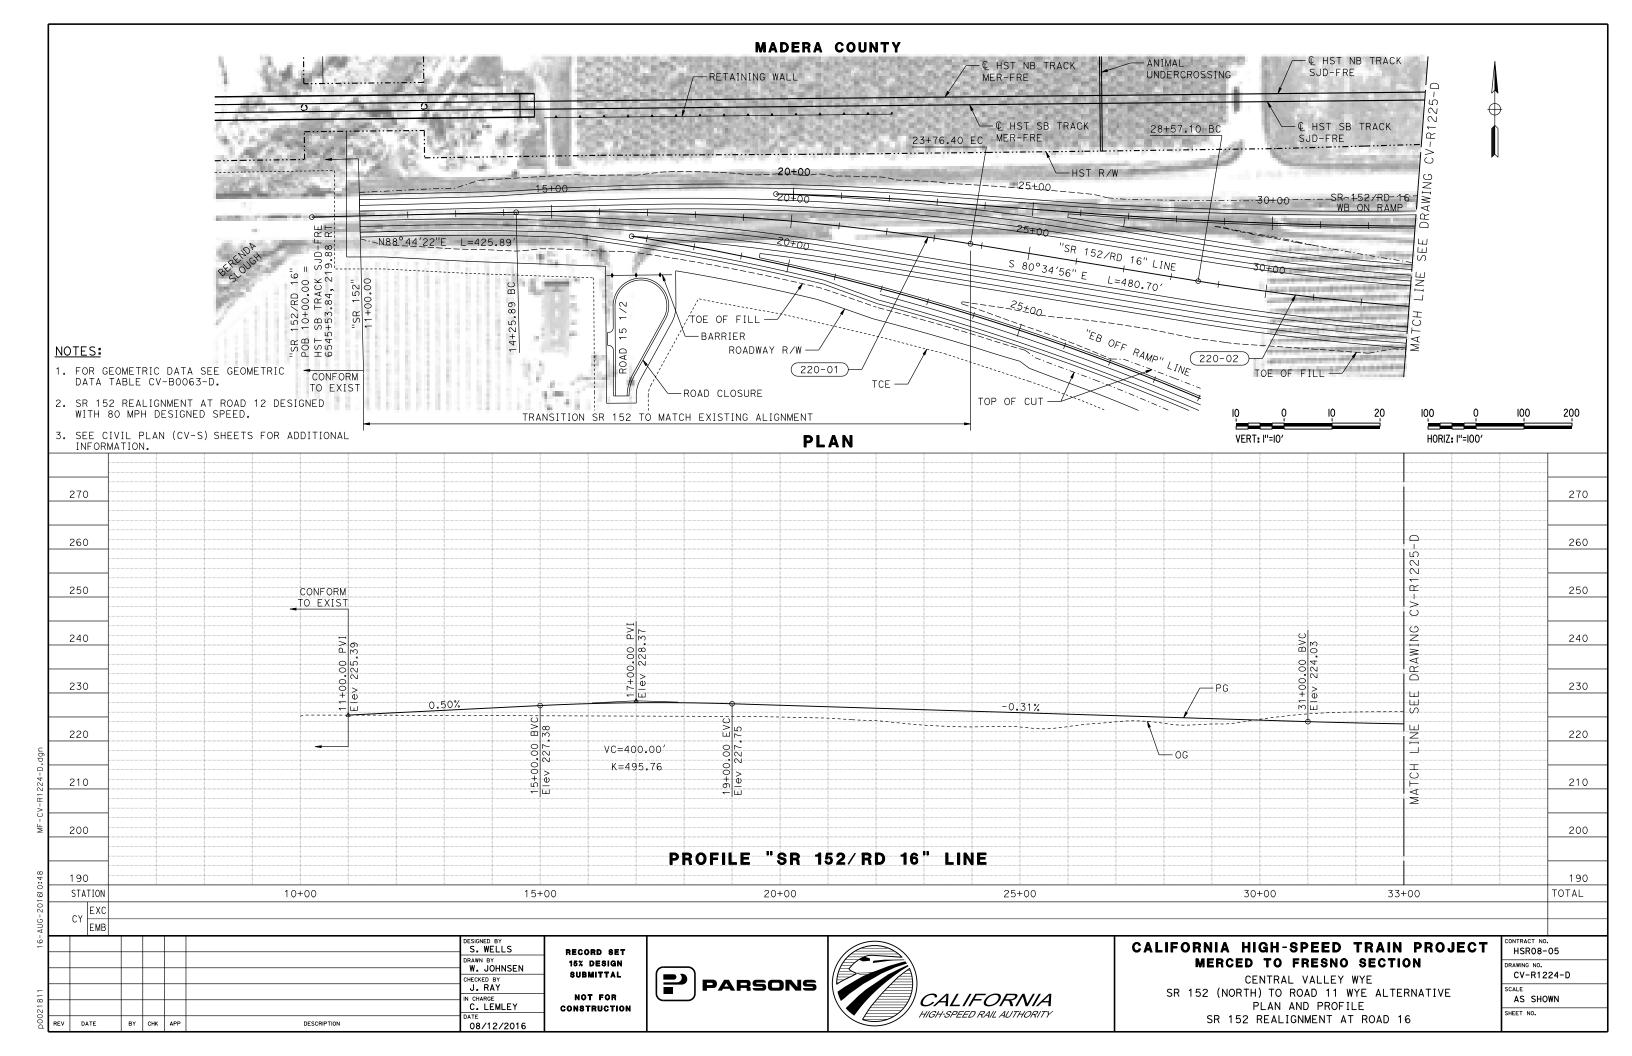


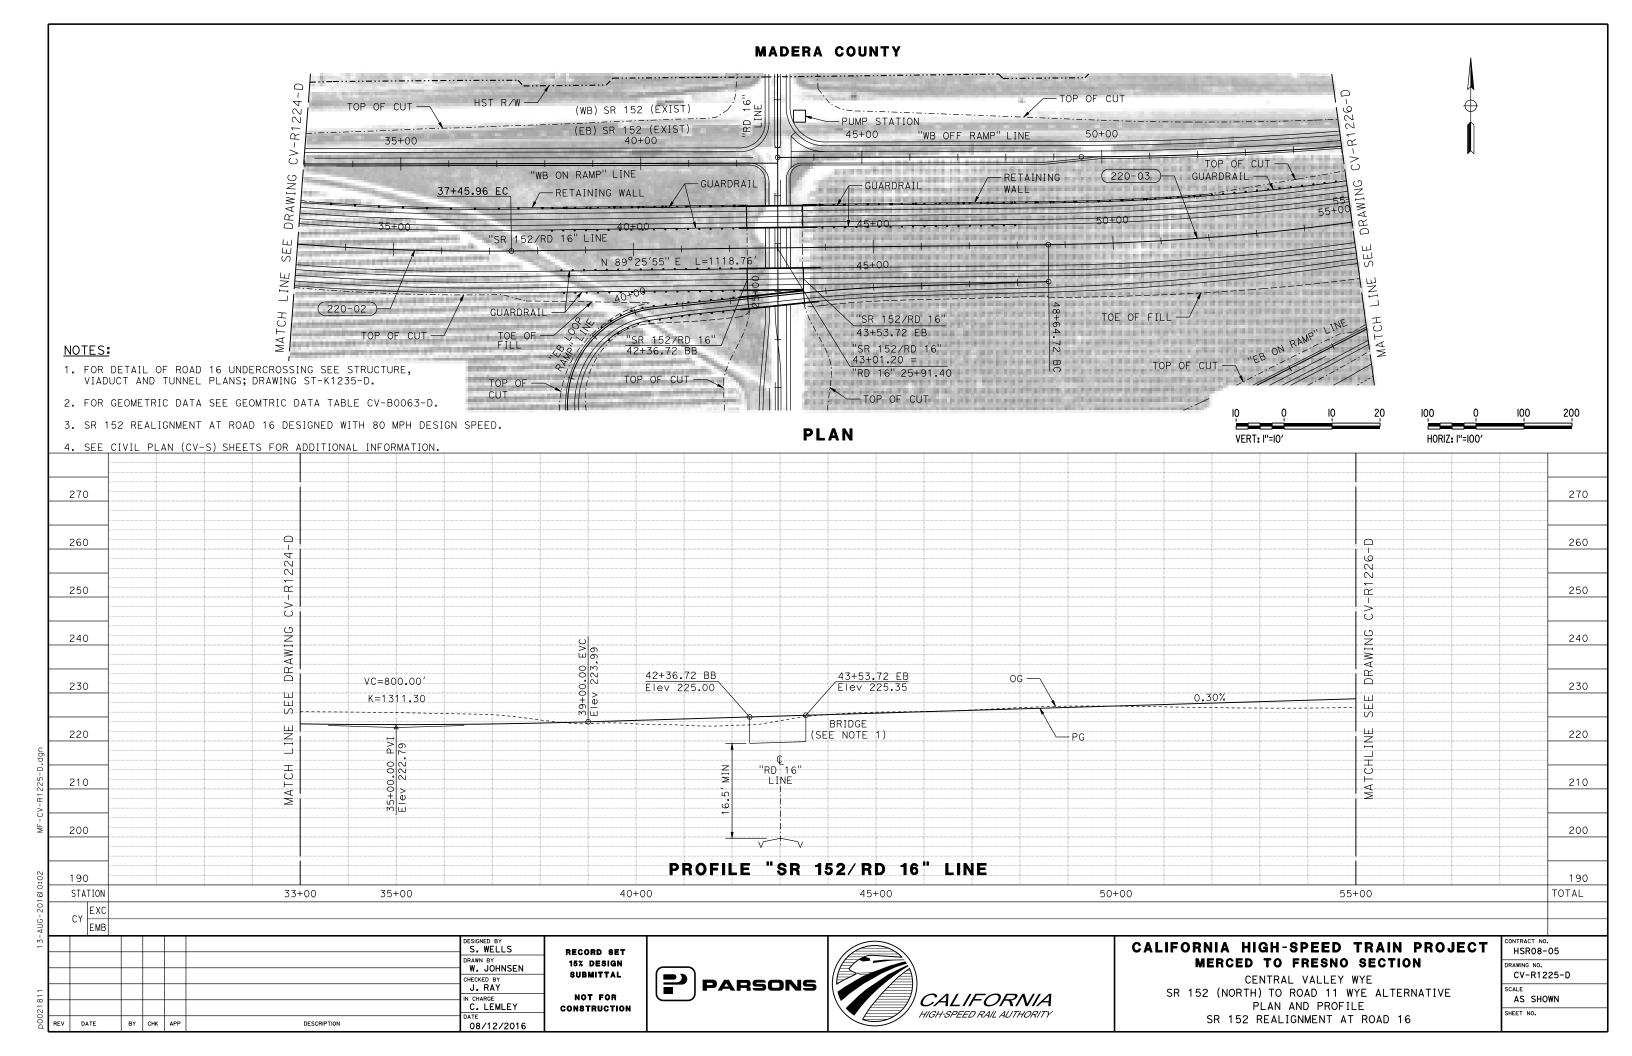


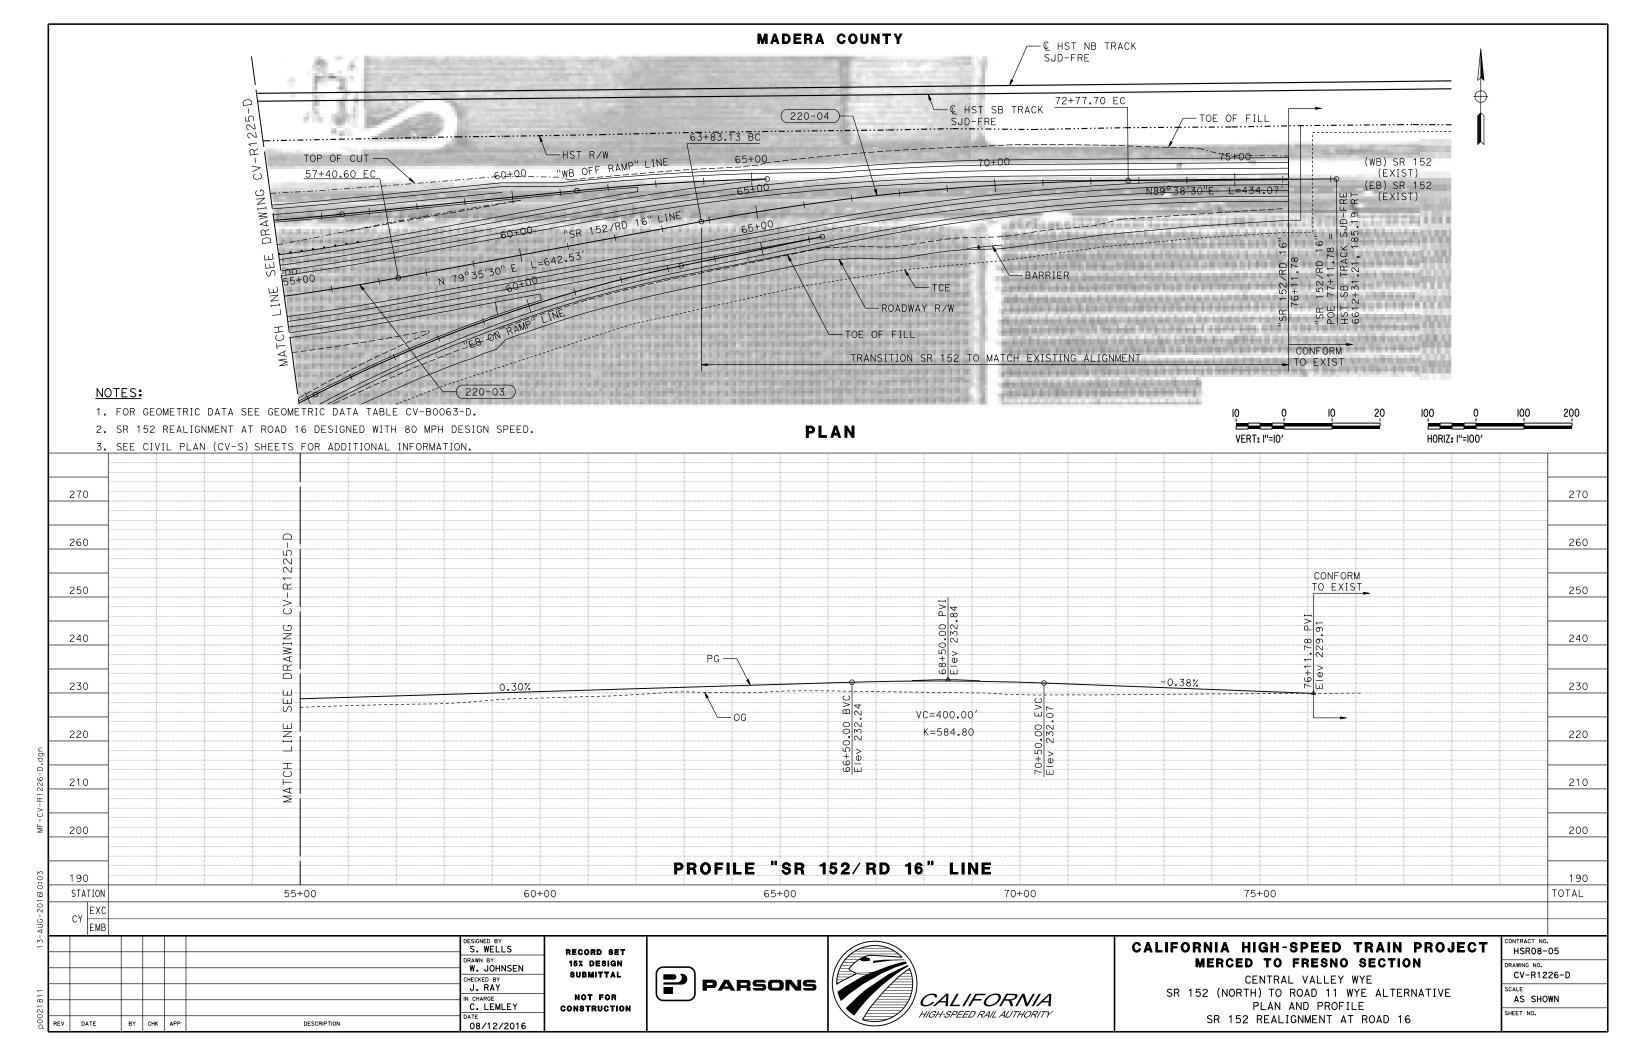


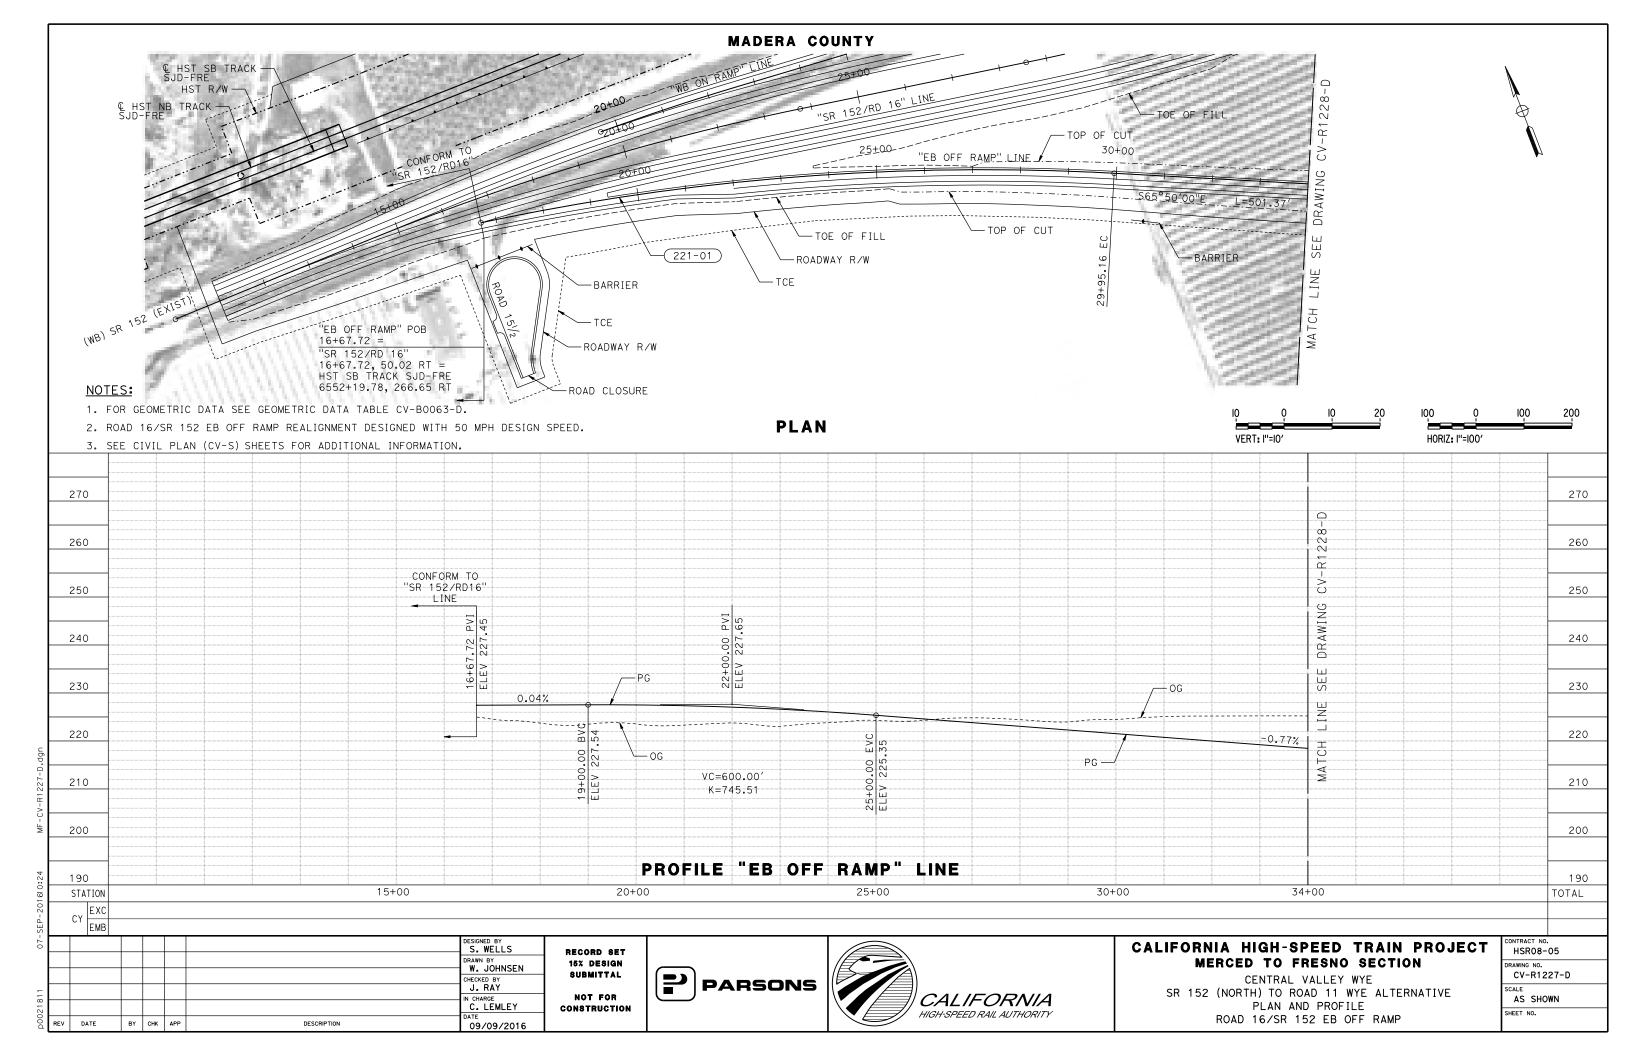


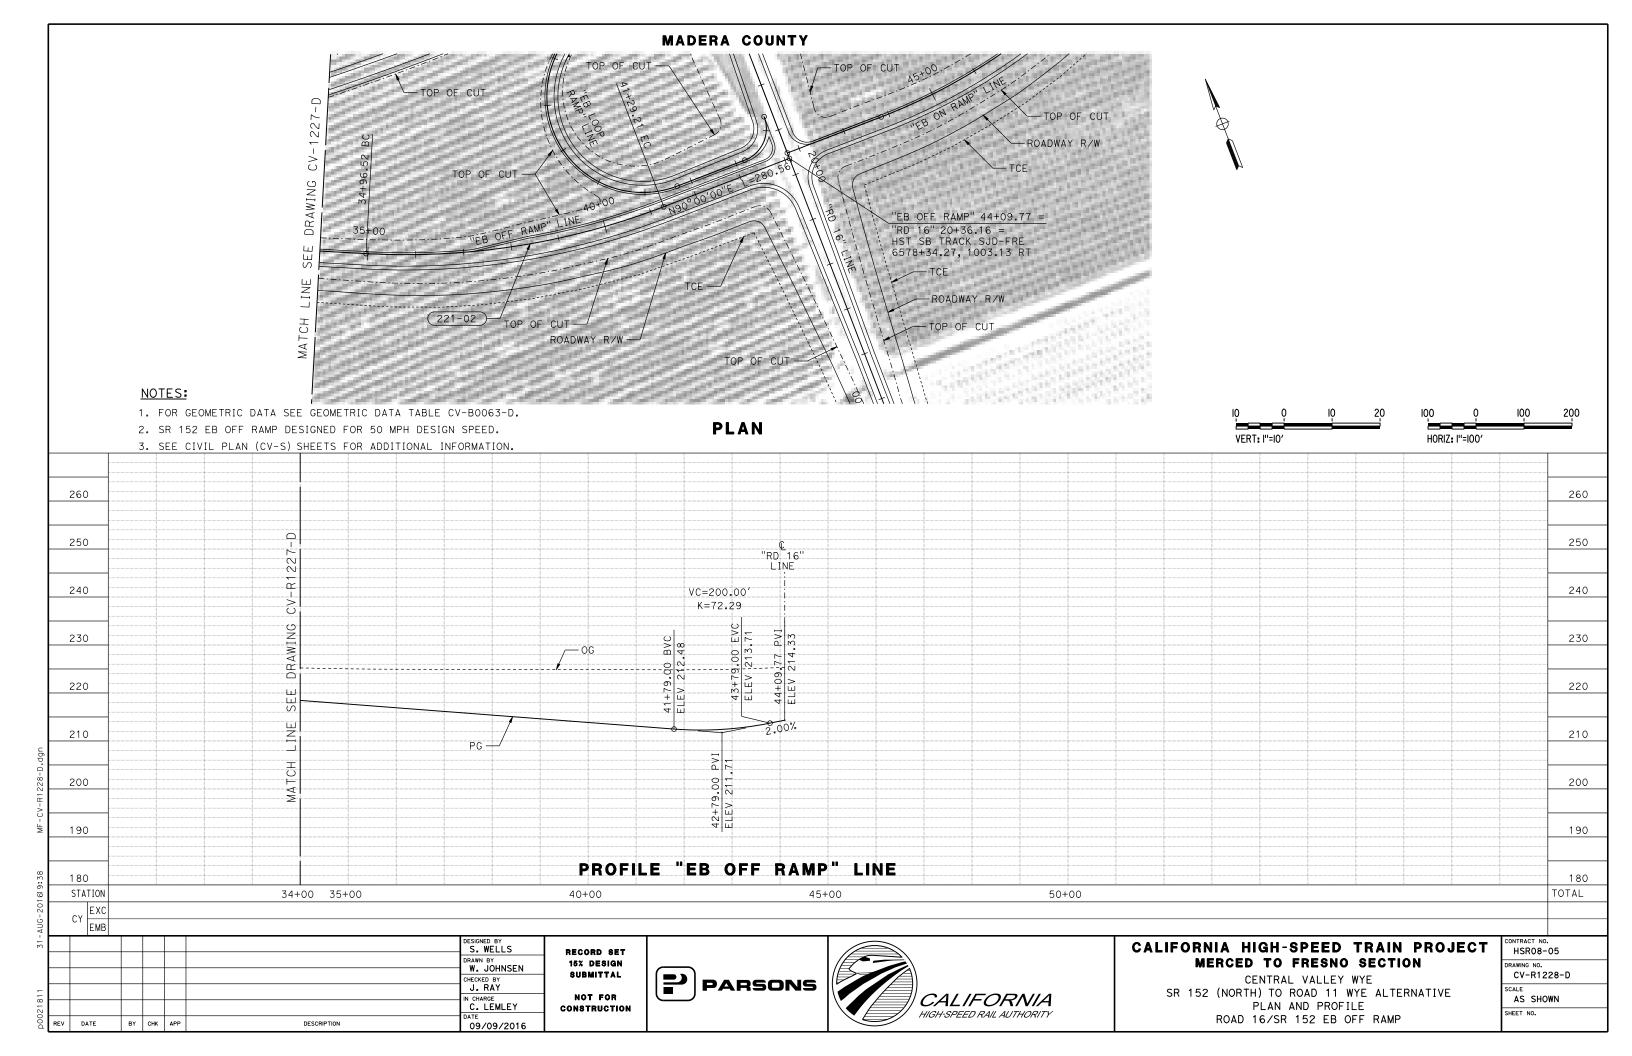


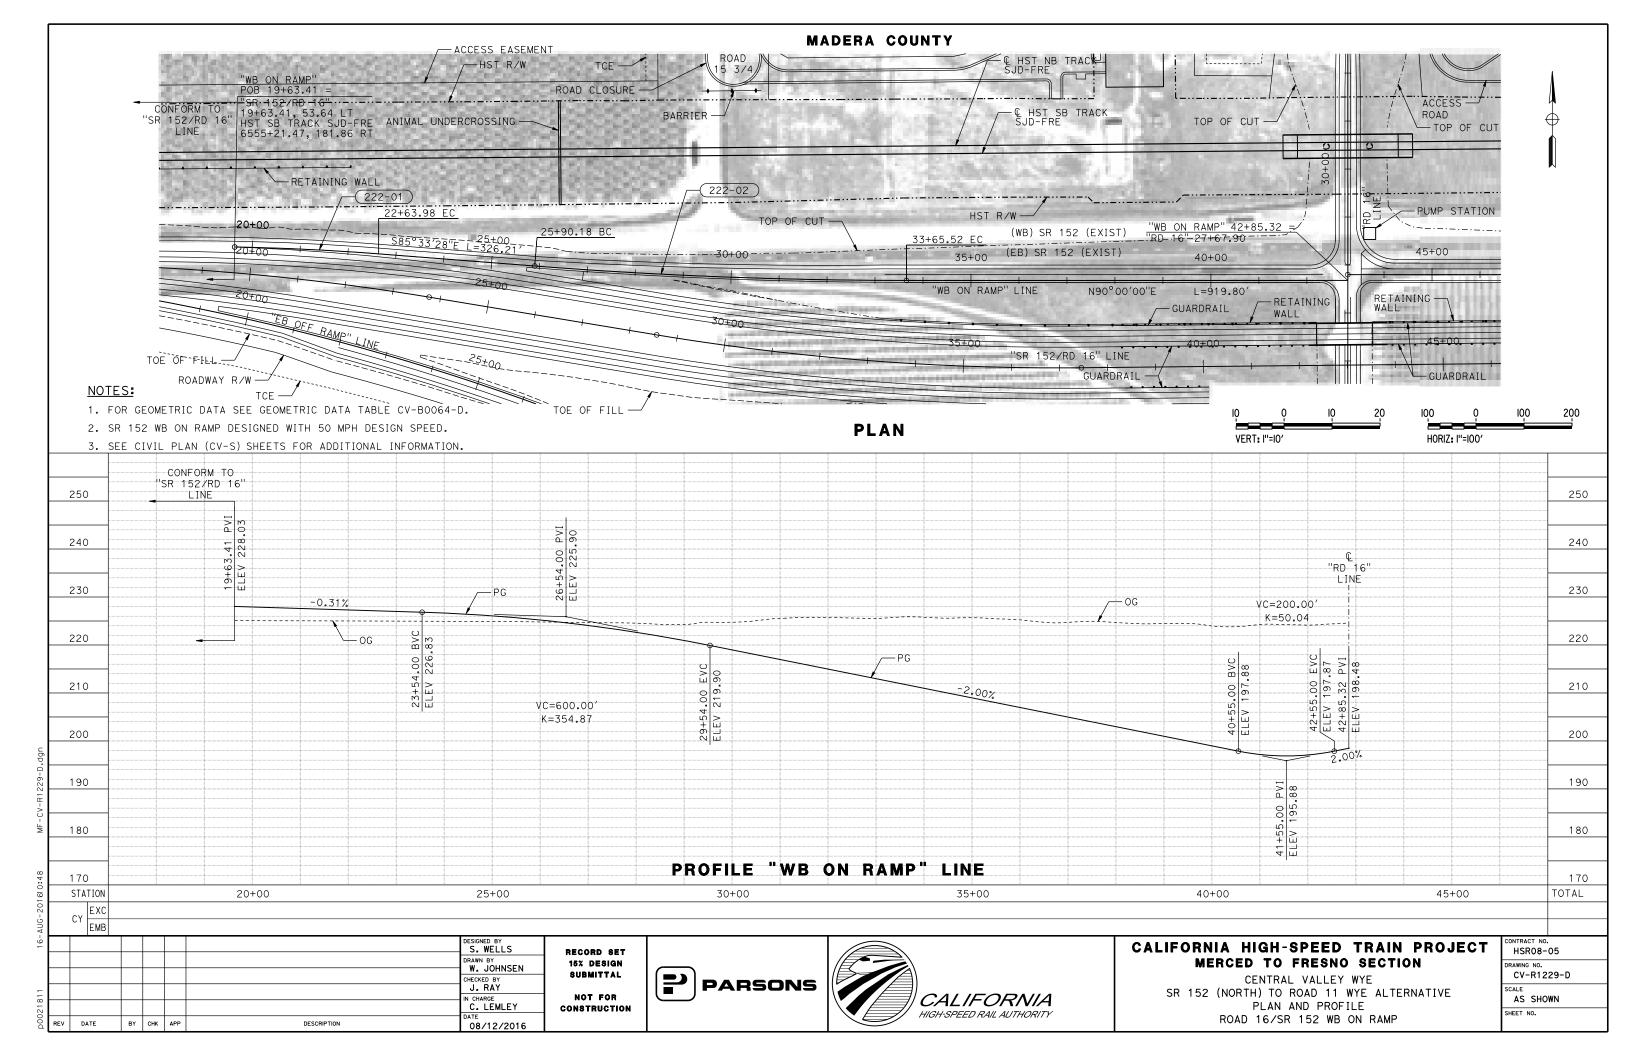


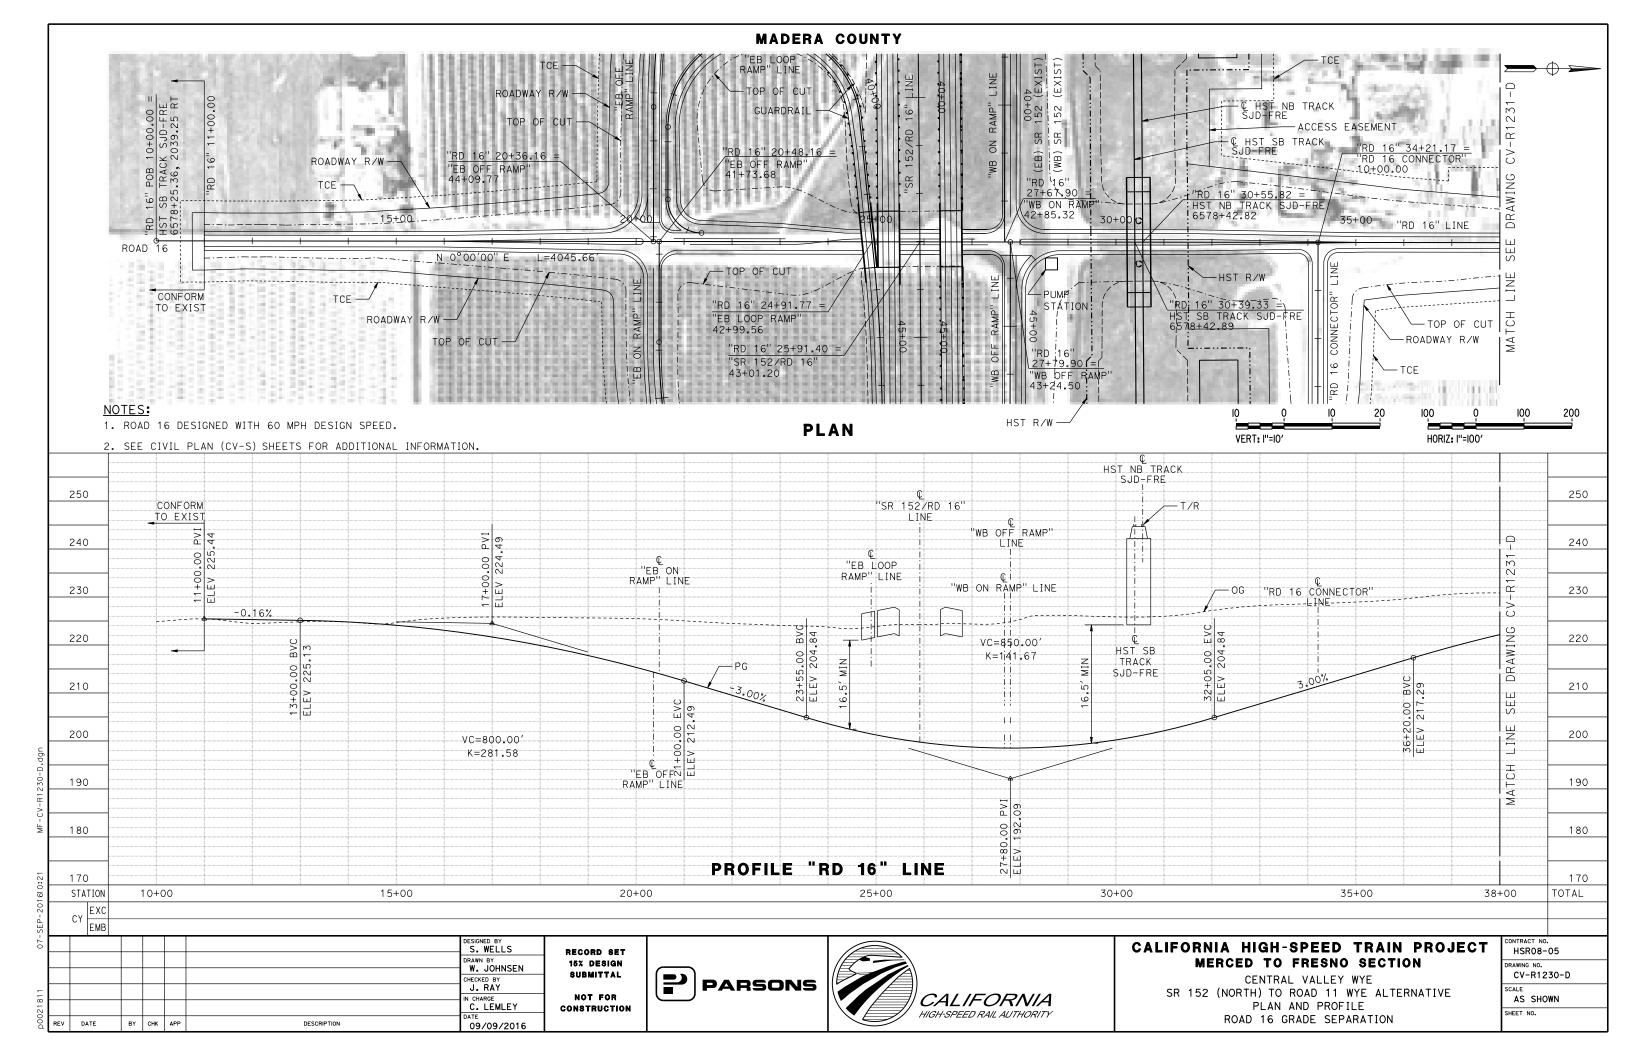


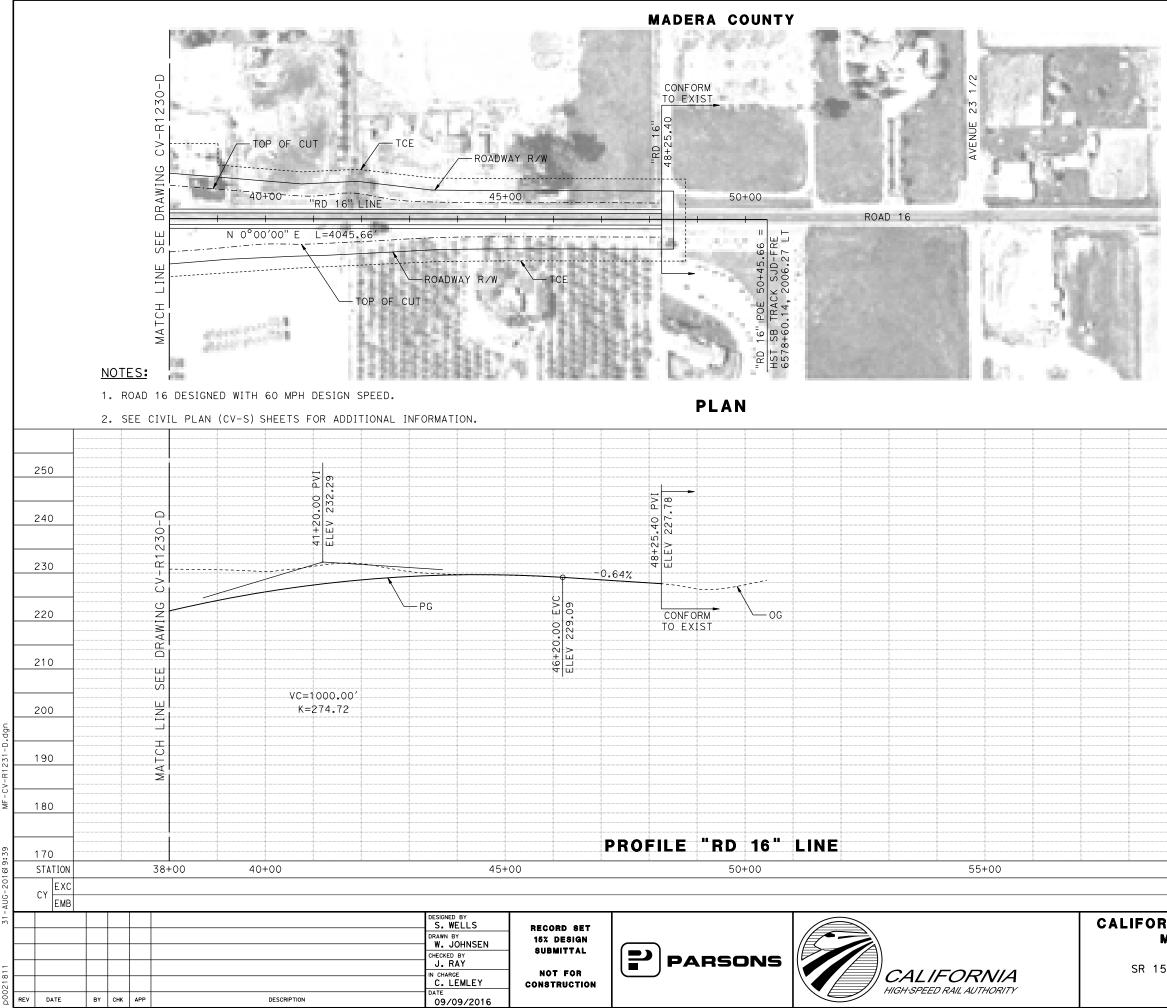




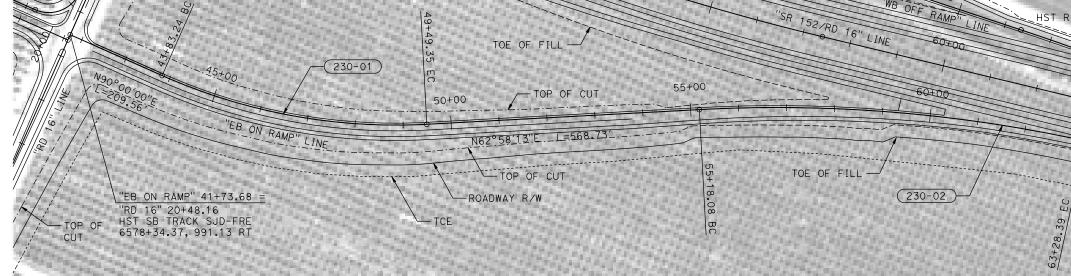


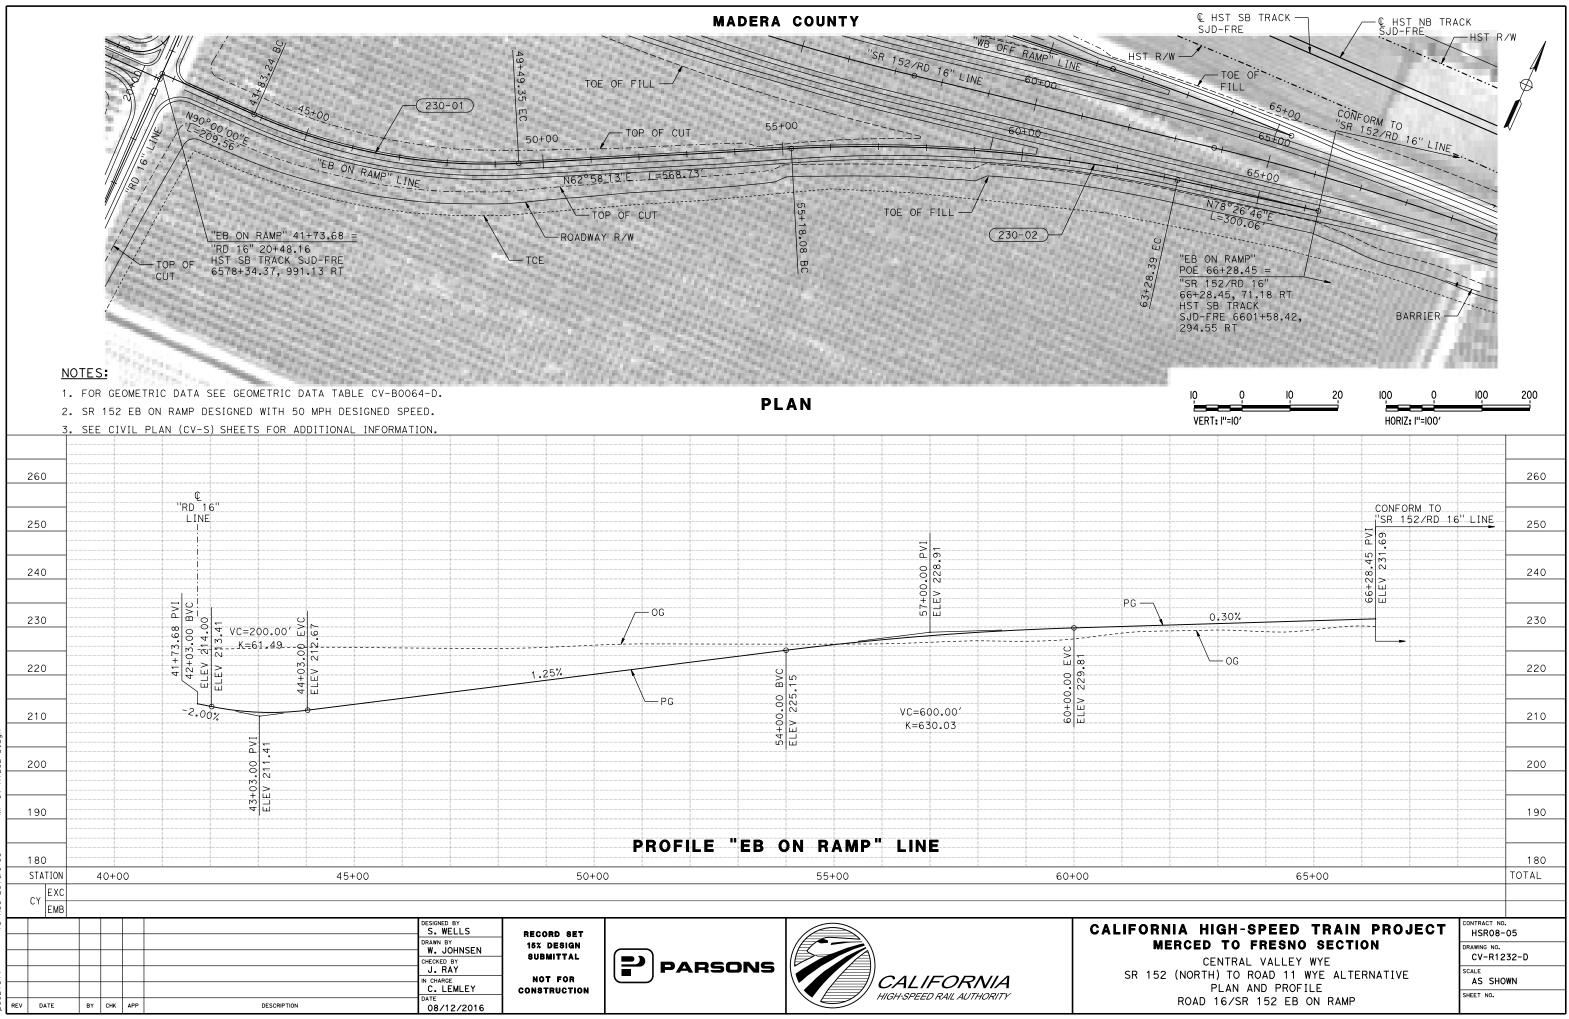


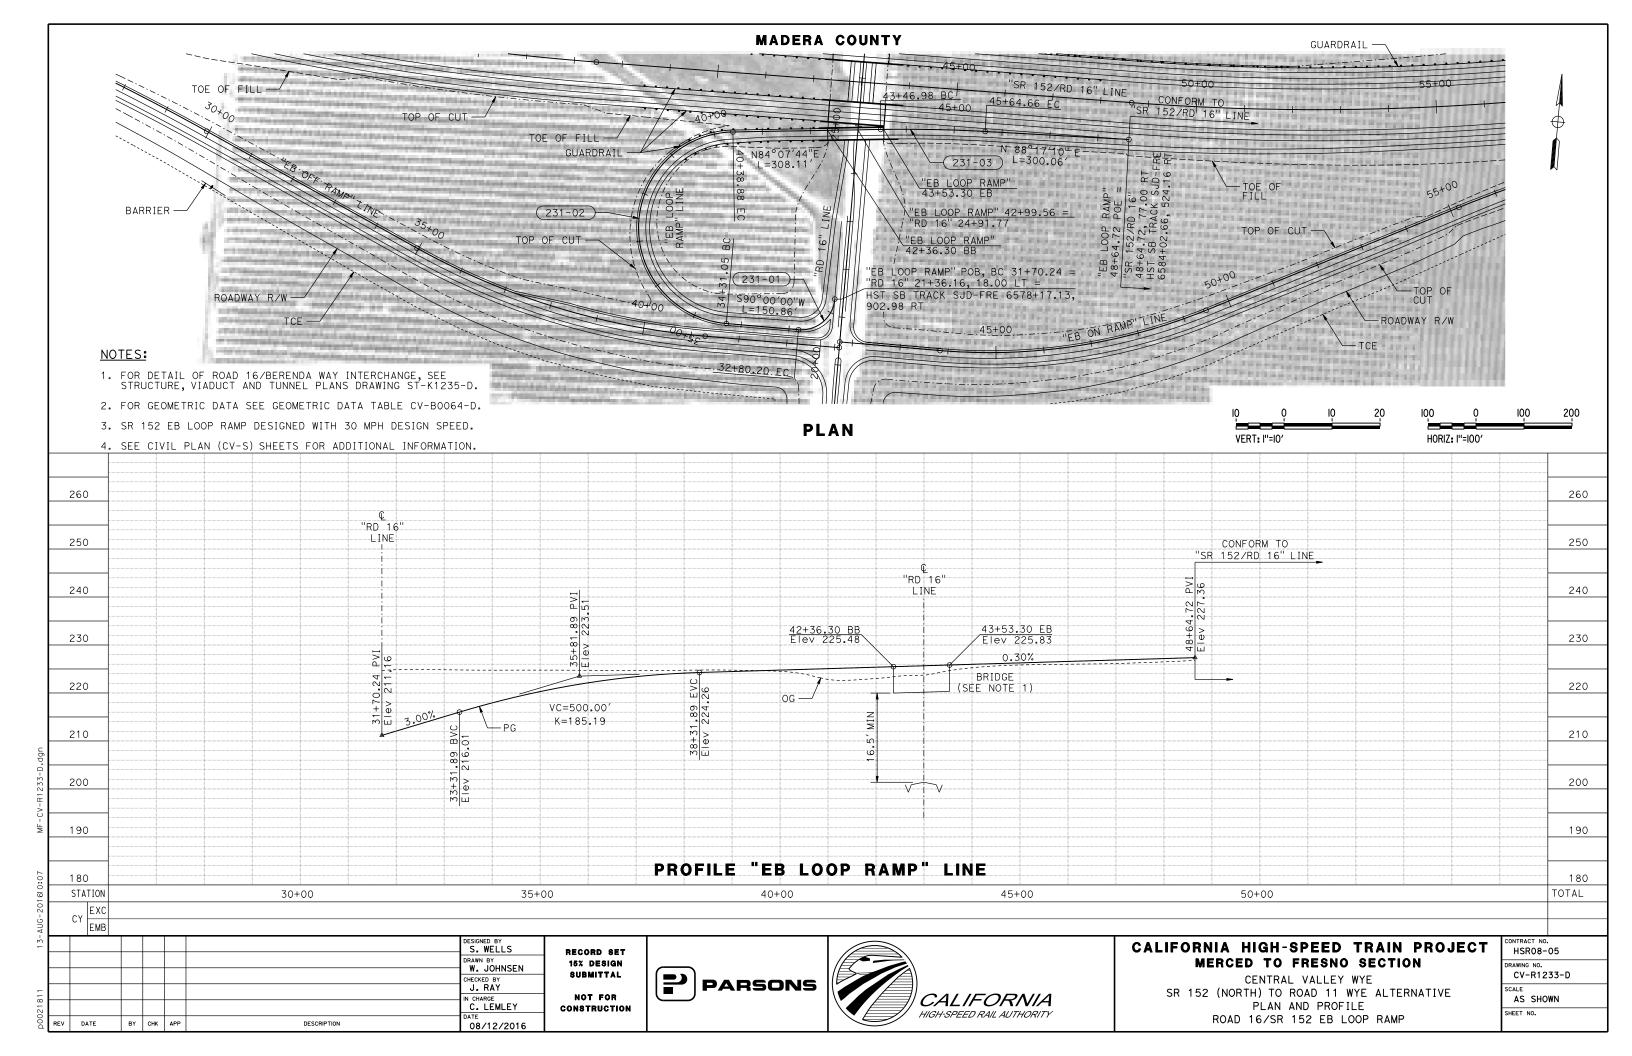


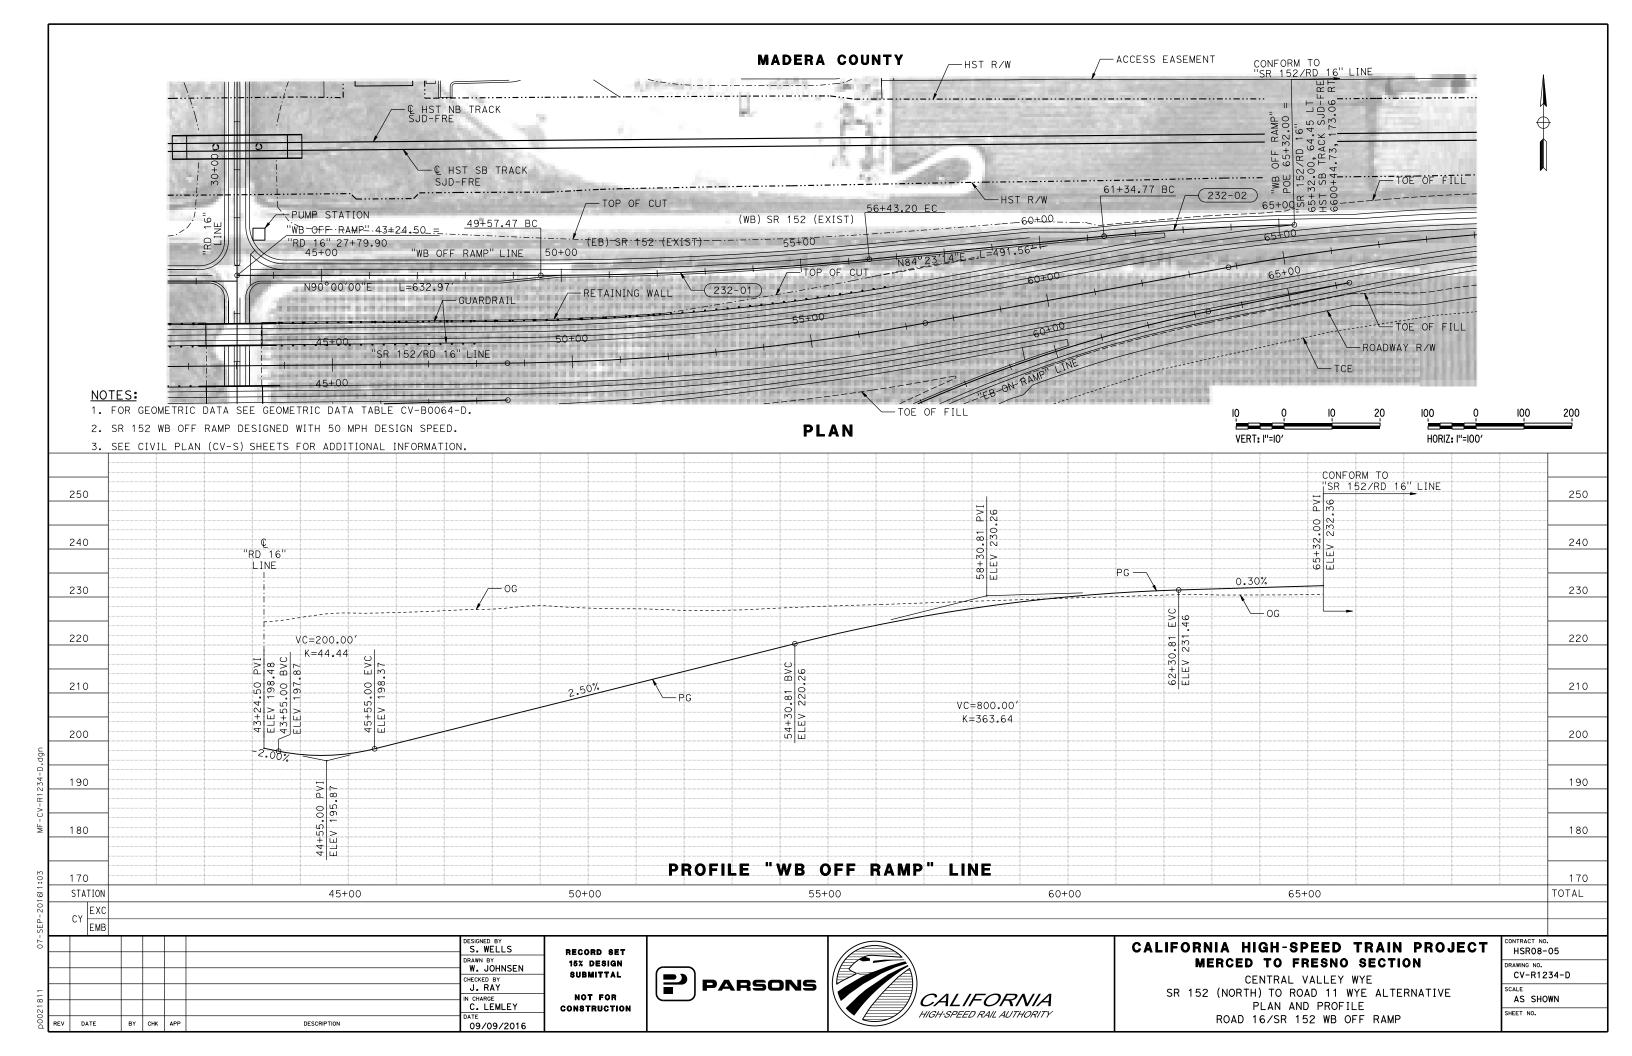


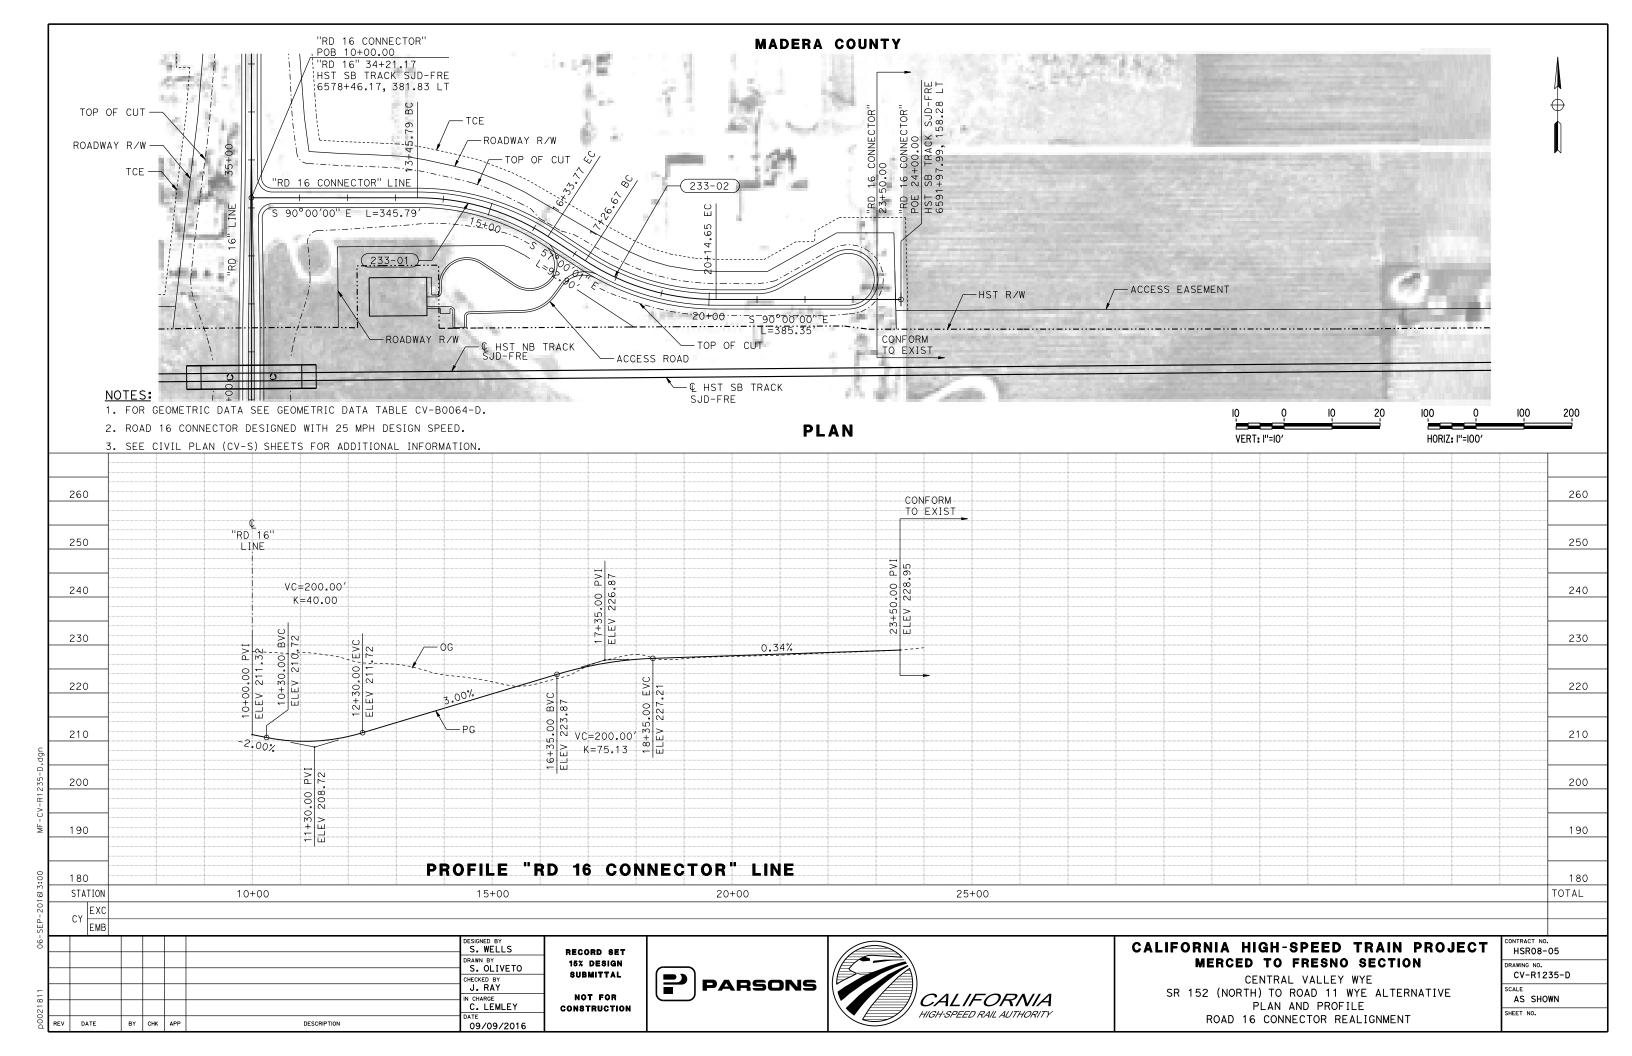
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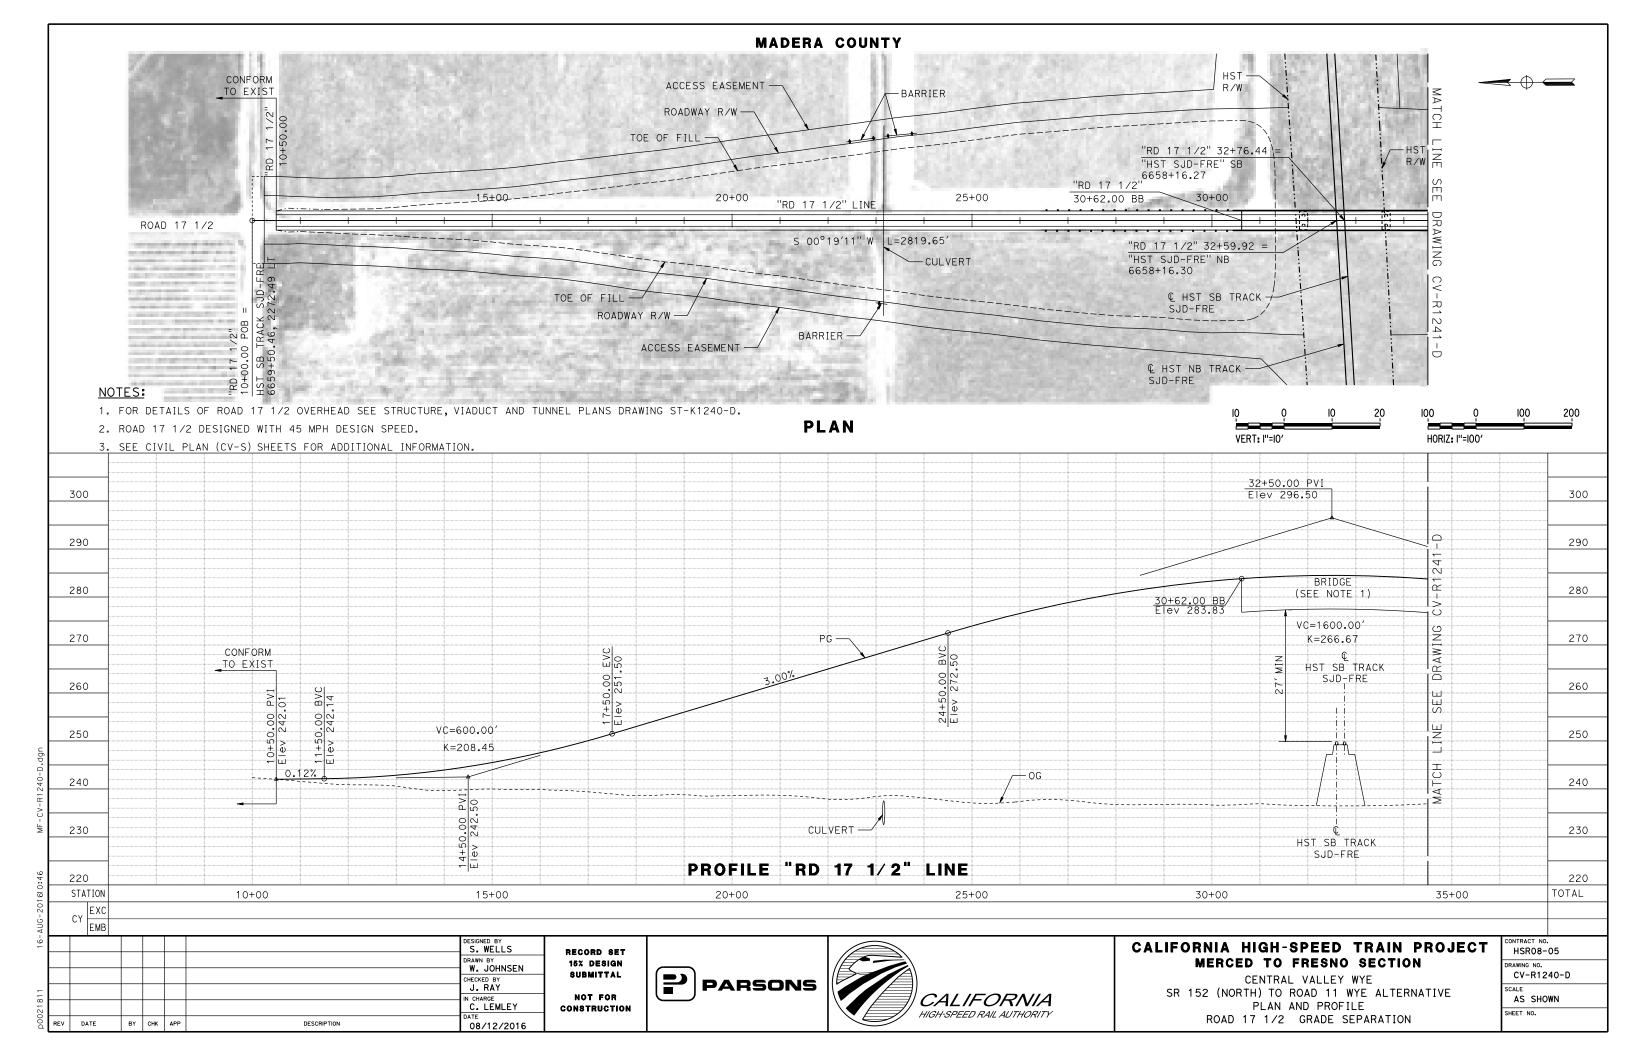


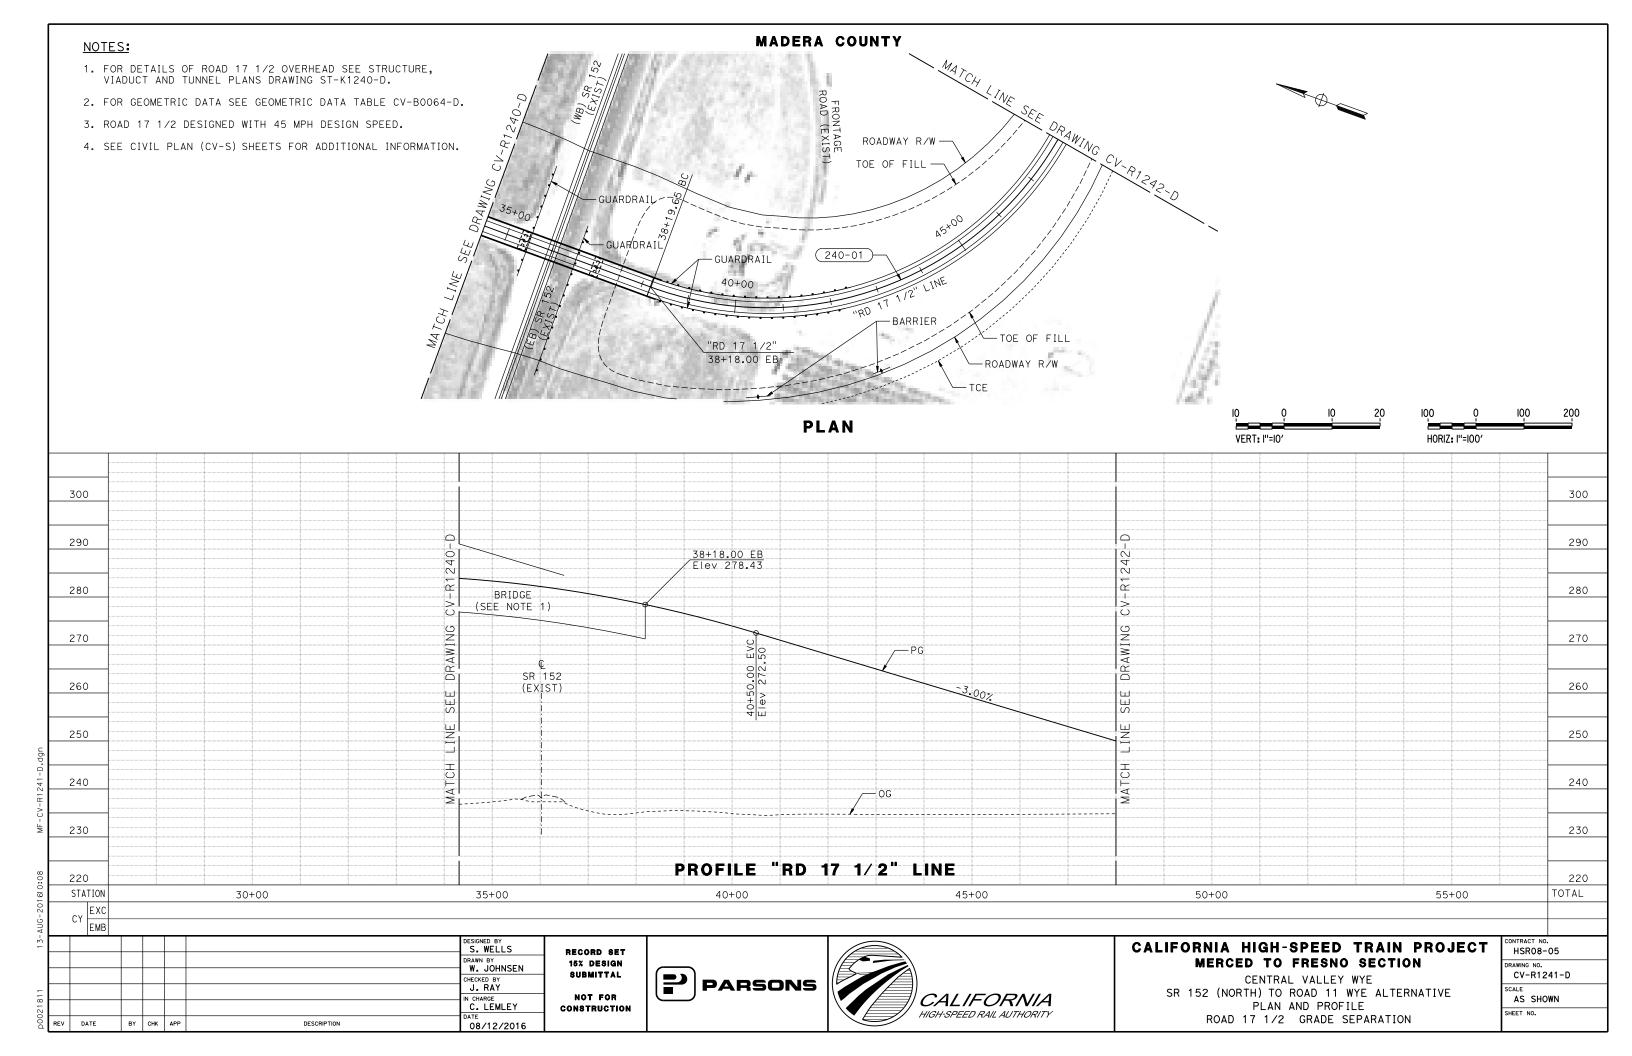


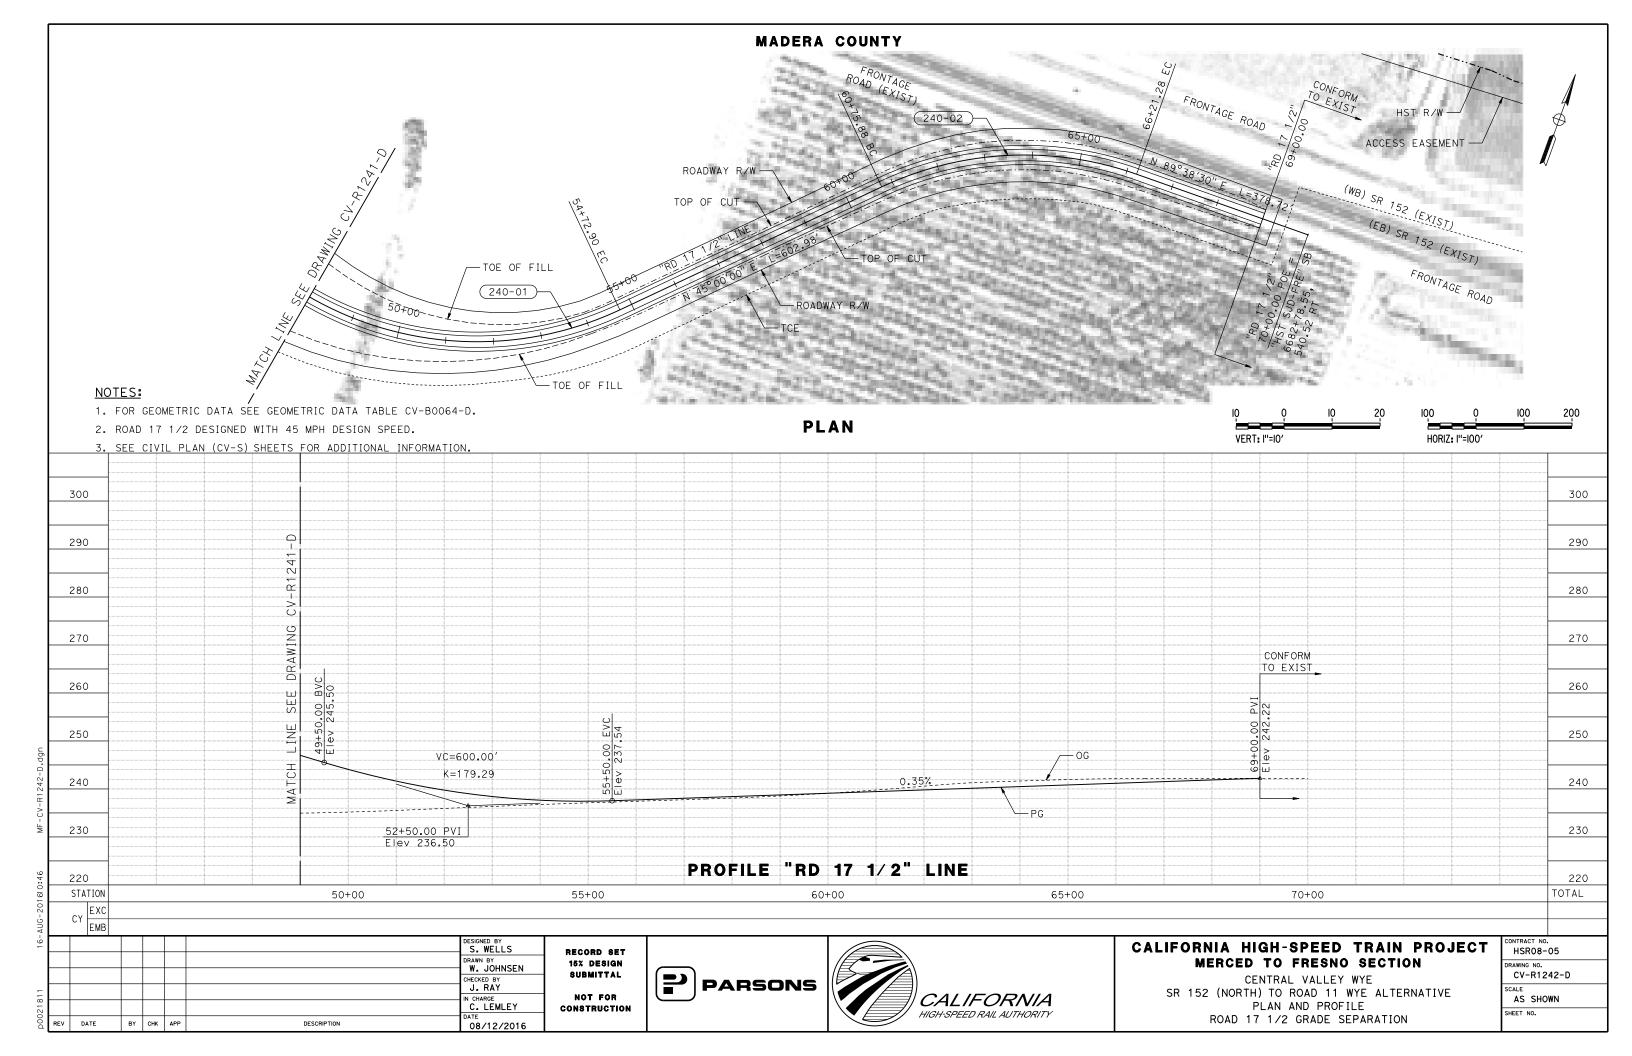


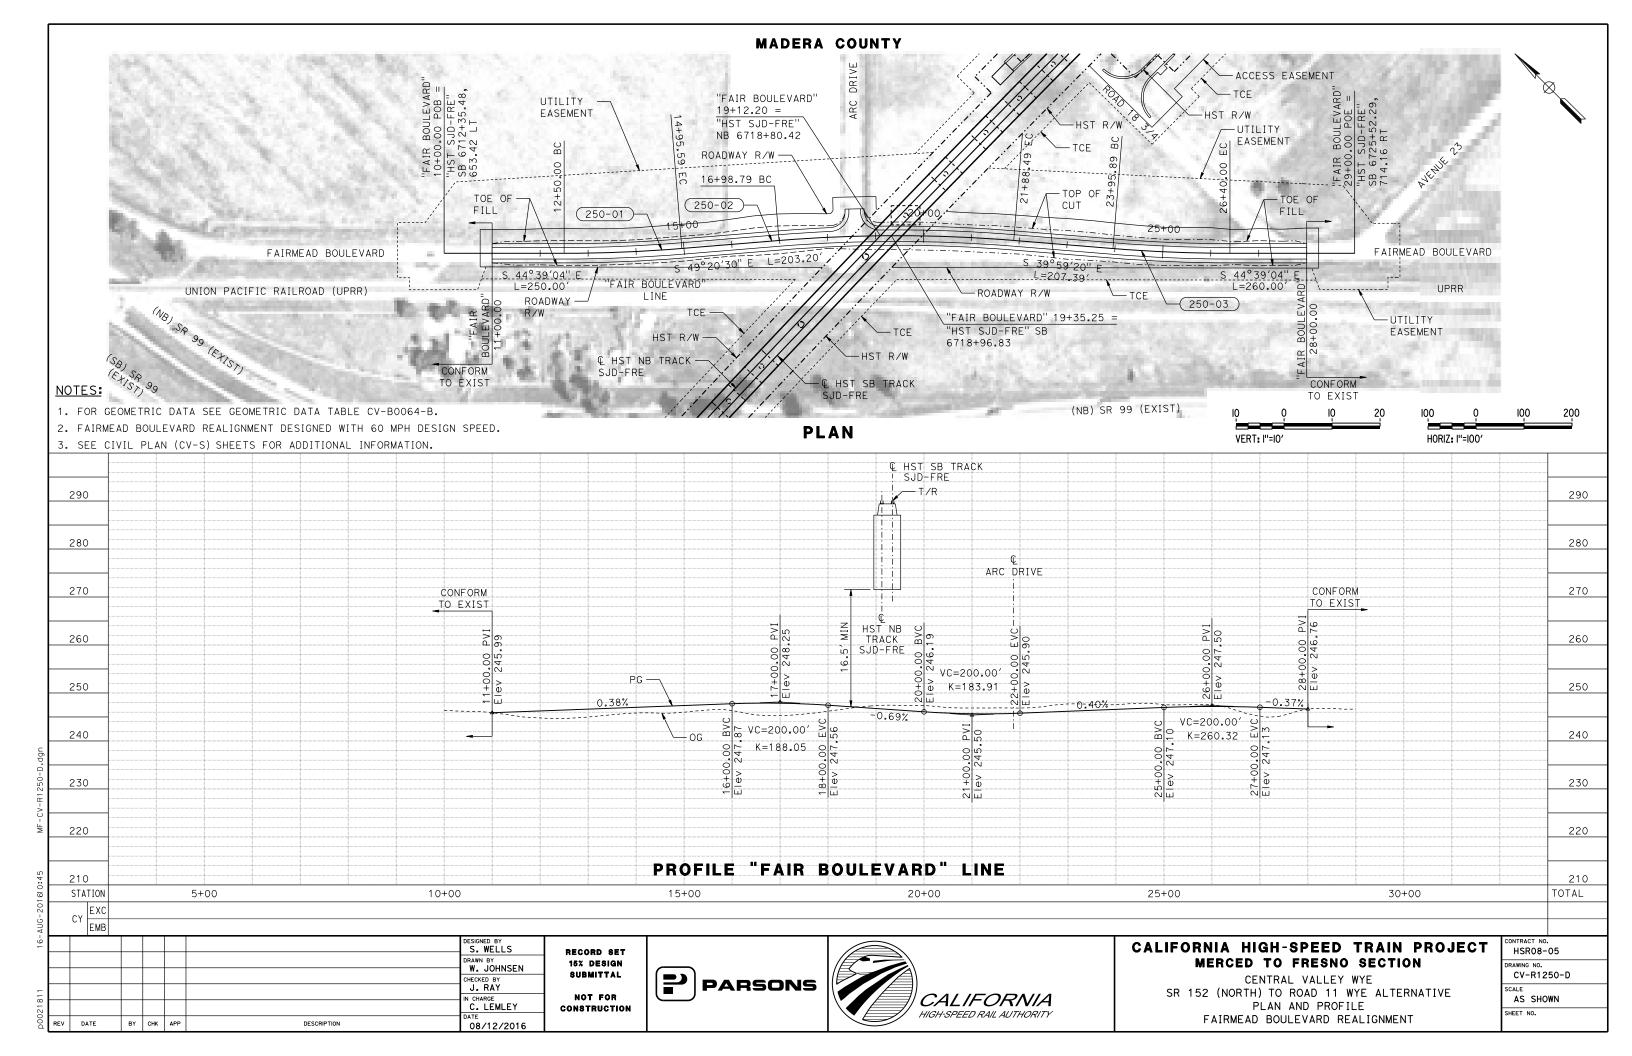


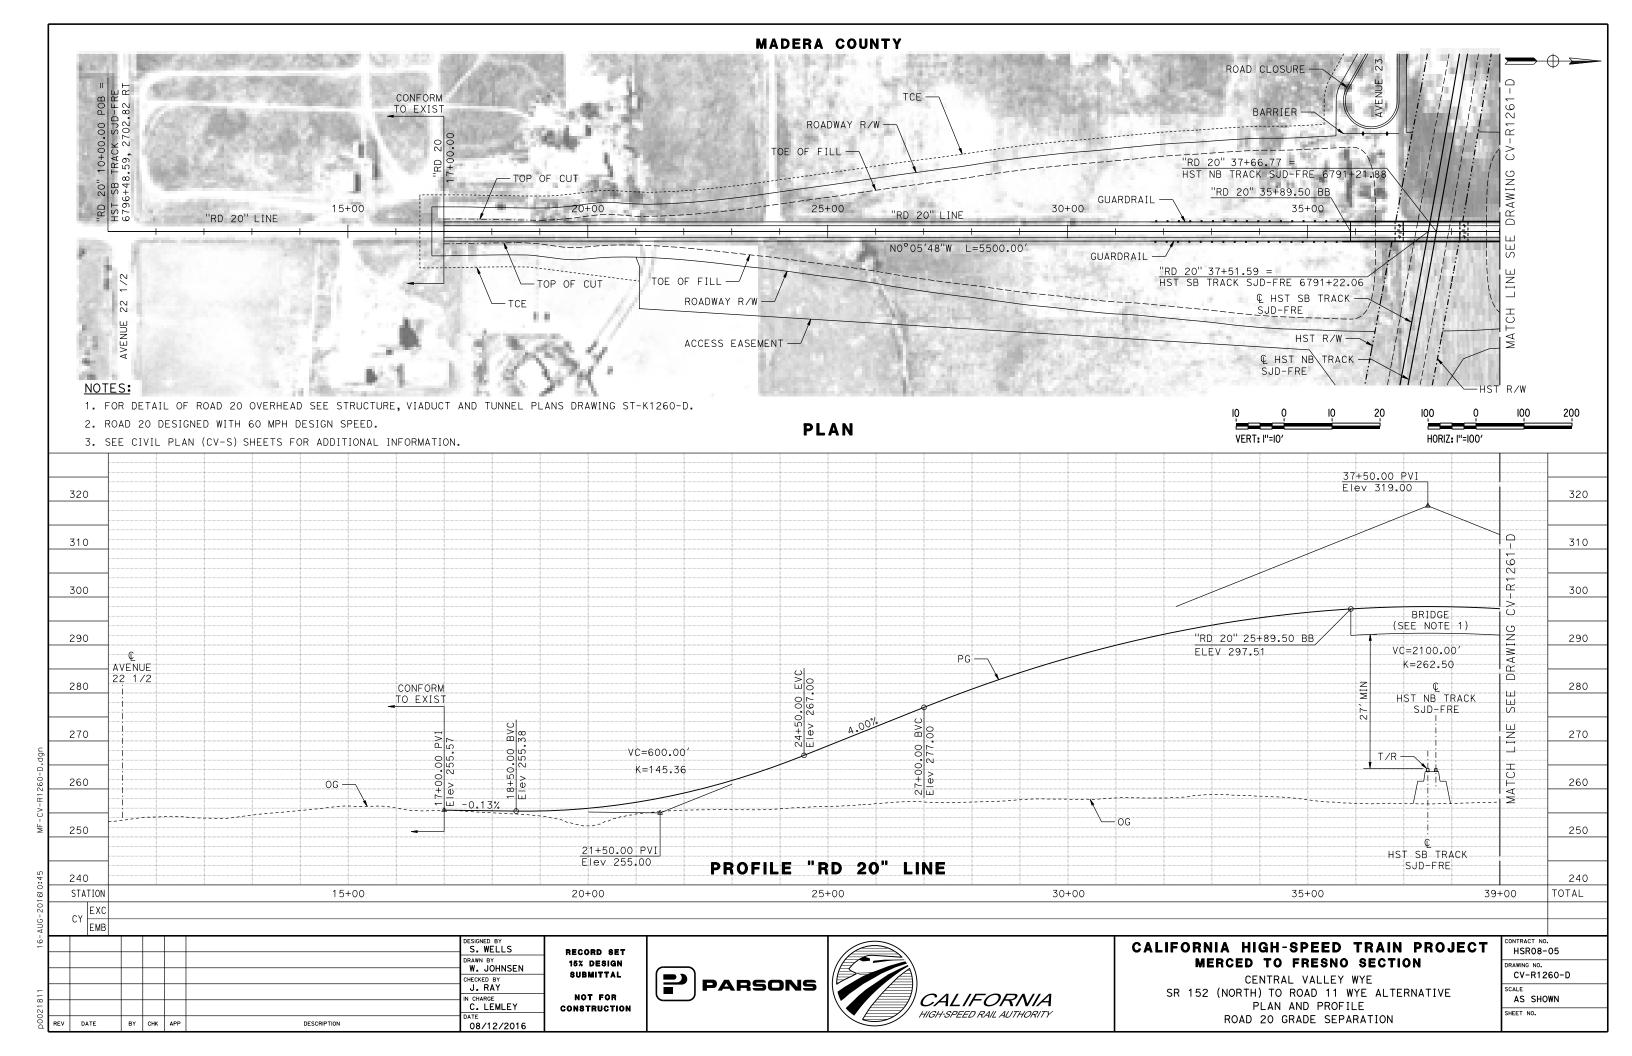


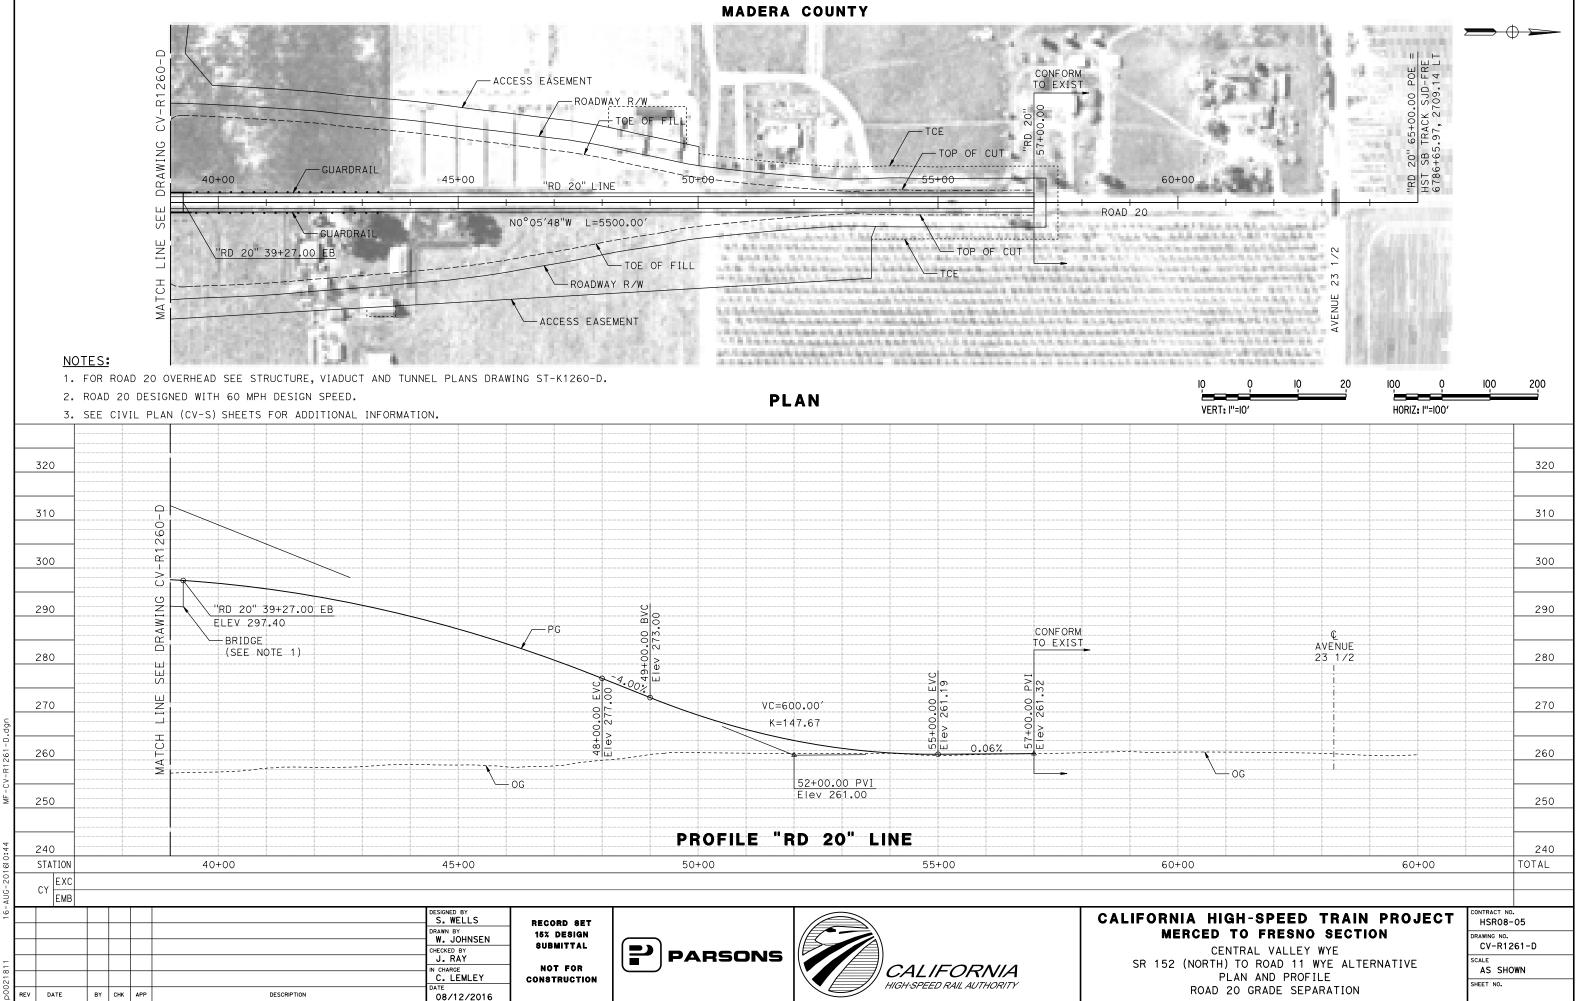


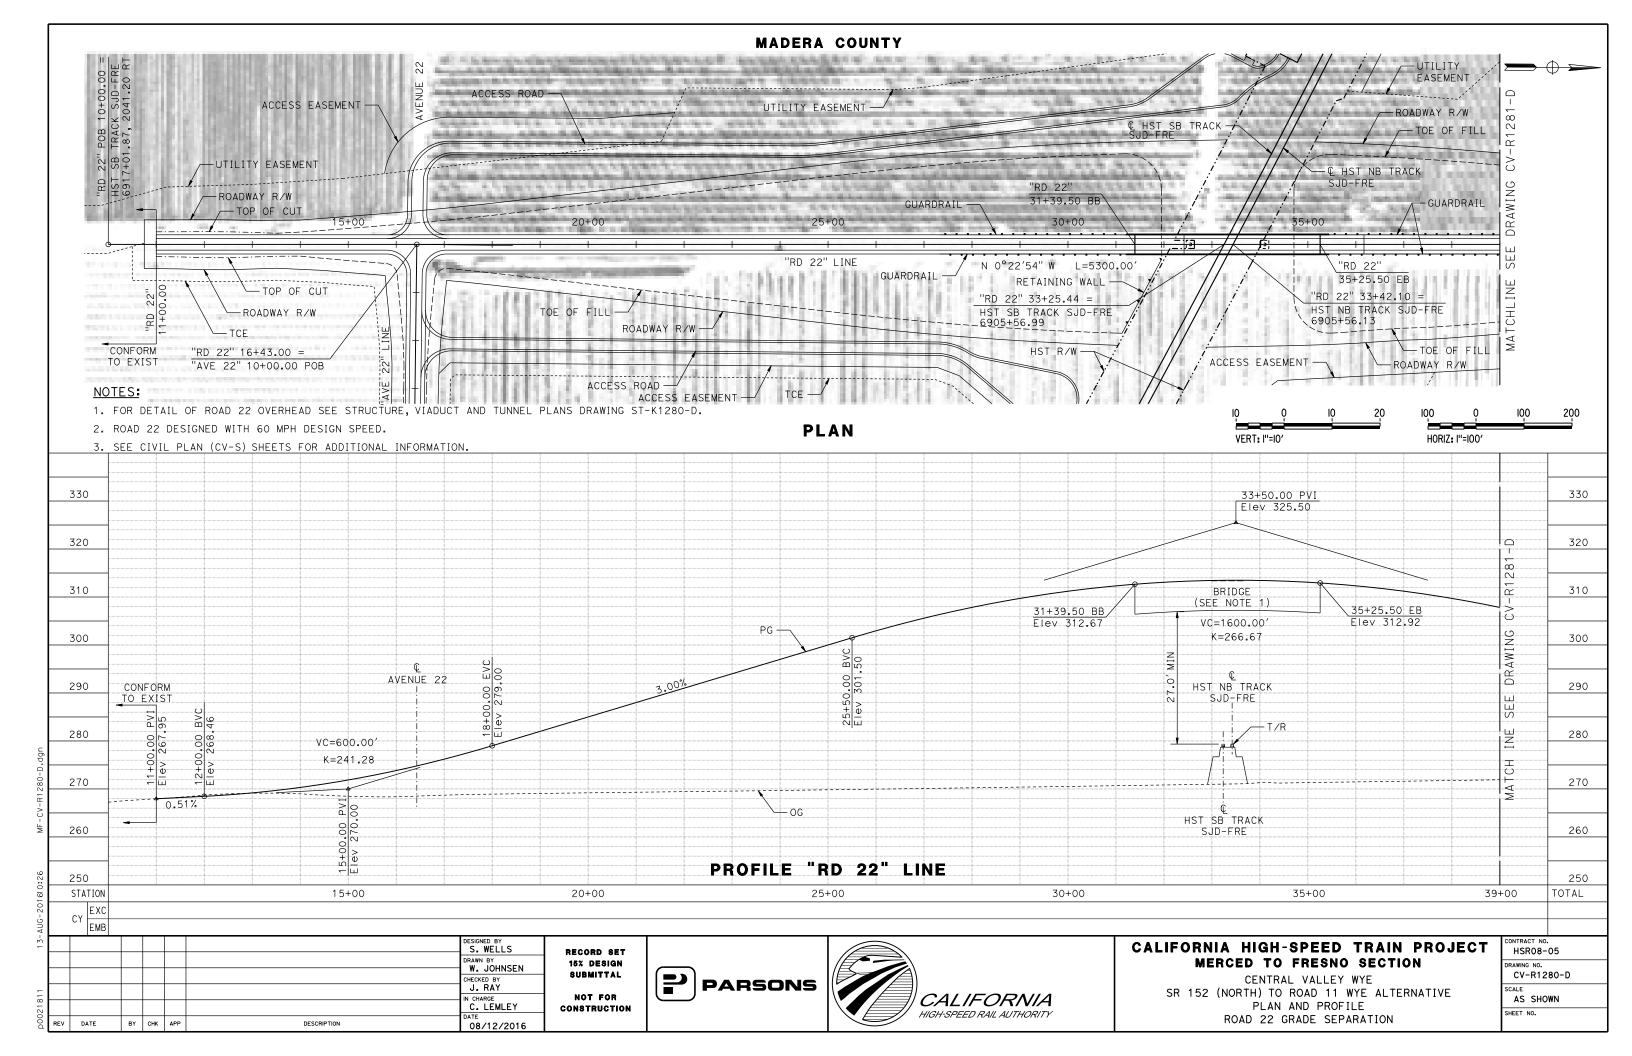


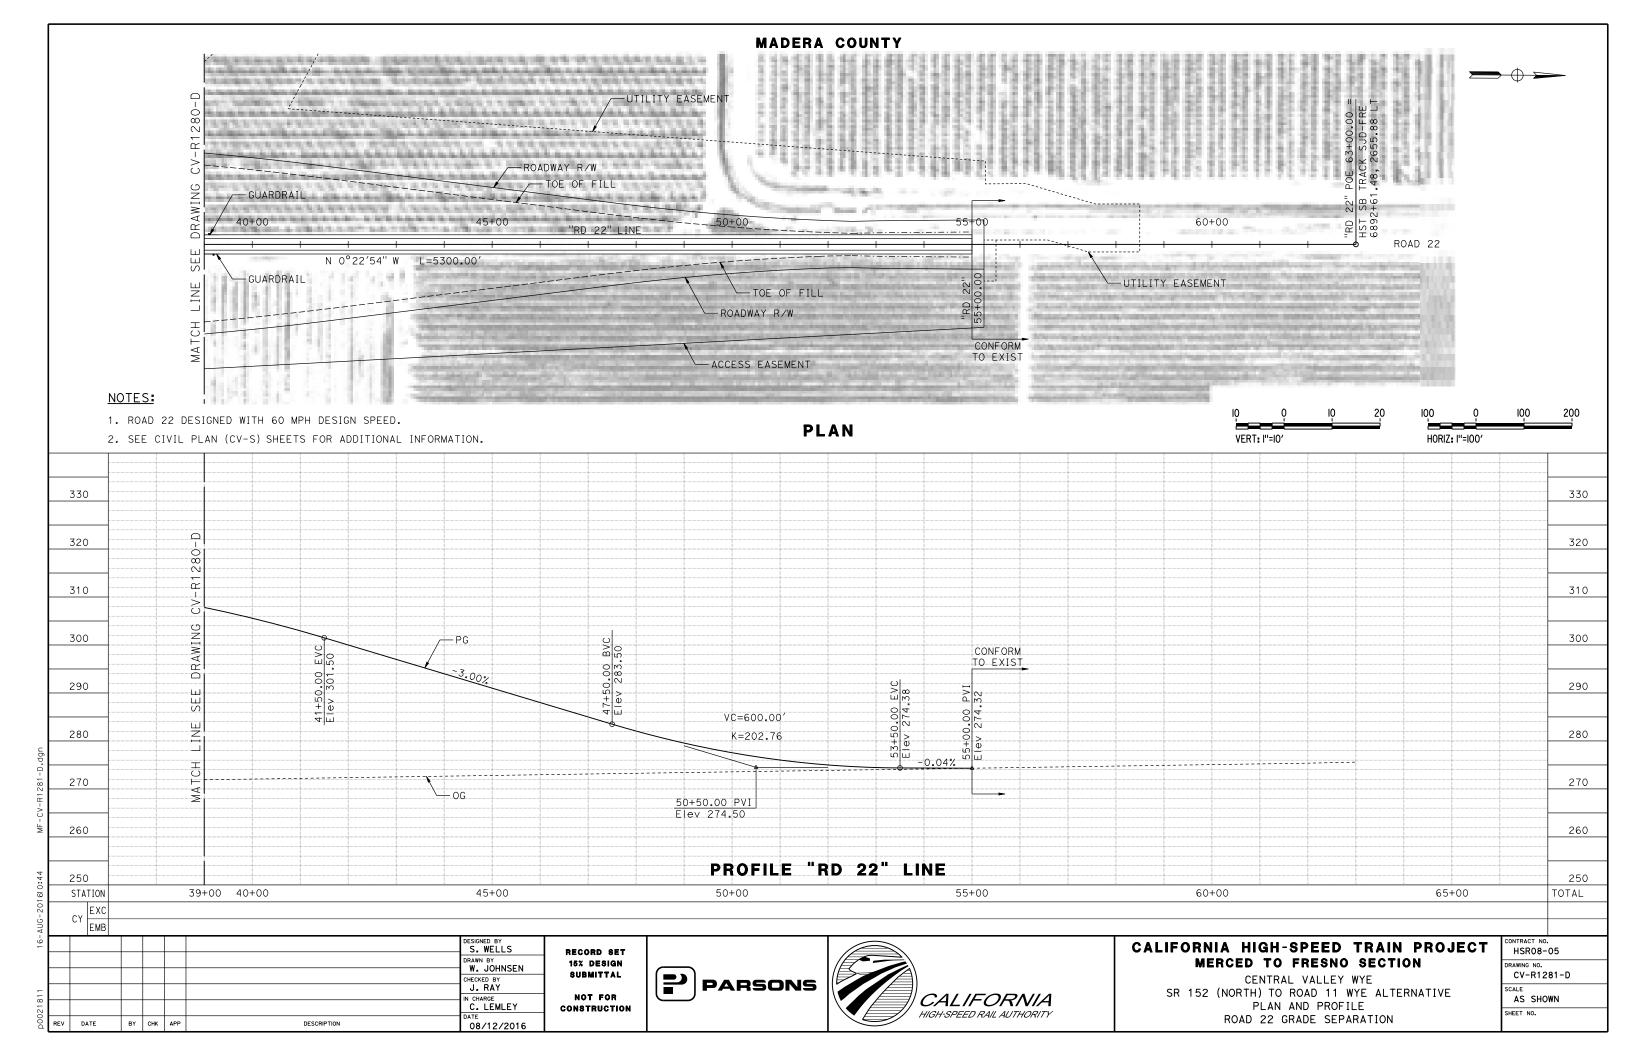


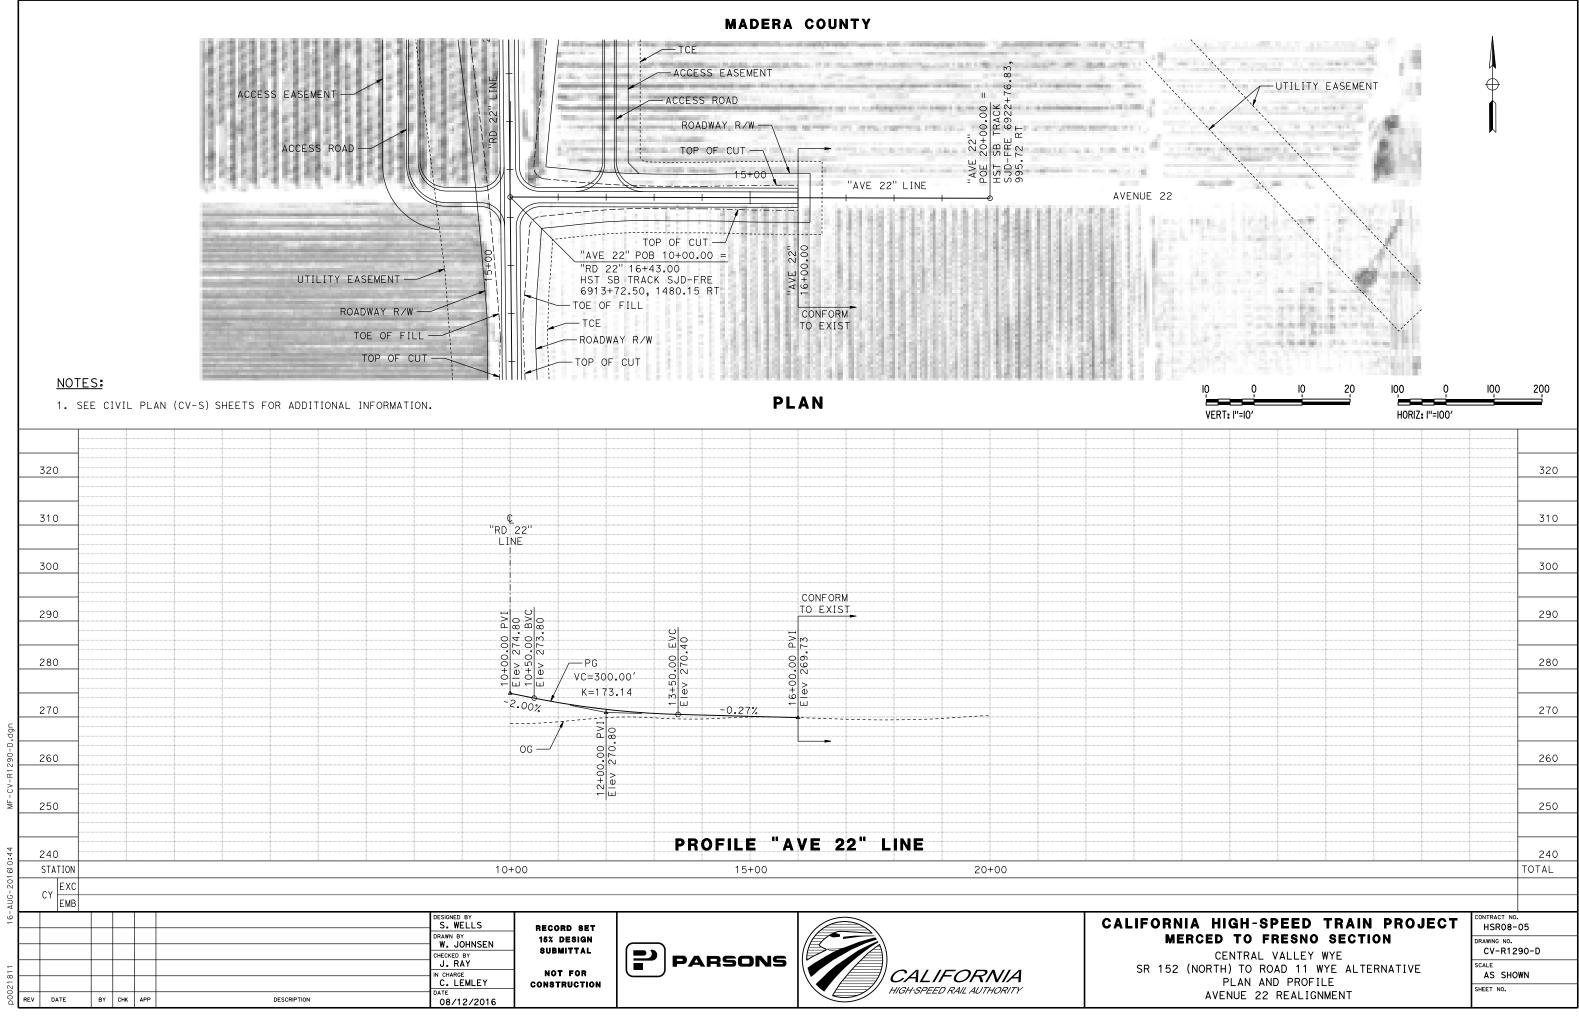


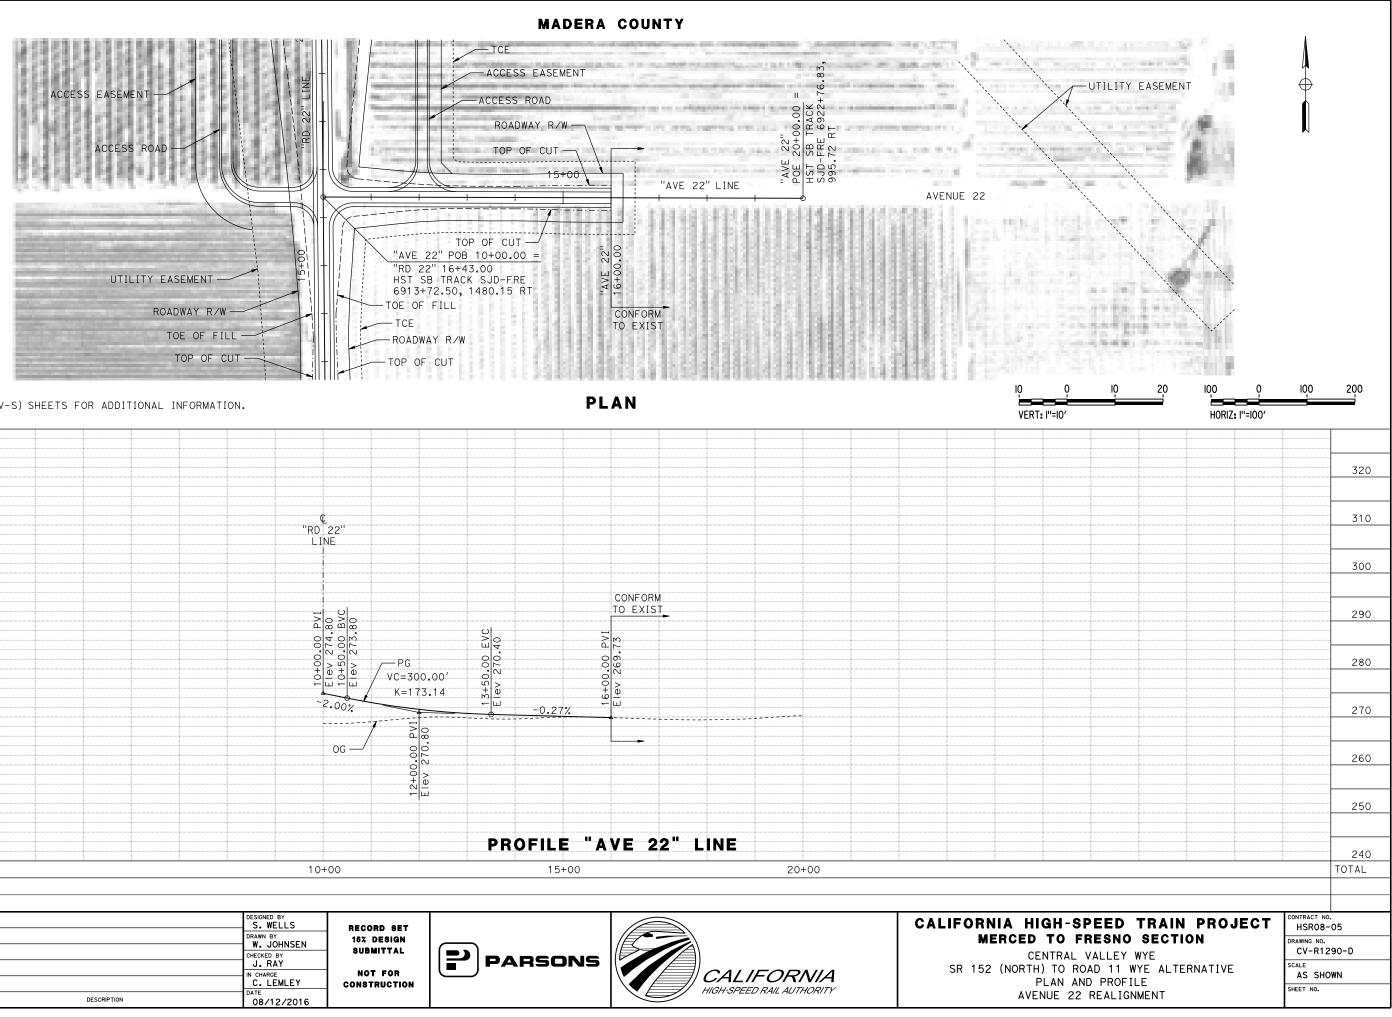


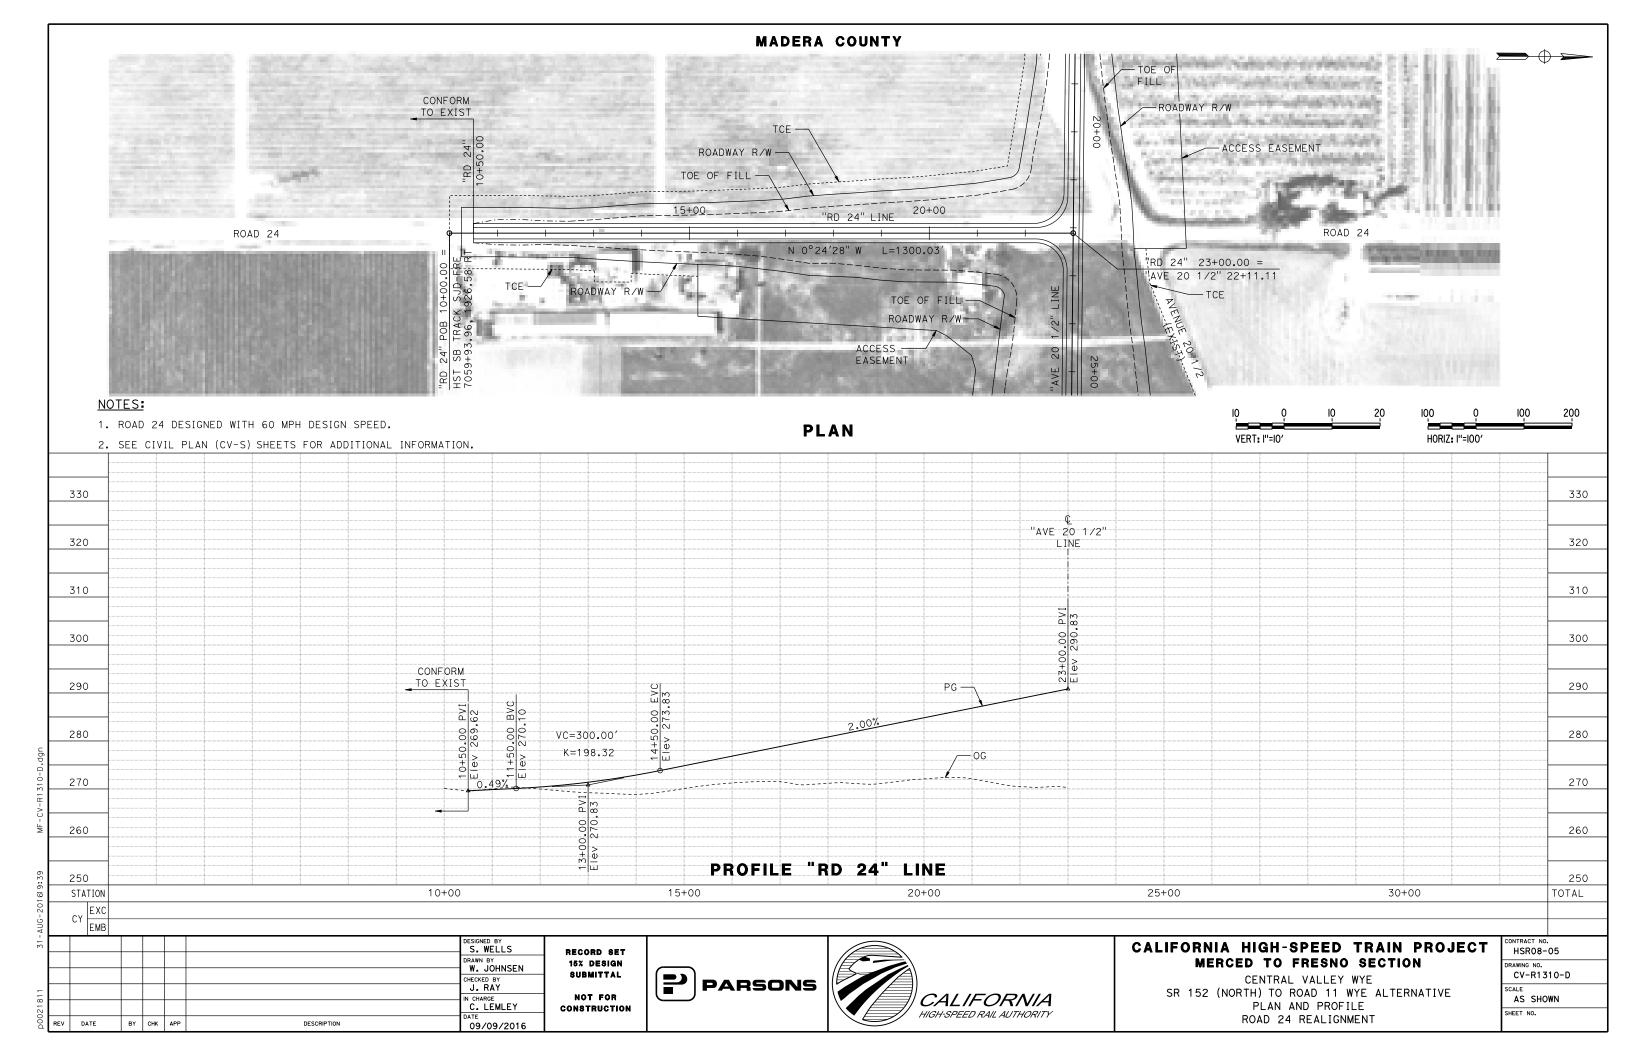


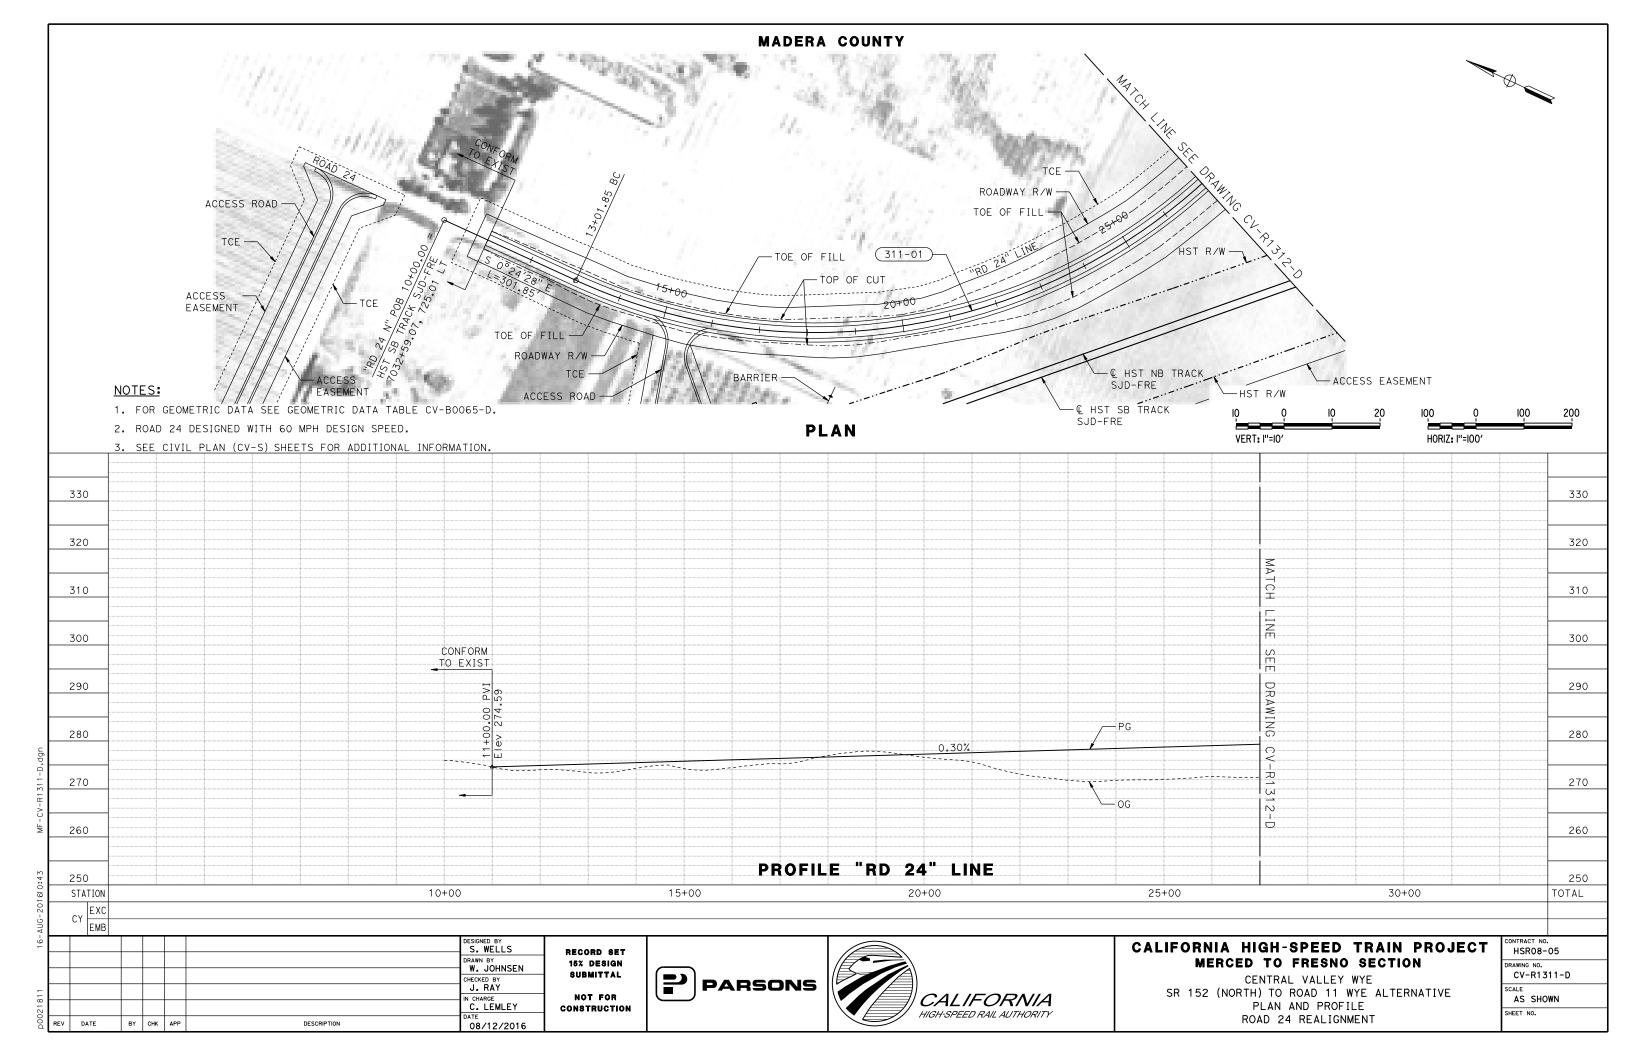


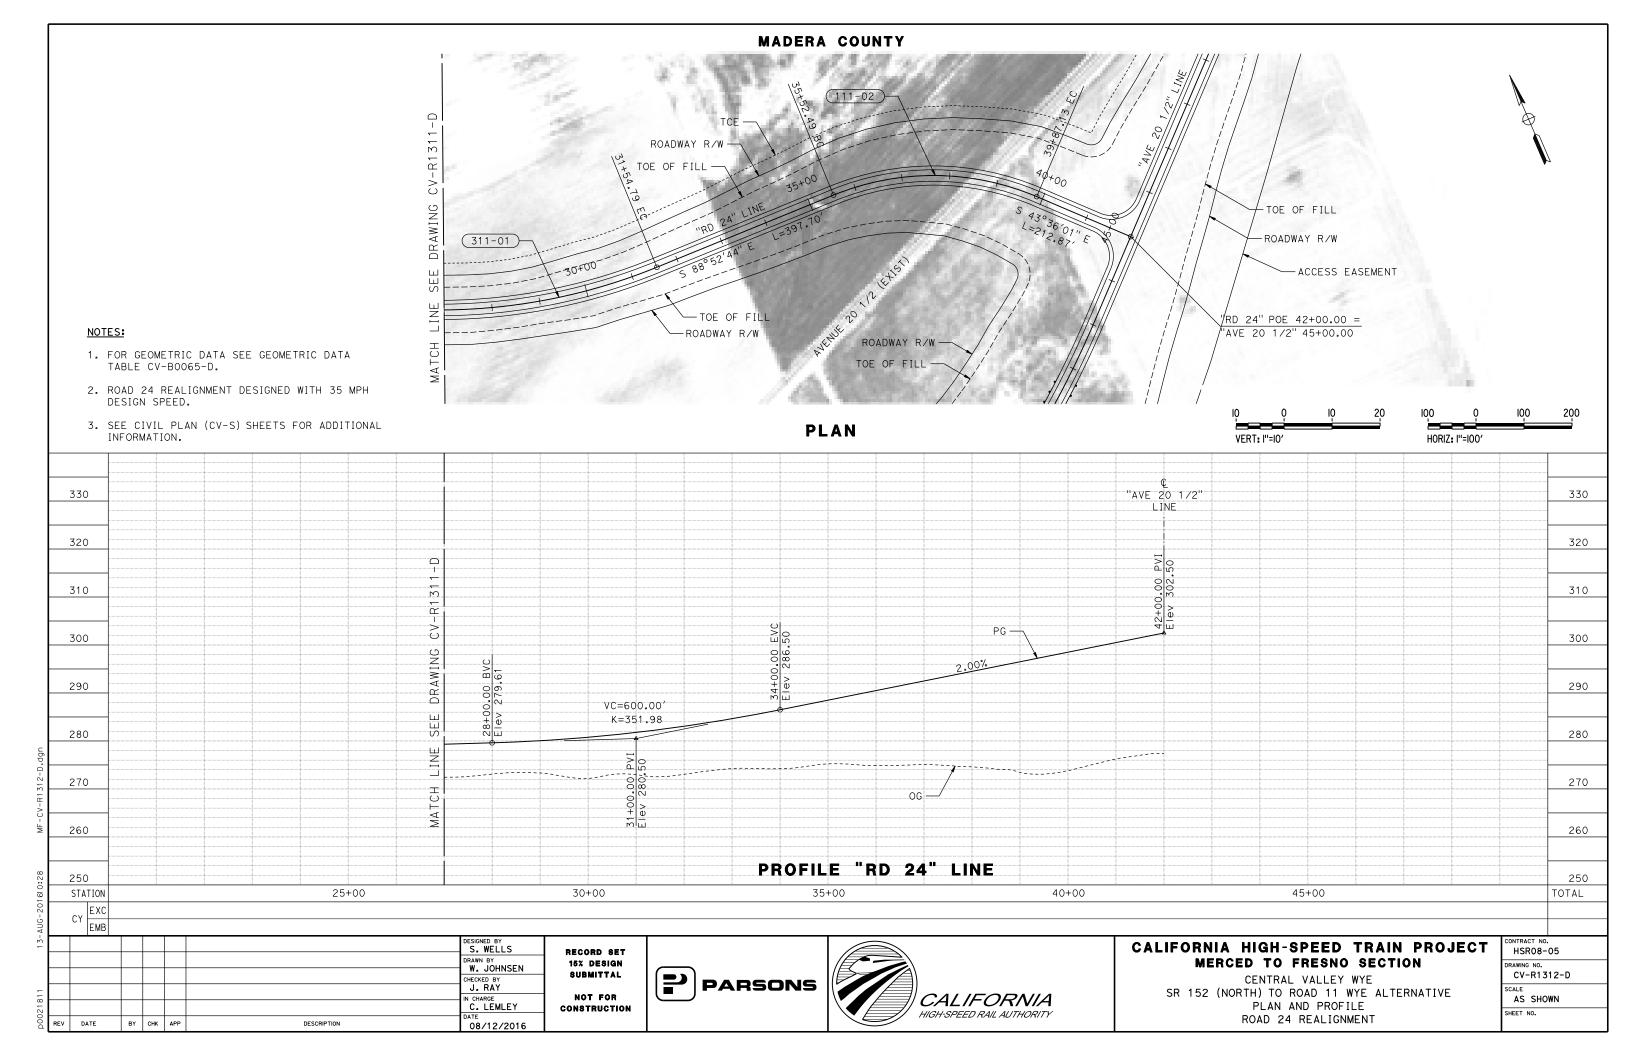


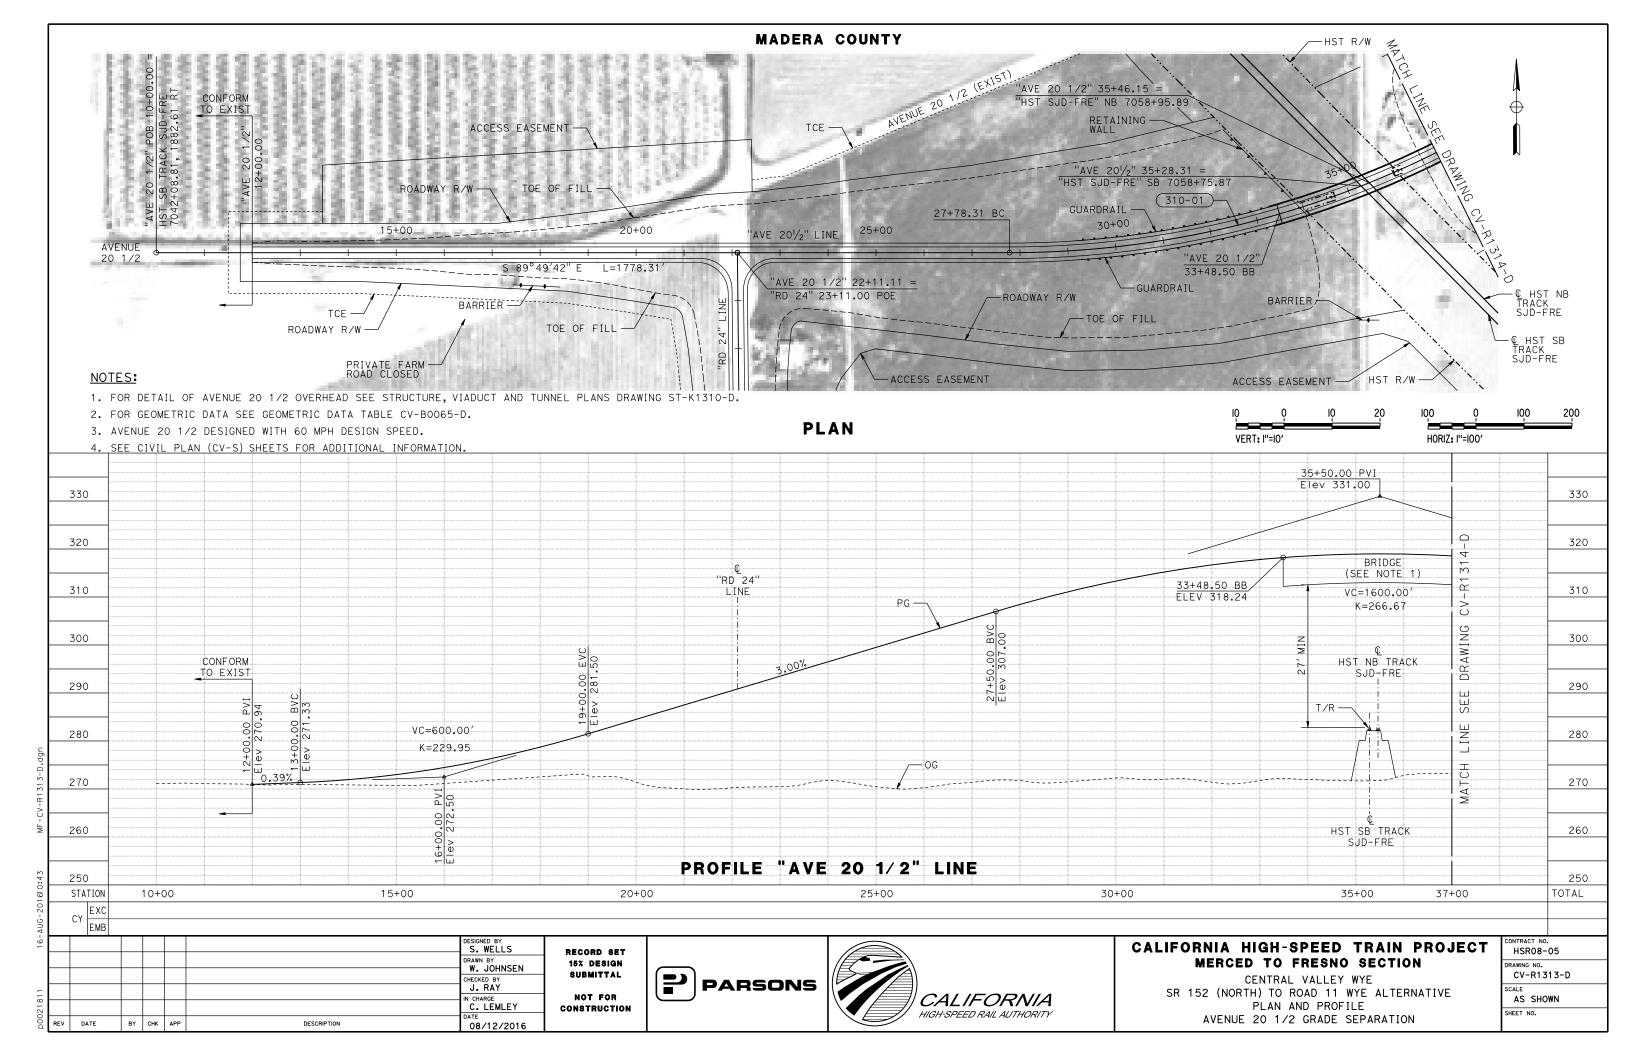


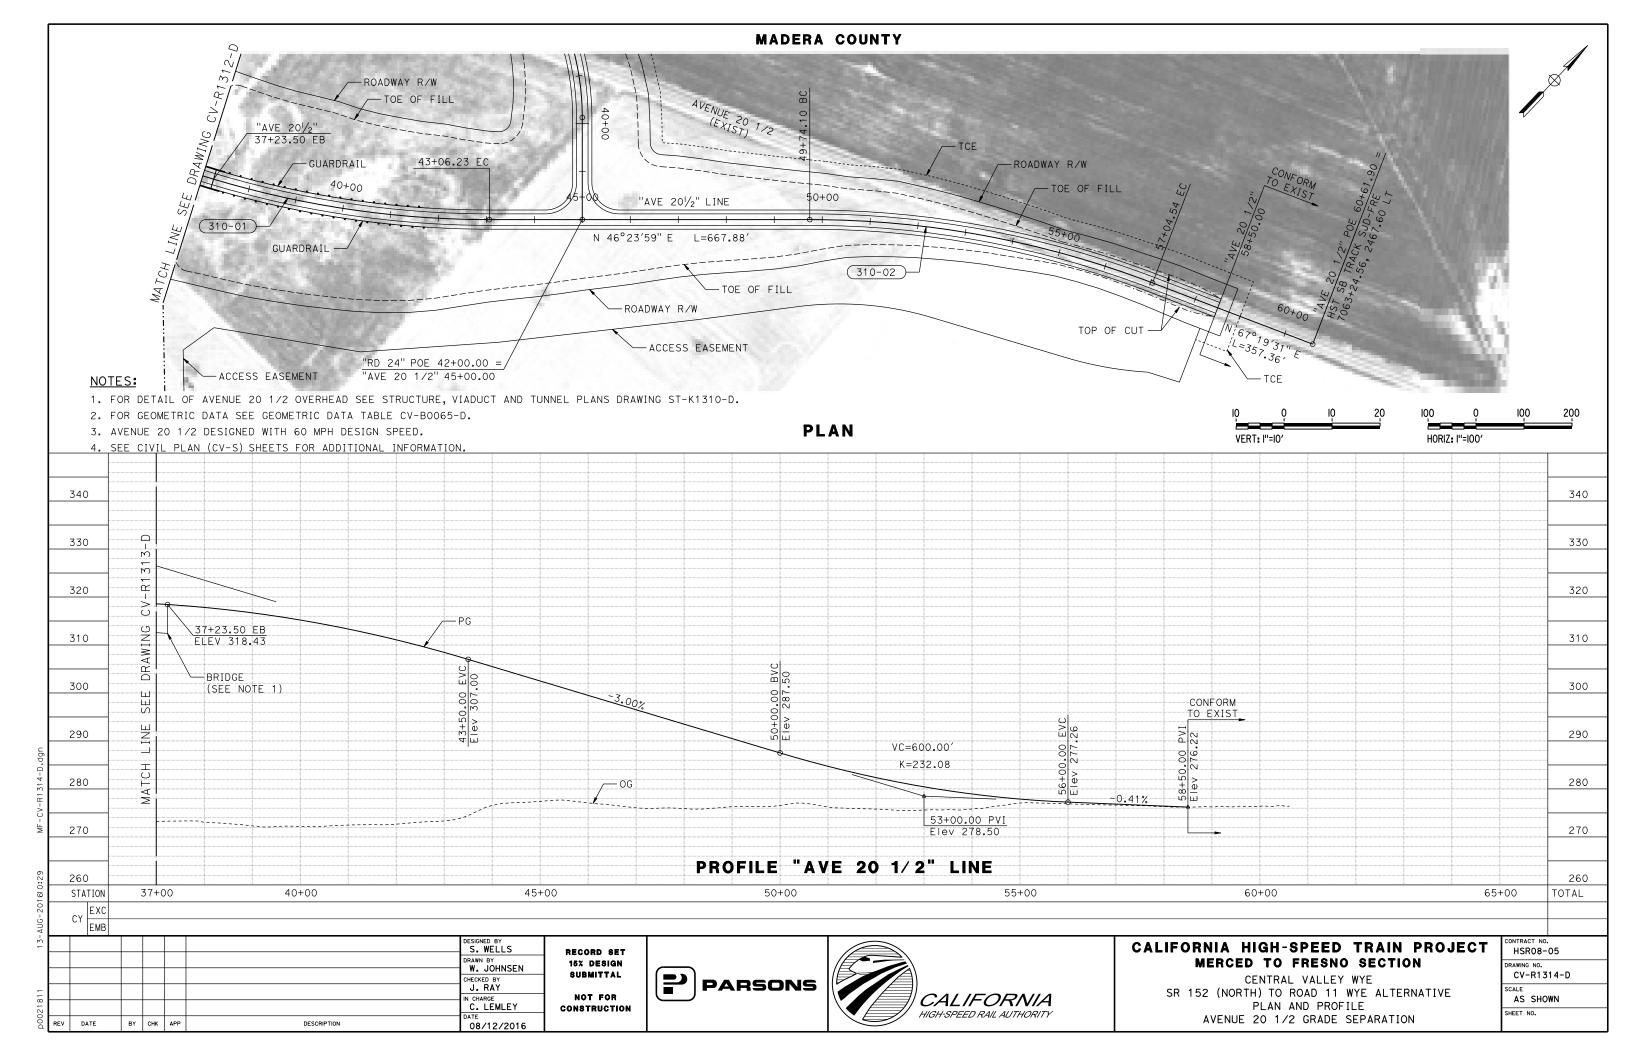


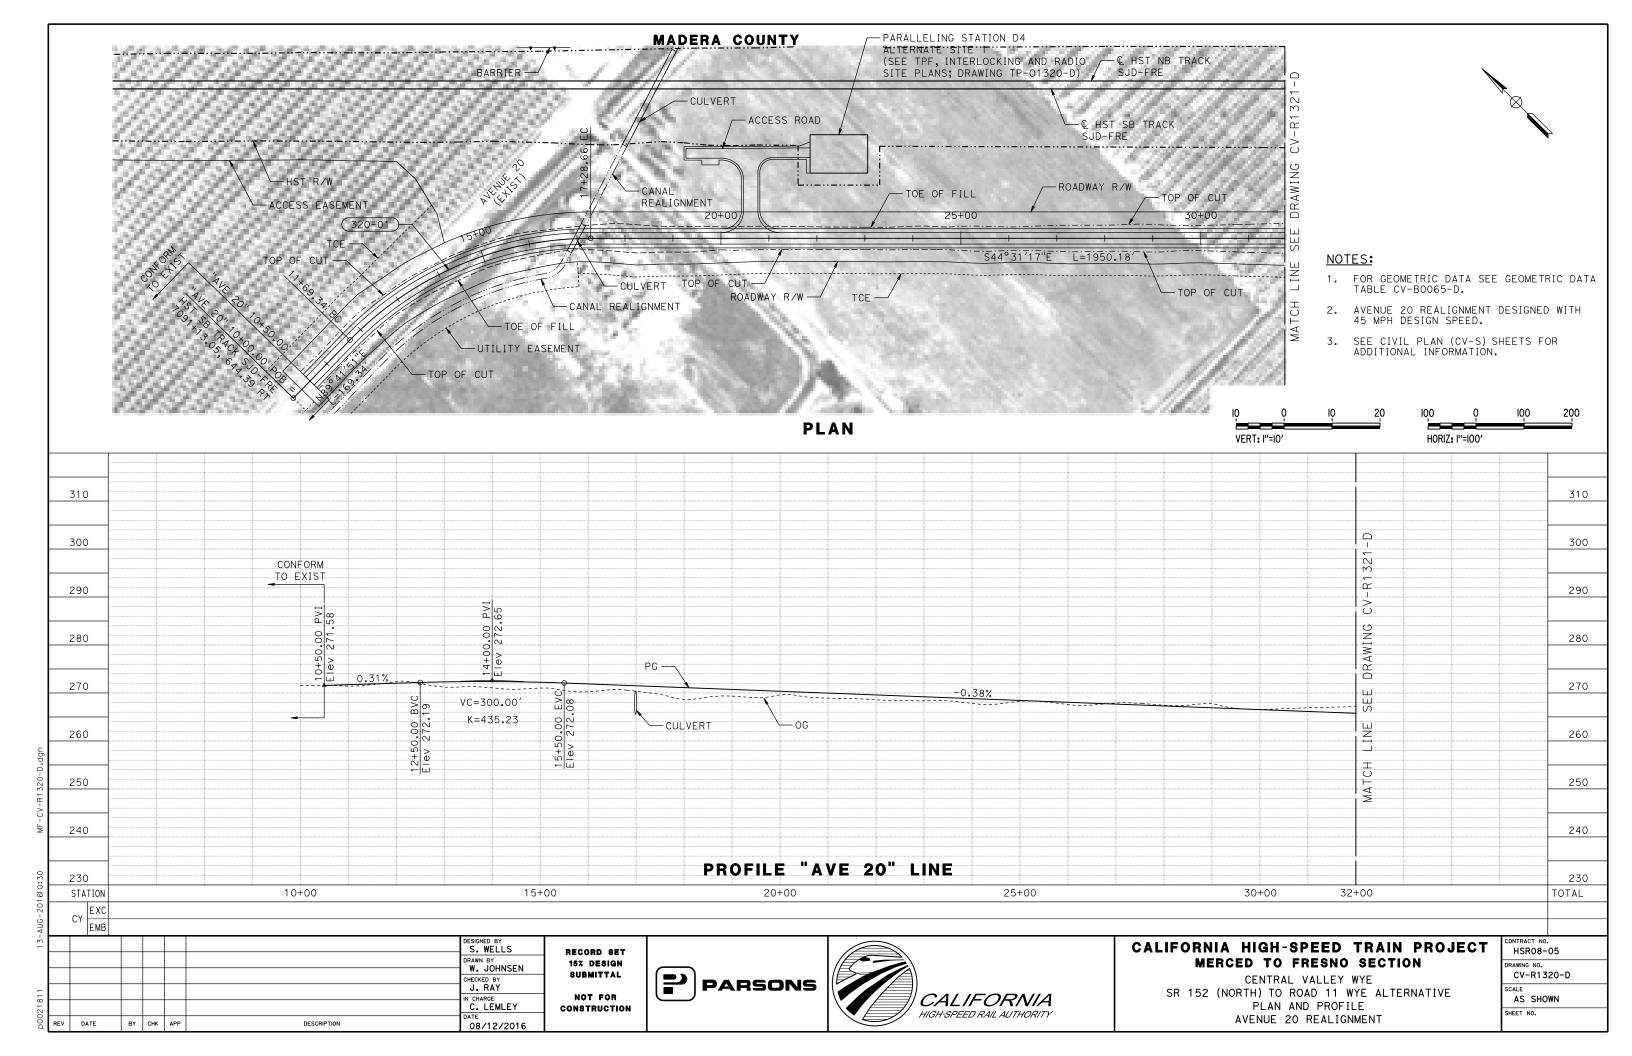


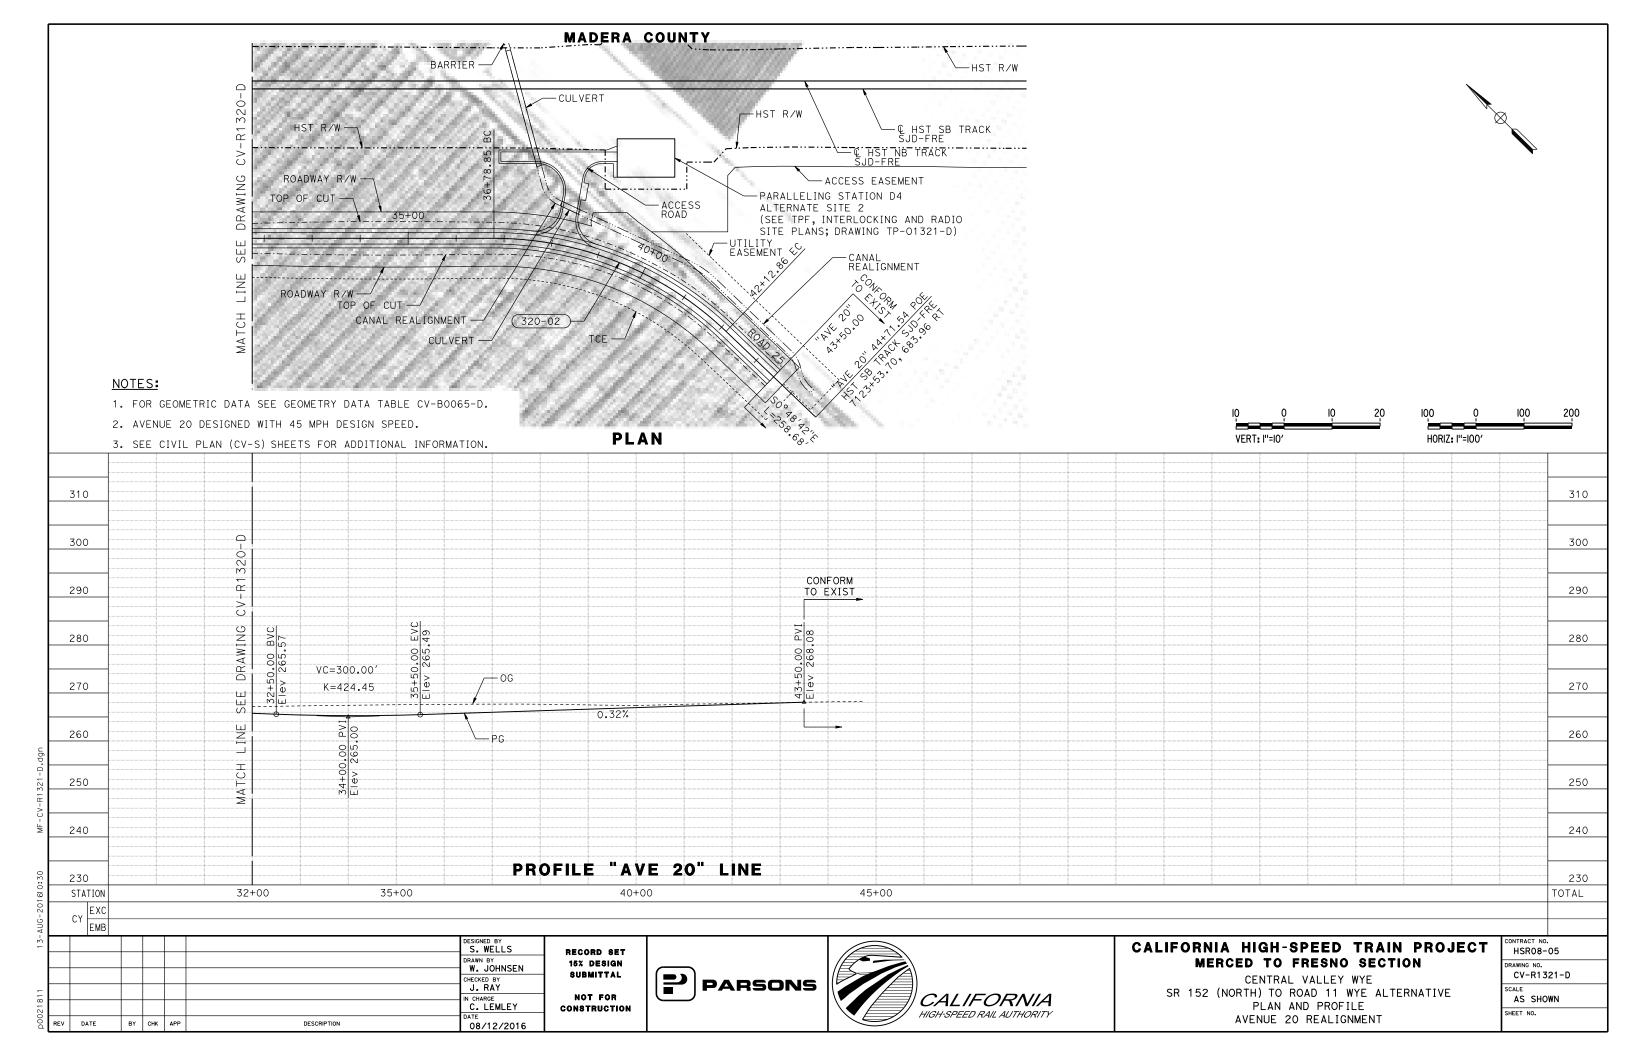


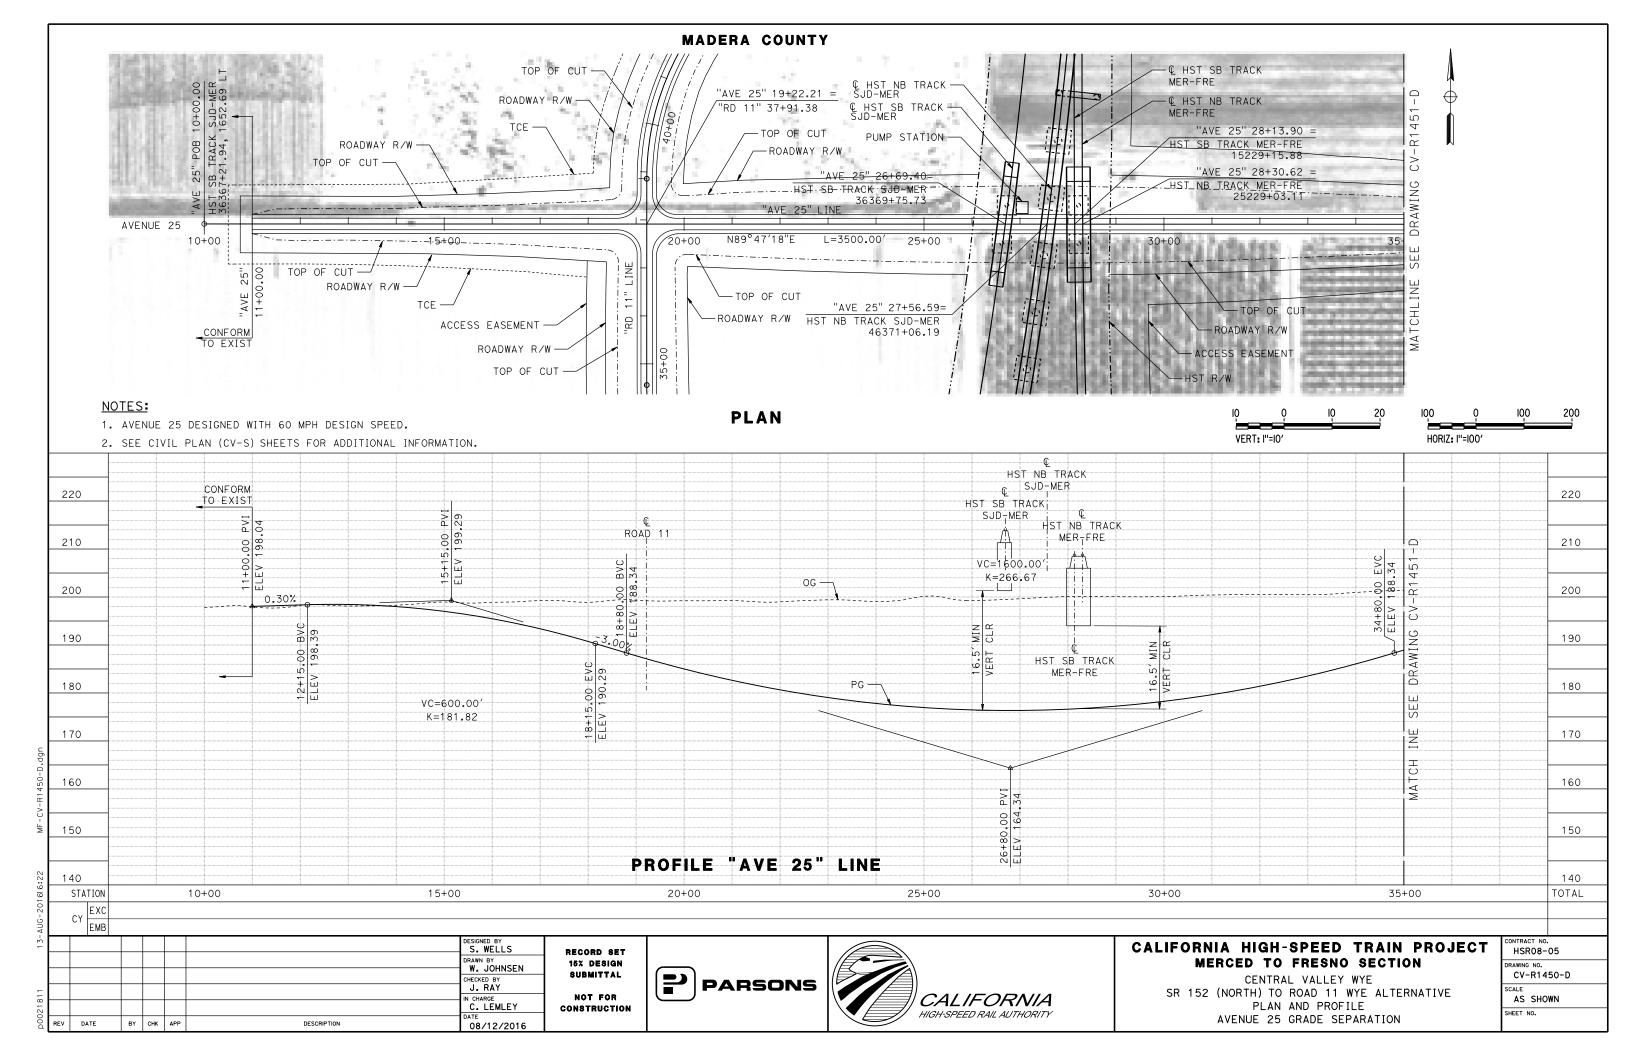


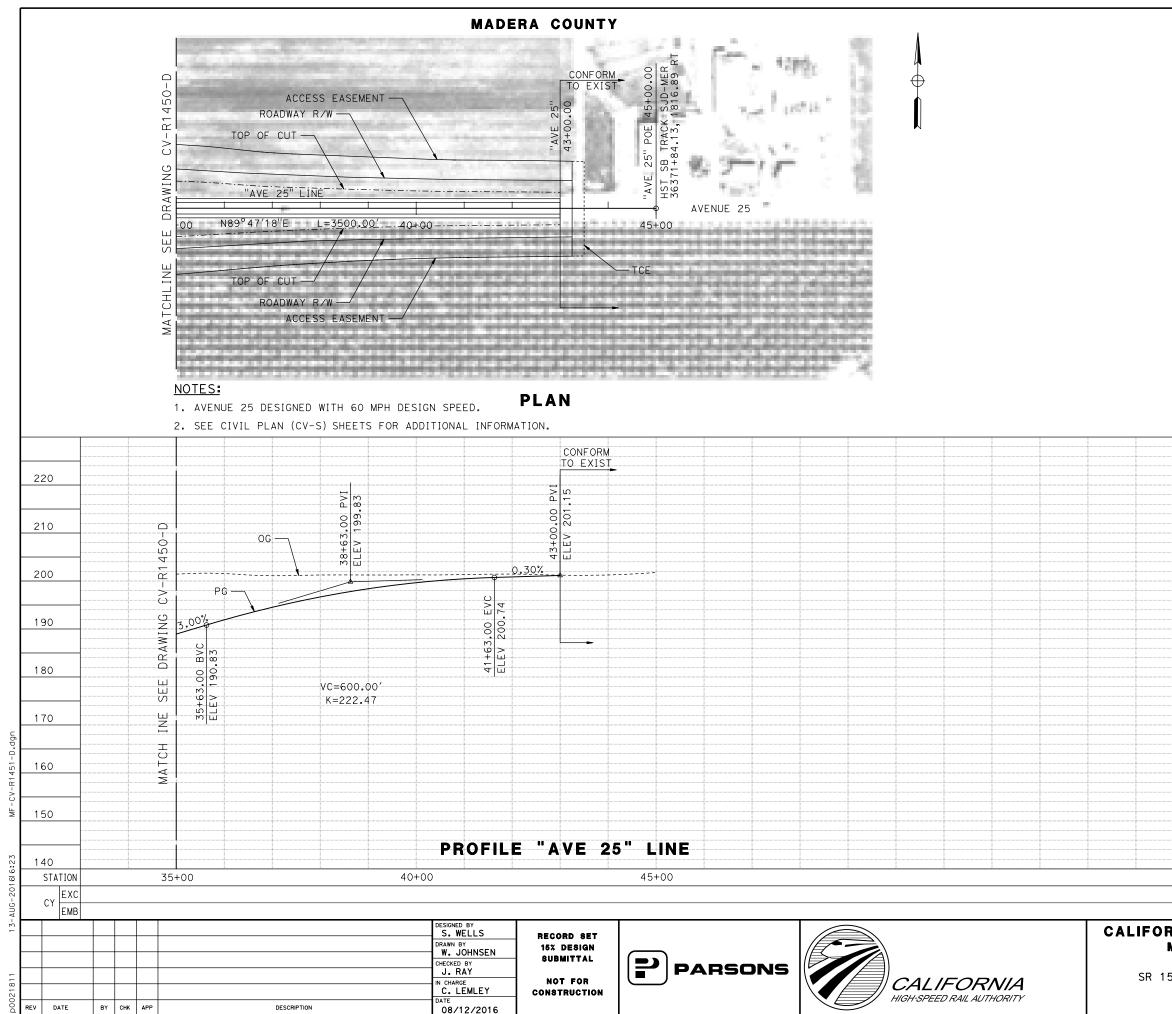




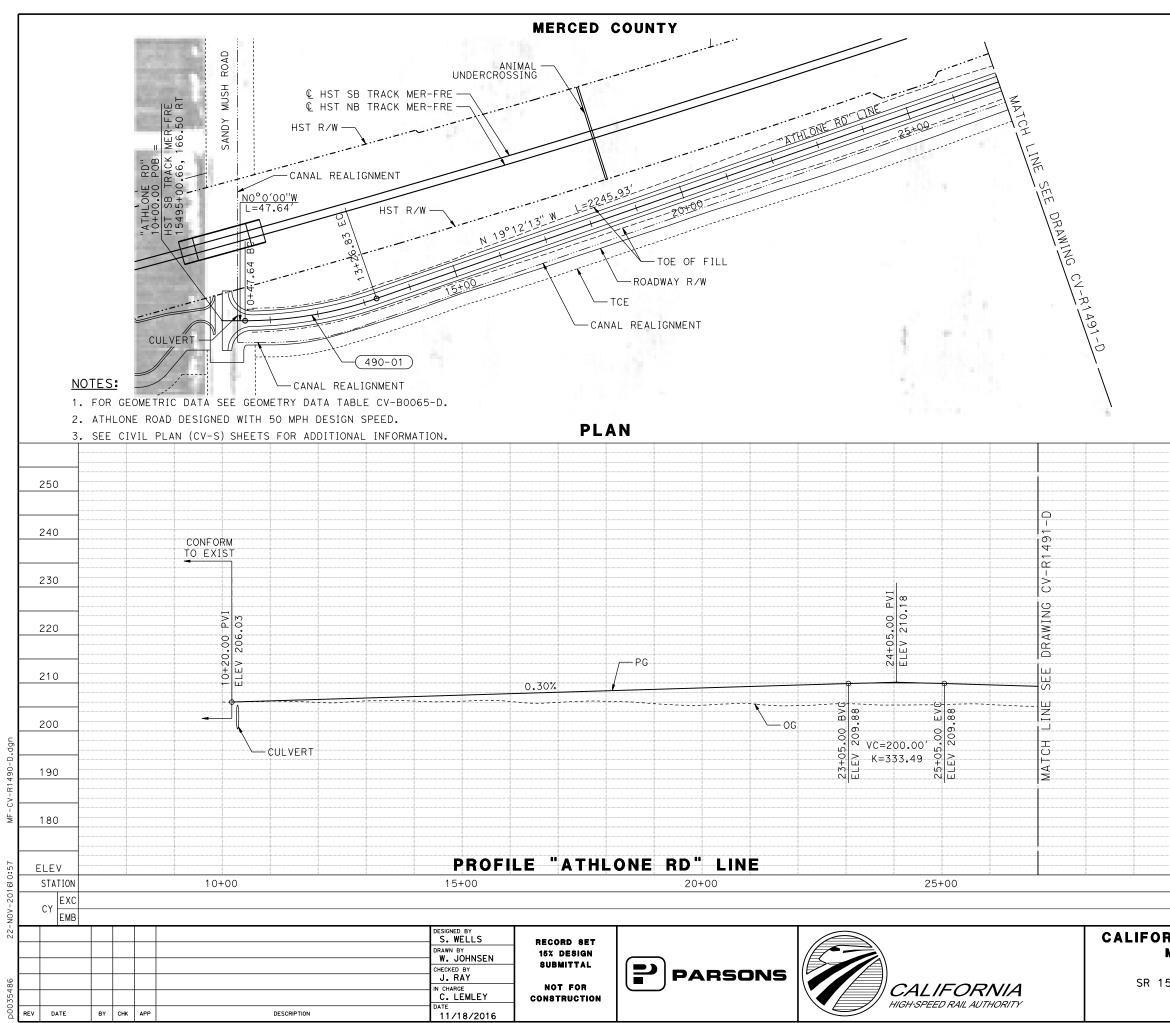




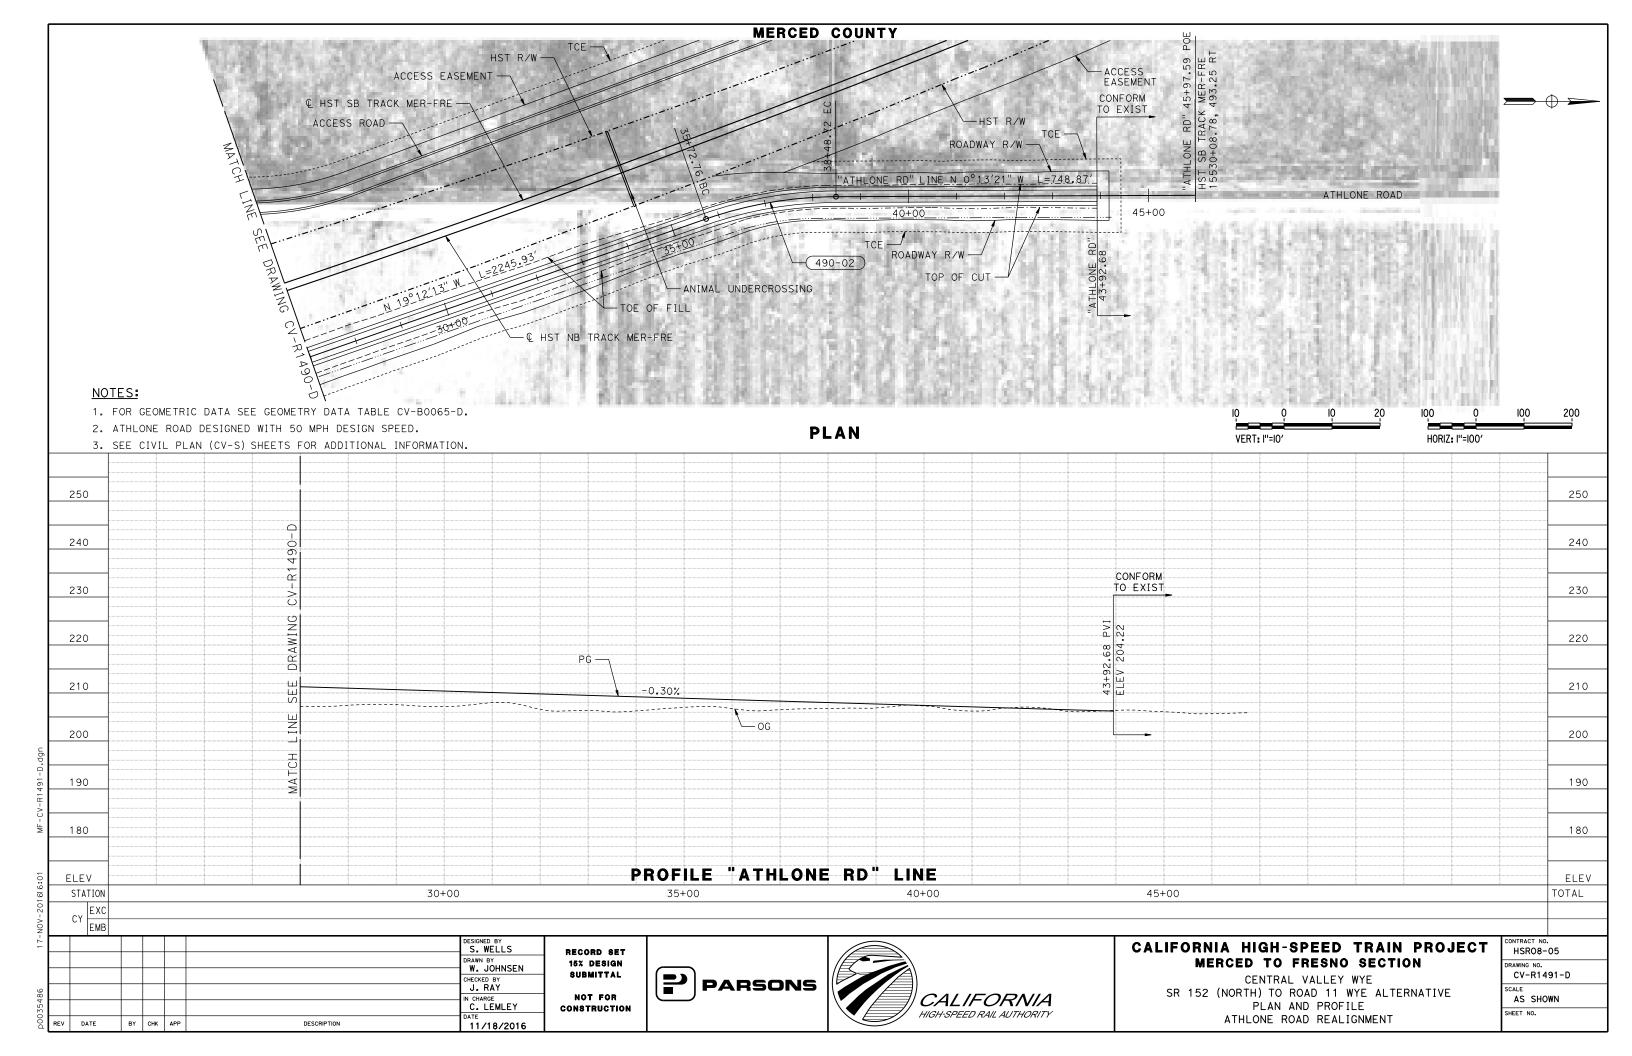


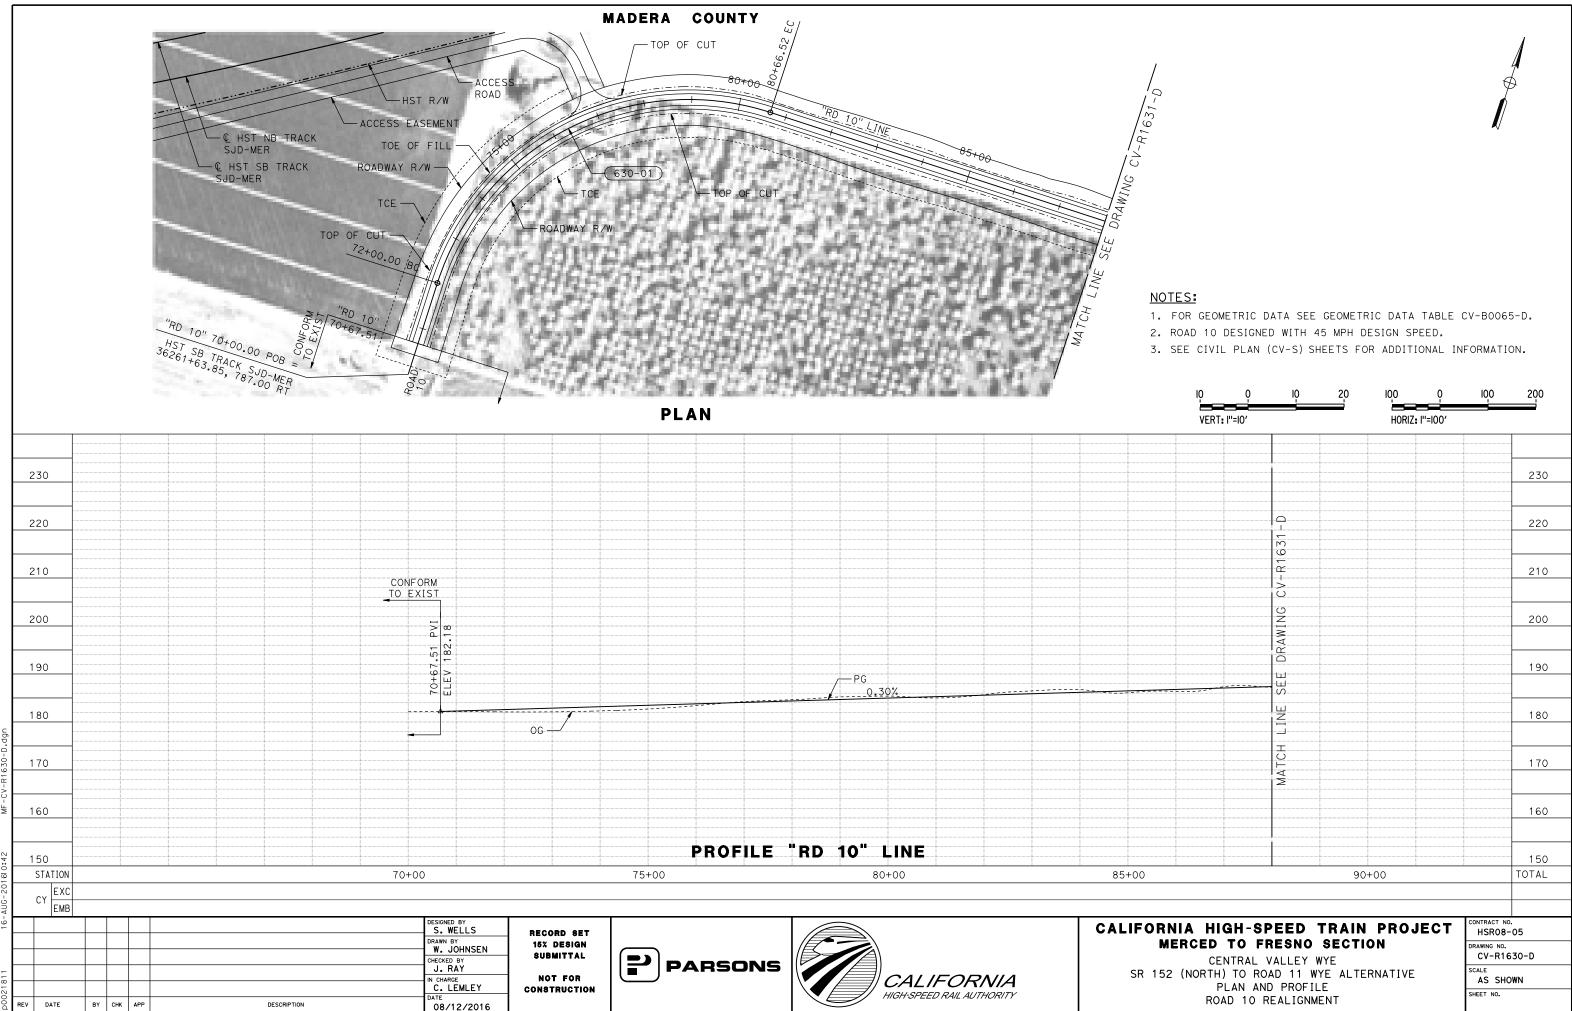


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	PLAN AND PROFILE					AS SH	NMC	
AVENUE 25 GRADE SEPARATION								

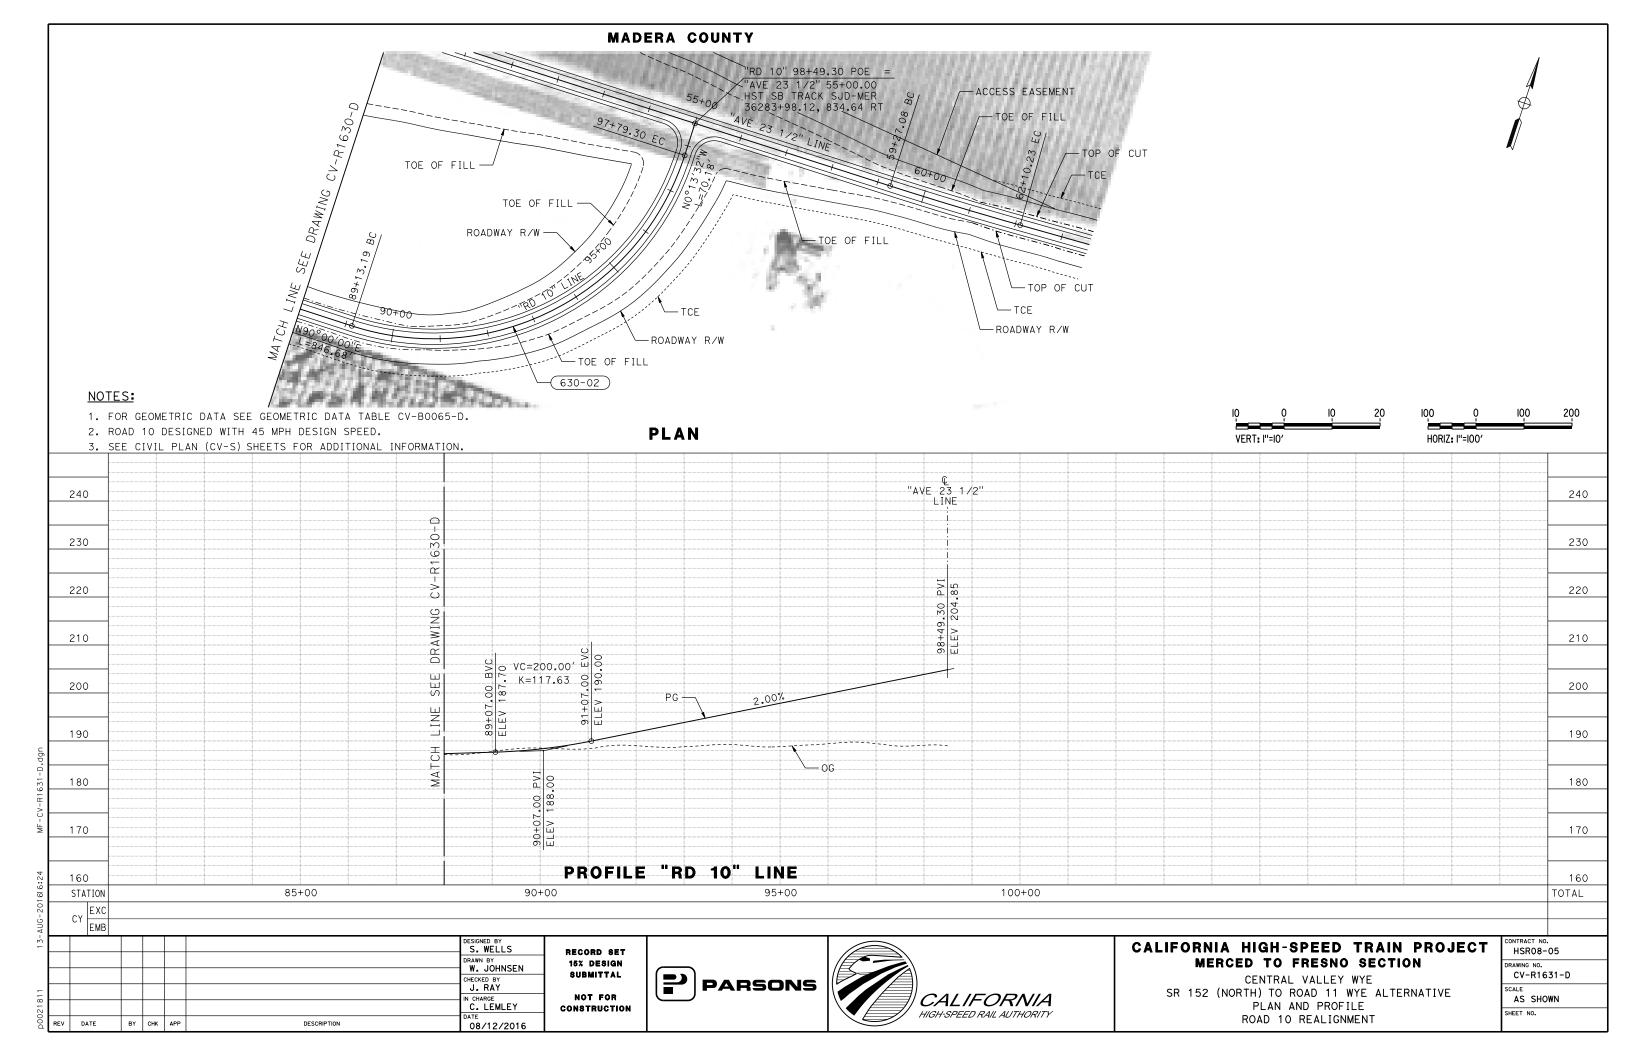


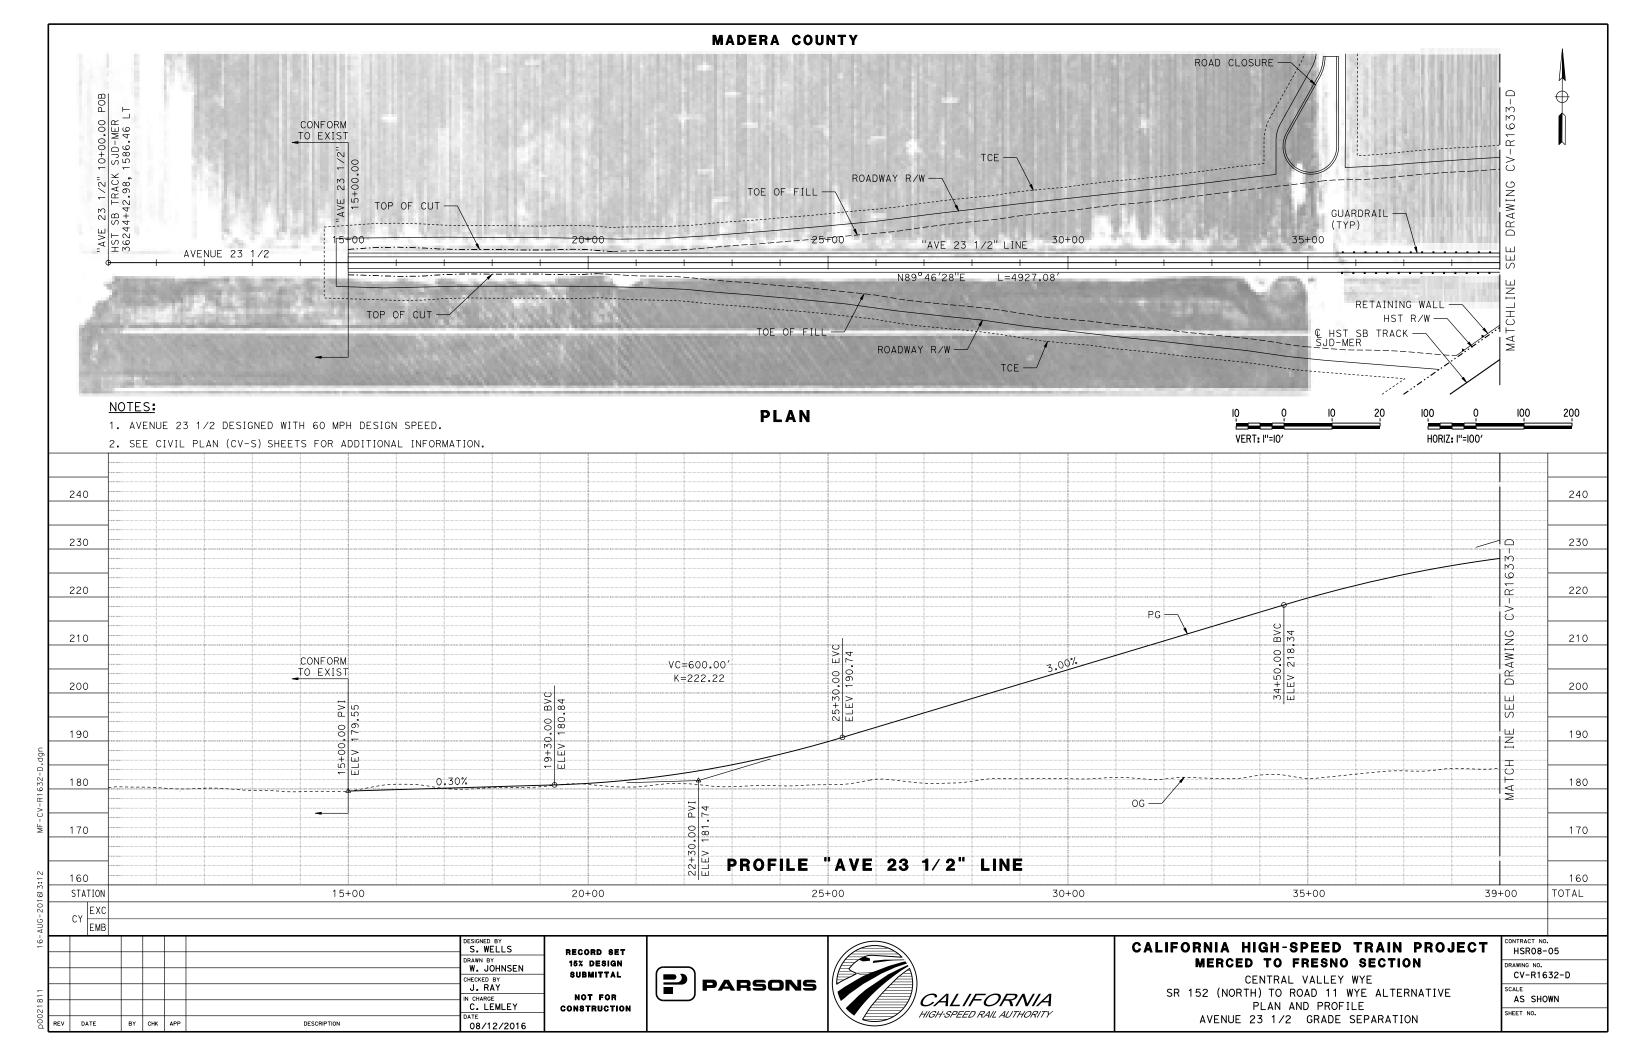
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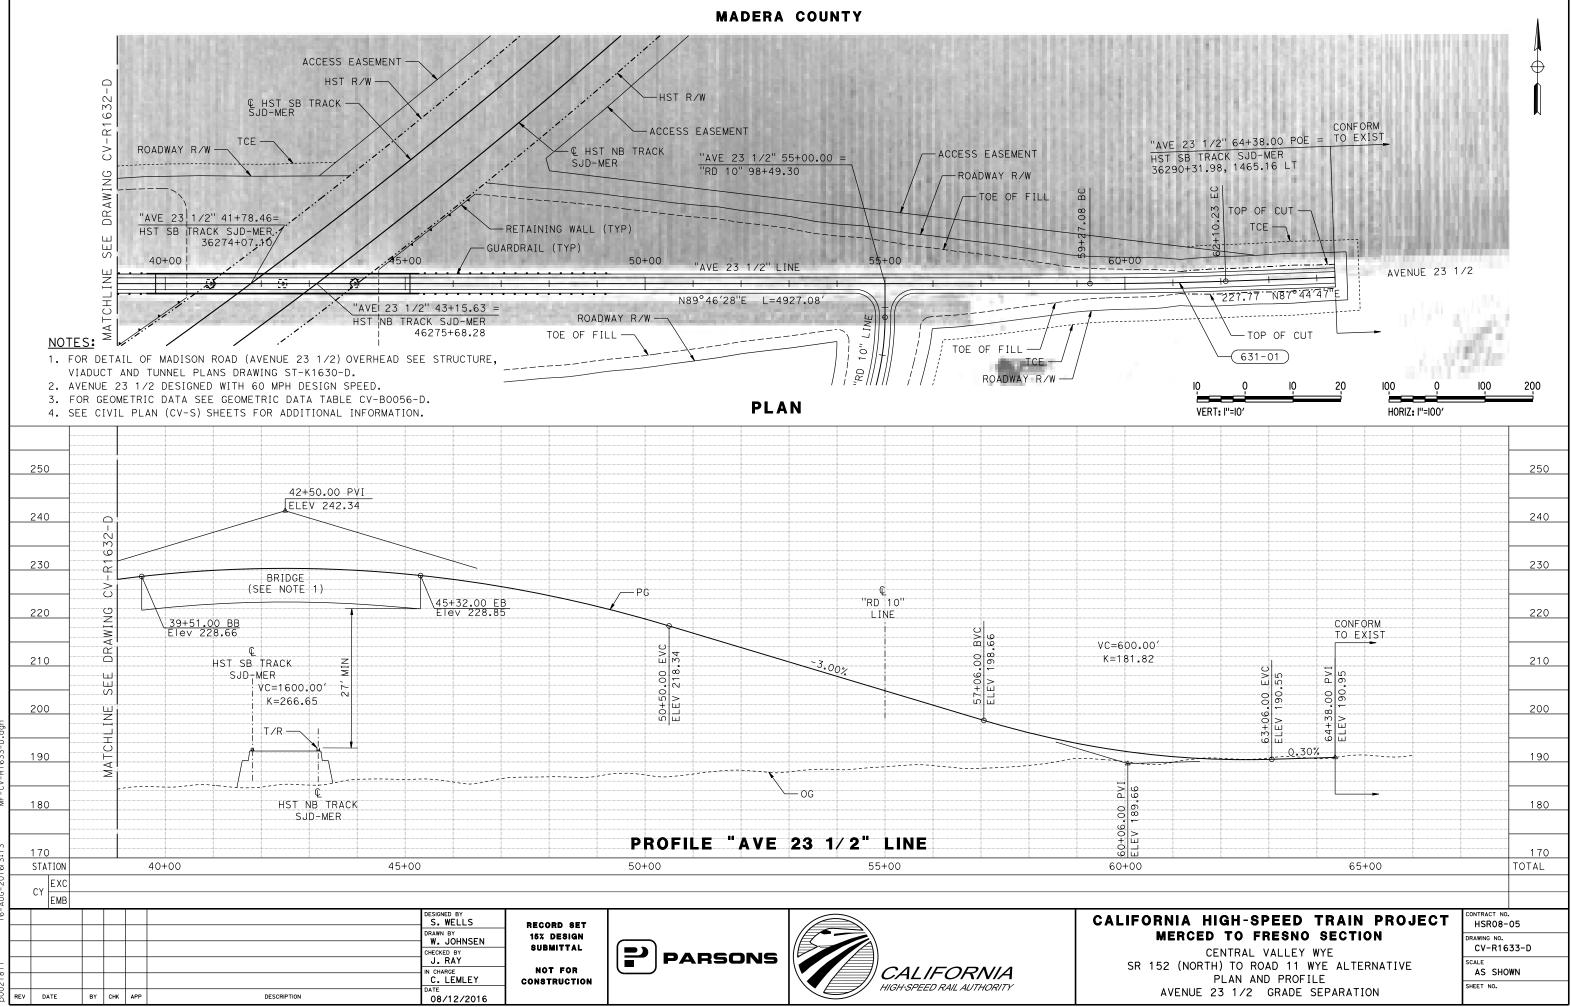


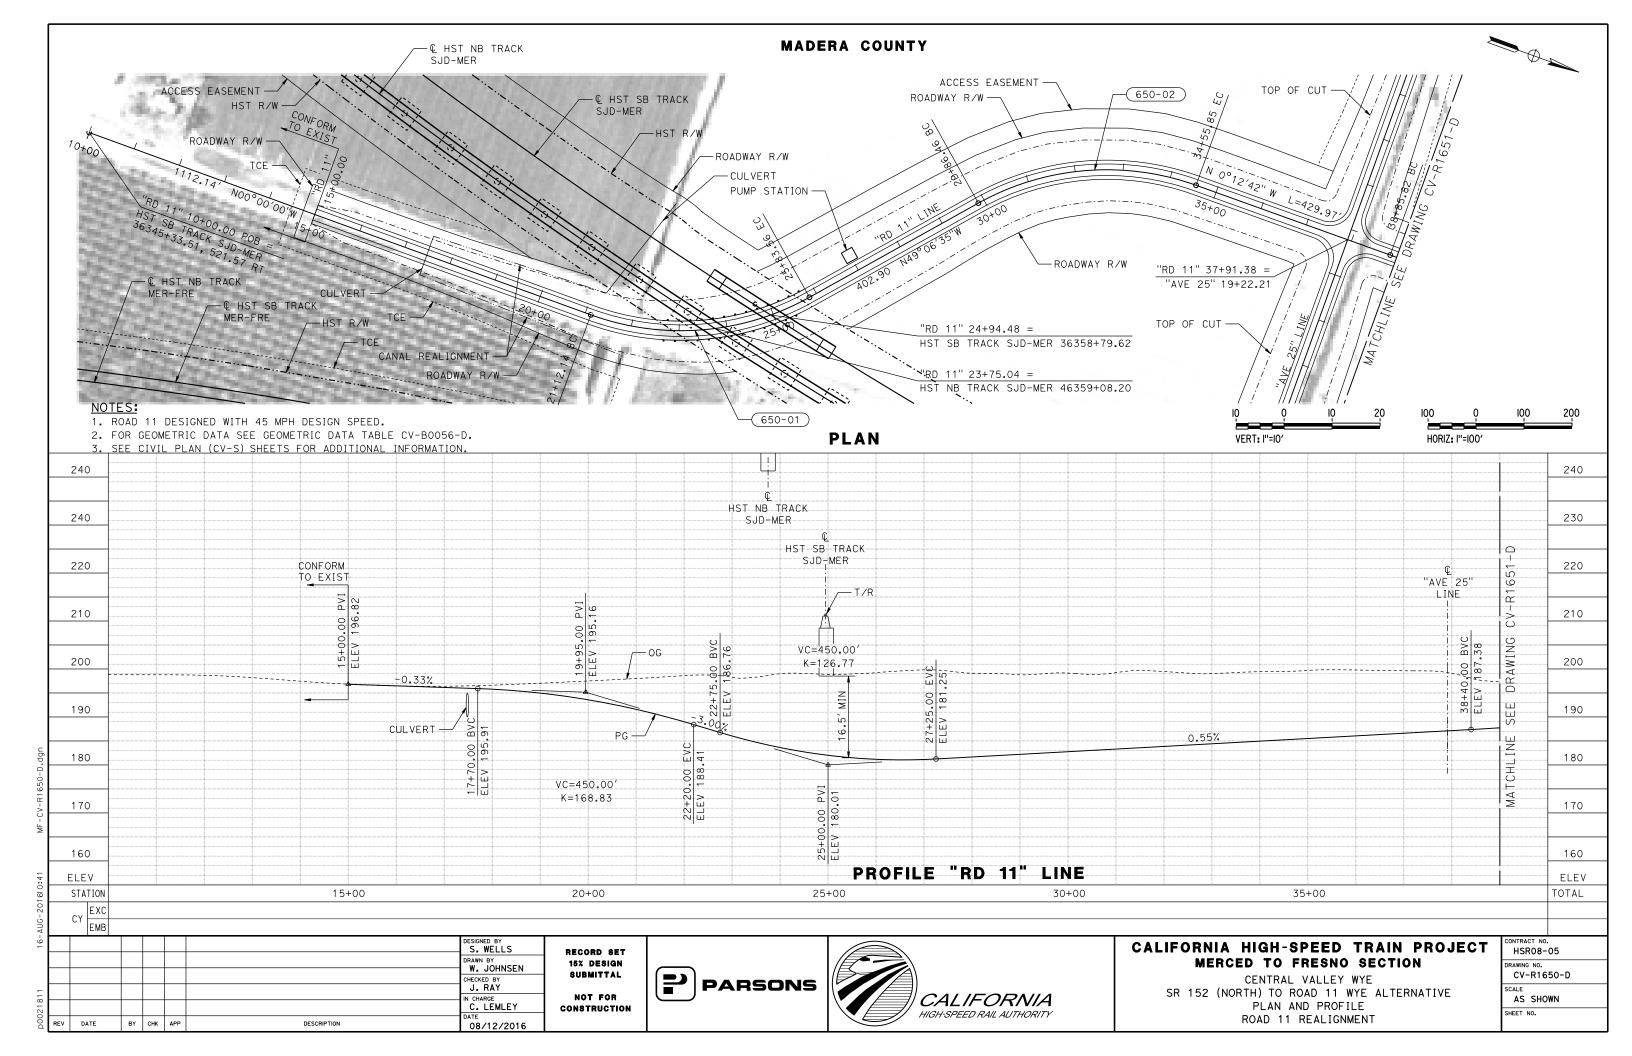


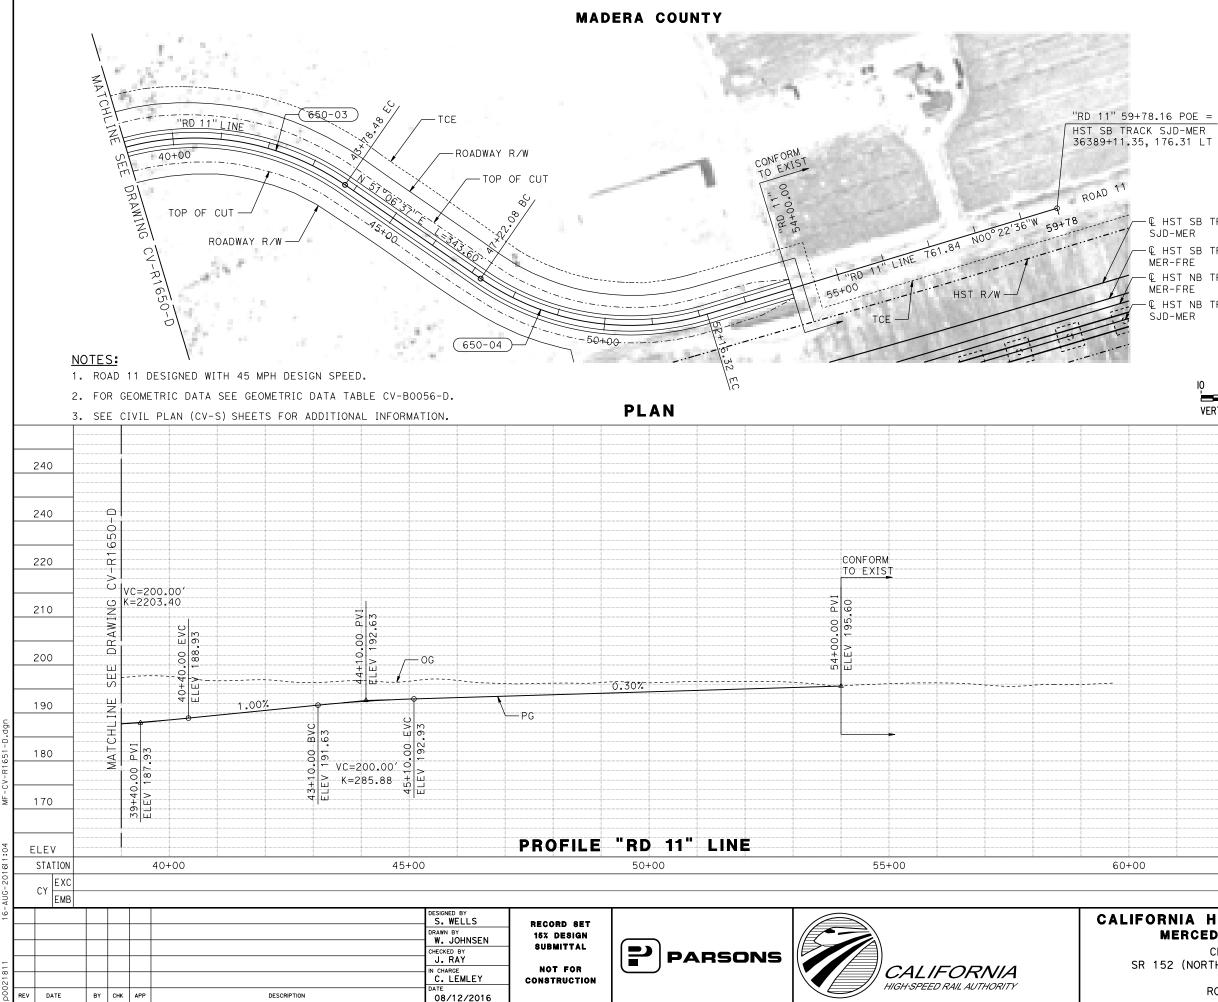














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NIA HIGH-SPEED TRAIN PROJECT Erced to fresno section						CONTRACT NO. HSR08-05 DRAWING NO.		
CENTRAL VALLEY WYE 2 (NORTH) TO ROAD 11 WYE ALTERNATIVE PLAN AND PROFILE ROAD 11 REALIGNMENT						CV-R1651-D SCALE AS SHOWN SHEET NO.		

## CONSTRUCTION STAGING

## INDIANA ROAD DETOUR:

- 1. CONSTRUCT TEMPORARY ROAD ON WEST SIDE OF INDIANA ROAD.
- 2. DURING CONSTRUCTION OF INDIANA ROAD GRADE SEPARATION, DIRECT TRAFFIC ONTO TEMPORARY ROADWAY.
- 3. RESTORE TRAFFIC TO INDIANA ROAD UPON COMPLETION OF ROADWAY REALIGNMENT WORK.
- 4. REMOVE TEMPORARY ROADWAY.

#### SR 59 DETOUR:

1. FOR STAGE CONSTRUCTION DETAIL OF SR 59 SEE DRAWINGS CV-I4100-D TO CV-I4103-D.

## ROAD 4 / LINCOLN ROAD DETOUR:

- 1. DURING CONSTRUCTION OF ROAD 4 / LINCOLN ROAD GRADE SEPARATION, DETOUR NB TRAFFIC TO EB AVE 21, NB ROAD 6, WB SR 152, NB RD 5 THEN WB AVENUE 23 1/2.
- 2. DETOUR SB TRAFFIC TO EB AVENUE 23 1/2, SB RD 5, EB SR 152, SB ROAD 6, THEN WB AVE 21.
- 3. RESTORE TRAFFIC TO ROAD 4 / LINCOLN RD UPON COMPLETION OF GRADE SEPARATION WORK.

## ROAD 9 / HEMLOCK ROAD DETOUR:

 FOR STAGE CONSTRUCTION DETAIL OF RD 9 / HEMLOCK RD SEE DRAWINGS CV-I4160-D TO CV-I4163-D.

### ROAD 12 DETOUR:

- 1. DURING CONSTRUCTION OF RD 12 GRADE SEPARATION, DETOUR NB TRAFFIC TO EB AVE 22 1/2, NB RD 13, THEN WB AVE 24.
- 2. DETOUR SB TRAFFIC TO EB AVE 24, SB RD 13, THEN WB AVE 22 1/2.
- 3. RESTORE TRAFFIC TO RD 12 UPON COMPLETION OF GRADE SEPARATION WORK.

#### SR 152 AT ROAD 12 DETOUR:

- 1. CONSTRUCT PROPOSED EASTBOUND AND WESTBOUND LANES OF SR 152.
- 2. SHIFT EASTBOUND AND WESTBOUND SR 152 TRAFFIC ONTO PROPOSED SR 152 REALIGNMENT.
- 3. DEMOLISH EXISTING SR 152.

## SR 233 / ROBERTSON BOULEVARD DETOUR:

 FOR STAGE CONSTRUCTION DETAIL OF SR 233 / ROBERTSON BLVD SEE DRAWINGS CV-I4210-D TO CV-I4214-D.

## ROAD 16 DETOUR:

1. FOR STAGE CONSTRUCTION DETAIL OF ROAD 16 SEE DRAWINGS CV-I4230-D TO CV-I4233-D.

## ROAD 17 1/2 DETOUR:

- 1. DURING CONSTRUCTION OF ROAD 17 1/2 GRADE SEPARATION, DETOUR SB TRAFFIC TO WB AVENUE 23 1/2, SB ROAD 17, EB SR 152, SB SR 99, SB AVENUE 21 1/2, THEN NB RD 19.
- 2. DETOUR NB TRAFFIC TO SB RD 19, NB AVE 21 1/2, NB SR 99, WB SR 152, NB RD 17, THEN EB AVE 23 1/2.
- 3. RESTORE TRAFFIC TO RD 17 1/2 UPON COMPLETION OF GRADE SEPARATION.

## ROAD 20 DETOUR:

- 1. DURING CONSTRUCTION OF RD 20 GRADE SEPARATION, DETOUR NB TRAFFIC TO WB AVE 22 1/2, THEN NB RD 19 1/2, THEN TO EB AVE 23 1/2.
- 2. DETOUR SB TRAFFIC TO WB AVE 23 1/2, THEN SB RD 19 1/2, THEN EB AVE 22 1/2.
- 3. RESTORE TRAFFIC TO RD 20 UPON COMPLETION OF GRADE SEPARATION WORK.

## ROAD 22 DETOUR:

- 1. DURING CONSTRUCTION OF RD 22 GRADE SEPARATION, DETOUR NB TRAFFIC TO NB FAIRMEAD BLVD, EB AVE 22, NB RD 20, THEN EB AVE 24.
- 2. DETOUR SB TRAFFIC TO WB AVE 24, SB RD 20, WB AVE 22, THEN SB FAIRMEAD BLVD.
- 3. BUILD TEMPORARY ROADWAY ON SOUTH SIDE OF AVE 22, CONNECTING AVE 22 TRAFFIC TO ROAD 22.
- 4. RESTORE TRAFFIC TO RD 22 AND AVE 22 UPON COMPLETION OF GRADE SEPARATION WORK.

## ROAD 24 AND AVENUE 20 1/2 DETOUR:

- 1. CONSTRUCT TEMPORARY ROADS ON WEST SIDE OF ROAD 24 AND SOUTH SIDE OF AVENUE 20 1/2
- DURING CONSTRUCTION OF ROAD 24 AND AVENUE 20 1/2 REALIGNMENT, DIRECT TRAFFIC ONTO TEMPORARY ROADWAYS.
- 3. RESTORE TRAFFIC TO ROAD 24 AND AVENUE 20 1/2 UPON COMPLETION OF ROADWAY REALIGNMENT WORK.
- 4. REMOVE TEMPORARY ROADWAYS.



## AVENUE 23 1/2 DETOUR:

- DURING CONSTRUCTION OF AVE 23 1/2 GRADE SEPARATION, DETOUR EB TRAFFIC TO SB RD 9, EB SR 152, THEN NB ROAD 11.
- 2. DETOUR WB TRAFFIC TO SB ROAD 11, WB SR 152, THEN NB RD 9.
- 3. RESTORE TRAFFIC TO AVE 23 1/2 UPON COMPLETION OF GRADE SEPARATION WORK.

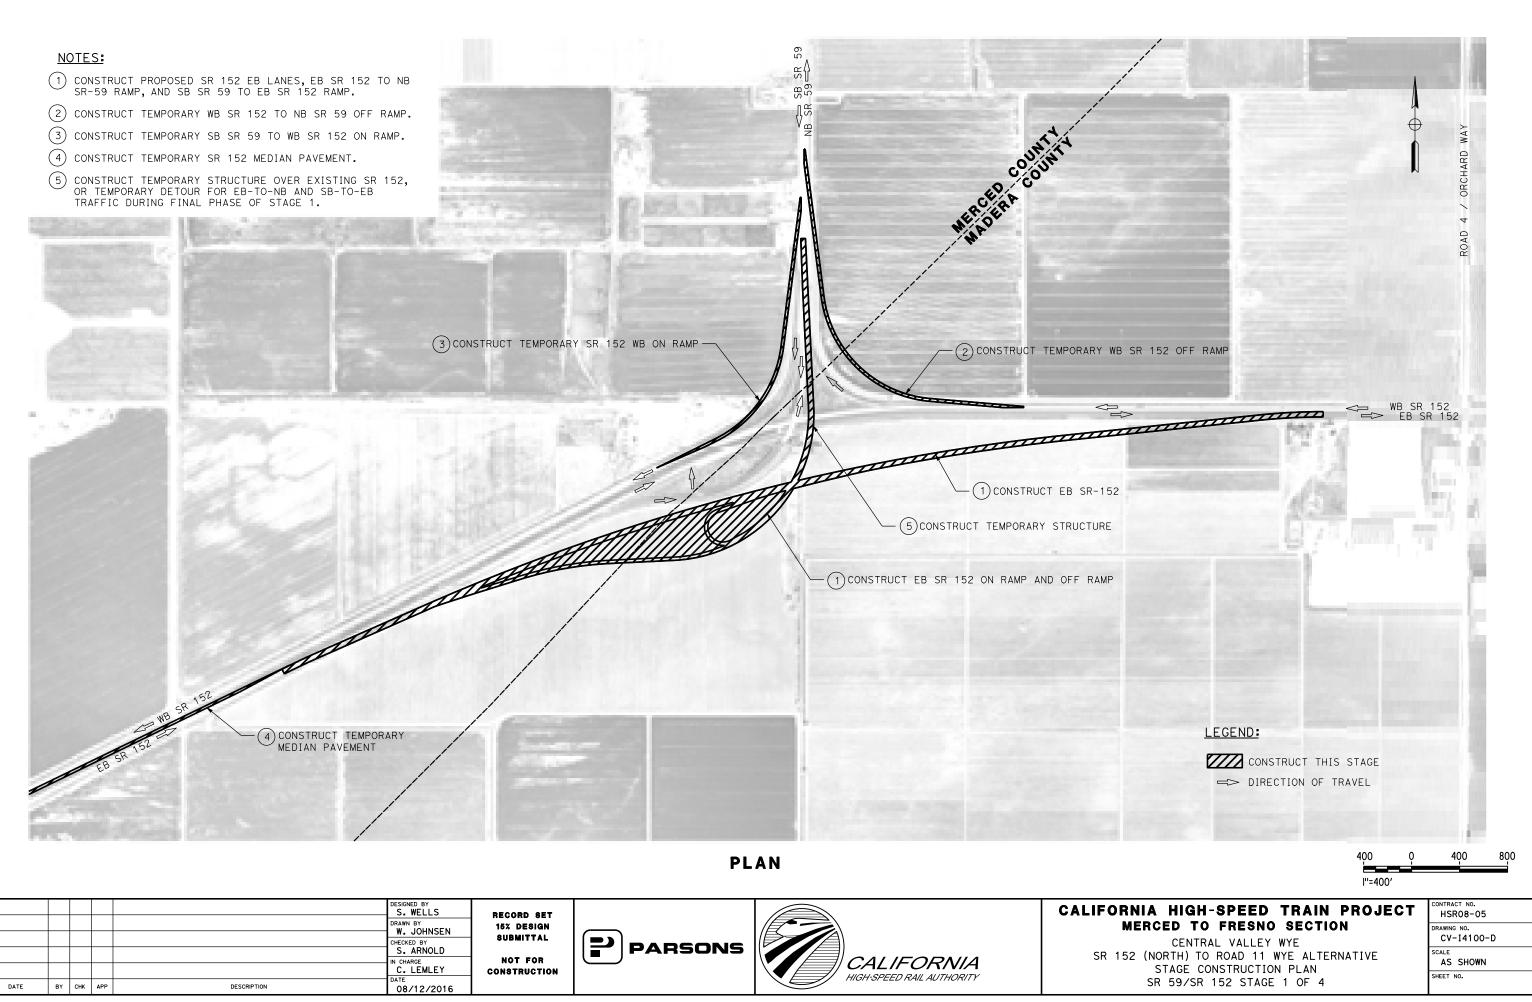
# CALIFORNIA HIGH-SPEED TRAIN PROJECT MERCED TO FRESNO SECTION CENTRAL VALLEY WYE

SR 152 (NORTH) TO ROAD 11 WYE ALTERNATIVE STAGE CONSTRUCTION PLAN GENERAL NOTES CONTRACT NO. HSR08-05 DRAWING NO.

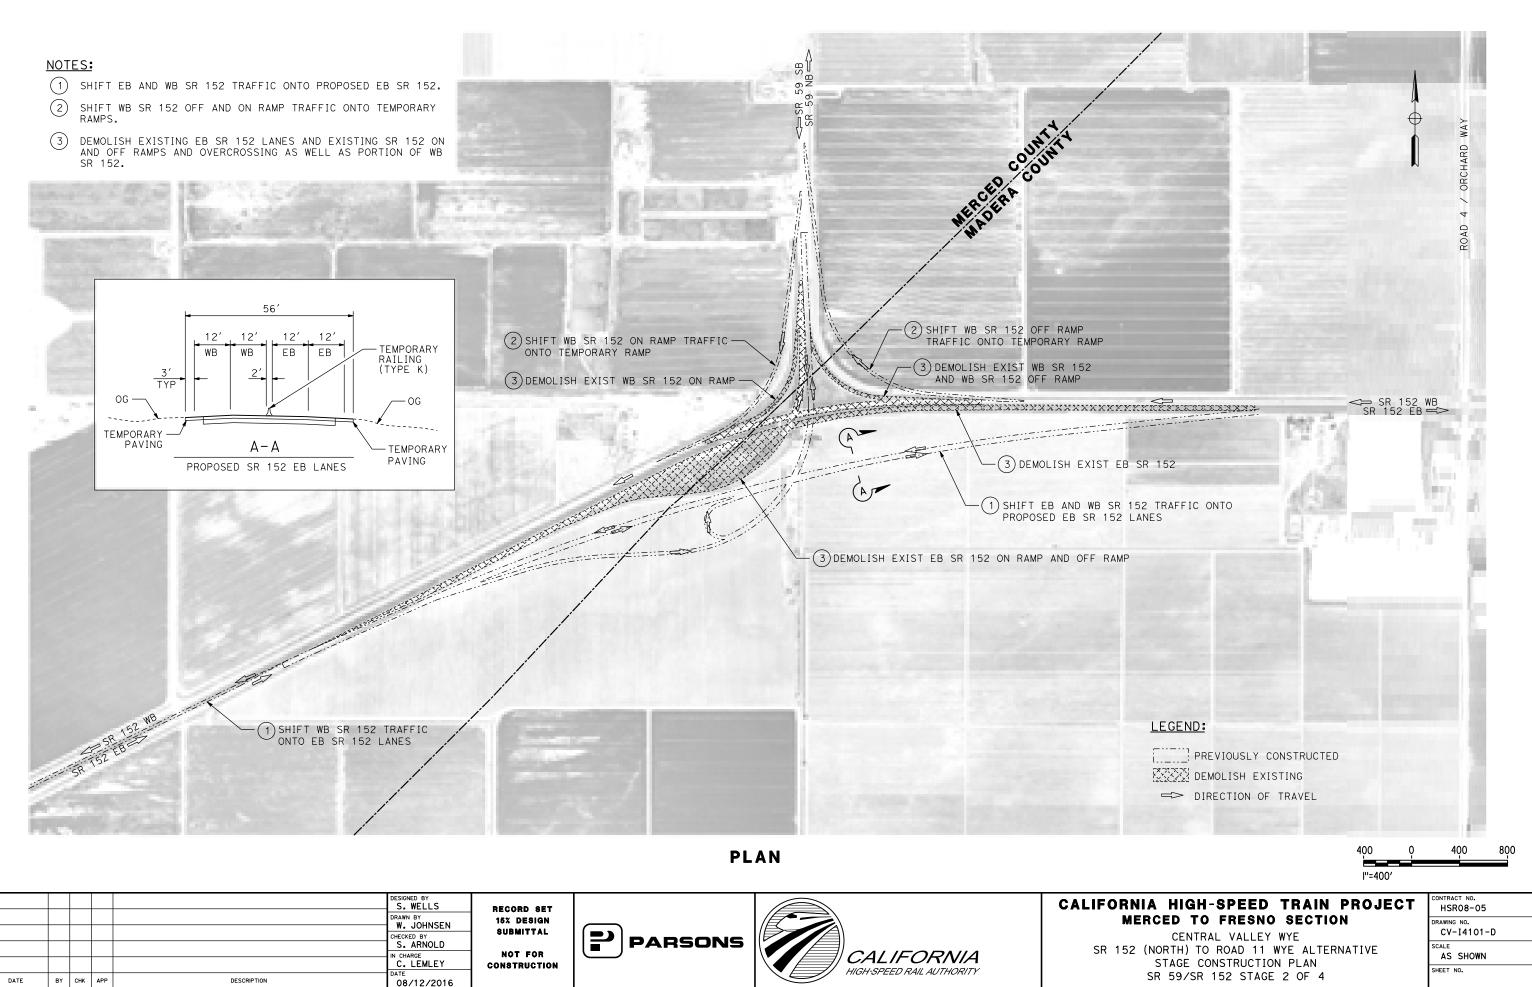
CV-I0001-D

NO SCALE

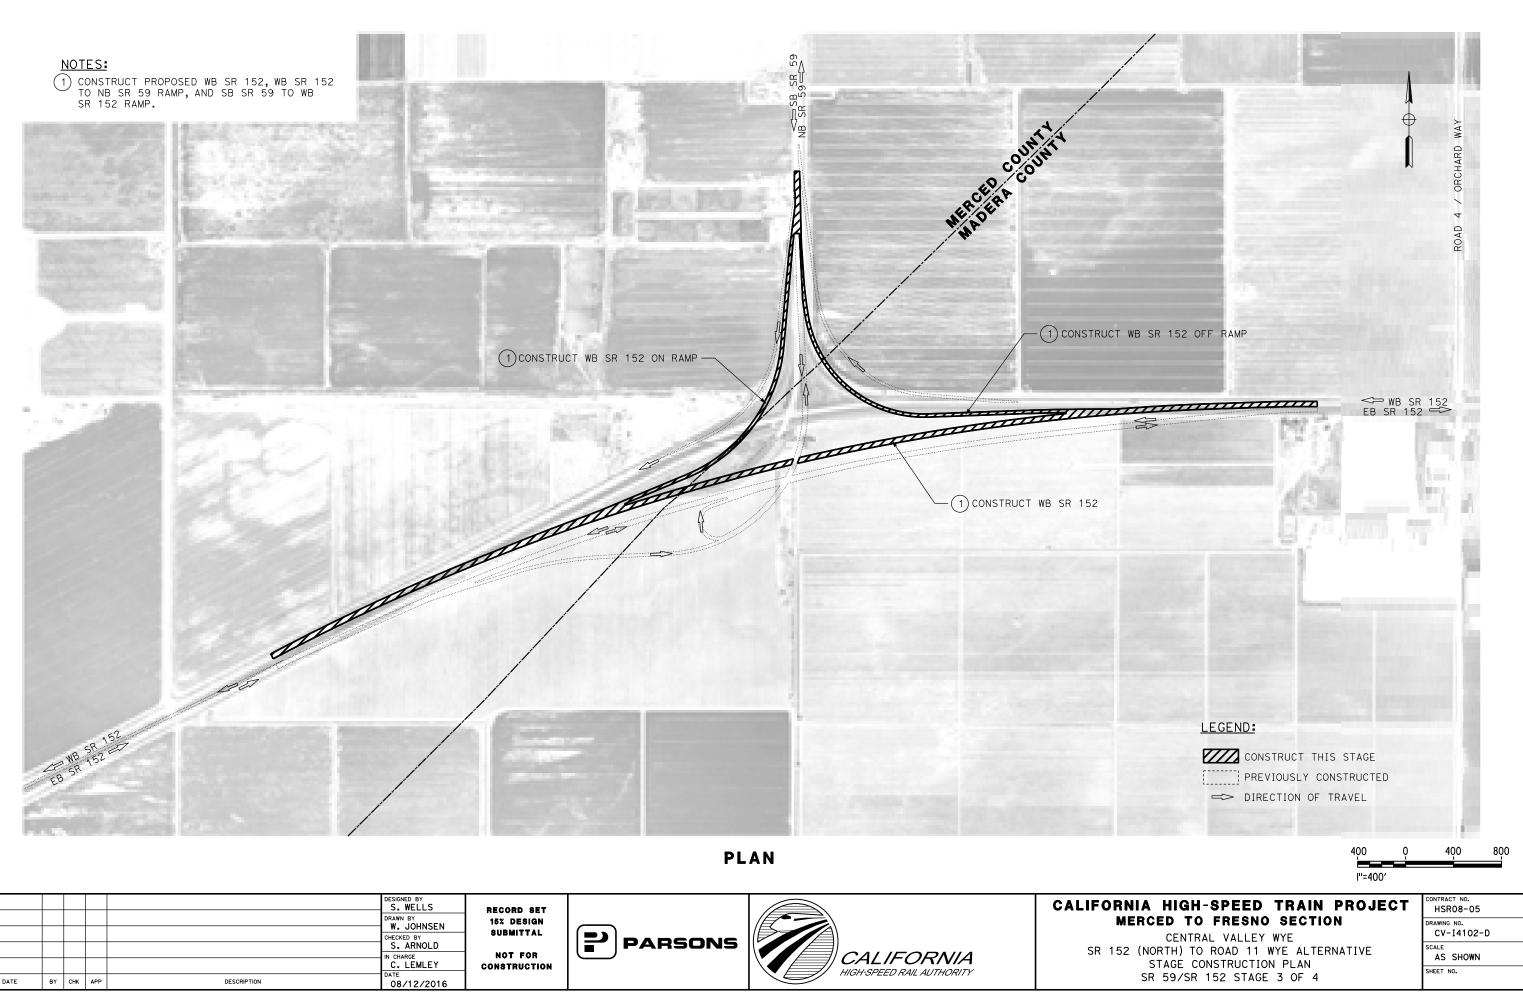
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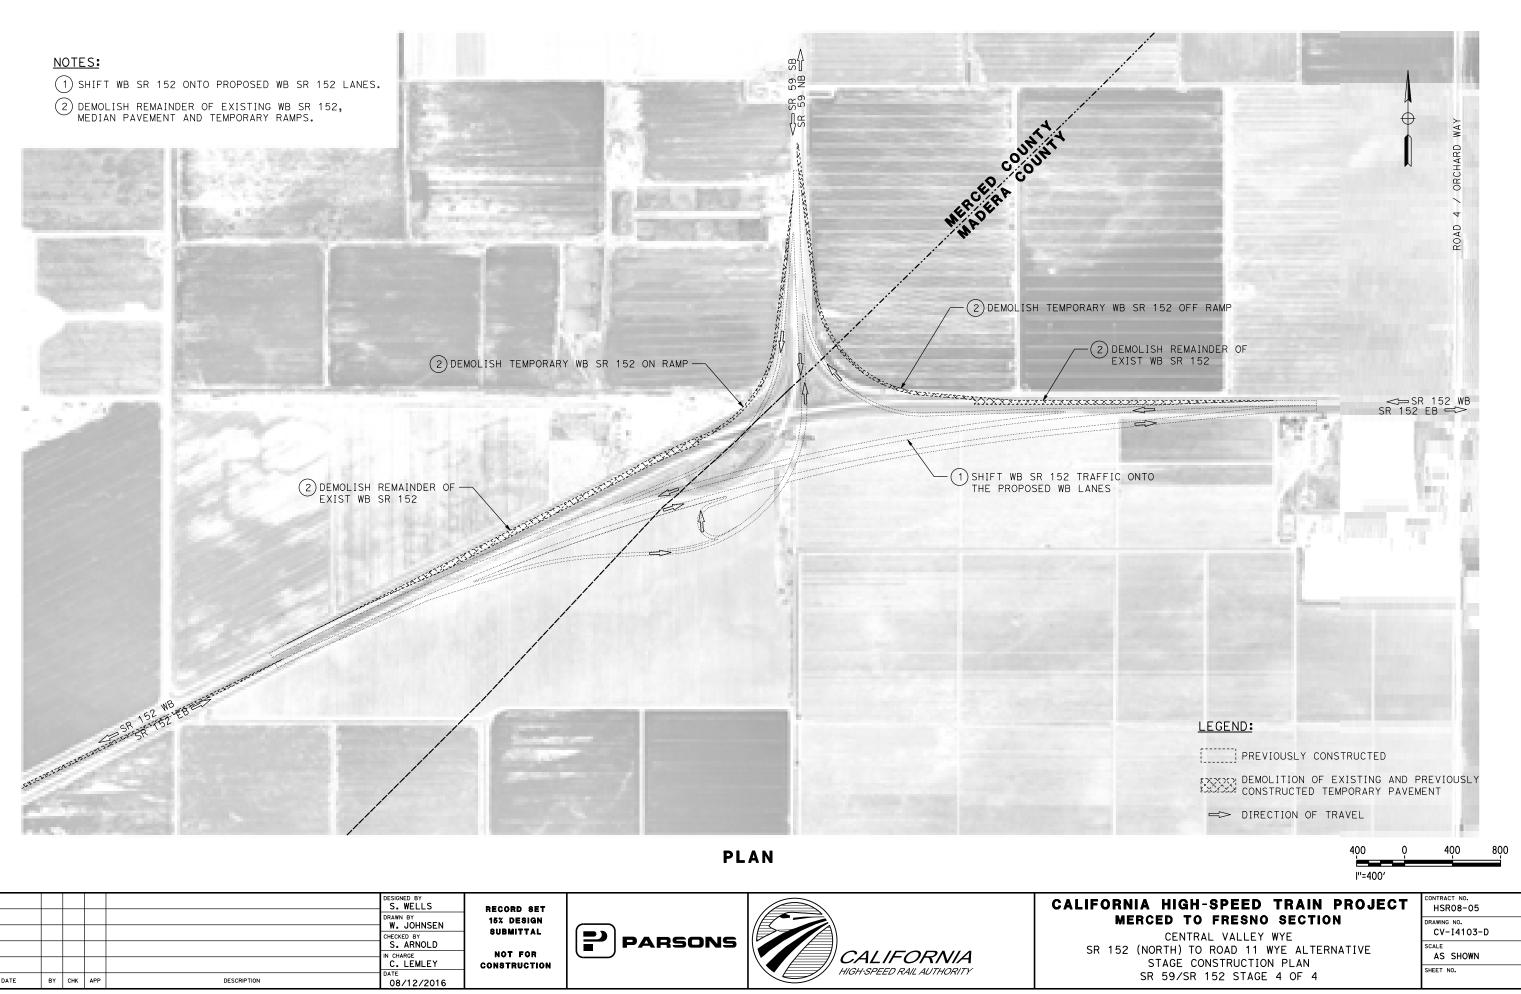


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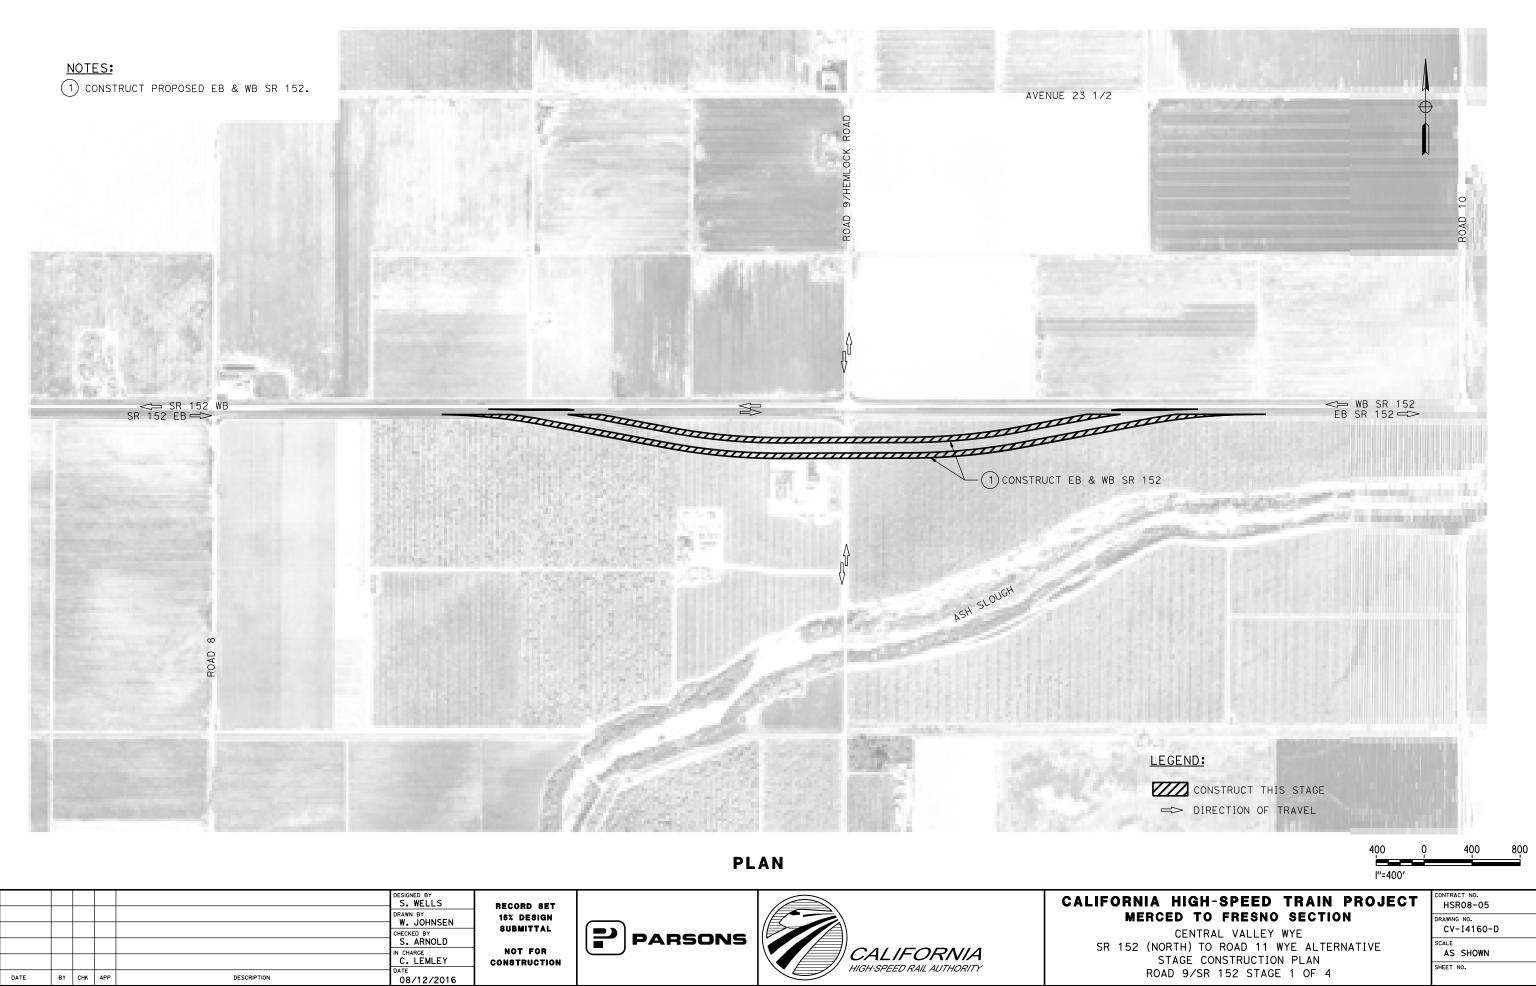




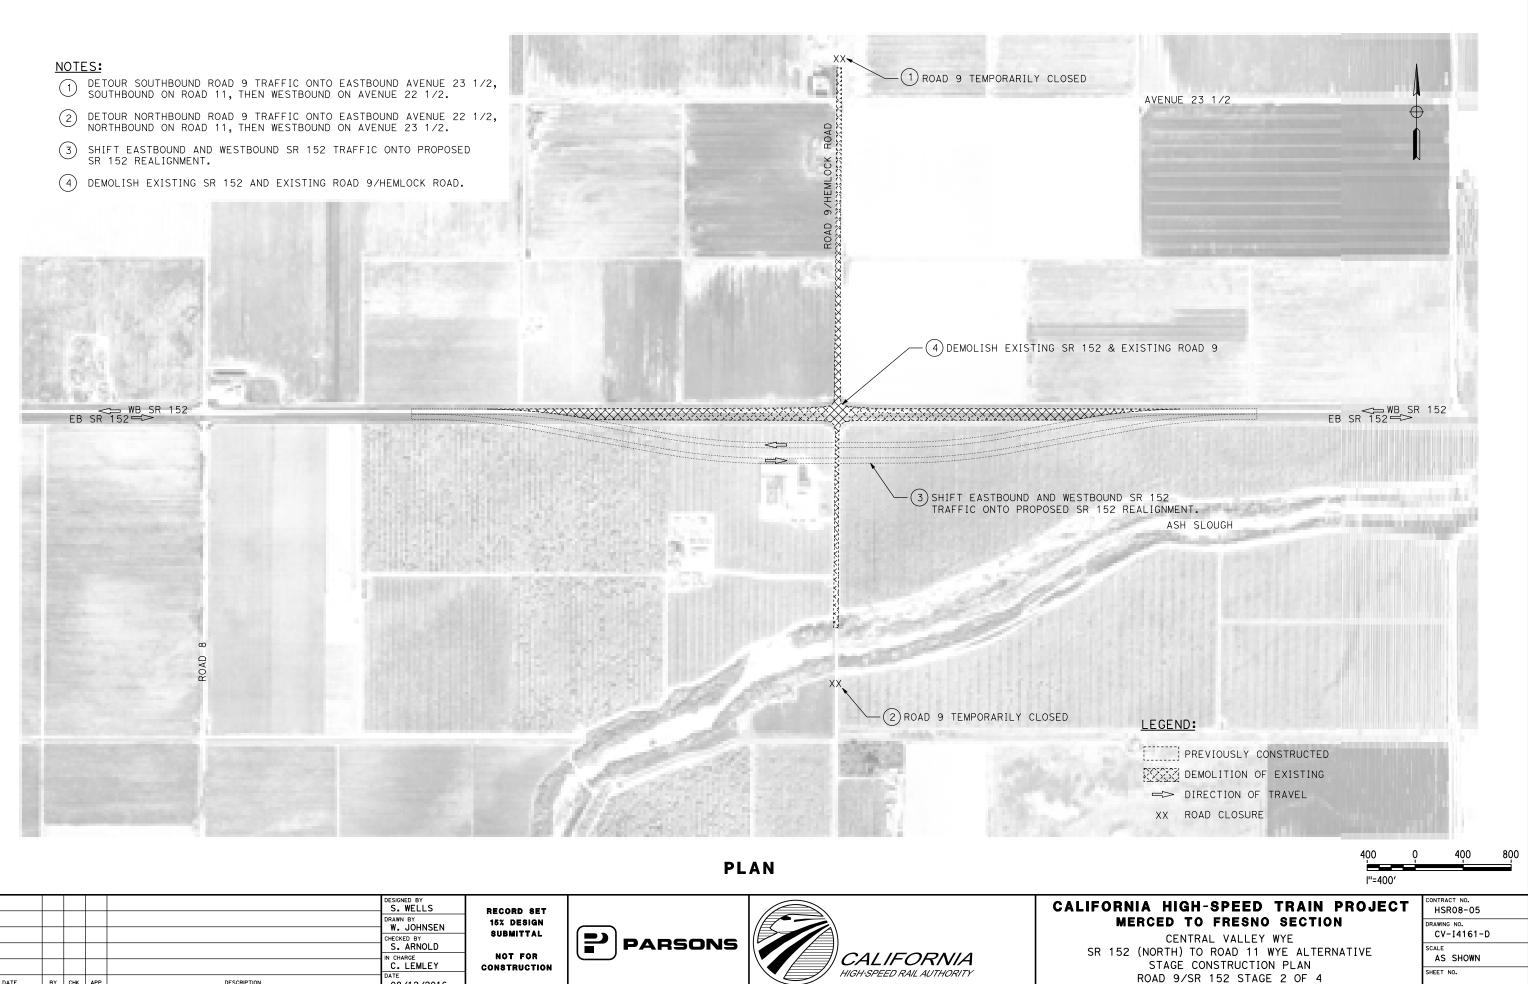




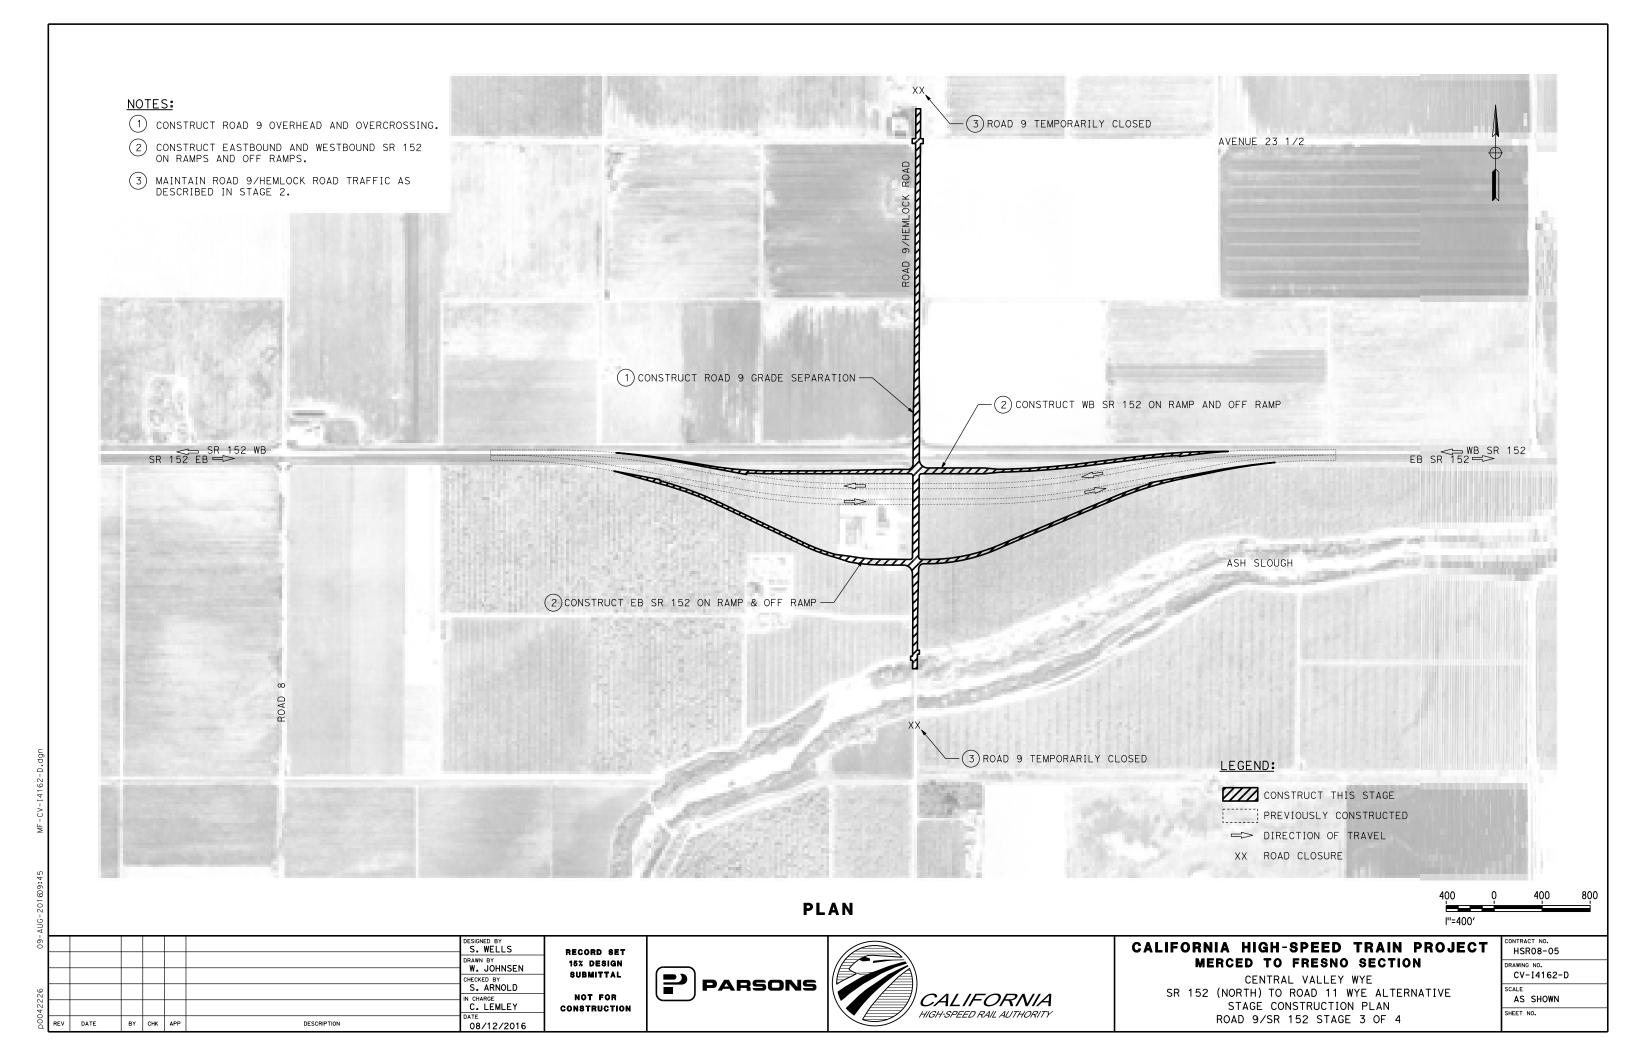
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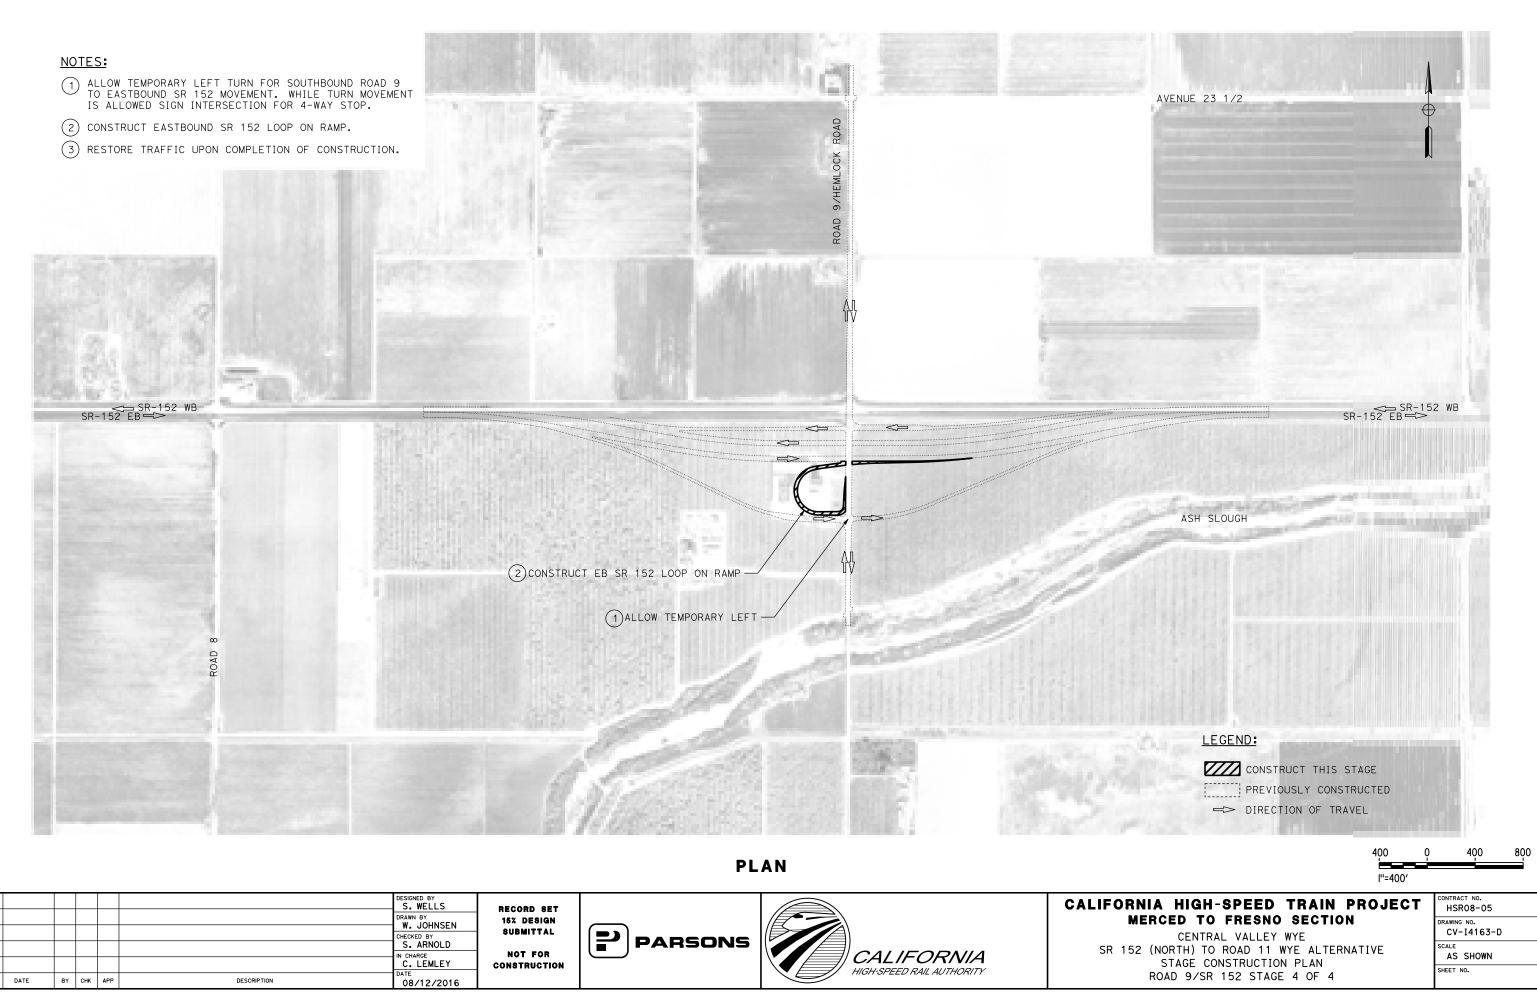


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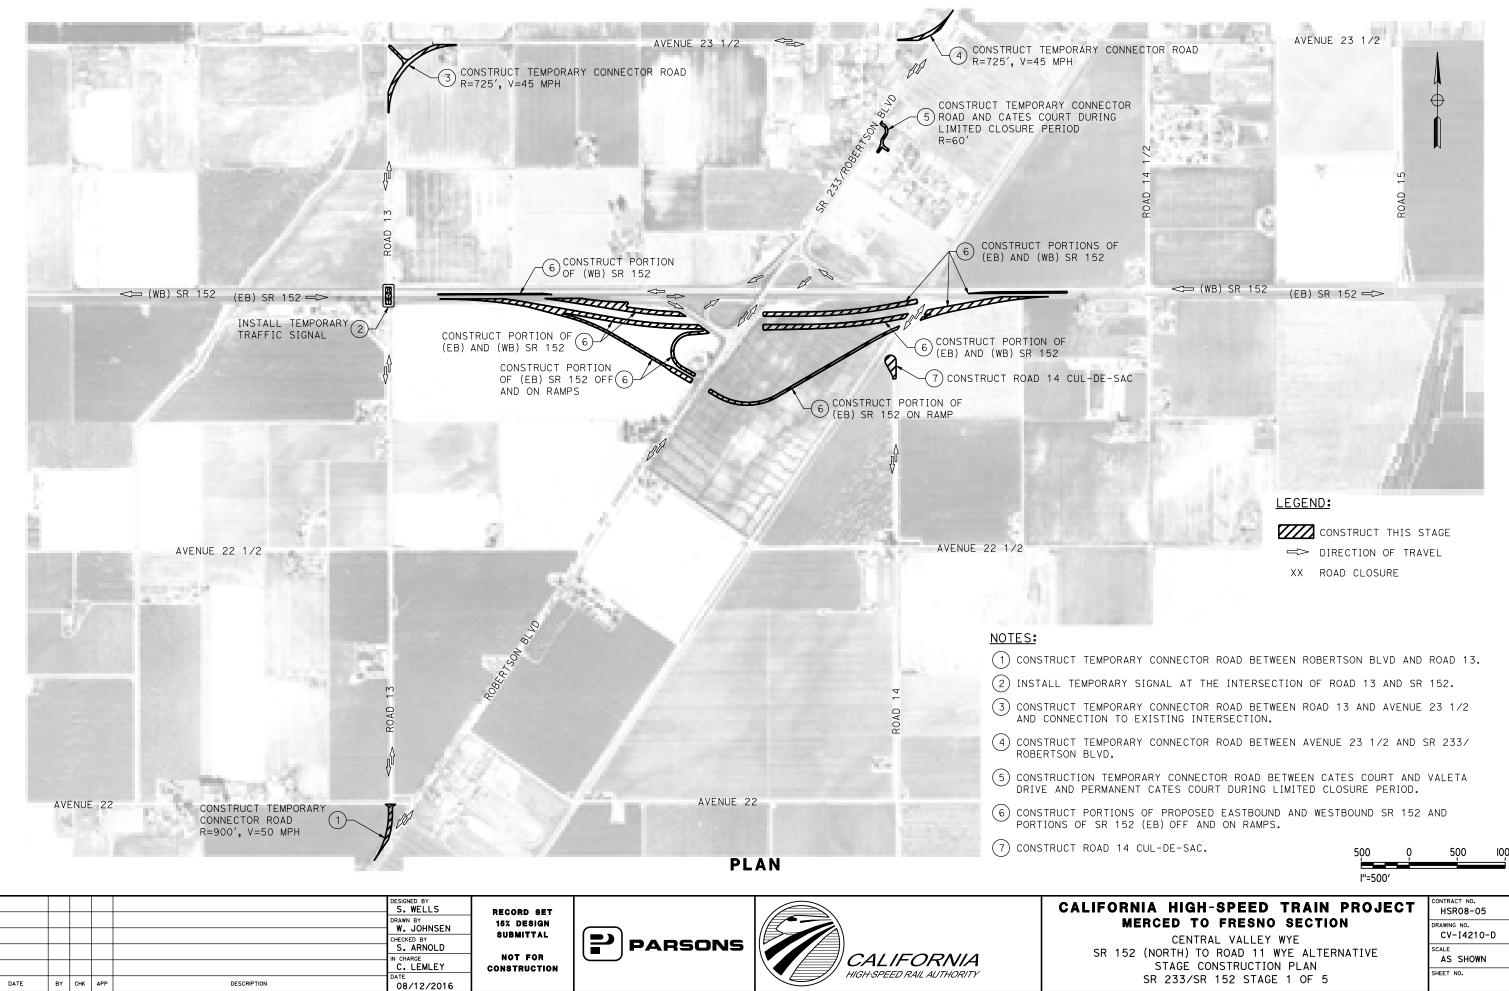


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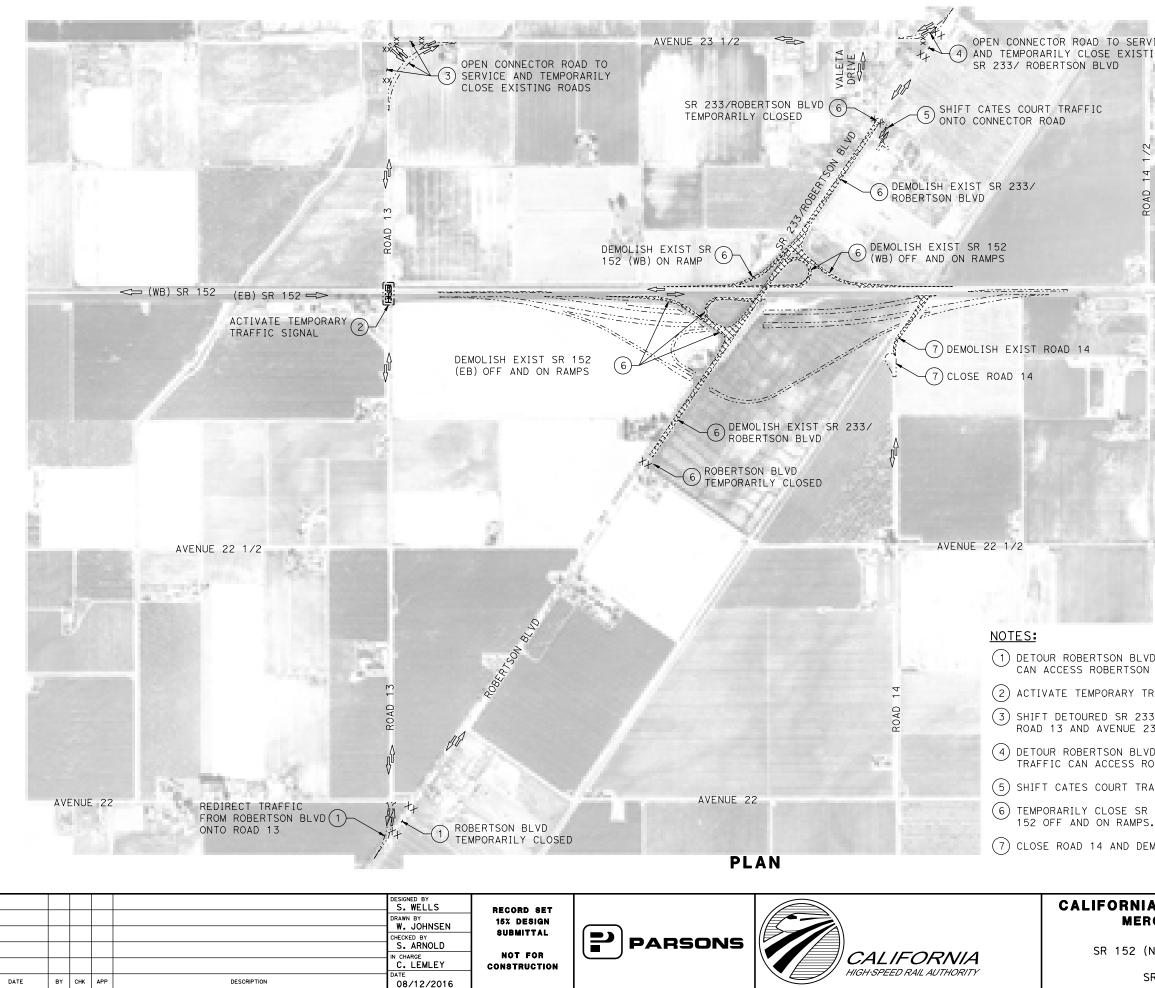




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CENTRAL VALLEY WYE		-	CV-14210-	-D
2 (NORTH) TO ROAD 11 WYE ALTER STAGE CONSTRUCTION PLAN	RNATIVE		AS SHOWN	
SR 233/SR 152 STAGE 1 OF 5			SHEET NO.	



REV

SERVICE KISTING	AVEN	NUE 23 1/2	Å
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	[]	CONSTRUCT T PREVIOUSLY DEMOLITION DIRECTION O ROAD CLOSUF	CONSTRUCTED OF EXISTING F TRAVEL

(1) DETOUR ROBERTSON BLVD TRAFFIC ONTO CONNECTOR ROAD TO ROAD 13. LOCAL TRAFFIC CAN ACCESS ROBERTSON BLVD VIA AVENUE 22.

(2) ACTIVATE TEMPORARY TRAFFIC SIGNAL AT THE INTERSECTION OF SR 152 AND ROAD 13.

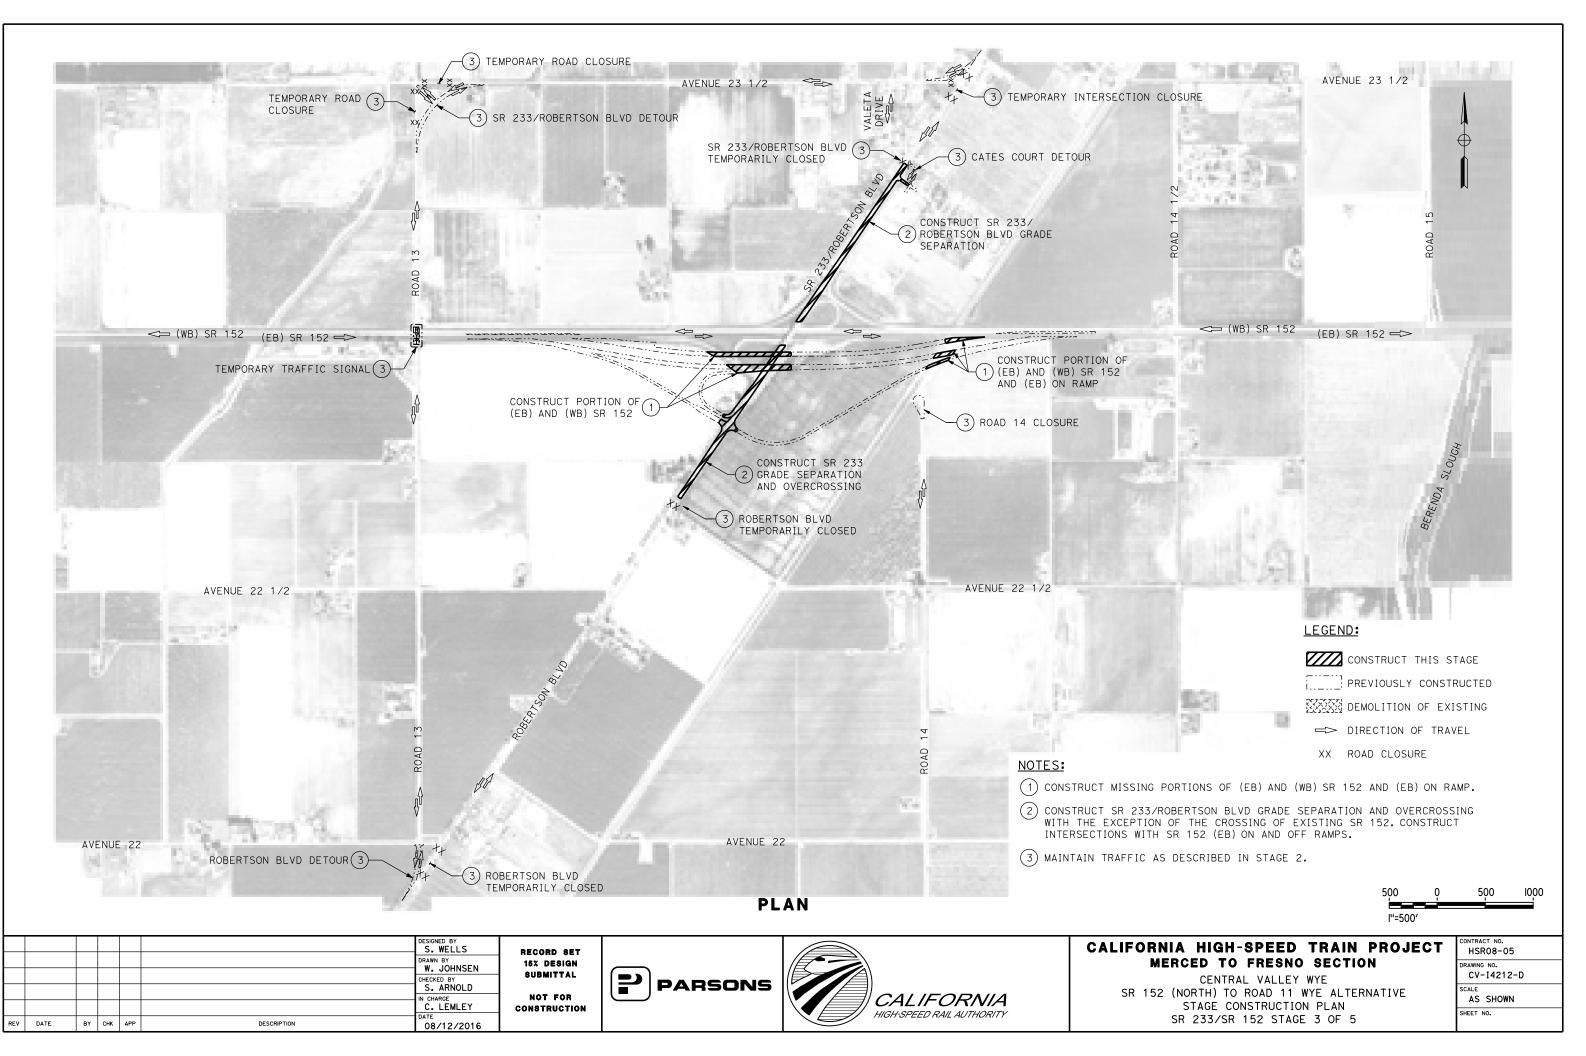
(3) SHIFT DETOURED SR 233/ROBERTSON BLVD TRAFFIC ONTO CONNECTOR ROAD BETWEEN ROAD 13 AND AVENUE 23 1/2 AND OPEN CONNECTOR TO EXISTING INTERSECTION.

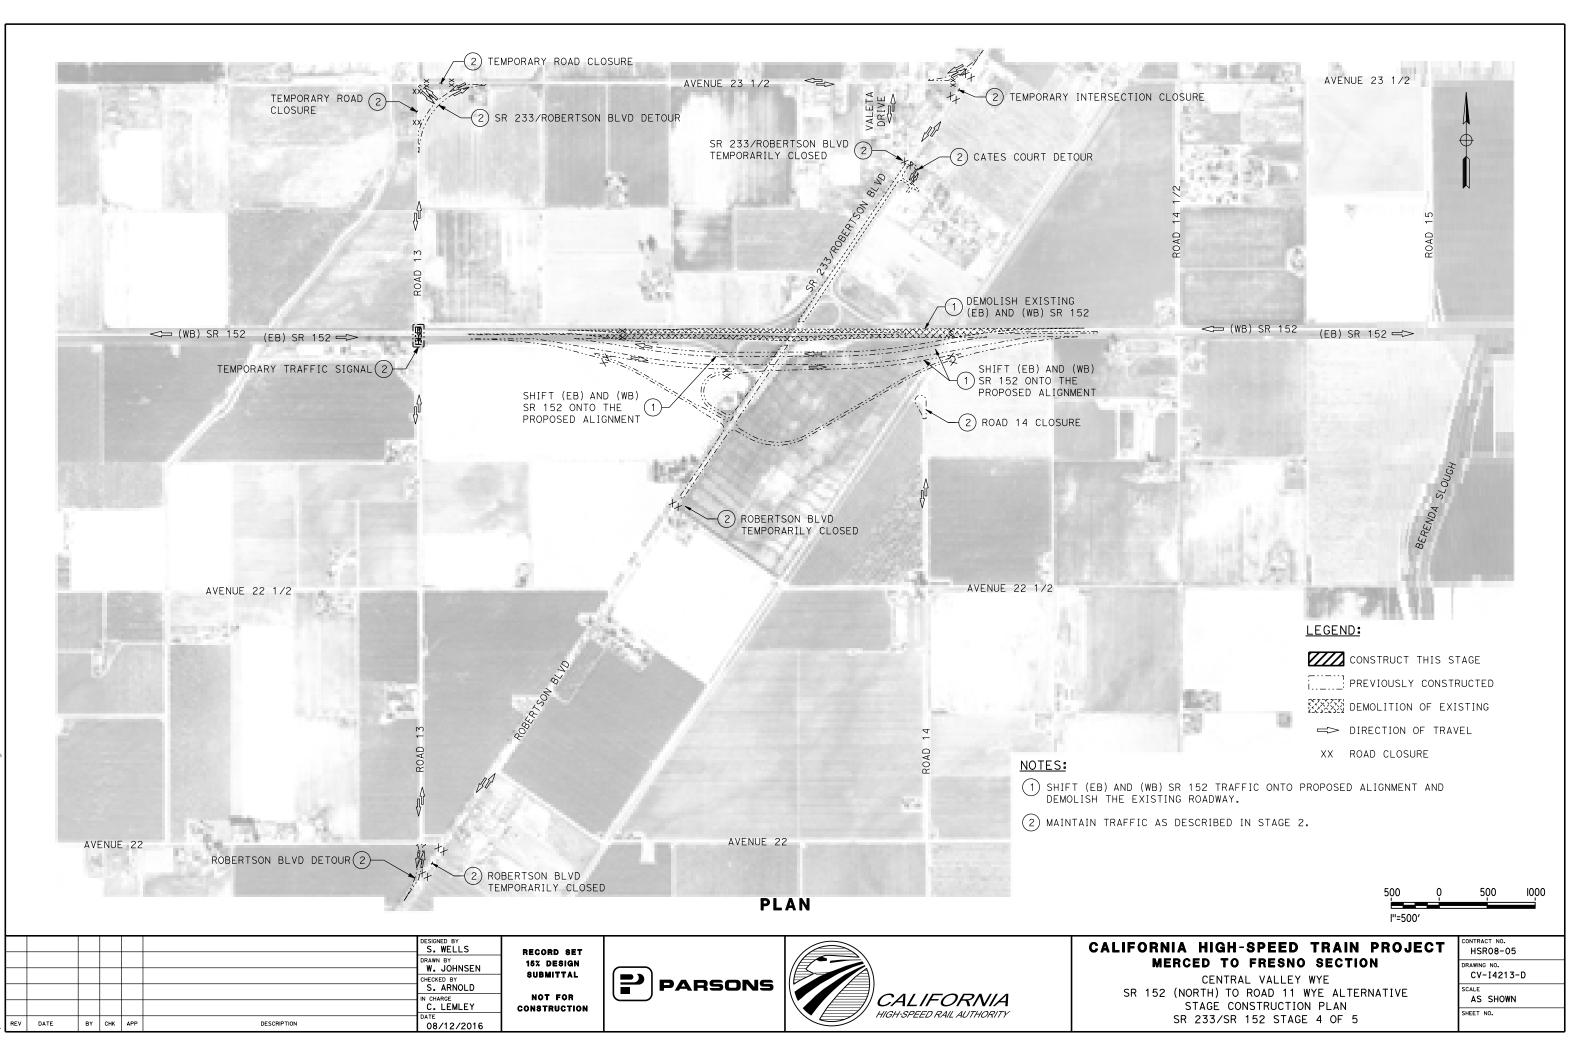
(4) DETOUR ROBERTSON BLVD TRAFFIC ONTO CONNECTOR ROAD TO AVENUE 23 1/2. LOCAL TRAFFIC CAN ACCESS ROBERTSON BLVD VIA VALETA DRIVE.

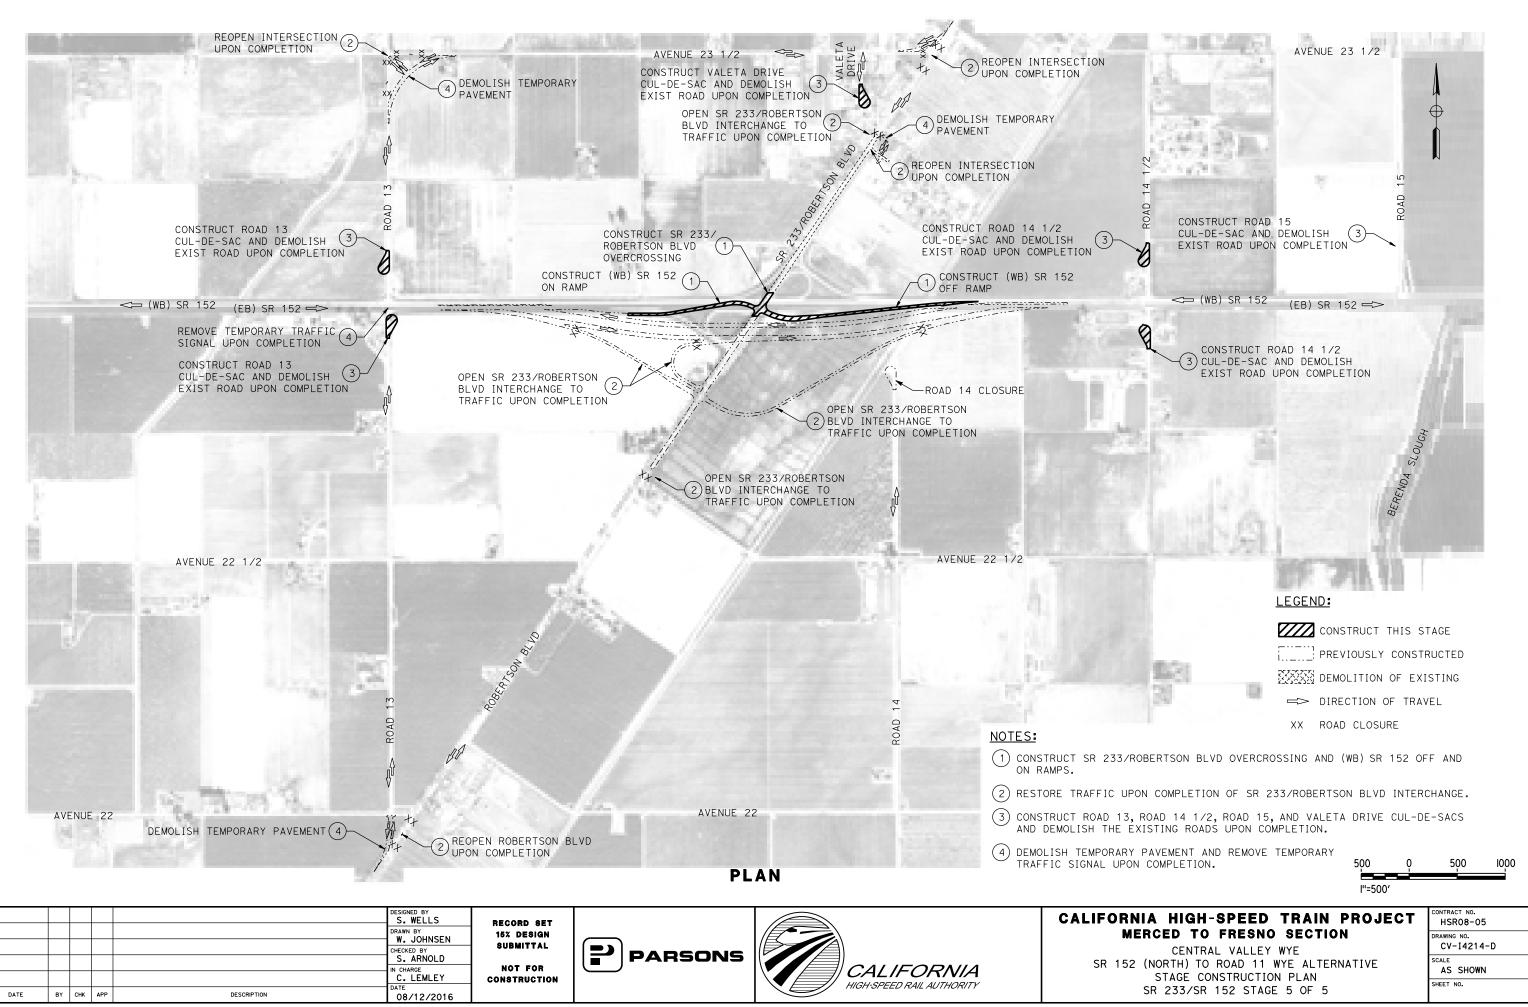
(5) SHIFT CATES COURT TRAFFIC ONTO CONNECTOR ROAD TO VALETA DRIVE.

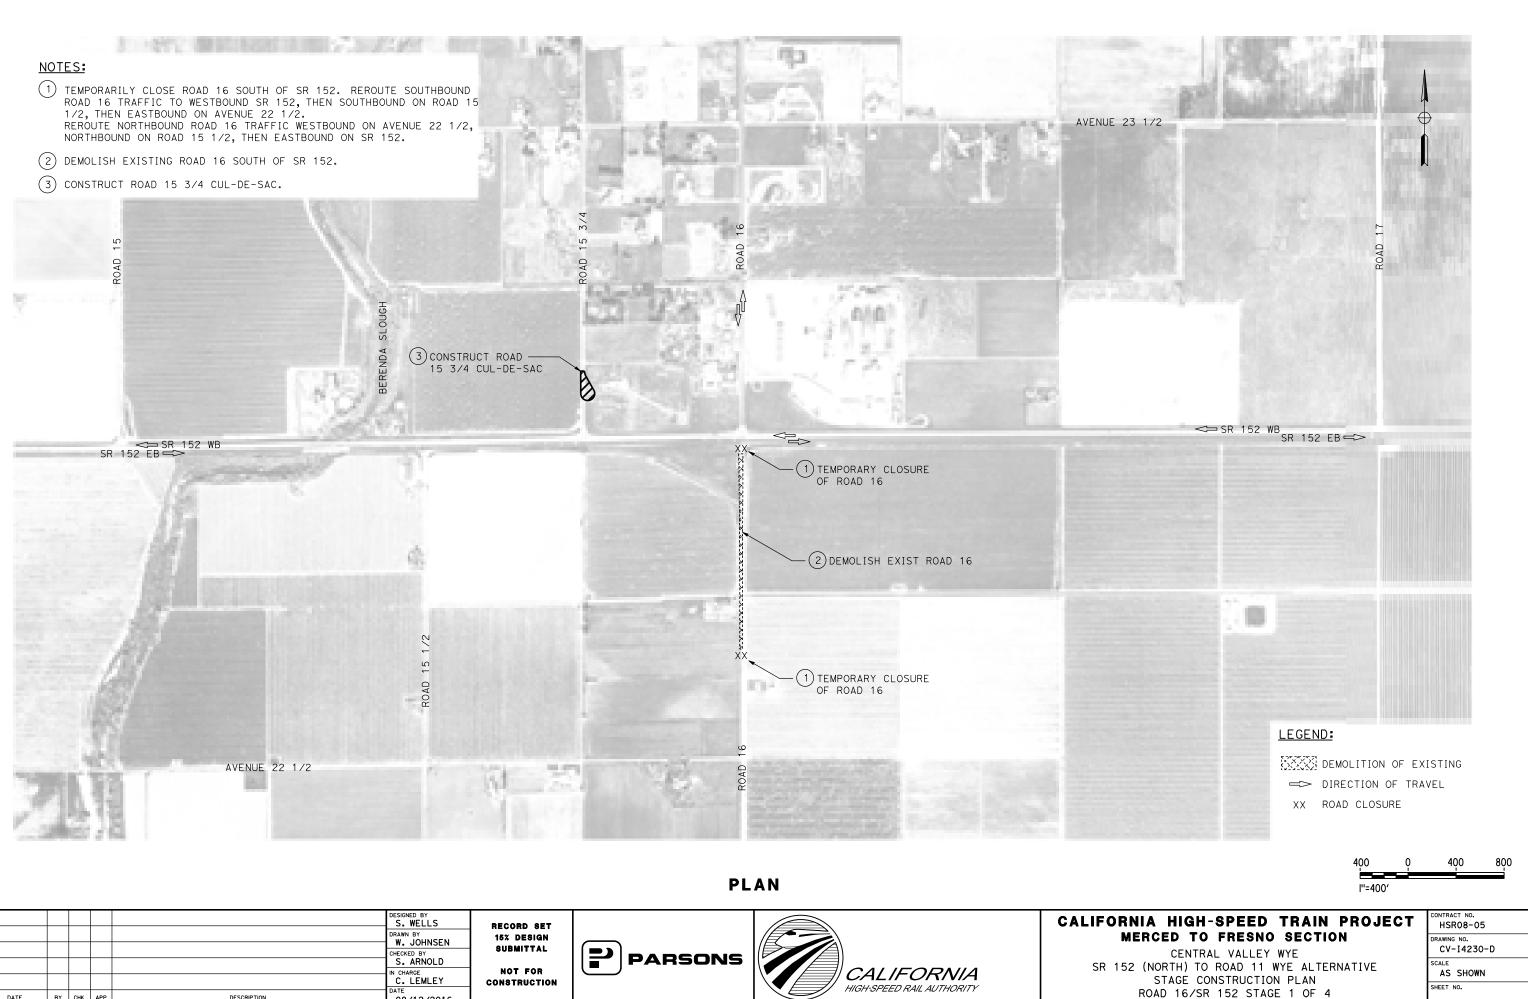
(6) TEMPORARILY CLOSE SR 233/ROBERTSON BLVD AND DEMOLISH EXISTING ROAD AND SR

DEMOLISH	THE	EXISTING	ROAD.	500 I''=500'	0 	500	1000 
ERCED CEN (NORTH) STAGE	<b>TO</b> ITRAI TO CON	SPEED FRESNO _ VALLEY ROAD 11 ' ISTRUCTIO 152 STAGE	SECTI WYE WYE ALTE N PLAN		СТ	CONTRACT NO. HSR08-05 DRAWING NO. CV-14211 SCALE AS SHOWN SHEET NO.	-D

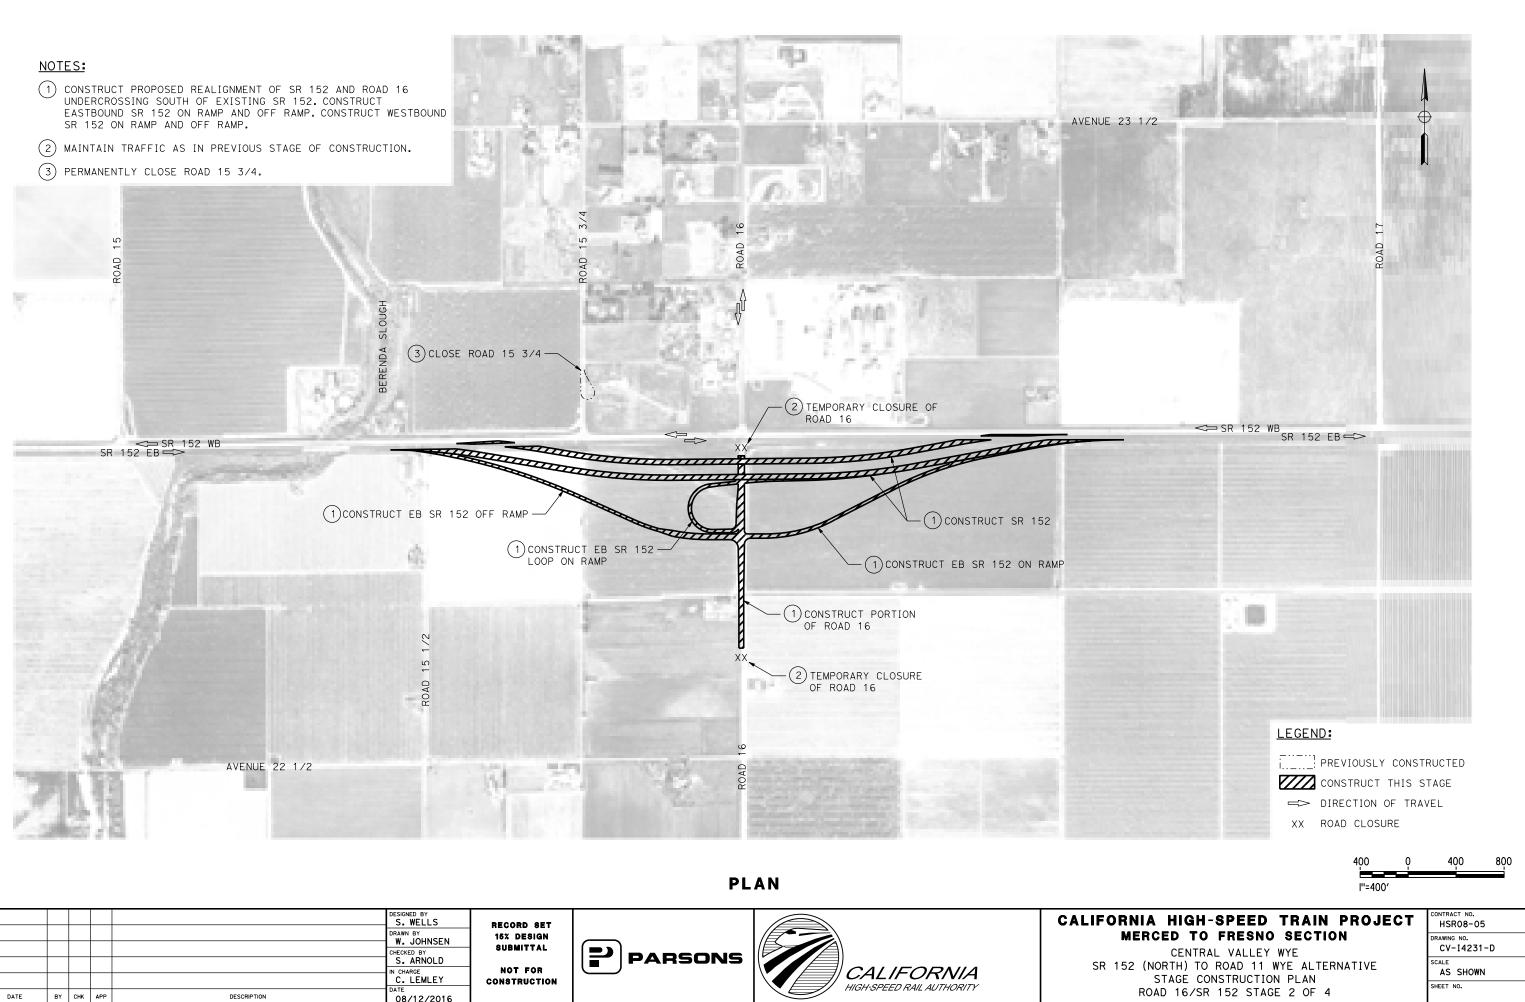






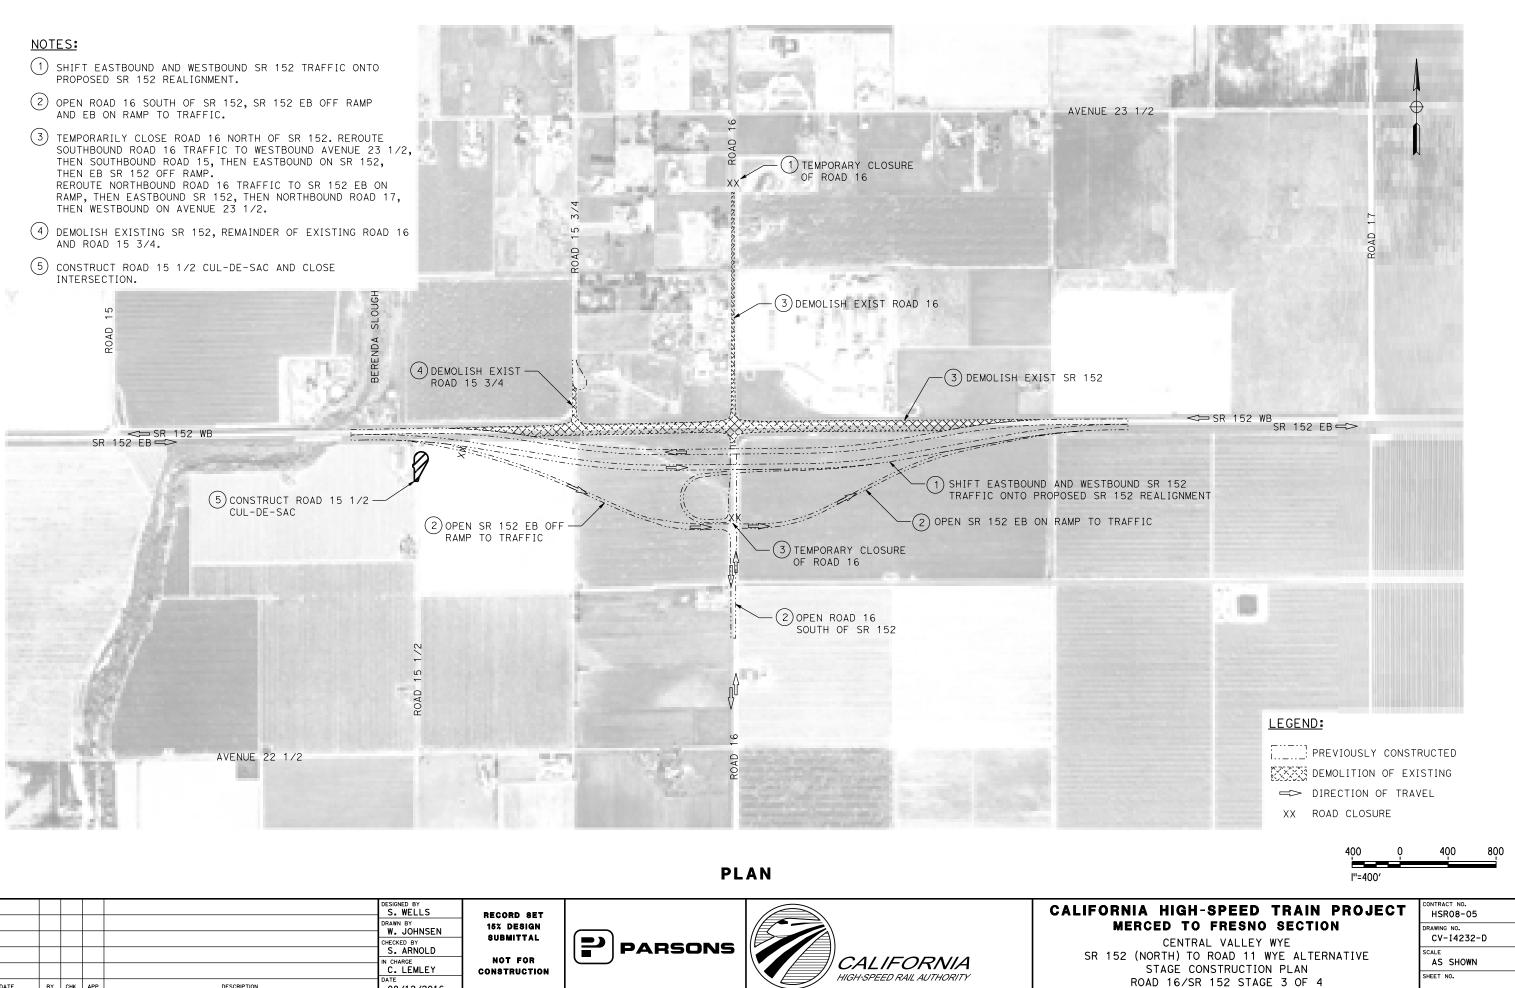


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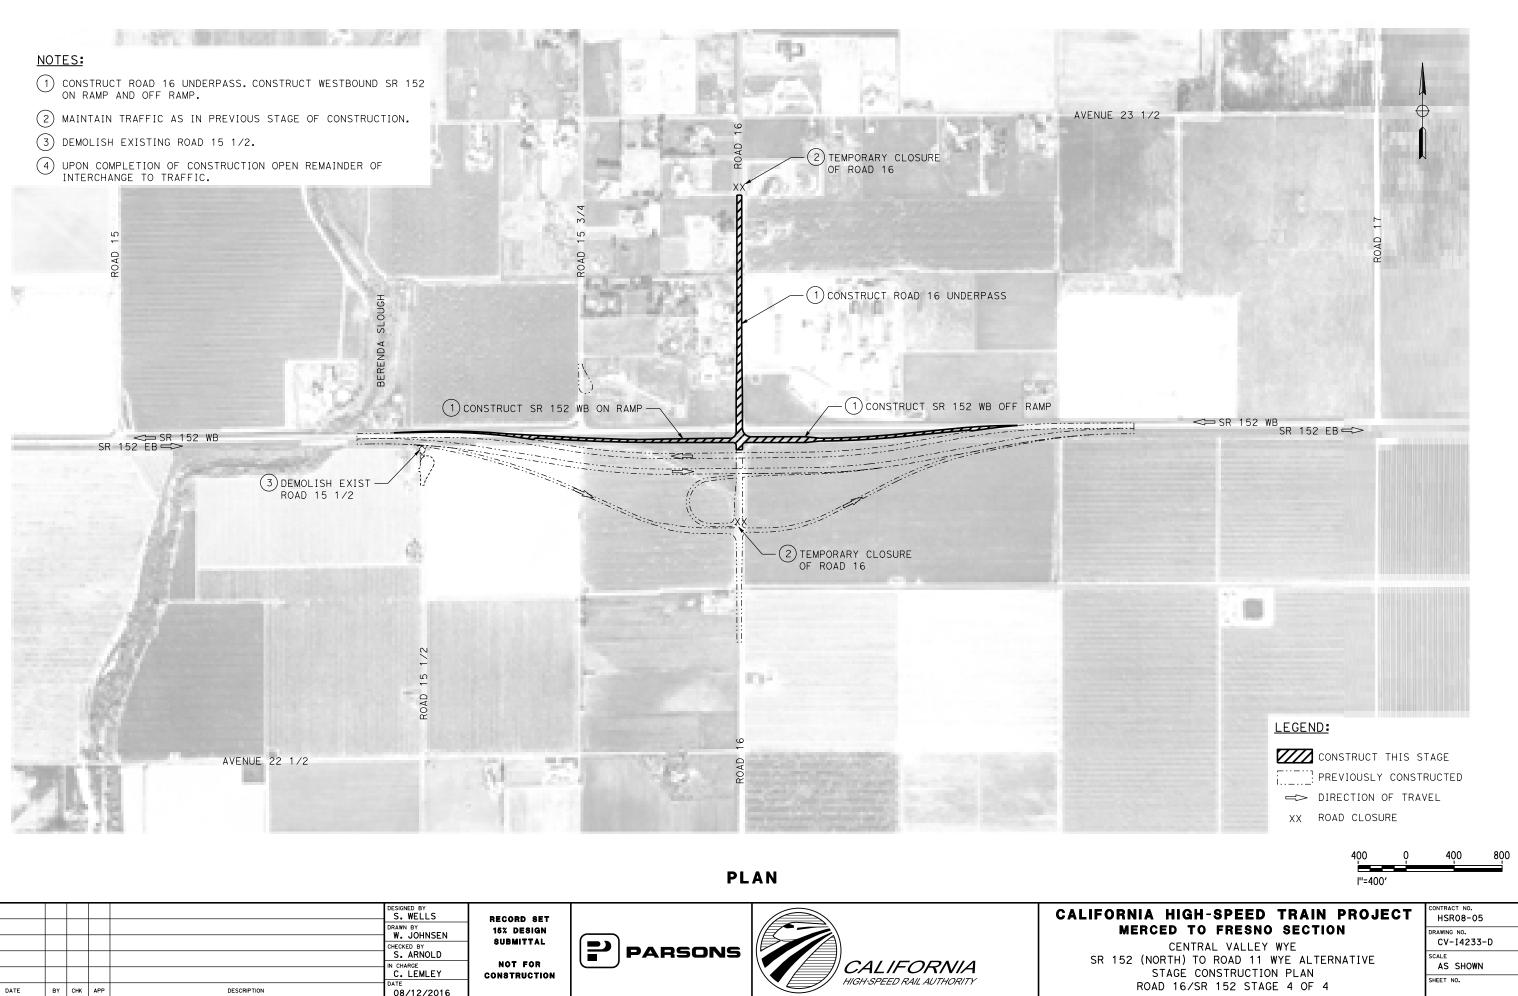




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