


Merced to Fresno Section: Central Valley Wye

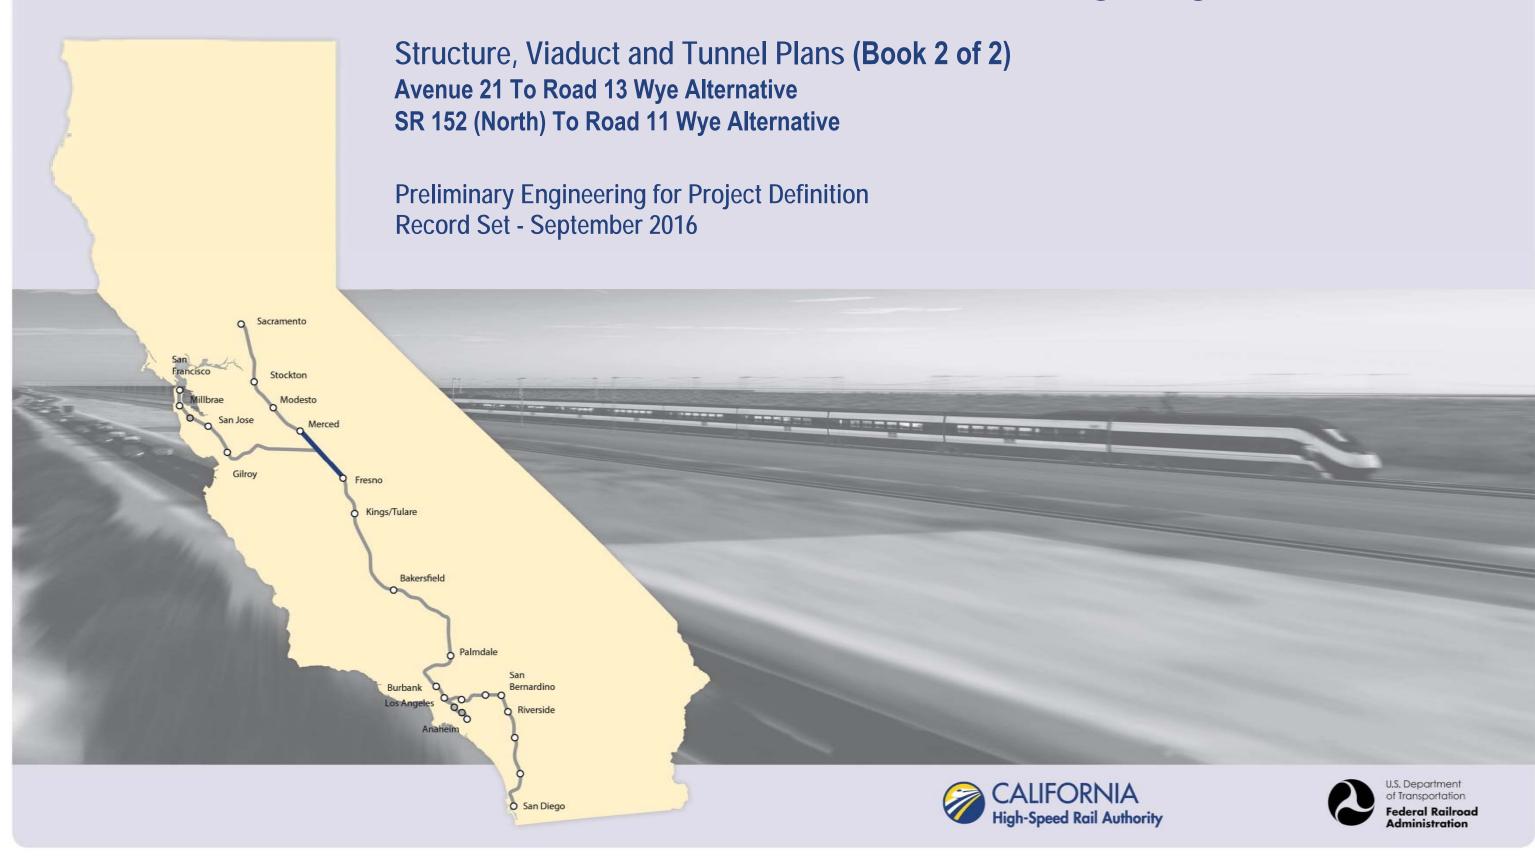

			INDEX OF DRAWINGS		
DRAWING NO.	SECTION	ALIGNMENT / PLAN SET	TITLE	DESCRIPTION	
			GENERAL		
ST-B0001	CENTRAL VALLEY WYE	STRUCTURE, VIADUCT AND TUNNEL PLANS	COVER		
ST-B0002	CENTRAL VALLEY WYE	STRUCTURE, VIADUCT AND TUNNEL PLANS	INDEX OF DRAWINGS	SHEET 1 OF 8	
ST-B0003	CENTRAL VALLEY WYE	STRUCTURE, VIADUCT AND TUNNEL PLANS	INDEX OF DRAWINGS	SHEET 2 OF 8	
ST-B0004	CENTRAL VALLEY WYE	STRUCTURE, VIADUCT AND TUNNEL PLANS	INDEX OF DRAWINGS	SHEET 3 OF 8	
ST-B0005	CENTRAL VALLEY WYE	STRUCTURE, VIADUCT AND TUNNEL PLANS	INDEX OF DRAWINGS	SHEET 4 OF 8	
ST-B0006	CENTRAL VALLEY WYE	STRUCTURE, VIADUCT AND TUNNEL PLANS	INDEX OF DRAWINGS	SHEET 5 OF 8	
ST-B0007	CENTRAL VALLEY WYE	STRUCTURE, VIADUCT AND TUNNEL PLANS	INDEX OF DRAWINGS	SHEET 6 OF 8	
ST-B0008	CENTRAL VALLEY WYE	STRUCTURE, VIADUCT AND TUNNEL PLANS	INDEX OF DRAWINGS	SHEET 7 OF 8	
ST-B0009	CENTRAL VALLEY WYE	STRUCTURE, VIADUCT AND TUNNEL PLANS	INDEX OF DRAWINGS	SHEET 8 OF 8	
ST-B0010	CENTRAL VALLEY WYE	STRUCTURE, VIADUCT AND TUNNEL PLANS	ABBREVIATIONS	SHEET 1 OF 2	
ST-B0011	CENTRAL VALLEY WYE	STRUCTURE, VIADUCT AND TUNNEL PLANS	ABBREVIATIONS	SHEET 2 OF 2	
ST-B4000	CENTRAL VALLEY WYE	STRUCTURE, VIADUCT AND TUNNEL PLANS	LOCATION PLAN		
		SR 1	52 (NORTH) TO ROAD 13 WYE ALTERNATIVE		
ST-B4001-A	CENTRAL VALLEY WYE	SR 152 (NORTH) TO ROAD 13 WYE ALTERNATIVE	KEY MAP OF STRUCTURAL PLANS	SHEET 1 OF 2	
ST-B4002-A	CENTRAL VALLEY WYE	SR 152 (NORTH) TO ROAD 13 WYE ALTERNATIVE	KEY MAP OF STRUCTURAL PLANS	SHEET 2 OF 2	
ST-K1050-A	CENTRAL VALLEY WYE	SR 152 (NORTH) TO ROAD 13 WYE ALTERNATIVE	GENERAL PLAN (SJD-FRE)	INDIANA ROAD OVERHEAD	
ST-K1060-A	CENTRAL VALLEY WYE	SR 152 (NORTH) TO ROAD 13 WYE ALTERNATIVE	GENERAL PLAN (SJD-FRE)	WILLIS ROAD UNDERPASS	
ST-K1065-A	CENTRAL VALLEY WYE	SR 152 (NORTH) TO ROAD 13 WYE ALTERNATIVE	GENERAL PLAN (SJD-FRE)	SAN JOAQUIN RIVER BRIDGE - 1 OF 2	
ST-K3065-A	CENTRAL VALLEY WYE	SR 152 (NORTH) TO ROAD 13 WYE ALTERNATIVE	TYPICAL SECTION (SJD-FRE)	SAN JOAQUIN RIVER BRIDGE - 2 OF 2	
ST-K1070-A	CENTRAL VALLEY WYE	SR 152 (NORTH) TO ROAD 13 WYE ALTERNATIVE	GENERAL PLAN (SJD-FRE)	MARIPOSA SLOUGH BRIDGE	
ST-K1075-A	CENTRAL VALLEY WYE	SR 152 (NORTH) TO ROAD 13 WYE ALTERNATIVE	GENERAL PLAN (SJD-FRE)	HARMON ROAD UNDERPASS	
ST-K1080-A	CENTRAL VALLEY WYE	SR 152 (NORTH) TO ROAD 13 WYE ALTERNATIVE	GENERAL PLAN (SJD-FRE)	AERIAL #1 - EASTSIDE BYPASS IRRIGATION DITCH - 1 OF 2	
ST-K3080-A	CENTRAL VALLEY WYE	SR 152 (NORTH) TO ROAD 13 WYE ALTERNATIVE	TYPICAL SECTION (SJD-FRE)	AERIAL #1 - EASTSIDE BYPASS IRRIGATION DITCH - 2 OF 2	
ST-K1100-A	CENTRAL VALLEY WYE	SR 152 (NORTH) TO ROAD 13 WYE ALTERNATIVE	GENERAL PLAN (SJD-FRE)	SR 59 / SR 152 INTERCHANGE - 1 OF 4	
ST-K1101-A	CENTRAL VALLEY WYE	SR 152 (NORTH) TO ROAD 13 WYE ALTERNATIVE	GENERAL PLAN (SJD-FRE)	SR 59 / SR 152 INTERCHANGE - 2 OF 4	
ST-K3101-A	CENTRAL VALLEY WYE	SR 152 (NORTH) TO ROAD 13 WYE ALTERNATIVE	TYPICAL SECTIONS (SJD-FRE)	SR 59 / SR 152 INTERCHANGE - 3 OF 4	
ST-K1102-A	CENTRAL VALLEY WYE	SR 152 (NORTH) TO ROAD 13 WYE ALTERNATIVE	GENERAL PLAN (SJD-FRE)	SR 59 / SR 152 INTERCHANGE - 4 OF 4	
ST-K1110-A	CENTRAL VALLEY WYE	SR 152 (NORTH) TO ROAD 13 WYE ALTERNATIVE	GENERAL PLAN (SJD-FRE)	LINCOLN ROAD (ROAD 4) OVERHEAD	
ST-K1160-A	CENTRAL VALLEY WYE	SR 152 (NORTH) TO ROAD 13 WYE ALTERNATIVE	GENERAL PLAN (SJD-FRE)	HEMLOCK ROAD (ROAD 9) INTERCHANGE - 1 OF 2	
ST-K3160-A	CENTRAL VALLEY WYE	SR 152 (NORTH) TO ROAD 13 WYE ALTERNATIVE	TYPICAL SECTIONS (SJD-FRE)	HEMLOCK ROAD (ROAD 9) INTERCHANGE - 2 OF 2	
ST-K1170-A	CENTRAL VALLEY WYE	SR 152 (NORTH) TO ROAD 13 WYE ALTERNATIVE	GENERAL PLAN (SJD-FRE)	ASH SLOUGH BRIDGE - 1 OF 2	
ST-K3170-A	CENTRAL VALLEY WYE	SR 152 (NORTH) TO ROAD 13 WYE ALTERNATIVE	TYPICAL SECTION (SJD-FRE)	ASH SLOUGH BRIDGE - 2 OF 2	
ST-K1190-A	CENTRAL VALLEY WYE	SR 152 (NORTH) TO ROAD 13 WYE ALTERNATIVE	GENERAL PLAN (SJD-FRE)	ELM ROAD (ROAD 12) UNDERPASS	
ST-K1195-A	CENTRAL VALLEY WYE	SR 152 (NORTH) TO ROAD 13 WYE ALTERNATIVE	GENERAL PLAN (SJD-FRE)	SR 152 (ROAD 12) UNDERCROSSING	
ST-K1210-A	CENTRAL VALLEY WYE	SR 152 (NORTH) TO ROAD 13 WYE ALTERNATIVE	GENERAL PLAN (SJD-FRE)	ROBERTSON BOULEVARD (SR 233) INTERCHANGE - 1 OF 2	
ST-K3210-A	CENTRAL VALLEY WYE	SR 152 (NORTH) TO ROAD 13 WYE ALTERNATIVE	TYPICAL SECTIONS (SJD-FRE)	ROBERTSON BOULEVARD (SR 233) INTERCHANGE - 2 OF 2	
ST-K1220-A	CENTRAL VALLEY WYE	SR 152 (NORTH) TO ROAD 13 WYE ALTERNATIVE	GENERAL PLAN (SJD-FRE)	BERENDA SLOUGH BRIDGE - 1 OF 2	
ST-K3220-A	CENTRAL VALLEY WYE	SR 152 (NORTH) TO ROAD 13 WYE ALTERNATIVE	TYPICAL SECTION (SJD-FRE)	BERENDA SLOUGH BRIDGE - 2 OF 2	
ST-K1230-A	CENTRAL VALLEY WYE	SR 152 (NORTH) TO ROAD 13 WYE ALTERNATIVE	GENERAL PLAN (SJD-FRE)	BERENDA WAY (ROAD 16) UNDERPASS	
ST-K1235-A	CENTRAL VALLEY WYE	SR 152 (NORTH) TO ROAD 13 WYE ALTERNATIVE	GENERAL PLAN (SJD-FRE)	BERENDA WAY (ROAD 16) INTERCHANGE - 1 OF 2	
ST-K3235-A	CENTRAL VALLEY WYE	SR 152 (NORTH) TO ROAD 13 WYE ALTERNATIVE	TYPICAL SECTION (SJD-FRE)	BERENDA WAY (ROAD 16) INTERCHANGE - 2 OF 2	
ST-K1240-A	CENTRAL VALLEY WYE	SR 152 (NORTH) TO ROAD 13 WYE ALTERNATIVE		ROAD 17 1/2 OVERHEAD	
		DESIGNED BY M. BRATT RECORD SET DRAWN BY 15% DESIGN		CALIFORNIA HIGH-SPEED TI Merced to Fresno s	
		CHECKED BY K. CHARAN IN CHARGE NOT FOR	PARSONS	CENTRAL VALLEY WY STRUCTURE, VIADUCT AND TUN TALIFORNIA	

BY CHK APP

DESCRIPTION

15% DESIGN Submittal NOT FOR CONSTRUCTION

IN CHARGE
C. LEMLEY

DATE 08/12/2016



AIN PROJECT MERCED TO FRESNO SECTION

CENTRAL VALLEY WYE STRUCTURE, VIADUCT AND TUNNEL PLANS INDEX OF DRAWINGS SHEET 1 OF 8

CONTRACT NO. HSRO8-05
DRAWING NO. ST-B0002
NO SCALE
SHEET NO.

			INDEX OF DRAWINGS		
DRAWING NO.	SECTION	ALIGNMENT / PLAN SET	TITLE	DESCRIPTION	
ST-K1250-A	CENTRAL VALLEY WYE	SR 152 (NORTH) TO ROAD 13 WYE ALTERNATIVE	GENERAL PLAN (SJD-FRE)	AERIAL #2 - SR 99 / UPRR - 1 OF 3	
ST-K1251-A	CENTRAL VALLEY WYE	SR 152 (NORTH) TO ROAD 13 WYE ALTERNATIVE	GENERAL PLAN (SJD-FRE)	AERIAL #2 - SR 99 / UPRR - 2 OF 3	
ST-K3250-A	CENTRAL VALLEY WYE	SR 152 (NORTH) TO ROAD 13 WYE ALTERNATIVE	TYPICAL SECTIONS (SJD-FRE)	AERIAL #2 - SR 99 / UPRR - 3 OF 3	
ST-K1260-A	CENTRAL VALLEY WYE	SR 152 (NORTH) TO ROAD 13 WYE ALTERNATIVE	GENERAL PLAN (SJD-FRE)	ROAD 20 OVERHEAD	
ST-K1280-A	CENTRAL VALLEY WYE	SR 152 (NORTH) TO ROAD 13 WYE ALTERNATIVE	GENERAL PLAN (SJD-FRE)	ROAD 22 OVERHEAD	
ST-K1310-A	CENTRAL VALLEY WYE	SR 152 (NORTH) TO ROAD 13 WYE ALTERNATIVE	GENERAL PLAN (SJD-FRE)	AVENUE 20 1/2 OVERHEAD	
ST-K1330-A	CENTRAL VALLEY WYE	SR 152 (NORTH) TO ROAD 13 WYE ALTERNATIVE	GENERAL PLAN (SJD-FRE)	DRY CREEK BRIDGE	
ST-K1420-A	CENTRAL VALLEY WYE	SR 152 (NORTH) TO ROAD 13 WYE ALTERNATIVE	GENERAL PLAN (MER-FRE)	AERIAL #3 - SOUTHBOUND OVER HST MAINLINE - 1 OF 6	
ST-K1421-A	CENTRAL VALLEY WYE	SR 152 (NORTH) TO ROAD 13 WYE ALTERNATIVE	GENERAL PLAN (MER-FRE)	AERIAL #3 - SOUTHBOUND OVER HST MAINLINE - 2 OF 6	
ST-K1422-A	CENTRAL VALLEY WYE	SR 152 (NORTH) TO ROAD 13 WYE ALTERNATIVE	GENERAL PLAN (MER-FRE)	AERIAL #3 - SOUTHBOUND OVER HST MAINLINE - 3 OF 6	
ST-K3420-A	CENTRAL VALLEY WYE	SR 152 (NORTH) TO ROAD 13 WYE ALTERNATIVE	TYPICAL SECTION (MER-FRE)	AERIAL #3 - SOUTHBOUND OVER HST MAINLINE - 4 OF 6	
ST-K3421-A	CENTRAL VALLEY WYE	SR 152 (NORTH) TO ROAD 13 WYE ALTERNATIVE	TYPICAL SECTION (MER-FRE)	AERIAL #3 - SOUTHBOUND OVER HST MAINLINE - 5 OF 6	
ST-K3422-A	CENTRAL VALLEY WYE	SR 152 (NORTH) TO ROAD 13 WYE ALTERNATIVE	TYPICAL SECTIONS (MER-FRE)	AERIAL #3 - SOUTHBOUND OVER HST MAINLINE - 6 OF 6	
ST-K1430-A	CENTRAL VALLEY WYE	SR 152 (NORTH) TO ROAD 13 WYE ALTERNATIVE	GENERAL PLAN (MER-FRE)	RAILROAD DRIVE UNDERPASS (HST NB)	
ST-K1433-A	CENTRAL VALLEY WYE	SR 152 (NORTH) TO ROAD 13 WYE ALTERNATIVE	GENERAL PLAN (MER-FRE)	ROBERTSON BOULEVARD (SR 233) UNDERPASS	
ST-K1436-A	CENTRAL VALLEY WYE	SR 152 (NORTH) TO ROAD 13 WYE ALTERNATIVE	GENERAL PLAN (MER-FRE)	MADISON ROAD (AVENUE 23 1/2) UNDERPASS	
ST-K1450-A	CENTRAL VALLEY WYE	SR 152 (NORTH) TO ROAD 13 WYE ALTERNATIVE	GENERAL PLAN (MER-FRE)	WASHINGTON ROAD (AVENUE 25) UNDERPASS - 1 OF 2	
ST-K3450-A	CENTRAL VALLEY WYE	SR 152 (NORTH) TO ROAD 13 WYE ALTERNATIVE	TYPICAL SECTION (MER-FRE)	WASHINGTON ROAD (AVENUE 25) UNDERPASS - 2 OF 2	
ST-K1455-A	CENTRAL VALLEY WYE	SR 152 (NORTH) TO ROAD 13 WYE ALTERNATIVE	GENERAL PLAN (MER-FRE)	ASH SLOUGH BRIDGE - 1 OF 2	
ST-K3455-A	CENTRAL VALLEY WYE	SR 152 (NORTH) TO ROAD 13 WYE ALTERNATIVE	TYPICAL SECTION (MER-FRE)	ASH SLOUGH BRIDGE - 2 OF 2	
ST-K1460-A	CENTRAL VALLEY WYE	SR 152 (NORTH) TO ROAD 13 WYE ALTERNATIVE	GENERAL PLAN (MER-FRE)	AVENUE 26 1/2 UNDERPASS	
ST-K1470-A	CENTRAL VALLEY WYE	SR 152 (NORTH) TO ROAD 13 WYE ALTERNATIVE	GENERAL PLAN (MER-FRE)	CHOWCHILLA RIVER BRIDGE - 1 OF 2	
ST-K3470-A	CENTRAL VALLEY WYE	SR 152 (NORTH) TO ROAD 13 WYE ALTERNATIVE	TYPICAL SECTION (MER-FRE)	CHOWCHILLA RIVER BRIDGE - 2 OF 2	
ST-K1475-A	CENTRAL VALLEY WYE	SR 152 (NORTH) TO ROAD 13 WYE ALTERNATIVE	GENERAL PLAN (MER-FRE)	VISTA AVENUE (ROAD 13) UNDERPASS	
ST-K1490-A	CENTRAL VALLEY WYE	SR 152 (NORTH) TO ROAD 13 WYE ALTERNATIVE	GENERAL PLAN (MER-FRE)	DUTCHMAN CREEK BRIDGE	
ST-K1495-A	CENTRAL VALLEY WYE	SR 152 (NORTH) TO ROAD 13 WYE ALTERNATIVE	GENERAL PLAN (MER-FRE)	ROAD 11 BRIDGE	
ST-T1500-A	CENTRAL VALLEY WYE	SR 152 (NORTH) TO ROAD 13 WYE ALTERNATIVE	GENERAL PLAN (MER-FRE)	RETAINED CUT - SANDY MUSH ROAD - 1 OF 2	
ST-T3500-A	CENTRAL VALLEY WYE	SR 152 (NORTH) TO ROAD 13 WYE ALTERNATIVE	TYPICAL SECTIONS (MER-FRE)	RETAINED CUT - SANDY MUSH ROAD - 2 OF 2	
ST-K1500-A	CENTRAL VALLEY WYE	SR 152 (NORTH) TO ROAD 13 WYE ALTERNATIVE	GENERAL PLAN (MER-FRE)	SANDY MUSH ROAD OVERHEAD	
ST-K1620-A	CENTRAL VALLEY WYE	SR 152 (NORTH) TO ROAD 13 WYE ALTERNATIVE	GENERAL PLAN (SJD-MER)	AERIAL #4 - NORTHBOUND OVER HST MAINLINE - 1 OF 6	
ST-K1621-A	CENTRAL VALLEY WYE	SR 152 (NORTH) TO ROAD 13 WYE ALTERNATIVE	GENERAL PLAN (SJD-MER)	AERIAL #4 - NORTHBOUND OVER HST MAINLINE - 2 OF 6	
ST-K1622-A	CENTRAL VALLEY WYE	SR 152 (NORTH) TO ROAD 13 WYE ALTERNATIVE	GENERAL PLAN (SJD-MER)	AERIAL #4 - NORTHBOUND OVER HST MAINLINE - 3 OF 6	
ST-K1623-A	CENTRAL VALLEY WYE	SR 152 (NORTH) TO ROAD 13 WYE ALTERNATIVE	GENERAL PLAN (SJD-MER)	AERIAL #4 - NORTHBOUND OVER HST MAINLINE - 4 OF 6	
ST-K3620-A	CENTRAL VALLEY WYE	SR 152 (NORTH) TO ROAD 13 WYE ALTERNATIVE	TYPICAL SECTIONS (SJD-MER)	AERIAL #4 - NORTHBOUND OVER HST MAINLINE - 5 OF 6	
ST-K3621-A	CENTRAL VALLEY WYE	SR 152 (NORTH) TO ROAD 13 WYE ALTERNATIVE	TYPICAL SECTIONS (SJD-MER)	AERIAL #4 - NORTHBOUND OVER HST MAINLINE - 6 OF 6	
ST-K1630-A	CENTRAL VALLEY WYE	SR 152 (NORTH) TO ROAD 13 WYE ALTERNATIVE	GENERAL PLAN (SJD-MER)	ELM ROAD (ROAD 12) UNDERPASS	
ST-K1635-A	CENTRAL VALLEY WYE	SR 152 (NORTH) TO ROAD 13 WYE ALTERNATIVE	GENERAL PLAN (SJD-MER)	MADISON ROAD (AVENUE 23 1/2) OVERHEAD	
ST-K1650-A	CENTRAL VALLEY WYE	SR 152 (NORTH) TO ROAD 13 WYE ALTERNATIVE	GENERAL PLAN (SJD-MER)	AERIAL #5 - NORTHBOUND OVER HST MERCED TO FRESNO - 1 OF 5	
ST-K1651-A	CENTRAL VALLEY WYE	SR 152 (NORTH) TO ROAD 13 WYE ALTERNATIVE	GENERAL PLAN (SJD-MER)	AERIAL #5 - NORTHBOUND OVER HST MERCED TO FRESNO - 2 OF 5	
ST-K1652-A	CENTRAL VALLEY WYE	SR 152 (NORTH) TO ROAD 13 WYE ALTERNATIVE	GENERAL PLAN (SJD-MER)	AERIAL #5 - NORTHBOUND OVER HST MERCED TO FRESNO - 3 OF 5	
ST-K3650-A	CENTRAL VALLEY WYE	SR 152 (NORTH) TO ROAD 13 WYE ALTERNATIVE	TYPICAL SECTIONS (SJD-MER)	AERIAL #5 - NORTHBOUND OVER HST MERCED TO FRESNO - 4 OF 5	
ST-K3651-A	CENTRAL VALLEY WYE	SR 152 (NORTH) TO ROAD 13 WYE ALTERNATIVE	TYPICAL SECTIONS (SJD-MER)	AERIAL #5 - NORTHBOUND OVER HST MERCED TO FRESNO - 5 OF 5	

- AU								
16-							DESIGNED BY M. BRATT	
							DRAWN BY A. M.	
_							CHECKED BY K. CHARAN	
1330							IN CHARGE C. LEMLEY	
p0051	REV	DATE	BY	снк	APP	DESCRIPTION	DATE 08/12/2016	

RECORD SET 15% DESIGN SUBMITTAL NOT FOR CONSTRUCTION





CALIFORNIA HIGH-SPEED TRAIN PROJECT MERCED TO FRESNO SECTION

CENTRAL VALLEY WYE STRUCTURE, VIADUCT AND TUNNEL PLANS INDEX OF DRAWINGS SHEET 2 OF 8

CONTRACT NO.
HSR08-05
DRAWING NO.
ST-B0003
SCALE
NO SCALE
SHEET NO.

OF 2	
DF 2	
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CH - 1 OF 2	
CH - 2 OF 2	
4	
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4	
OF 2	
OF 2	
ASH SLOUGH BRIDGE ELM ROAD (ROAD 12) OVERHEAD	
ROBERTSON BOULEVARD (SR 233) INTERCHANGE - 1 OF 2	
ROBERTSON BOULEVARD (SR 233) INTERCHANGE - 2 OF 2	
BERENDA SLOUGH BRIDGE	
OF 2	
OF 2	
 }	
3	
3	
3	
ROAD 22 OVERHEAD	
AVENUE 20 1/2 OVERHEAD	
DRY CREEK BRIDGE	
AERIAL #3 - SOUTHBOUND OVER HST MAINLINE - 1 OF 5	
AERIAL #3 - SOUTHBOUND OVER HST MAINLINE - 2 OF 5	
AERIAL #3 - SOUTHBOUND OVER HST MAINLINE - 3 OF 5	
AERIAL #3 - SOUTHBOUND OVER HST MAINLINE - 4 OF 5	
- 5 OF 5	
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16-AUG-201607:

| DESIGNED BY | M. BRATT | DRAWN BY | A. M. | CHECKED BY | K. CHARAN | IN CHARGE | C. LEMLEY | DATE | BY CHK | APP | DESCRIPTION | DATE | O8/12/2016

RECORD SET
15% DESIGN
SUBMITTAL
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CONSTRUCTION





CALIFORNIA HIGH-SPEED TRAIN PROJECT MERCED TO FRESNO SECTION

CENTRAL VALLEY WYE STRUCTURE, VIADUCT AND TUNNEL PLANS INDEX OF DRAWINGS SHEET 3 OF 8 CONTRACT NO.
HSR08-05
DRAWING NO.
ST-B0004
SCALE
NO SCALE

NO SCALE

AUG								
16-							DESIGNED BY M. BRATT	Г
							DRAWN BY A. M.	1
0							CHECKED BY K. CHARAN	1
5133a							IN CHARGE C. LEMLEY	
p0051	REV	DATE	BY	снк	APP	DESCRIPTION	DATE 08/12/2016	

RECORD SET
15% DESIGN
SUBMITTAL
NOT FOR
CONSTRUCTION





CALIFORNIA HIGH-SPEED TRAIN PROJECT MERCED TO FRESNO SECTION

CENTRAL VALLEY WYE
STRUCTURE, VIADUCT AND TUNNEL PLANS
INDEX OF DRAWINGS
SHEET 4 OF 8

CONTRACT NO.
HSR08-05
DRAWING NO.
ST-B0005
SCALE
NO SCALE

SHEET NO.

				INDEX OF DRAWINGS				
DRAWING NO.	SECTION	ALIGNMENT / PLAN S	EΤ	TITLE		DESCRIPTION		
ST-K1070-C	CENTRAL VALLEY WYE	AVENUE 21 TO ROAD 13 WYE	ALTERNATIVE	GENERAL PLAN (SJD-FRE)	SAN JOAQUIN RIVER BRIDGE - 1 OF 2			
ST-K3070-C	CENTRAL VALLEY WYE	AVENUE 21 TO ROAD 13 WYE	ALTERNATIVE	TYPICAL SECTION (SJD-FRE)	SAN JOAQU	SAN JOAQUIN RIVER BRIDGE - 2 OF 2		
ST-K1080-C	CENTRAL VALLEY WYE	AVENUE 21 TO ROAD 13 WYE	ALTERNATIVE	GENERAL PLAN (SJD-FRE)	AERIAL #1 - FRESNO	RIVER AND MARIPOSA SLOUGH - 1 OF 2		
ST-K3080-C	CENTRAL VALLEY WYE	AVENUE 21 TO ROAD 13 WYE	ALTERNATIVE	TYPICAL SECTION (SJD-FRE)	AERIAL #1 - FRESNO	RIVER AND MARIPOSA SLOUGH - 2 OF 2		
ST-K1085-C	CENTRAL VALLEY WYE	AVENUE 21 TO ROAD 13 WYE	ALTERNATIVE	GENERAL PLAN (SJD-FRE)	S	R 152 UNDERPASS		
ST-K1090-C	CENTRAL VALLEY WYE	AVENUE 21 TO ROAD 13 WYE	ALTERNATIVE	GENERAL PLAN (SJD-FRE)	FLAN	AGAN ROAD UNDERPASS		
ST-K1100-C	CENTRAL VALLEY WYE	AVENUE 21 TO ROAD 13 WYE	ALTERNATIVE	GENERAL PLAN (SJD-FRE)	AERIAL #2 - EASTSI	DE BYPASS IRRIGATION DITCH - 1 OF 2		
ST-K3100-C	CENTRAL VALLEY WYE	AVENUE 21 TO ROAD 13 WYE	ALTERNATIVE	TYPICAL SECTION (SJD-FRE)	AERIAL #2 - EASTSI	DE BYPASS IRRIGATION DITCH - 2 OF 2		
ST-K1120-C	CENTRAL VALLEY WYE	AVENUE 21 TO ROAD 13 WYE	ALTERNATIVE	GENERAL PLAN (SJD-FRE)	LINCOLN	ROAD (ROAD 4) OVERHEAD		
ST-K1150-C	CENTRAL VALLEY WYE	AVENUE 21 TO ROAD 13 WYE	ALTERNATIVE	GENERAL PLAN (SJD-FRE)	JUNIPER	ROAD (ROAD 7) UNDERPASS		
ST-K1155-C	CENTRAL VALLEY WYE	AVENUE 21 TO ROAD 13 WYE	ALTERNATIVE	GENERAL PLAN (SJD-FRE)	ASH S	LOUGH BRIDGE - 1 OF 2		
ST-K3155-C	CENTRAL VALLEY WYE	AVENUE 21 TO ROAD 13 WYE	ALTERNATIVE	TYPICAL SECTION (SJD-FRE)	ASH S	LOUGH BRIDGE - 2 OF 2		
ST-K1160-C	CENTRAL VALLEY WYE	AVENUE 21 TO ROAD 13 WYE	ALTERNATIVE	GENERAL PLAN (SJD-FRE)	HEMLOCK	ROAD (ROAD 9) OVERHEAD		
ST-K1200-C	CENTRAL VALLEY WYE	AVENUE 21 TO ROAD 13 WYE	ALTERNATIVE	GENERAL PLAN (SJD-FRE)	ROBERTS	ON BOULEVARD OVERHEAD		
ST-K1210-C	CENTRAL VALLEY WYE	AVENUE 21 TO ROAD 13 WYE	ALTERNATIVE	GENERAL PLAN (SJD-FRE)	R	DAD 14 UNDERPASS		
ST-K1220-C	CENTRAL VALLEY WYE	AVENUE 21 TO ROAD 13 WYE	ALTERNATIVE	GENERAL PLAN (SJD-FRE)	BER	ENDA SLOUGH BRIDGE		
ST-K1230-C	CENTRAL VALLEY WYE	AVENUE 21 TO ROAD 13 WYE	ALTERNATIVE	GENERAL PLAN (SJD-FRE)	BERENDA	WAY (ROAD 16) OVERHEAD		
ST-K1260-C	CENTRAL VALLEY WYE	AVENUE 21 TO ROAD 13 WYE	ALTERNATIVE	GENERAL PLAN (SJD-FRE)	R	OAD 19 OVERHEAD		
ST-K1270-C	CENTRAL VALLEY WYE	AVENUE 21 TO ROAD 13 WYE	ALTERNATIVE	GENERAL PLAN (SJD-FRE)	RO	DAD 20 UNDERPASS		
ST-K1275-C	CENTRAL VALLEY WYE	AVENUE 21 TO ROAD 13 WYE	ALTERNATIVE	GENERAL PLAN (SJD-FRE)	AERIAL #3	3 - SR 99 / UPRR - 1 OF 2		
ST-K3275-C	CENTRAL VALLEY WYE	AVENUE 21 TO ROAD 13 WYE	ALTERNATIVE	TYPICAL SECTIONS (SJD-FRE)	AERIAL #3	3 - SR 99 / UPRR - 2 OF 2		
ST-K1290-C	CENTRAL VALLEY WYE	AVENUE 21 TO ROAD 13 WYE	ALTERNATIVE	GENERAL PLAN (SJD-FRE)	R	ROAD 22 OVERHEAD		
ST-K1300-C	CENTRAL VALLEY WYE	AVENUE 21 TO ROAD 13 WYE	ALTERNATIVE	GENERAL PLAN (SJD-FRE)	AVEN	AVENUE 20 1/2 OVERHEAD		
ST-K1320-C	CENTRAL VALLEY WYE	AVENUE 21 TO ROAD 13 WYE	ALTERNATIVE	GENERAL PLAN (SJD-FRE)	С	DRY CREEK BRIDGE		
ST-K1420-C	CENTRAL VALLEY WYE	AVENUE 21 TO ROAD 13 WYE	ALTERNATIVE	GENERAL PLAN (MER-FRE)	AERIAL #4 - SOUTI	AERIAL #4 - SOUTHBOUND OVER HST MAINLINE - 1 OF 6		
ST-K1421-C	CENTRAL VALLEY WYE	AVENUE 21 TO ROAD 13 WYE	ALTERNATIVE	GENERAL PLAN (MER-FRE)	AERIAL #4 - SOUTH	AERIAL #4 - SOUTHBOUND OVER HST MAINLINE - 2 OF 6		
ST-K1422-C	CENTRAL VALLEY WYE	AVENUE 21 TO ROAD 13 WYE	ALTERNATIVE	GENERAL PLAN (MER-FRE)	AERIAL #4 - SOUTH	HBOUND OVER HST MAINLINE - 3 OF 6		
ST-K1423-C	CENTRAL VALLEY WYE	AVENUE 21 TO ROAD 13 WYE	ALTERNATIVE	GENERAL PLAN (MER-FRE)	AERIAL #4 - SOUTH	HBOUND OVER HST MAINLINE - 4 OF 6		
ST-K3420-C	CENTRAL VALLEY WYE	AVENUE 21 TO ROAD 13 WYE	ALTERNATIVE	TYPICAL SECTIONS (MER-FRE)	AERIAL #4 - SOUTH	HBOUND OVER HST MAINLINE - 5 OF 6		
ST-K3421-C	CENTRAL VALLEY WYE	AVENUE 21 TO ROAD 13 WYE	ALTERNATIVE	TYPICAL SECTIONS (MER-FRE)	AERIAL #4 - SOUTH	HBOUND OVER HST MAINLINE - 6 OF 6		
ST-K1426-C	CENTRAL VALLEY WYE	AVENUE 21 TO ROAD 13 WYE	ALTERNATIVE	GENERAL PLAN (MER-FRE)	HST NB BR	IDGE OVER BERENDA SLOUGH		
ST-K1430-C	CENTRAL VALLEY WYE	AVENUE 21 TO ROAD 13 WYE	ALTERNATIVE	GENERAL PLAN (MER-FRE)	ROAD	14 UNDERPASS (HST NB)		
ST-K1435-C	CENTRAL VALLEY WYE	AVENUE 21 TO ROAD 13 WYE	ALTERNATIVE	GENERAL PLAN (MER-FRE)	AVEN	NUE 21 1/2 OVERHEAD		
ST-K1440-C	CENTRAL VALLEY WYE	AVENUE 21 TO ROAD 13 WYE	ALTERNATIVE	GENERAL PLAN (MER-FRE)	ROBERTSO	ROBERTSON BOULEVARD UNDERPASS		
ST-K1445-C	CENTRAL VALLEY WYE	AVENUE 21 TO ROAD 13 WYE	ALTERNATIVE	GENERAL PLAN (MER-FRE)	AVEN	AVENUE 22 1/2 UNDERPASS		
ST-K1450-C	CENTRAL VALLEY WYE	AVENUE 21 TO ROAD 13 WYE	ALTERNATIVE	GENERAL PLAN (MER-FRE)	SR 15	SR 152 UNDERPASS - 1 OF 2		
ST-K3450-C	CENTRAL VALLEY WYE	AVENUE 21 TO ROAD 13 WYE	ALTERNATIVE	TYPICAL SECTION (MER-FRE)	SR 15	SR 152 UNDERPASS - 2 OF 2		
ST-K1470-C	CENTRAL VALLEY WYE	AVENUE 21 TO ROAD 13 WYE	ALTERNATIVE	GENERAL PLAN (MER-FRE)	WASHINGTON	WASHINGTON ROAD (AVENUE 25) UNDERPASS		
ST-K1475-C	CENTRAL VALLEY WYE	AVENUE 21 TO ROAD 13 WYE	ALTERNATIVE	GENERAL PLAN (MER-FRE)	ASH S	ASH SLOUGH BRIDGE - 1 OF 2		
ST-K3475-C	CENTRAL VALLEY WYE	AVENUE 21 TO ROAD 13 WYE	ALTERNATIVE	TYPICAL SECTION (MER-FRE)	ASH S	ASH SLOUGH BRIDGE - 2 OF 2		
ST-K1480-C	CENTRAL VALLEY WYE	AVENUE 21 TO ROAD 13 WYE	ALTERNATIVE	GENERAL PLAN (MER-FRE)	AVEN	AVENUE 26 1/2 UNDERPASS		
ST-K1490-C	CENTRAL VALLEY WYE	AVENUE 21 TO ROAD 13 WYE	ALTERNATIVE	GENERAL PLAN (MER-FRE)	CHOWCHIL	CHOWCHILLA RIVER BRIDGE - 1 OF 2		
ST-K3490-C	CENTRAL VALLEY WYE	AVENUE 21 TO ROAD 13 WYE .	ALTERNATIVE	TYPICAL SECTION (MER-FRE)	CHOWCHIL	LA RIVER BRIDGE - 2 OF 2		
		DESIGNED BY M. BRATT DRAWN BY A. M. CHECKED BY K. CHARAN IN CHARGE	RECORD SET 15% DESIGN SUBMITTAL NOT FOR	PARSONS	CALIFORNIA	CALIFORNIA HIGH-SPEED T MERCED TO FRESNO S CENTRAL VALLEY WY STRUCTURE, VIADUCT AND TUI		

BY CHK APP

DESCRIPTION

15% DESIGN Submittal NOT FOR CONSTRUCTION

IN CHARGE
C. LEMLEY

DATE 08/12/2016



AIN PROJECT MERCED TO FRESNO SECTION

CENTRAL VALLEY WYE
STRUCTURE, VIADUCT AND TUNNEL PLANS
INDEX OF DRAWINGS
SHEET 5 OF 8

HSRO8-05
DRAWING NO. ST-B0006
NO SCALE

SHEET NO.

<u> </u>				INDEX OF DRAWINGS			
DRAWING NO.	SECTION	ALIGNMENT / PLAN SI	ΞΤ	TITLE	DESCRIPTION		
ST-K1495-C	CENTRAL VALLEY WYE	AVENUE 21 TO ROAD 13 WYE A	LTERNATIVE	GENERAL PLAN (MER-FRE)	GENERAL PLAN (MER-FRE) VISTA AVENUE (ROAD 13) UNDERPASS		
ST-K1510-C	CENTRAL VALLEY WYE	AVENUE 21 TO ROAD 13 WYE A	LTERNATIVE	GENERAL PLAN (MER-FRE)	DUTCHMAN CREEK BRIDGE		
ST-K1515-C	CENTRAL VALLEY WYE	AVENUE 21 TO ROAD 13 WYE A	LTERNATIVE	GENERAL PLAN (MER-FRE)	ROAD 11 BRIDGE		
ST-T1520-C	CENTRAL VALLEY WYE	AVENUE 21 TO ROAD 13 WYE A	LTERNATIVE	GENERAL PLAN (MER-FRE)	RETAINED CUT - SANDY MUSH ROAD - 1	OF 2	
ST-T3520-C	CENTRAL VALLEY WYE	AVENUE 21 TO ROAD 13 WYE A	LTERNATIVE	TYPICAL SECTIONS (MER-FRE)	RETAINED CUT - SANDY MUSH ROAD - 2	OF 2	
ST-K1520-C	CENTRAL VALLEY WYE	AVENUE 21 TO ROAD 13 WYE A	LTERNATIVE	GENERAL PLAN (MER-FRE)	SANDY MUSH ROAD OVERHEAD		
ST-K1620-C	CENTRAL VALLEY WYE	AVENUE 21 TO ROAD 13 WYE A	LTERNATIVE	GENERAL PLAN (SJD-MER)	AERIAL #5 - NORTHBOUND OVER HST MAINLINE	- 1 OF 5	
ST-K1621-C	CENTRAL VALLEY WYE	AVENUE 21 TO ROAD 13 WYE A	LTERNATIVE	GENERAL PLAN (SJD-MER)	AERIAL #5 - NORTHBOUND OVER HST MAINLINE	- 2 OF 5	
ST-K1622-C	CENTRAL VALLEY WYE	AVENUE 21 TO ROAD 13 WYE A	LTERNATIVE	GENERAL PLAN (SJD-MER)	AERIAL #5 - NORTHBOUND OVER HST MAINLINE	- 3 OF 5	
ST-K3620-C	CENTRAL VALLEY WYE	AVENUE 21 TO ROAD 13 WYE A	LTERNATIVE	TYPICAL SECTIONS (SJD-MER)	AERIAL #5 - NORTHBOUND OVER HST MAINLINE	- 4 OF 5	
T-K3621-C	CENTRAL VALLEY WYE	AVENUE 21 TO ROAD 13 WYE A	LTERNATIVE	TYPICAL SECTIONS (SJD-MER)	AERIAL #5 - NORTHBOUND OVER HST MAINLINE	- 5 OF 5	
T-K1630-C	CENTRAL VALLEY WYE	AVENUE 21 TO ROAD 13 WYE A	LTERNATIVE	GENERAL PLAN (SJD-MER)	AVENUE 21 1/2 OVERHEAD		
ST-K1640-C	CENTRAL VALLEY WYE	AVENUE 21 TO ROAD 13 WYE A	LTERNATIVE	GENERAL PLAN (SJD-MER)	AERIAL #6 - NORTHBOUND OVER HST MERCED TO FR	ESNO - 1 OF	
T-K1641-C	CENTRAL VALLEY WYE	AVENUE 21 TO ROAD 13 WYE #	LTERNATIVE	GENERAL PLAN (SJD-MER)	AERIAL #6 - NORTHBOUND OVER HST MERCED TO FR	ESNO - 2 OF	
T-K1642-C	CENTRAL VALLEY WYE	AVENUE 21 TO ROAD 13 WYE A	LTERNATIVE	GENERAL PLAN (SJD-MER)	AERIAL #6 - NORTHBOUND OVER HST MERCED TO FR	ESNO - 3 OF	
T-K1643-C	CENTRAL VALLEY WYE	AVENUE 21 TO ROAD 13 WYE A	LTERNATIVE	GENERAL PLAN (SJD-MER)	AERIAL #6 - NORTHBOUND OVER HST MERCED TO FR	ESNO - 4 OF	
T-K3640-C	CENTRAL VALLEY WYE	AVENUE 21 TO ROAD 13 WYE A	LTERNATIVE	TYPICAL SECTIONS (SJD-MER)	AERIAL #6 - NORTHBOUND OVER HST MERCED TO FR	ESNO - 5 OF	
T-K3641-C	CENTRAL VALLEY WYE	AVENUE 21 TO ROAD 13 WYE A	LTERNATIVE	TYPICAL SECTIONS (SJD-MER)	AERIAL #6 - NORTHBOUND OVER HST MERCED TO FR	ESNO - 6 OF	
T-K1646-C	CENTRAL VALLEY WYE	AVENUE 21 TO ROAD 13 WYE A	LTERNATIVE	GENERAL PLAN (SJD-MER)	AVENUE 22 1/2 UNDERPASS (HST SB)		
			SR 152	(NORTH) TO ROAD 11 WYE ALTERNATIVE	<u>'</u>		
T-B4001-D	CENTRAL VALLEY WYE	SR 152 (NORTH) TO ROAD 11 WYE	ALTERNATIVE	KEY MAP OF STRUCTURAL PLANS	SHEET 1 OF 2		
T-B4002-D	CENTRAL VALLEY WYE	SR 152 (NORTH) TO ROAD 11 WYE	ALTERNATIVE	KEY MAP OF STRUCTURAL PLANS	SHEET 2 OF 2		
T-K1050-D	CENTRAL VALLEY WYE	SR 152 (NORTH) TO ROAD 11 WYE	ALTERNATIVE	GENERAL PLAN (SJD-FRE)	INDIANA ROAD OVERHEAD	INDIANA ROAD OVERHEAD	
T-K1055-D	CENTRAL VALLEY WYE	SR 152 (NORTH) TO ROAD 11 WYE	ALTERNATIVE	GENERAL PLAN (SJD-FRE)	WOOD SLOUGH BRIDGE	WOOD SLOUGH BRIDGE	
Γ-K1060-D	CENTRAL VALLEY WYE	SR 152 (NORTH) TO ROAD 11 WYE	ALTERNATIVE	GENERAL PLAN (SJD-FRE)	WILLIS ROAD UNDERPASS		
T-K1065-D	CENTRAL VALLEY WYE	SR 152 (NORTH) TO ROAD 11 WYE	ALTERNATIVE	GENERAL PLAN (SJD-FRE)	SAN JOAQUIN RIVER BRIDGE - 1 OF 2	2	
Γ-K3065-D	CENTRAL VALLEY WYE	SR 152 (NORTH) TO ROAD 11 WYE	ALTERNATIVE	TYPICAL SECTION (SJD-FRE)	SAN JOAQUIN RIVER BRIDGE - 2 OF 2	<u> </u>	
Γ-K1070-D	CENTRAL VALLEY WYE	SR 152 (NORTH) TO ROAD 11 WYE	ALTERNATIVE	GENERAL PLAN (SJD-FRE)	MARIPOSA SLOUGH BRIDGE		
T-K1075-D	CENTRAL VALLEY WYE	SR 152 (NORTH) TO ROAD 11 WYE	ALTERNATIVE	GENERAL PLAN (SJD-FRE)	HARMON ROAD UNDERPASS		
T-K1080-D	CENTRAL VALLEY WYE	SR 152 (NORTH) TO ROAD 11 WYE	ALTERNATIVE	GENERAL PLAN (SJD-FRE)	AERIAL #1 - EASTSIDE BYPASS IRRIGATION DITC	 CH - 1 OF 2	
Γ-K3080-D	CENTRAL VALLEY WYE	SR 152 (NORTH) TO ROAD 11 WYE	ALTERNATIVE	TYPICAL SECTION (SJD-FRE)	AERIAL #1 - EASTSIDE BYPASS IRRIGATION DITC	 CH - 2 OF 2	
T-K1100-D	CENTRAL VALLEY WYE	SR 152 (NORTH) TO ROAD 11 WYE	- ALTERNATIVE	GENERAL PLAN (SJD-FRE)	SR 59 / SR 152 INTERCHANGE - 1 OF	4	
T-K1101-D	CENTRAL VALLEY WYE	SR 152 (NORTH) TO ROAD 11 WYE	ALTERNATIVE	GENERAL PLAN (SJD-FRE)	SR 59 / SR 152 INTERCHANGE - 2 OF	4	
T-K3101-D	CENTRAL VALLEY WYE	SR 152 (NORTH) TO ROAD 11 WYE	ALTERNATIVE	TYPICAL SECTIONS (SJD-FRE)	SR 59 / SR 152 INTERCHANGE - 3 OF	4	
T-K1102-D	CENTRAL VALLEY WYE	SR 152 (NORTH) TO ROAD 11 WYE	ALTERNATIVE	GENERAL PLAN (SJD-FRE)	SR 59 / SR 152 INTERCHANGE - 4 OF	4	
T-K1110-D	CENTRAL VALLEY WYE	SR 152 (NORTH) TO ROAD 11 WYE	ALTERNATIVE	GENERAL PLAN (SJD-FRE) LINCOLN ROAD (ROAD 4) OVERHEAD			
Γ-K1160-D	CENTRAL VALLEY WYE	SR 152 (NORTH) TO ROAD 11 WYE	ALTERNATIVE	GENERAL PLAN (SJD-FRE)			
T-K1161-D	CENTRAL VALLEY WYE	SR 152 (NORTH) TO ROAD 11 WYE	ALTERNATIVE	GENERAL PLAN (SJD-FRE)	HEMLOCK ROAD (ROAD 9) INTERCHANGE - 1 OF 2		
T-K3161-D	CENTRAL VALLEY WYE	SR 152 (NORTH) TO ROAD 11 WYE		TYPICAL SECTIONS (SJD-FRE)		HEMLOCK ROAD (ROAD 9) INTERCHANGE - 2 OF 2	
T-K1170-D	CENTRAL VALLEY WYE	SR 152 (NORTH) TO ROAD 11 WYE		GENERAL PLAN (SJD-FRE)	ASH SLOUGH BRIDGE - 1 OF 2		
T-K3170-D	CENTRAL VALLEY WYE	SR 152 (NORTH) TO ROAD 11 WYE		TYPICAL SECTION (SJD-FRE)	ASH SLOUGH BRIDGE - 2 OF 2		
T-K1190-D	CENTRAL VALLEY WYE	SR 152 (NORTH) TO ROAD 11 WYE		GENERAL PLAN (SJD-FRE)	ELM ROAD (ROAD 12) UNDERPASS		
ST-K1195-D	CENTRAL VALLEY WYE	SR 152 (NORTH) TO ROAD 11 WYE		GENERAL PLAN (SJD-FRE)	SR 152 (ROAD 12) UNDERCROSSING		
		DESIGNED BY M. BRATT	RECORD SET		CALIFORNIA HIG	H-SPEED	
		DRAWN BY A. M.	15% DESIGN			O FRESNO	

BY CHK APP

DESCRIPTION

A. M.
CHECKED BY
K. CHARAN 15% DESIGN Submittal NOT FOR CONSTRUCTION IN CHARGE
C. LEMLEY DATE 08/12/2016

PARSONS



AIN PROJECT MERCED TO FRESNO SECTION

CENTRAL VALLEY WYE STRUCTURE, VIADUCT AND TUNNEL PLANS INDEX OF DRAWINGS SHEET 6 OF 8

HSR08-05
DRAWING NO. ST-B0007
NO SCALE
SHEET NO.

			INDEX OF DRAWINGS	
DRAWING NO.	SECTION	ALIGNMENT / PLAN SET	TITLE	DESCRIPTION
ST-K1210-D	CENTRAL VALLEY WYE	SR 152 (NORTH) TO ROAD 11 WYE ALTERNATIVE	GENERAL PLAN (SJD-FRE)	ROBERTSON BOULEVARD (SR 233) INTERCHANGE - 1 OF 2
ST-K3210-D	CENTRAL VALLEY WYE	SR 152 (NORTH) TO ROAD 11 WYE ALTERNATIVE	TYPICAL SECTIONS (SJD-FRE)	ROBERTSON BOULEVARD (SR 233) INTERCHANGE - 2 OF 2
ST-K1220-D	CENTRAL VALLEY WYE	SR 152 (NORTH) TO ROAD 11 WYE ALTERNATIVE	GENERAL PLAN (SJD-FRE)	BERENDA SLOUGH BRIDGE - 1 OF 2
ST-K3220-D	CENTRAL VALLEY WYE	SR 152 (NORTH) TO ROAD 11 WYE ALTERNATIVE	TYPICAL SECTION (SJD-FRE)	BERENDA SLOUGH BRIDGE - 2 OF 2
ST-K1230-D	CENTRAL VALLEY WYE	SR 152 (NORTH) TO ROAD 11 WYE ALTERNATIVE	GENERAL PLAN (SJD-FRE)	BERENDA WAY (ROAD 16) UNDERPASS
ST-K1235-D	CENTRAL VALLEY WYE	SR 152 (NORTH) TO ROAD 11 WYE ALTERNATIVE	GENERAL PLAN (SJD-FRE)	BERENDA WAY (ROAD 16) INTERCHANGE - 1 OF 2
ST-K3235-D	CENTRAL VALLEY WYE	SR 152 (NORTH) TO ROAD 11 WYE ALTERNATIVE	TYPICAL SECTION (SJD-FRE)	BERENDA WAY (ROAD 16) INTERCHANGE - 2 OF 2
ST-K1240-D	CENTRAL VALLEY WYE	SR 152 (NORTH) TO ROAD 11 WYE ALTERNATIVE	GENERAL PLAN (SJD-FRE)	ROAD 17 1/2 OVERHEAD
ST-K1250-D	CENTRAL VALLEY WYE	SR 152 (NORTH) TO ROAD 11 WYE ALTERNATIVE	GENERAL PLAN (SJD-FRE)	AERIAL #2 - SR 99 / UPRR - 1 OF 3
ST-K1251-D	CENTRAL VALLEY WYE	SR 152 (NORTH) TO ROAD 11 WYE ALTERNATIVE	GENERAL PLAN (SJD-FRE)	AERIAL #2 - SR 99 / UPRR - 2 OF 3
ST-K3250-D	CENTRAL VALLEY WYE	SR 152 (NORTH) TO ROAD 11 WYE ALTERNATIVE	TYPICAL SECTIONS (SJD-FRE)	AERIAL #2 - SR 99 / UPRR - 3 OF 3
ST-K1260-D	CENTRAL VALLEY WYE	SR 152 (NORTH) TO ROAD 11 WYE ALTERNATIVE	GENERAL PLAN (SJD-FRE)	ROAD 20 OVERHEAD
ST-K1280-D	CENTRAL VALLEY WYE	SR 152 (NORTH) TO ROAD 11 WYE ALTERNATIVE	GENERAL PLAN (SJD-FRE)	ROAD 22 OVERHEAD
ST-K1300-D	CENTRAL VALLEY WYE	SR 152 (NORTH) TO ROAD 11 WYE ALTERNATIVE	GENERAL PLAN (SJD-FRE)	BERENDA CREEK BRIDGE
ST-K1310-D	CENTRAL VALLEY WYE	SR 152 (NORTH) TO ROAD 11 WYE ALTERNATIVE	GENERAL PLAN (SJD-FRE)	AVENUE 20 1/2 OVERHEAD
ST-K1330-D	CENTRAL VALLEY WYE	SR 152 (NORTH) TO ROAD 11 WYE ALTERNATIVE	GENERAL PLAN (SJD-FRE)	DRY CREEK BRIDGE
ST-K1410-D	CENTRAL VALLEY WYE	SR 152 (NORTH) TO ROAD 11 WYE ALTERNATIVE	GENERAL PLAN (MER-FRE)	AERIAL #3 - SOUTHBOUND OVER HST MAINLINE - 1 OF 6
ST-K1411-D	CENTRAL VALLEY WYE	SR 152 (NORTH) TO ROAD 11 WYE ALTERNATIVE	GENERAL PLAN (MER-FRE)	AERIAL #3 - SOUTHBOUND OVER HST MAINLINE - 2 OF 6
ST-K1412-D	CENTRAL VALLEY WYE	SR 152 (NORTH) TO ROAD 11 WYE ALTERNATIVE	GENERAL PLAN (MER-FRE)	AERIAL #3 - SOUTHBOUND OVER HST MAINLINE - 3 OF 6
ST-K3410-D	CENTRAL VALLEY WYE	SR 152 (NORTH) TO ROAD 11 WYE ALTERNATIVE	TYPICAL SECTION (MER-FRE)	AERIAL #3 - SOUTHBOUND OVER HST MAINLINE - 4 OF 6
ST-K3411-D	CENTRAL VALLEY WYE	SR 152 (NORTH) TO ROAD 11 WYE ALTERNATIVE	TYPICAL SECTION (MER-FRE)	AERIAL #3 - SOUTHBOUND OVER HST MAINLINE - 5 OF 6
ST-K3412-D	CENTRAL VALLEY WYE	SR 152 (NORTH) TO ROAD 11 WYE ALTERNATIVE	TYPICAL SECTIONS (MER-FRE)	AERIAL #3 - SOUTHBOUND OVER HST MAINLINE - 6 OF 6
ST-K1430-D	CENTRAL VALLEY WYE	SR 152 (NORTH) TO ROAD 11 WYE ALTERNATIVE	GENERAL PLAN (MER-FRE)	ROAD 12 UNDERPASS
ST-K1435-D	CENTRAL VALLEY WYE	SR 152 (NORTH) TO ROAD 11 WYE ALTERNATIVE	GENERAL PLAN (MER-FRE)	MADISON ROAD (AVENUE 23 1/2) UNDERPASS
ST-K1440-D	CENTRAL VALLEY WYE	SR 152 (NORTH) TO ROAD 11 WYE ALTERNATIVE	GENERAL PLAN (MER-FRE)	ASH SLOUGH BRIDGE - 1 OF 2
ST-K3440-D	CENTRAL VALLEY WYE	SR 152 (NORTH) TO ROAD 11 WYE ALTERNATIVE	TYPICAL SECTION (MER-FRE)	ASH SLOUGH BRIDGE - 2 OF 2
ST-K1450-D	CENTRAL VALLEY WYE	SR 152 (NORTH) TO ROAD 11 WYE ALTERNATIVE	GENERAL PLAN (MER-FRE)	WASHINGTON ROAD (AVENUE 25) UNDERPASS - 1 OF 2
ST-K3450-D	CENTRAL VALLEY WYE	SR 152 (NORTH) TO ROAD 11 WYE ALTERNATIVE	TYPICAL SECTION (MER-FRE)	WASHINGTON ROAD (AVENUE 25) UNDERPASS - 2 OF 2
ST-K1455-D	CENTRAL VALLEY WYE	SR 152 (NORTH) TO ROAD 11 WYE ALTERNATIVE	GENERAL PLAN (MER-FRE)	CHOWCHILLA RIVER BRIDGE
ST-K1460-D	CENTRAL VALLEY WYE	SR 152 (NORTH) TO ROAD 11 WYE ALTERNATIVE	GENERAL PLAN (MER-FRE)	AVENUE 26 UNDERPASS
ST-K1490-D	CENTRAL VALLEY WYE	SR 152 (NORTH) TO ROAD 11 WYE ALTERNATIVE	GENERAL PLAN (MER-FRE)	DUTCHMAN CREEK BRIDGE
ST-K1495-D	CENTRAL VALLEY WYE	SR 152 (NORTH) TO ROAD 11 WYE ALTERNATIVE	GENERAL PLAN (MER-FRE)	SANDY MUSH ROAD UNDERPASS
ST-K1510-D	CENTRAL VALLEY WYE	SR 152 (NORTH) TO ROAD 11 WYE ALTERNATIVE	GENERAL PLAN (MER-FRE)	DEADMAN CREEK BRIDGE No. 1
ST-K1515-D	CENTRAL VALLEY WYE	SR 152 (NORTH) TO ROAD 11 WYE ALTERNATIVE	GENERAL PLAN (MER-FRE)	DEADMAN CREEK BRIDGE No. 2
ST-K1610-D	CENTRAL VALLEY WYE	SR 152 (NORTH) TO ROAD 11 WYE ALTERNATIVE	GENERAL PLAN (SJD-MER)	AERIAL #4 - NORTHBOUND OVER HST MAINLINE - 1 OF 5
ST-K1611-D	CENTRAL VALLEY WYE	SR 152 (NORTH) TO ROAD 11 WYE ALTERNATIVE	GENERAL PLAN (SJD-MER)	AERIAL #4 - NORTHBOUND OVER HST MAINLINE - 2 OF 5
ST-K1612-D	CENTRAL VALLEY WYE	SR 152 (NORTH) TO ROAD 11 WYE ALTERNATIVE	GENERAL PLAN (SJD-MER)	AERIAL #4 - NORTHBOUND OVER HST MAINLINE - 3 OF 5
ST-K3610-D	CENTRAL VALLEY WYE	SR 152 (NORTH) TO ROAD 11 WYE ALTERNATIVE	TYPICAL SECTIONS (SJD-MER)	AERIAL #4 - NORTHBOUND OVER HST MAINLINE - 4 OF 5
ST-K3611-D	CENTRAL VALLEY WYE	SR 152 (NORTH) TO ROAD 11 WYE ALTERNATIVE	TYPICAL SECTIONS (SJD-MER)	AERIAL #4 - NORTHBOUND OVER HST MAINLINE - 5 OF 5
ST-K1620-D	CENTRAL VALLEY WYE	SR 152 (NORTH) TO ROAD 11 WYE ALTERNATIVE	GENERAL PLAN (SJD-FRE)	HEMLOCK ROAD (ROAD 9) UNDERPASS
ST-K1630-D	CENTRAL VALLEY WYE	SR 152 (NORTH) TO ROAD 11 WYE ALTERNATIVE	GENERAL PLAN (SJD-MER)	MADISON ROAD (AVENUE 23 1/2) OVERHEAD

M. BRATT DRAWN BY
A. M. CHECKED BY
K. CHARAN IN CHARGE
C. LEMLEY DATE 08/12/2016 BY CHK APP DESCRIPTION

RECORD SET 15% DESIGN SUBMITTAL NOT FOR

CONSTRUCTION





CALIFORNIA HIGH-SPEED TRAIN PROJECT MERCED TO FRESNO SECTION

CENTRAL VALLEY WYE STRUCTURE, VIADUCT AND TUNNEL PLANS INDEX OF DRAWINGS SHEET 7 OF 8

HSRO8-05
DRAWING NO. ST-B0008
SCALE NO SCALE

NO SCALE SHEET NO.

			INDEX OF DRAWINGS	
DRAWING NO.	SECTION	ALIGNMENT / PLAN SET	TITLE	DESCRIPTION
ST-K1641-D	CENTRAL VALLEY WYE	SR 152 (NORTH) TO ROAD 11 WYE ALTERNATIVE	GENERAL PLAN (SJD-MER)	AERIAL #5 - NORTHBOUND OVER HST MERCED TO FRESNO - 2 OF 6
ST-K1642-D	CENTRAL VALLEY WYE	SR 152 (NORTH) TO ROAD 11 WYE ALTERNATIVE	GENERAL PLAN (SJD-MER)	AERIAL #5 - NORTHBOUND OVER HST MERCED TO FRESNO - 3 OF 6
ST-K1643-D	CENTRAL VALLEY WYE	SR 152 (NORTH) TO ROAD 11 WYE ALTERNATIVE	GENERAL PLAN (SJD-MER)	AERIAL #5 - NORTHBOUND OVER HST MERCED TO FRESNO - 4 OF 6
ST-K3640-D	CENTRAL VALLEY WYE	SR 152 (NORTH) TO ROAD 11 WYE ALTERNATIVE	TYPICAL SECTIONS (SJD-MER)	AERIAL #5 - NORTHBOUND OVER HST MERCED TO FRESNO - 5 OF 6
ST-K3641-D	CENTRAL VALLEY WYE	SR 152 (NORTH) TO ROAD 11 WYE ALTERNATIVE	TYPICAL SECTIONS (SJD-MER)	AERIAL #5 - NORTHBOUND OVER HST MERCED TO FRESNO - 6 OF 6
ST-K1650-D	CENTRAL VALLEY WYE	SR 152 (NORTH) TO ROAD 11 WYE ALTERNATIVE	GENERAL PLAN (SJD-MER)	ROAD 11 UNDERPASS
ST-K1653-D	CENTRAL VALLEY WYE	SR 152 (NORTH) TO ROAD 11 WYE ALTERNATIVE	GENERAL PLAN (SJD-MER)	WASHINGTON ROAD (AVENUE 25) UNDERPASS
ST-K1656-D	CENTRAL VALLEY WYE	SR 152 (NORTH) TO ROAD 11 WYE ALTERNATIVE	GENERAL PLAN (SJD-MER)	CHOWCHILLA RIVER BRIDGE

MF-ST-BOOO9

16-AUG-201610:

1								
0							DESIGNED BY M. BRATT	
							DRAWN BY A. M.	
_							CHECKED BY K. CHARAN	
1 236							IN CHARGE C. LEMLEY	
دالالا	REV	DATE	BY	СНК	APP	DESCRIPTION	DATE 08 /12 /2016	

RECORD SET 15% DESIGN SUBMITTAL NOT FOR

CONSTRUCTION





CALIFORNIA HIGH-SPEED TRAIN PROJECT MERCED TO FRESNO SECTION

CENTRAL VALLEY WYE
STRUCTURE, VIADUCT AND TUNNEL PLANS
INDEX OF DRAWINGS
SHEET 8 OF 8

HSR08-05
DRAWING NO. ST-B0009
NO SCALE
SHEET NO.

	(A)				(D CONTINUED)		(F CONTINUED)		(J CONTINUED)
				25.7		5.1.75			
AB	AGGREGATE BASE	CAA	CABLE ANCHOR ASSEMBLY	DET	DETAIL, DETOUR	FNTB	FACING NORTHBOUND TRAFFIC	JS	JUNCTION STRUCTURE
ABBC	ASBESTOS BONDED BITUMINOUS COATED	CAP	CORRUGATED ALUMINUM PIPE	DF	DOUGLAS FIR, DIRECT FIXATION	FOB	FREE ON BOARD	JT	JOINT
ABM	AIR-BLOWN MORTAR	CAPA	CORRUGATED ALUMINUM PIPE ARCH	DI	DRAINAGE INLET, DROP INLET	FOC	FACE OF CONCRETE		
ABN	ABANDON	CAS	CONSTRUCTION AREA SIGN	DIA	DIAMETER	FR RD	FRONTAGE ROAD		L
ABUT	ABUTMENT	CB	CONCRETE BARRIER	DIAPH	DIAPHRAGM	FRE	FRESNO	L	LENGTH
AC	ASPHALT CONCRETE	CBW	CONCRETE BLOCK WALL	DIST	DISTANCE, DISTRICT	FS	FAR SIDE, FINISHED SURFACE	LAT	LATITUDE
ACB	ASPHALT CONCRETE BASE	C-C	CENTER TO CENTER	DMBB	DOUBLE METAL BEAM BARRIER	FSBT	FACING SOUTHBOUND TRAFFIC	LCB	LEAN CONCRETE BASE LAST LONG TIE
ACP	ASBESTOS CEMENT PIPE ADDED DEAD LOAD	CHSRA	CALIFORNIA HIGH-SPEED RAIL	DR DTBB	DRIVE DOUBLE THRIE BEAM BARRIER	FTG FWBT	FOOTING FACING WESTBOUND TRAFFIC	LLT	LAST LONG TIE LANE
ADL ADJ	ADJUST	CHSR	AUTHORITY (SEE AUTHORITY) CALIFORNIA HIGH-SPEED RAIL	DWY	DRIVEWAY	FWY	FREEWAY	LN LOC	LOCATION
AFES	ALTERNATIVE FLARED END SECTION	CHST	CALIFORNIA HIGH-SPEED TRAIN	DWI	DRIVEWAT	L AA I		LOL	LAYOUT LINE
AHD	AHEAD	CG	CENTER OF GRAVITY		(E)		G	LONG	LONGITUDE
ALT	ALTERNATE	CHNL	CHANNEL	F	EAST	G	GRADE, ACCELERATION DUE TO	LONGIT	LONGITUDINAL
AM	TIME FROM MIDNIGHT TO NOON	CI	CAST IRON	EA	ACTUAL SUPERELEVATION	O	GRAVITY	LS	LUMP SUM, LENGTH OF SPIRAL
AP	ALTERNATIVE PIPE	CIDH	CAST-IN-DRILLED-HOLE	EASE	EASEMENT	GA	GAGE	LT	LEFT
APC	ALTERNATIVE PIPE CULVERT	CIP	CAST-IN-PLACE, CAST IRON PIPE	EB	END OF BRIDGE, EASTBOUND	GALV	GALVANIZED	LVC	LENGTH OF VERTICAL CURVE
APPROX	APPROXIMATE	CIPCP	CAST-IN-PLACE CONCRETE PIPE	EC	END HORIZONTAL CURVE	GP	GRADING PLANE	2.0	
APU	ALTERNATIVE PIPE UNDERDRAIN	CISS	CAST-IN-STEEL SHELL	ECR	END CURB RETURN	GR	GUARD RAILING		(M $)$
AR	ACCESS RESTRICTION	CJP	COMPLETE JOINT PENETRATION	ED	EDGE DRAIN	GRDR	GIRDER	MAINT	MAINTENANCE
ARS	ACCELERATION RESPONSE SPECTRUM	CL	CHAIN LINK, CLASS	EDC	EDGE DRAIN CLEANOUT	GSP	GALVANIZED STEEL PIPE	MAX	MAXIMUM
AS	AGGREGATE SUBBASE	CL-6	CHAIN LINK FENCE (6 FT)	EDO	EDGE DRAIN OUTLET	GTR	GUTTER	MB	METAL BEAM
ASRP	ALUMINUM SPIRAL RIB PIPE	CLR	CLEAR, CLEARANCE	EDV	EDGE DRAIN VENT			MBB	METAL BEAM BARRIER
ASSY	ASSEMBLY	СМ	CORRUGATED METAL	ELEC	ELECTROLIER		(H)	MBGR	METAL BEAM GUARD RAILING
ATC	AUTOMATIC TRAIN CONTROL	CMP	CORRUGATED METAL PIPE	ELECT	ELECTRIC	Н	HEIGHT	MED	MEDIAN
ATPB	ASPHALT TREATED PERMEABLE BASE	СО	COUNTY	ELEV	ELEVATION	H, HR	HOUR	MER	MERCED
ATPM	ASPHALT TREATED PERMEABLE MATERIAL	COL	COLUMN	EMB	EMBANKMENT	HD	HORIZONTAL DRAIN	MF	MERCED TO FRESNO
AUTHORITY	CALIFORNIA HIGH-SPEED RAIL AUTHORITY	CONC	CONCRETE	ENGR	ENGINEER	HDWL	HEADWALL	МН	MANHOLE
AVE	AVENUE	COND	CONDUIT	EOD	EDGE OF DECK	HEX HD	HEXAGONAL HEAD	MIN	MINIMUM
AVG	AVERAGE	CONN	CONNECTOR	EP	EDGE OF PAVEMENT	НМА	HOT MIXED ASPHALT	MISC	MISCELLANEOUS
@	AT	CONST	CONSTRUCT, CONSTRUCTION	EQ	EQUATION	HORIZ	HORIZONTAL	MISC I & S	S MISCELLANEOUS IRON AND STEEL
	В	CONT	CONTINUOUS	ES	EDGE OF SHOULDER	HP	HINGE POINT, HORSEPOWER	MKR	MARKER
		COORD	COORDINATE	ET	END TUNNEL	HPS	HIGH PERFORMANCE STEEL	MOD	MODIFIED, MODIFY
BAGR	BRIDGE APPROACH GUARD RAILING	CP	CANDLEPOWER	ETW	EDGE OF TRAVELED WAY	HS	HIGH STRENGTH	MON	MONUMENT
BB	BEGINNING OF BRIDGE	CP1	CONSTRUCTION PACKAGE 1	EU	UNBALANCED SUPERELEVATION	HSR	HIGH-SPEED RAIL	MOW	MAINTENANCE-OF-WAY FACILITY
В-В	BACK-TO-BACK	CR	CREEK	EVC	END VERTICAL CURVE	HST	HIGH-SPEED TRAIN	MP	METAL PLATE
BC	BEGIN HORIZONTAL CURVE	CRCP	CONTINUOUS REINFORCED CONCRETE PAVEMENT	EW	ENDWALL	HW	HEADWALL,	MPGR	METAL PLATE GUARD RAILING
BCR	BEGIN CURB RETURN	CRSP	CONCRETED ROCK SLOPE PROTECTION	EXC	EXCAVATION		100-YR HIGH WATER (UNLESS NOTED	MPH	MILES PER HOUR
BEG	BEGIN	CRZ	CLEAR RECOVERY ZONE	EXIST, (E)	EXISTING		OTHERWISE)	MR	MOVEMENT RATING
BIT CTD	BITUMINOUS COATED	CS	CURVE SPIRAL POINT	EXP	EXPANSION, EXPRESSWAY	HWM	HIGH WATER MARK	MSE	MECHANICALLY STABILIZED EARTH
BK	BACK	CSP	CORRUGATED STEEL PIPE	EXP JT	EXPANSION JOINT	HWY	HIGHWAY	MTL	MATERIAL
BKF	BACKFILL	CSPA	CORRUGATED STEEL PIPE ARCH	EXT	EXTERIOR				N
BLDG	BUILDING	CTB	CEMENT TREATED BASE		(F)	10	I I I I I I I I I I I I I I I I I I I	N	
BLM	BRIDGE-LOG MILE	СТРВ	CEMENT TREATED PERMEABLE BASE	F 2 2		IB	IMPORTED BORROW	N	NORTH
BLVD	BOULEVARD	СТРМ	CEMENT TREATED PERMEABLE MATERIAL	F & C	FRAME AND COVER	ID	INSIDE DIAMETER	NB	NORTHBOUND
BM BOT	BENCH MARK	CTRS	CENTERS	F & G	FRAME AND GRATE	IF	INSIDE FACE	NC	NORMAL CROWN
BOT	BOTTOM	CULV	CULVERT	FB	FLOOR BEAM	INT	INTERIOR	NIC	NOT IN CONTRACT
BNSF	BNSF RAILWAY	<u>C</u>	CENTERLINE	FDN	FOUNDATION	INV	INVERT	NO.	NUMBER (MUST HAVE PERIOD)
BR BRG	BRIDGE			FEBT	FACING EASTBOUND TRAFFIC	IRR	IRRIGATION	NOS.	NUMBERS (MUST HAVE PERIOD)
BRG BT	BEARING BEGIN TUNNEL	D	DEPTH	FES FF	FLARED END SECTION FILTER FABRIC	IS	INTERLOCKING SITE	NPS NS	NOMINAL PIPE SIZE NEAR SIDE
Θ BTU	BRITISH THERMAL UNIT	DD	DOWNDRAIN	F G	FINISHED GRADE		J	NTS	NOT TO SCALE
BVC	BEGIN VERTICAL CURVE	DBL	DOUBLE	FH	FIRE HYDRANT	JCT	JUNCTION	INIJ	
BM BAC	BARBED WIRE	DEG	DEGREE	FIG	FIGURE	JP	JOINT POLE		
10-2	SANDED WINE	DEL	DELINEATOR	FL	FLOW LINE	JPCP	JOINT FOLE JOINTED PLAIN CONCRETE PAVEMENT	OBI R	OBLITERATE
DP - 2		ULL	DESIGNED BY	, L	Ton Live	01 01			CONTRACT NO
1	+ + -		C. LEMLEY RECORD SET				CALIFORNIA HIGH-SPI		IN PROJECT HSR08-05
	+ + +		DRAWN BY J. KIDWELL SUBMITTAL				MERCED TO FRI		DRAWING NO. ST-B0010
	+ + +		HA. M. HAI	RSONS			CENTRAL VA STRUCTURE, VIADUCT		
133	+ + +		IN CHARGE C. LEMLEY CONSTRUCTION		CALIFOR		ABBREVI		NO SCALE
CO REV DATE BY	Y CHK APP DESCRIPTION		DATE 08/12/2016		HIGH-SPEED RAIL AU	THORITY	SHEET 1		SHEET NO.
<u> </u>			00/12/2010						

1330			J. KIDWELL SURMITTAL	PARSO	CALIFORN	VA	CENTRAL VALLEY WYE STRUCTURE, VIADUCT AND TUNNEL PLANS ABBREVIATIONS
Q Q			DESIGNED BY C. LEMLEY DRAWN BY 15% DESIGN				CALIFORNIA HIGH-SPEED TRAIN PROJECTION
76-2011	POINT OF VERTICAL CURVE						
PVC	POLYVINYL CHLORIDE,	SJD	SAN JOSE DIRIDON STATION				
<u> </u>	POINT OF TANGENCY	SIM	SIMILAR	TRK	TRACK		
PSP	PARALLELING STATION PERFORATED STEEL PIPE	SHLD SHT	SHEET	TRANS	TRANSITION		
PS, P/S	POINT OF SWITCH, PRESTRESSED,	SG	SUBGRADE SHOULDER	TPSS T/R	TRACTION POWER SUBSTATION TOP OF RAIL		
PS&E	PLANS, SPECIFICATIONS AND ESTIMATES	SEP	SEPARATION	TPM	TREATED PERMEABLE MATERIAL		
PRVC	POINT OF REVERSE VERTICAL CURVE	SEC	SECOND, SECTION	TPF	TRACTION POWER FACILITY		
PRF	PAVEMENT REINFORCING FABRIC	SD	STORM DRAIN	TPB	TREATED PERMEABLE BASE		
5 PRC	POINT OF REVERSE CURVE	SCSP	SLOTTED CORRUGATED STEEL PIPE	TP	TELEPHONE POLE		
PPP	PERFORATED PLASTIC PIPE	SC	SAND CUSHION, SPIRAL CURVE POINT	TOT	TOTAL		
PPL	PREFORMED PERMEABLE LINER	SB	SOUTHBOUND	ТО	TURNOUT	YRS	YEARS
	POWER POLE	SAPP	STRUCTURAL ALUMINUM PLATE PIPE	ТМ	TECHNICAL MEMORANDUM	YR	YEAR
PP	PIPE PILE, PLASTIC PIPE,	SALV	SALVAGE	TG	TOP OF GRADE		
POVC	POINT OF VERTICAL CURVE	SAE	STRUCTURE APPROACH EMBANKMENT	TEMP	TEMPORARY		Y
POT	POINT OF TANGENT	S	SOUTH, SUPPLEMENT	TEL	TELEPHONE	XO	CROSSOVER
POE	POINT OF END		(<u> </u>	TCE	TEMPORARY CONSTRUCTION EASEMENT	XING	CROSSING
POC	POINT OF HORIZONTAL CURVE		C	TCB	TRAFFIC CONTROL BOX	X SEC	CROSS SECTION
РОВ	POINT OF BEGINNING	RWY	RAILWAY	TC	TOP OF CURB, TRAIN CONTROL		(X)
PN	PAVING NOTCH	R/W	RIGHT-OF-WAY	TBR	TIMBER		
	TIME FROM NOON TO MIDNIGHT	• • •	RETAINING WALL	TBD	TO BE DETERMINED	WWLOL	WINGWALL LAYOUT LINE
PM	POST MILE,	RW	REDWOOD,	ТВВ	THRIE BEAM BARRIER	ww	WINGWALL
P/L	PROPERTY LINE	RTE	ROUTE	TAN	TANGENT	WV	WATER VALVE
P, PL	PLATE	RT	RIGHT	TAB	TABLET	WT	WEIGHT
PJP	PARTIAL JOINT PENETRATION	RSP	ROCK SLOPE PROTECTION	Т	SEMI-TANGENT	WSP	WELDED STEEL PIPE
PITO	POINT OF INTERSECTION TURNOUT	RR	RAILROAD		(T)	WS	WATER SURFACE
PI	POINT OF INTERSECTION		REFERENCE POINT	5 15		WM	WIRE MESH
PG&E	PACIFIC GAS AND ELECTRIC	RP	RADIUS POINT,	S4S	SURFACE 4 SIDES	WH	WEEP HOLE
PG	PROFILE GRADE	RM	ROAD-MIXED	SYM	SYMMETRICAL	WCB	WORLD COORDINATE BEARING
PERM MTL	PERMEABLE MATERIAL	RDWY	ROADWAY	SWS	SWITCHING STATION	WB	WESTBOUND
PED UC	PEDESTRIAN UNDERCROSSING	REV	REVISED	SWR	SEWER	W	WEST, WIDTH
PED OC	PEDESTRIAN OVERCROSSING	RET	RETAINING	SW	SIDEWALK, SOUND WALL		(
PED	PEDESTRIAN	REPL	REPLACEMENT	SURF	SURFACING		
PCVC	POINT OF COMPOUND VERTICAL CURVE	REL	RELOCATE	STR	STRUCTURE	VOL	VOLUME
	PRESTRESSED CONCRETE PIPE		REINFORCING	STD	STANDARD	VIA	VIADUCT
PCP	PERFORATED CONCRETE PIPE,	REINF	REINFORCED, REINFORCEMENT,	STBB	SINGLE THRIE BEAM BARRIER	VERT	VERTICAL
	PORTLAND CEMENT CONCRETE	RD	ROAD	STA	STATION	VCP	VITRIFIED CLAY PIPE
PCC	POINT OF COMPOUND CURVE,	RCPA	REINFORCED CONCRETE PIPE ARCH	ST	STREET, SPIRAL TANGENT POINT	VC	VERTICAL CURVE
PC	POINT OF CURVATURE, PRECAST	RCP	REINFORCED CONCRETE PIPE	SSRP	STEEL SPIRAL RIB PIPE	VAR	VARIABLE
РВ	PULL BOX, PHASE BREAK	RCB	REINFORCED CONCRETE BOX	SSPPA	STRUCTURAL STEEL PLATE PIPE ARCH	V	DESIGN SPEED, VALVE
PAP	PERFORATED ALUMINUM PIPE	RCA	REINFORCED CONCRETE ARCH	SSPP	STRUCTURAL STEEL PLATE PIPE		(V
Р	PAGE	R/C	RATE OF CHANGE	SSPA	STRUCTURAL STEEL PLATE ARCH		V
	(P)	R & S	REMOVE AND SALVAGE	SSD	STRUCTURAL SECTION DRAIN	UXO	UNIVERSAL CROSSOVER
		R & D	REMOVE AND DISPOSE	SSBM	STRAP AND SADDLE BRACKET METHOD	UPRR	UNION PACIFIC RAILROAD
OPP	OPPOSITE	R	RADIUS	SS	SLOPE STAKE, SUBSTATION	UP	UNDERPASS
0-0	OUT TO OUT		R	SRS	STANDALONE RADIO SITE	UON	UNLESS OTHERWISE NOTED
ОН	OVERHEAD			SR	STATE ROUTE	UD	UNDERDRAIN
OGAC	OPEN GRADED ASPHALT CONCRETE	QTY	QUANTITY	SPP	SLOTTED PLASTIC PIPE	UC	UNDERCROSSING
OG	ORIGINAL GROUND		(Q	SPEC	SPECIAL, SPECIFICATIONS		
OF	OUTSIDE FACE			SM	SELECTED MATERIAL		
OD	OUTSIDE DIAMETER	PVT	POINT OF VERTICAL TANGENT	S	STATION LINE	TYP	TYPICAL
ocs	OVERHEAD CONTACT SYSTEM	PVMT	PAVEMENT	SJV	SAN JOAQUIN VALLEY	13	TUBULAR STEEL, TANGENT SPIRAL POINT
ос	OVERCROSSING	PVI	POINT OF VERTICAL INTERSECTION	SJM	SAN JOSE TO MERCED	TS	TRANSVERSE, TRAFFIC SIGNAL,
I	(O CONTINUED)		(P CONTINUED)		(S CONTINUED)		(T CONTINUED)

CONSTRUCTION

IN CHARGE
C. LEMLEY

DATE 08/12/2016

DESCRIPTION


REV DATE


BY CHK APP


CENTRAL VALLEY WYE
STRUCTURE, VIADUCT AND TUNNEL PLANS
ABBREVIATIONS SHEET 2 OF 2

CONTRACT NO. HSRO8-05 DRAWING NO. ST-B0011 SCALE NO SCALE

SHEET NO.

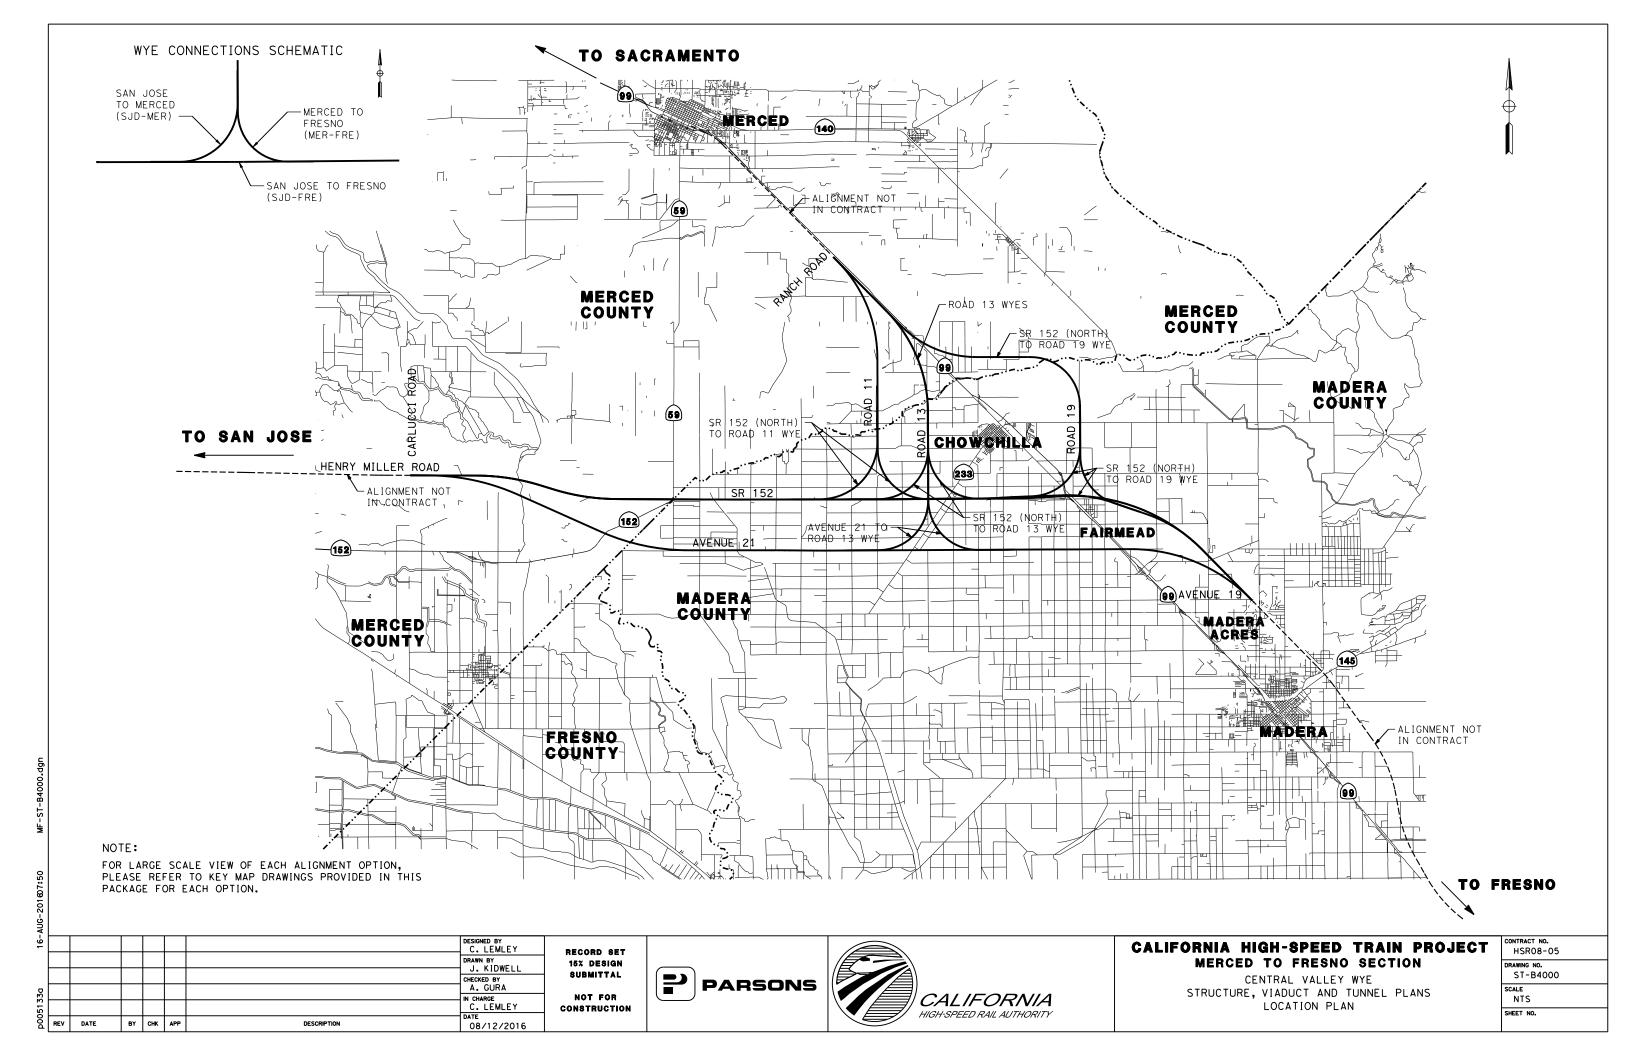

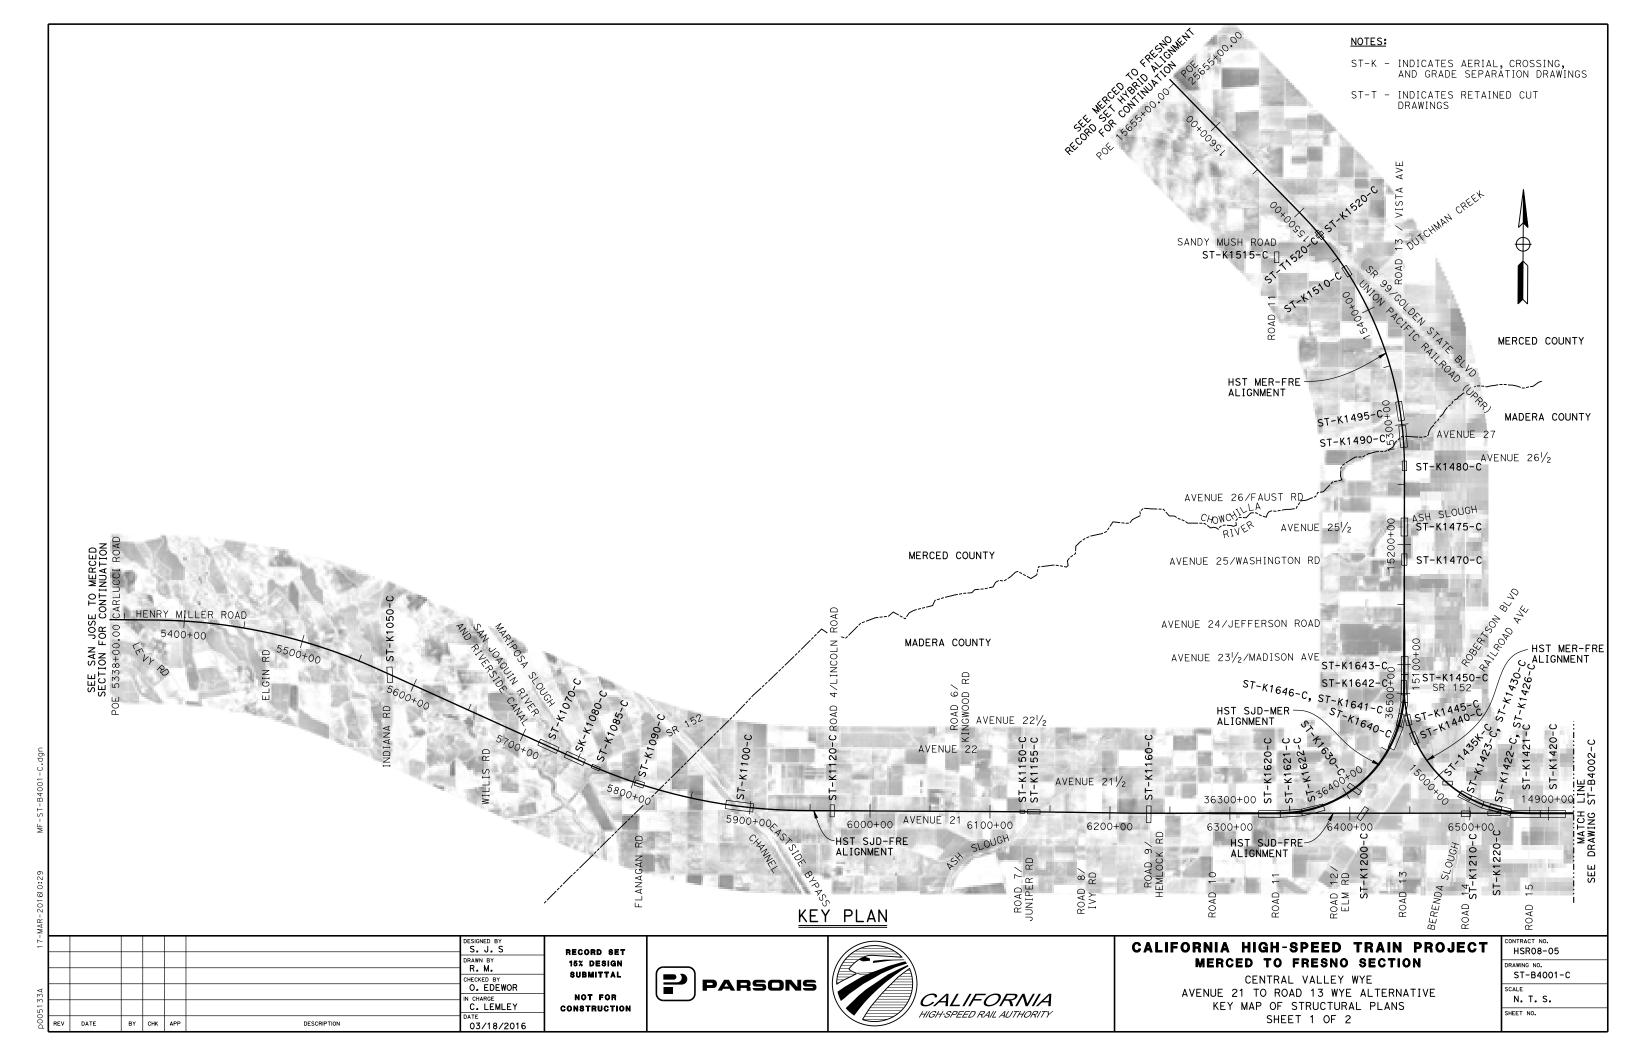

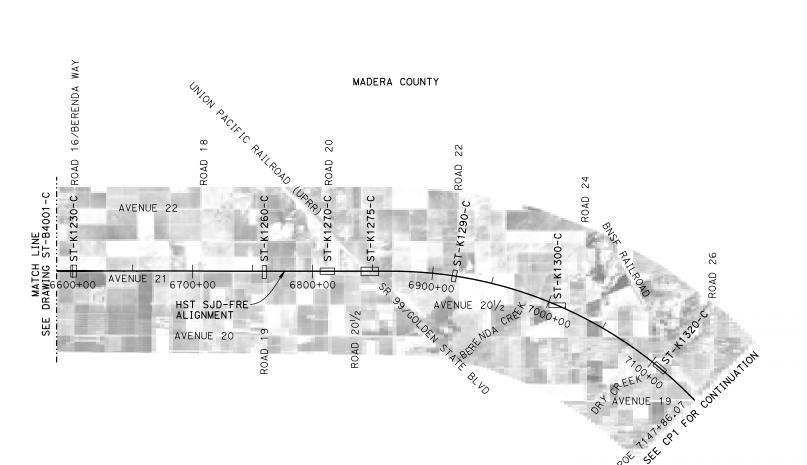

KEY PLAN

NOTES:

ST-K - INDICATES AERIAL, CROSSING, AND GRADE SEPARATION DRAWINGS

ΜA								
17-							DESIGNED BY	
							DRAWN BY	•
(0							CHECKED BY A. GURA	
42226							IN CHARGE C. LEMLEY	c
00d	REV	DATE	BY	снк	APP	DESCRIPTION	03/18/2016	

RECORD SET
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CONSTRUCTION








CALIFORNIA HIGH-SPEED TRAIN PROJECT MERCED TO FRESNO SECTION

CENTRAL VALLEY WYE
AVENUE 21 TO ROAD 13 WYE ALTERNATIVE
KEY MAP OF STRUCTURAL PLANS
SHEET 2 OF 2

HSR08-05	
DRAWING NO. ST-B4002-C	
SCALE N. T. S.	
SHEET NO.	

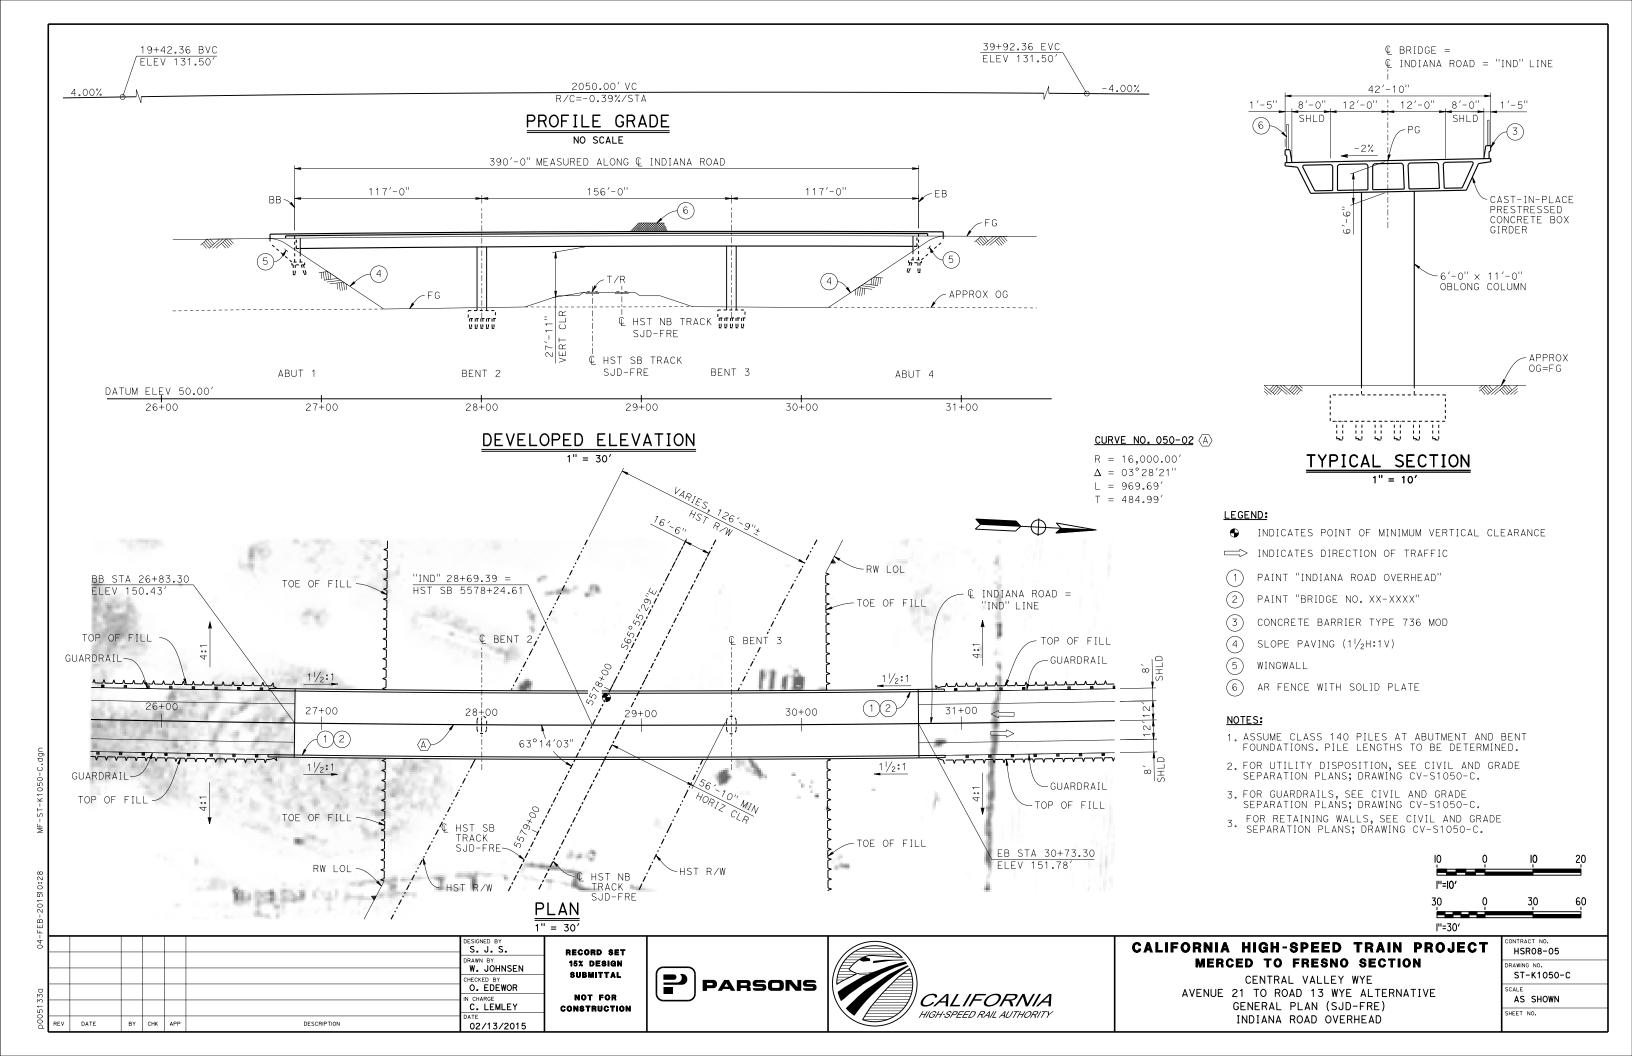

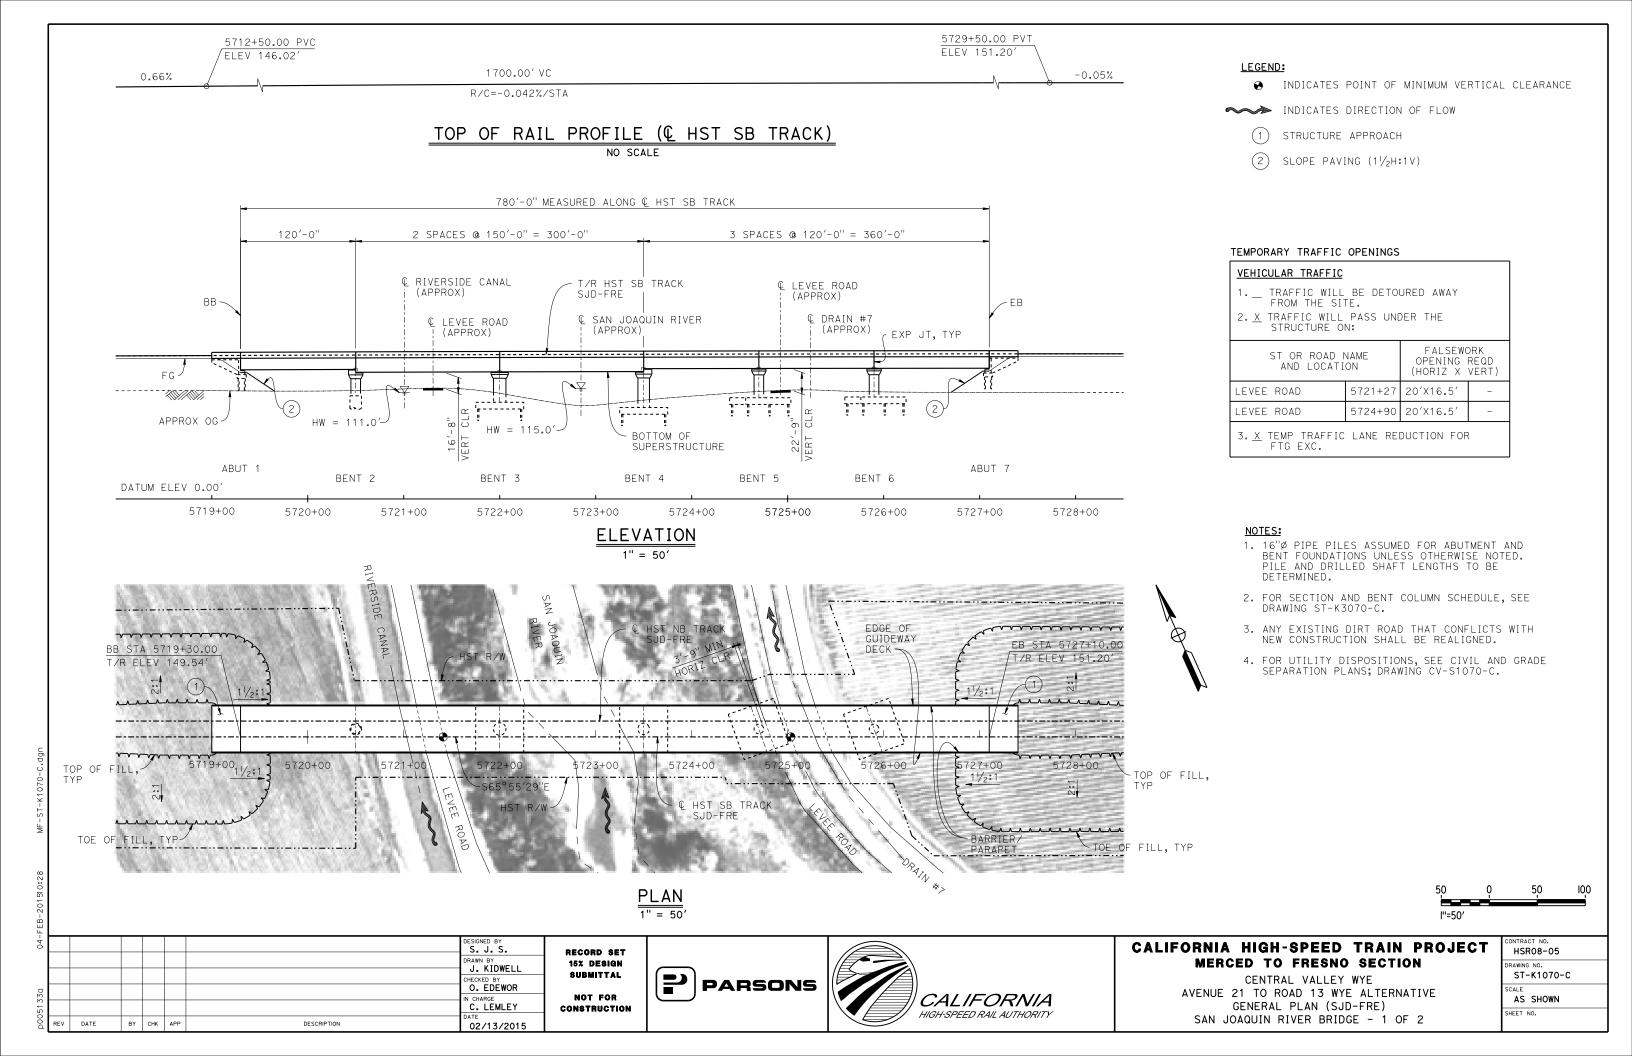

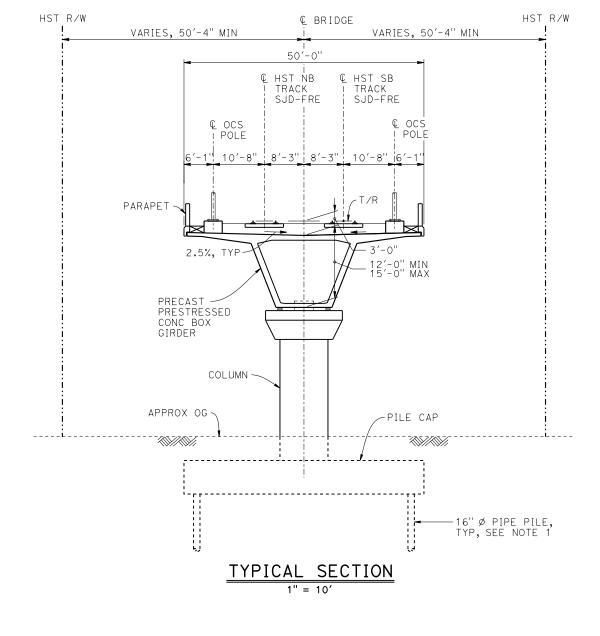

	BENT COLUMN SCHE	DULE
BENT	COLUMN TYPE	CIDH TYPE
2	10'-0"Ø	12′-0''ø
3	13'-0''ø	
4	12'-0"ø	
5 - 6	10'-0"Ø	

NOTES

1. PILE AND DRILLED SHAFT LENGTHS TO BE DETERMINED.



ij.								
-50							DESIGNED BY S. J. S.	
							DRAWN BY J. KIDWELL	
							CHECKED BY O. EDEWOR	
5133a							IN CHARGE C. LEMLEY	c
p0051	REV	DATE	BY	СНК	APP	DESCRIPTION	DATE 02/13/2015	

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CONSTRUCTION






CALIFORNIA HIGH-SPEED TRAIN PROJECT MERCED TO FRESNO SECTION


CENTRAL VALLEY WYE
AVENUE 21 TO ROAD 13 WYE ALTERNATIVE
TYPICAL SECTION (SJD-FRE)
SAN JOAQUIN RIVER BRIDGE - 2 OF 2

1	CONTRACT NO.
	HSR08-05
ı	DRAWING NO.
	ST-K3070-C
ı	SCALE
	AS SHOWN
	SHEET NO.

TOP OF RAIL PROFILE (& HST SB TRACK) NO SCALE

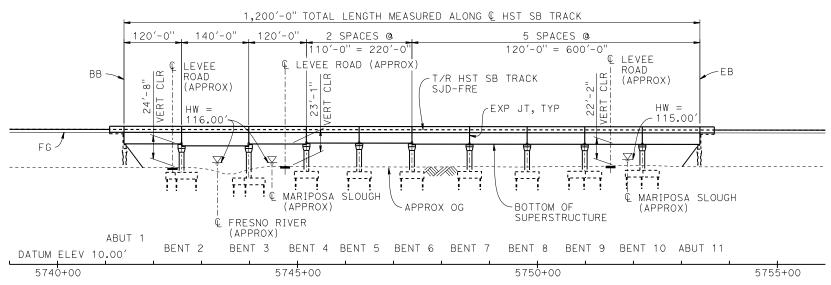

DEVELOPED ELEVATION

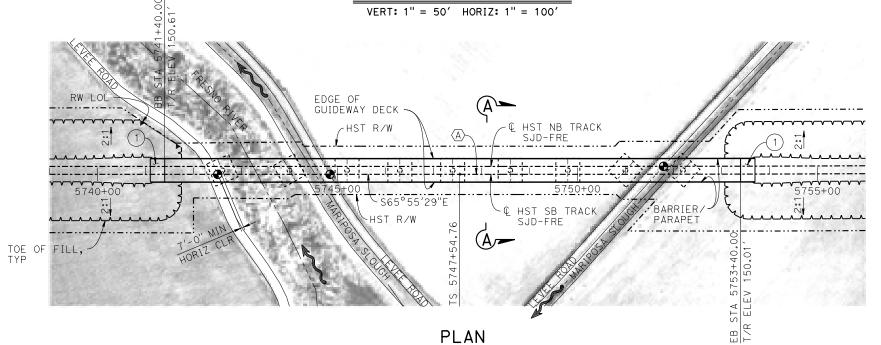

TEMPORARY TRAFFIC OPENINGS

VEHICULAR TRAFFIC

- 1. __ TRAFFIC WILL BE DETOURED AWAY FROM THE SITE.
- 2. X TRAFFIC WILL PASS UNDER THE STRUCTURE ON:

ST OR ROAD AND LOCAT	FALSEWO OPENING (HORIZ X	REQD	
LEVEE ROAD	5742+40	20'X16.5'	1
LEVEE ROAD	5744+72	20'X16.5'	-
LEVEE ROAD	5751+52	20′X16.5′	-

3. \underline{X} TEMP TRAFFIC LANE REDUCTION FOR FTG EXC.

NOTES:

- 1. 16"Ø PIPE PILES ASSUMED FOR ABUTMENT AND BENT FOUNDATIONS. PILE LENGTHS TO BE DETERMINED.
- 2. FOR SECTION, SEE DRAWING ST-K3080-C.
- 3. ANY EXISTING DIRT ROAD THAT CONFLICTS WITH NEW CONSTRUCTION SHALL BE REALIGNED.
- 4. FOR UTILITY DISPOSITIONS, SEE CIVIL AND GRADE SEPARATION PLANS; DRAWING CV-S1080-C.
- 5. FOR RETAINING WALLS, SEE CIVIL AND GRADE SEPARATION PLANS; DRAWING CV-S1080-C.

LEGEND:

INDICATES DIRECTION OF FLOW

- 1) STRUCTURE APPROACH
- (2) SLOPE PAVING (11/2H:1V)

CURVE SJD-FRE 2 SB (A)

R = 45,016.50'LS = 1,650.00'



DESIGNED BY
S. J. S.

DRAWN BY
J. KIDWELL
CHECKED BY
O. EDEWOR
IN CHARGE
C. LEMLEY
DATE
BY CHK APP
DESCRIPTION
DATE
02/13/2015

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CONSTRUCTION

1" = 100'





CALIFORNIA HIGH-SPEED TRAIN PROJECT MERCED TO FRESNO SECTION

CENTRAL VALLEY WYE

AVENUE 21 TO ROAD 13 WYE ALTERNATIVE


GENERAL PLAN (SJD-FRE)

AERIAL #1 - FRESNO RIVER AND MARIPOSA SLOUGH - 1 OF 2

DRAWING NO.
ST-K1080-C

AS SHOWN



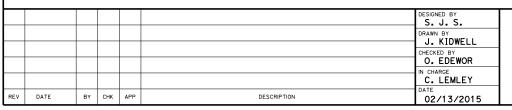

RECORD SET
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CONSTRUCTION

HST R/W

VARIES, 50'-4" MIN

PARAPET ~

PRECAST -PRESTRESSED CONC BOX GIRDER

APPROX OG

© OCS ! POLE

2.5%, TYP

10'-0" Ø COLUMN ⋅

10'-8"





HST R/W

€ BRIDGE

€ HST SB | TRACK | SJD-FRE

10'-8"

© HST NB I TRACK I SJD-FRE

SECTION A-A

VARIES, 50'-4" MIN

€ ocs ! Pole

-PILE CAP

-16" Ø PIPE PILE, TYP, SEE NOTE 1

NOTES:

- 1. PILE LENGTHS TO BE DETERMINED.
- 2. FOR TRACK SUPERELEVATION DETAILS, SEE ALIGNMENT AND TYPICAL SECTION PLANS; DRAWING TT-B0050-C.



CALIFORNIA HIGH-SPEED TRAIN PROJECT MERCED TO FRESNO SECTION


CENTRAL VALLEY WYE


AVENUE 21 TO ROAD 13 WYE ALTERNATIVE


TYPICAL SECTION (SJD-FRE)

AERIAL #1 - FRESNO RIVER AND MARIPOSA SLOUGH - 2 OF 2

,	HSR08-05
	DRAWING NO. ST-K3080-C
	SCALE AS SHOWN

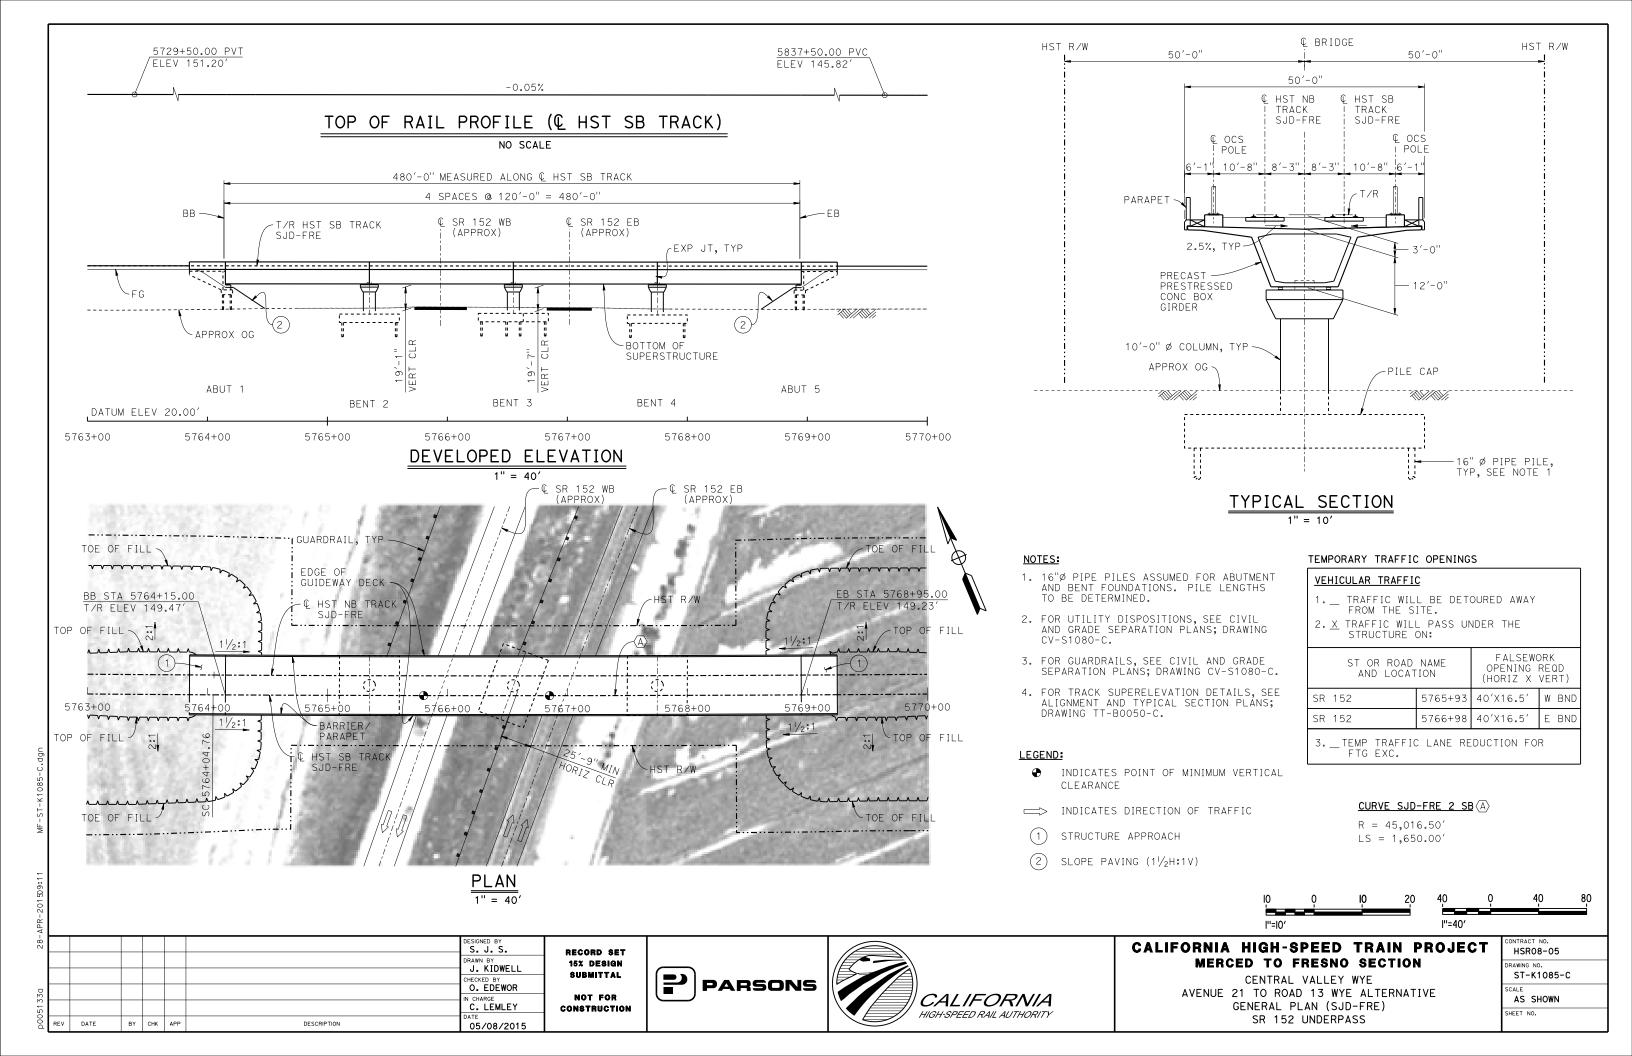

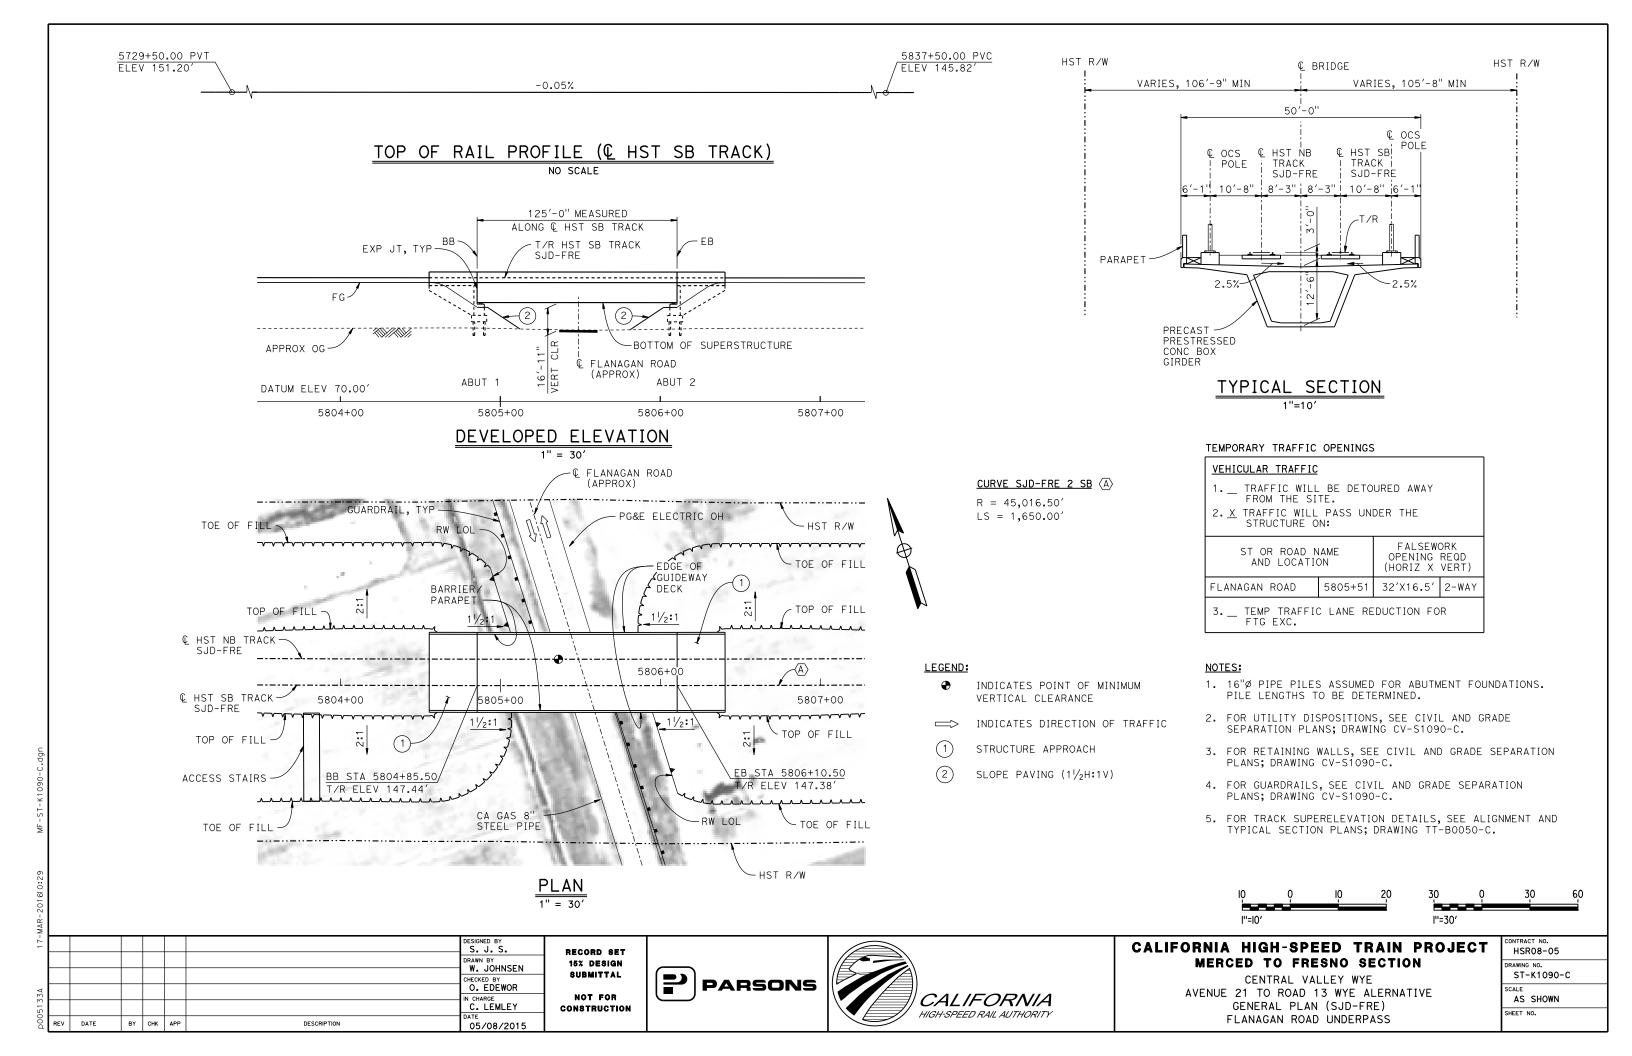

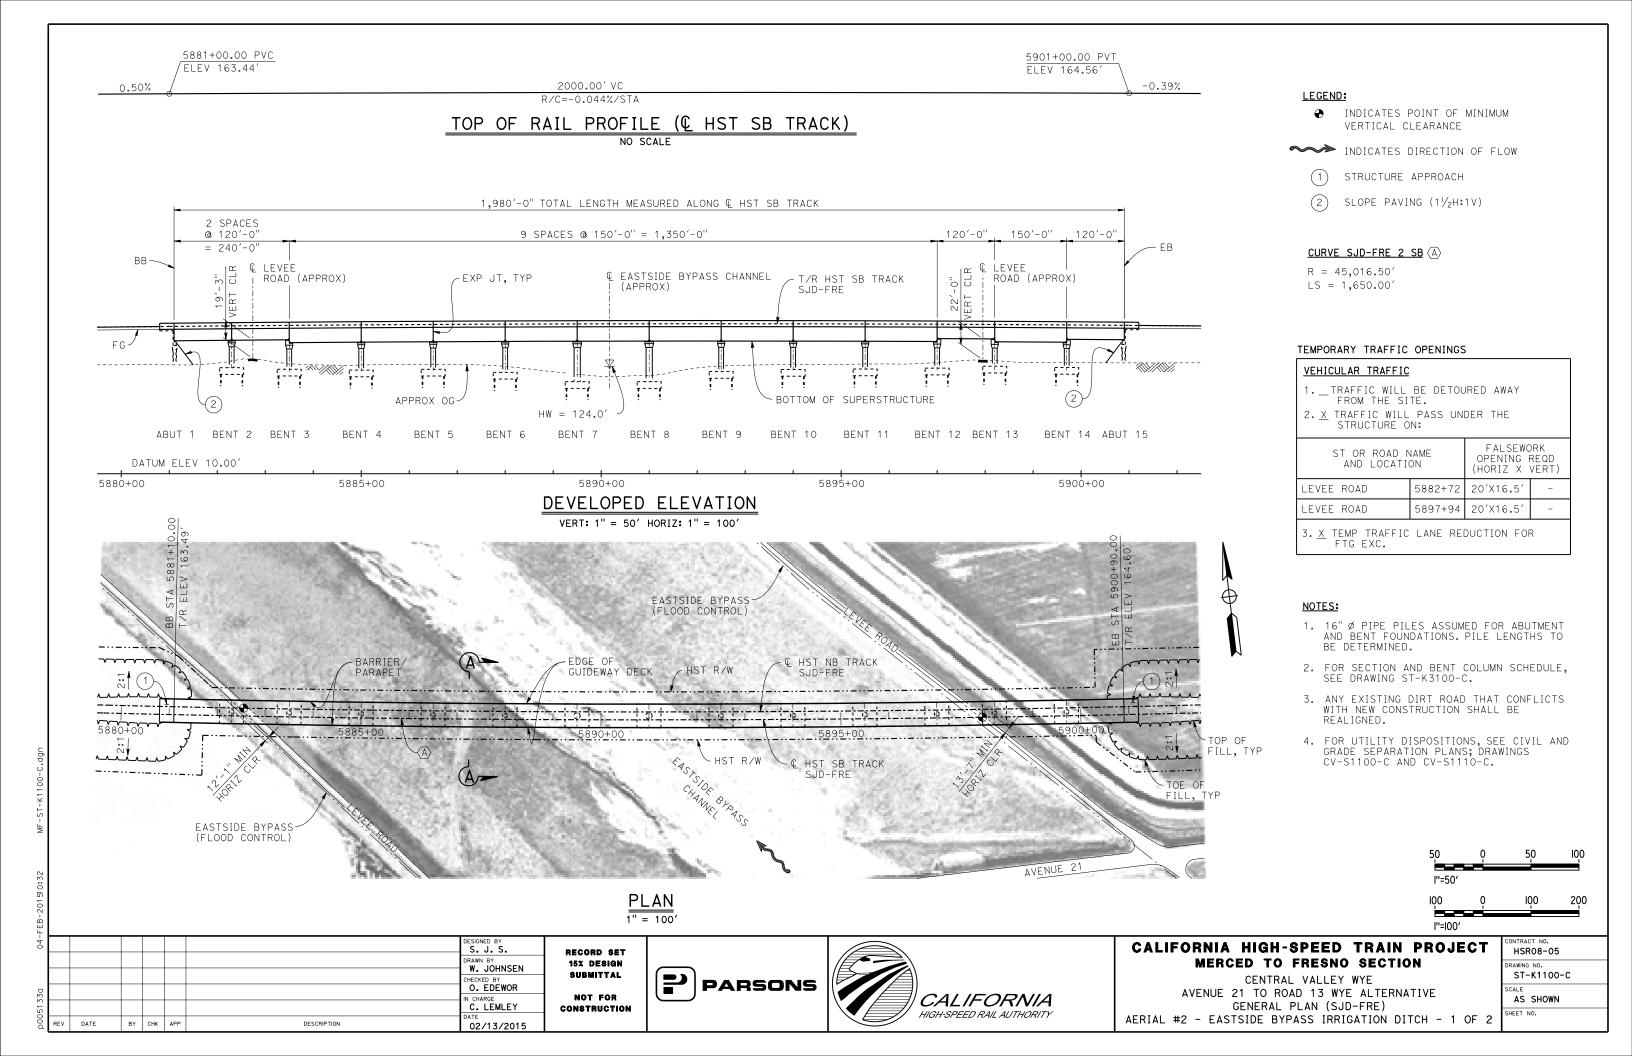


€ BRIDGE

BENT CC	LUMN SCHEDULE
BENT	COLUMN TYPE
2 - 6	10'-0"Ø
7 - 8	13'-0"Ø
9 - 14	10'-0"Ø

NOTES

- 1. PILE LENGTHS TO BE DETERMINED.
- 2. FOR TRACK SUPERELEVATION DETAILS, SEE ALIGNMENT AND TYPICAL SECTION PLANS; DRAWING TT-B0050-C.

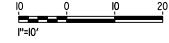

ij.								
-60							DESIGNED BY S. J. S.	
							DRAWN BY W. JOHNSEN	
П							CHECKED BY O. EDEWOR	
51330							IN CHARGE C. LEMLEY	C
00d	REV	DATE	BY	СНК	APP	DESCRIPTION	02/13/2015	

RECORD SET
15% DESIGN
SUBMITTAL
NOT FOR
CONSTRUCTION





CALIFORNIA HIGH-SPEED TRAIN PROJECT MERCED TO FRESNO SECTION


CENTRAL VALLEY WYE


AVENUE 21 TO ROAD 13 WYE ALTERNATIVE

TYPICAL SECTION (SJD-FRE)

AERIAL #2 - EASTSIDE BYPASS IRRIGATION DITCH - 2 OF 2

CONTRACT NO.
HSR08-05
DRAWING NO.
ST-K3100-C
SCALE
AS SHOWN
SHEET NO.

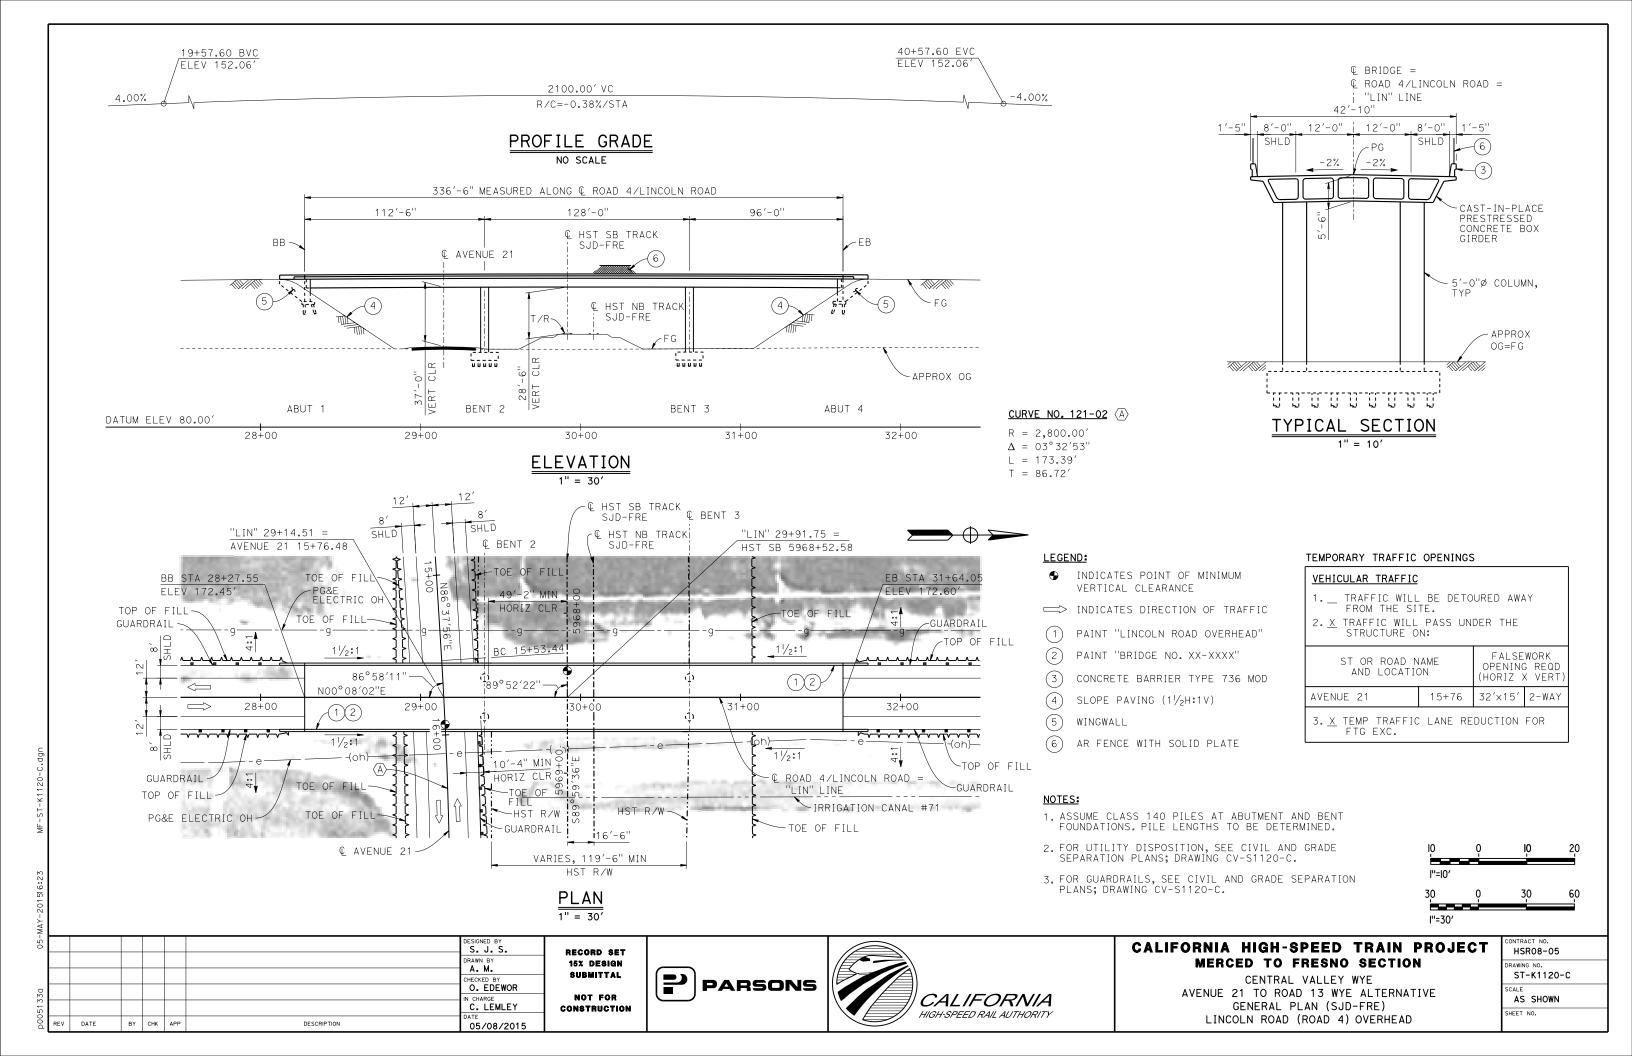


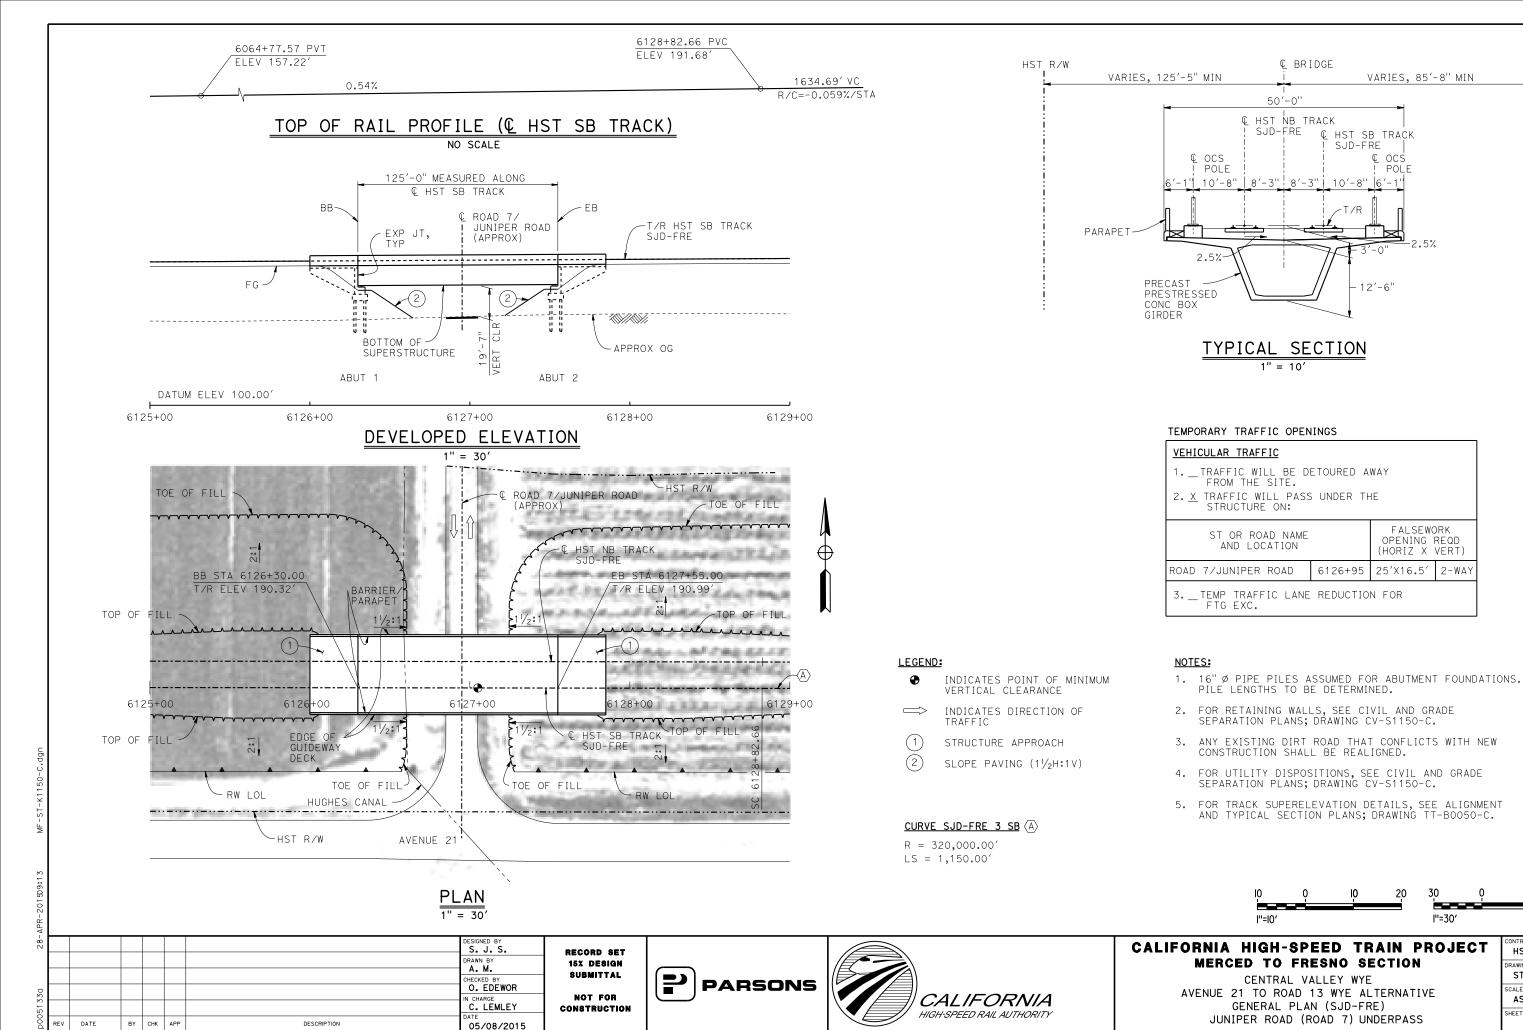


CONTRACT NO.
HSRO8-05
DRAWING NO.
ST-K1150-C
SCALE
AS SHOWN

60


HST_R/W

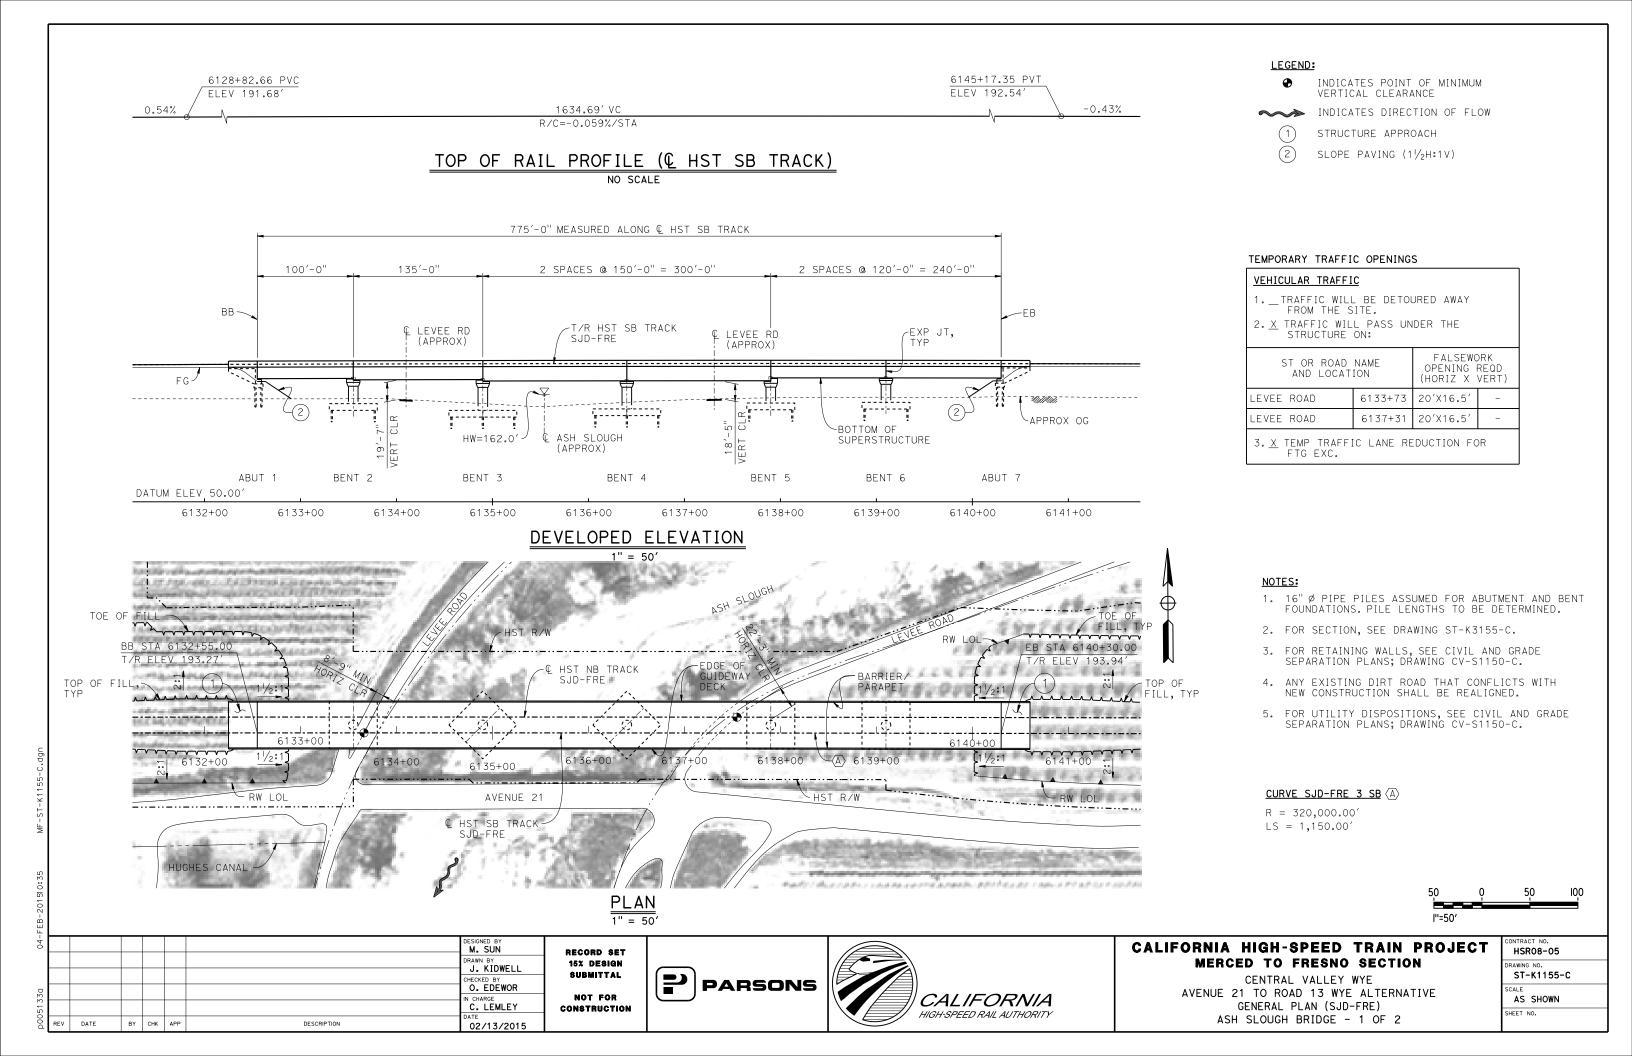

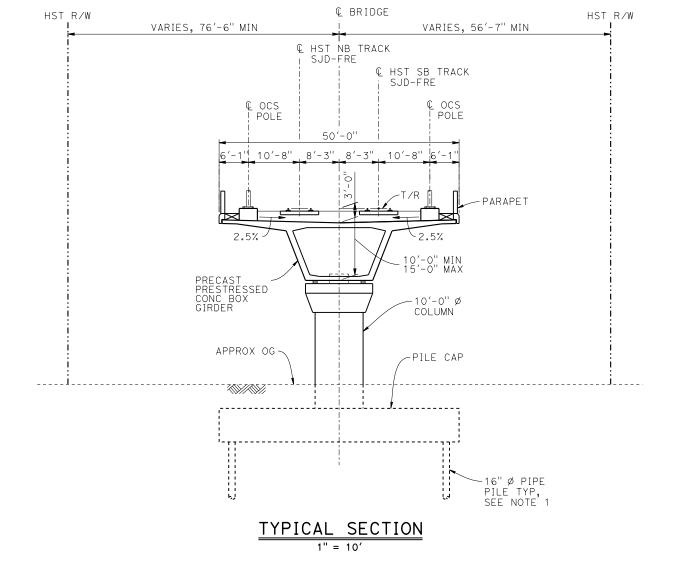

NOTES:

- 1. PILE LENGTHS TO BE DETERMINED.
- 2. FOR TRACK SUPERELEVATION DETAILS, SEE ALIGNMENT AND TYPICAL SECTION PLANS; DRAWING TT-B0050-C.

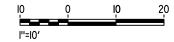

Ţ.								
-60							DESIGNED BY M. SUN	
							DRAWN BY J. KIDWELL	
20							CHECKED BY O. EDEWOR	
9							IN CHARGE C. LEMLEY] c
1500d	REV	DATE	BY	СНК	APP	DESCRIPTION	DATE 02/13/2015	

RECORD SET
15% DESIGN
SUBMITTAL
NOT FOR
CONSTRUCTION





CALIFORNIA HIGH-SPEED TRAIN PROJECT MERCED TO FRESNO SECTION

CENTRAL VALLEY WYE


AVENUE 21 TO ROAD 13 WYE ALTERNATIVE


TYPICAL SECTION (SJD-FRE)


ASH SLOUGH BRIDGE - 2 OF 2


Г	CONTRACT NO. HSR08-05
	DRAWING NO. ST-K3155-C
	SCALE AS SHOWN

SHEET NO.

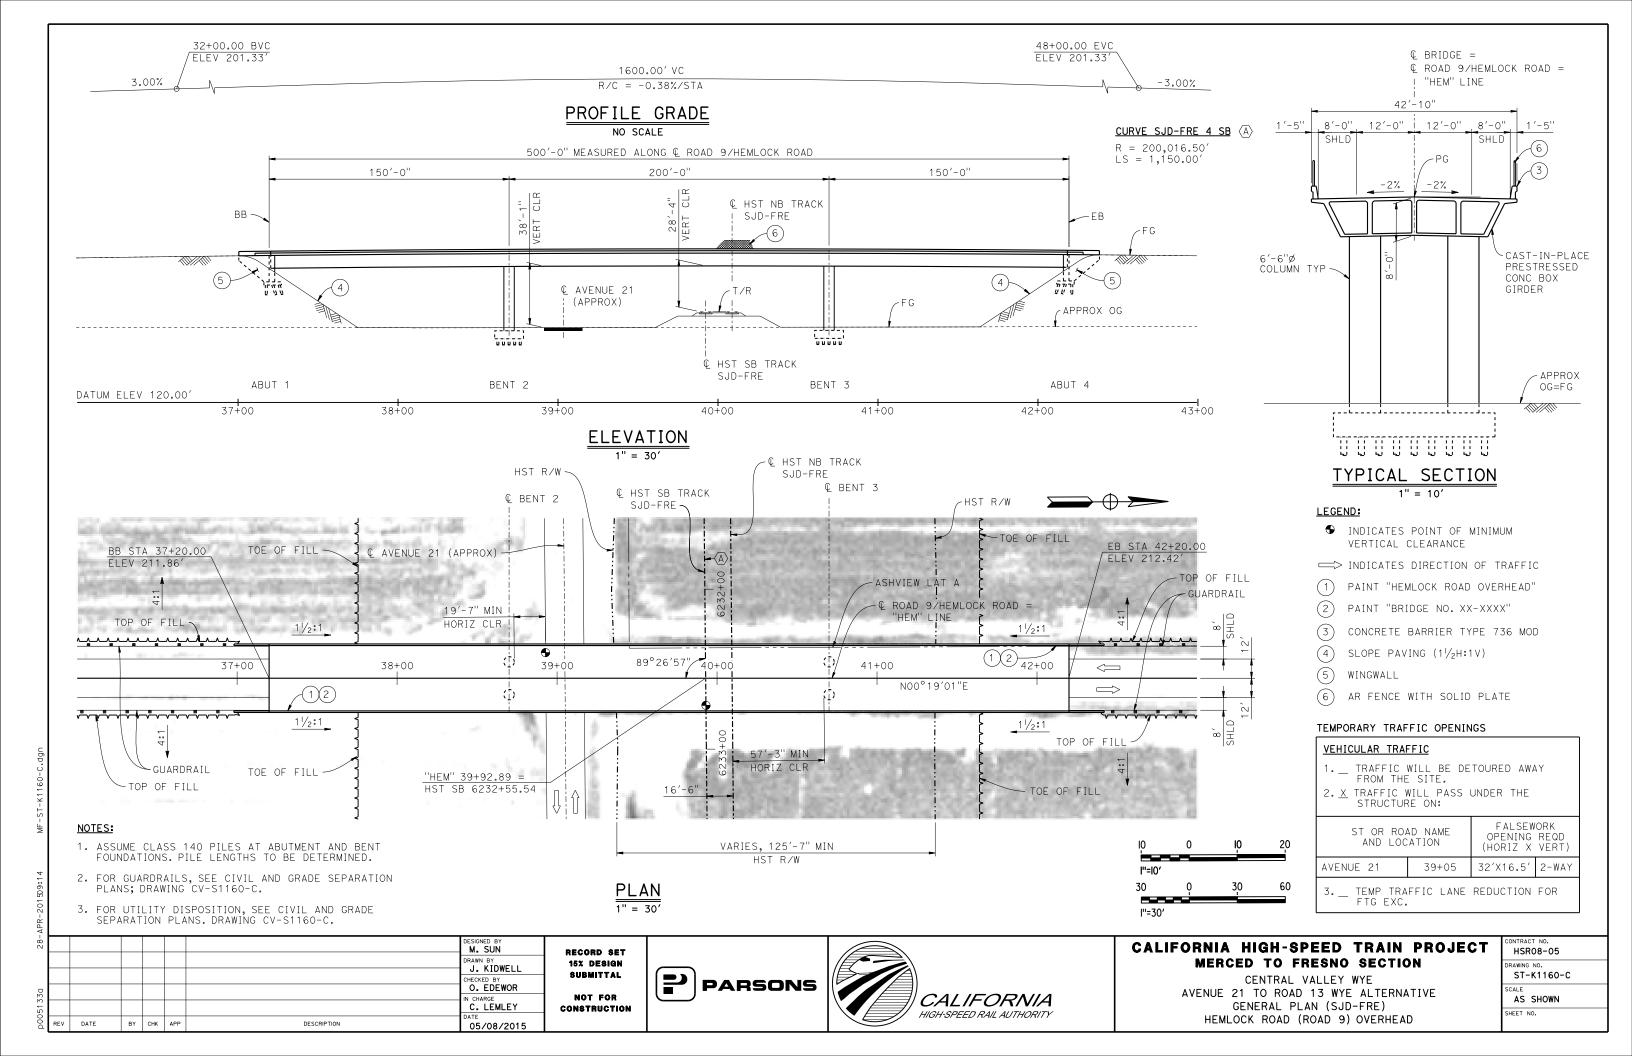

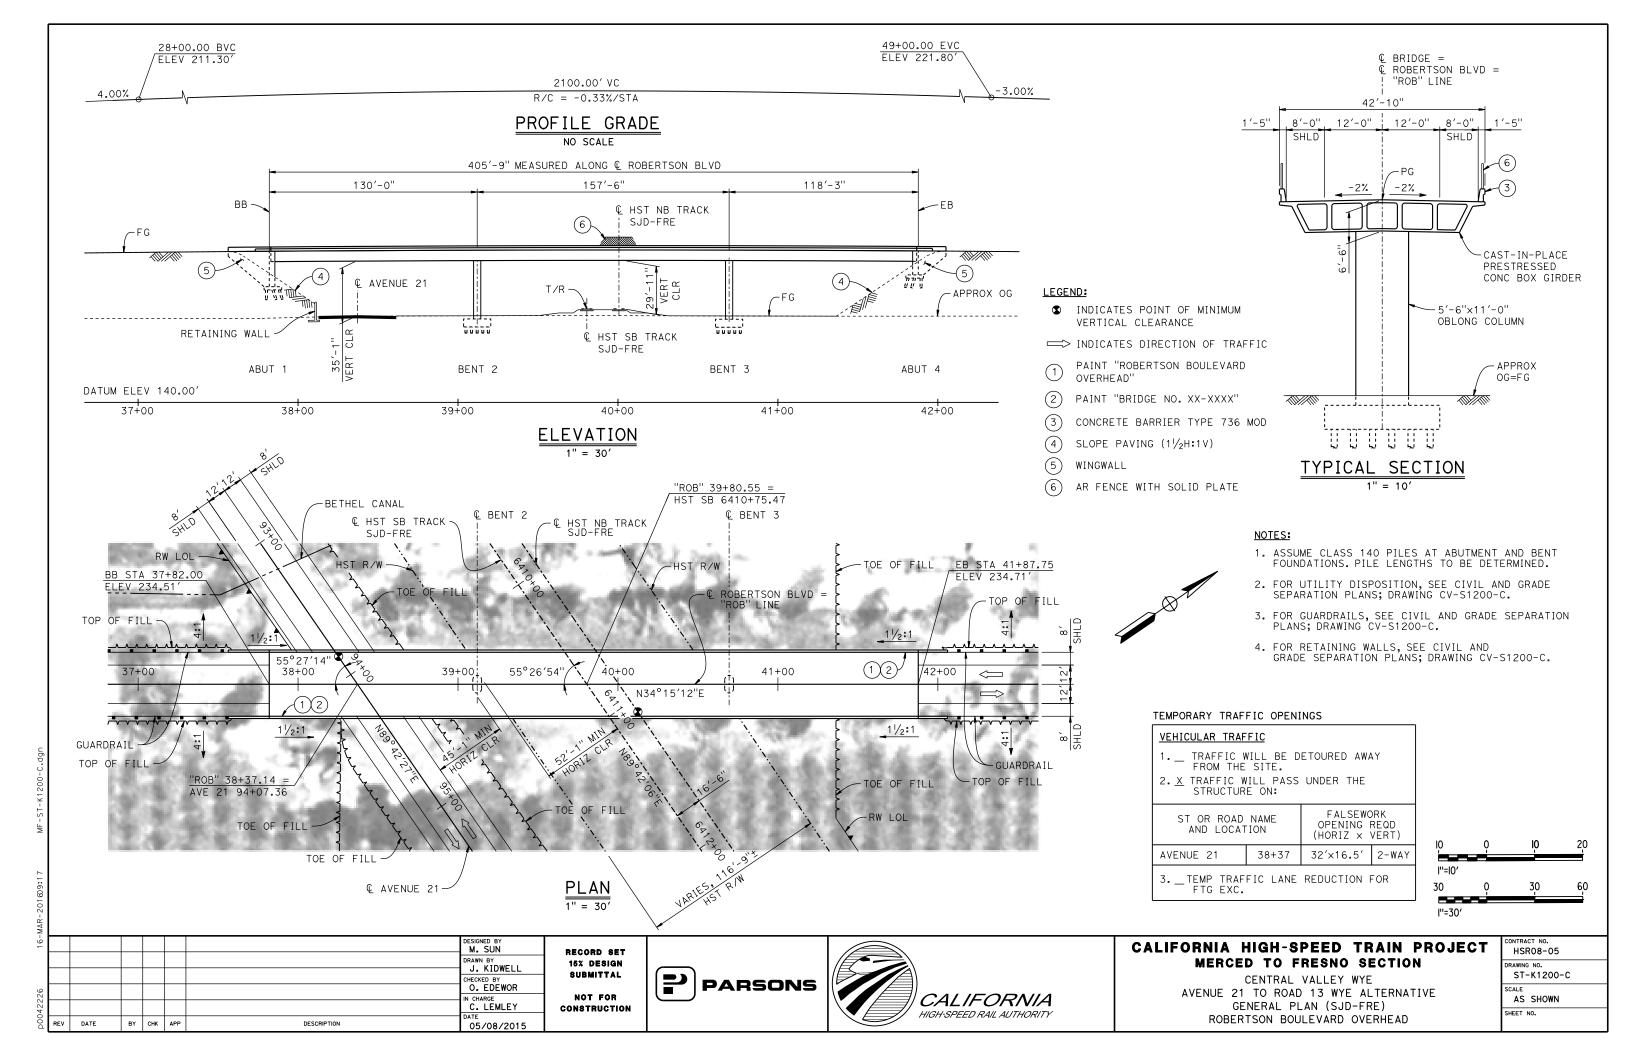

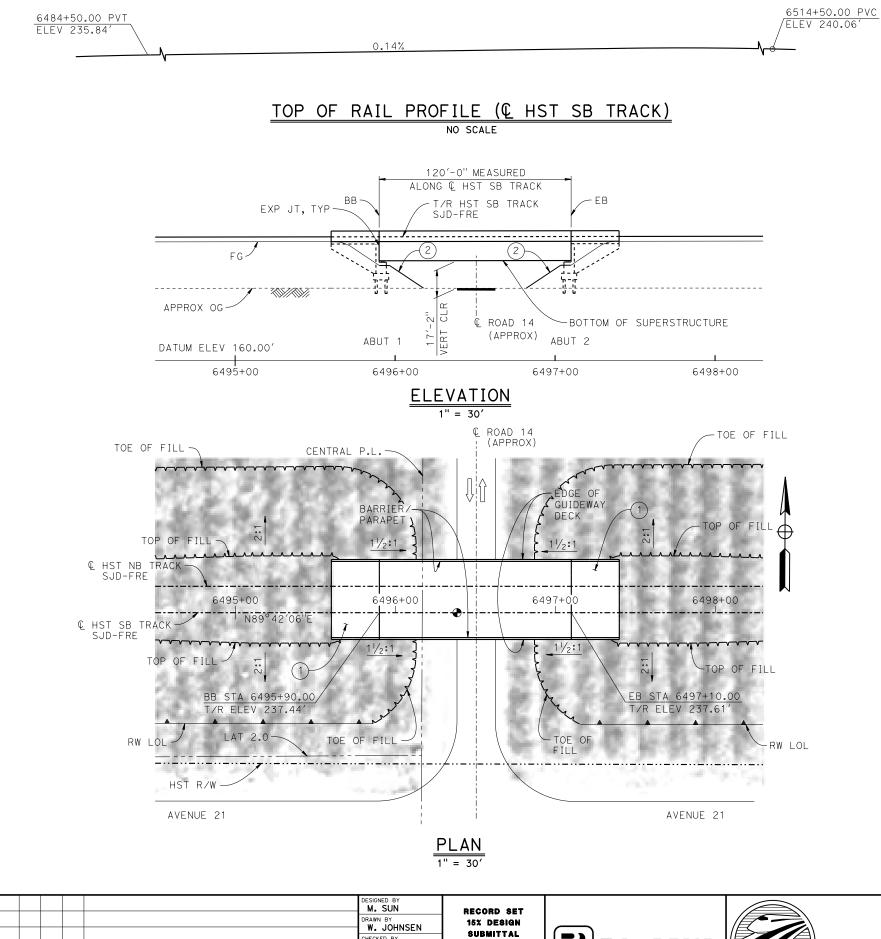

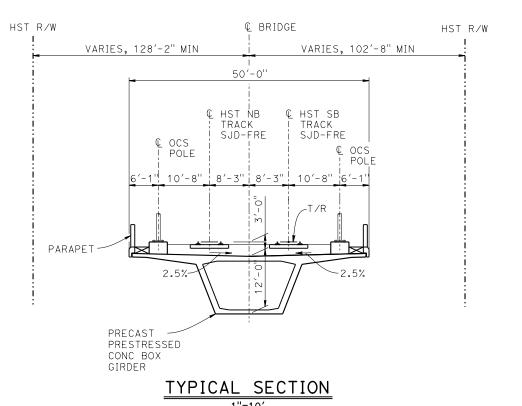

TEMPORARY TRAFFIC OPENINGS

	0. 2	<i>*</i>				
<u>VEHICULAR TRAFFIC</u>						
1 TRAFFIC WILL BE DETOURED AWAY FROM THE SITE.						
2. X TRAFFIC WILL PASS UNDER THE STRUCTURE ON:						
ST OR ROAD N AND LOCATIO	FALSEWOPENING (HORIZ X	REQD				
ROAD 14	32′X16.5′	2-WAY				
3 TEMP TRAFFIC LANE REDUCTION FOR FIG FXC.						

LEGEND:

- ◆ INDICATES POINT OF MINIMUM VERTICAL CLEARANCE
- (1) STRUCTURE APPROACH
- (2) SLOPE PAVING $(1\frac{1}{2}H:1V)$

NOTES:

- 1. 16" Ø PIPE PILES ASSUMED FOR ABUTMENT FOUNDATIONS. PILE LENGTHS TO BE DETERMINED.
- 2. FOR UTILITY DISPOSITIONS, SEE CIVIL AND GRADE SEPARATION PLANS; DRAWING CV-S1210-C.
- 3. FOR RETAINING WALLS, SEE CIVIL AND GRADE SEPARATION PLANS; DRAWING CV-S1210-C.



M. SUN
DRAWN BY W. JOHNSEN
O. EDEWOR
IN CHARGE C. LEMLEY

DESCRIPTION

DATE

BY CHK APP



NOT FOR

CONSTRUCTION


05/08/2015





CALIFORNIA HIGH-SPEED TRAIN PROJECT MERCED TO FRESNO SECTION


CENTRAL VALLEY WYE
AVENUE 21 TO ROAD 13 WYE ALTERNATIVE
GENERAL PLAN (SJD-FRE)
ROAD 14 UNDERPASS

CONTRACT NO.
HSR08-05
DRAWING NO.
ST-K1210-C
SCALE
AS SHOWN
SHEET NO.

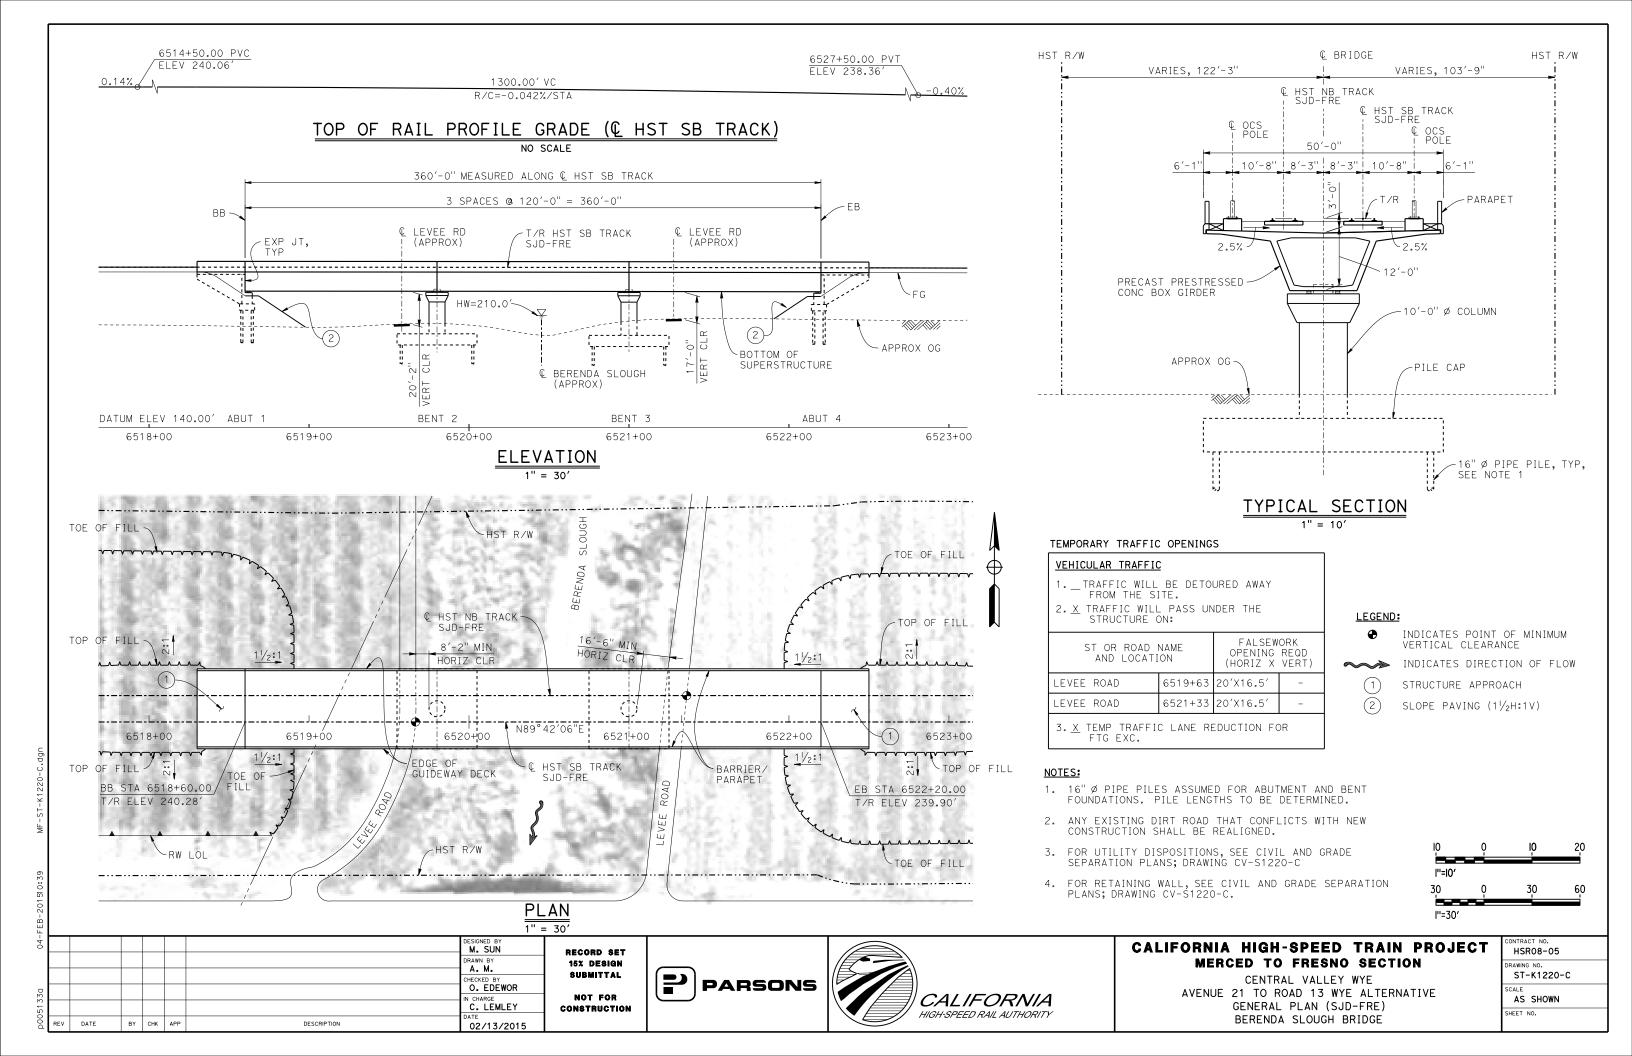

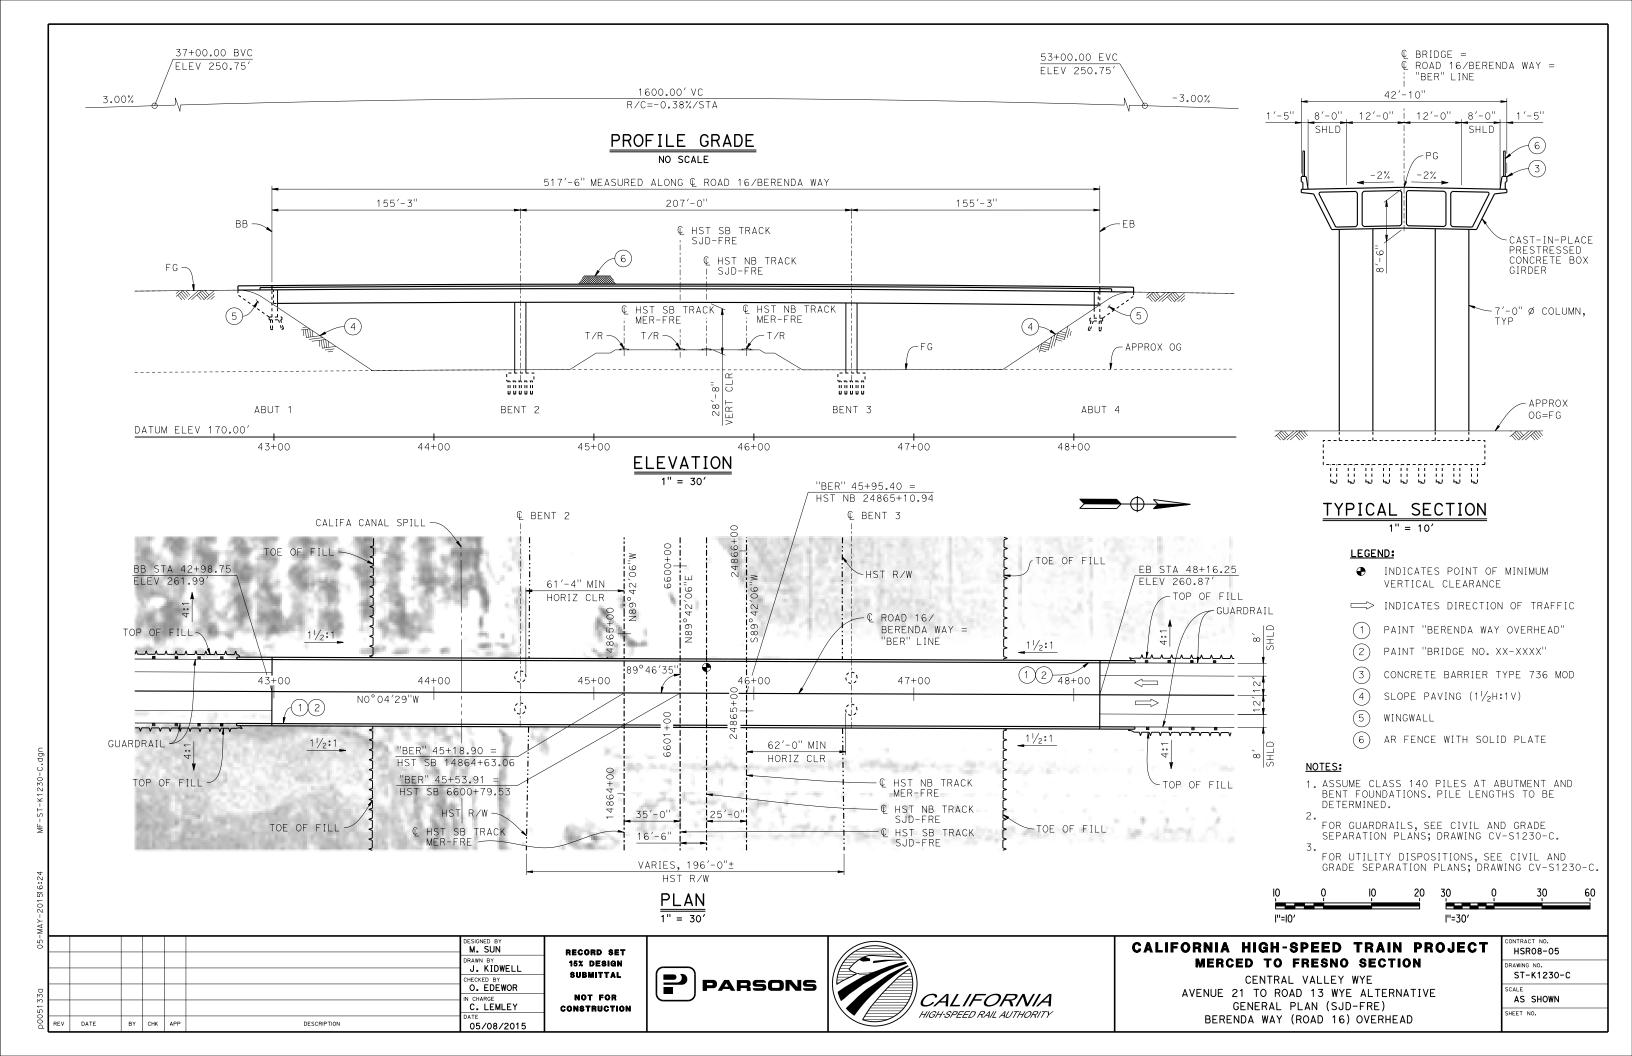


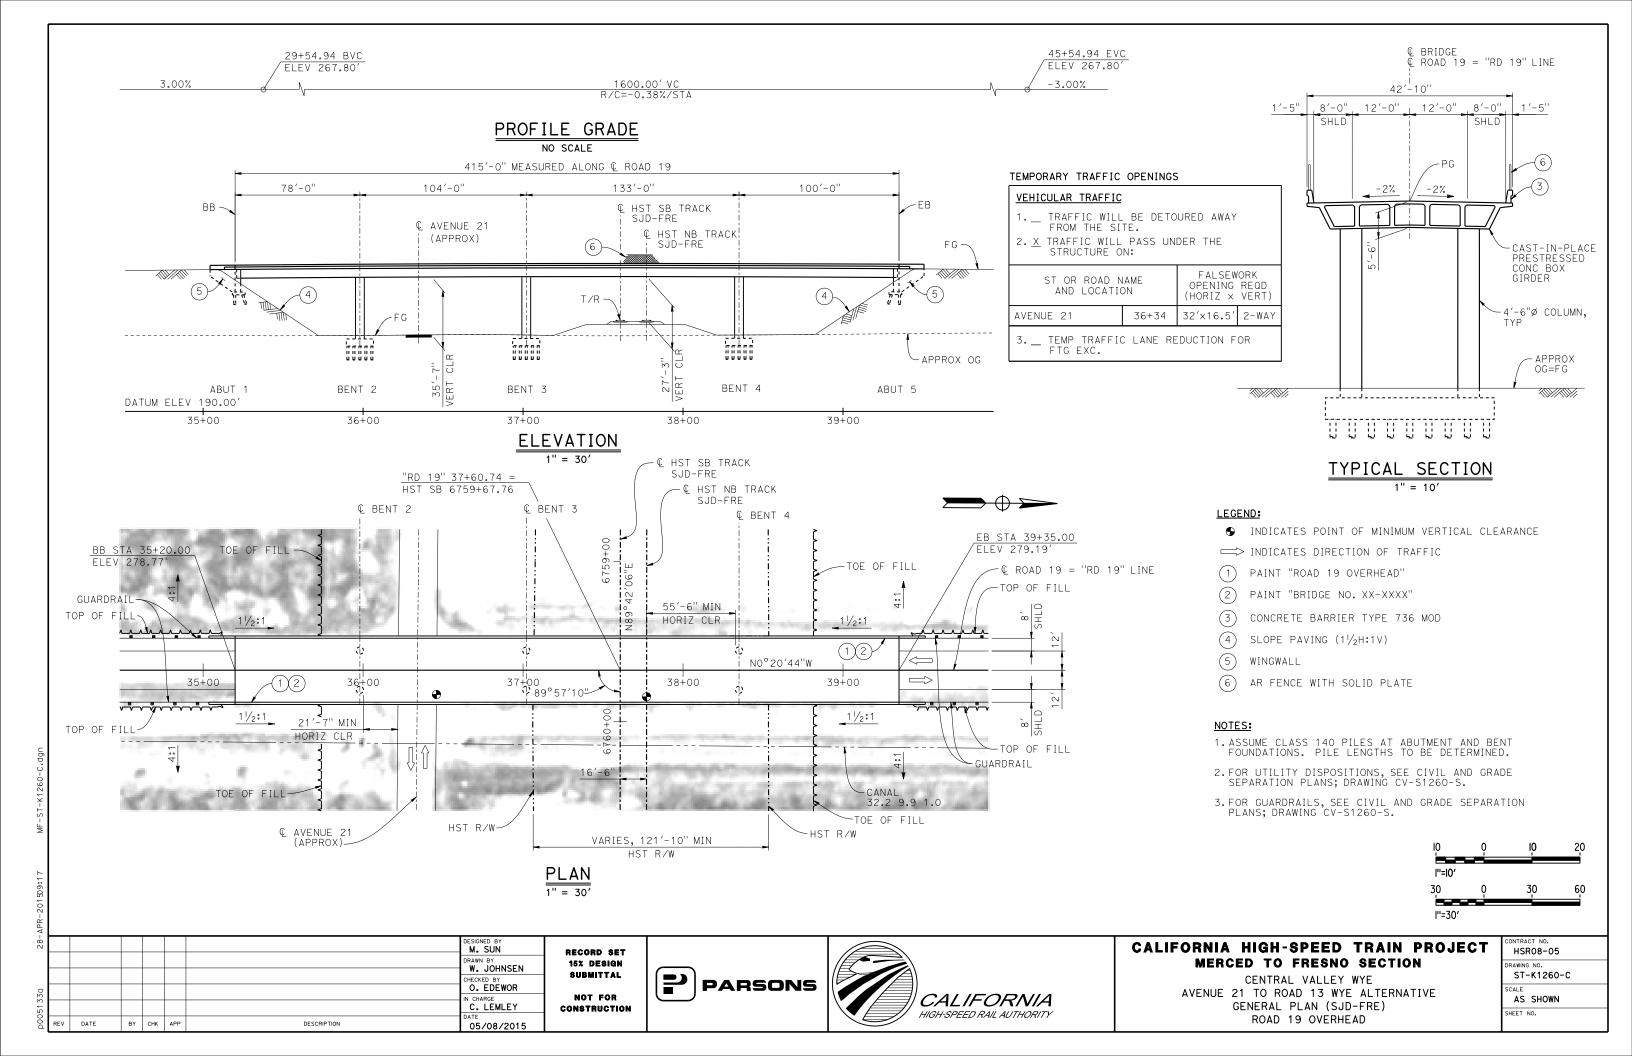


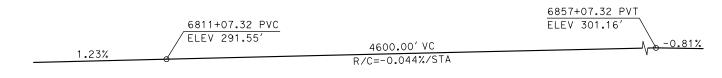


TOP OF RAIL PROFILE (& HST SB TRACK)

NO SCALE

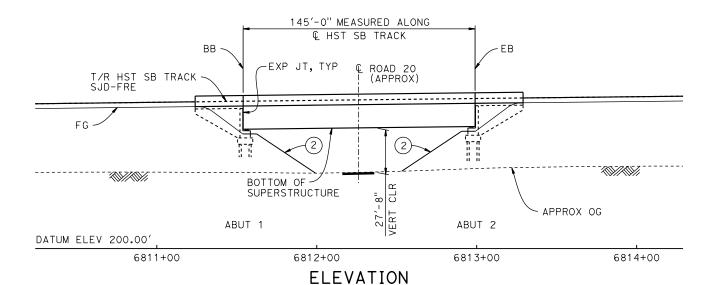

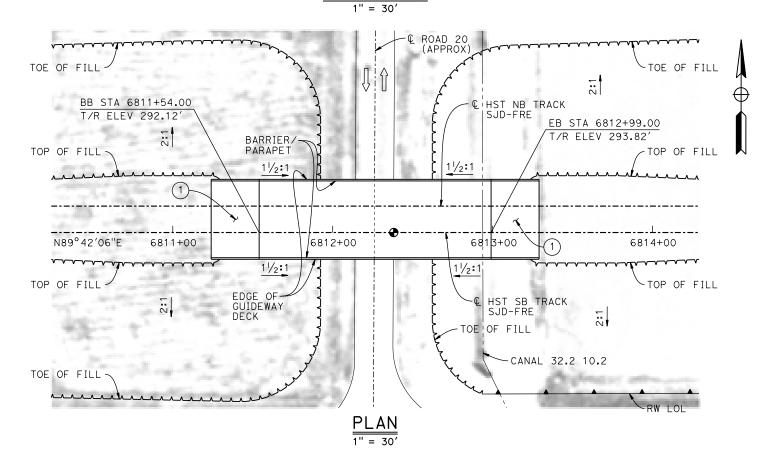

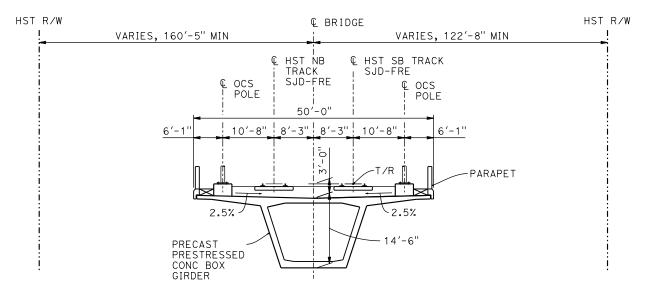

TYPICAL SECTION

TEMPORARY TRAFFIC OPENINGS

VEHICULAR TRAFFIC

- 1. __TRAFFIC WILL BE DETOURED AWAY FROM THE SITE.
- 2. \underline{X} TRAFFIC WILL PASS UNDER THE STRUCTURE ON:

	ST OR ROAD NAME AND LOCATION		FALSEW OPENING (HORIZ X	REQD
ROAD	20	6812+26	32′X16.5′	2-WAY


3. _ TEMP TRAFFIC LANE REDUCTION FOR FTG EXC.

LEGEND:

- INDICATES POINT OF MINIMUM VERTICAL CLEARANCE
- (1) STRUCTURE APPROACH
- (2) SLOPE PAVING $(1\frac{1}{2}H:1V)$

NOTES:

- 1. 16" Ø PIPE PILES ASSUMED FOR ABUTMENT FOUNDATIONS. PILE LENGTHS TO BE DETERMINED.
- 2. ANY EXISTING DIRT ROAD THAT CONFLICTS WITH NEW CONSTRUCTION SHALL BE REALIGNED.
- 3. FOR UTILITY DISPOSITIONS, SEE CIVIL AND GRADE SEPARATION PLANS; DRAWING CV-S1270-C.
- 4. FOR RETAINING WALL, SEE CIVIL AND GRADE SEPARATION PLANS; DRAWING CV-S1270-C.

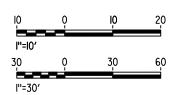

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9							DESIGNED BY S. J. S.	Г
							DRAWN BY	ĺ
							CHECKED BY	ĺ
9							O. EDEWOR IN CHARGE	ł
14.2.2							C. LEMLEY	
D00	REV	DATE	BY	СНК	APP	DESCRIPTION	DATE 05/08/2015	

RECORD SET
15% DESIGN
SUBMITTAL
NOT FOR
CONSTRUCTION






CALIFORNIA HIGH-SPEED TRAIN PROJECT MERCED TO FRESNO SECTION

CENTRAL VALLEY WYE
AVENUE 21 TO ROAD 13 WYE ALTERNATIVE
GENERAL PLAN (SJD-FRE)
ROAD 20 UNDERPASS

CONTRACT NO.
HSR08-05
DRAWING NO.
ST-K1270-C
SCALE
AS SHOWN
SHEET NO.

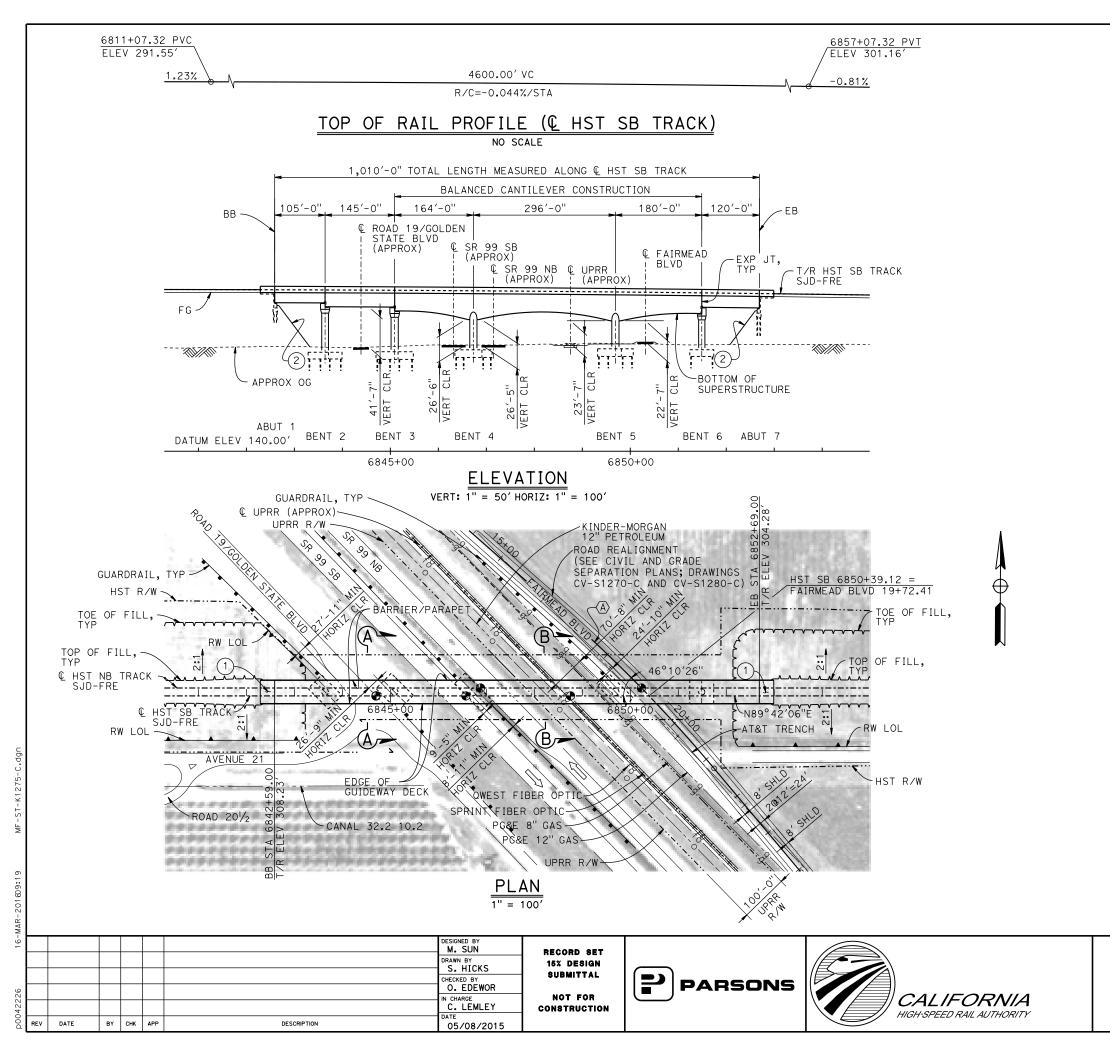

LEGEND:

- INDICATES POINT OF MINIMUM VERTICAL CLEARANCE
- □ INDICATES DIRECTION OF TRAFFIC
 □
- (1) STRUCTURE APPROACH
- 2) SLOPE PAVING $(1\frac{1}{2}H:1V)$

TEMPORARY TRAFFIC OPENINGS

VEHICULAR TRAFFIC

- 1. _ TRAFFIC WILL BE DETOURED AWAY
- FROM THE SITE.
- 2. \underline{X} TRAFFIC WILL PASS UNDER THE STRUCTURE ON:

ST OR ROAD NAME AND LOCATION		FALSEWORK OPENING REQD (HORIZ X VERT)	
ROAD 19/GOLDEN STATE BLVD	6844+40	40′x16.5′	2-WAY
SR 99	6846+35	52′x16.5′	S BND
SR 99	6847+30	52′x16.5′	N BND
FAIRMEAD BLVD	6850+39	32′x16.5′	2-WAY

3. \underline{X} TEMP TRAFFIC LANE REDUCTION FOR FTG EXC.

TEMPORARY TRAFFIC OPENINGS

	RAILROAD TRAFFIC FALSEWORK OPENING REQUIRED ON:			
	NAME OF RR AND L	FALSEWORK OPENING REQD (HORIZ X VERT)		
	UPRR	6848+68	24′×21′	

NOTES:

- 1. 16" Ø PIPE PILES ASSUMED FOR ABUTMENT AND BENT FOUNDATIONS. PILE LENGTHS TO BE DETERMINED.
- 2. FOR SECTIONS AND BENT COLUMN SCHEDULE, SEE DRAWING ST-K3275-C.
- 3. ANY EXISTING DIRT ROAD THAT CONFLICTS WITH NEW CONSTRUCTION SHALL BE REALIGNED.
- 4. FOR UTILITY DISPOSITIONS, SEE CIVIL AND GRADE SEPARATION PLANS; DRAWINGS CV-S1270-C AND CV-S1280-C.
- 5. FOR GUARDRAILS, SEE CIVIL AND GRADE SEPARATION PLANS; DRAWINGS CV-S1270-C AND CV-S1280-C.
- 6. FOR RETAINING WALLS, SEE CIVIL AND GRADE SEPARATION PLANS; DRAWINGS CV-S1270-C AND CV-S2180-C.


CURVE NO. 270-02 (A)

R = 3,000.00'

 $\Delta = 1^{\circ}54'35'$

L = 454.11'

T = 227.49'

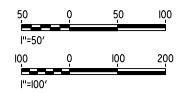

CALIFORNIA HIGH-SPEED TRAIN PROJECT MERCED TO FRESNO SECTION


CENTRAL VALLEY WYE


AVENUE 21 TO ROAD 13 WYE ALTERNATIVE


GENERAL PLAN (SJD-FRE)


AERIAL #3 - SR 99 / UPRR - 1 OF 2


	TRACT NO.
\vdash	HSR08-05
	AWING NO.
	ST-K1275-C
SCA	ALE
	AS SHOWN
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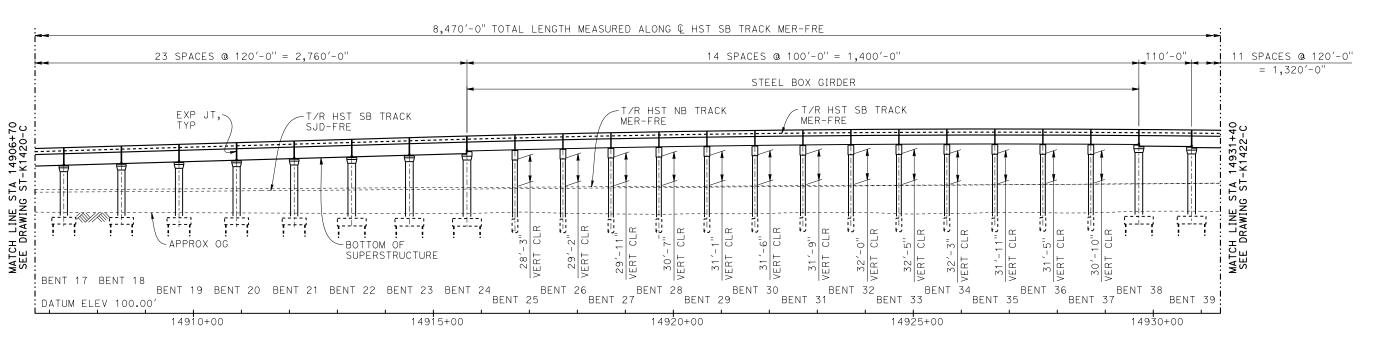


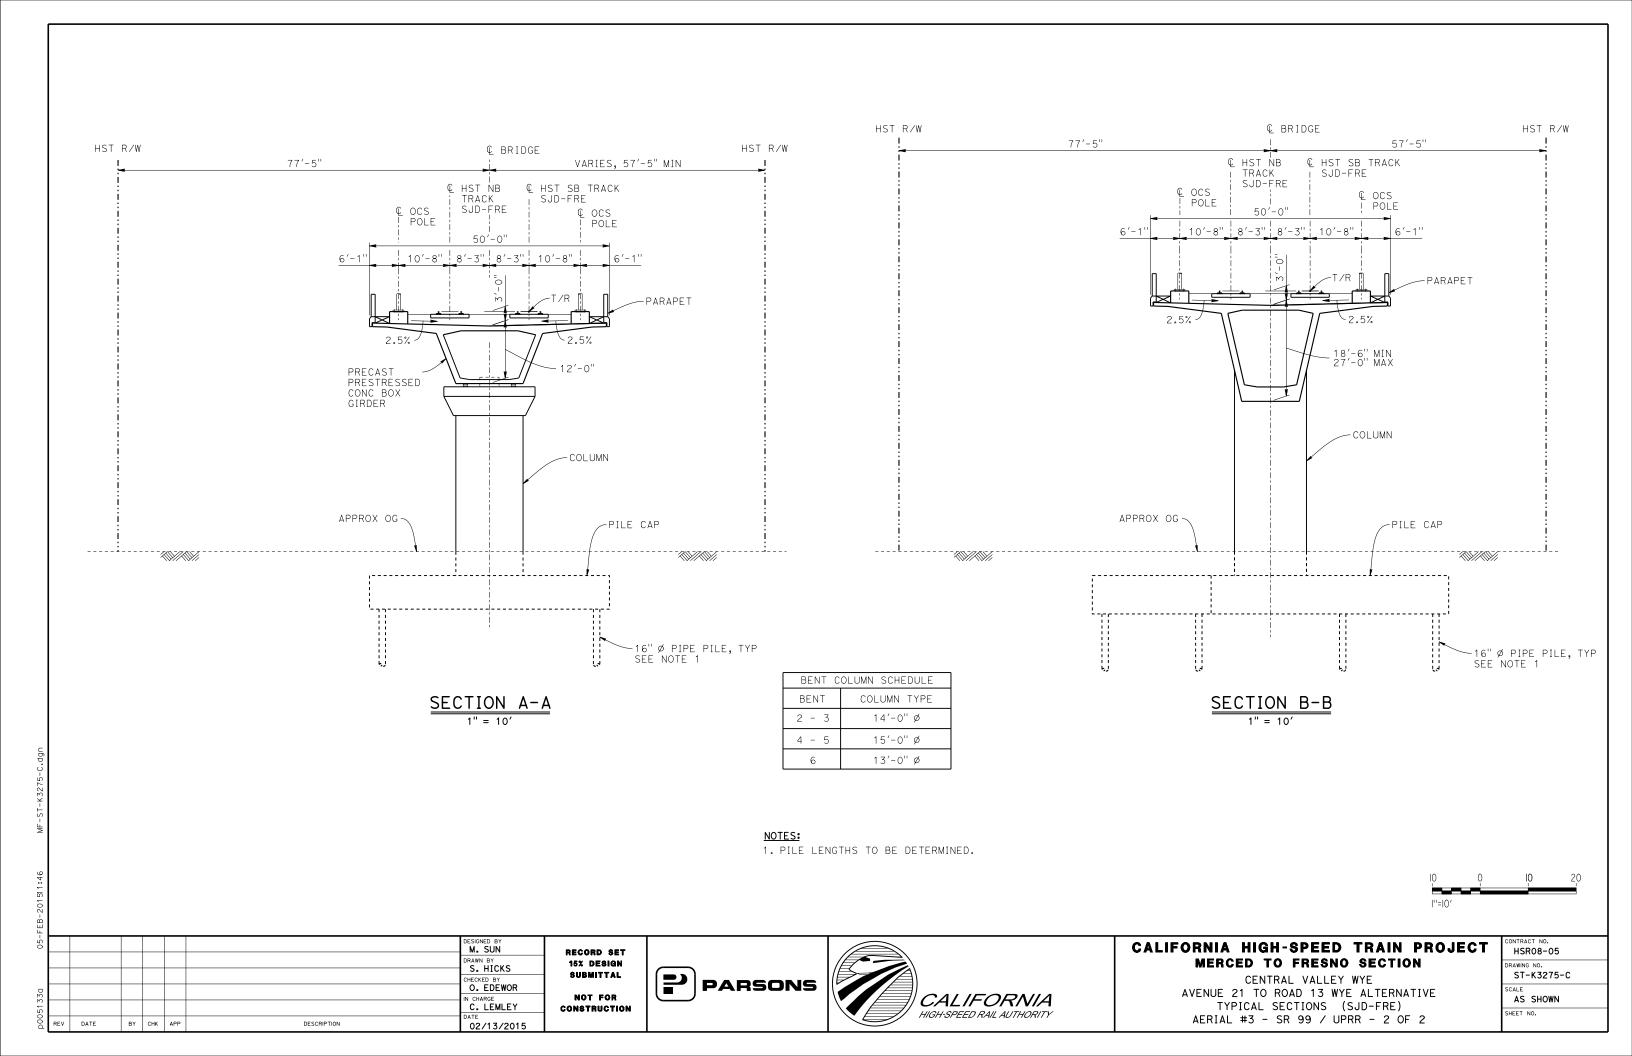

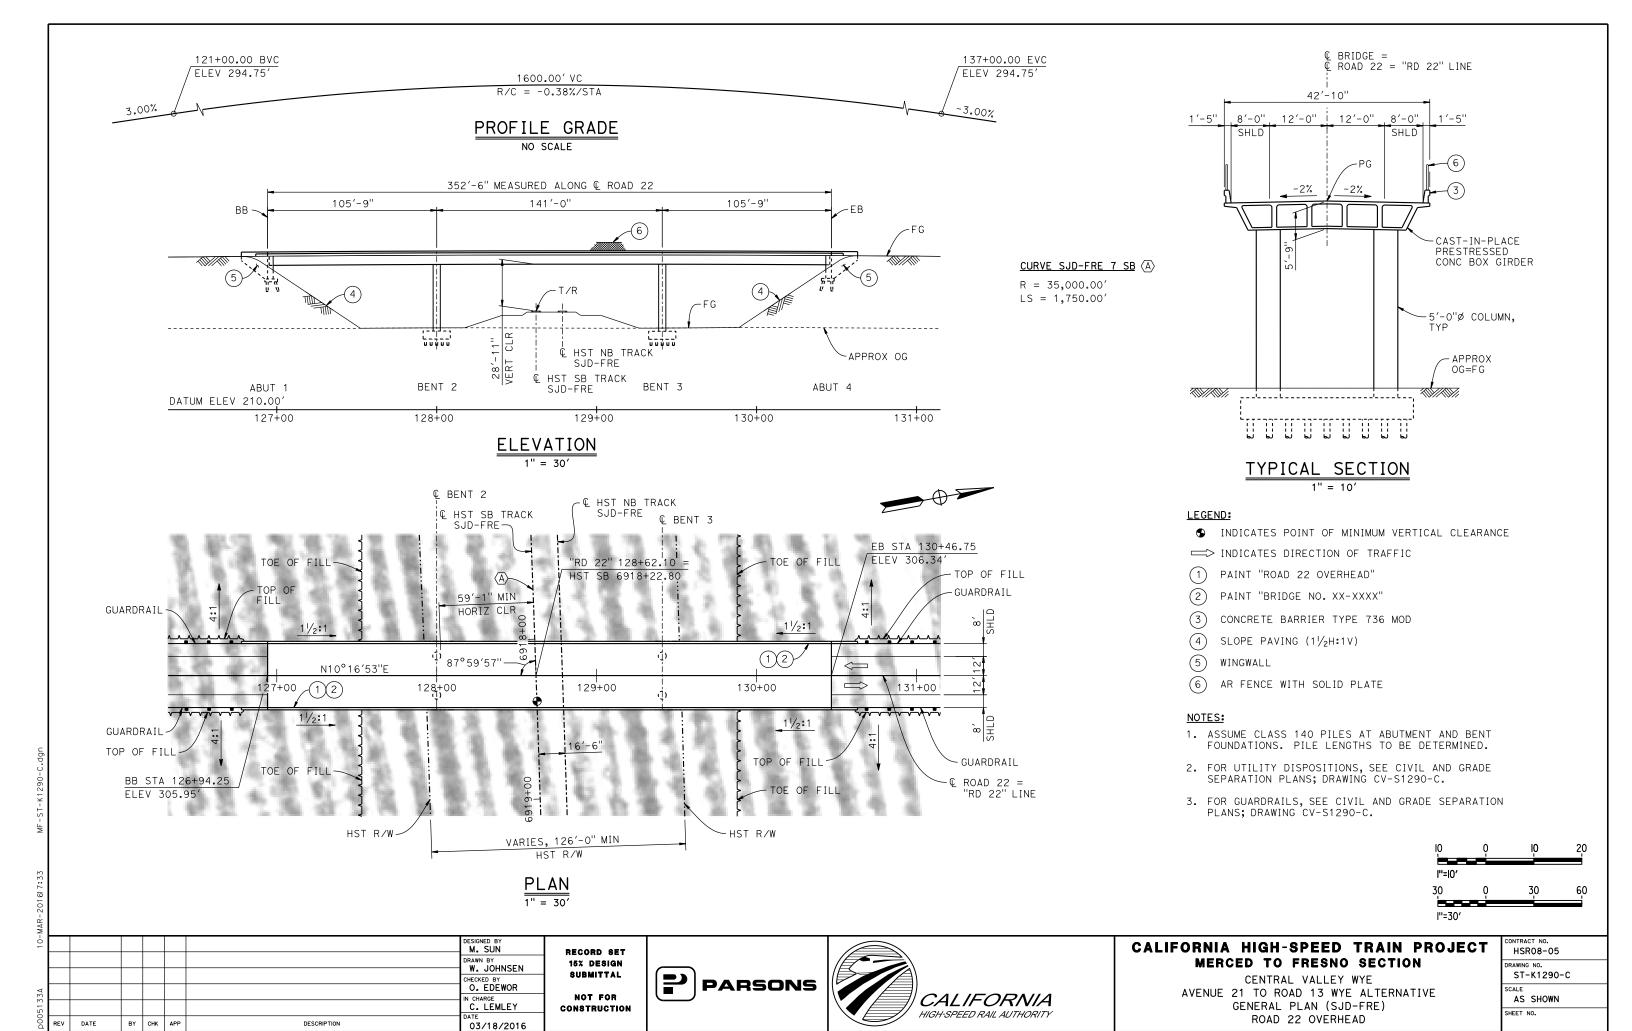

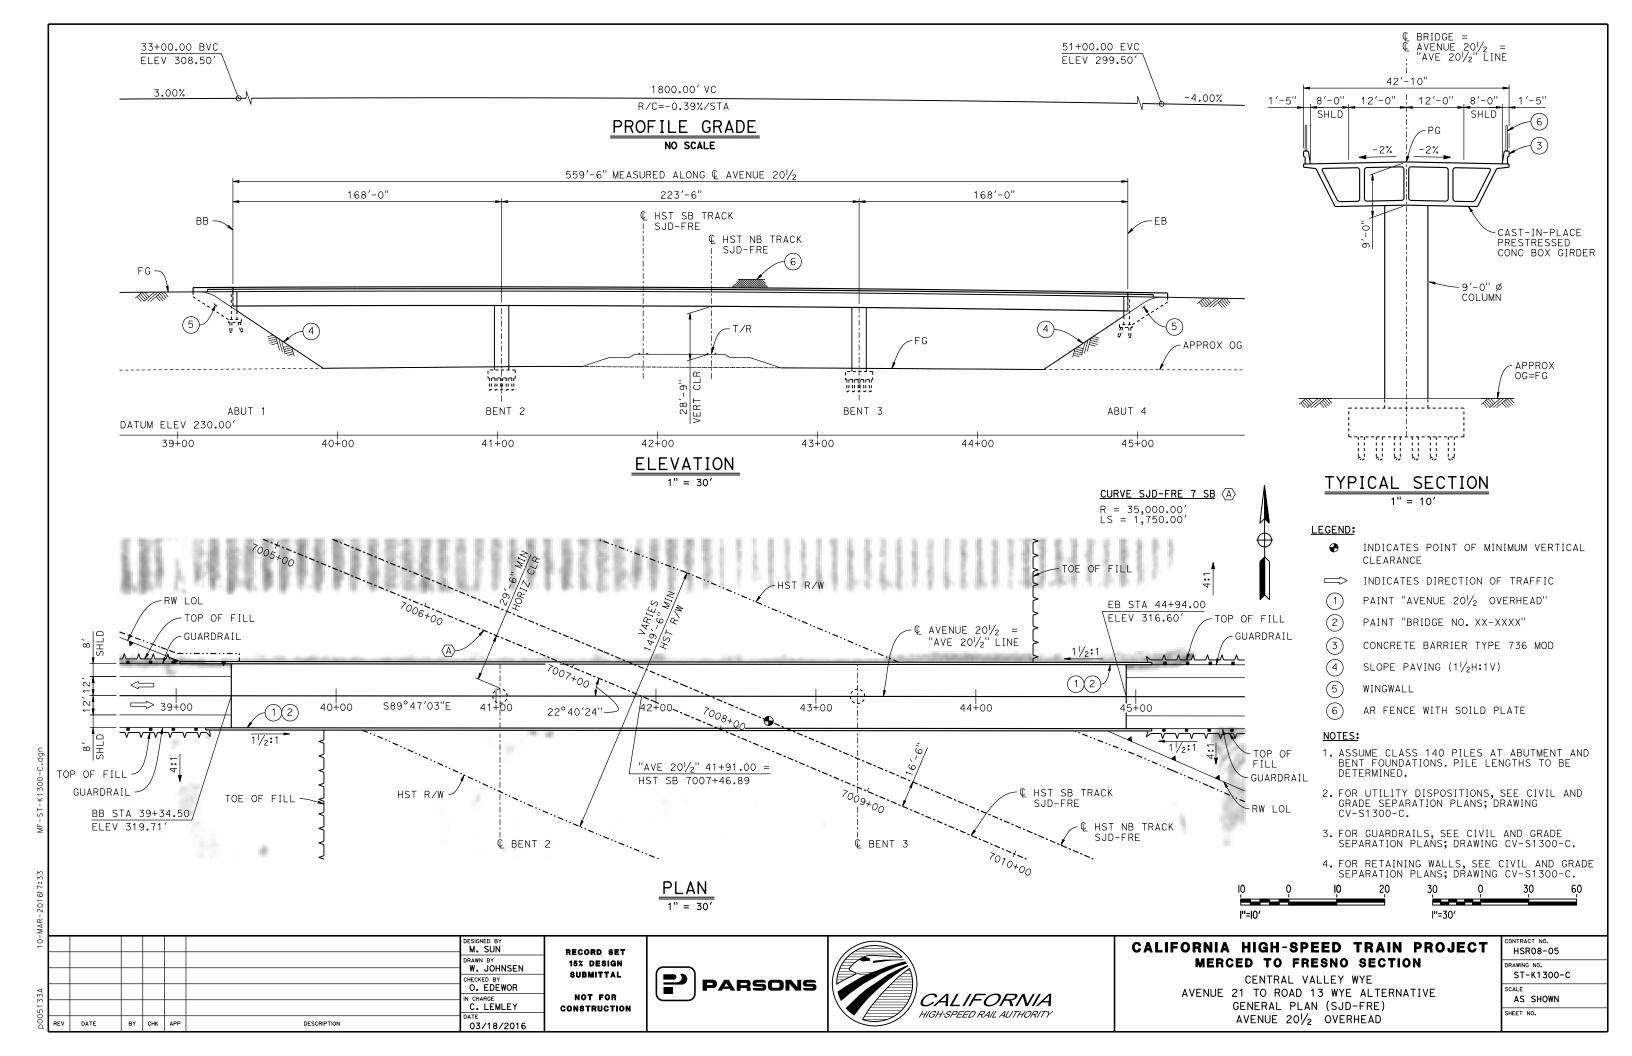
2250.00' VC R/C = -0.121%/STA

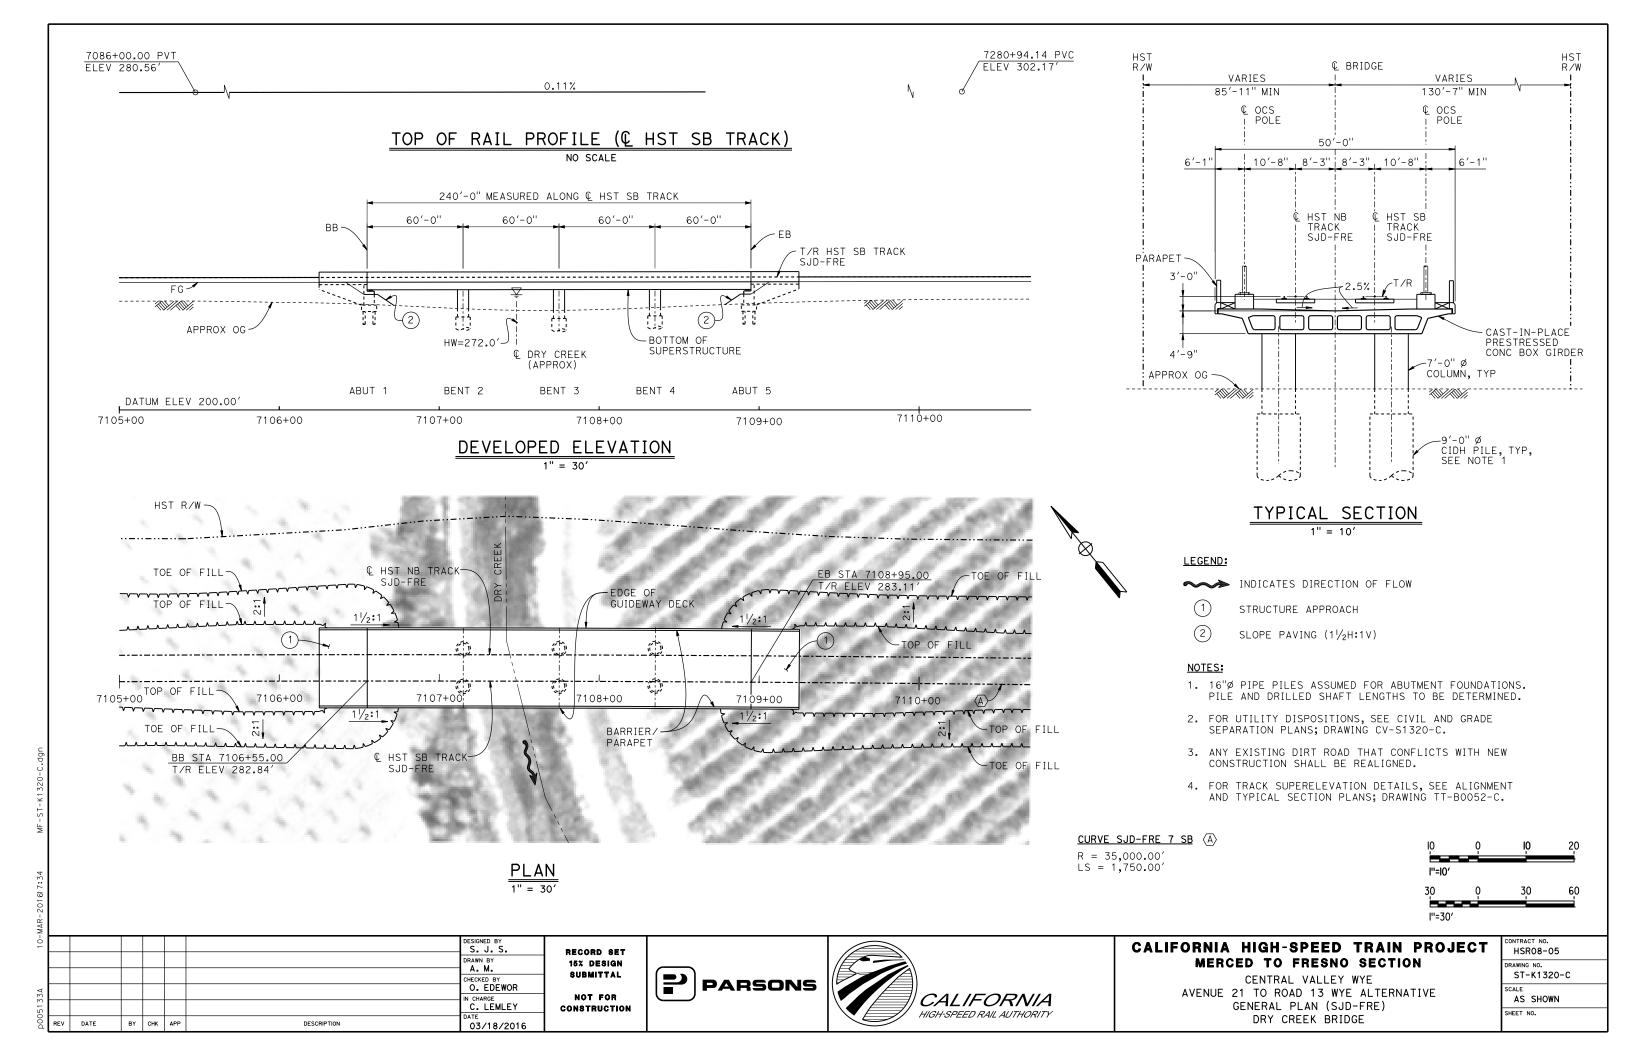TOP OF RAIL PROFILE (HST SB TRACK MER-FRE)

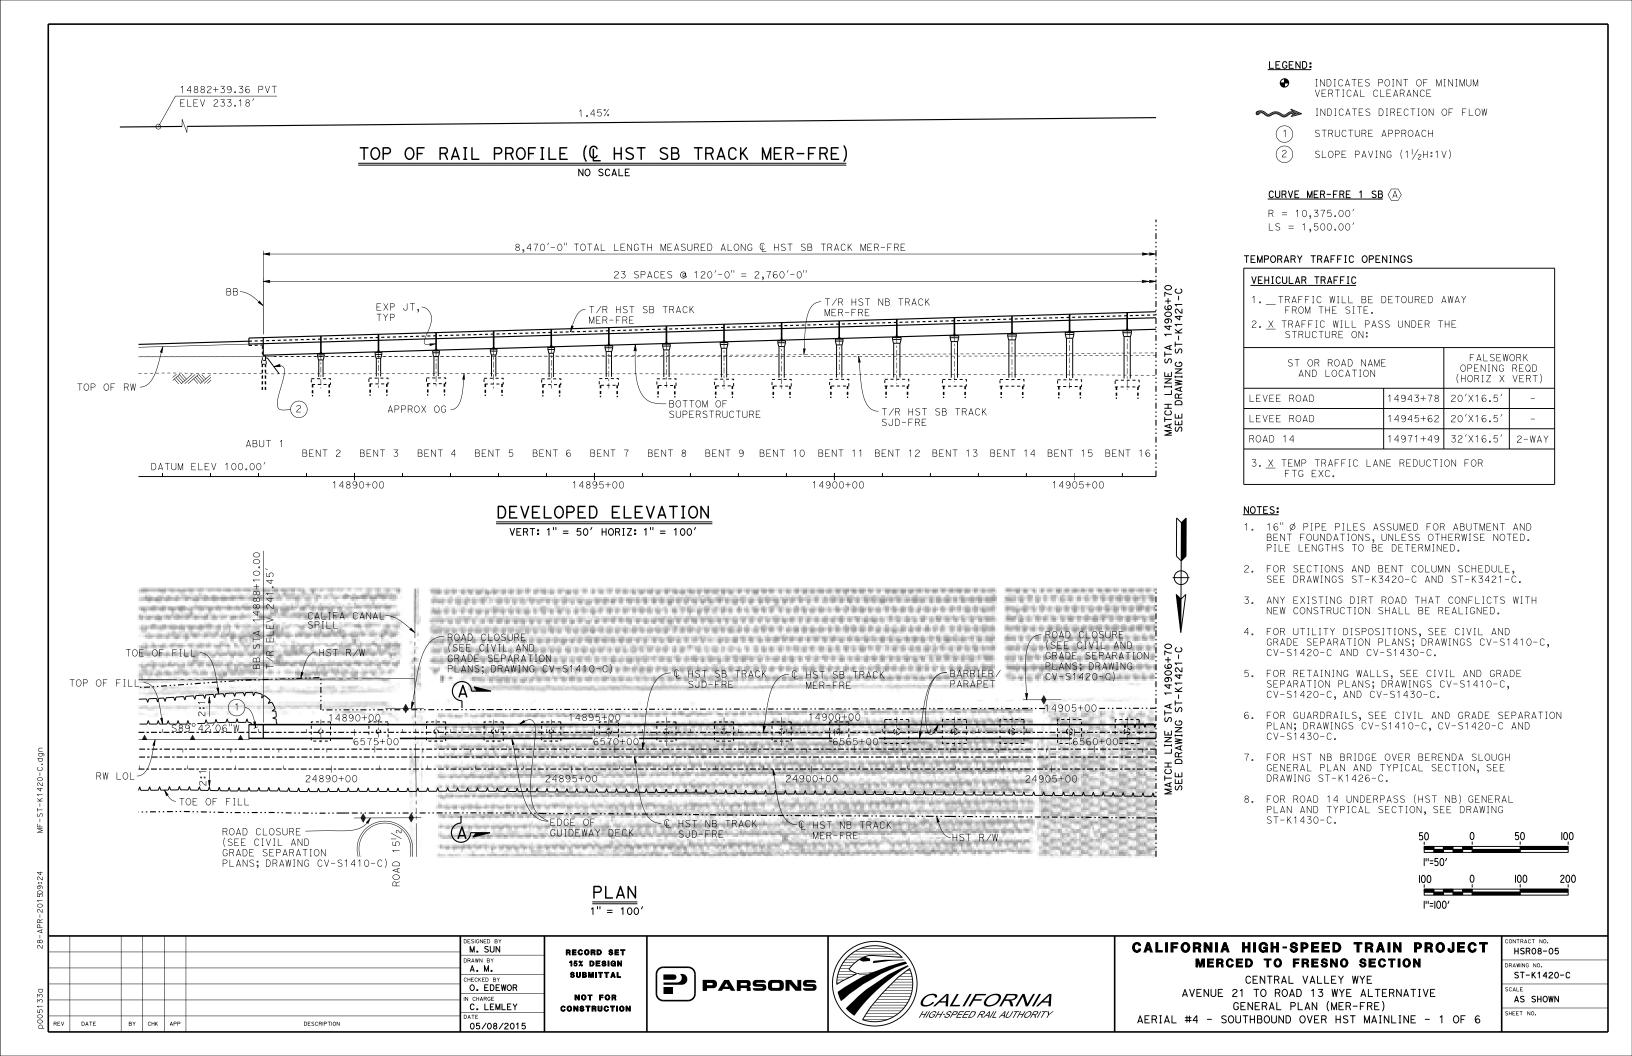

DEVELOPED ELEVATION

VERT: 1" = 50' HORIZ: 1" = 100'

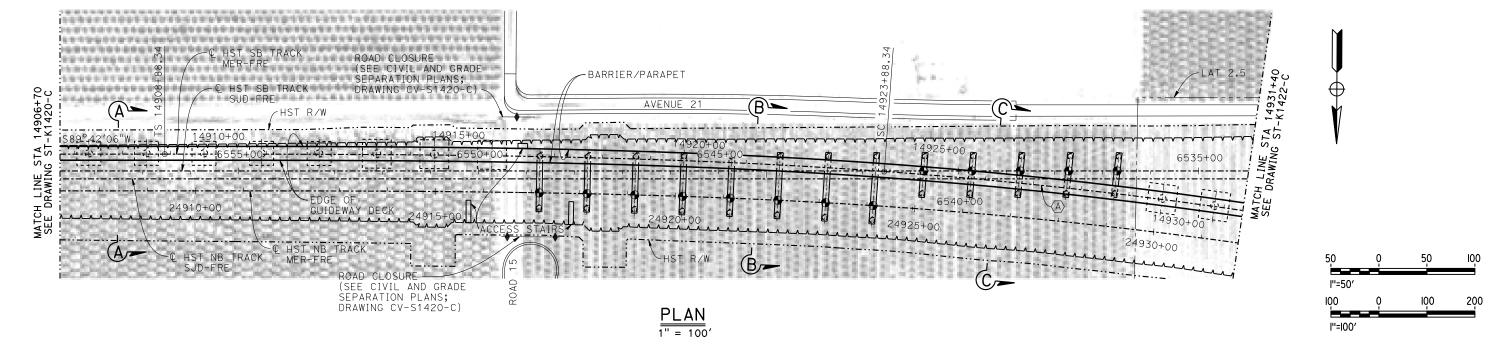

Ā								
8							DESIGNED BY M. SUN	
							DRAWN BY	
3G							CHECKED BY O. EDEWOR	
\sim							IN CHARGE C. LEMLEY	
poopl	REV	DATE	BY	СНК	APP	DESCRIPTION	DATE 05/08/2015	

RECORD SET
15% DESIGN
SUBMITTAL
NOT FOR
CONSTRUCTION





CALIFORNIA HIGH-SPEED TRAIN PROJECT MERCED TO FRESNO SECTION

CENTRAL VALLEY WYE

AVENUE 21 TO ROAD 13 WYE ALTERNATIVE


GENERAL PLAN (MER-FRE)

AERIAL #4 - SOUTHBOUND OVER HST MAINLINE - 2 OF 6


CONTRACT NO. HSR08-05
DRAWING NO. ST-K1421-C
AS SHOWN
SHEET NO.


2250.00′ VC R/C = -0.121%/STA

TOP OF RAIL PROFILE (HST SB TRACK MER-FRE) NO SCALE

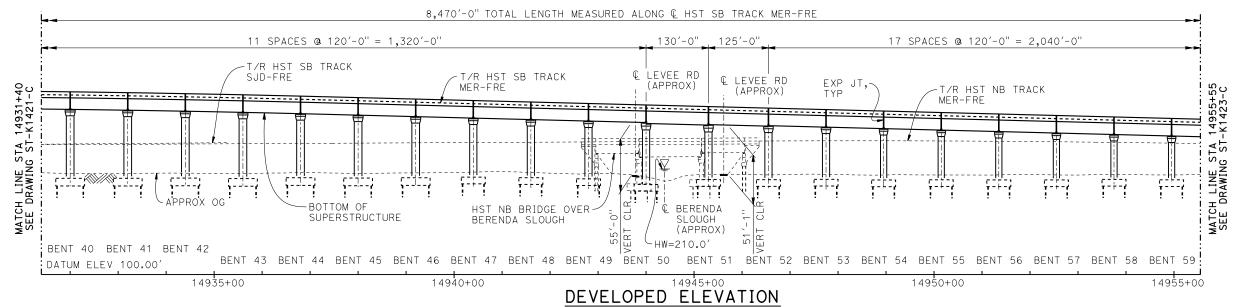

VERT: 1" = 50' HORIZ: 1" = 100'

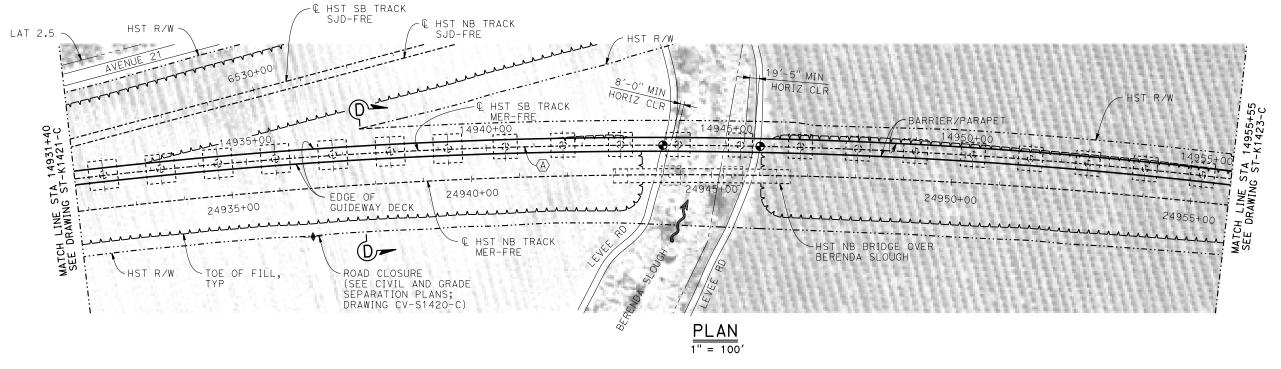

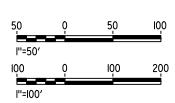

					DESIGNED BY M. SUN	
					DRAWN BY A. M.	
					CHECKED BY O. EDEWOR	
					IN CHARGE	_
					C. LEMLEY DATE	⊣ ՙ
REV	DATE	BY	CHK	APP	DESCRIPTION 05/08/2015	

RECORD SET 15% DESIGN SUBMITTAL NOT FOR CONSTRUCTION






CALIFORNIA HIGH-SPEED TRAIN PROJECT MERCED TO FRESNO SECTION


CENTRAL VALLEY WYE AVENUE 21 TO ROAD 13 WYE ALTERNATIVE GENERAL PLAN (MER-FRE) AERIAL #4 - SOUTHBOUND OVER HST MAINLINE - 3 OF 6

HSRO8-05
DRAWING NO. ST-K1422-C
AS SHOWN
SHEET NO.

TOP OF RAIL PROFILE (HST SB TRACK MER-FRE)

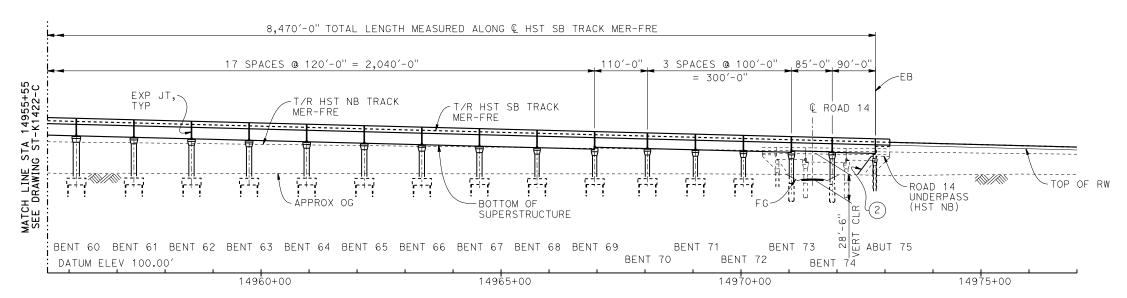

DEVELOPED ELEVATION

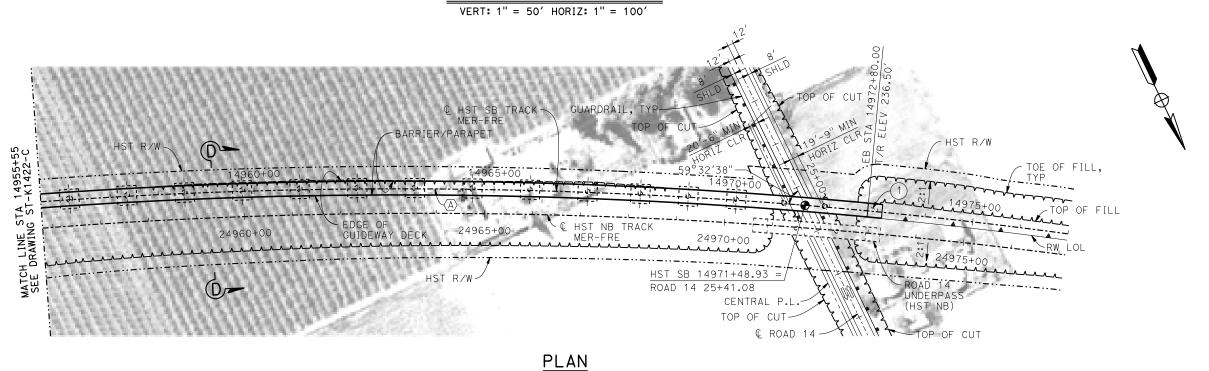

50	Q	50	100
l''=50'		,	
100	Q	IQ0	200
l"=I00′			

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0							DESIGNED BY M. SUN	
							DRAWN BY	
,							CHECKED BY O. EDEWOR	
)) 							IN CHARGE C. LEMLEY	(
200	REV	DATE	BY	СНК	APP	DESCRIPTION	DATE 05/08/2015	

RECORD SET
15% DESIGN
SUBMITTAL
NOT FOR
CONSTRUCTION



1" = 100'



CALIFORNIA HIGH-SPEED TRAIN PROJECT MERCED TO FRESNO SECTION


CENTRAL VALLEY WYE


AVENUE 21 TO ROAD 13 WYE ALTERNATIVE


GENERAL PLAN (MER-FRE)


AERIAL #4 - SOUTHBOUND OVER HST MAINLINE - 4 OF 6


CONTRACT NO. HSR08-05
DRAWING NO. ST-K1423-C
AS SHOWN
SHEET NO.

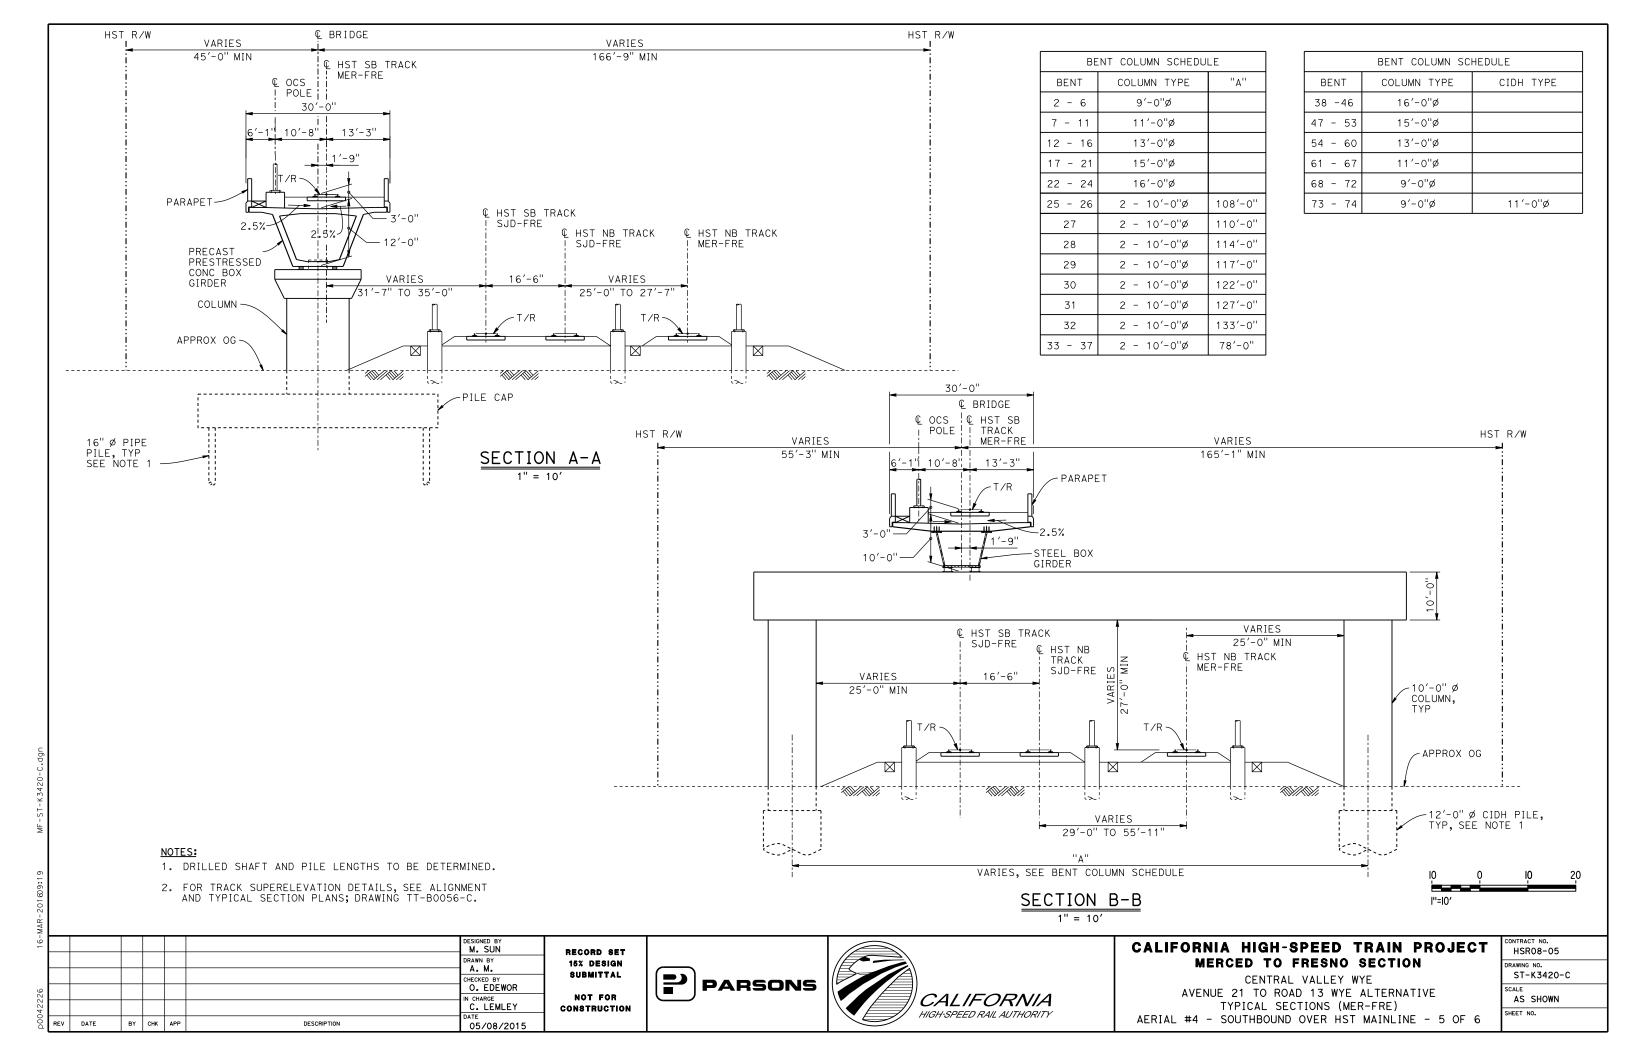


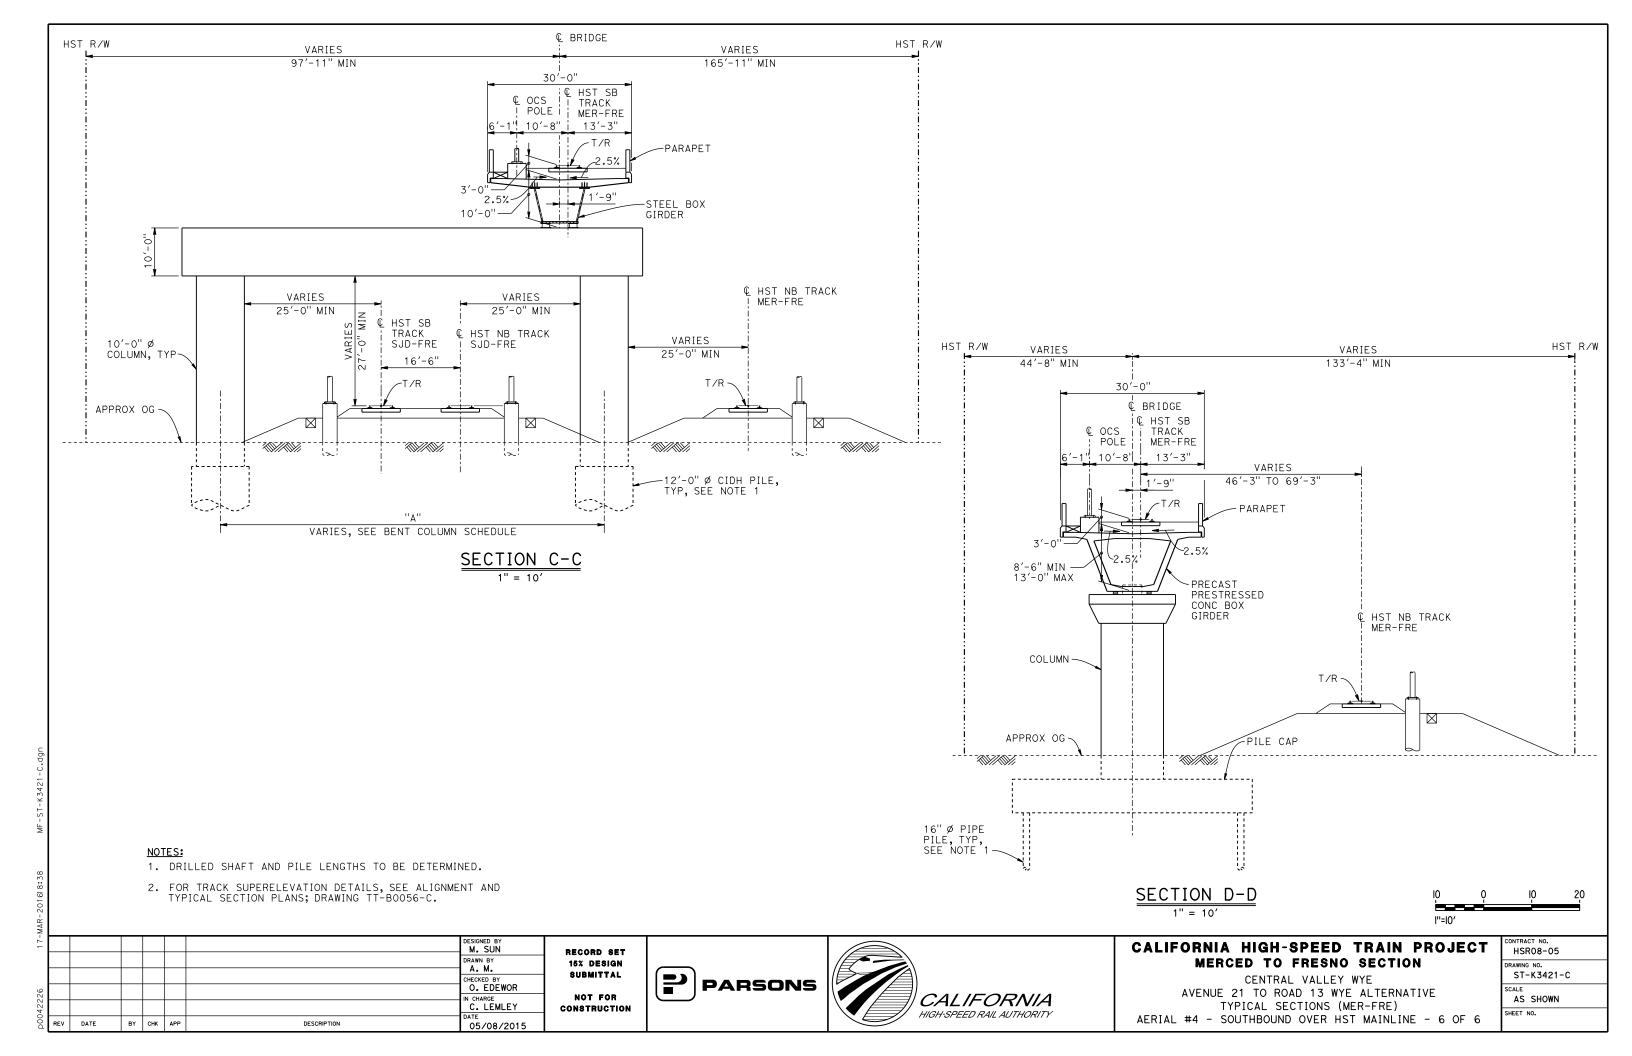


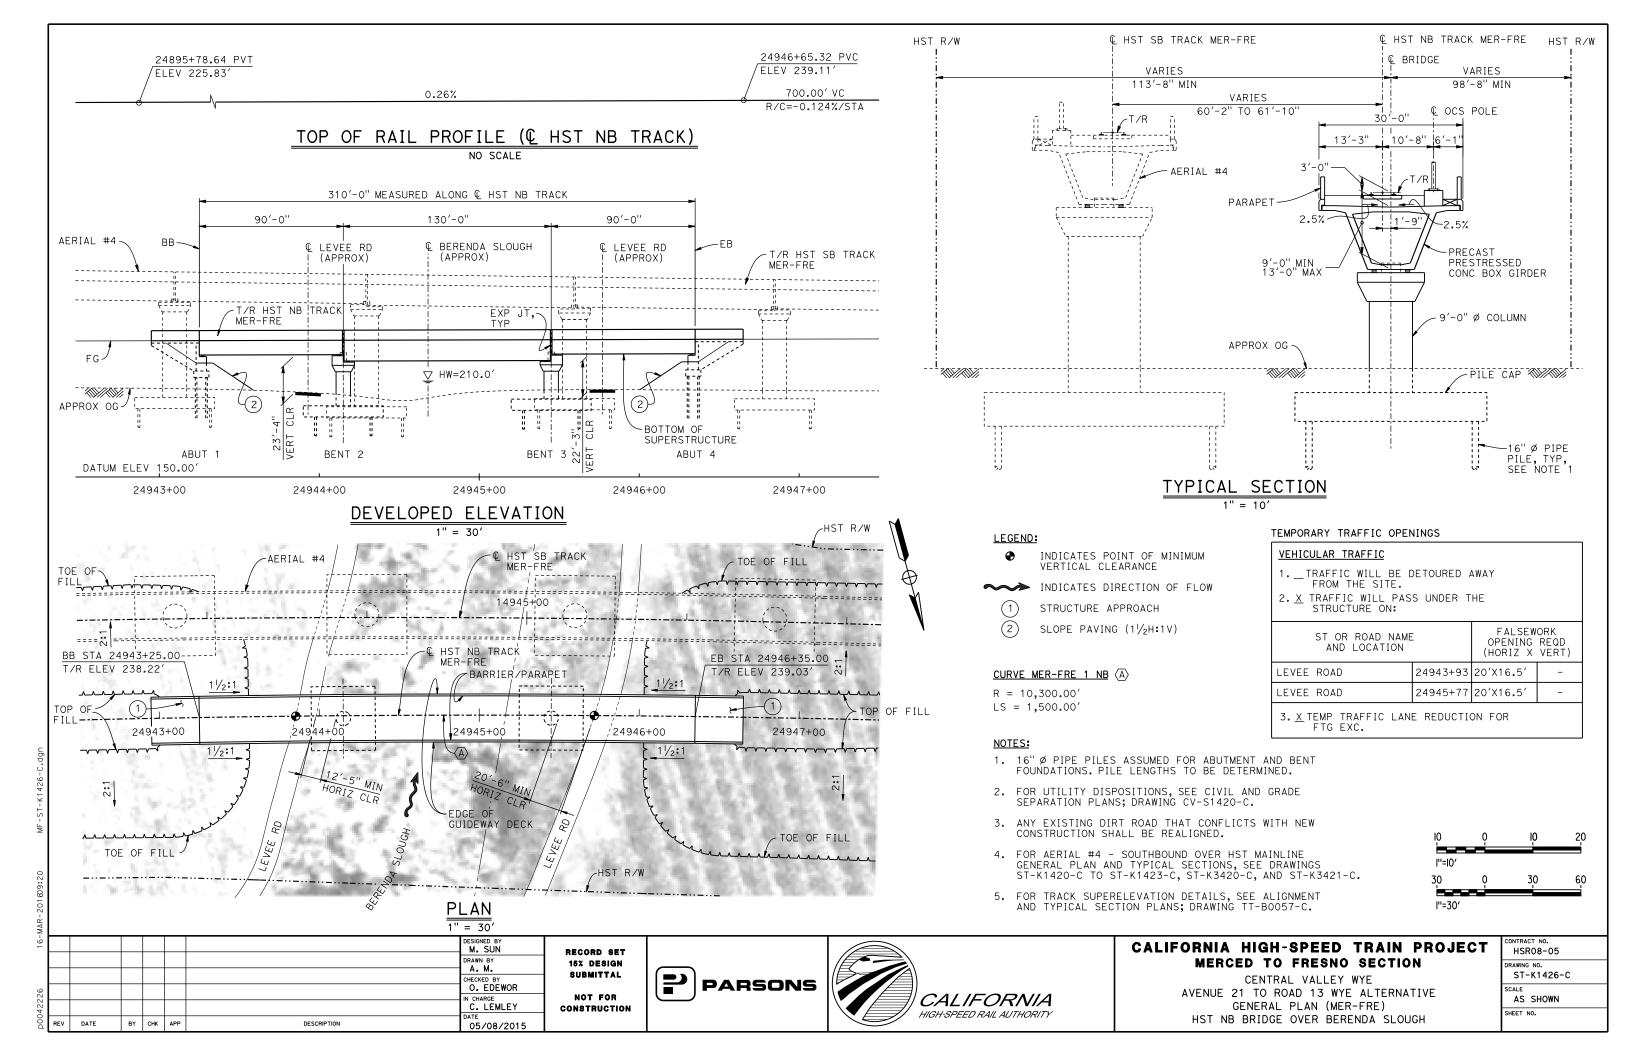


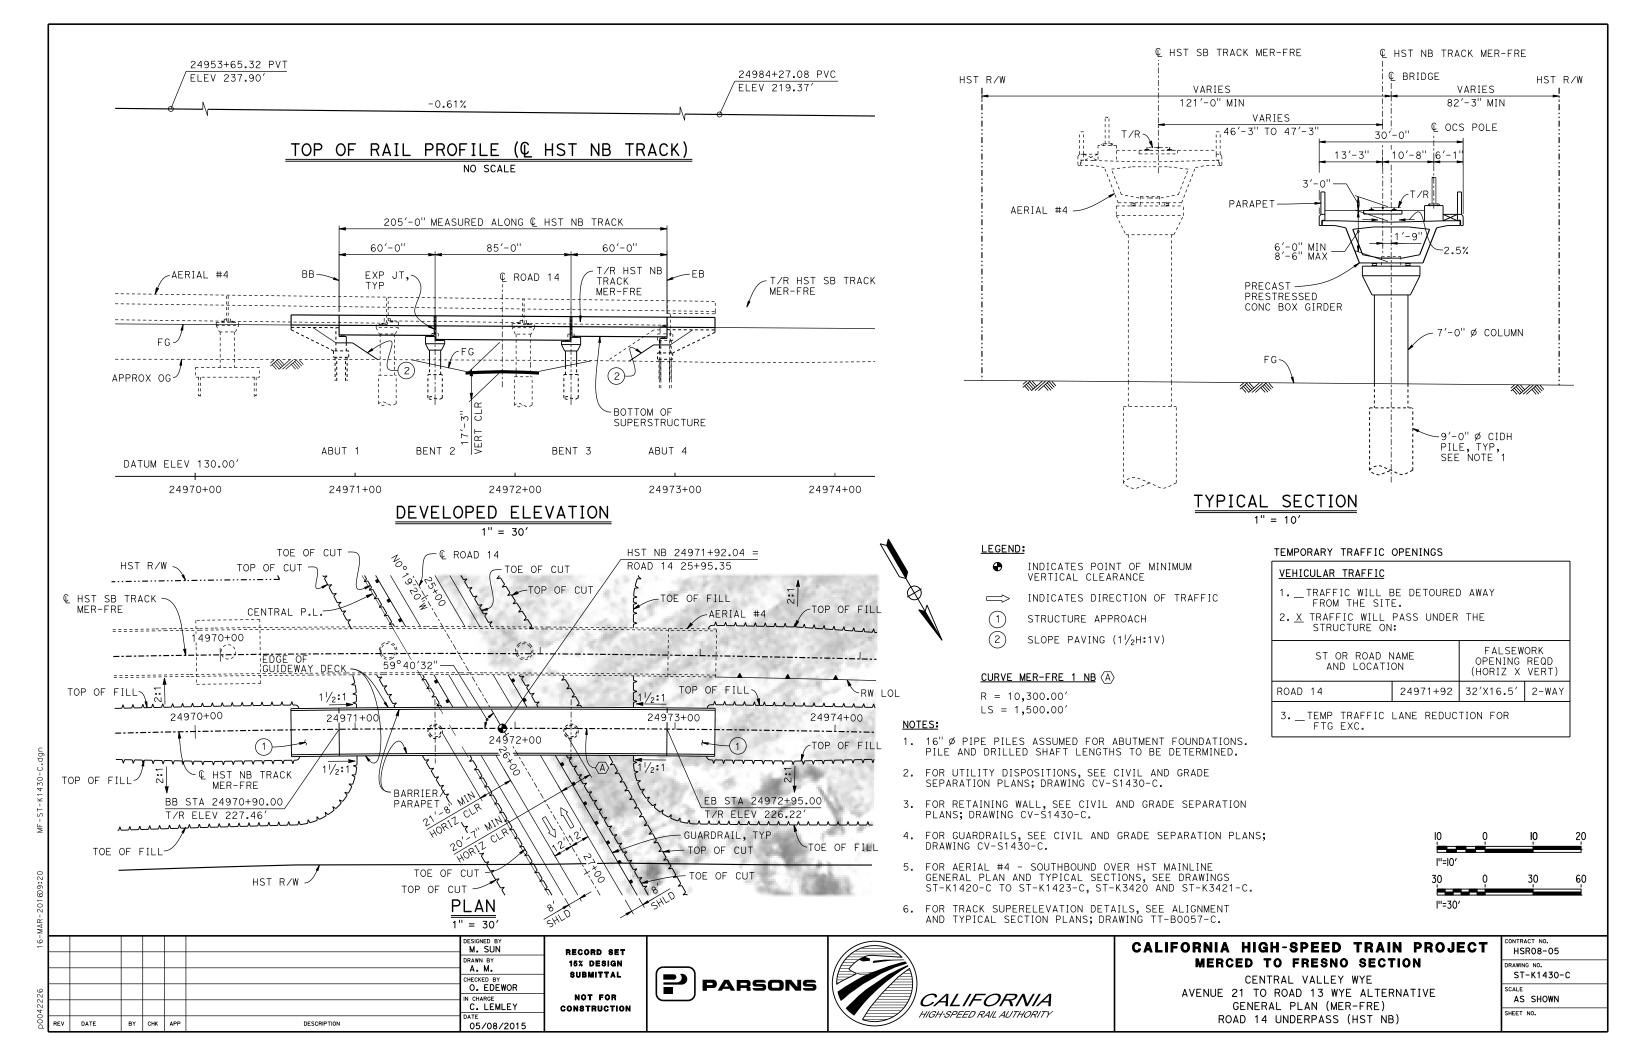


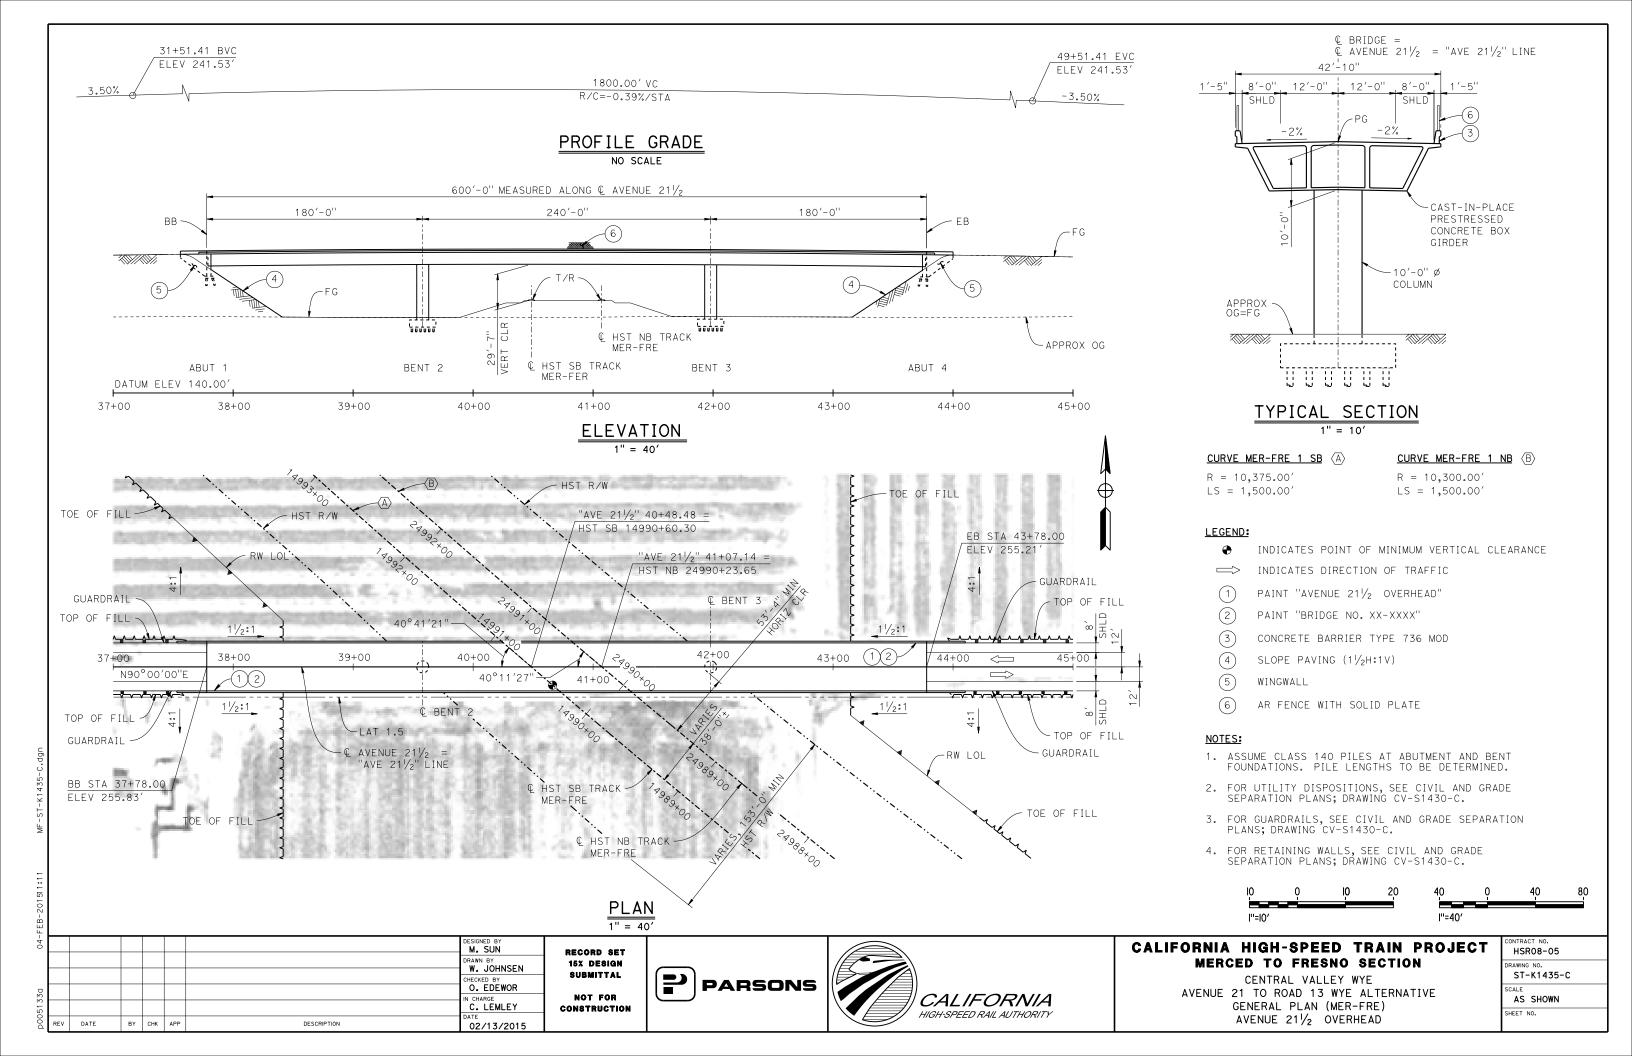

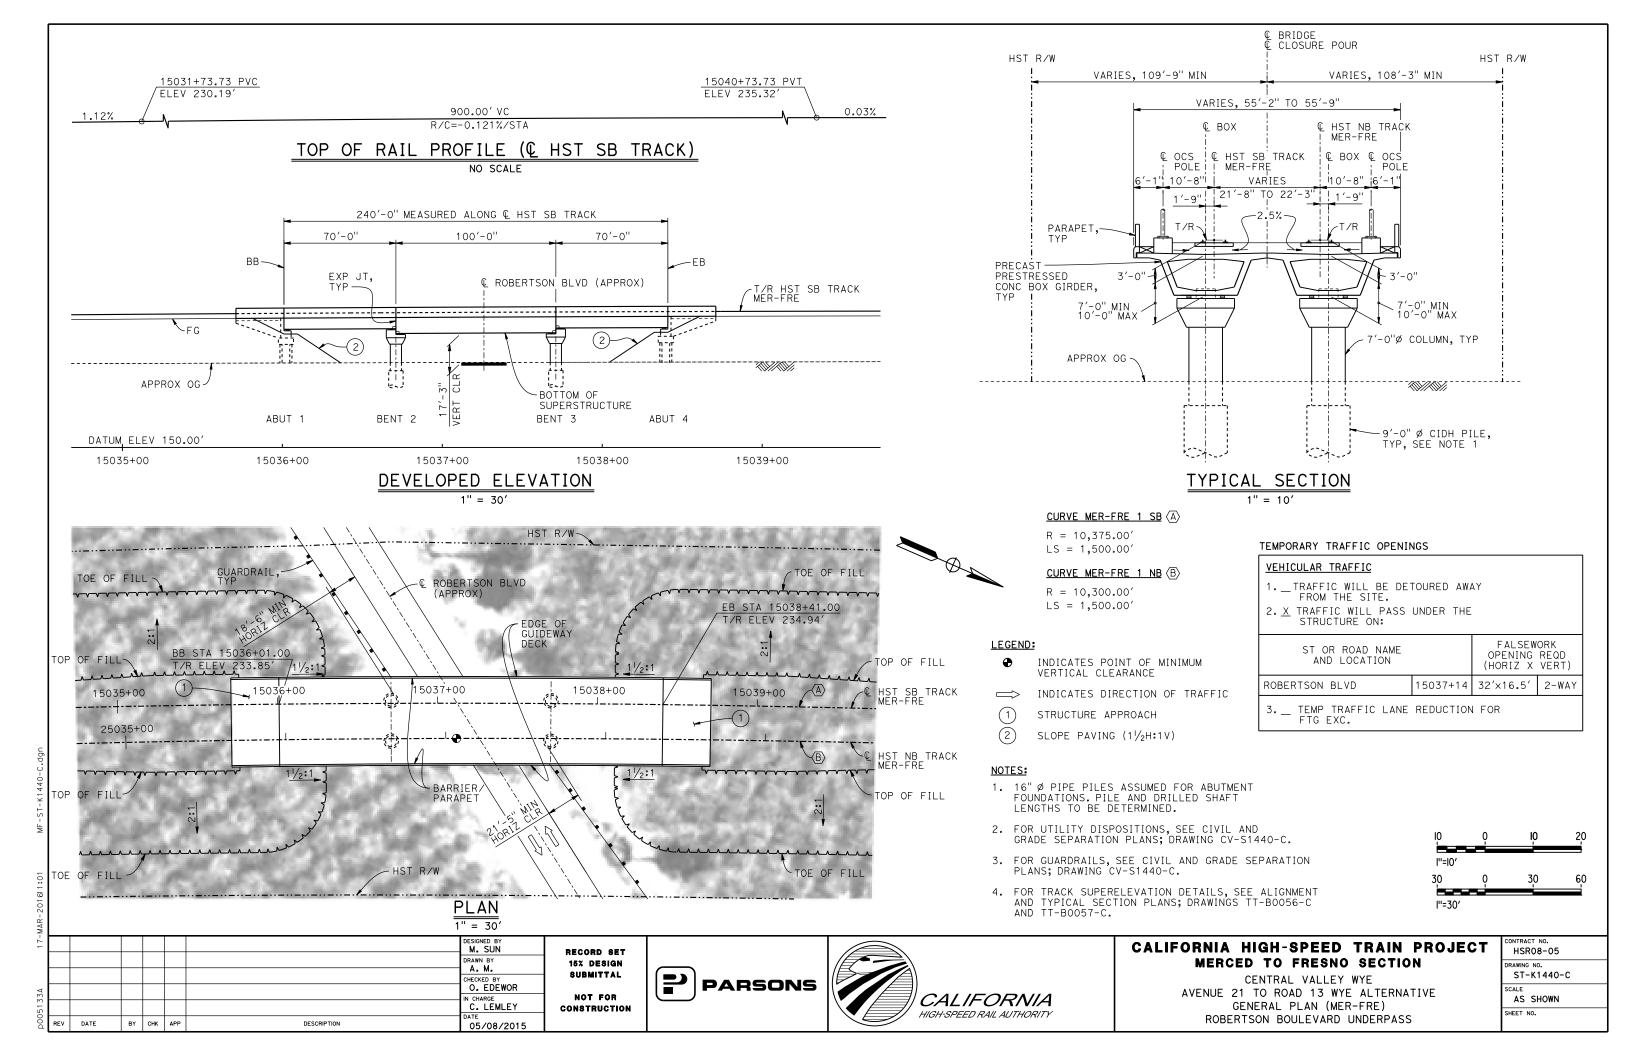

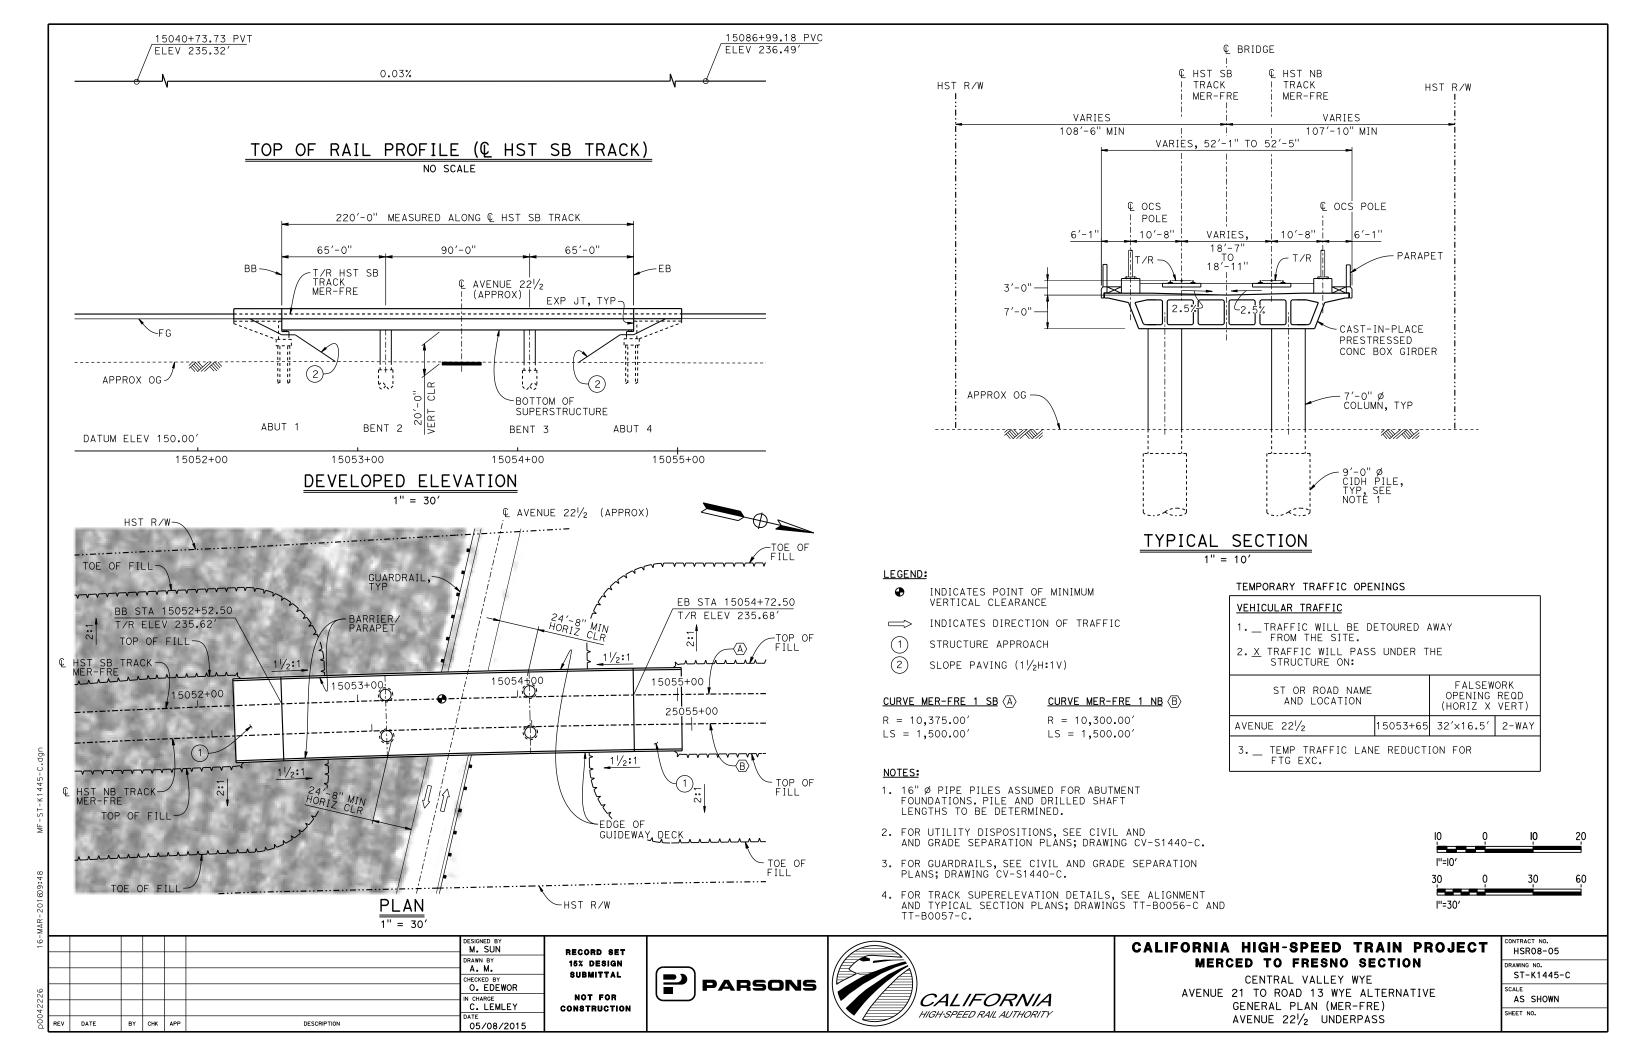

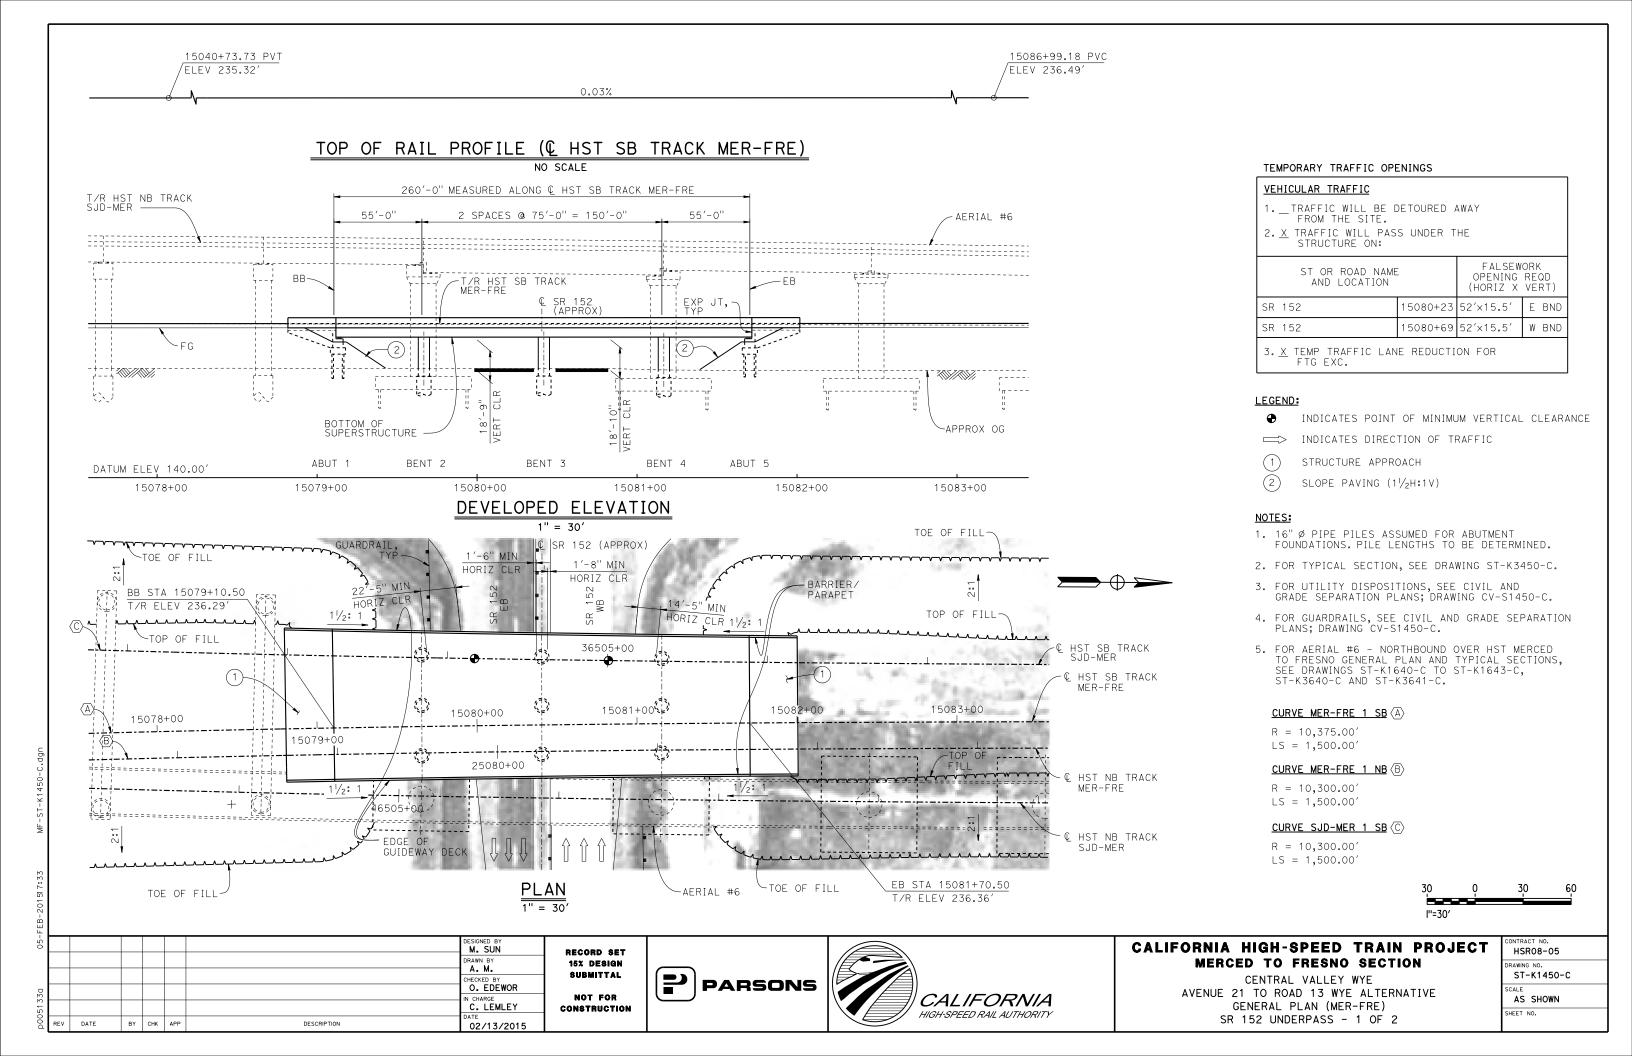

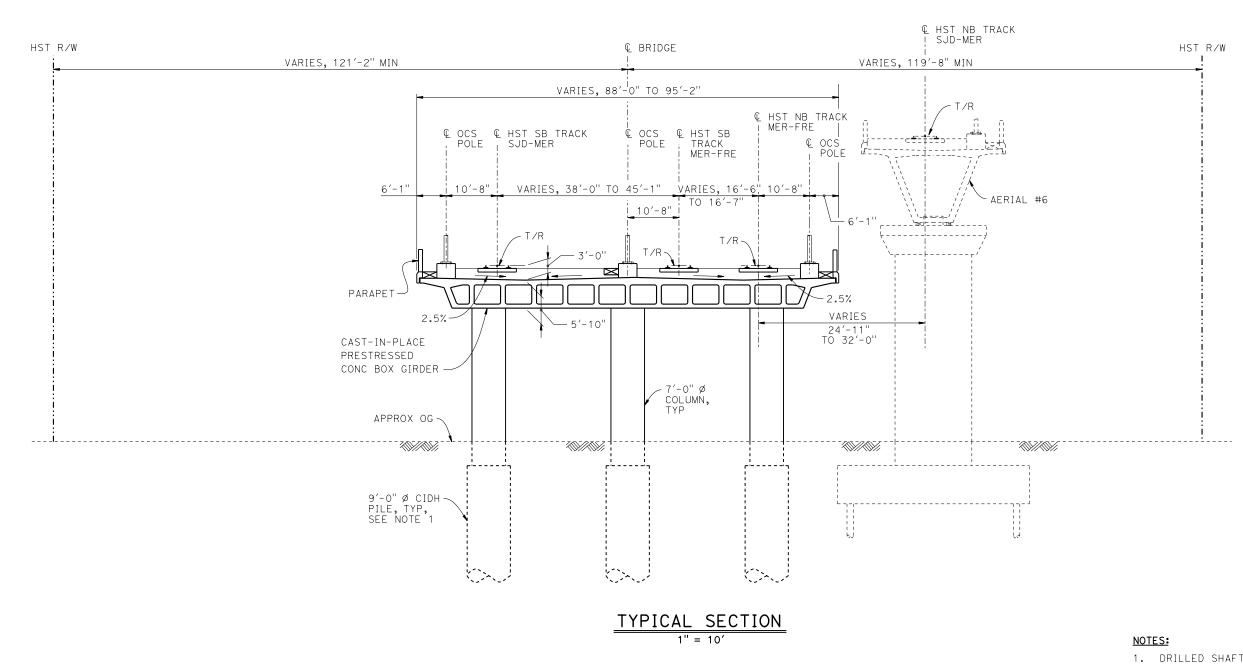

- 1. DRILLED SHAFT LENGTHS TO BE DETERMINED.
- 2. FOR TRACK SUPERELEVATION DETAILS, SEE ALIGNMENT AND TYPICAL SECTION PLANS; DRAWINGS TT-B0056-C AND TT-B0057-C.



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28-							DESIGNED BY M. SUN	
							DRAWN BY	
							CHECKED BY	
330							O. EDEWOR	
21							C. LEMLEY	C.
D00	REV	DATE	BY	CHK	APP	DESCRIPTION	05/08/2015	

RECORD SET
15% DESIGN
SUBMITTAL
NOT FOR
CONSTRUCTION








CALIFORNIA HIGH-SPEED TRAIN PROJECT MERCED TO FRESNO SECTION

CENTRAL VALLEY WYE
AVENUE 21 TO ROAD 13 WYE ALTERNATIVE
TYPICAL SECTION (MER-FRE)
SR 152 UNDERPASS - 2 OF 2

CONTRACT NO. HSR08-05
DRAWING NO.
ST-K3450-C
SCALE
AS SHOWN
SHEET NO.

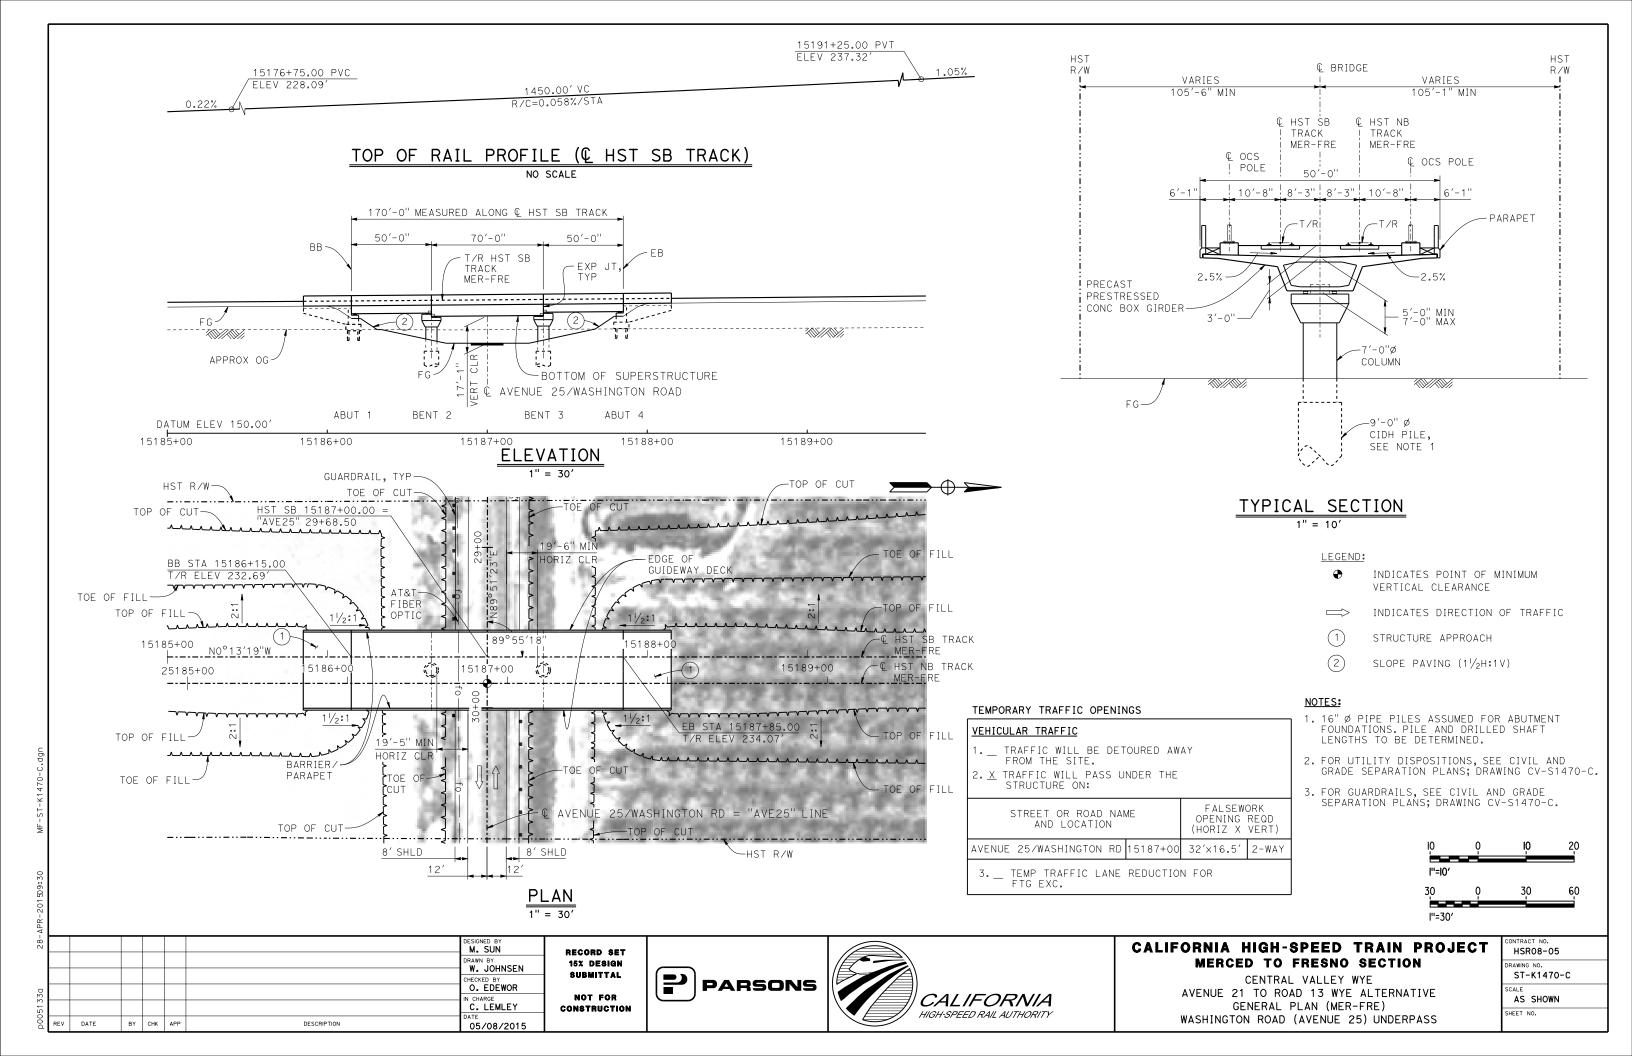

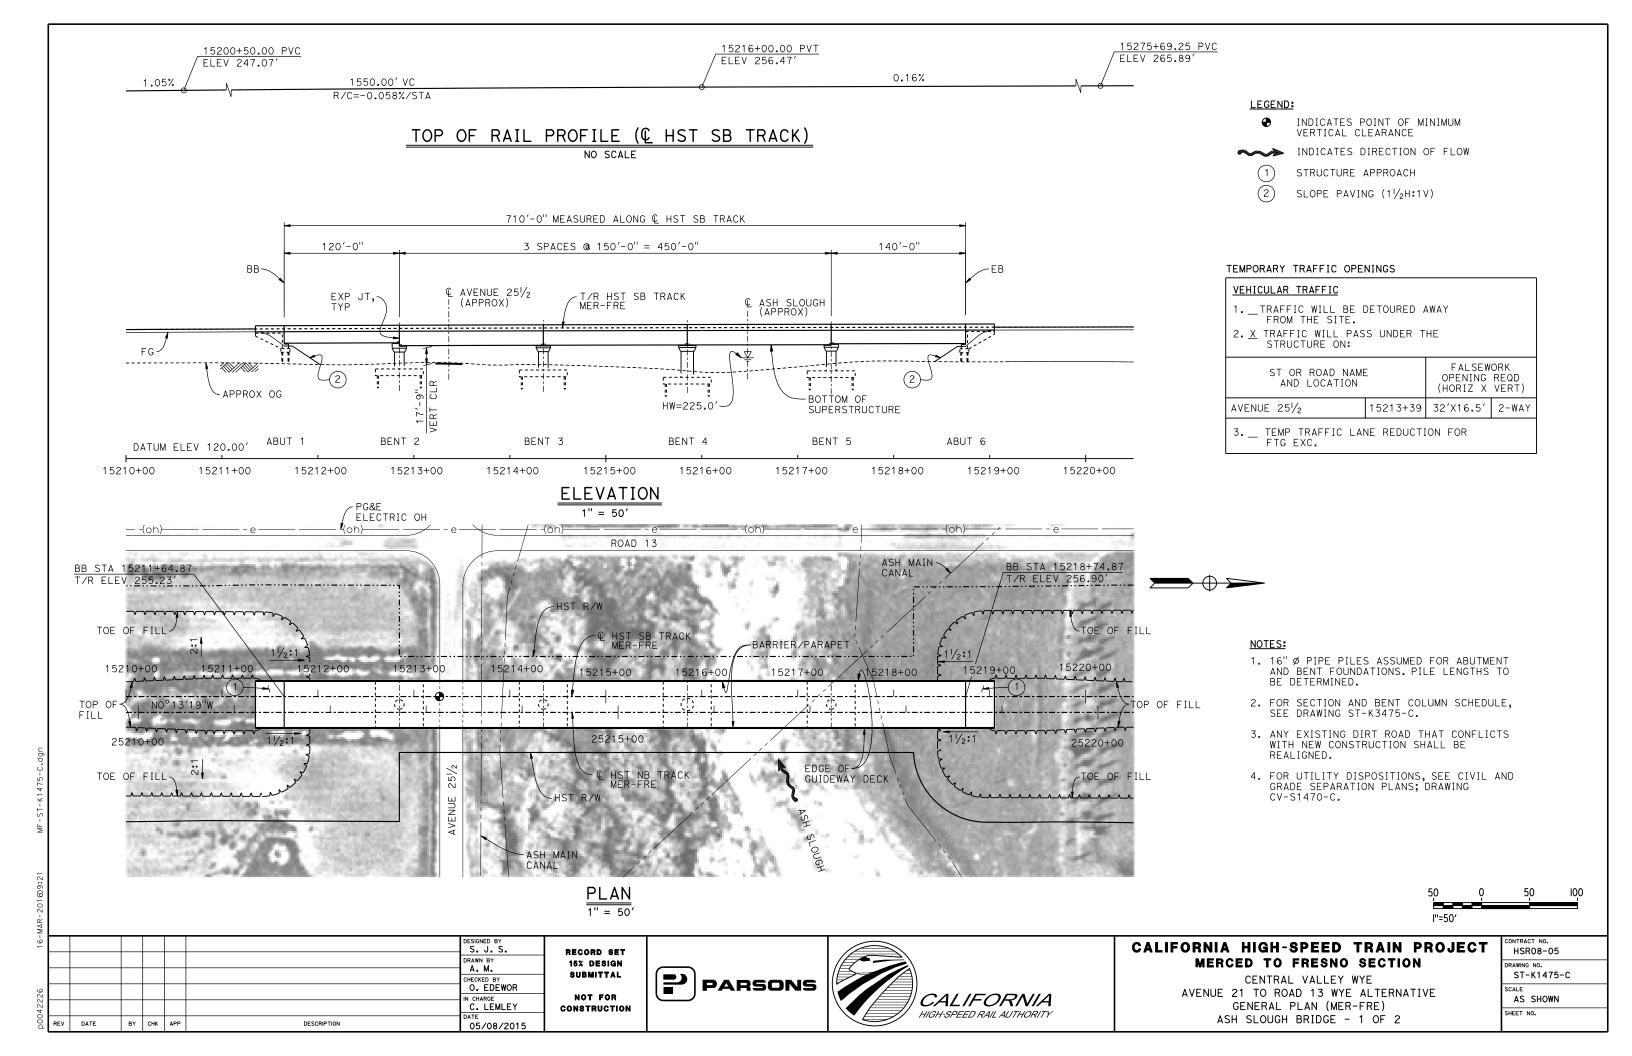

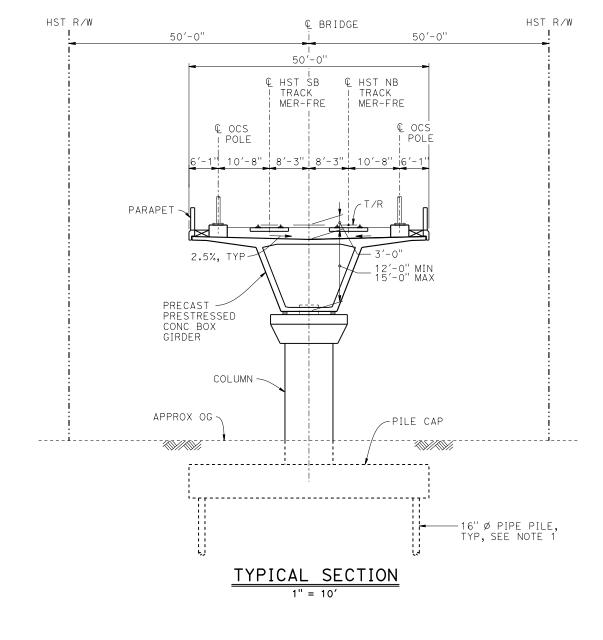

BENT C	OLUMN SCHEDULE		
BENT	COLUMN TYPE		
2 - 3	10′-0''ø		
4	13'-0"Ø		
5	10'-0"Ø		

NOTES:

1. PILE LENGTHS TO BE DETERMINED.



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-50							DESIGNED BY S. J. S.	
							DRAWN BY A. M.	
_							CHECKED BY O. EDEWOR	
51330							IN CHARGE C. LEMLEY	c
p0051	REV	DATE	BY	СНК	APP	DESCRIPTION	DATE 02/13/2015	

RECORD SET
15% DESIGN
SUBMITTAL
NOT FOR
CONSTRUCTION






CALIFORNIA HIGH-SPEED TRAIN PROJECT MERCED TO FRESNO SECTION

CENTRAL VALLEY WYE
AVENUE 21 TO ROAD 13 WYE ALTERNATIVE
TYPICAL SECTION (MER-FRE)
ASH SLOUGH BRIDGE - 2 OF 2

CONTRACT NO.
HSR08-05
DRAWING NO.
ST-K3475-C
SCALE
AS SHOWN
SHEET NO.

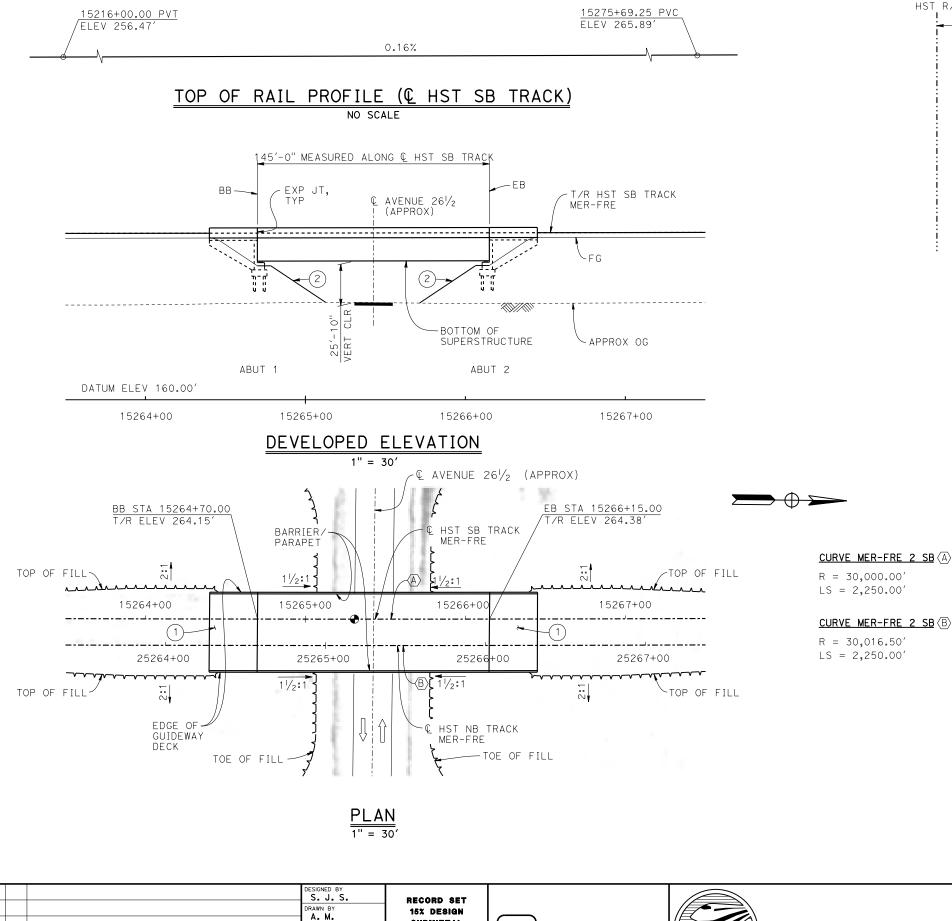

SUBMITTAL

NOT FOR

CONSTRUCTION

O. EDEWOR


N CHARGE
C. LEMLEY

05/08/2015

DATE

BY CHK APP

DESCRIPTION

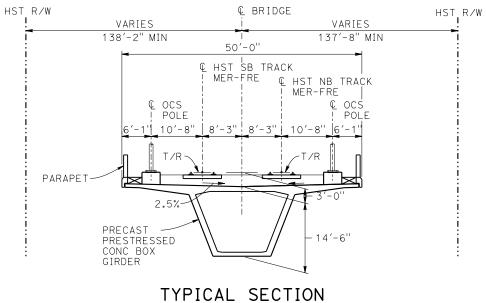

LEGEND:


- INDICATES POINT OF MINIMUM VERTICAL CLEARANCE
- (1) STRUCTURE APPROACH
- (2) SLOPE PAVING $(1\frac{1}{2}H:1V)$

TEMPORARY TRAFFIC OPENINGS

<u>VEHICULAR TRAFFIC</u>							
1TRAFFIC WILL BE DETOURED AWAY FROM THE SITE.							
2. X TRAFFIC WILL PASS UNDER THE STRUCTURE ON:							
ST OR ROAD NAME AND LOCATION	FALSEW OPENING (HORIZ X	REQD					
AVENUE 261/2	15265+43	32′X16.5′	2-WAY				
3TEMP TRAFFIC LANE REDUCTION FOR FTG EXC.							

NOTES:

- 16" Ø PIPE PILES ASSUMED FOR ABUTMENT FOUNDATIONS. PILE LENGTHS TO BE DETERMINED.
- 2. ANY EXISTING DIRT ROAD THAT CONFLICTS WITH NEW CONSTRUCTION SHALL BE REALIGNED.
- 3. FOR UTILITY DISPOSITIONS, SEE CIVIL AND GRADE SEPARATION PLANS; DRAWING CV-S1480-C.
- 4. FOR TRACK SUPERELEVATION DETAILS, SEE ALIGNMENT AND TYPICAL SECTION PLANS; DRAWINGS TT-B0056-C AND TT-B0057-C.

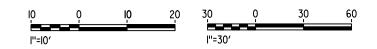

PARSONS

CALIFORNIA


HIGH-SPEED RAIL AUTHORITY


CALIFORNIA HIGH-SPEED TRAIN PROJECT MERCED TO FRESNO SECTION

CENTRAL VALLEY WYE

AVENUE 21 TO ROAD 13 WYE ALTERNATIVE
GENERAL PLAN (MER-FRE)
AVENUE 26½ UNDERPASS

HSR08-05
DRAWING NO. ST-K1480-C
AS SHOWN
SHEET NO.

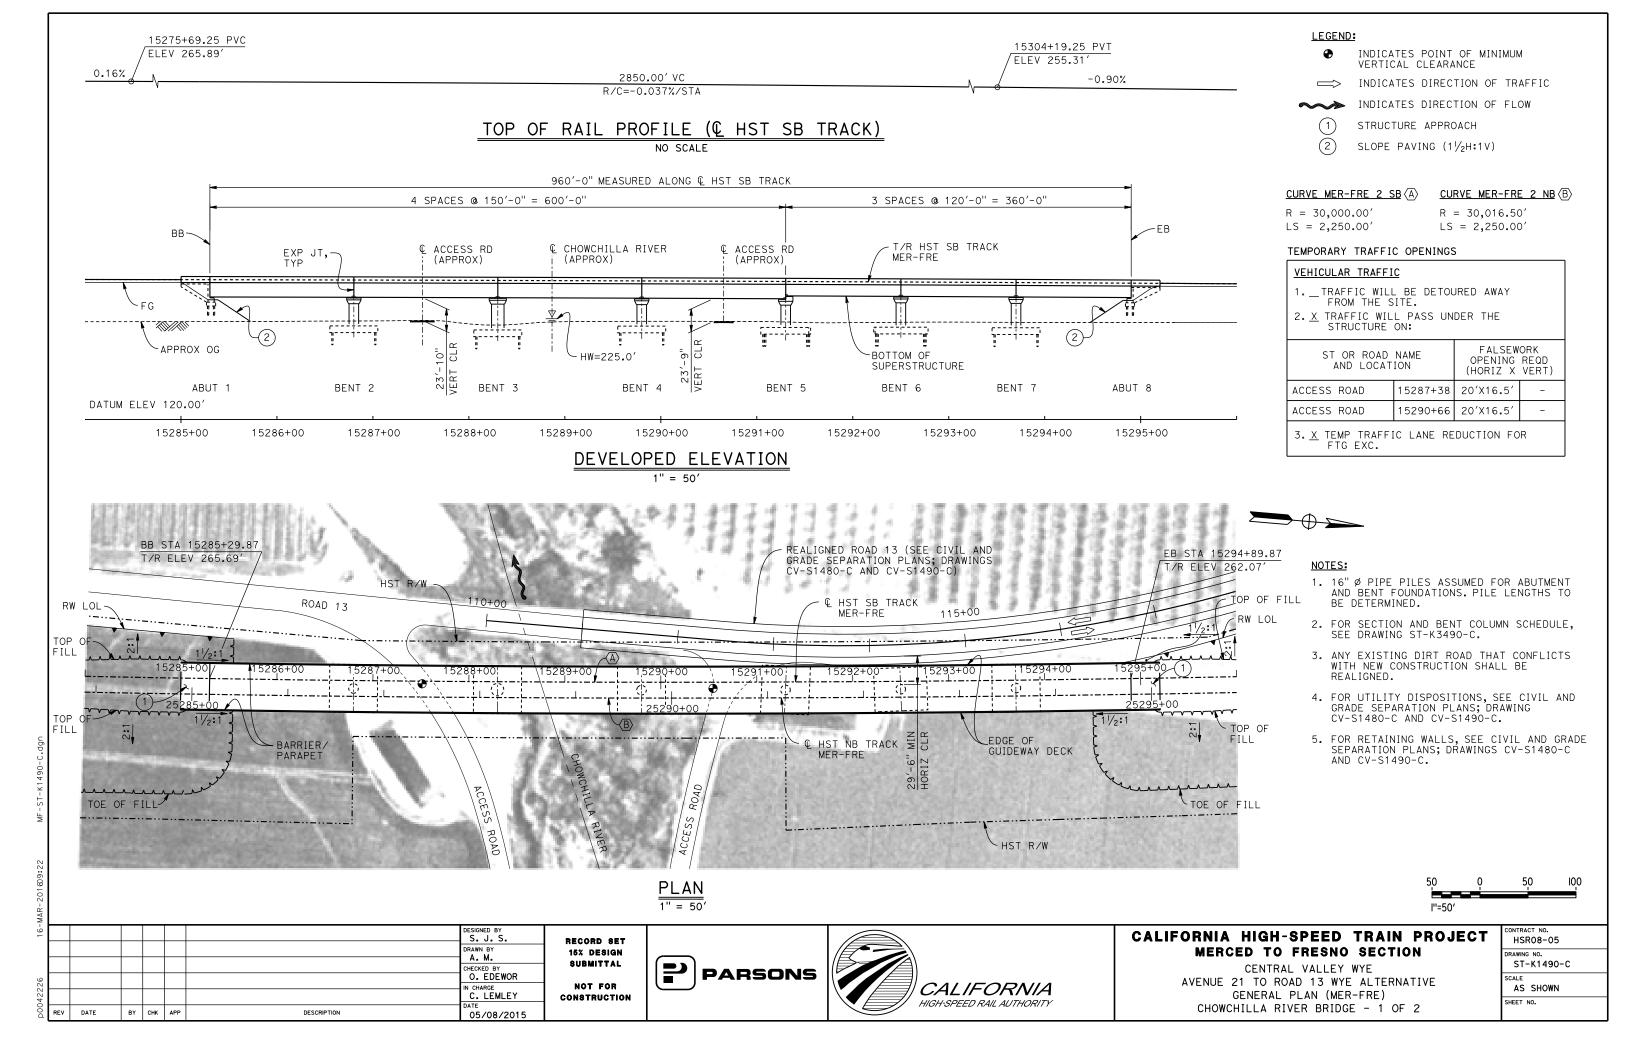

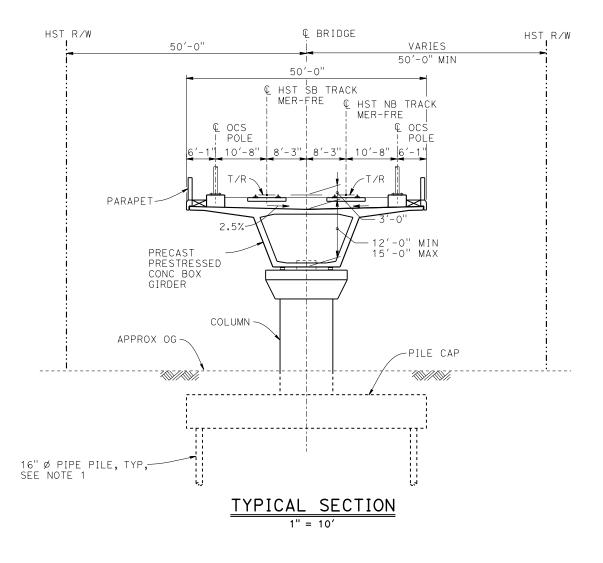

NOTES:

- 1. PILE LENGTHS TO BE DETERMINED.
- 2. FOR TRACK SUPERELEVATION DETAILS, SEE ALIGNMENT AND TYPICAL SECTION PLANS; DRAWINGS TT-B0056-C AND TT-B0057-C.



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-50							DESIGNED BY S. J. S.	
							DRAWN BY A. M.	1
_							CHECKED BY O. EDEWOR	İ
5133a							IN CHARGE C. LEMLEY	۱ ,
p006	REV	DATE	BY	СНК	APP	DESCRIPTION	DATE 02/13/2015	

RECORD SET
15% DESIGN
SUBMITTAL
NOT FOR
CONSTRUCTION






CALIFORNIA HIGH-SPEED TRAIN PROJECT MERCED TO FRESNO SECTION

CENTRAL VALLEY WYE

AVENUE 21 TO ROAD 13 WYE ALTERNATIVE

TYPICAL SECTION (MER-FRE)

CHOWCHILLA RIVER BRIDGE - 2 OF 2

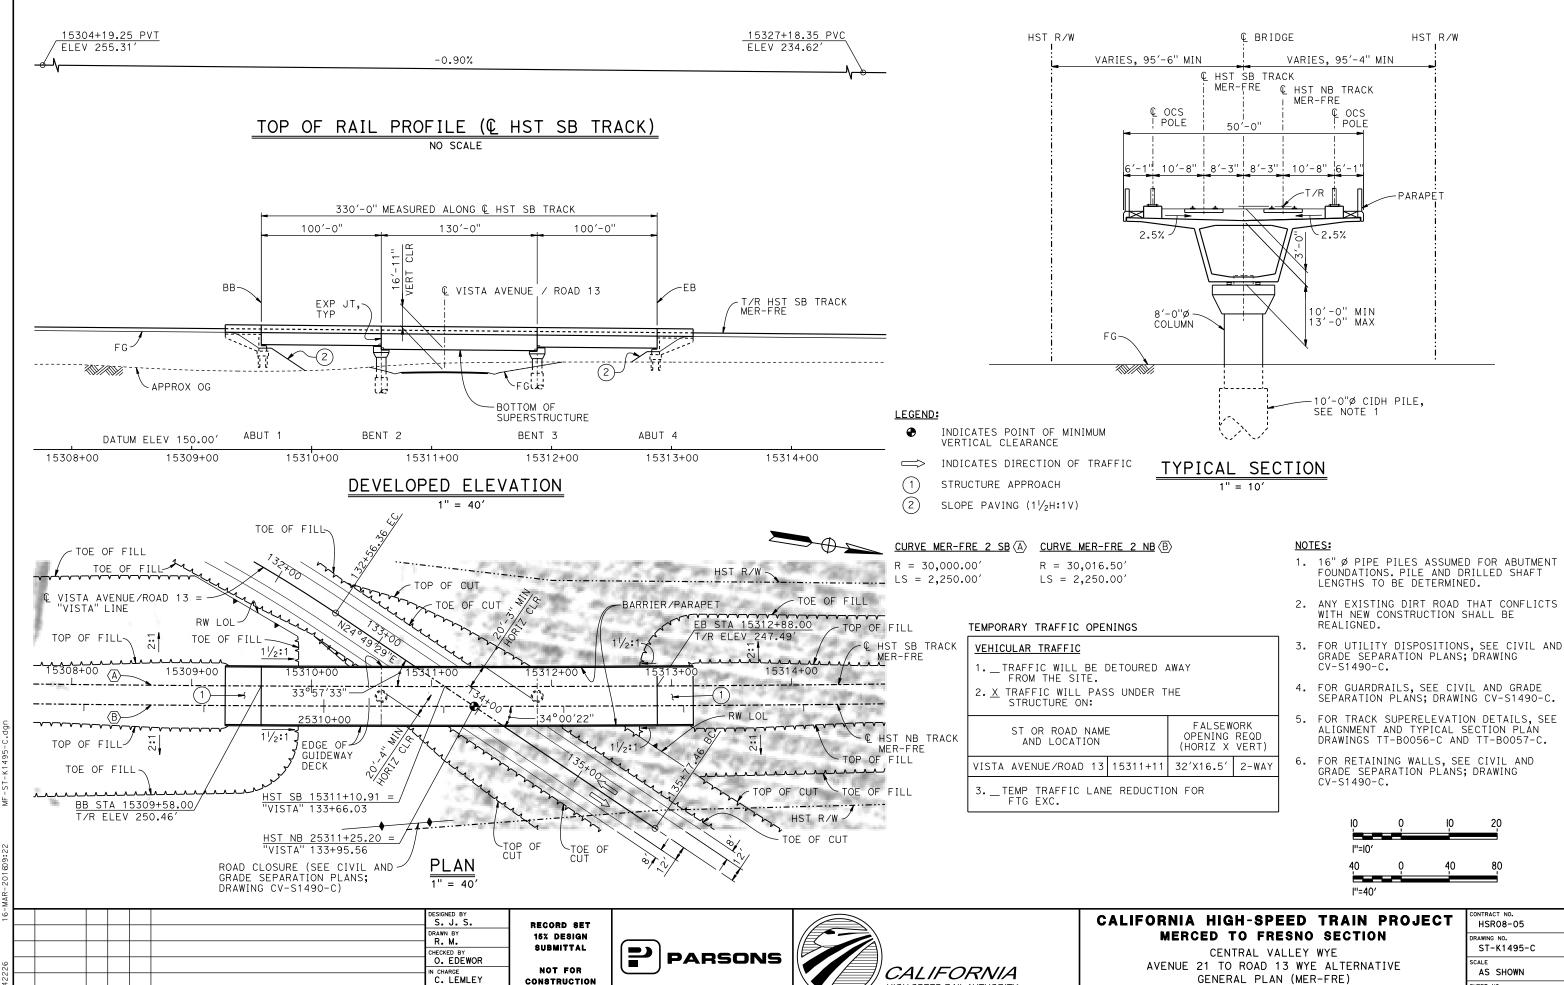

HIGH-SPEED RAIL AUTHORITY

CONSTRUCTION

05/08/2015


DATE

BY CHK APP

DESCRIPTION


GENERAL PLAN (MER-FRE) VISTA AVENUE (ROAD 13) UNDERPASS

AS SHOWN SHEET NO.

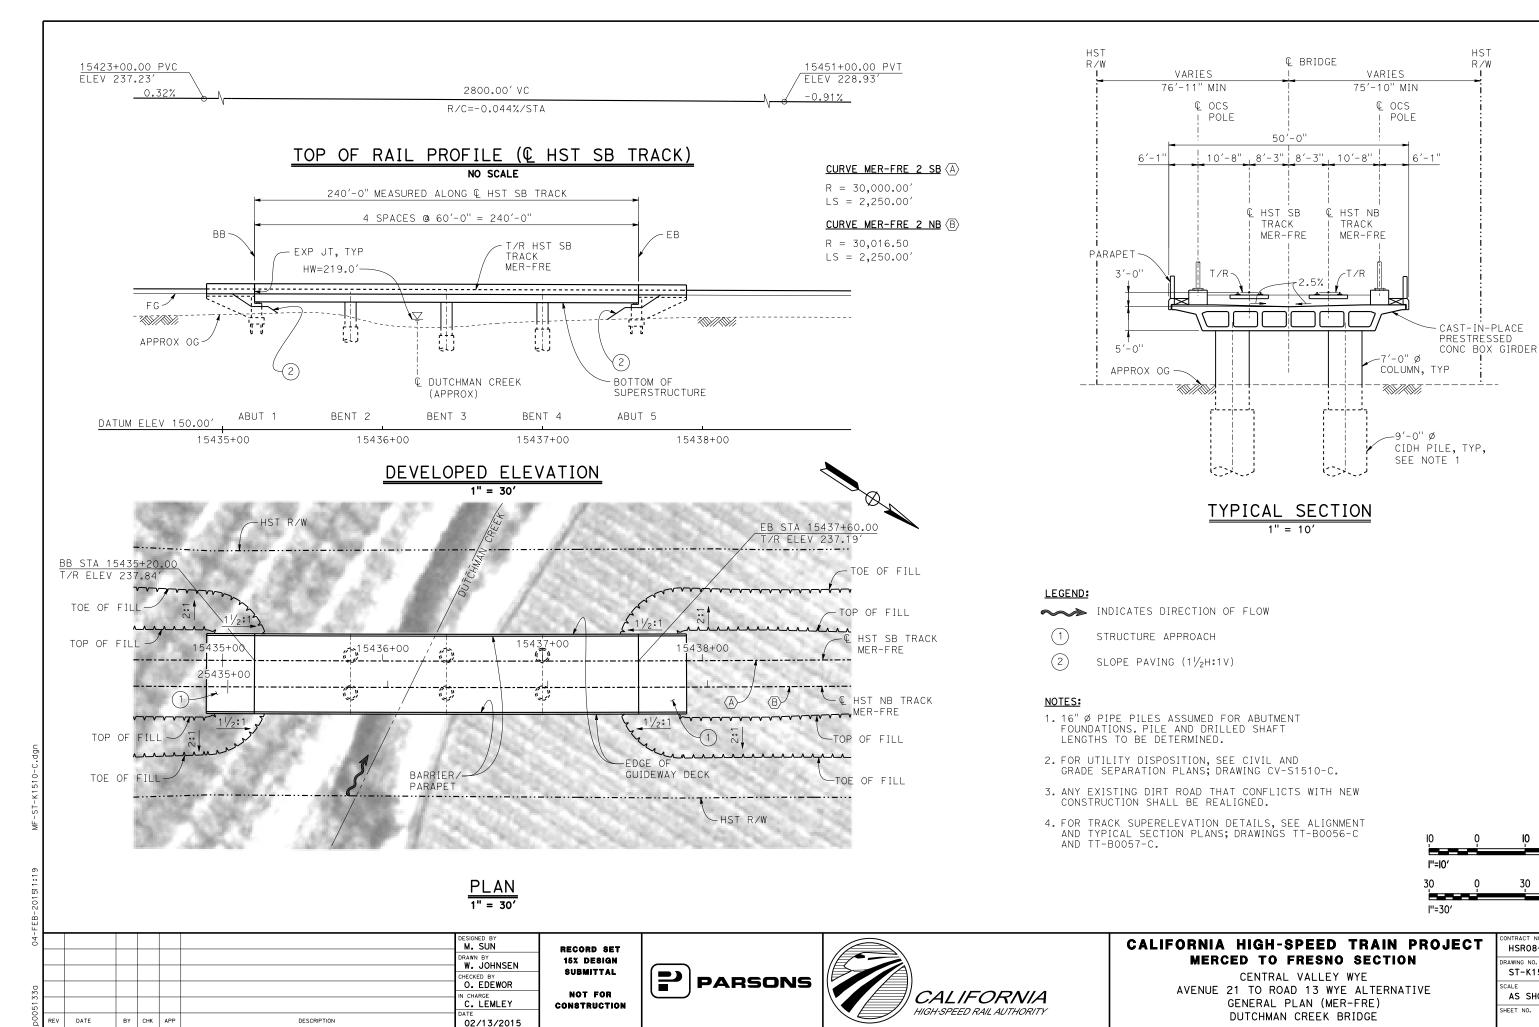



HSR08-05 ST-K1510-C AS SHOWN SHEET NO.


30

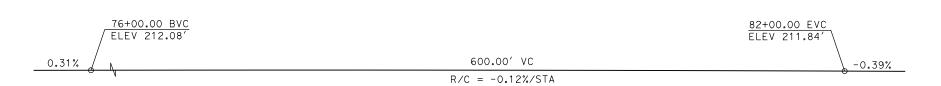

PROFILE GRADE NO SCALE

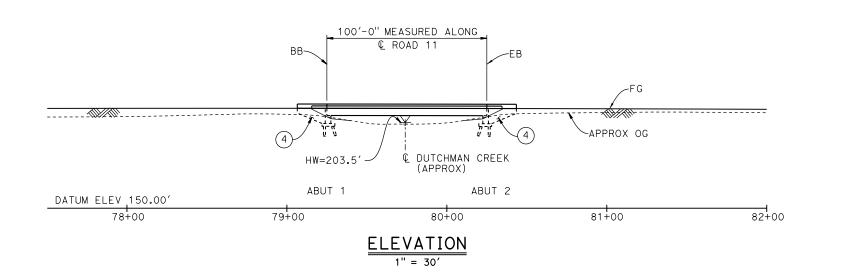

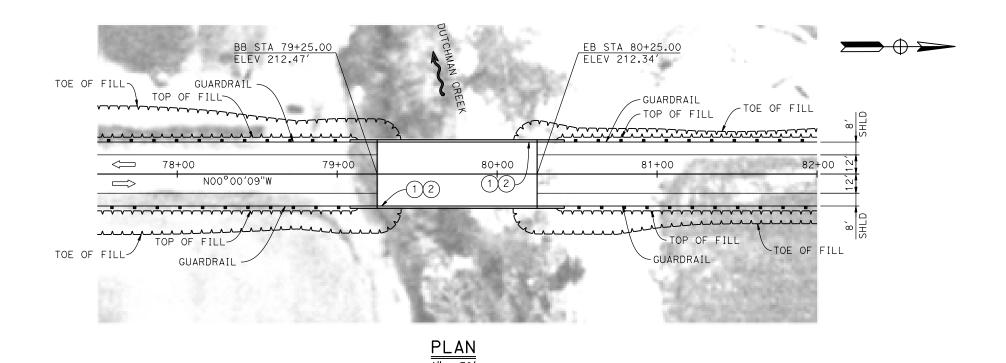

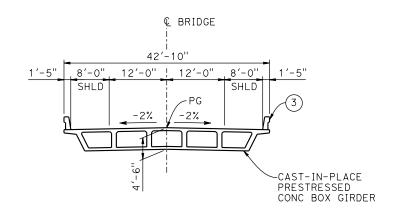

TYPICAL SECTION

LEGEND:

➤ INDICATES DIRECTION OF FLOW

(1) PAINT "ROAD 11 BRIDGE"


2 PAINT "BRIDGE NO. XX-XXXX"

(3) CONCRETE BARRIER TYPE 732

(4) WINGWALL

NOTES:

- 1. ASSUME CLASS 140 PILES AT ABUTMENT AND BENT FOUNDATIONS. PILE LENGTHS TO BE DETERMINED.
- 2. FOR UTILITY DISPOSITIONS, SEE CIVIL AND GRADE SEPARATION PLANS; DRAWING CV-R1512-C.
- 3. FOR GUARDRAILS, SEE CIVIL AND GRADE SEPARATION PLANS; DRAWING CV-R1512-C.

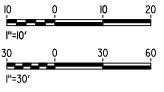

MA								
10-							DESIGNED BY	
							DRAWN BY	•
3A							CHECKED BY K. CHARAN	
3							IN CHARGE C. LEMLEY	C
500d	REV	DATE	BY	снк	APP	DESCRIPTION	03/18/2016	

RECORD SET
15% DESIGN
SUBMITTAL
NOT FOR
CONSTRUCTION








CALIFORNIA HIGH-SPEED TRAIN PROJECT MERCED TO FRESNO SECTION

CENTRAL VALLEY WYE
AVENUE 21 TO ROAD 13 WYE ALTERNATIVE
GENERAL PLAN (MER-FRE)
ROAD 11 BRIDGE

CONTRACT NO.
HSR08-05
DRAWING NO.
ST-K1515-C
SCALE
AS SHOWN
SHEET NO.

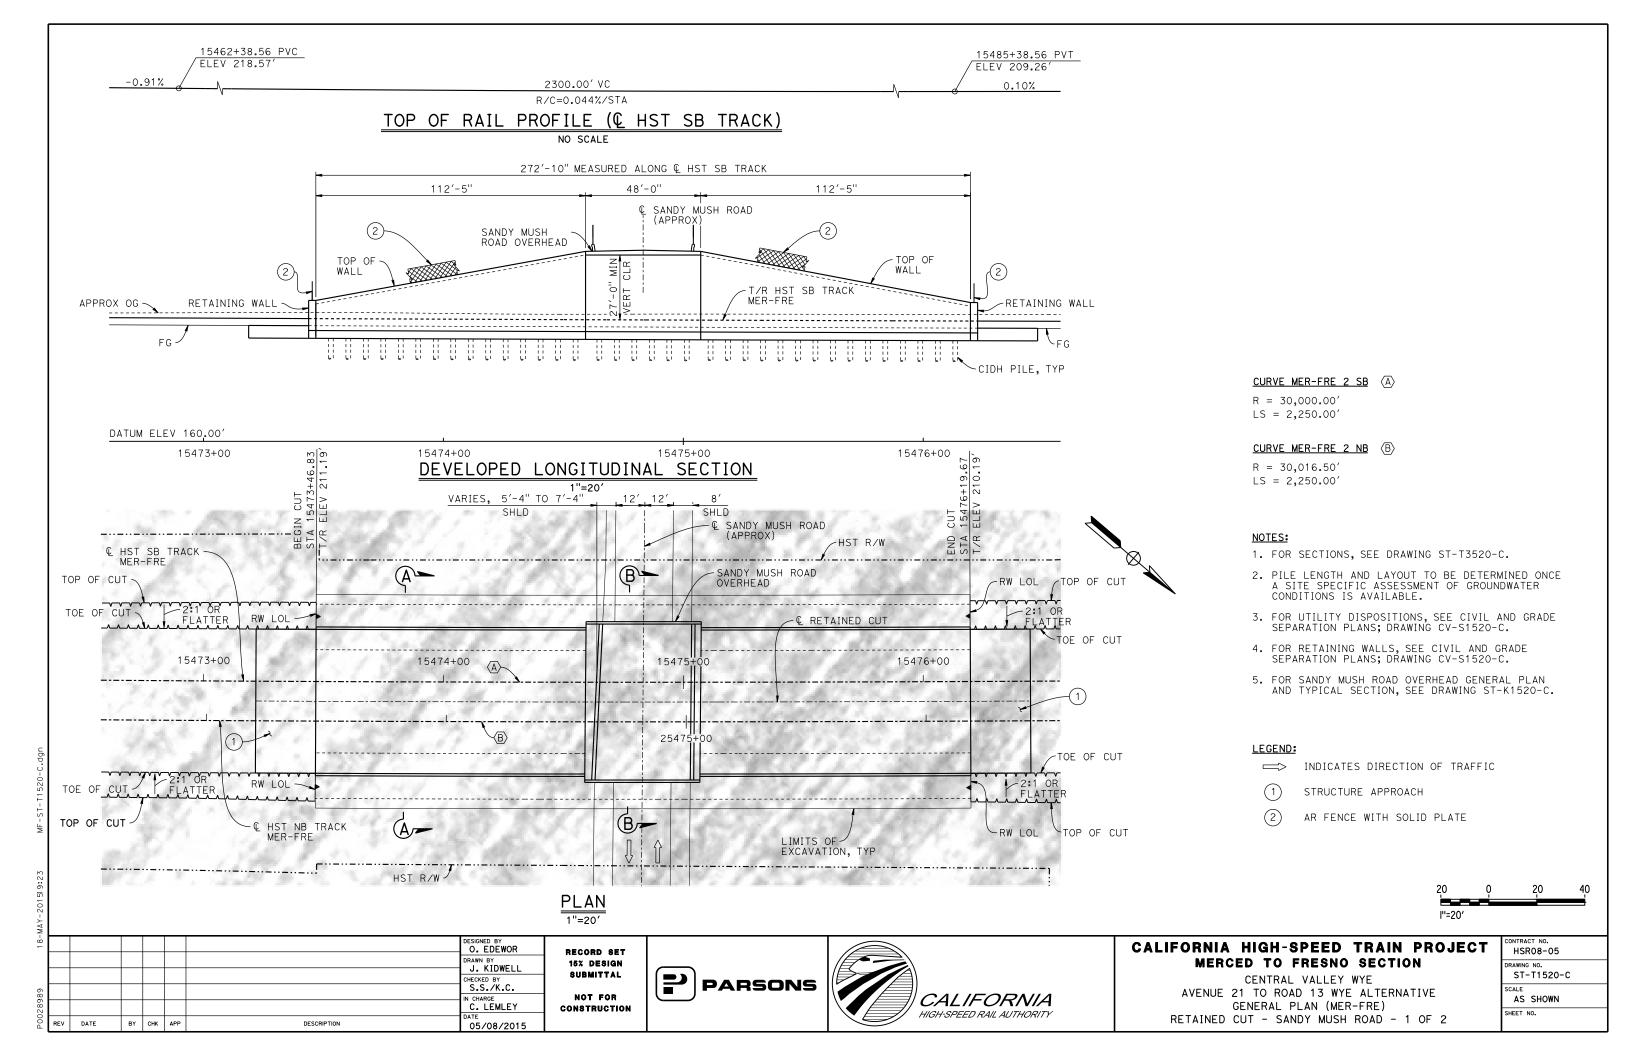

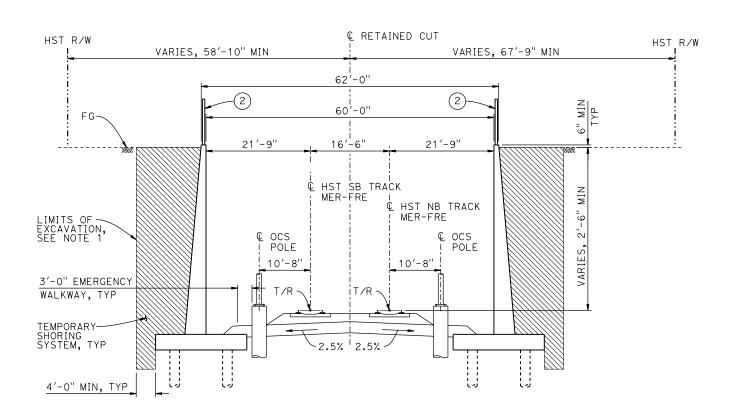

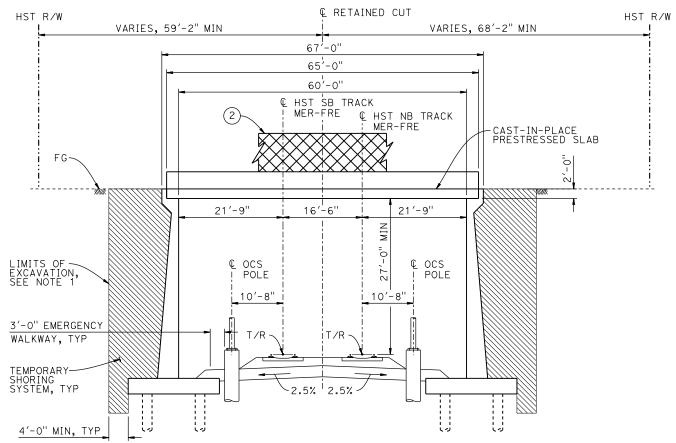

 $\frac{\text{SECTION } A-A}{1" = 10'}$

 $\frac{\text{SECTION B-B}}{1" = 10'}$

NOTES:

- 1. LIMITS OF EXCAVATION SHALL NOT EXTEND BEYOND HST $\ensuremath{\mathsf{R/W}}\xspace.$
- 2. PILE LENGTH AND LAYOUT TO BE DETERMINED ONCE A SITE SPECIFIC ASSESSMENT OF GROUNDWATER CONDITIONS IS AVAILABLE.
- 3. FOR TRACK SUPERELEVATION DETAILS, SEE ALIGNMENT AND TYPICAL SECTION PLANS; DRAWINGS TT-B0056-C AND TT-B0057-C.



2								
0							DESIGNED BY O. EDEWOR	RE
							DRAWN BY	15
							CHECKED BY S.S./K.C.	8ા
30							IN CHARGE	١ ١
200							C. LEMLEY DATE	CON
Ĺ	REV	DATE	BY	CHK	APP	DESCRIPTION	05/08/2015	

RECORD SET
15% DESIGN
SUBMITTAL
NOT FOR
CONSTRUCTION







CALIFORNIA HIGH-SPEED TRAIN PROJECT MERCED TO FRESNO SECTION

CENTRAL VALLEY WYE
AVENUE 21 TO ROAD 13 WYE ALTERNATIVE
TYPICAL SECTIONS (MER-FRE)
RETAINED CUT - SANDY MUSH ROAD - 2 OF 2


CONTRACT NO. HSR08-05
DRAWING NO. ST-T3520-C
SCALE AS SHOWN
SHEET NO.

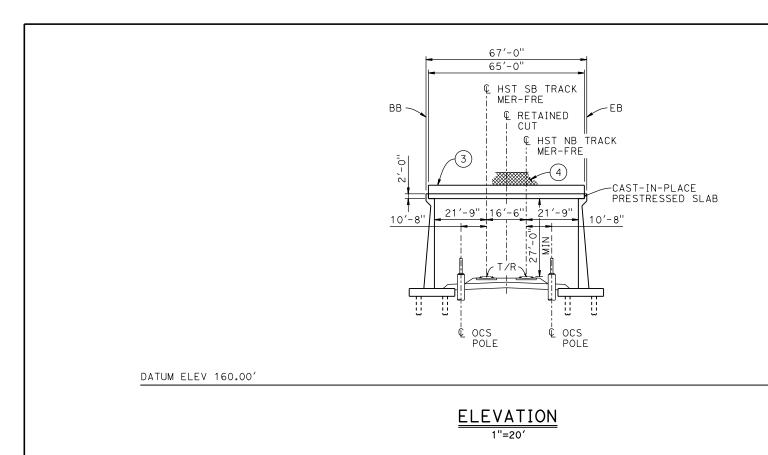

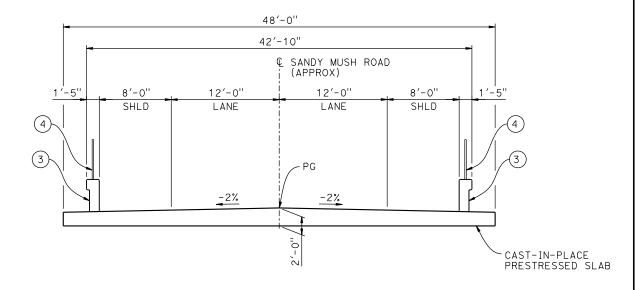

TYPICAL SECTION

3/6"=1'-0"

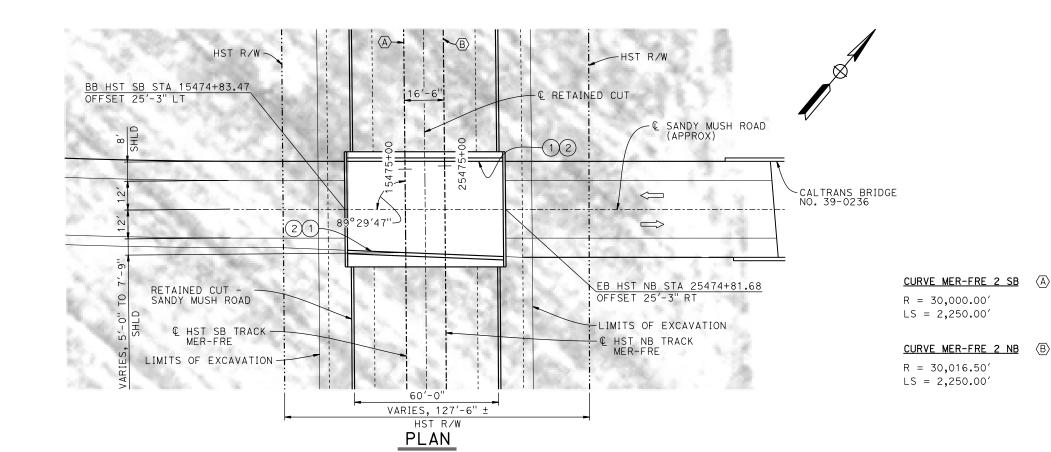


LEGEND:

- (1) PAINT "SANDY MUSH ROAD OVERHEAD"
- 2 PAINT "BRIDGE NO. XX-XXXX"
- (3) CONCRETE BARRIER TYPE 736 MOD
- (4) AR FENCE WITH SOLID PLATE

NOTES:

- 1. FOR UTILITY DISPOSITIONS, SEE CIVIL AND GRADE SEPARATION PLANS; DRAWING CV-S1520-C.
- 2. PILE LENGTH AND LAYOUT TO BE DETERMINED ONCE A SITE SPECIFIC ASSESSMENT OF GROUNDWATER CONDITIONS IS AVAILABLE.
- 3. FOR RETAINED CUT SANDY MUSH ROAD GENERAL PLAN AND TYPICAL SECTIONS, SEE DRAWINGS ST-T1520-C AND ST-T3520-C.

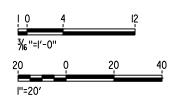

DESIGNED BY O. EDEWOR DRAWN BY J. KIDWELL CHECKED BY S.S./K.C. RECORD SET 15% DESIGN SUBMITTAL

IN CHARGE
C. LEMLEY

05/08/2015

DATE

BY CHK APP

DESCRIPTION

SUBMITTAL NOT FOR CONSTRUCTION






CALIFORNIA HIGH-SPEED TRAIN PROJECT MERCED TO FRESNO SECTION


CENTRAL VALLEY WYE
AVENUE 21 TO ROAD 13 WYE ALTERNATIVE
GENERAL PLAN (MER-FRE)
SANDY MUSH ROAD OVERHEAD

CONTRACT NO. HSR08-05
DRAWING NO.
ST-K1520-C
SCALE
AS SHOWN
SHEET NO.

TOP OF RAIL PROFILE (HST NB TRACK SJD-MER)

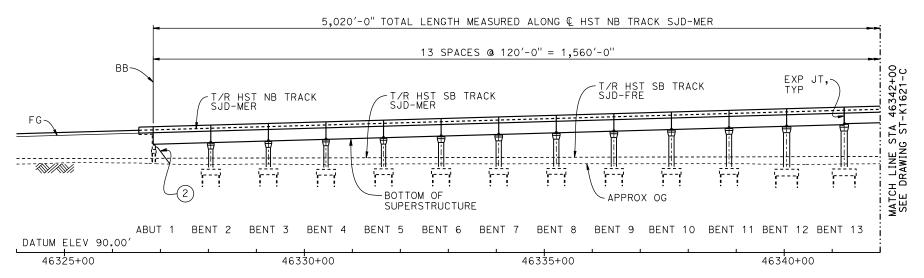

DEVELOPED ELEVATION

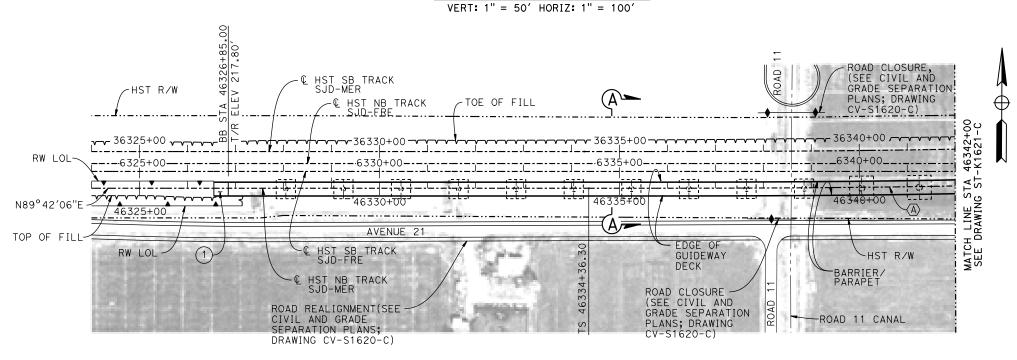

PLAN 1" = 100'

RECORD SET
15% DESIGN
SUBMITTAL
NOT FOR
CONSTRUCTION





LEGEND:


- INDICATES POINT OF MINIMUM VERTICAL CLEARANCE
- 1) STRUCTURE APPROACH
- 2) SLOPE PAVING $(1\frac{1}{2}H:1V)$

CURVE SJD-MER 1 NB (A)

R = 10,376.50'LS = 1,500.00'

NOTES:

- 1. 16" Ø PIPE PILES ASSUMED FOR ABUTMENT AND BENT FOUNDATIONS, UNLESS OTHERWISE NOTED. PILE LENGTHS TO BE DETERMINED.
- 2. FOR SECTIONS AND BENT COLUMN SCHEDULE, SEE DRAWINGS ST-K3620-C AND ST-K3621-C.
- 3. FOR RETAINING WALLS, SEE CIVIL AND GRADE SEPARATION PLANS; DRAWING CV-S1620-C.
- 4. FOR UTILITY DISPOSITIONS, SEE CIVIL AND GRADE SEPARATION PLANS; DRAWING CV-S1620-C.
- 5. ANY EXISTING DIRT ROAD THAT CONFLICTS WITH NEW CONSTRUCTION SHALL BE REALIGNED.

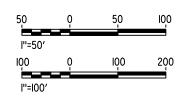

CALIFORNIA HIGH-SPEED TRAIN PROJECT MERCED TO FRESNO SECTION

CENTRAL VALLEY WYE

AVENUE 21 TO ROAD 13 WYE ALTERNATIVE

GENERAL PLAN (SJD-MER)


AERIAL #5 - NORTHBOUND OVER HST MAINLINE - 1 OF 5

CONTRACT NO. HSR08-05
DRAWING NO. ST-K1620-C
SCALE AS SHOWN


2150.00' VC

R/C=-0.122%/STA

TOP OF RAIL PROFILE (HST NB TRACK SJD-MER)

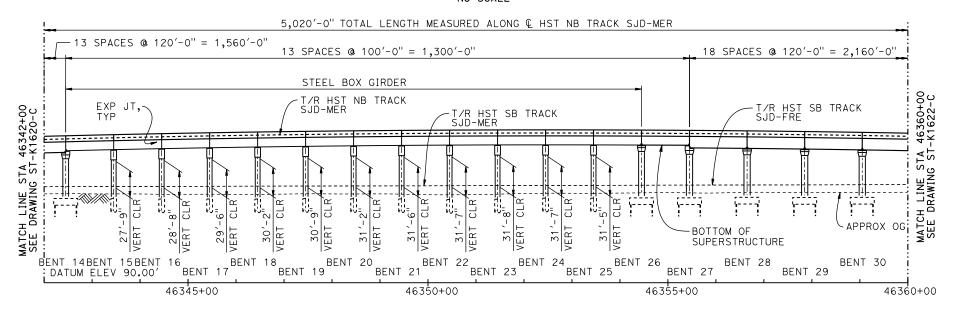

DEVELOPED ELEVATION

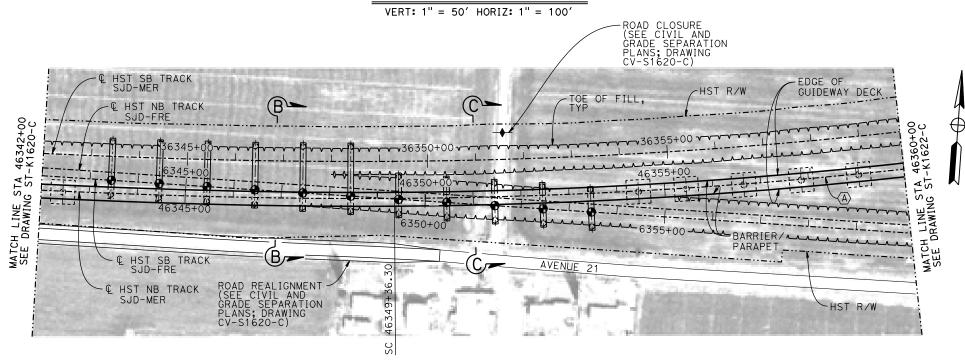

PLAN 1" = 100'

50	Q	50	100
l''=50′			
100	Q	100	200
l"=l00′			

È								
9							DESIGNED BY M. SUN	RECORD SET
							DRAWN BY	15% DESIGN
							CHECKED BY O. EDEWOR	SUBMITTAL
2226							IN CHARGE C. LEMLEY	NOT FOR
p0042	_	DATE	BY	СНК	APP	DESCRIPTION	DATE 05/08/2015	CONSTRUCTION



CALIFORNIA HIGH-SPEED TRAIN PROJECT MERCED TO FRESNO SECTION

CENTRAL VALLEY WYE AVENUE 21 TO ROAD 13 WYE ALTERNATIVE GENERAL PLAN (SJD-MER) AERIAL #5 - NORTHBOUND OVER HST MAINLINE - 2 OF 5

CONTRACT NO.
HSR08-05
DRAWING NO.
ST-K1621-C
SCALE
AS SHOWN
SHEET NO.


HSR08-05


AS SHOWN


ST-K1622-C

RAWING NO.

SHEET NO.

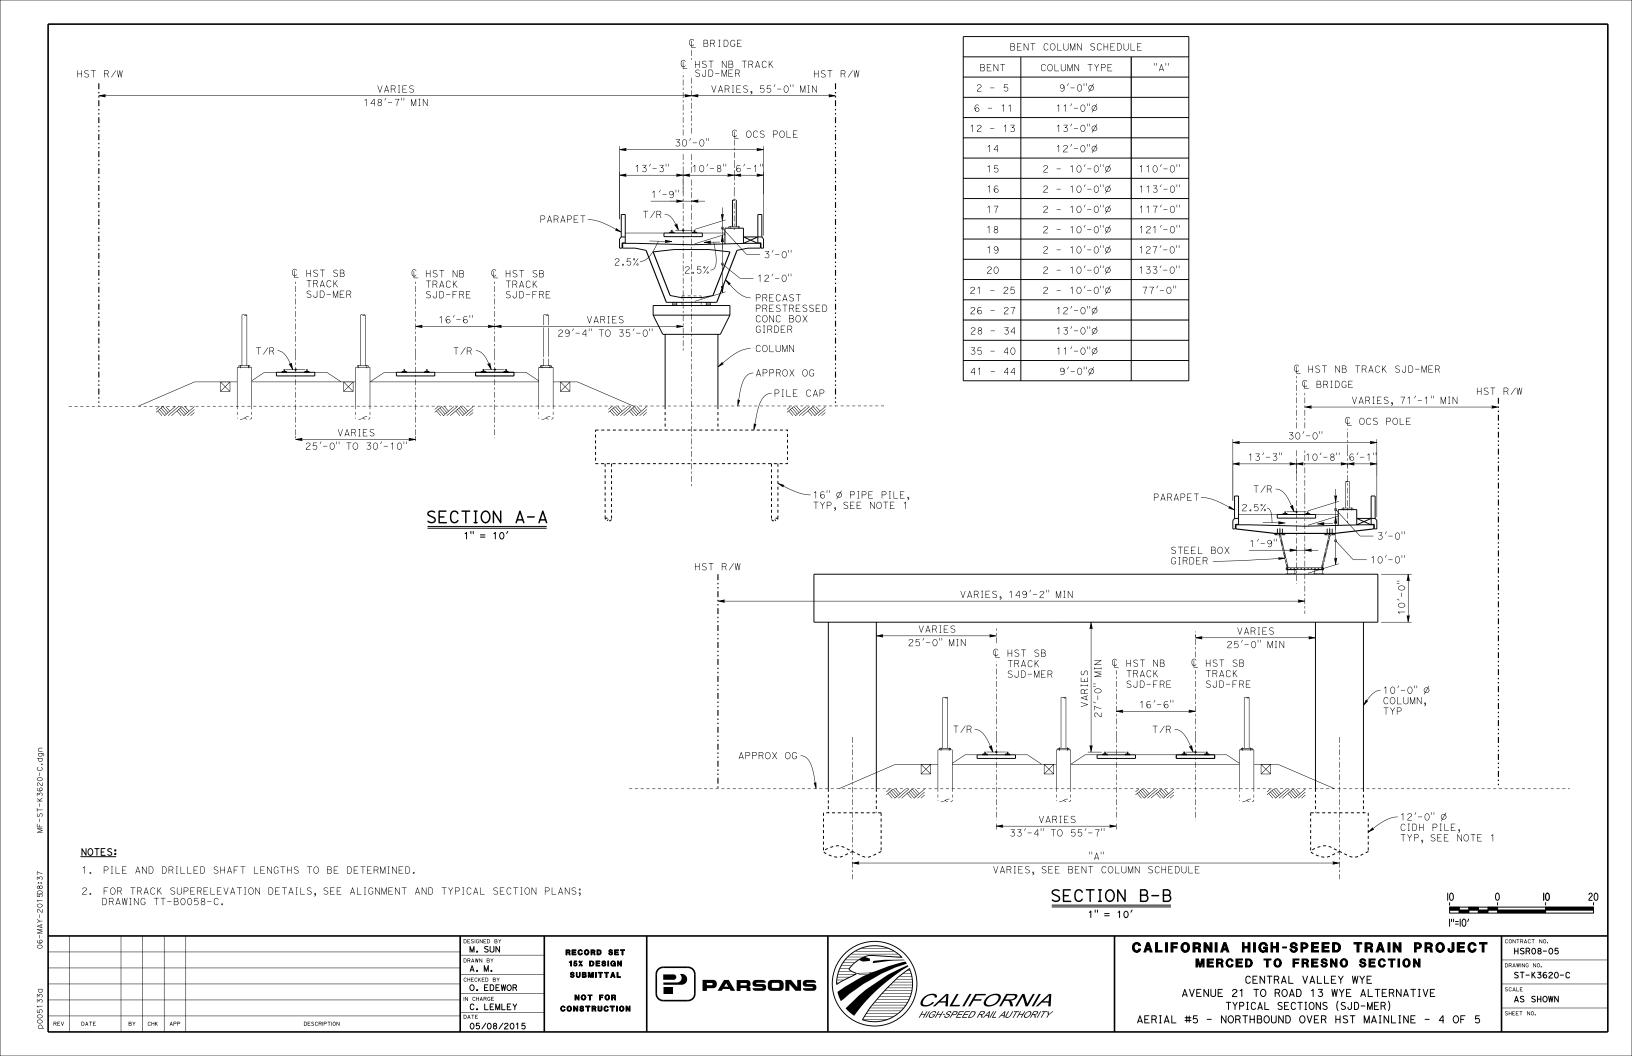


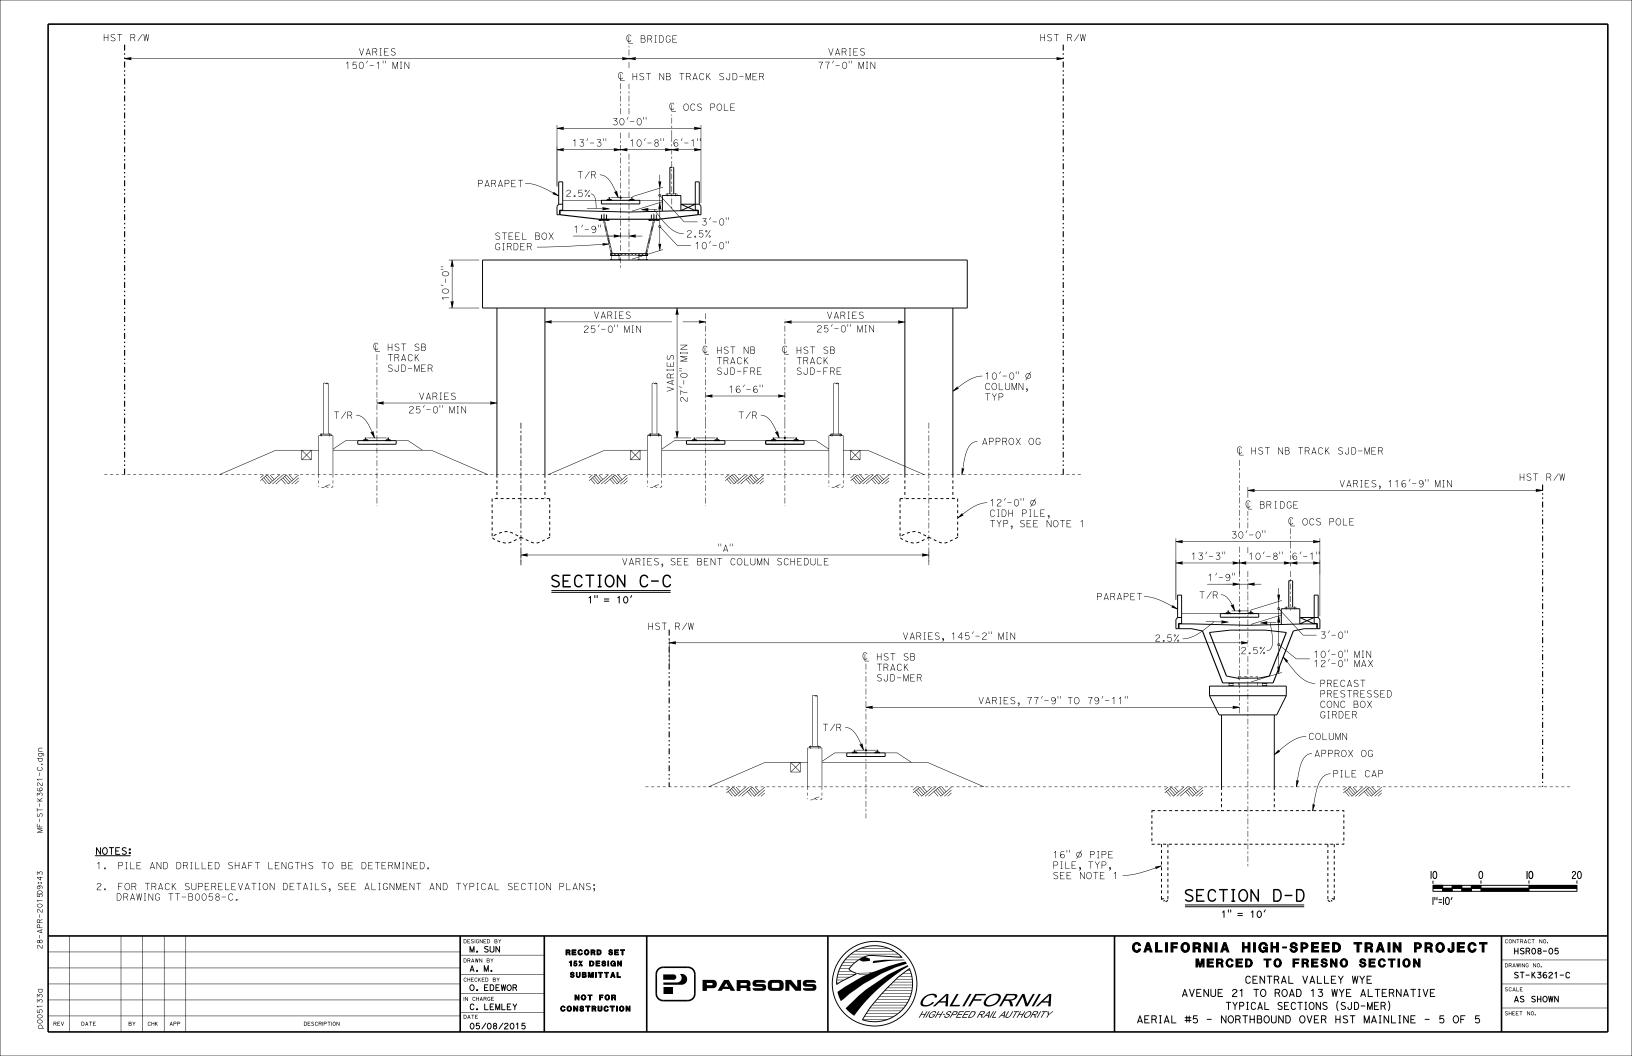

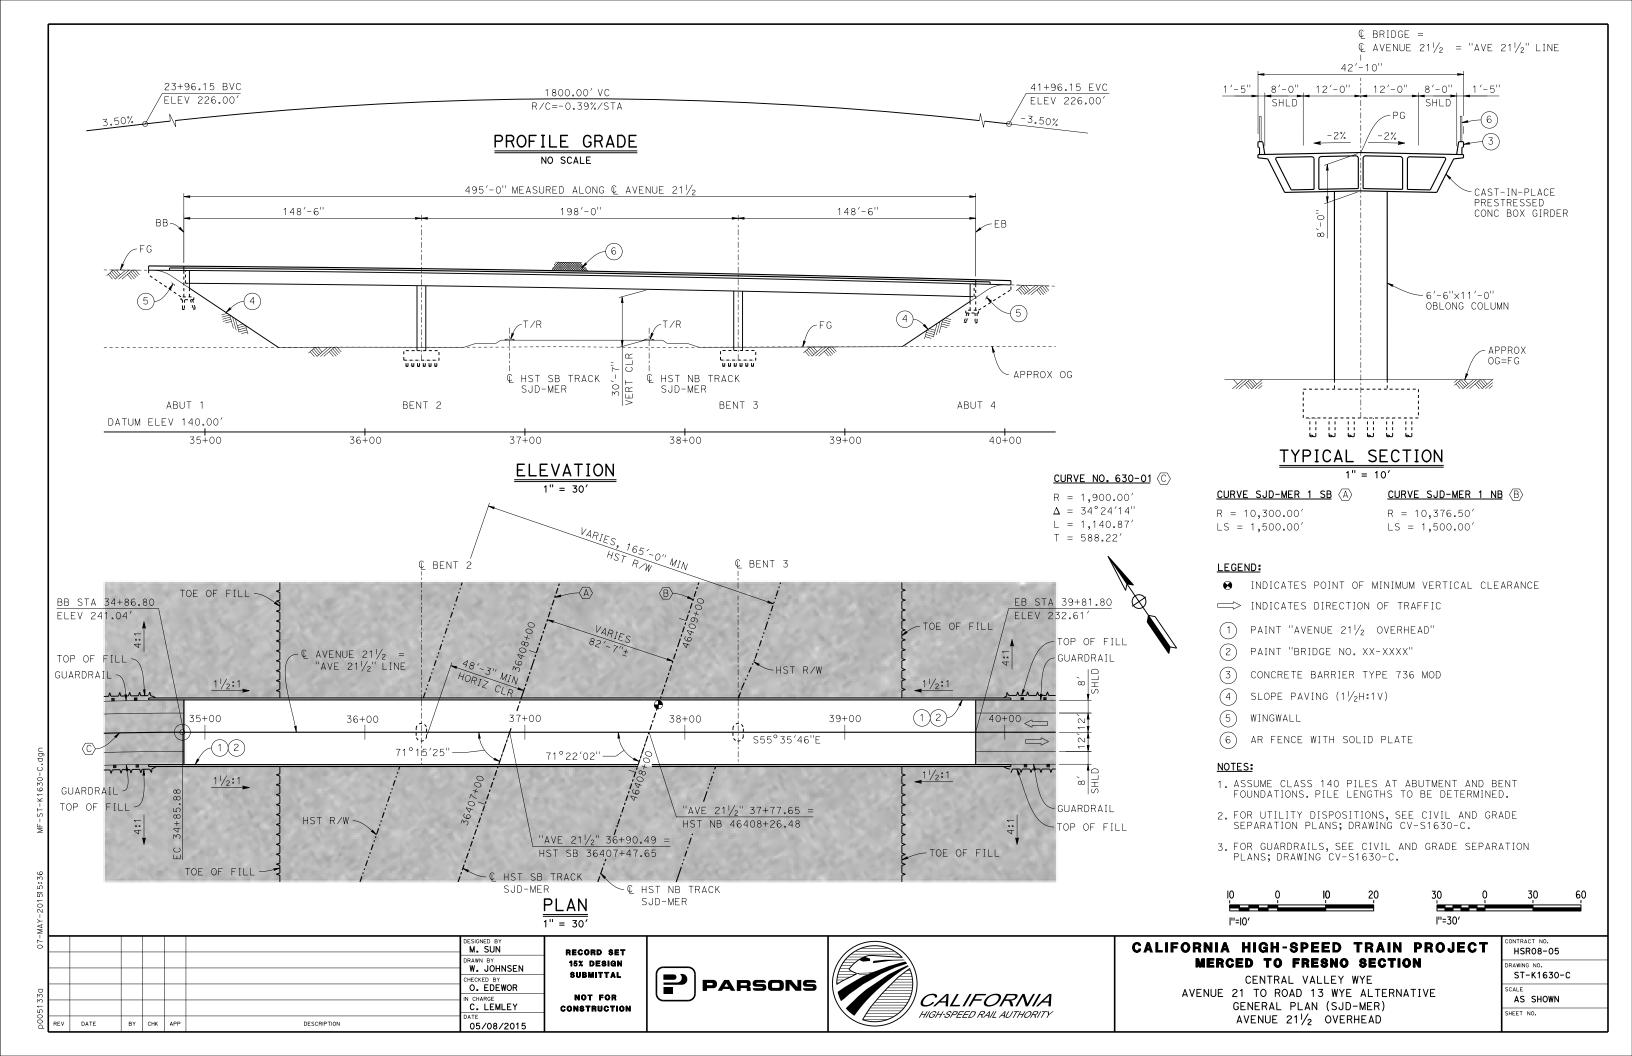


1.45%

TOP OF RAIL PROFILE (& HST NB TRACK SJD-MER)

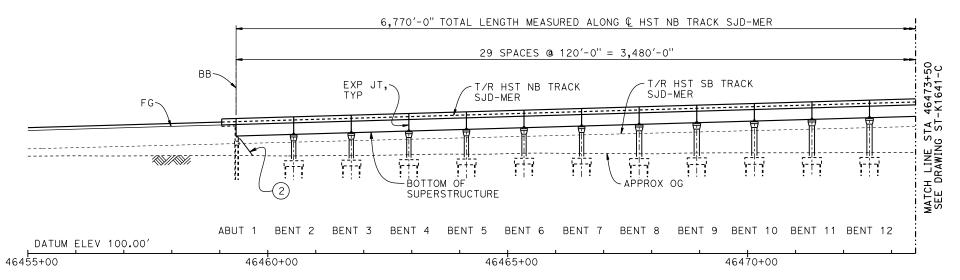

DEVELOPED ELEVATION

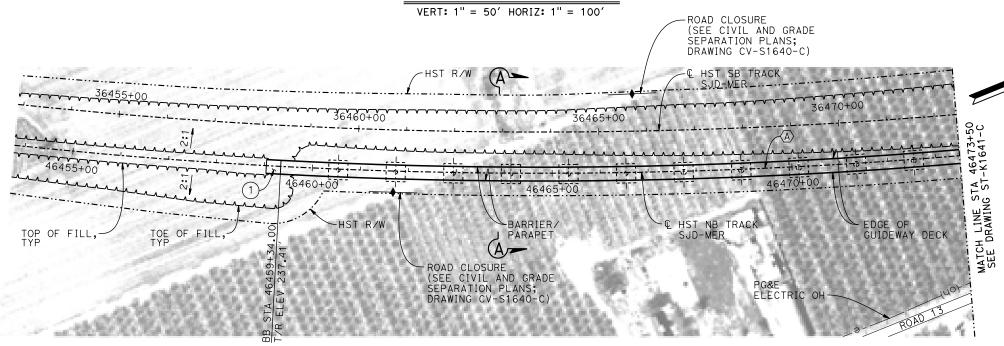

PLAN 1" = 100'

RECORD SET 15% DESIGN SUBMITTAL NOT FOR CONSTRUCTION

M. SUN

CHECKED BY
O. EDEWOR

N CHARGE C. LEMLEY

05/08/2015

DRAWN BY





LEGEND:

- INDICATES POINT OF MINIMUM VERTICAL CLEARANCE
- INDICATES DIRECTION OF TRAFFIC
- STRUCTURE APPROACH
- SLOPE PAVING (11/2H:1V)

CURVE SJD-MER 1 NB (A)

R = 10,376.50'LS = 1,500.00'

TEMPORARY TRAFFIC OPENINGS

VEHICULAR TRAFFIC


- 1. __TRAFFIC WILL BE DETOURED AWAY FROM THE SITE.
- 2. X TRAFFIC WILL PASS UNDER THE STRUCTURE ON:

ST OR ROAD NAME AND LOCATION	FALSEWORK OPENING REQD (HORIZ X VERT)					
AVENUE 221/2	46479+15	32′X16.5′	2-WAY			
SR 152	46505+72	52′X16.5′	E BND			
SR 152	46506+18	52′x16.5′	W BND			
3. X TEMP TRAFFIC LAN	E REDUCTI	ON FOR				

FTG EXC.

NOTES:

- 1. 16" Ø PIPE PILES ASSUMED FOR ABUTMENT AND BENT FOUNDATIONS, UNLESS OTHERWISE NOTED. PILE LENGTHS TO BE DETERMINED.
- 2. FOR SECTIONS AND BENT COLUMN SCHEDULE, SEE DRAWINGS ST-K3640-C AND ST-K3641-C.
- 3. ANY EXISTING DIRT ROAD THAT CONFLICTS WITH NEW CONSTRUCTION SHALL BE REALIGNED.
- 4. FOR UTILITY DISPOSITIONS, SEE CIVIL AND GRADE SEPARATION PLANS; DRAWINGS CV-S1640-C AND CV-S1650-C.
- 5. FOR GUARDRAILS, SEE CIVIL AND GRADE SEPARATION PLANS; DRAWINGS CV-S1640-C AND CV-S1650-C.
- 6. FOR RETAINING WALL, SEE CIVIL AND GRADE SEPARATION PLNAS; DRAWINGS CV-S1640-C AND CV-S1650-C.
- 7. FOR AVENUE 22 $^{\prime}\!\!/_2$ UNDERPASS (HST SB) GENERAL PLAN AND TYPICAL SECTION, SEE DRAWING ST-K1646-C.
- 8. FOR SR 152 UNDERPASS GENERAL PLAN AND TYPICAL SECTION, SEE DRAWINGS ST-K1450-C AND ST-K3450-C.

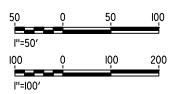

CALIFORNIA HIGH-SPEED TRAIN PROJECT MERCED TO FRESNO SECTION

CENTRAL VALLEY WYE AVENUE 21 TO ROAD 13 WYE ALTERNATIVE GENERAL PLAN (SJD-MER) AERIAL #6 - NORTHBOUND OVER HST MERCED TO FRESNO - 1 OF 6

HSR08-05 ST-K1640-C AS SHOWN SHEET NO.


DATE

BY CHK APP

DESCRIPTION


TOP OF RAIL PROFILE (& HST NB TRACK SJD-MER)

NO SCALE

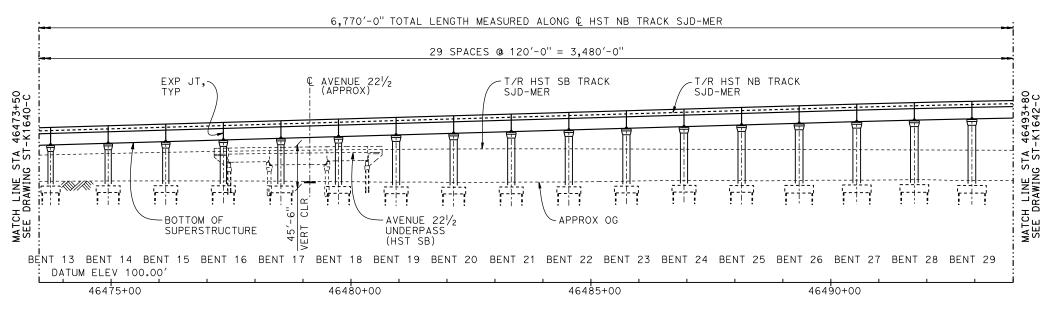

DEVELOPED ELEVATION

VERT: 1" = 50' HORIZ: 1" = 100'

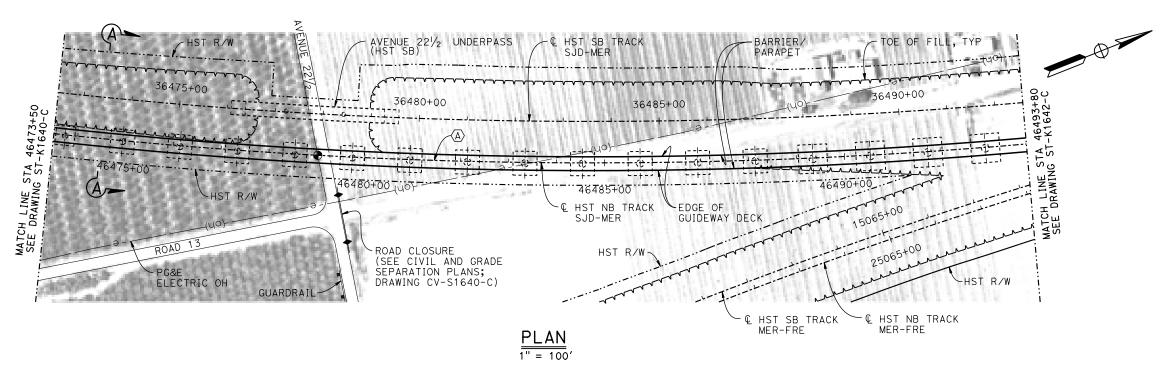

50	Q	50	100
l''=50'			
100	Q	ΙŌΟ	200
l"=l00′			

Σ								
5							DESIGNED BY M. SUN	
							DRAWN BY	l
							CHECKED BY	l
0							O. EDEWOR	
775							C. LEMLEY	0
2	REV	DATE	BY	СНК	APP	DESCRIPTION	05/08/2015	

RECORD SET
15% DESIGN
SUBMITTAL
NOT FOR
CONSTRUCTION






CALIFORNIA HIGH-SPEED TRAIN PROJECT MERCED TO FRESNO SECTION

CENTRAL VALLEY WYE
AVENUE 21 TO ROAD 13 WYE ALTERNATIVE
GENERAL PLAN (SJD-MER)
AERIAL #6 - NORTHBOUND OVER HST MERCED TO FRESNO - 2 OF 6


	CONTRACT NO.		
	HSR08-05		
	DRAWING NO.		
	ST-K1641-C		
	SCALE		
	AS SHOWN		
ŝ	SHEET NO.		

46531+81.57 PVC ELEV 231.12'

TOP OF RAIL PROFILE (@ HST NB TRACK SJD-MER)

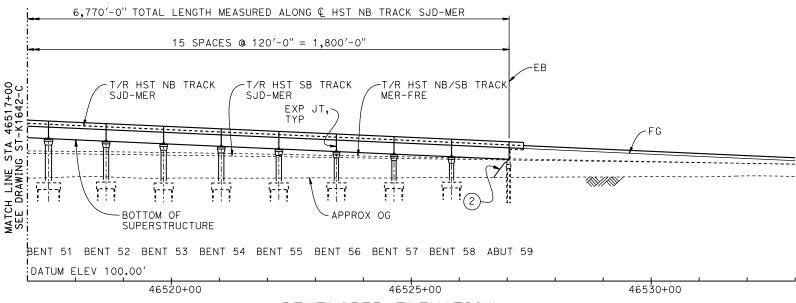

DEVELOPED ELEVATION VERT: 1" = 50' HORIZ: 1" = 100'

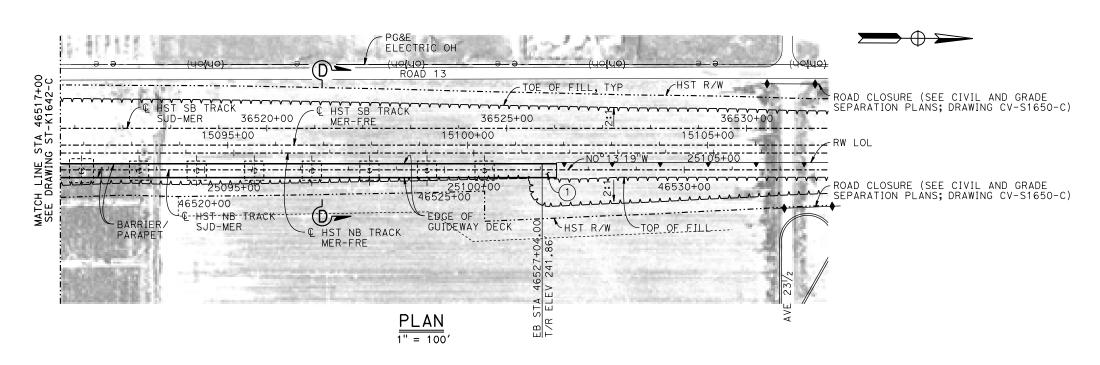

50	Q	50	10,0
l''=50'			
100	Q	100	20
l''=l00′			

						DESIGNED BY M. SUN	
						DRAWN BY	1
						CHECKED BY	1
						O. EDEWOR IN CHARGE	ł
						C. LEMLEY] (
REV	DATE	BY	СНК	APP	DESCRIPTION	05/08/2015	

RECORD SET 15% DESIGN SUBMITTAL NOT FOR CONSTRUCTION








CALIFORNIA HIGH-SPEED TRAIN PROJECT MERCED TO FRESNO SECTION


CENTRAL VALLEY WYE AVENUE 21 TO ROAD 13 WYE ALTERNATIVE GENERAL PLAN (SJD-MER) AERIAL #6 - NORTHBOUND OVER HST MERCED TO FRESNO - 4 OF 6

CONTRACT NO.
HSR08-05
DRAWING NO.
ST-K1643-C
SCALE
AS SHOWN
SHEET NO

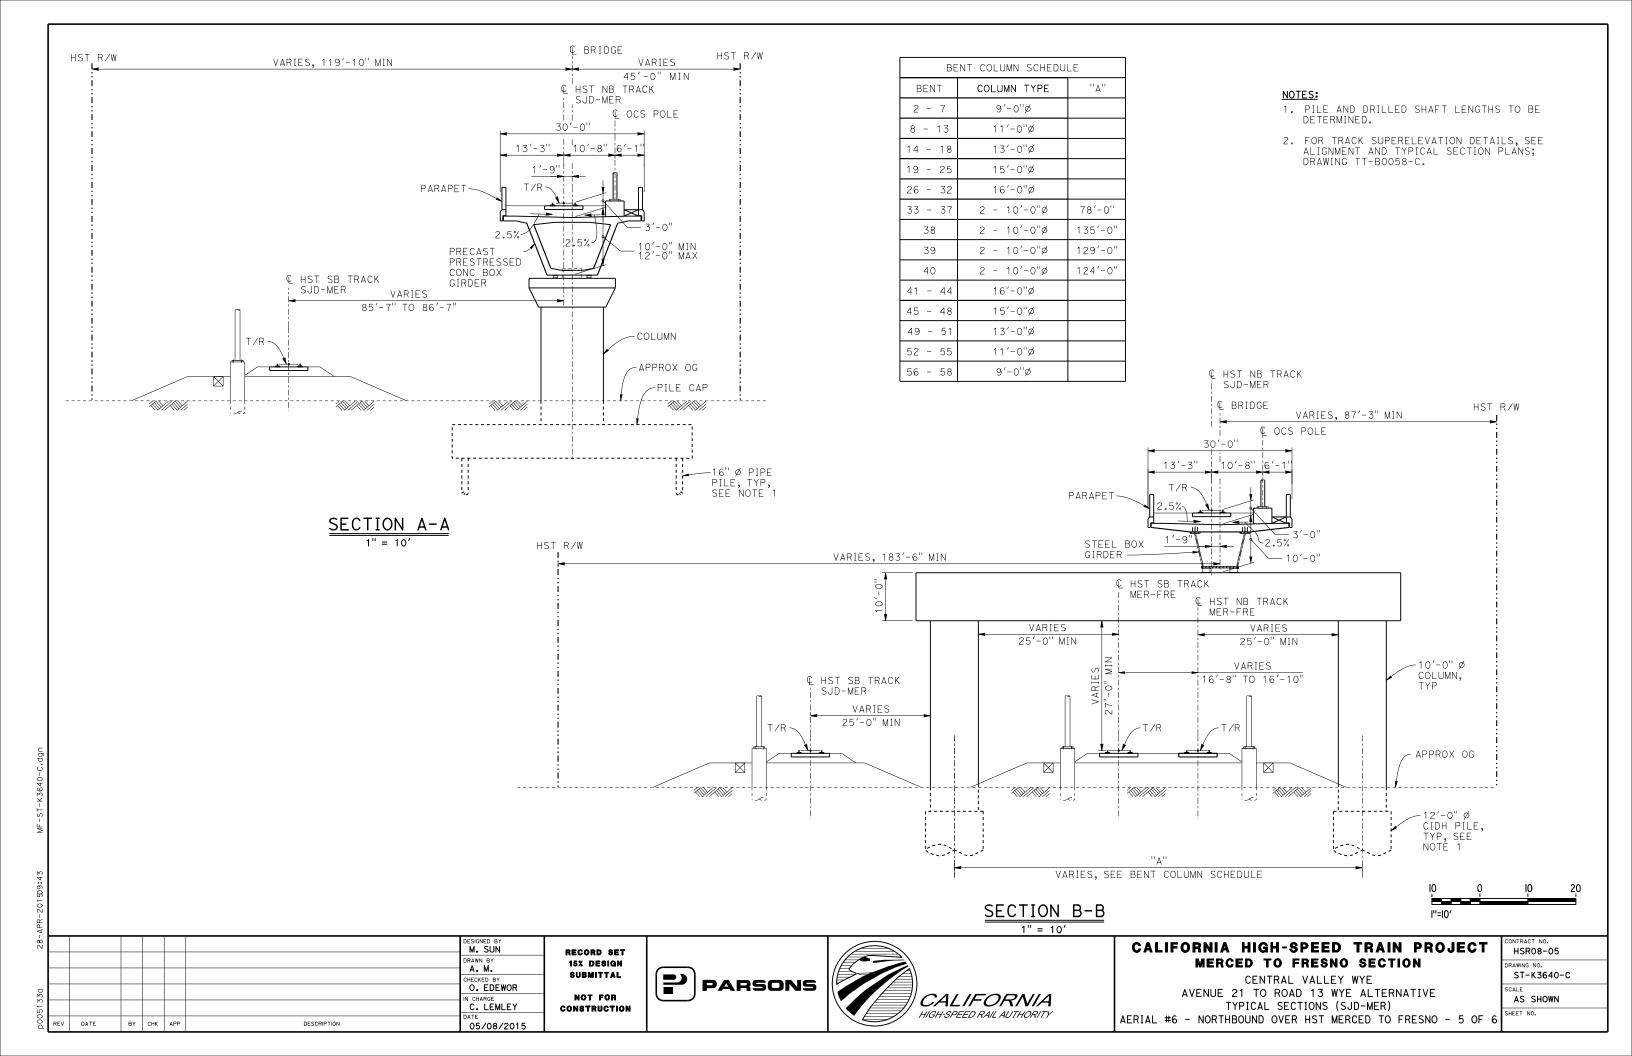

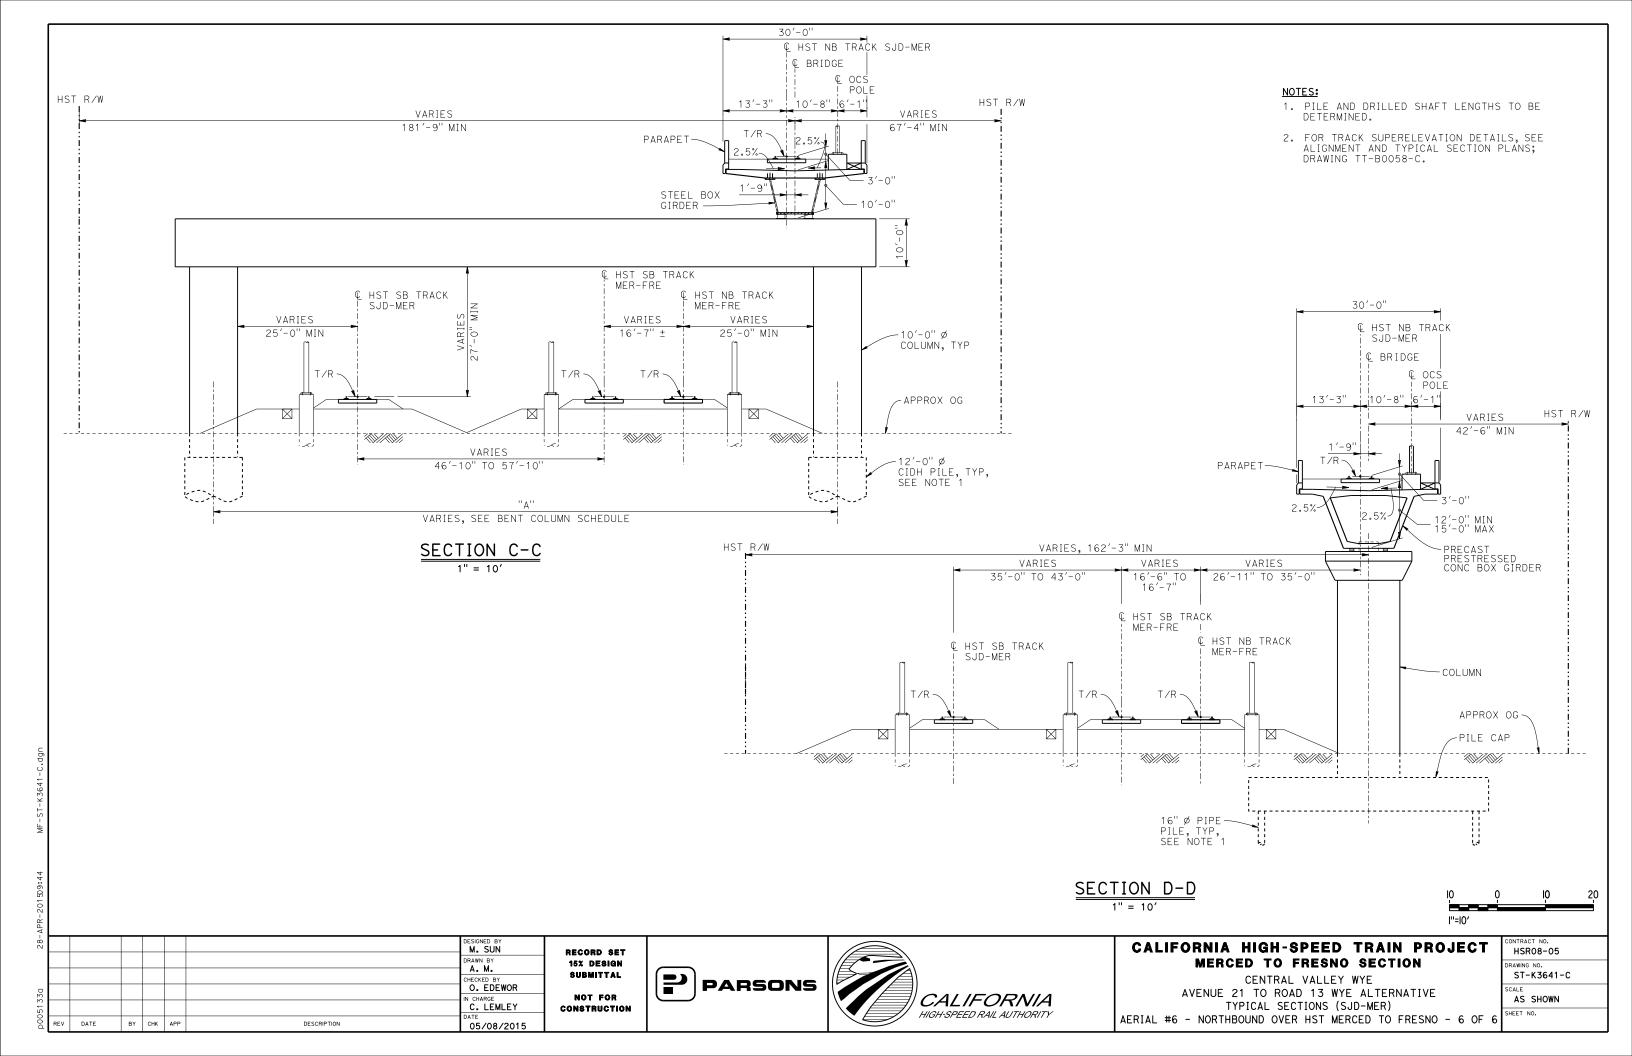


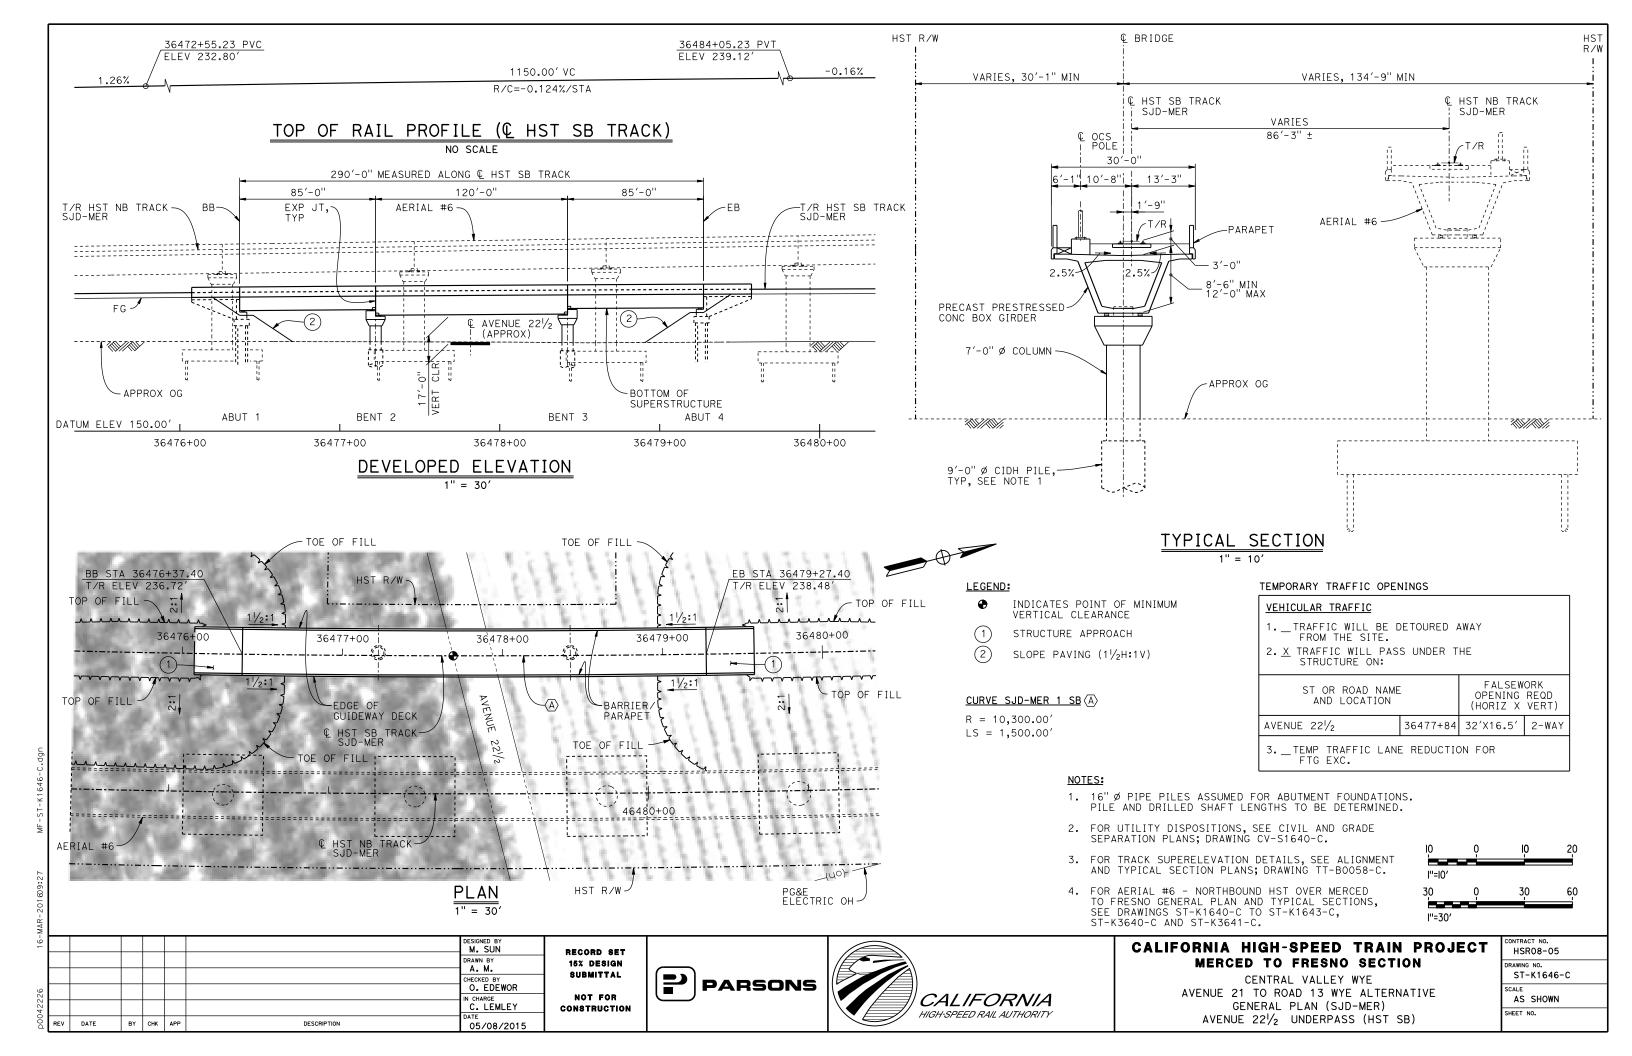

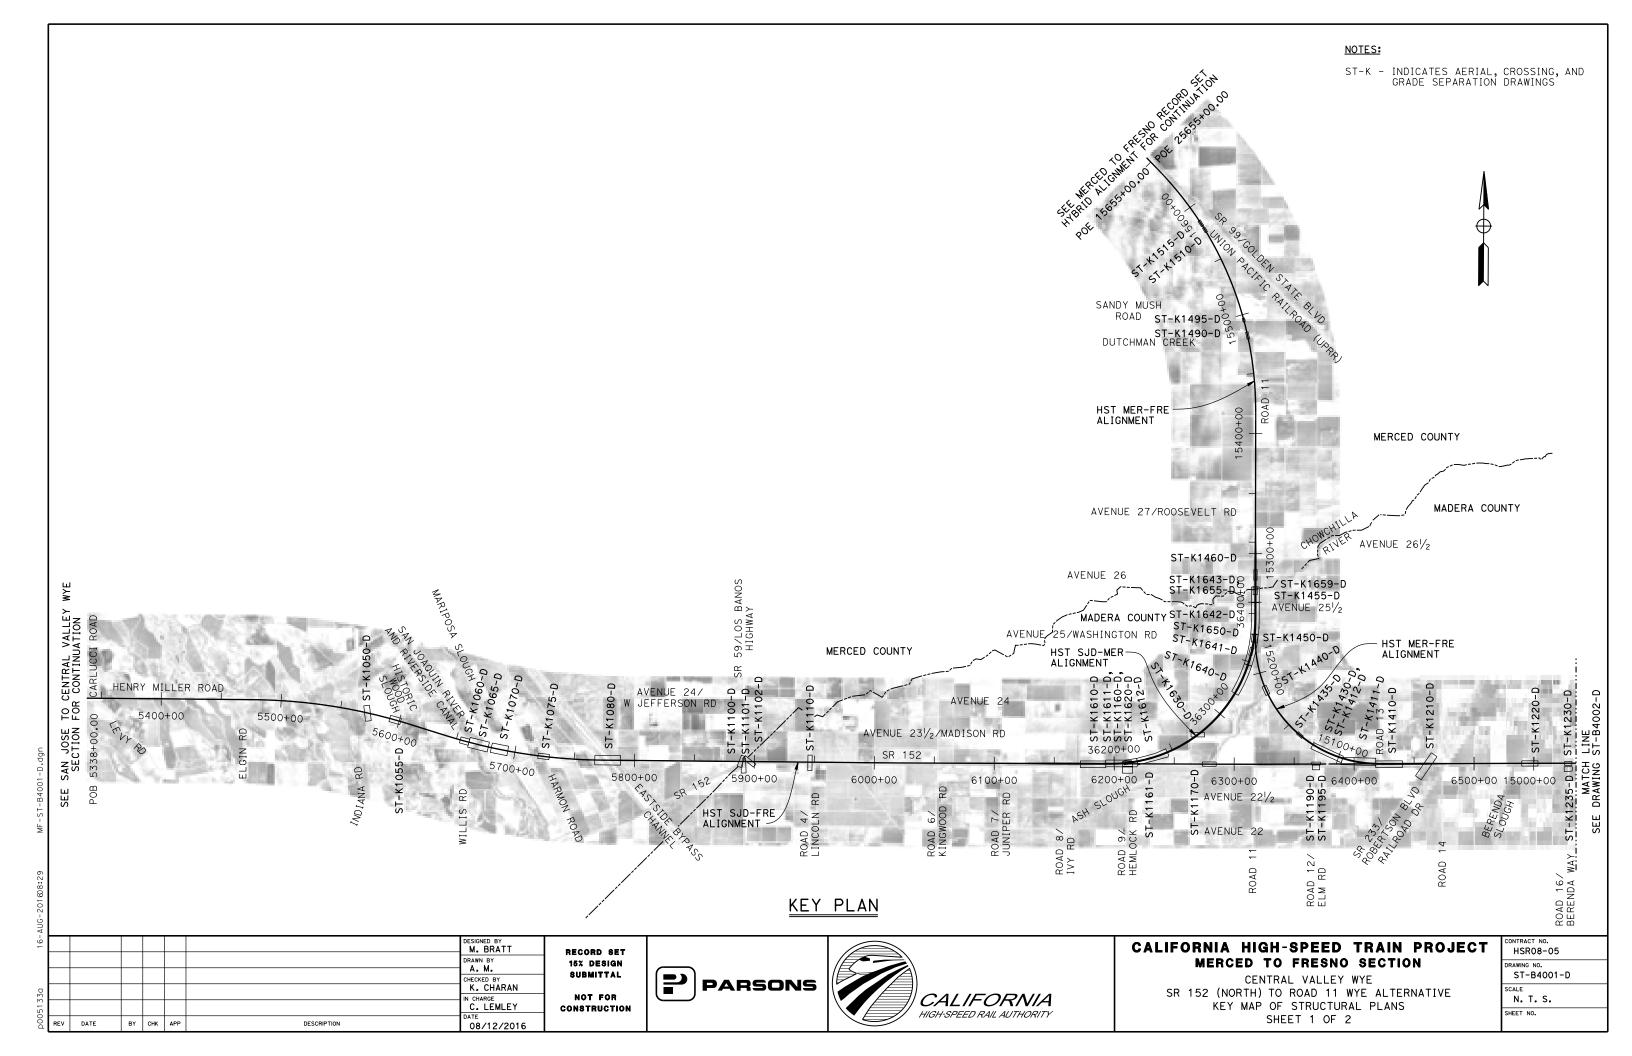

NOTES:

ST-K - INDICATES AERIAL, CROSSING, AND GRADE SEPARATION DRAWINGS

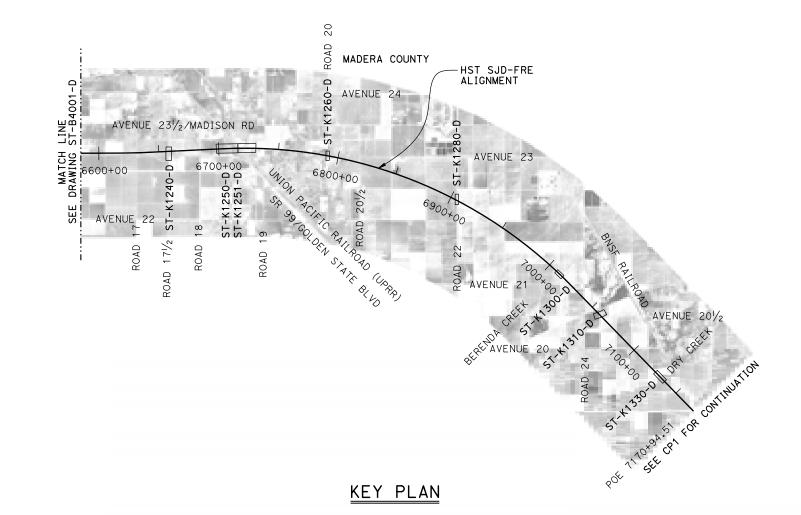

Ą							
15-							DESIGNED BY M. BRATT
							DRAWN BY A. M.
0							CHECKED BY K. CHARAN
51330							IN CHARGE C. LEMLEY
00d	REV	DATE	BY	СНК	APP	DESCRIPTION	DATE 08/12/2016

RECORD SET 15% DESIGN SUBMITTAL NOT FOR CONSTRUCTION







CALIFORNIA HIGH-SPEED TRAIN PROJECT MERCED TO FRESNO SECTION

CENTRAL VALLEY WYE SR 152 (NORTH) TO ROAD 11 WYE ALTERNATIVE KEY MAP OF STRUCTURAL PLANS SHEET 2 OF 2

Γ	CONTRACT NO. HSR08-05
	DRAWING NO. ST-B4002-D
	SCALE N. T. S.
	SHEET NO.

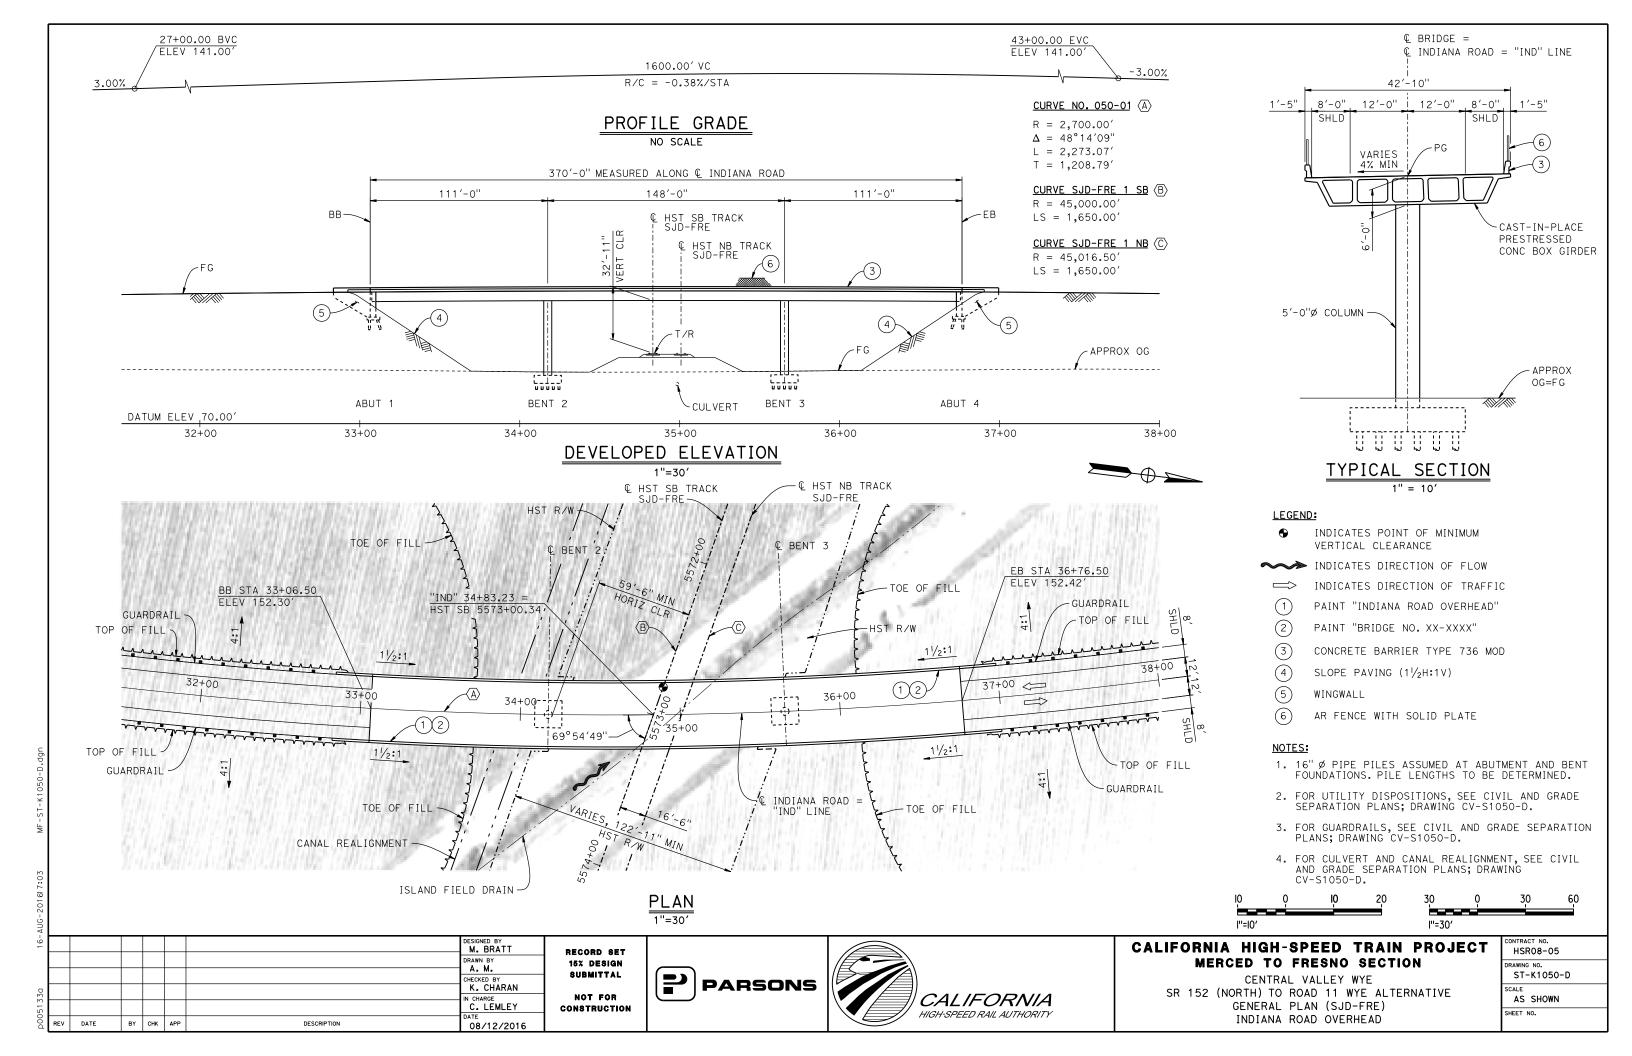

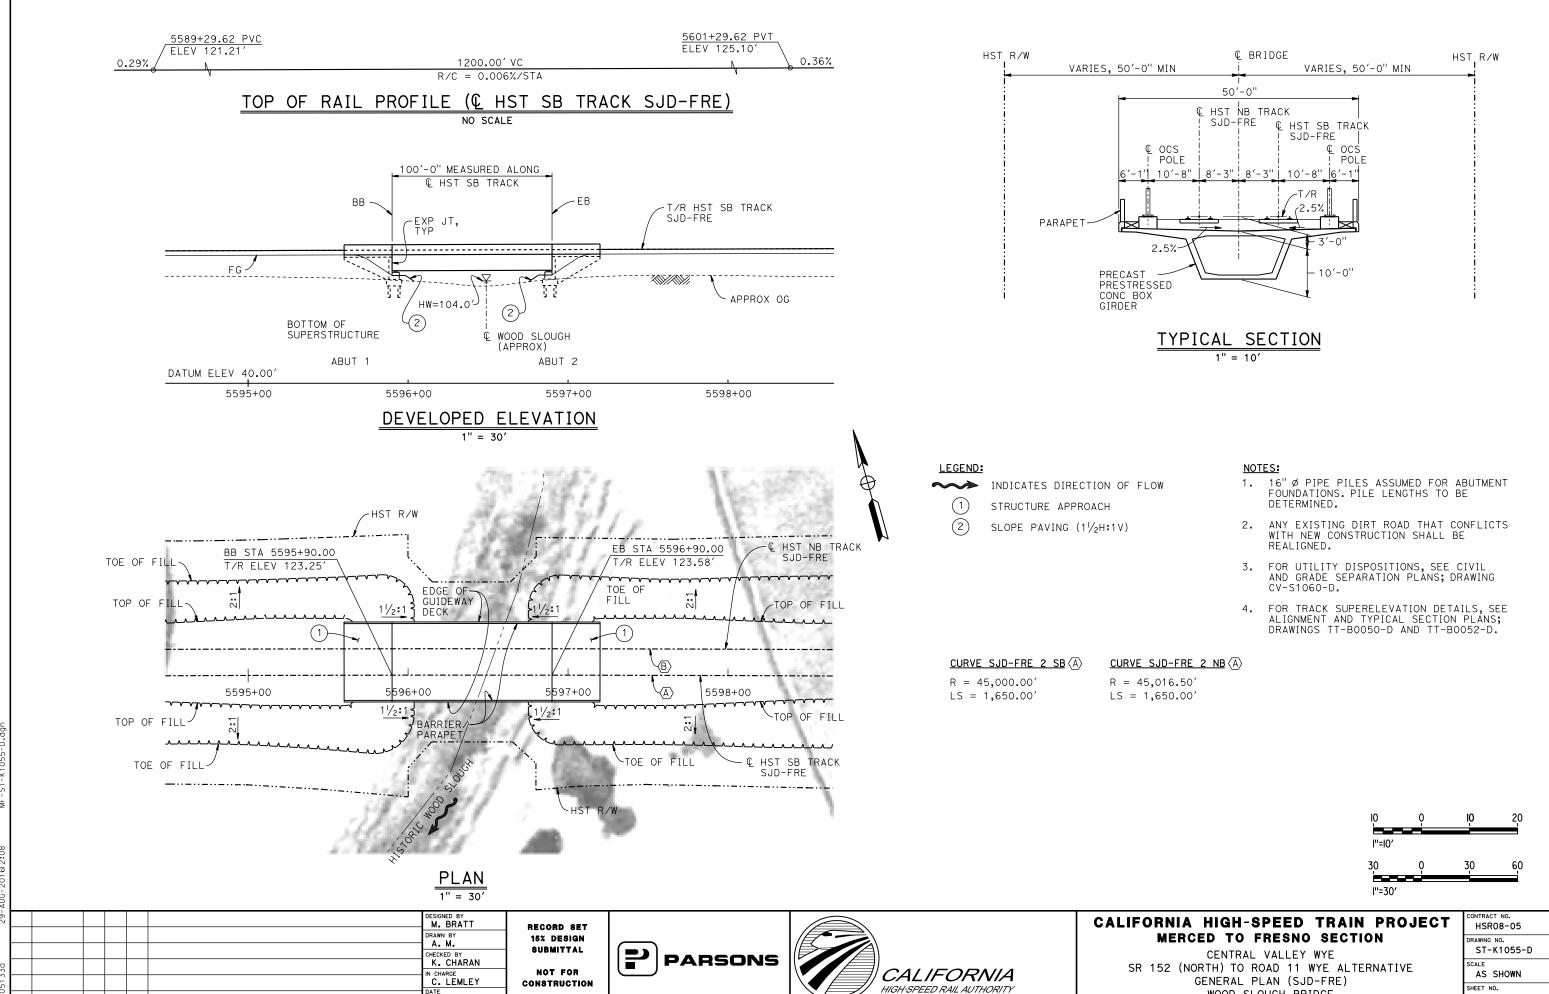

DATE


BY CHK APP


DESCRIPTION

09/02/2016

SHEET NO.

WOOD SLOUGH BRIDGE

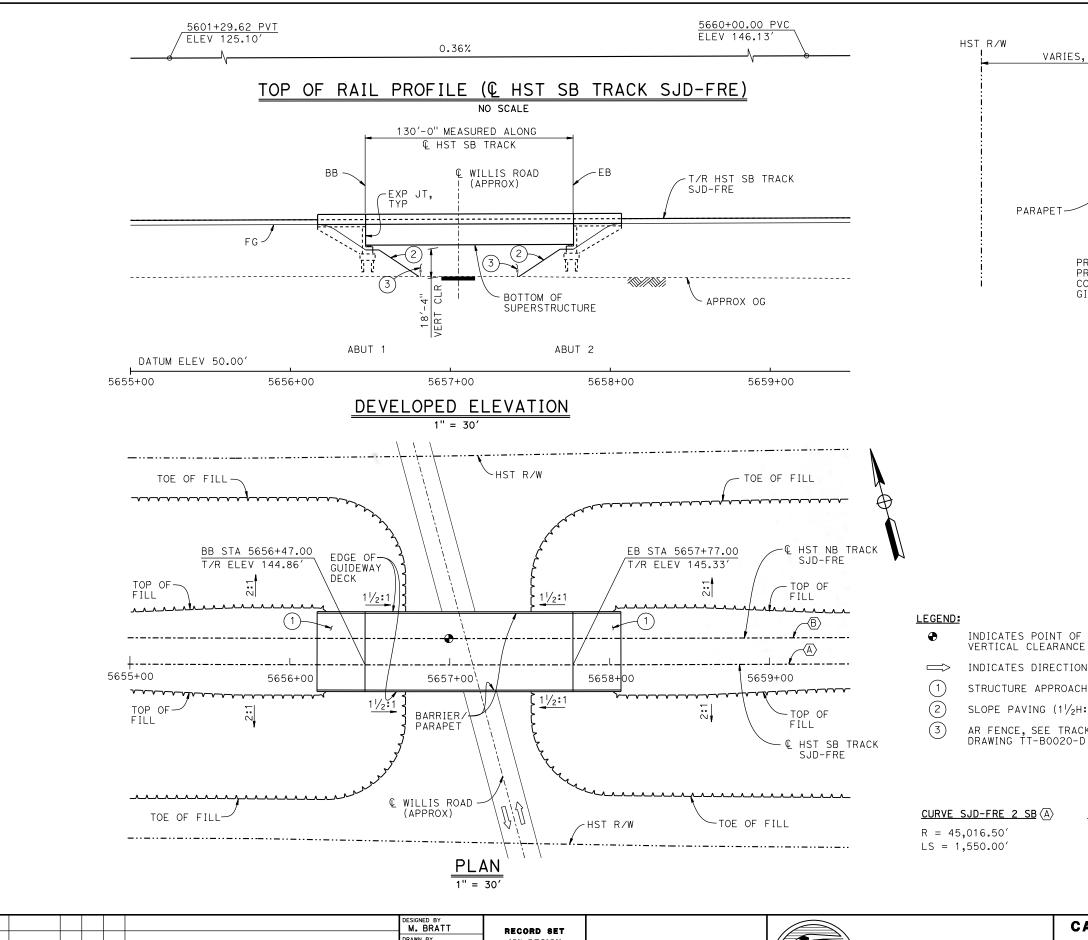

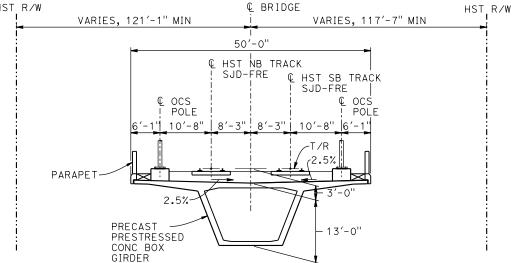

TYPICAL SECTION

TEMPORARY TRAFFIC OPENINGS


<u>VEHICULAR TRAFFIC</u>						
1 TRAFFIC WILL BE DETOURED AWAY FROM THE SITE.						
2. X TRAFFIC WILL PASS UNDER THE STRUCTURE ON:						
ST OR ROAD AND LOCAT	FALSEW OPENING (HORIZ X	REQD				
WILLIS ROAD	5657+14	32′X16.5′	2-WAY			
3 TEMP TRAFFIC LANE REDUCTION FOR FTG EXC.						

- INDICATES POINT OF MINIMUM
- INDICATES DIRECTION OF TRAFFIC
- STRUCTURE APPROACH
- SLOPE PAVING $(1\frac{1}{2}H:1V)$
- AR FENCE, SEE TRACK PLANS; DRAWING TT-B0020-D

- 16" Ø PIPE PILES ASSUMED FOR ABUTMENT FOUNDATIONS. PILE LENGTHS TO BE DETERMINED.
- 2. ANY EXISTING DIRT ROAD THAT CONFLICTS WITH NEW CONSTRUCTION SHALL BE REALIGNED.
- 3. FOR UTILITY DISPOSITIONS, SEE CIVIL AND GRADE SEPARATION PLANS; DRAWING CV-S1060-D.
- 4. FOR TRACK SUPERELEVATION, SEE ALIGNMENT AND TYPICAL SECTION PLANS; DRAWINGS TT-B0050-D AND TT-B0052-D.

CURVE SJD-FRE 2 NB (B)

R = 45,000.00'LS = 1,550.00

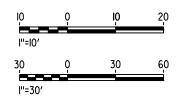

DRAWN BY K. CHARAN C. LEMLEY

DESCRIPTION

DATE

BY CHK APP

15% DESIGN SUBMITTAL NOT FOR CONSTRUCTION

08/12/2016







CALIFORNIA HIGH-SPEED TRAIN PROJECT MERCED TO FRESNO SECTION

CENTRAL VALLEY WYE SR 152 (NORTH) TO ROAD 11 WYE ALTERNATIVE GENERAL PLAN (SJD-FRE) WILLIS ROAD UNDERPASS

CONTRACT NO.
HSR08-05
DRAWING NO.
ST-K1060-D
SCALE
AS SHOWN
SHEET NO.

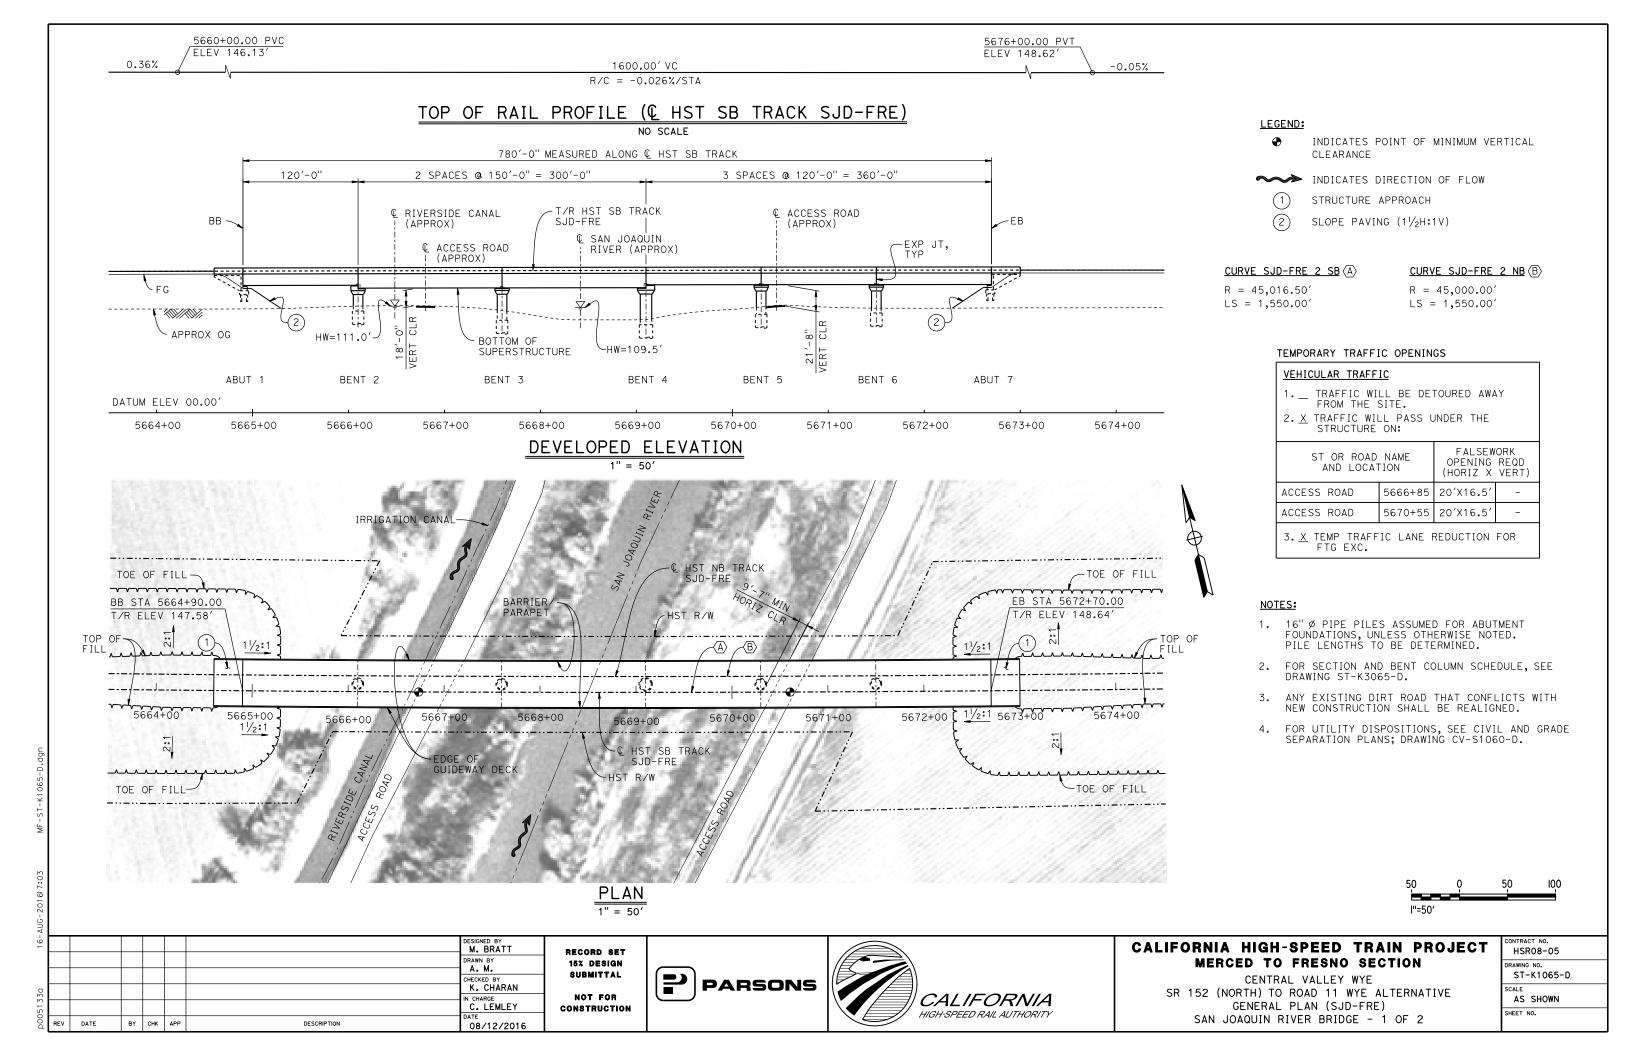

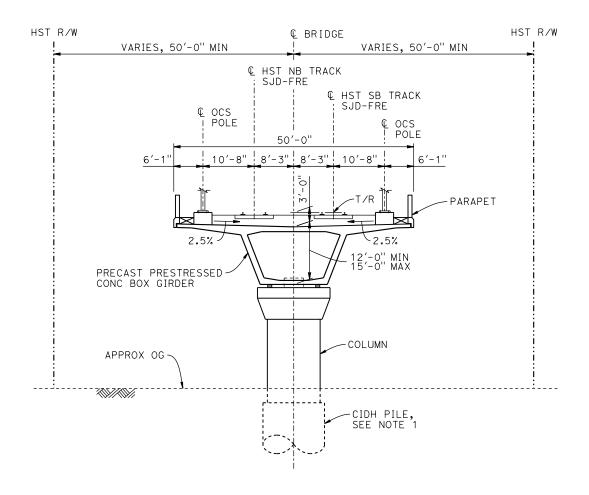

TYPICAL SECTION

BENT COLUMN SCHEDULE				
BENT	COLUMN TYPE	CIDH		
2	13'-0" Ø	15'-0" Ø		
3	14'-0'' Ø	16'-0" Ø		
4	13′-0" ø	15'-0" Ø		
5 - 6	11'-0" Ø	13'-0" Ø		

NOTES:

- 1. PILE AND DRILLED SHAFT LENGTHS TO BE DETERMINED.
- 2. FOR TRACK SUPERELEVATION DETAILS, SEE ALIGNMENT AND TYPICAL SECTION PLANS; DRAWING TT-B0050-D AND TT-B0052-D.



ΑŪ								
15-							DESIGNED BY M. BRATT	
							DRAWN BY	
							CHECKED BY	
330							K. CHARAN IN CHARGE	
051							C. LEMLEY	C.
ОД	REV	DATE	BY	CHK	APP	DESCRIPTION	08/12/2016	

RECORD SET
15% DESIGN
SUBMITTAL
NOT FOR
CONSTRUCTION








CALIFORNIA HIGH-SPEED TRAIN PROJECT MERCED TO FRESNO SECTION


CENTRAL VALLEY WYE
SR 152 (NORTH) TO ROAD 11 WYE ALTERNATIVE
TYPICAL SECTION (SJD-FRE)
SAN JOAQUIN RIVER BRIDGE - 2 OF 2

CONTRACT NO.
HSR08-05
DRAWING NO.
ST-K3065-D
SCALE
AS SHOWN
SHEET NO.

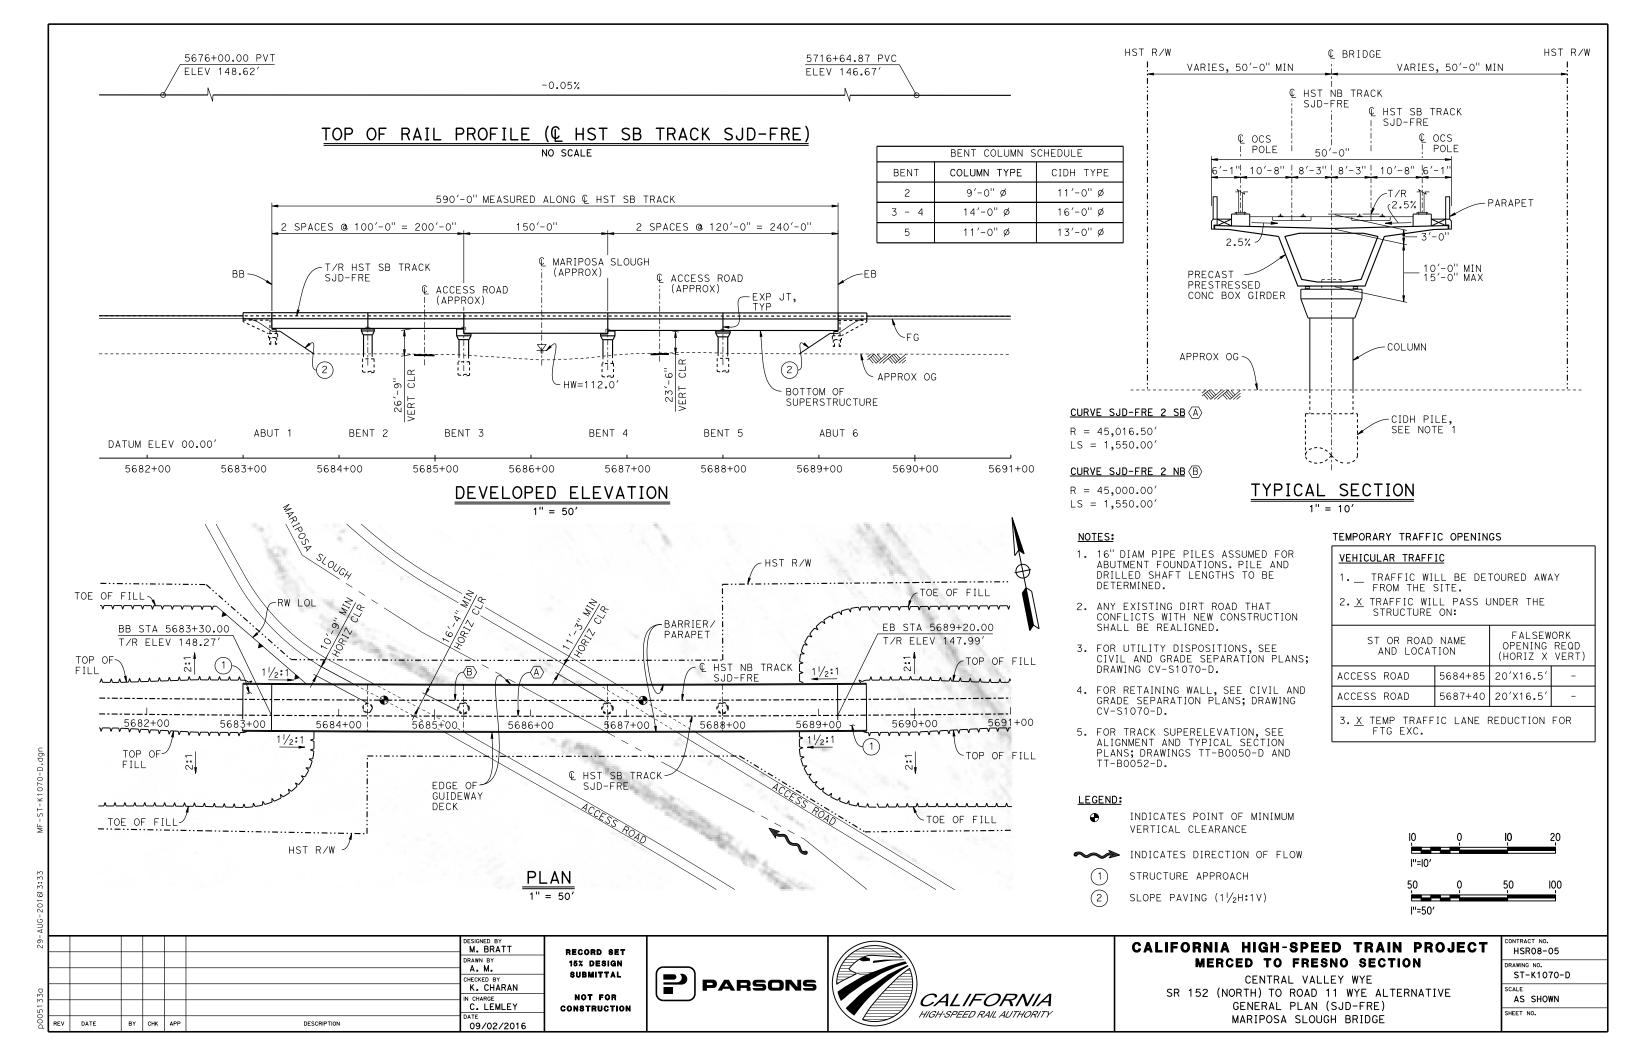

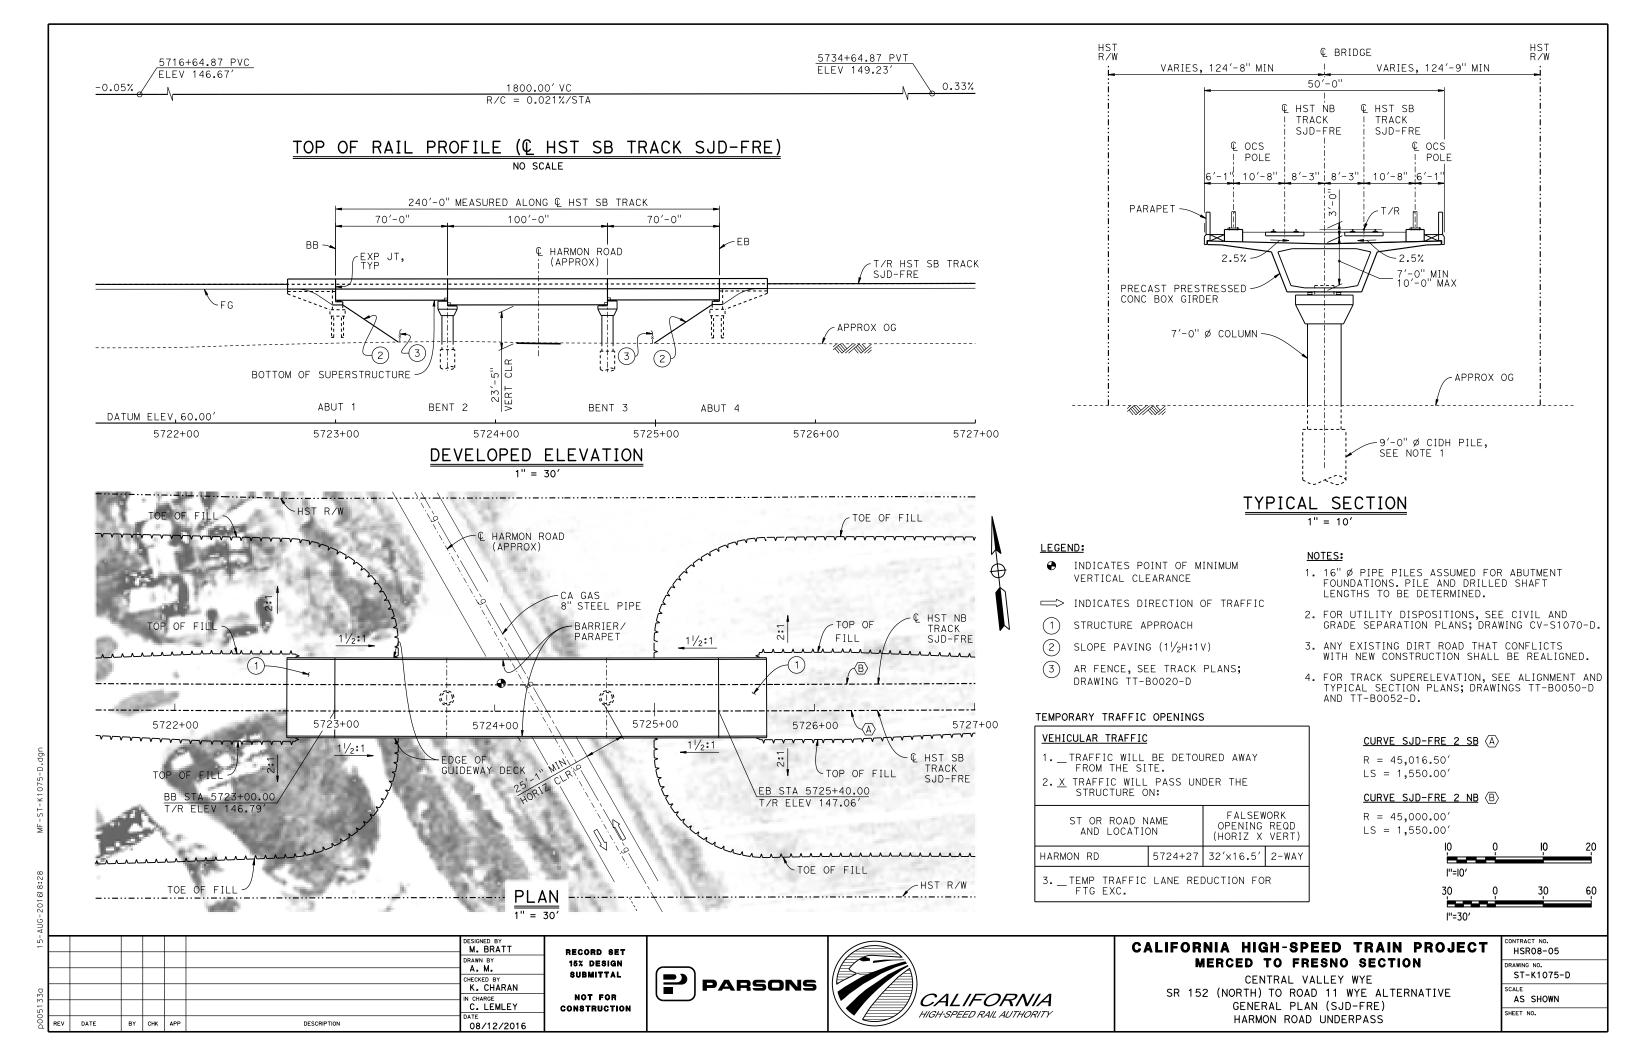

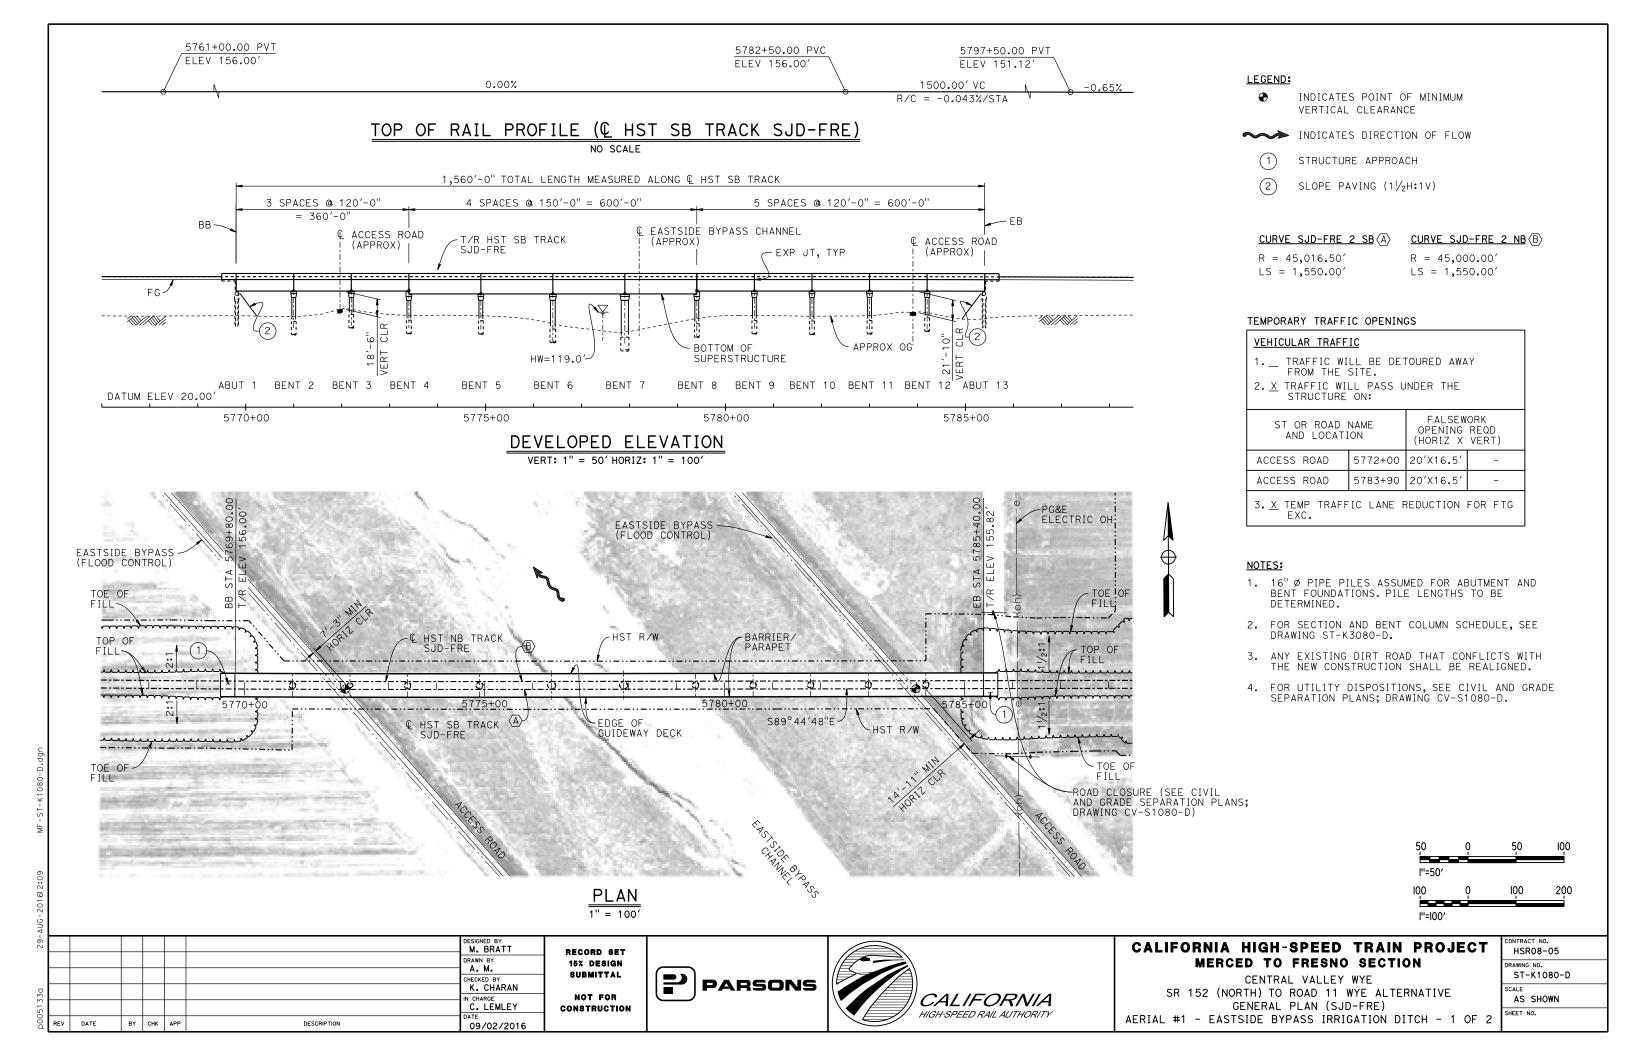

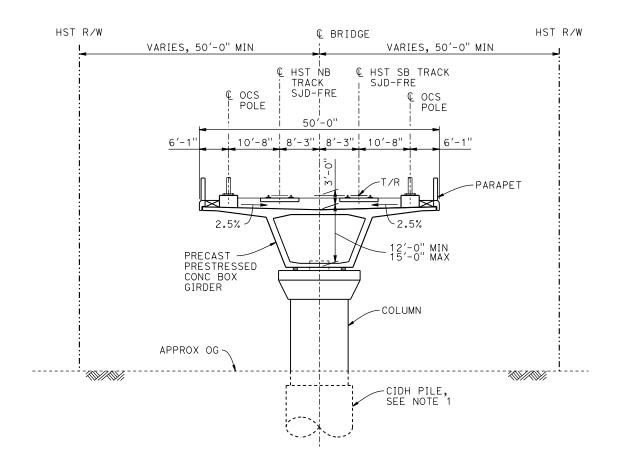

TYPICAL SECTION

1" = 10'

BENT COLUMN SCHEDULE				
BENT	COLUMN TYPE	CIDH		
2	10'-0" Ø	12'-0" Ø		
3	9'-0" Ø	11'-0" Ø		
4-5	10'-0" Ø	12'-0" Ø		
6	11'-0" Ø	13'-0" Ø		
7	13'-0" Ø	15'-0" Ø		
8-10	10'-0" Ø	12'-0" Ø		
11-12	9'-0" ø	11'-0" Ø		

NOTES:

- 1. PILE LENGTHS TO BE DETERMINED.
- 2. FOR TRACK SUPERELEVATION DETAILS, SEE ALIGNMENT AND TYPICAL SECTION PLANS; DRAWINGS TT-B0050-D AND TT-B0052-D.



ΑOC								
15-							DESIGNED BY M. BRATT	Γ,
							DRAWN BY	
0							CHECKED BY K. CHARAN	
5133							- IN CHARGE C. LEMLEY	_c ,
00d	REV	DATE	BY	СНК	APP	DESCRIPTION	DATE 08/12/2016	

RECORD SET
15% DESIGN
SUBMITTAL
NOT FOR
CONSTRUCTION








CALIFORNIA HIGH-SPEED TRAIN PROJECT MERCED TO FRESNO SECTION

CENTRAL VALLEY WYE
SR 152 (NORTH) TO ROAD 11 WYE ALTERNATIVE
TYPICAL SECTION (SJD-FRE)
AERIAL #1 - EASTSIDE BYPASS IRRIGATION DITCH - 2 OF 2

-	CONTRACT NO.
	HSR08-05
	DRAWING NO.
	ST-K3080-D
	SCALE
	AS SHOWN
2	SHEET NO.

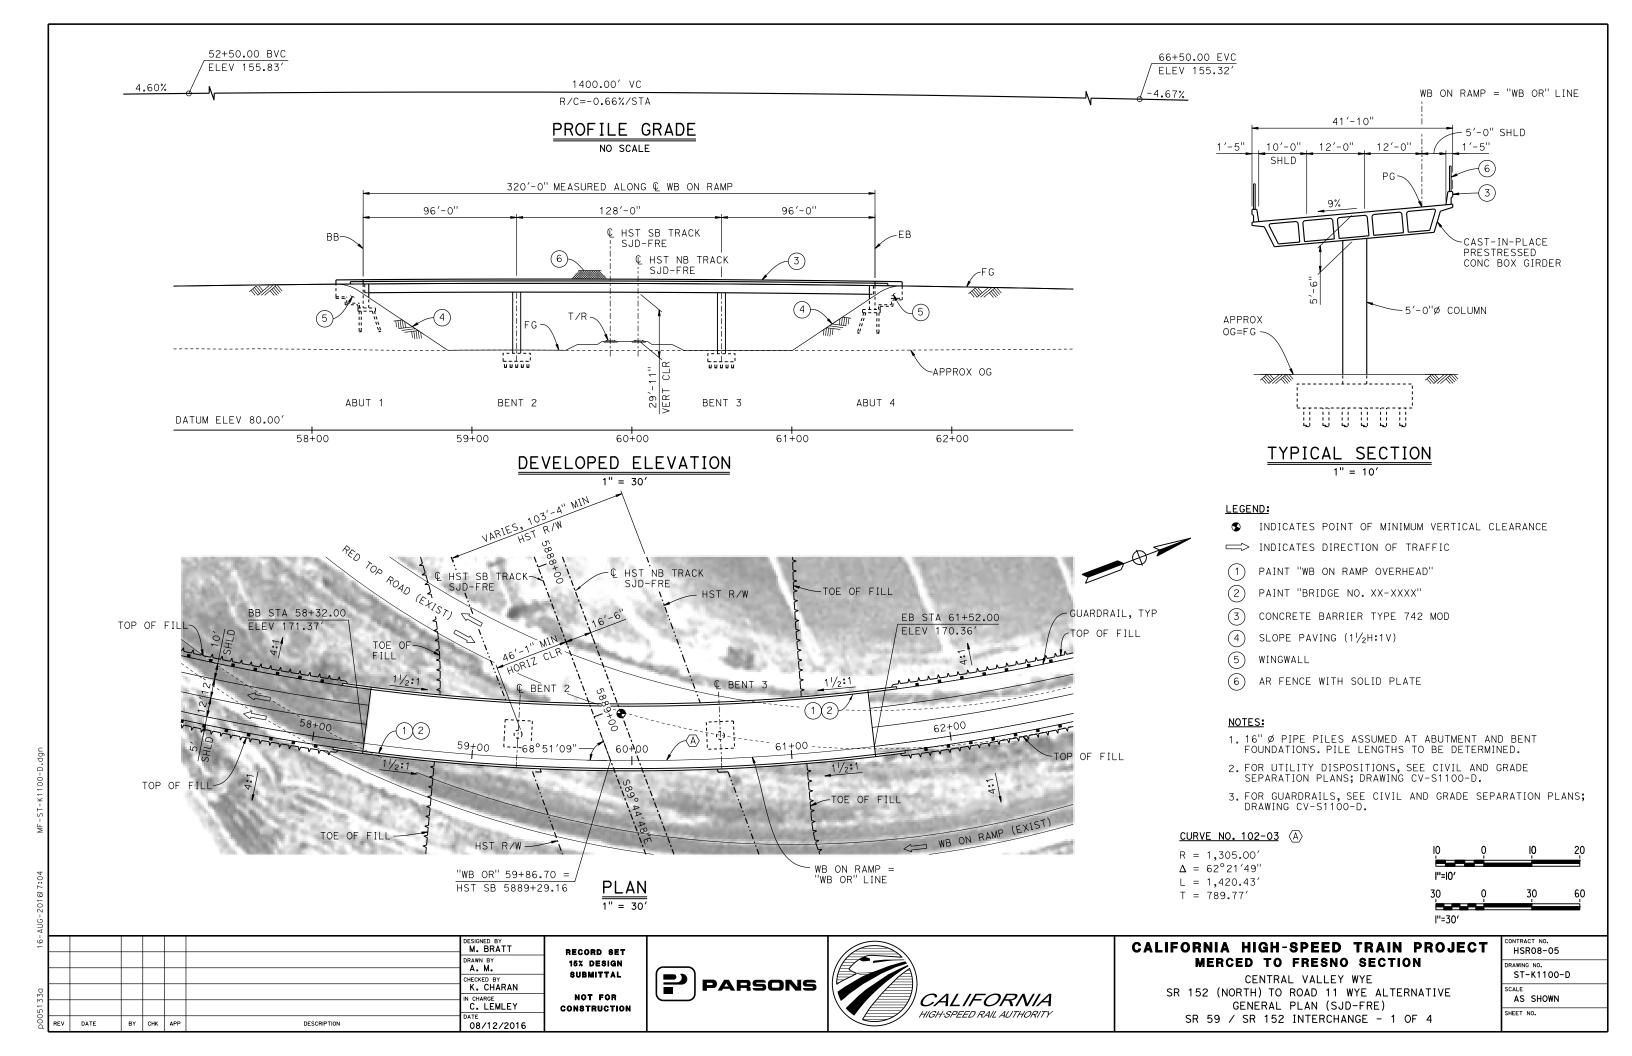

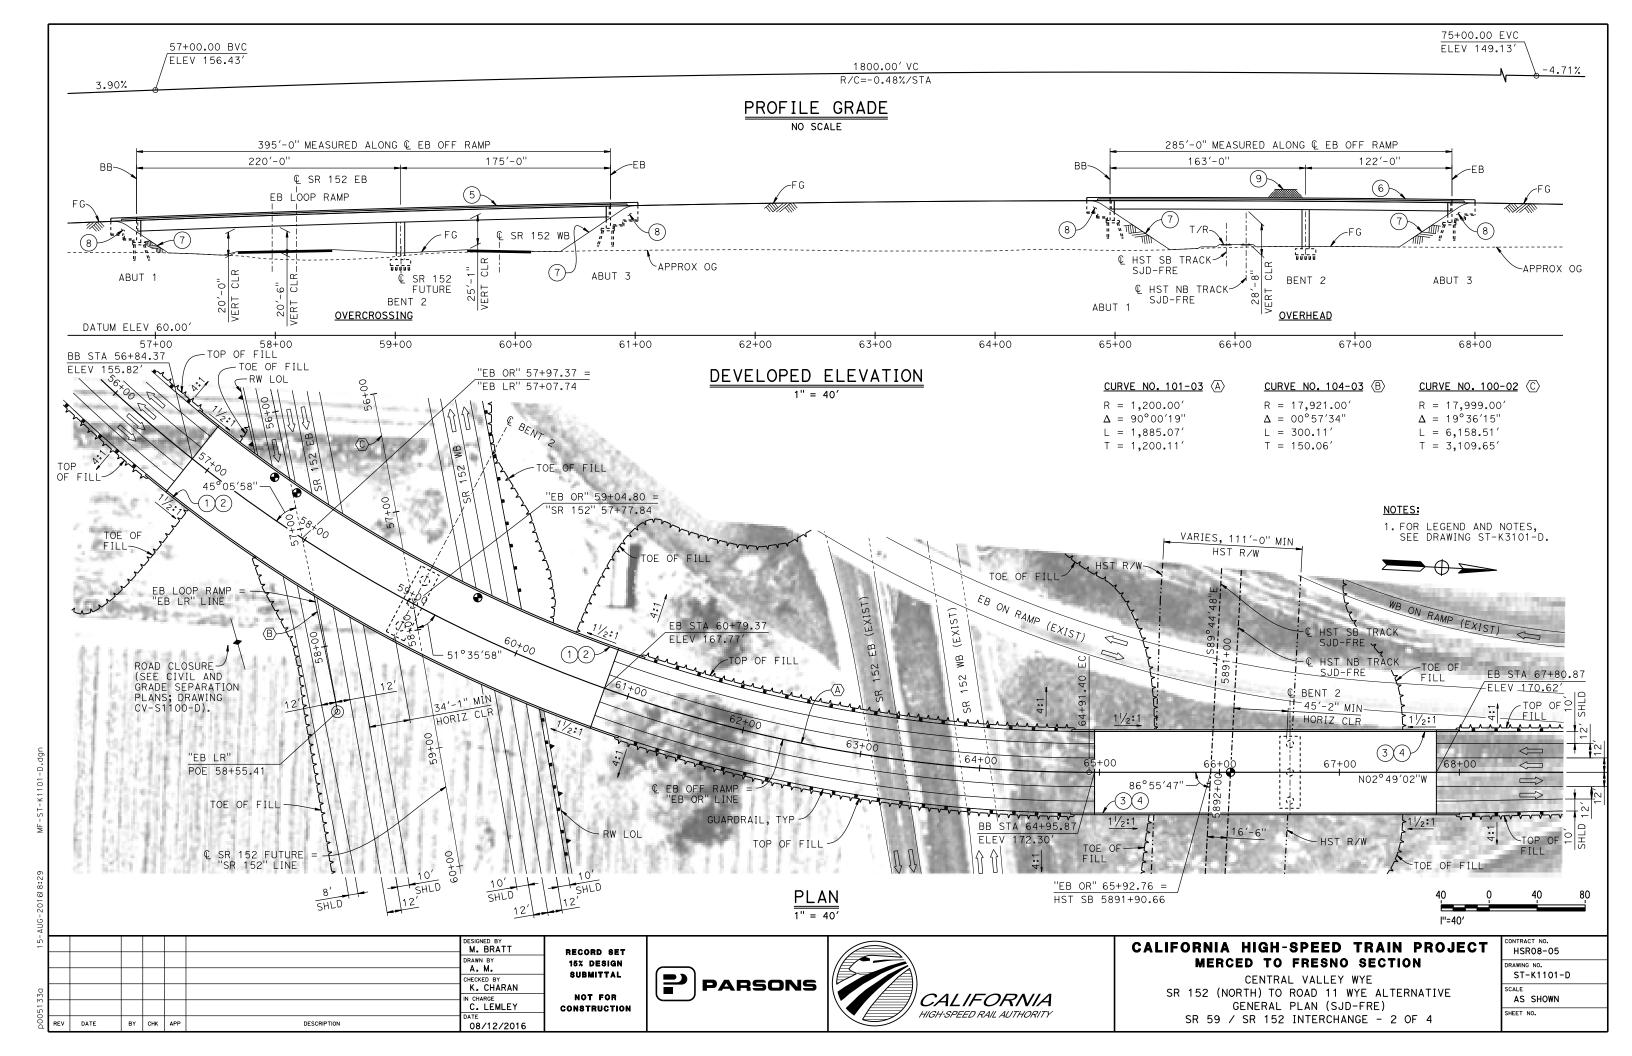

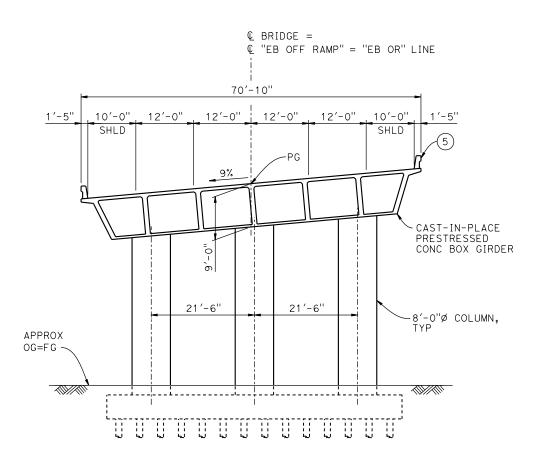


TYPICAL SECTION AT OVERCROSSING

TEMPORARY TRAFFIC OPENINGS

VEHICULAR TRAFFIC				
1 TRAFFIC WILL BE DETOURED AWAY FROM THE SITE. 2. X TRAFFIC WILL PASS UNDER THE STRUCTURE ON:				
ST OR ROAD N AND LOCATIO		FALSEW OPENING (HORIZ X	REQD	
SR 152	57+97	40′X16.5′	E BND	
SR 152	59+88	40′X16.5′	W BND	
3. — TEMP TRAFFIC LANE REDUCTION FOR FTG EXC.				

<u>LEGEND:</u>

- ♠ INDICATES POINT OF MINIMUM VERTICAL CLEARANCE
- 1) PAINT "EB OFF RAMP OVERCROSSING"
- (2) PAINT "BRIDGE NO. XX-XXXX"
- (3) PAINT "EB OFF RAMP OVERHEAD"
- (4) PAINT "BRIDGE NO. XX-XXXX"
- (5) CONCRETE BARRIER TYPE 742
- (6) CONCRETE BARRIER TYPE 736 MOD
- (7) SLOPE PAVING $(1\frac{1}{2}H:1V)$
- (8) WINGWALL
- (9) AR FENCE WITH SOLID PLATE

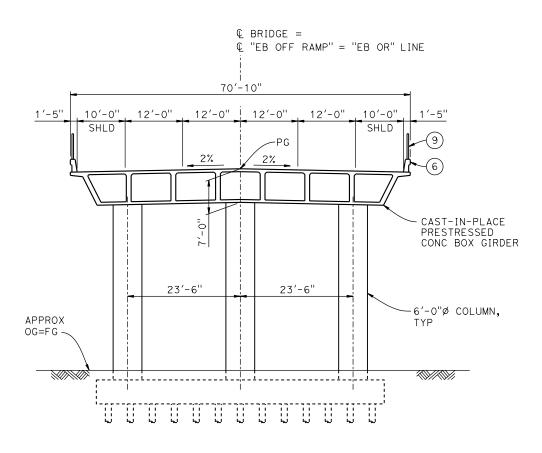

TYPICAL SECTION AT OVERHEAD

NOTES:

- 1.16" Ø PIPE PILES ASSUMED AT ABUTMENT AND BENT FOUNDATIONS. PILE LENGTHS TO BE DETERMINED.
- 2. FOR UTILITY DISPOSITIONS, SEE CIVIL AND GRADE SEPARATION PLANS; DRAWING CV-S1100-D.
- 3. FOR RETAINING WALLS, SEE CIVIL AND GRADE SEPARATION PLANS; DRAWING CV-S1100-D.
- 4. FOR GUARDRAILS, SEE CIVIL AND GRADE SEPARATION PLANS; DRAWING CV-S1100-D.



RECORD SET
15% DESIGN
SUBMITTAL
NOT FOR
CONSTRUCTION







CALIFORNIA HIGH-SPEED TRAIN PROJECT MERCED TO FRESNO SECTION

CENTRAL VALLEY WYE
SR 152 (NORTH) TO ROAD 11 WYE ALTERNATIVE
TYPICAL SECTIONS (SJD-FRE)
SR 59 / SR 152 INTERCHANGE - 3 OF 4

HSR08-05
DRAWING NO. ST-K3101-D
AS SHOWN
SHEET NO.

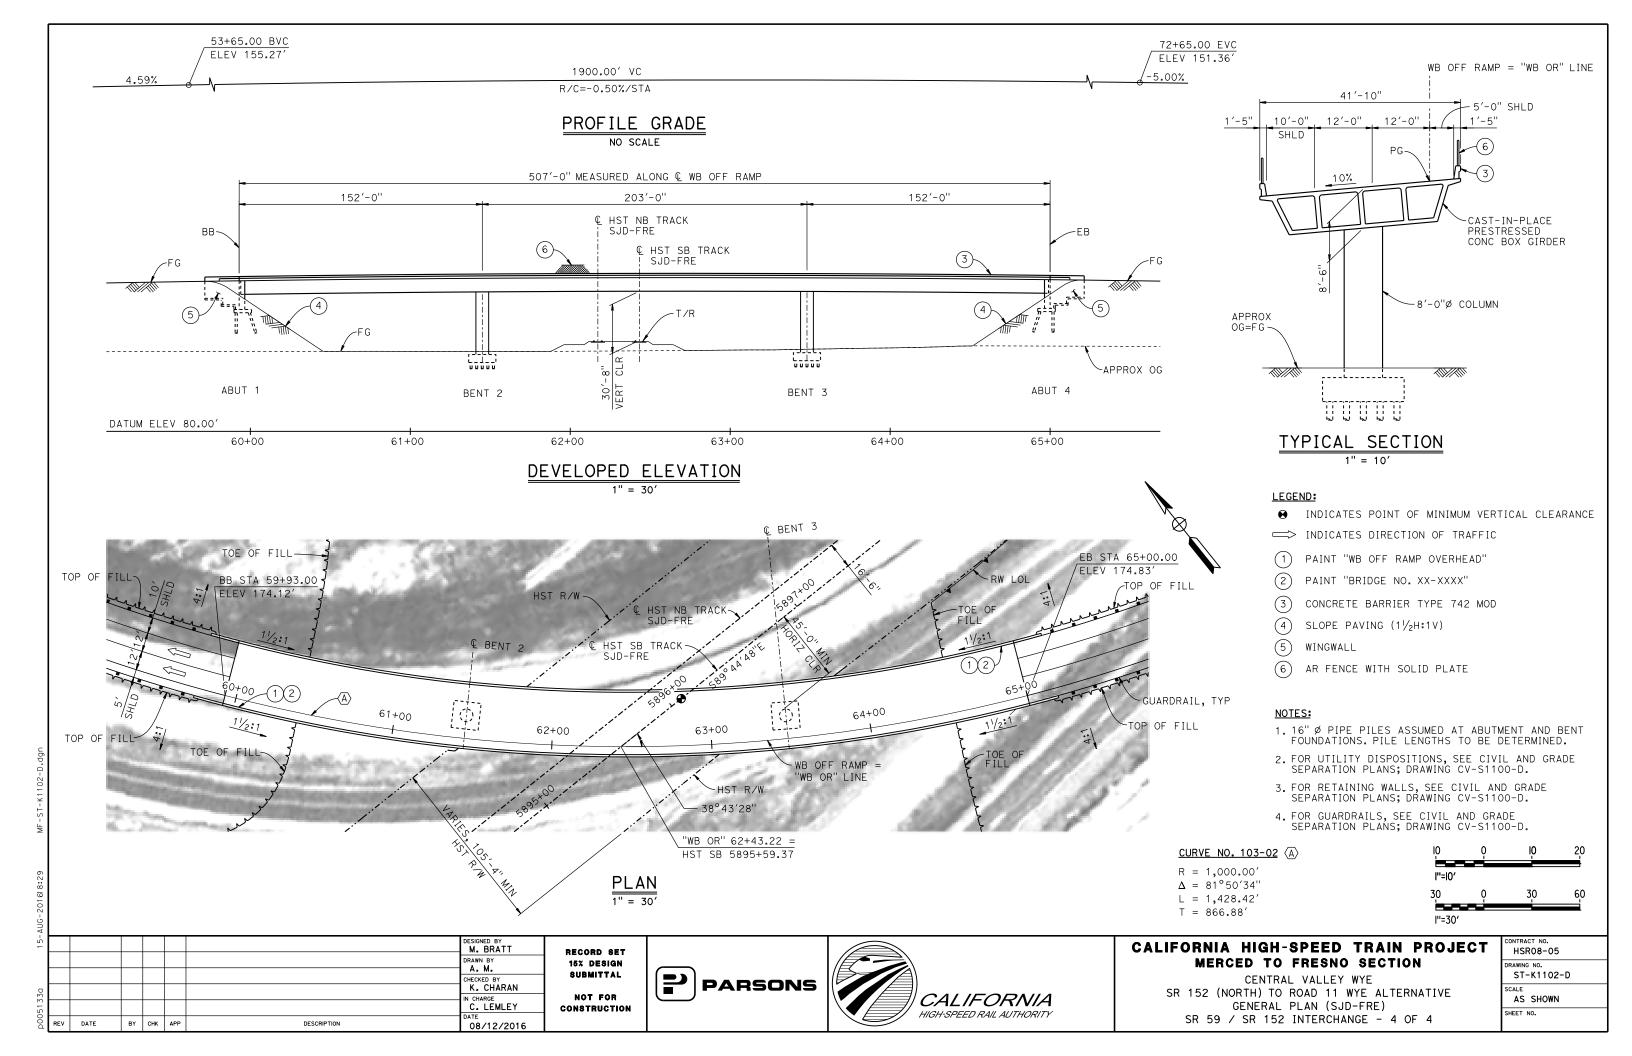

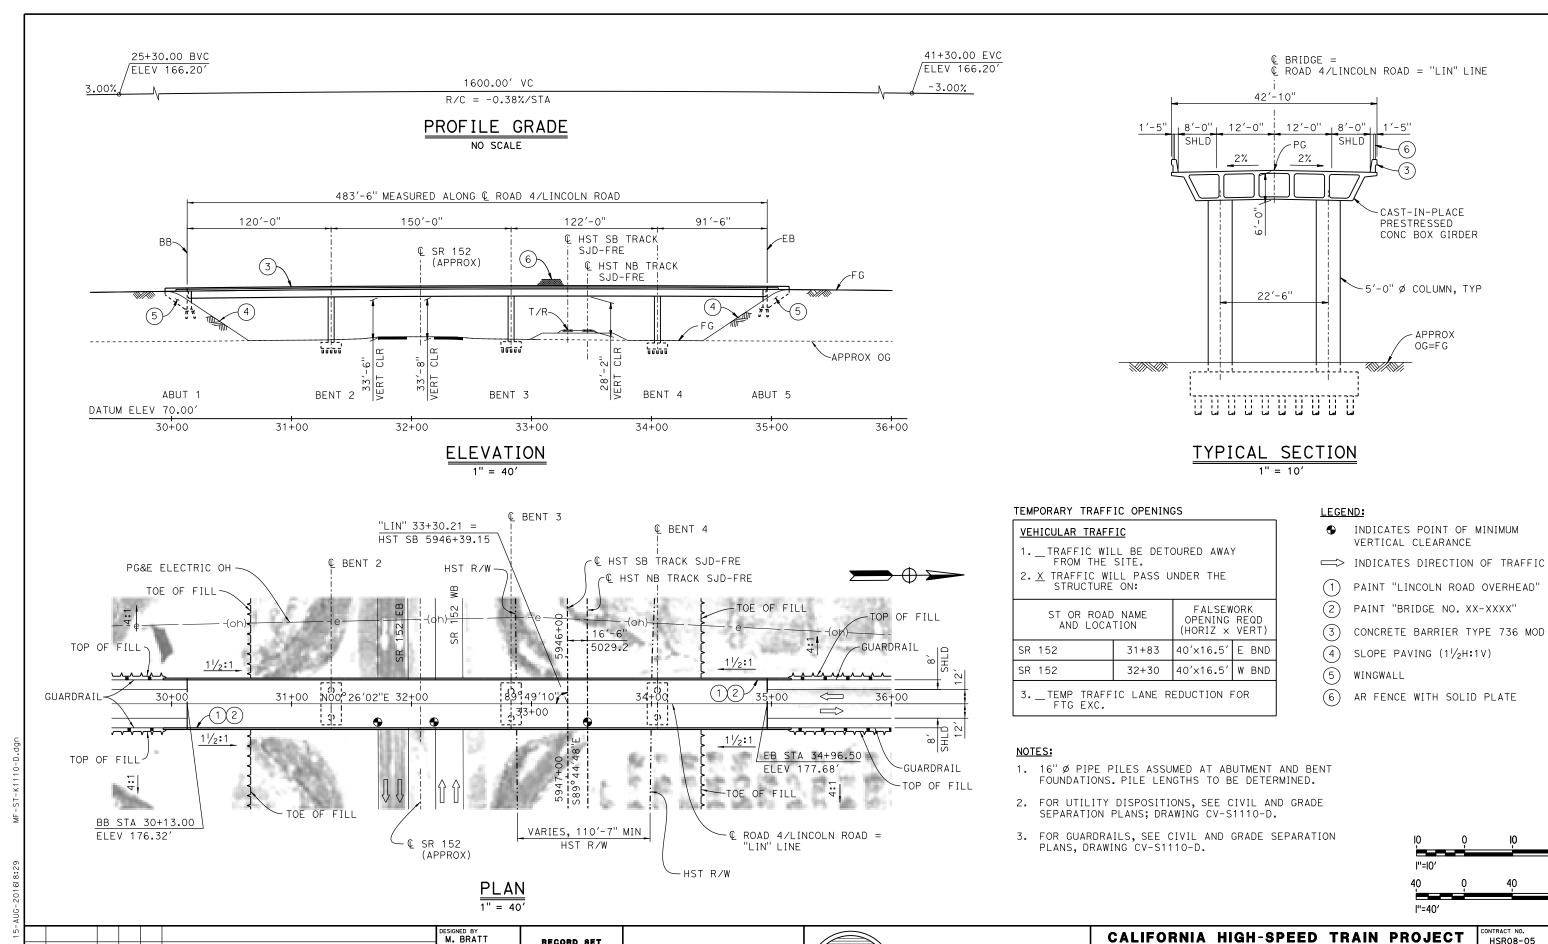

PARSONS

CALIFORNIA

HIGH-SPEED RAIL AUTHORITY

RECORD SET

15% DESIGN SUBMITTAL

NOT FOR

CONSTRUCTION

K. CHARAN

IN CHARGE
C. LEMLEY

08/12/2016

DATE


BY CHK APP


DESCRIPTION


CALIFORNIA HIGH-SPEED TRAIN PROJECT MERCED TO FRESNO SECTION

CENTRAL VALLEY WYE SR 152 (NORTH) TO ROAD 11 WYE ALTERNATIVE GENERAL PLAN (SJD-FRE) LINCOLN ROAD (ROAD 4) OVERHEAD

HSR08-05 ST-K1110-D AS SHOWN SHEET NO.

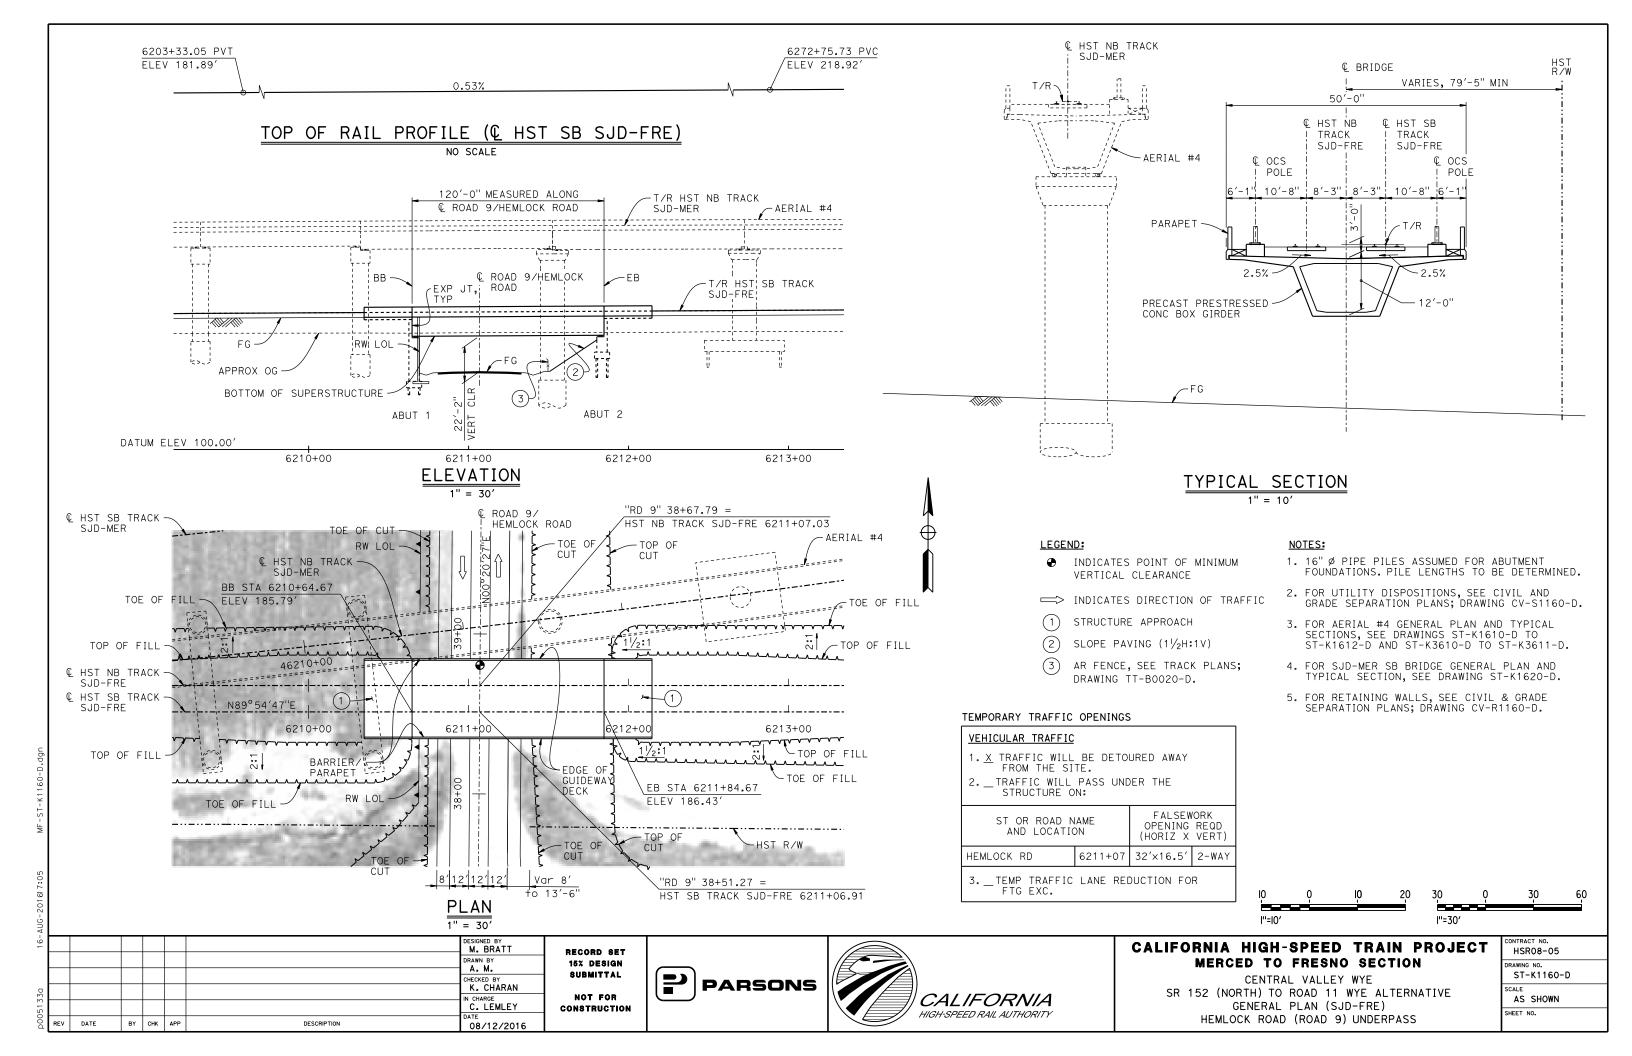

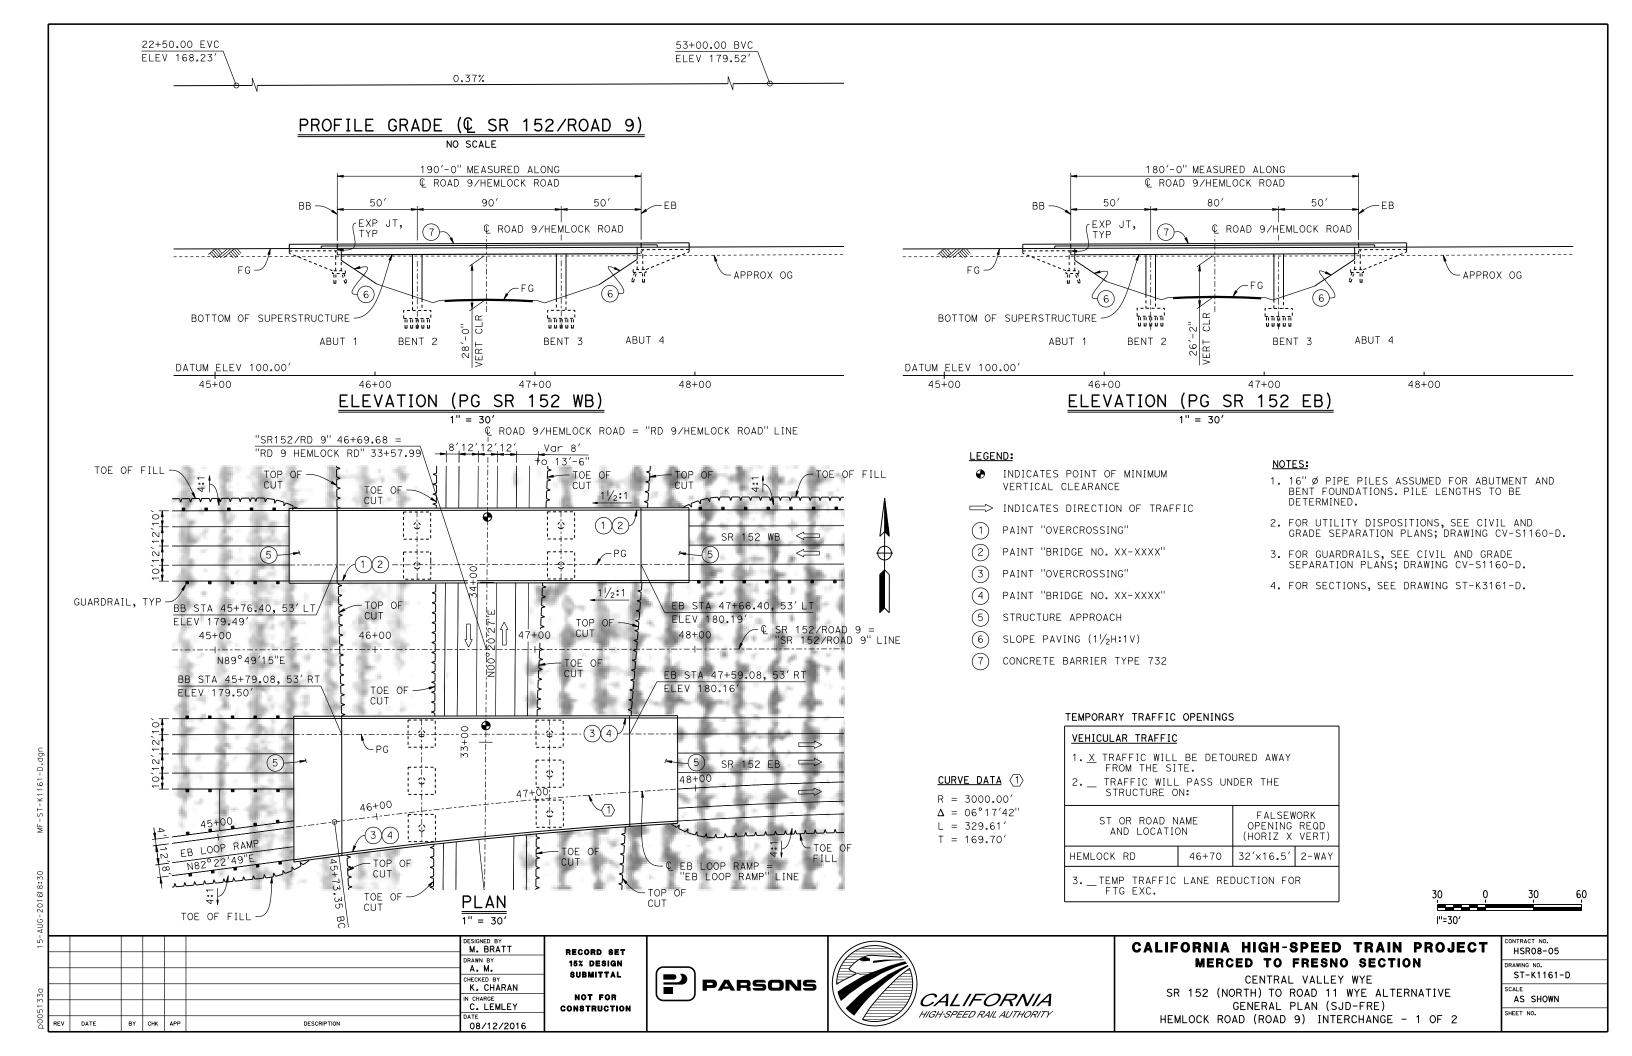

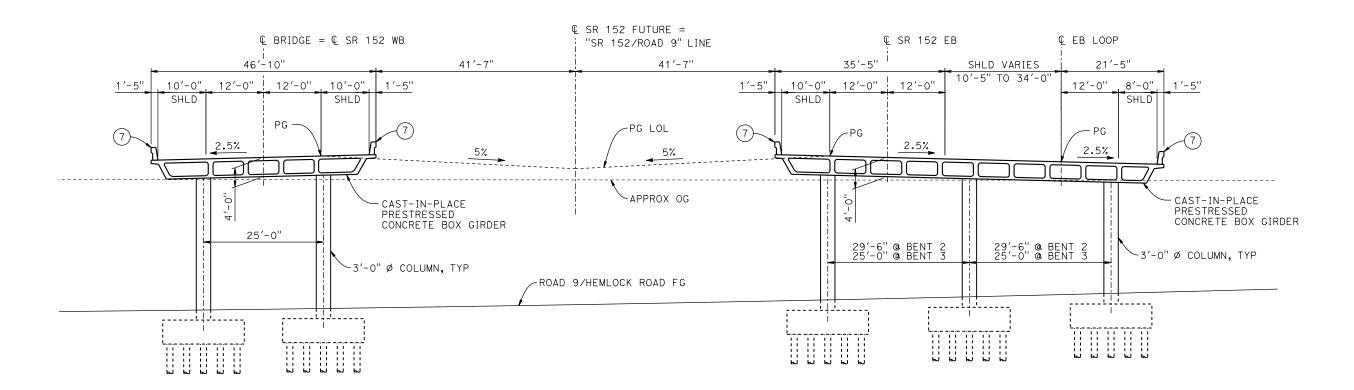

TYPICAL SECTION
1" = 10'

NOTES:

1. FOR NOTES AND LEGEND, SEE DRAWING ST-K1161-D.



ΑŬ								
-5							DESIGNED BY M. BRATT	-
							DRAWN BY	RE 18
_							CHECKED BY K. CHARAN	8
51330							IN CHARGE C. LEMLEY	COP
p0051	REV	DATE	BY	снк	APP	DESCRIPTION	DATE 08/12/2016	

RECORD SET
15% DESIGN
SUBMITTAL
NOT FOR
CONSTRUCTION







CALIFORNIA HIGH-SPEED TRAIN PROJECT MERCED TO FRESNO SECTION

CENTRAL VALLEY WYE
SR 152 (NORTH) TO ROAD 11 WYE ALTERNATIVE
TYPICAL SECTION (SJD-FRE)
HEMLOCK ROAD (ROAD 9) INTERCHANGE - 2 OF 2

CONTRACT NO.
HSR08-05
DRAWING NO.
ST-K3161-D
SCALE
AS SHOWN
SHEET NO.

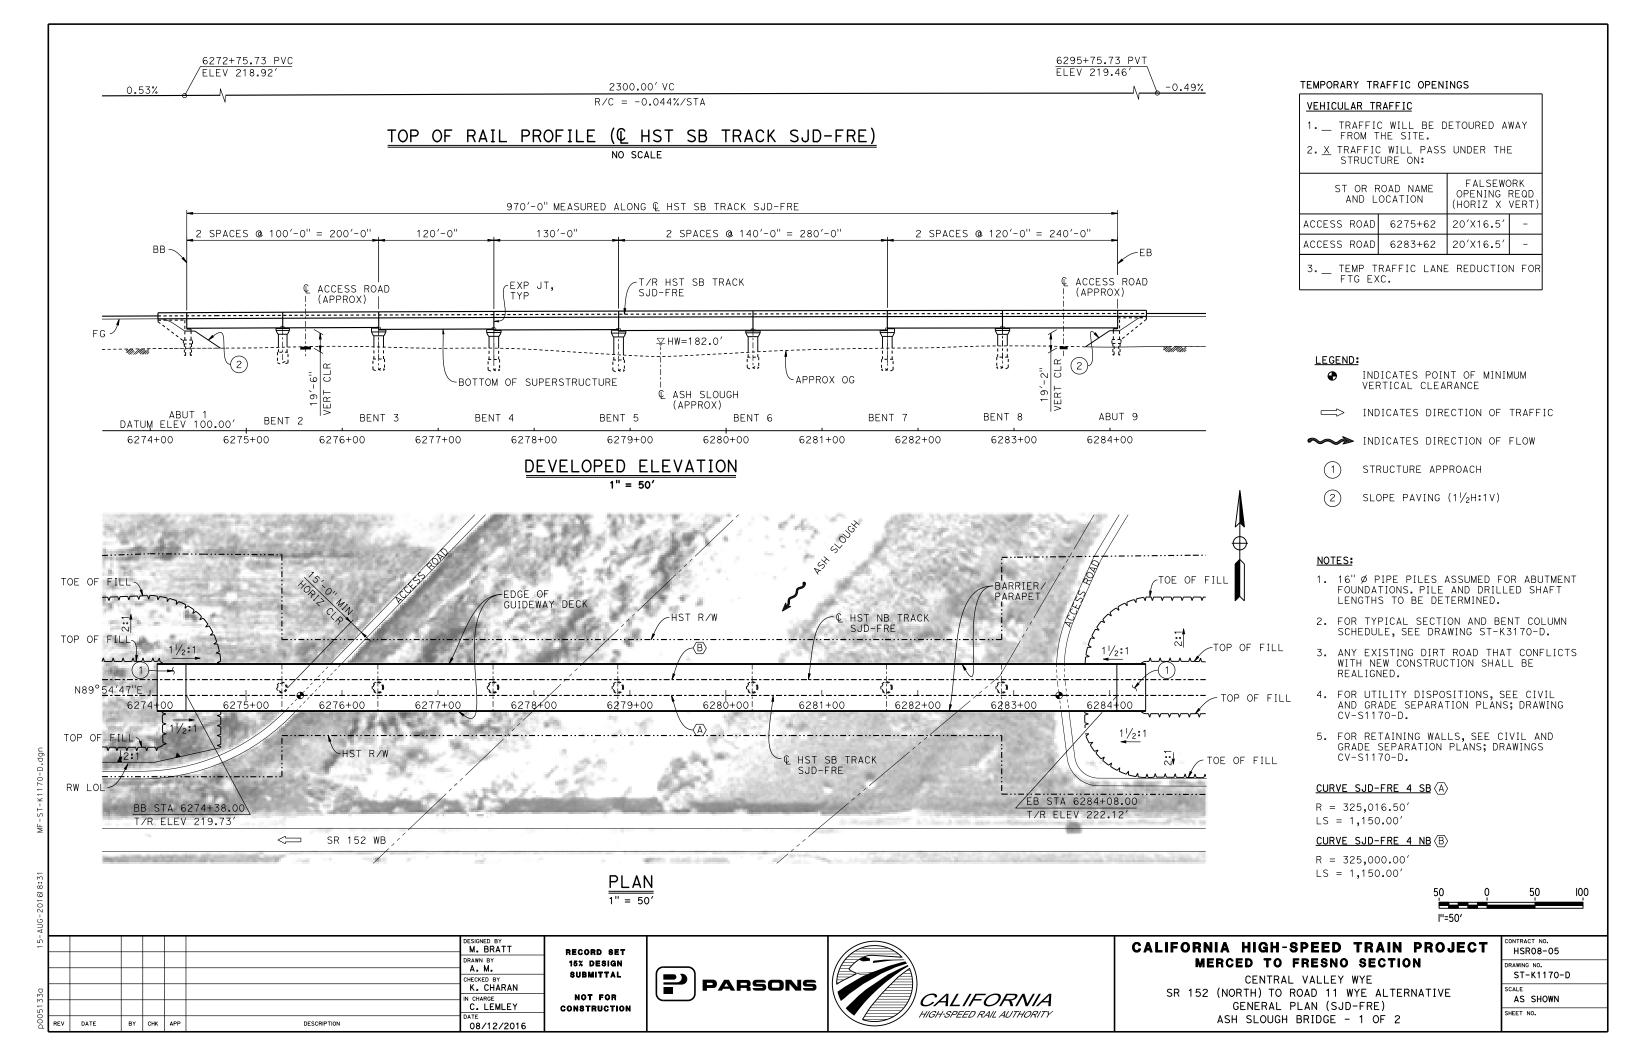

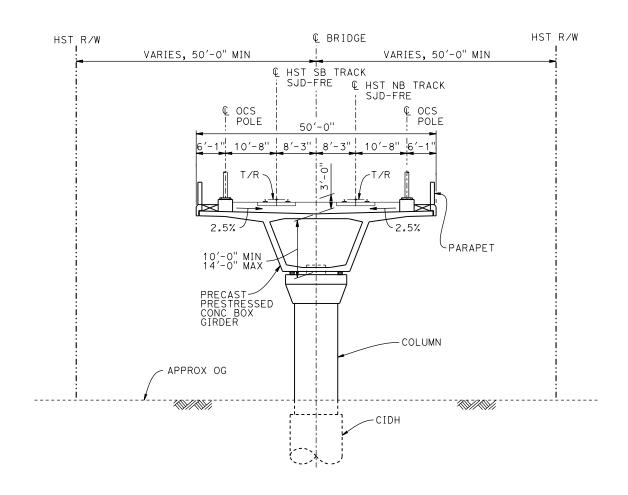

TYPICAL SECTION

NOT

1. DRILLED SHAFT LENGTHS TO BE DETERMINED.

BENT COLUMN SCHEDULE

CIDH

11'-0'' Ø

12'-0'' Ø

COLUMN TYPE

9'-0" ø

10'-0" Ø

BENT

2

2. FOR TRACK SUPERELEVATION DETAILS, SEE ALIGNMENT AND TYPICAL SECTION PLANS; DRAWINGS TT-B0051-D AND TT-B0053-D.

0 10 20

| DESIGNED BY | M. BRATT | DRAWN BY | A. M. | CHECKED BY | K. CHARAN | IN CHARGE | C. LEMLEY | DATE | BY CHK | APP | DESCRIPTION | DATE | O8/12/2016

RECORD SET
15% DESIGN
SUBMITTAL
NOT FOR
CONSTRUCTION







CALIFORNIA HIGH-SPEED TRAIN PROJECT MERCED TO FRESNO SECTION

CENTRAL VALLEY WYE
SR 152 (NORTH) TO ROAD 11 WYE ALTERNATIVE
TYPICAL SECTION (SJD-FRE)
ASH SLOUGH BRIDGE - 2 OF 2

CONTRACT NO. HSR08-05
DRAWING NO. ST-K3170-D
AS SHOWN
SHEET NO.

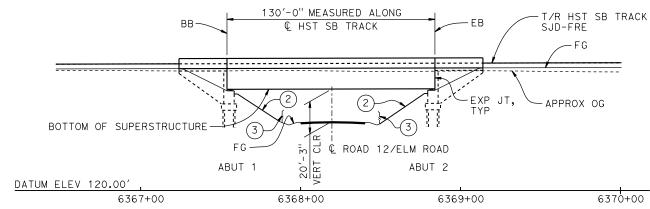


ELEVATION

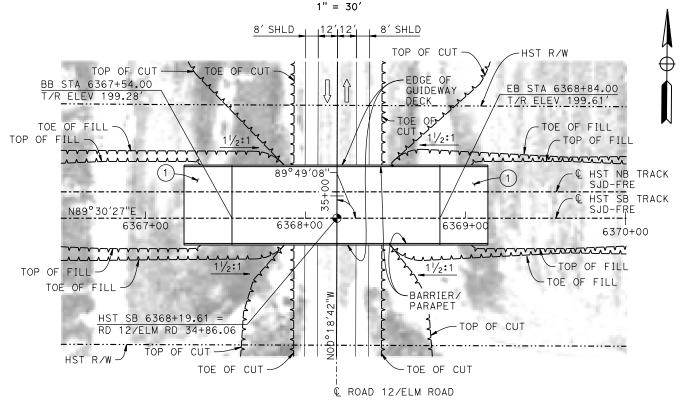

PLAN

LEGEND:

- INDICATES POINT OF MINIMUM
 VERTICAL CLEARANCE
- (1) STRUCTURE APPROACH
- 2 SLOPE PAVING $(1\frac{1}{2}H:1V)$
- AR FENCE, SEE TRACK PLANS; DRAWING TT-B0020-D

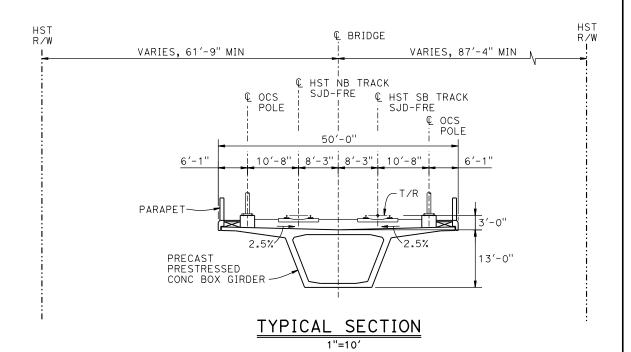

TEMPORARY TRAFFIC OPENINGS

VEHICULAR TRAFFIC

- 1. \underline{X} TRAFFIC WILL BE DETOURED AWAY FROM THE SITE.
- 2. TRAFFIC WILL PASS UNDER THE STRUCTURE ON:

STREET OR ROAD NAME
AND LOCATION

FALSEWORK
OPENING REQD
(HORIZ X VERT)

ROAD 12/ELM ROAD 6368+20 32'x16.5' 2-WAY

3. __TEMP TRAFFIC LANE REDUCTION FOR FTG EXC.

NOTES:

- 16"Ø PIPE PILES ASSUMED FOR ABUTMENT FOUNDATIONS. PILE LENGTHS TO BE DETERMINED.
- 2. FOR UTILITY DISPOSITIONS, SEE CIVIL AND GRADE SEPARATION PLANS; DRAWING CV-S1190-D.



⋖								
-61							DESIGNED BY M. BRATT	Ι,
							DRAWN BY A. M.	l '
							CHECKED BY	l
3a							K. CHARAN IN CHARGE	l
0513							C. LEMLEY	c
poc	REV	DATE	BY	СНК	APP	DESCRIPTION	08/12/2016	

RECORD SET
15% DESIGN
SUBMITTAL
NOT FOR
CONSTRUCTION








CALIFORNIA HIGH-SPEED TRAIN PROJECT MERCED TO FRESNO SECTION

CENTRAL VALLEY WYE
SR 152 (NORTH) TO ROAD 11 WYE ALTERNATIVE
GENERAL PLAN (SJD-FRE)
ELM ROAD (ROAD 12) UNDERPASS


CONTRACT NO. HSRO8-05	
DRAWING NO. ST-K1190-D	
31-41190-0	
SCALE	
AS SHOWN	
SHEET NO.	

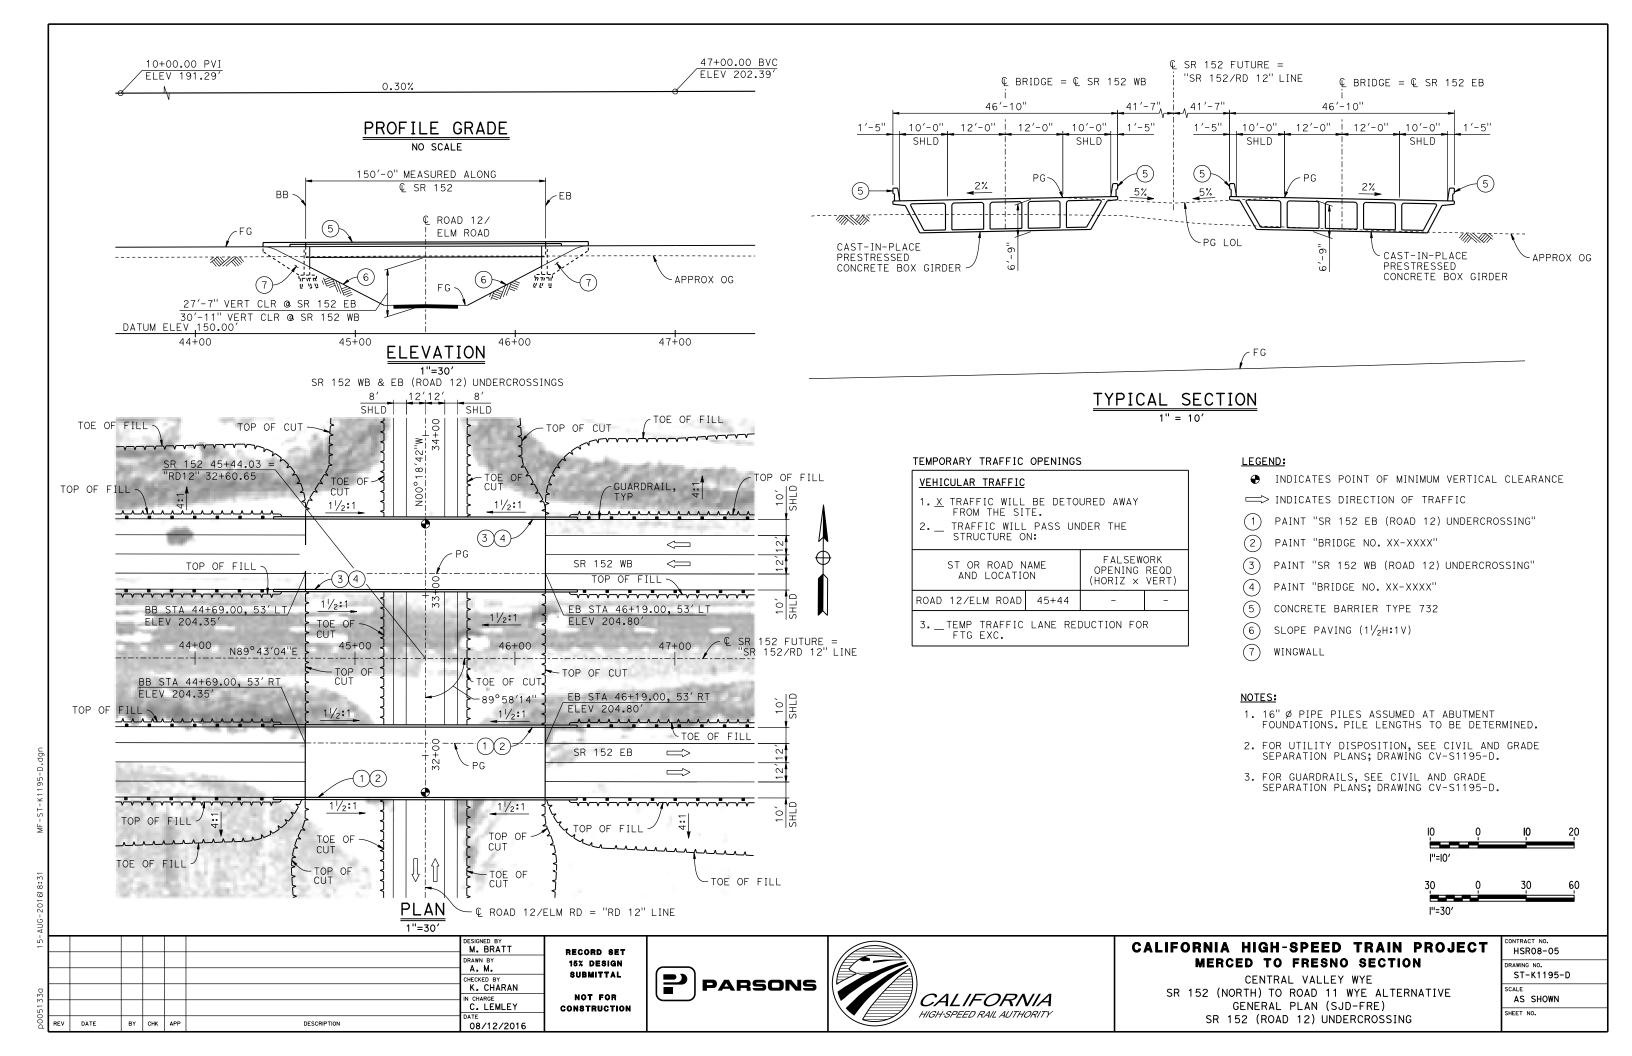

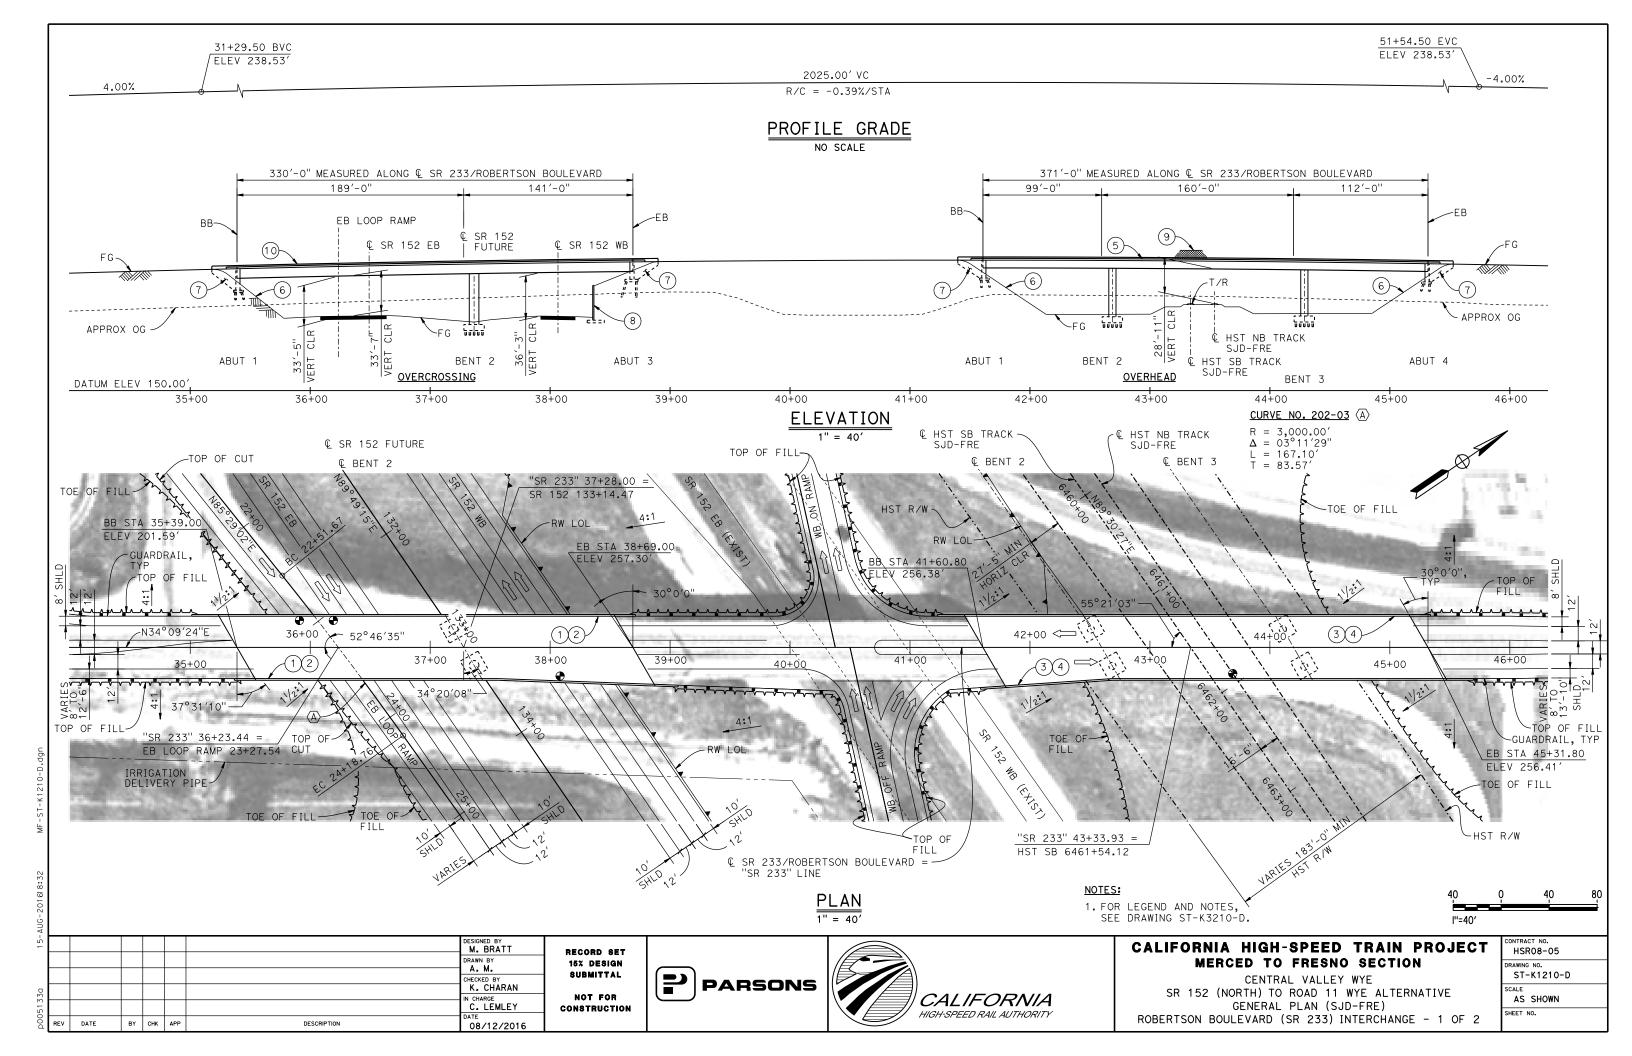

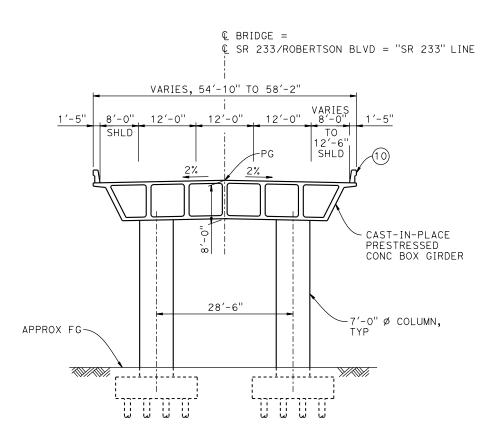

TYPICAL SECTION AT OVERCROSSING

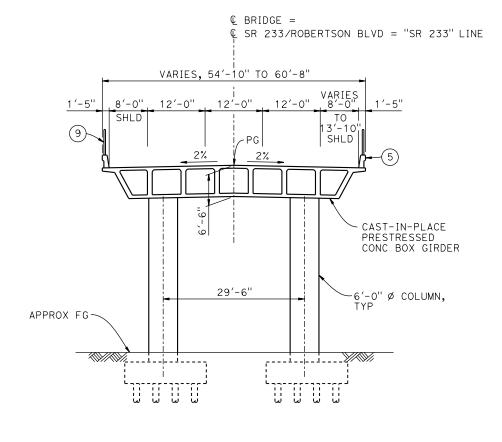

TYPICAL SECTION AT OVERHEAD

TEMPORARY TRAFFIC OPENINGS

VEHICULAR TRAFFIC 1. _ TRAFFIC WILL BE DETOURED AWAY FROM THE SITE. 2. X TRAFFIC WILL PASS UNDER THE STRUCTURE ON: FALSEWORK OPENING REQD ST OR ROAD NAME AND LOCATION (HORIZ X VERT) SR 152 40'X16.5' 38+08 40'X16.5' 3. _ TEMP TRAFFIC LANE REDUCTION FOR FTG EXC.

- ◆ INDICATES POINT OF MINIMUM VERTICAL CLEARANCE
- PAINT "ROBERTSON BLVD OVERCROSSING"
- 2 PAINT "BRIDGE NO. XX-XXXX"
- PAINT "ROBERTSON BLVD OVERHEAD"
- 4 PAINT "BRIDGE NO. XX-XXXX"
- CONCRETE BARRIER TYPE 736 MOD
- 6 SLOPE PAVING $(1\frac{1}{2}H:1V)$
- (7)WINGWALL
- (8) RETAINING WALL
- AR FENCE WITH SOLID PLATE
- CONCRETE BARRIER TYPE 732 MOD

- 1.16" \not PIPE PILES ASSUMED AT ABUTMENT AND BENT FOUNDATIONS. PILE LENGTHS TO BE DETERMINED.
- 2. FOR UTILITY DISPOSITIONS, SEE CIVIL AND GRADE SEPARATION PLANS; DRAWING CV-S1210-D.
- 3. FOR RETAINING WALLS, SEE CIVIL AND GRADE SEPARATION PLANS; DRAWING CV-S1210-D.
- 4. FOR GUARDRAILS, SEE CIVIL AND GRADE SEPARATION PLANS; DRAWING CV-S1210-D.

M. BRATT DRAWN BY K. CHARAN IN CHARGE
C. LEMLEY CONSTRUCTION DATE BY CHK APP DESCRIPTION 08/12/2016

RECORD SET 15% DESIGN SUBMITTAL NOT FOR







CALIFORNIA HIGH-SPEED TRAIN PROJECT MERCED TO FRESNO SECTION

CENTRAL VALLEY WYE SR 152 (NORTH) TO ROAD 11 WYE ALTERNATIVE TYPICAL SECTIONS (SJD-FRE) ROBERTSON BOULEVARD (SR 233) INTERCHANGE - 2 OF 2


I	CONTRACT NO.
I	HSR08-05
ı	DRAWING NO.
I	ST-K3210-D
ı	SCALE
I	AS SHOWN
I	SHEET NO.
ı	

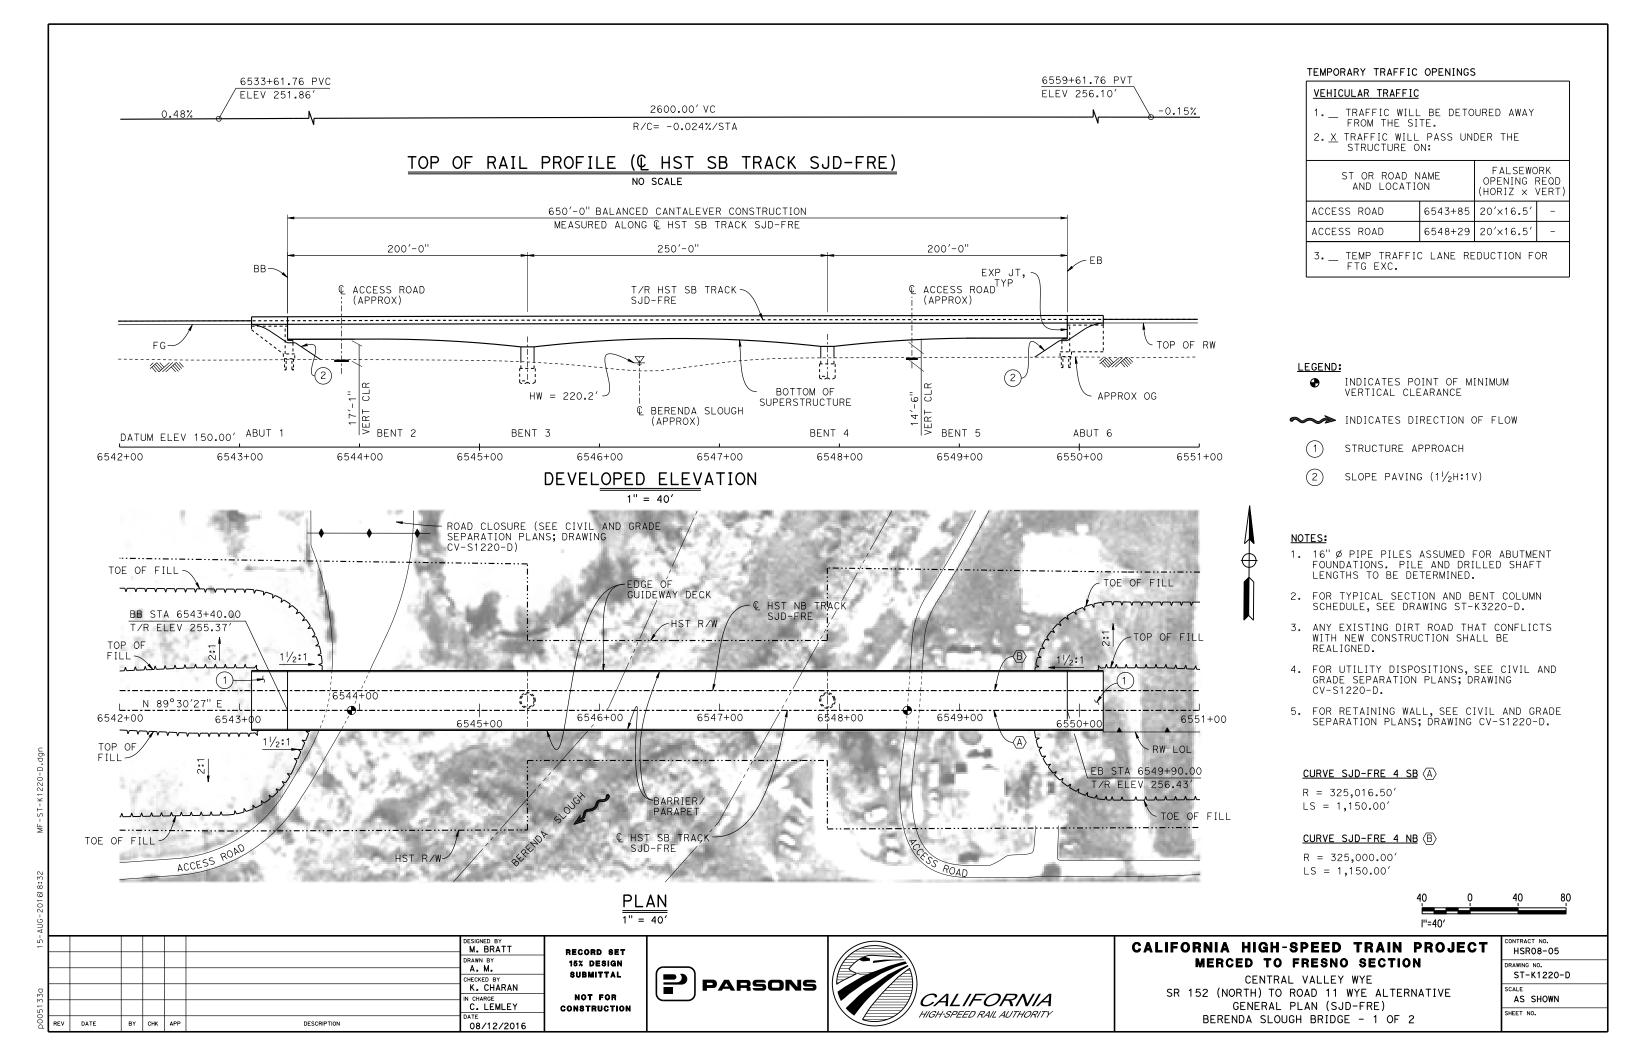

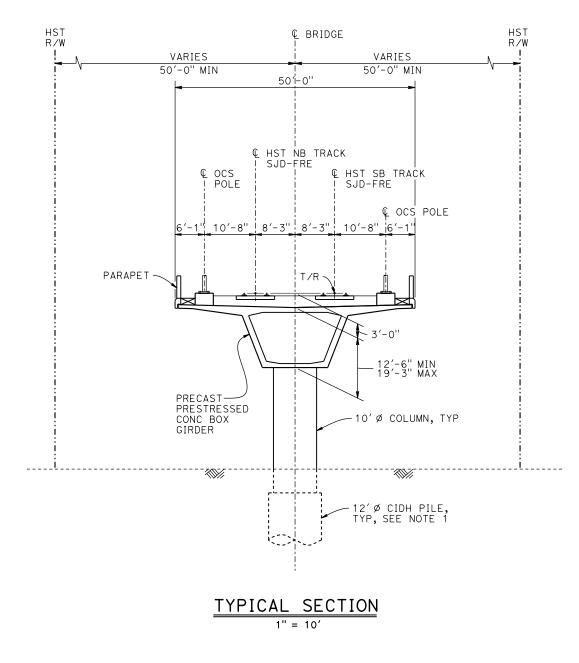

NOTE:

- 1. DRILLED SHAFT LENGTHS TO BE DETERMINED.
- 2. FOR TRACK SUPERELEVATION DETAILS, SEE ALIGNMENT AND TYPICAL SECTION PLANS; DRAWINGS TT-B0051-D AND TT-B0053-D.

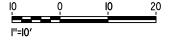

ΑU								
15-							DESIGNED BY M. BRATT	Ι,
							DRAWN BY A. M.	·
							CHECKED BY K. CHARAN	
5133a							IN CHARGE C. LEMLEY	_c
p005	REV	DATE	BY	СНК	APP	DESCRIPTION	DATE 08/12/2016	

RECORD SET
15% DESIGN
SUBMITTAL
NOT FOR
CONSTRUCTION








CALIFORNIA HIGH-SPEED TRAIN PROJECT MERCED TO FRESNO SECTION

CENTRAL VALLEY WYE
SR 152 (NORTH) TO ROAD 11 WYE ALTERNATIVE
TYPICAL SECTION (SJD-FRE)
BERENDA SLOUGH BRIDGE - 2 OF 2

HSRO8-05
DRAWING NO. ST-K3220-D
AS SHOWN
SHEET NO.

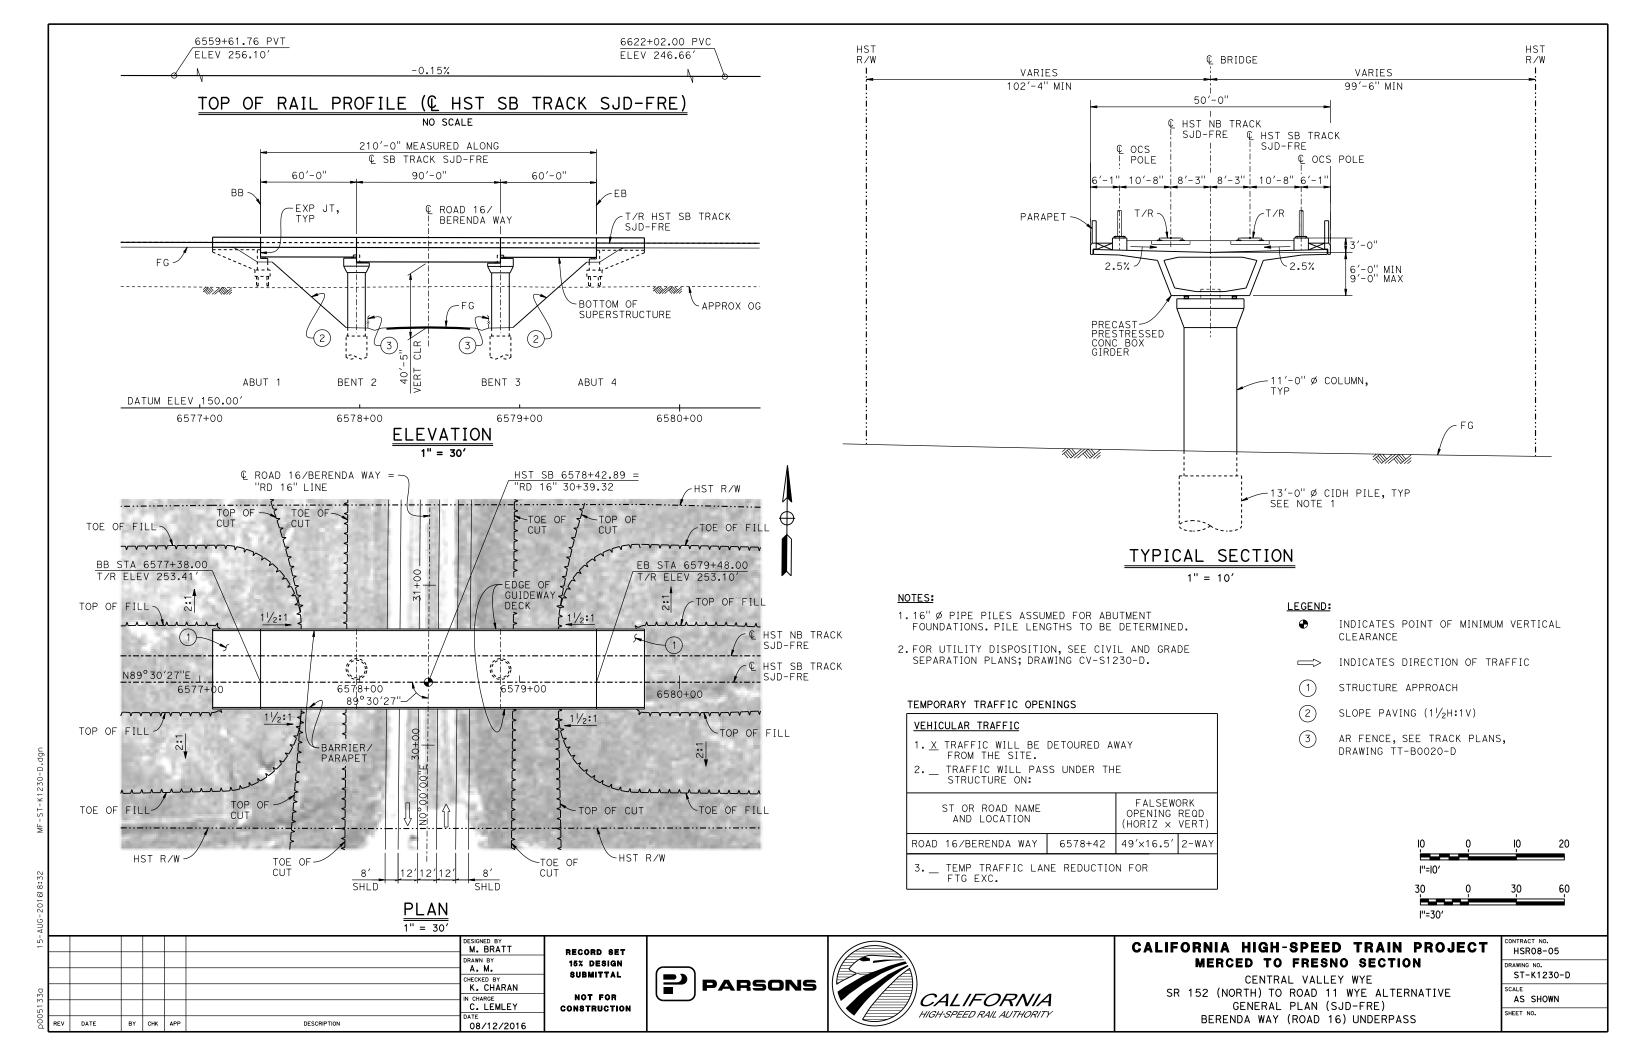

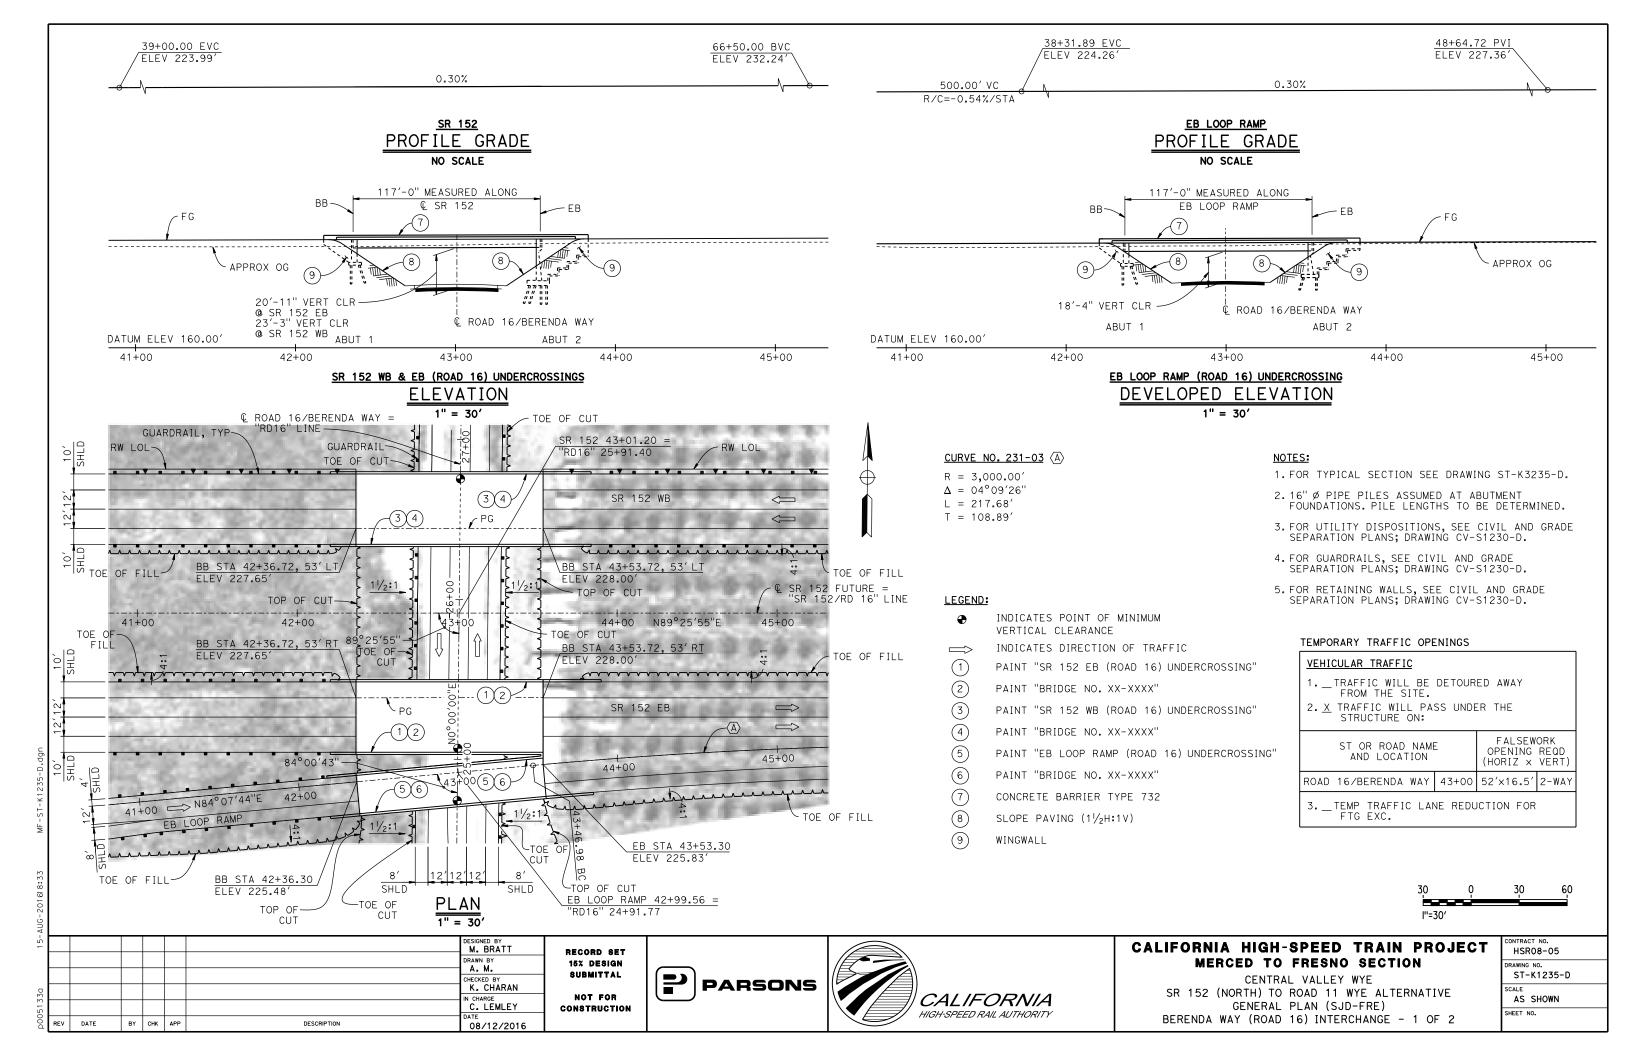

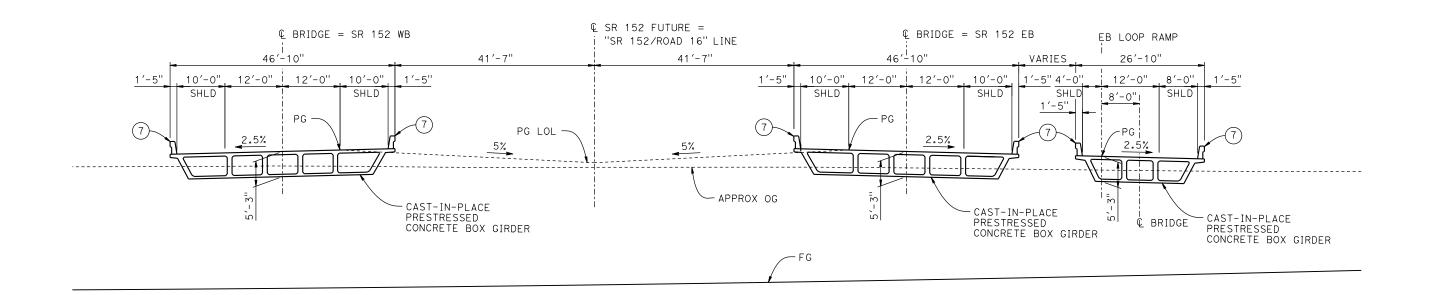

TYPICAL SECTION 1" = 10'

NOTES:

1. FOR NOTES AND LEGEND, SEE DRAWING ST-K1235-D.



ΑO								
15-							DESIGNED BY M. BRATT	RI
							DRAWN BY	1
5133a							CHECKED BY K. CHARAN	COI
							IN CHARGE C. LEMLEY	
00d	REV	DATE	BY	снк	APP	DESCRIPTION	08/12/2016	

RECORD SET
15% DESIGN
SUBMITTAL
NOT FOR
CONSTRUCTION






CALIFORNIA HIGH-SPEED TRAIN PROJECT MERCED TO FRESNO SECTION

CENTRAL VALLEY WYE
SR 152 (NORTH) TO ROAD 11 WYE ALTERNATIVE
TYPICAL SECTION (SJD-FRE)
BERENDA WAY (ROAD 16) INTERCHANGE - 2 OF 2

CONTRACT NO.							
HSR08-05							
DRAWING NO.							
ST-K3235-D							
SCALE							
AS SHOWN							
SHEET NO.							

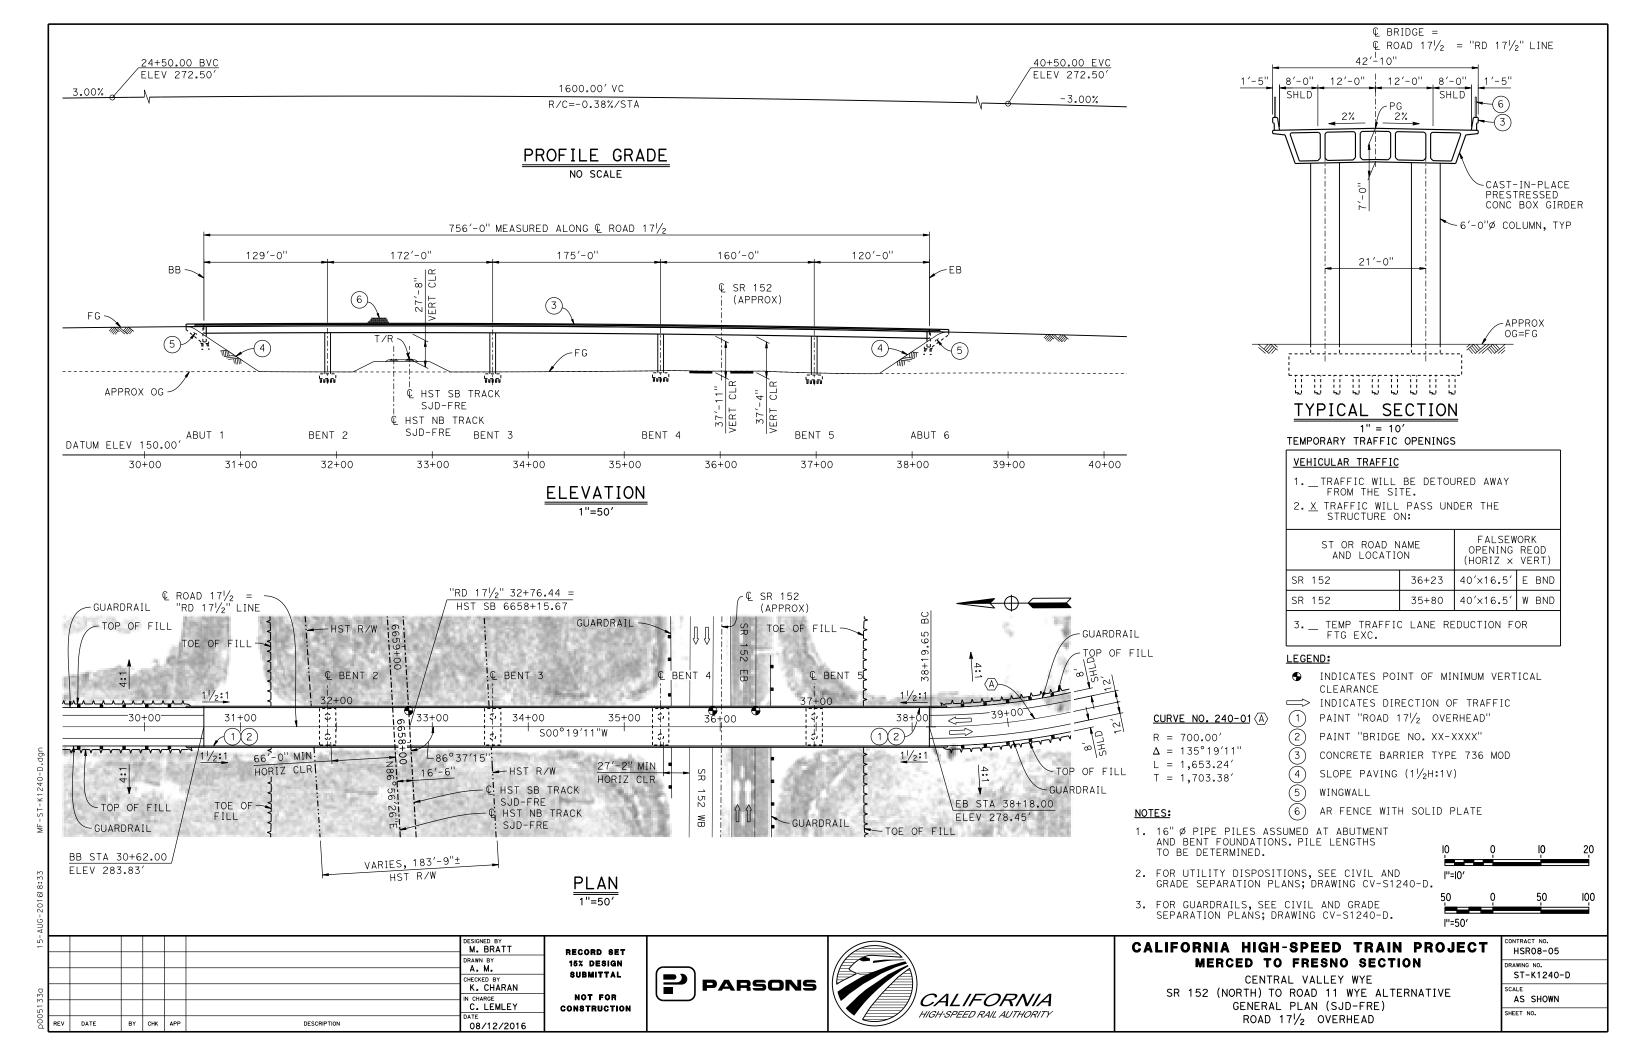

DATE

BY CHK APP


DESCRIPTION

08/12/2016

AERIAL #2 - SR 99 / UPRR - 1 OF 3

TOP OF RAIL PROFILE (HST SB TRACK SJD-FRE)

NO SCALE

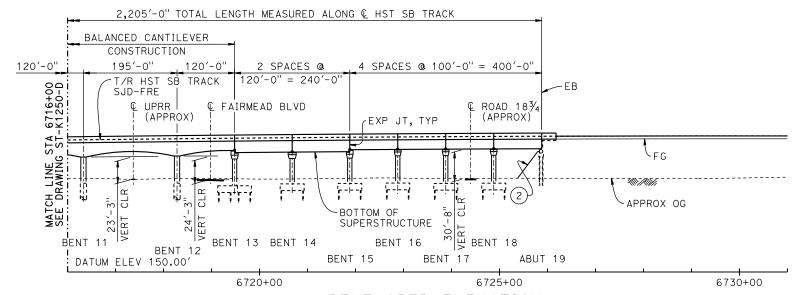


DEVELOPED ELEVATION VERT: 1" = 50' HORIZ: 1" = 100'

RECORD SET

15% DESIGN SUBMITTAL

NOT FOR

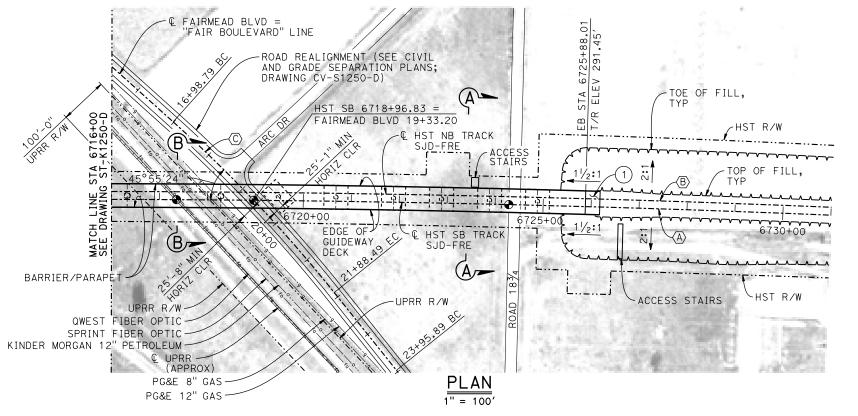

TEMPORARY TRAFFIC OPENINGS

VEHICULAR TRAFFIC

- 1. __TRAFFIC WILL BE DETOURED AWAY FROM THE SITE.
- 2. \underline{X} TRAFFIC WILL PASS UNDER THE STRUCTURE ON:

ST OR ROAD NAM AND LOCATION	FALSEWO OPENING (HORIZ X	REQD						
SR 152 SB ON RAMP	6709+18	25′X16.5′	S BND					
SR 99	6709+83	37′X16.5′	S BND					
SR 99	6712+48	37′X16.5′	N BND					
FAIRMEAD BLVD	6718+98	32′X16.5′	2-WAY					
ROAD 183/4	6724+40	32′X16.5′	2-WAY					

3. __TEMP TRAFFIC LANE REDUCTION FOR FTG EXC.

TEMPORARY TRAFFIC OPENINGS

RAILROAD TRAFFIC						
FALSEWORK OPENING REQUIRED ON:						
NAME OF RR AND LOCATION OPENING REOD (HORIZ X VERT)						
UPRR	6717+37	24′ X 21′				

LEGEND:

- INDICATES POINT OF MINIMUM VERTICAL CLEARANCE
- INDICATES DIRECTION OF TRAVEL
- STRUCTURE APPROACH
- SLOPE PAVING (1/2H:1V)

NOTES:


CURVE NO. 250-02 (C)

R = 3,000.00' $\Delta = 9^{\circ}21'10''$

L = 489.71'

T = 245.40'

- 1. FOR GENERAL NOTES, SEE DRAWING ST-K1250-D.
- 2. FOR SECTIONS AND BENT COLUMN SCHEDULE, SEE DRAWING ST-K3250-D.

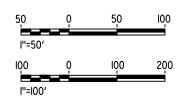

M. BRATT K. CHARAN IN CHARGE
C. LEMLEY CONSTRUCTION DATE BY CHK APP DESCRIPTION 08/12/2016


PARSONS




CALIFORNIA HIGH-SPEED TRAIN PROJECT MERCED TO FRESNO SECTION

CENTRAL VALLEY WYE SR 152 (NORTH) TO ROAD 11 WYE ALTERNATIVE GENERAL PLAN (SJD-FRE) AERIAL #2 - SR 99 / UPRR - 2 OF 3

CONTRACT NO. HSRO8-05							
DRAWING NO. ST-K1251-D							
AS SHOWN							
SHEET NO.							

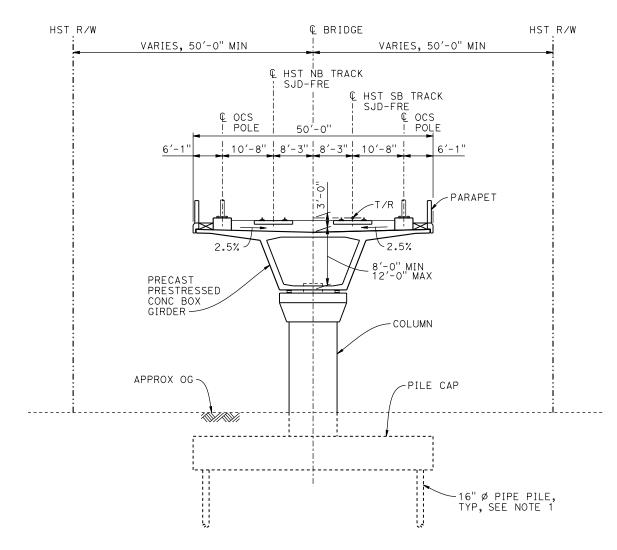

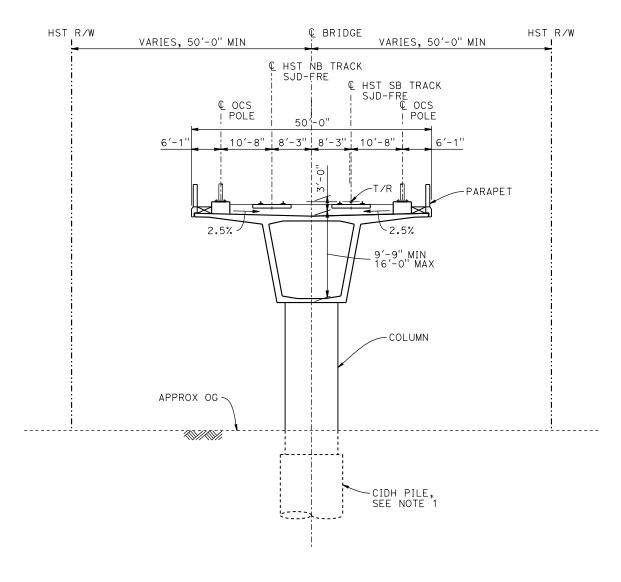


SECTION A-A

BENT COLUMN SCHEDULE							
BENT	COLUMN TYPE	CIDH TYPE					
2 - 5	9'-0" Ø						
6	11'-0" Ø	13'-0" Ø					
7	12'-0" Ø						
8	11'-0" Ø	13'-0" Ø					
9 - 10	10'-0" Ø						
11 - 12	11'-0" Ø	13'-0" Ø					
13 - 18	9'-0" ø						

$\frac{\text{SECTION }B-B}{1''=10'}$

NOTES:

- PILE AND DRILLED SHAFT LENGTHS TO BE DETERMINED.
- 2. FOR TRACK SUPERELEVATION DETAILS, SEE ALIGNMENT AND TYPICAL SECTION PLANS; DRAWINGS TT-BOO51-D AND TT-BOO53-D.

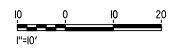

ΑU								
15-							DESIGNED BY M. BRATT	R
							DRAWN BY	
30							CHECKED BY K. CHARAN	
513							IN CHARGE C. LEMLEY	co
00d	REV	DATE	BY	снк	APP	DESCRIPTION	DATE 08/12/2016	

RECORD SET
15% DESIGN
SUBMITTAL
NOT FOR
CONSTRUCTION








CALIFORNIA HIGH-SPEED TRAIN PROJECT MERCED TO FRESNO SECTION


CENTRAL VALLEY WYE
SR 152 (NORTH) TO ROAD 11 WYE ALTERNATIVE
TYPICAL SECTIONS (SJD-FRE)
AERIAL #2 - SR 99 / UPRR - 3 OF 3


CONTRACT NO.
HSR08-05
DRAWING NO.
ST-K3250-D
SCALE
AS SHOWN
SHEET NO.

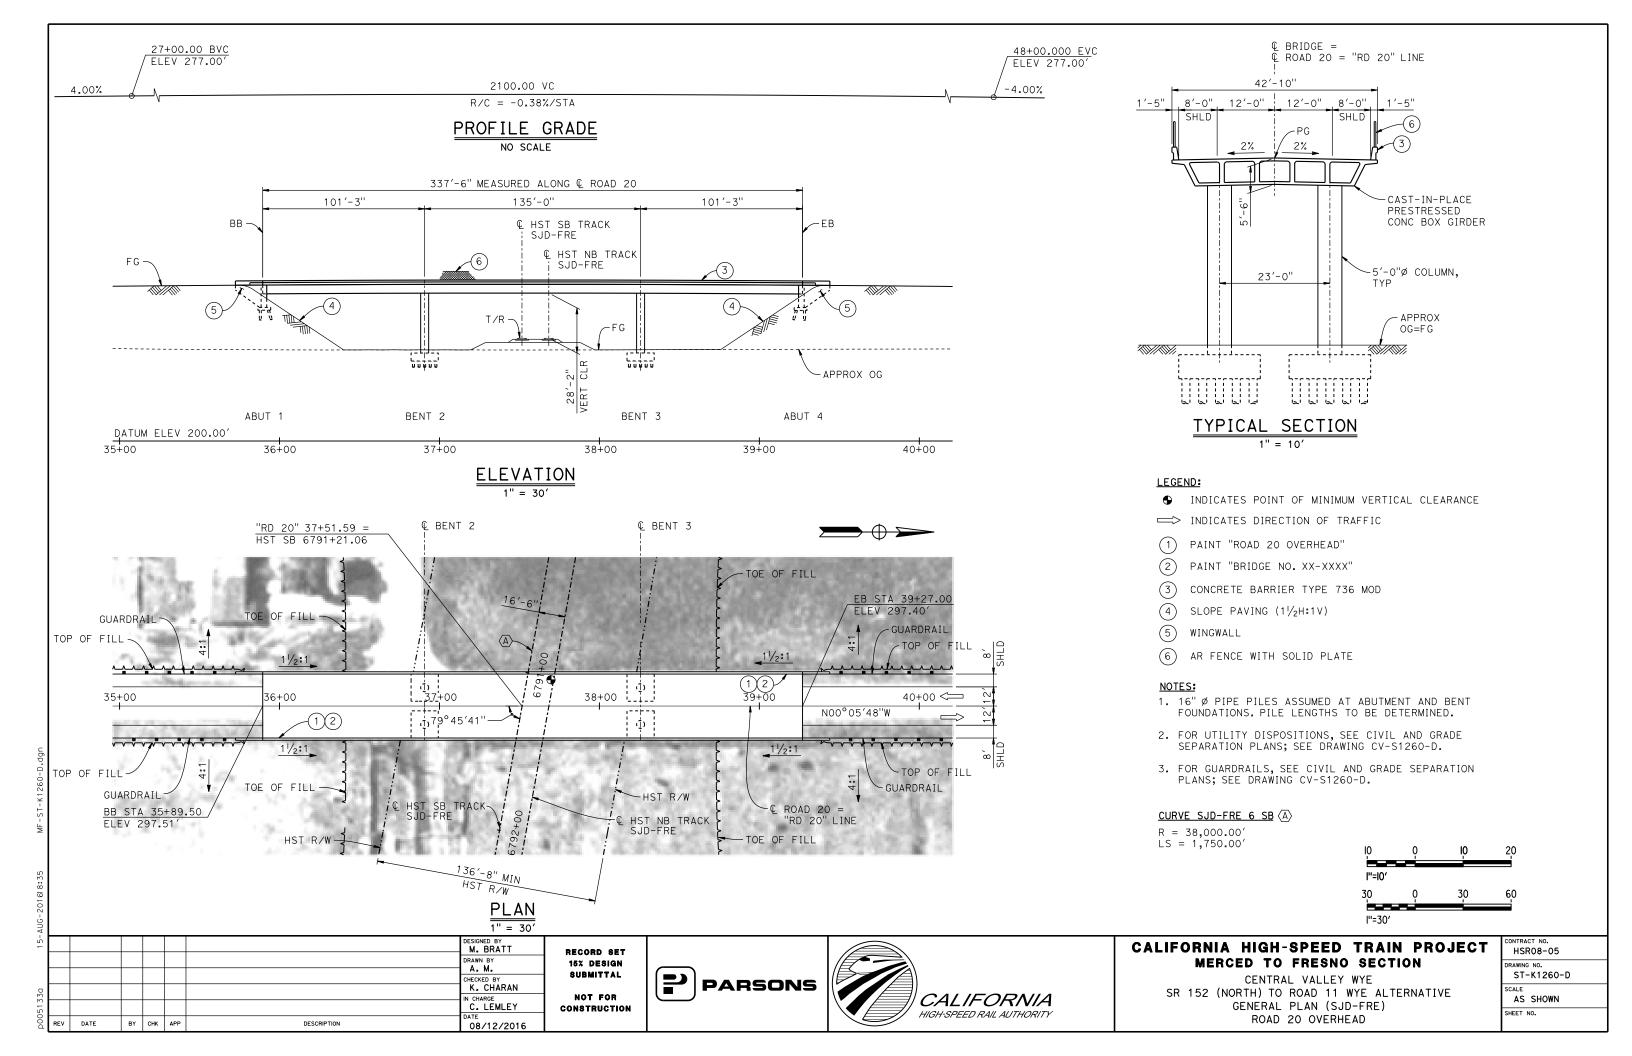


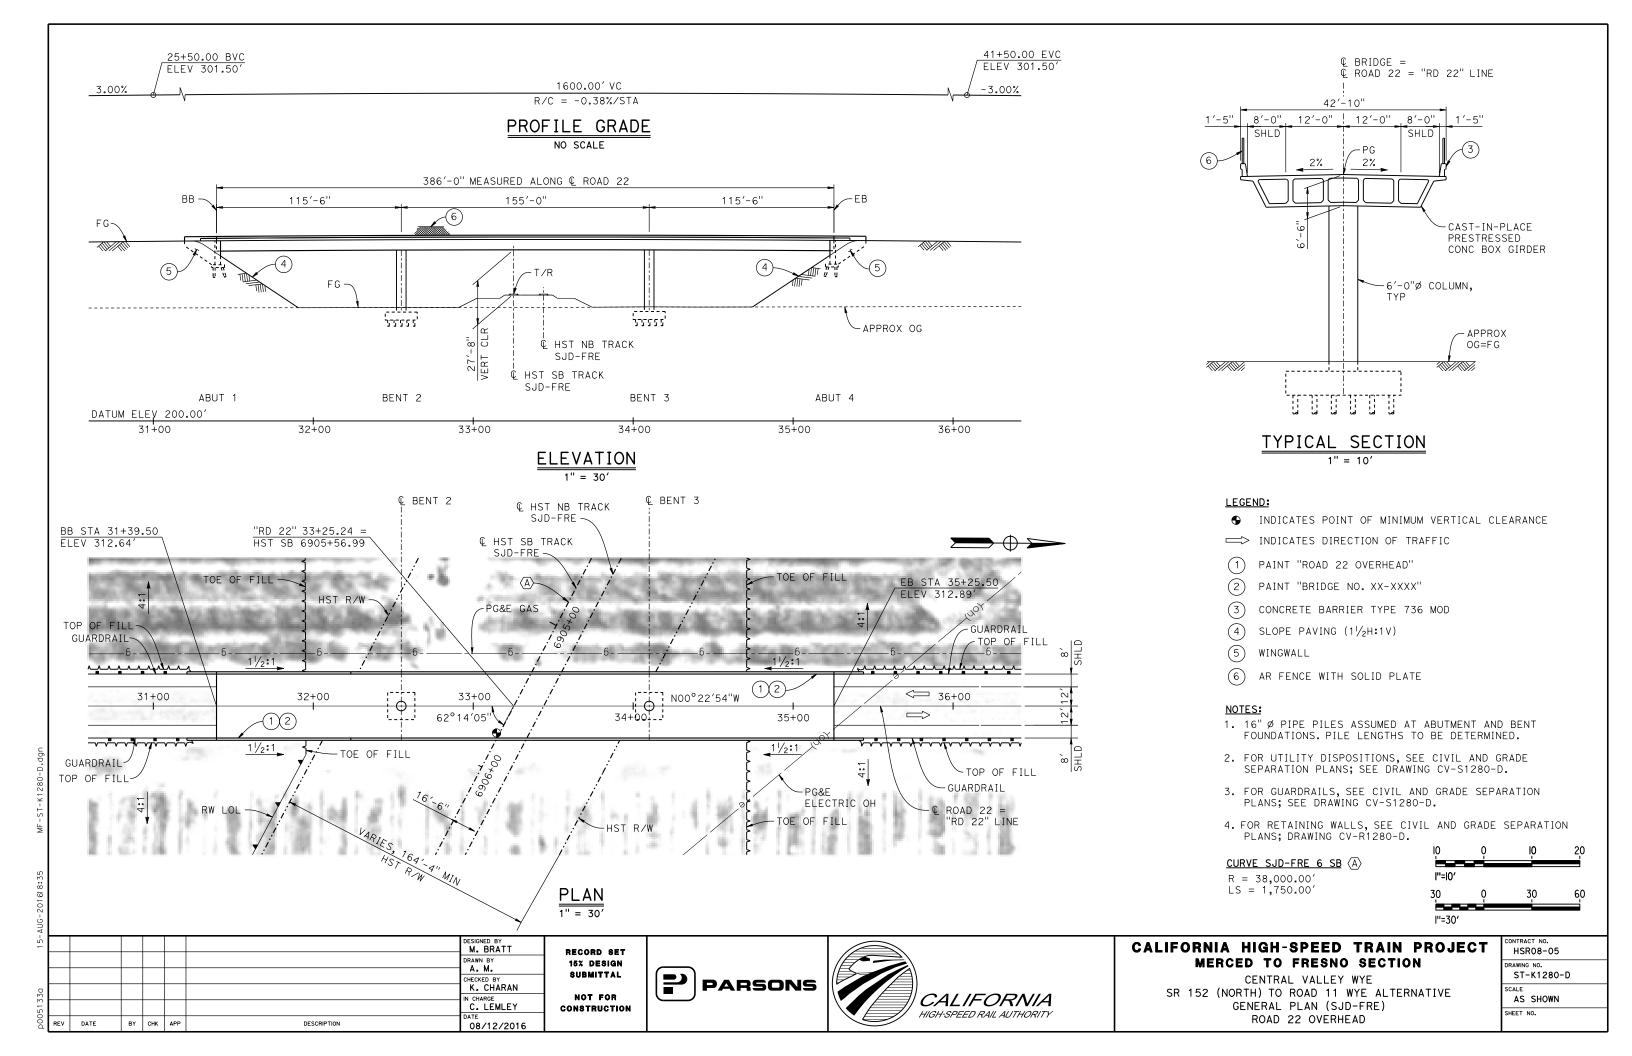

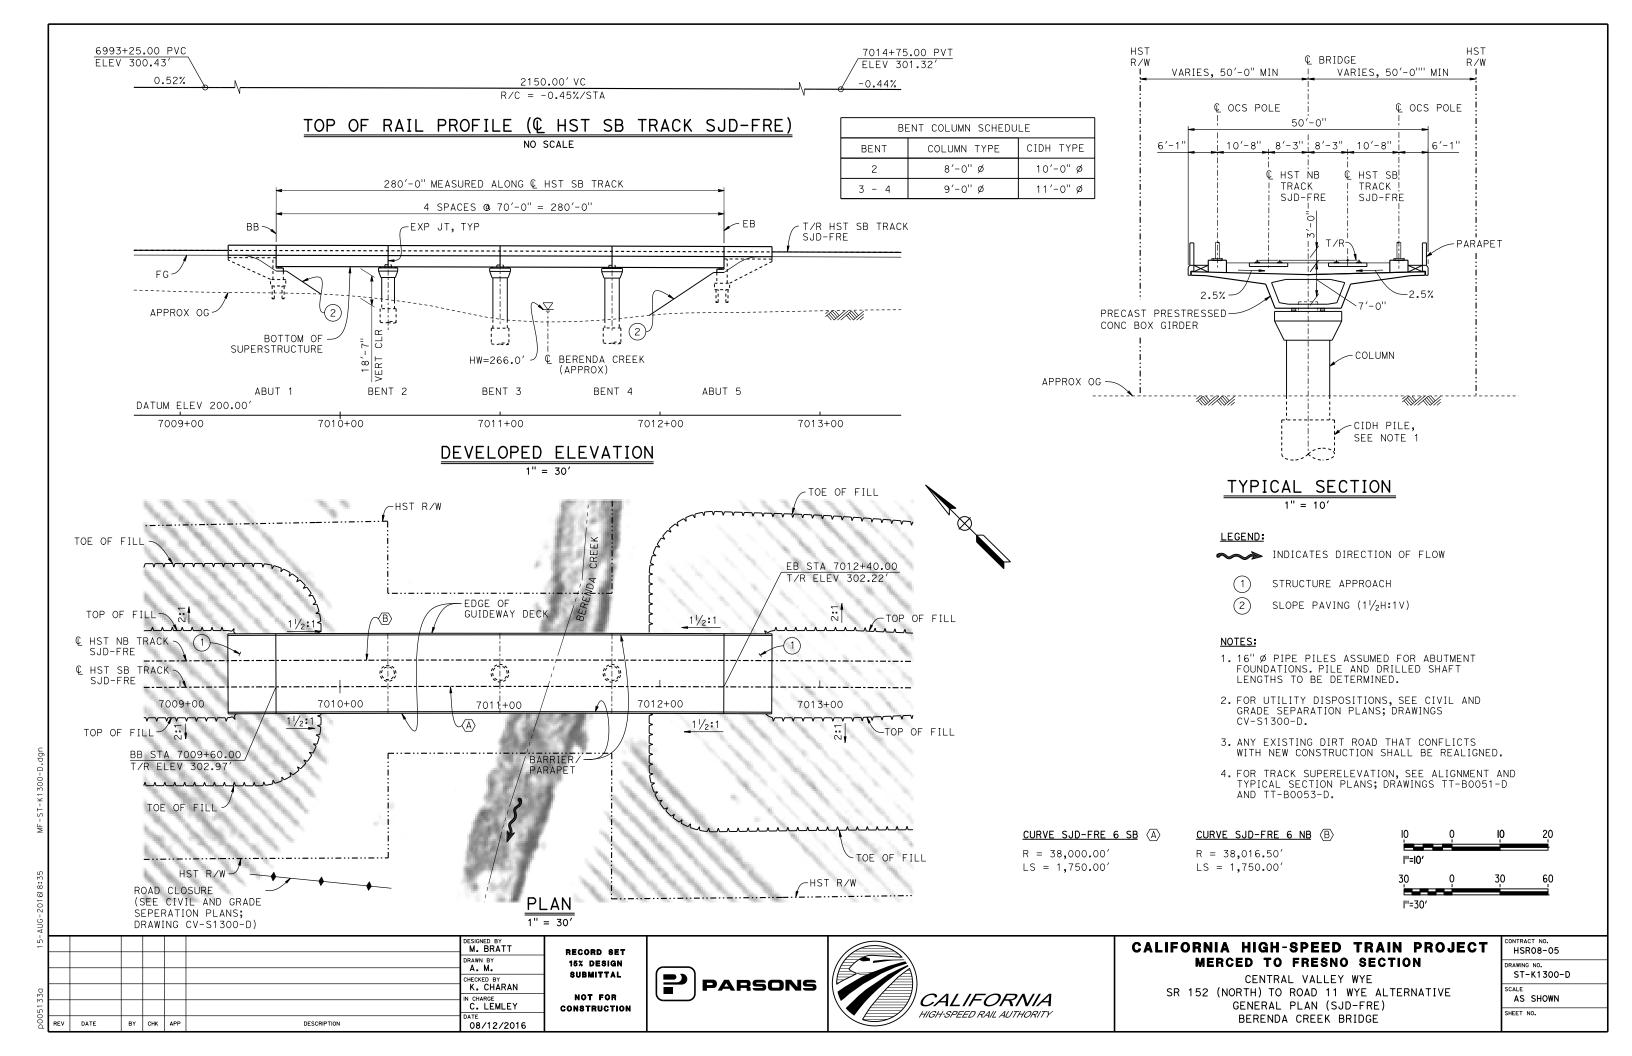

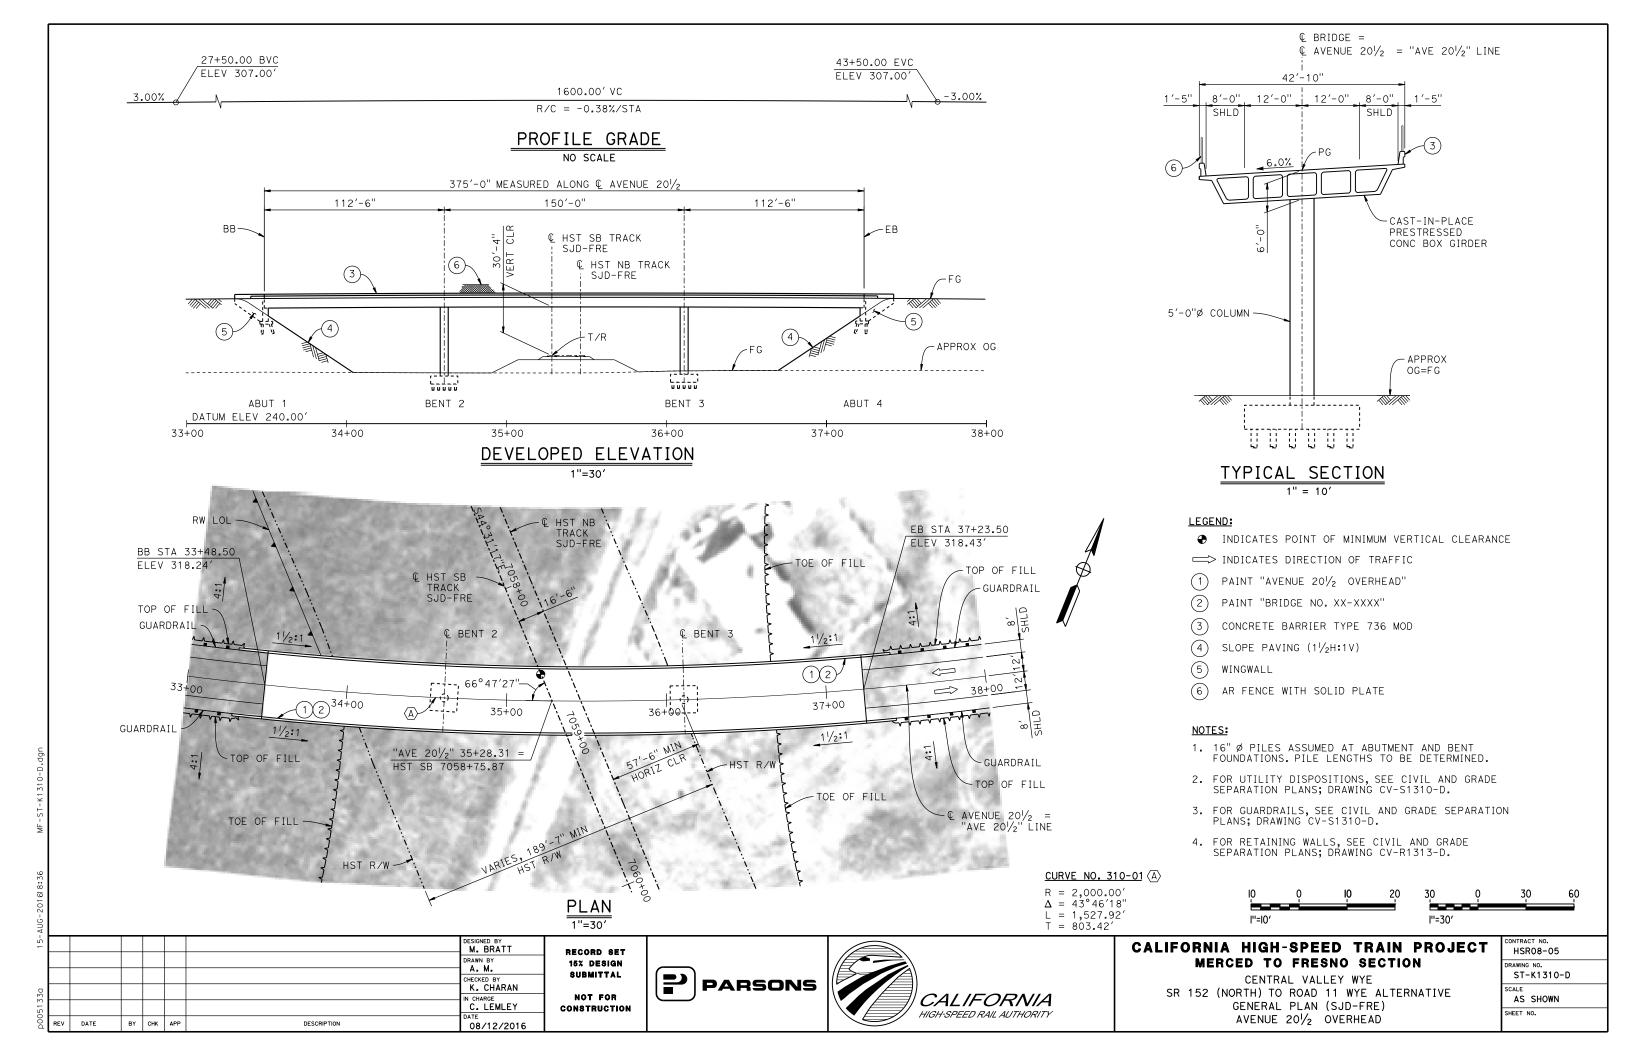

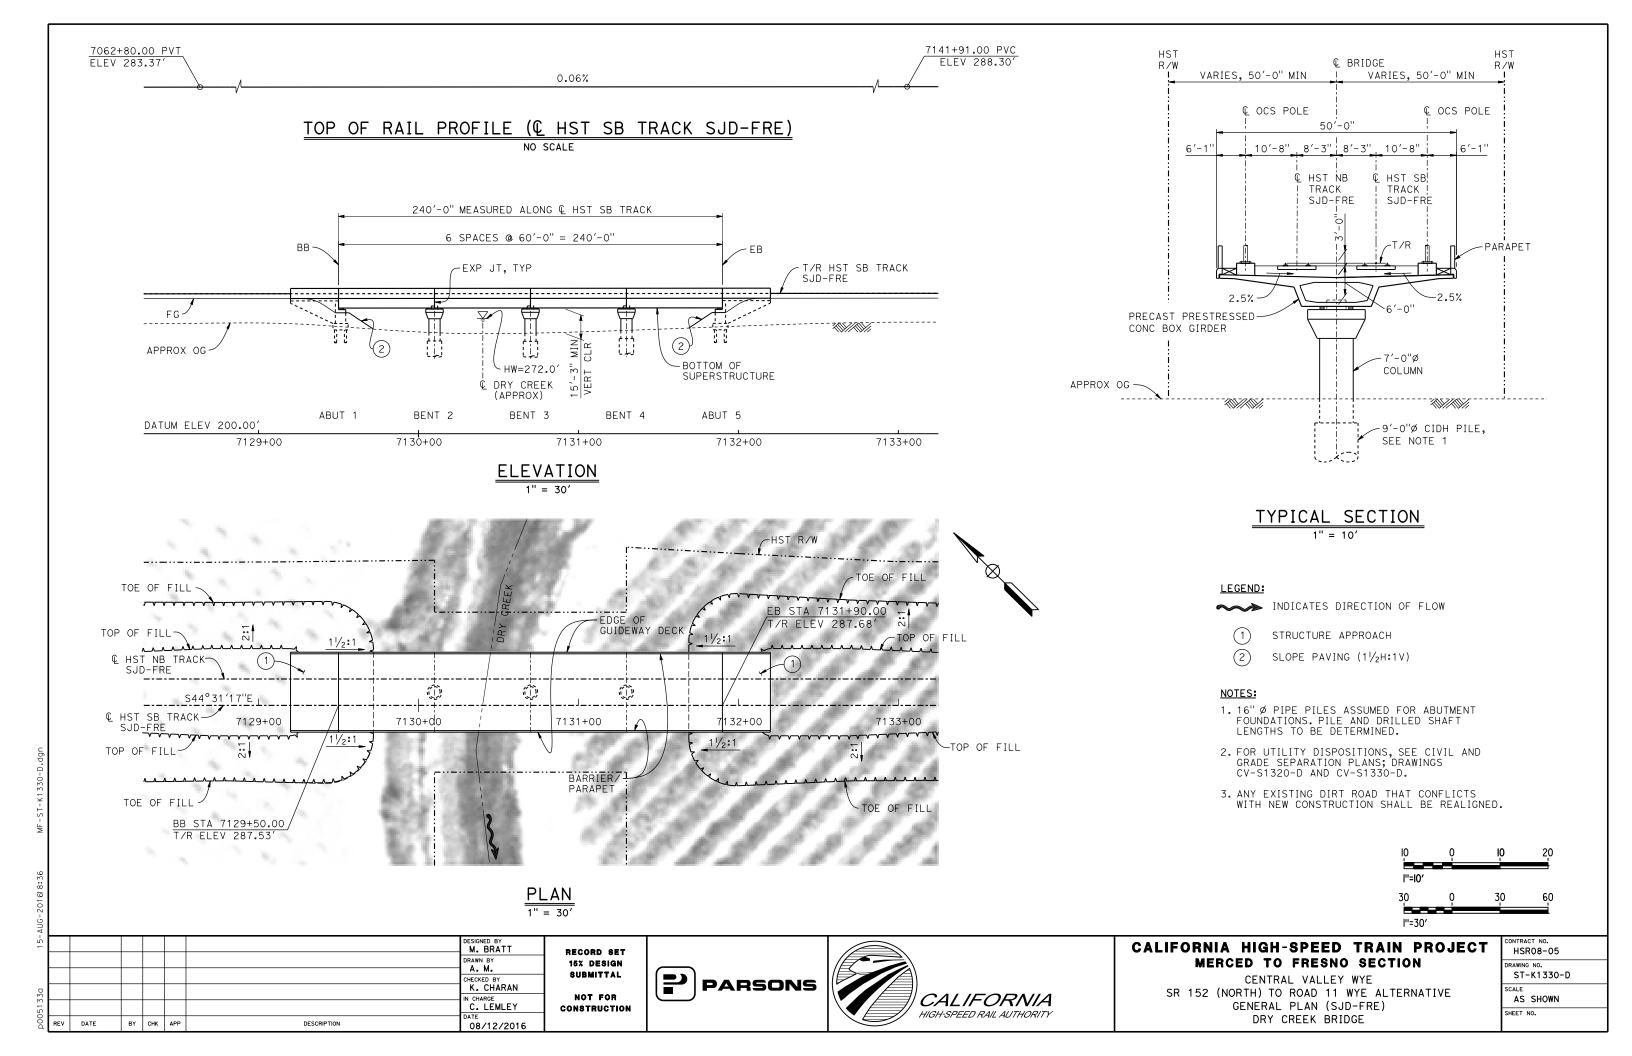


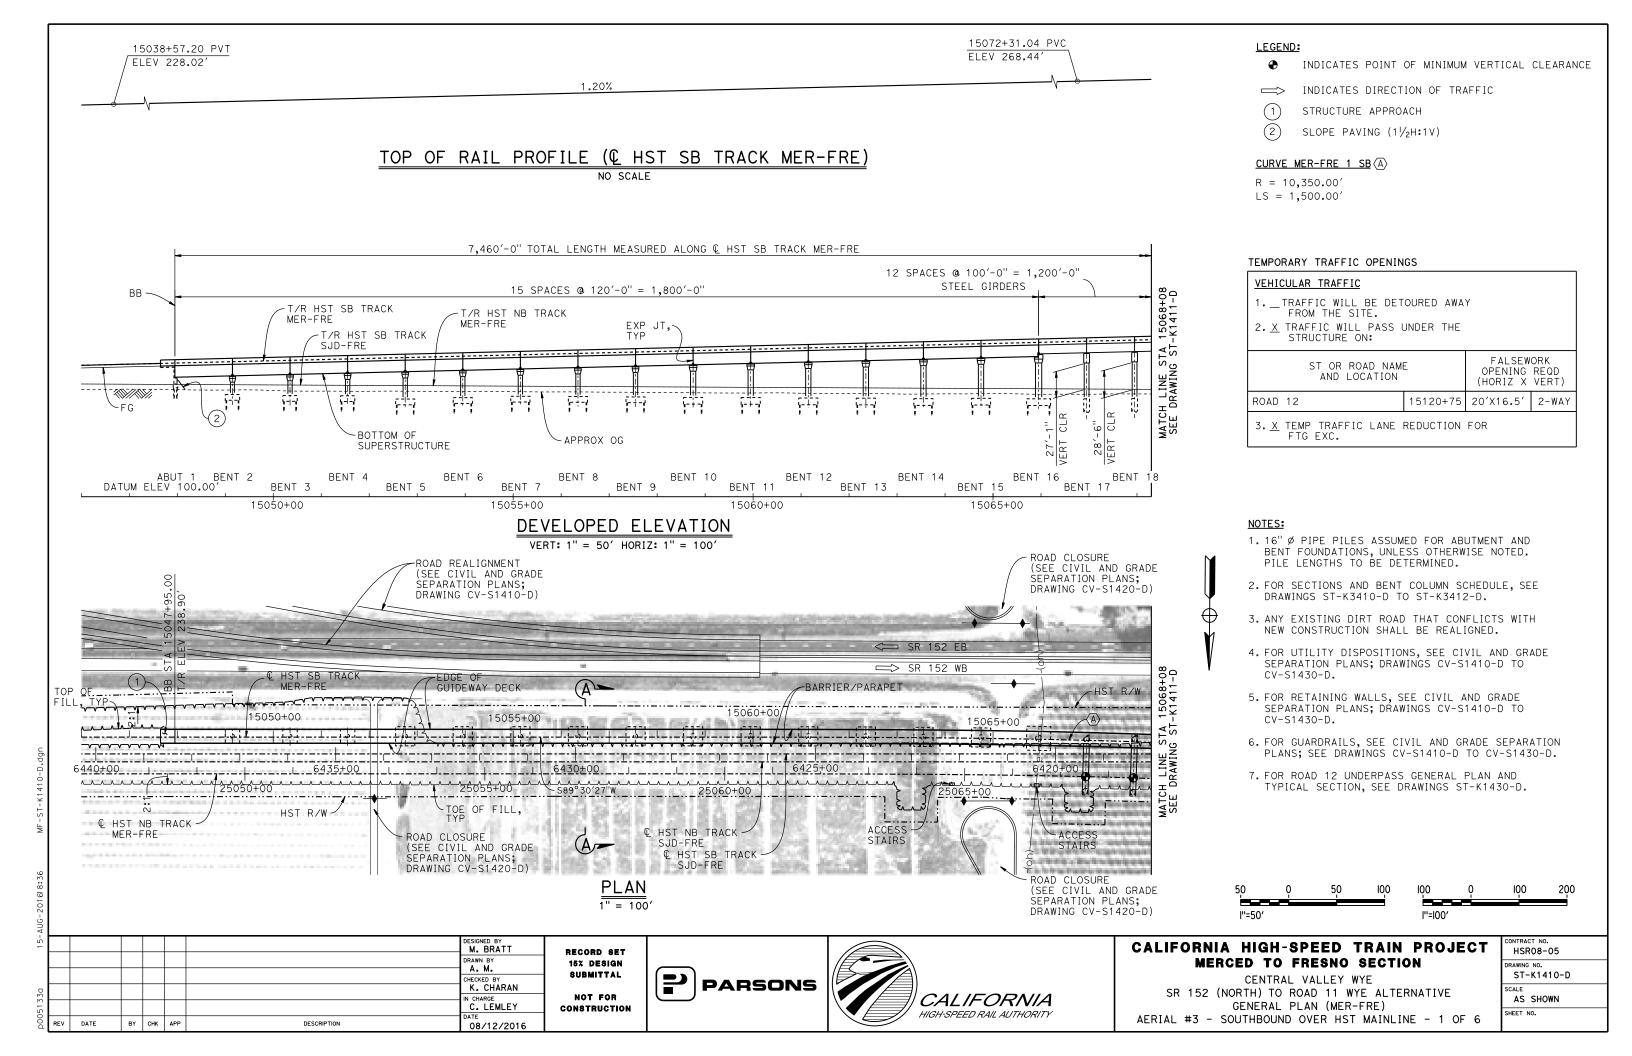

-0.88%

TOP OF RAIL PROFILE (& HST SB TRACK MER-FRE)

NO SCALE

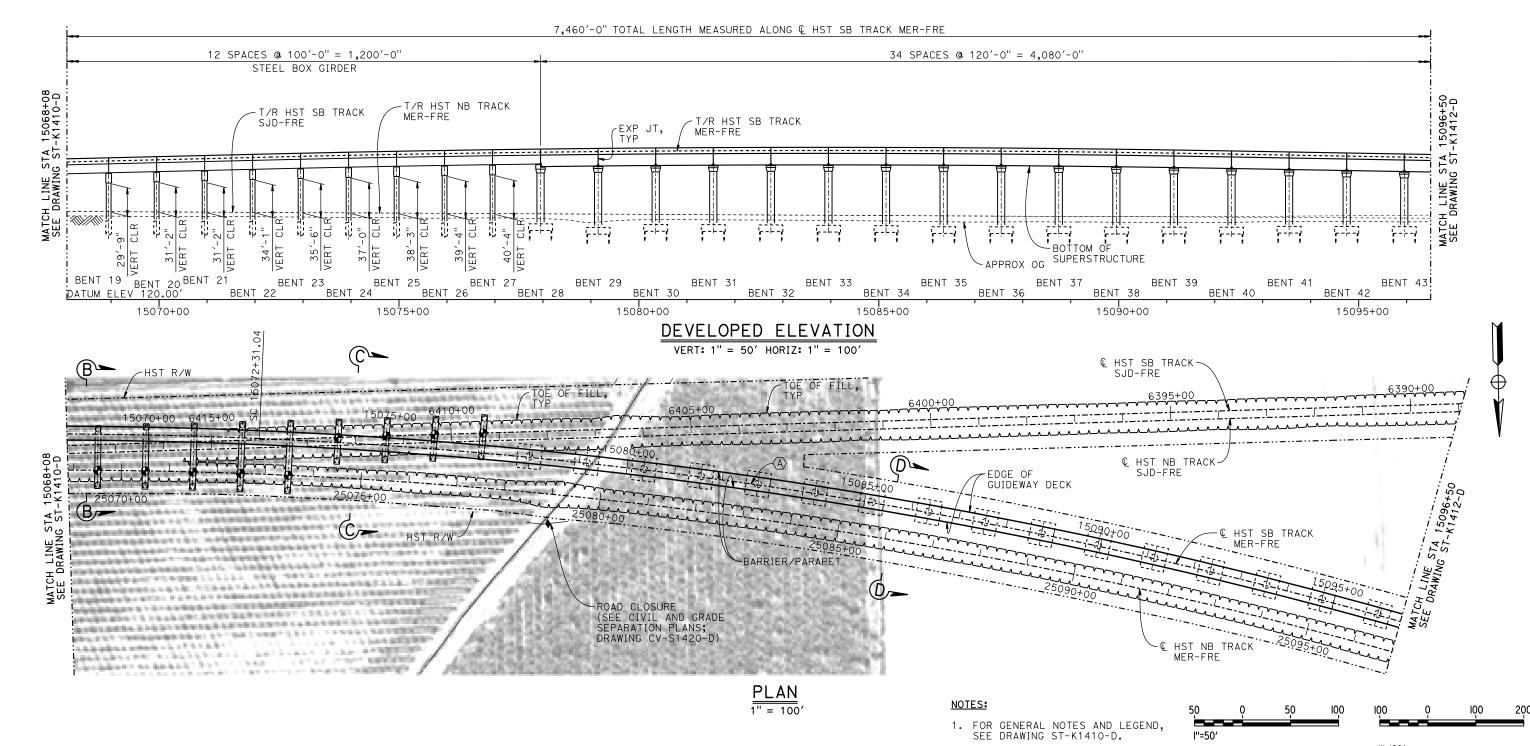

p005133a 15-AUG-2C

BY CHK APP

DESCRIPTION

15% DESIGN
SUBMITTAL

NOT FOR
CONSTRUCTION

RECORD SET

M. BRATT

K. CHARAN

IN CHARGE
C. LEMLEY

08/12/2016





CALIFORNIA HIGH-SPEED TRAIN PROJECT MERCED TO FRESNO SECTION

CENTRAL VALLEY WYE

SR 152 (NORTH) TO ROAD 11 WYE ALTERNATIVE

GENERAL PLAN (MER-FRE)

AERIAL #3 - SOUTHBOUND OVER HST MAINLINE - 2 OF 6

CONTRACT NO.
HSR08-05


DRAWING NO.
ST-K1411-D


SCALE
AS SHOWN

SHEET NO.

TOP OF RAIL PROFILE (@ HST SB TRACK MER-FRE)

NO SCALE

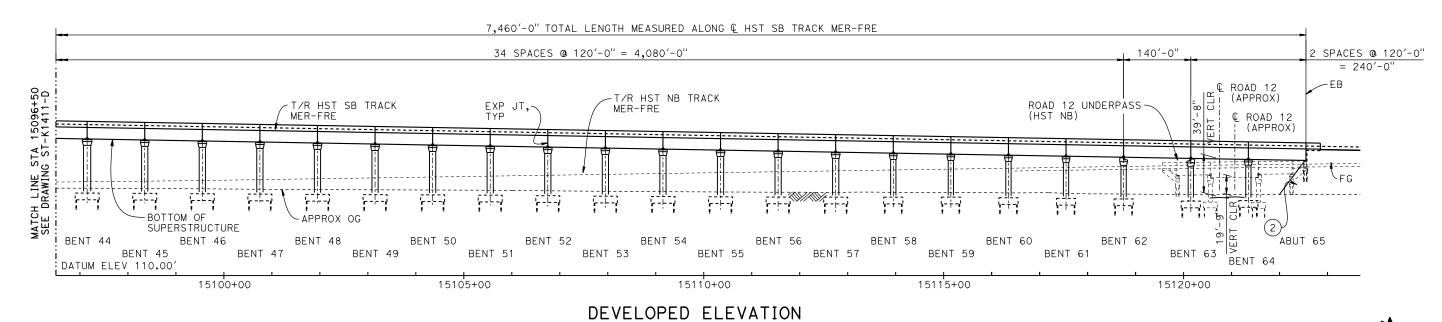

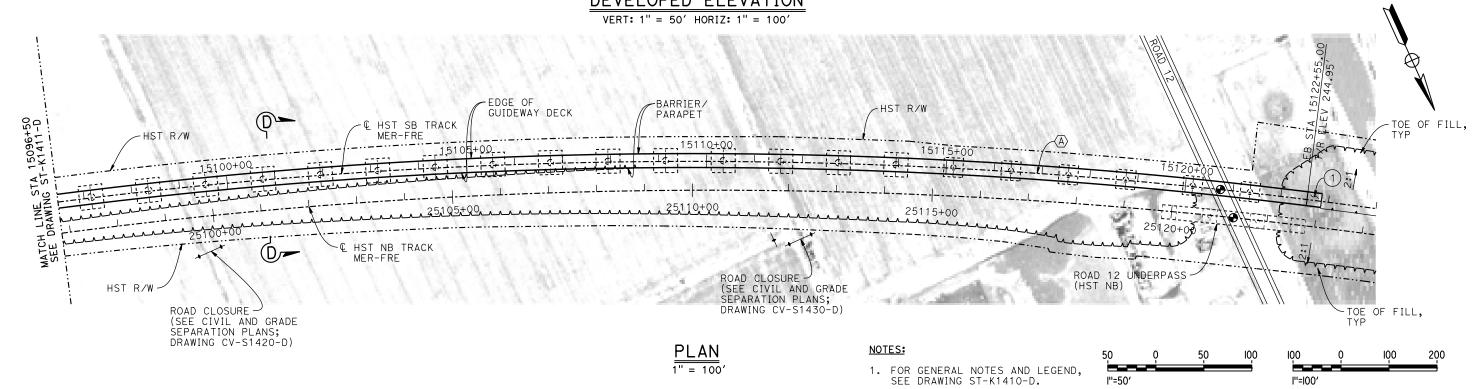

M. BRATT DRAWN BY CHECKED BY IN CHARGE
C. LEMLEY DATE BY CHK APP DESCRIPTION 08/12/2016



SUBMITTAL


NOT FOR



CALIFORNIA HIGH-SPEED TRAIN PROJECT CONTRACT NO. HSRO8-C MERCED TO FRESNO SECTION

CENTRAL VALLEY WYE SR 152 (NORTH) TO ROAD 11 WYE ALTERNATIVE GENERAL PLAN (MER-FRE) AERIAL #3 - SOUTHBOUND OVER HST MAINLINE - 3 OF 6

HSR08-05						
DRAWING NO.						
ST-K1412-D						
SCALE						
AS SHOWN						
SHEET NO.						

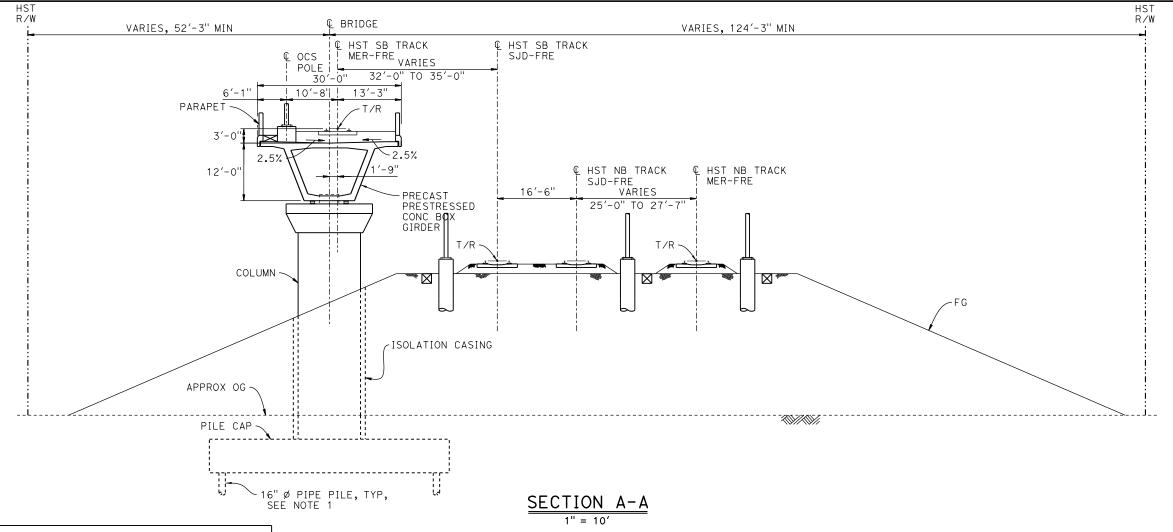

	BENT COLUMN SCHEDULE							
BENT	COLUMN TYPE	CIDH TYPE	"A"	TYP SECTION, SHEET				
2 - 4	8'-0" Ø			A-A, ST-K3410-D				
5 - 9	9'-0" Ø			A-A, ST-K3410-D				
10 - 15	11'-0" Ø			A-A, ST-K3410-D				
16	13'-0" Ø			A-A, ST-K3410-D				
17	2 - 10'-0" Ø	12'-0" Ø	108'-0"	B-B, ST-K3411-D				
18	2 - 10'-0" Ø	12'-0" Ø	111'-0"	B-B, ST-K3411-D				
19	2 - 10'-0" Ø	12'-0" Ø	115′-0"	B-B, ST-K3411-D				
20	2 - 10'-0" Ø	12'-0" ø	120'-0"	B-B, ST-K3411-D				
21	2 - 10'-0" Ø	12'-0" Ø	124'-0"	B-B, ST-K3411-D				
22	2 - 10'-0" Ø	12'-0" ø	130′-0"	B-B, ST-K3411-D				
23	2 - 10'-0" Ø	12'-0" Ø	137′-0"	B-B, ST-K3411-D				
24 - 27	2 - 10'-0" Ø	12'-0" ø	78′-0"	C-C, ST-K3412-D				
28 - 45	15′-0" Ø			D-D, ST-K3412-D				
46 - 58	13'-0" Ø			D-D, ST-K3412-D				
59 - 64	11'-0" Ø			D-D, ST-K3412-D				

NOTES:

- 1. PILE LENGTHS TO BE DETERMINED.
- 2. FOR TRACK SUPERELEVATION DETAILS, SEE ALIGNMENT AND TYPICAL SECTION PLANS; DRAWING TT-B0054-D.

10	o	ΙO	20
l''=l0'			

-61 339 15-	REV	DATE	BY	CHK	APP	DESCRIPTION	DESIGNED BY M. BRATT DRAWN BY A. M. CHECKED BY K. CHARAN IN CHARGE C. LEMLEY DATE	
ă	REV	DATE	BY	СНК	APP	DESCRIPTION	08/12/2016	

RECORD SET
15% DESIGN
SUBMITTAL
NOT FOR
CONSTRUCTION








CALIFORNIA HIGH-SPEED TRAIN PROJECT MERCED TO FRESNO SECTION


CENTRAL VALLEY WYE
SR 152 (NORTH) TO ROAD 11 WYE ALTERNATIVE
TYPICAL SECTION (MER-FRE)
AERIAL #3 - SOUTHBOUND OVER HST MAINLINE - 4 OF 6


CONTRACT NO.
HSR08-05
DRAWING NO.
ST-K3410-D
SCALE
AS SHOWN
SHEET NO.

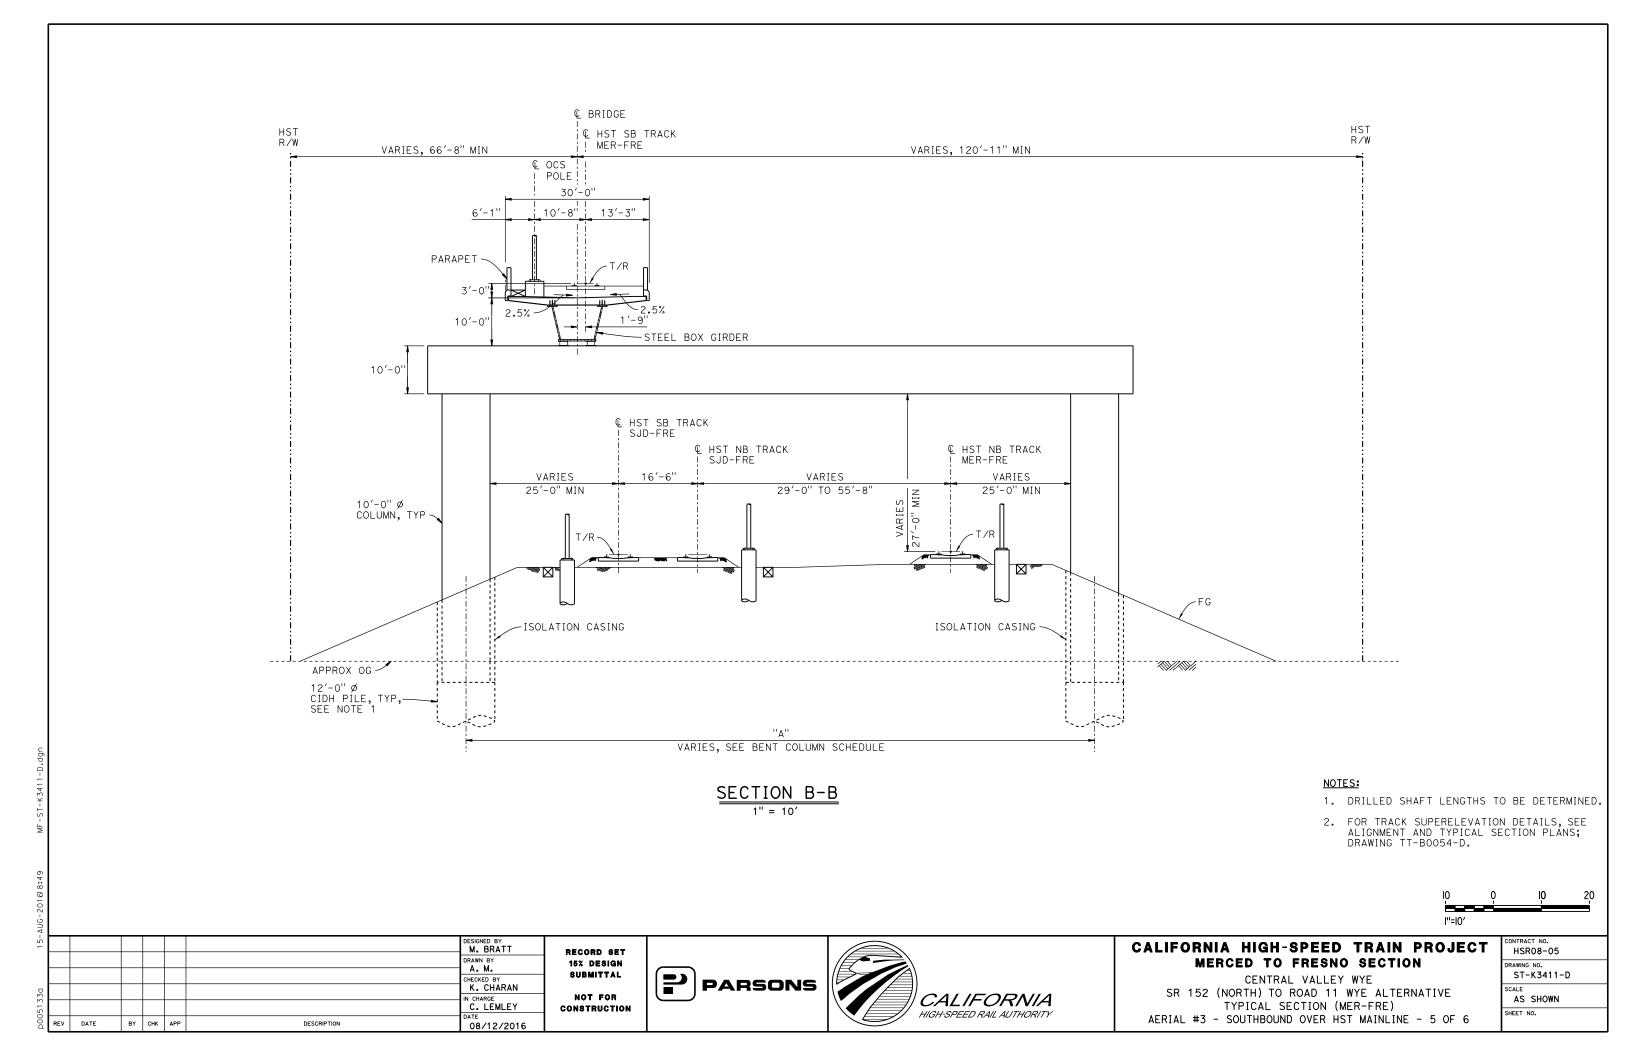


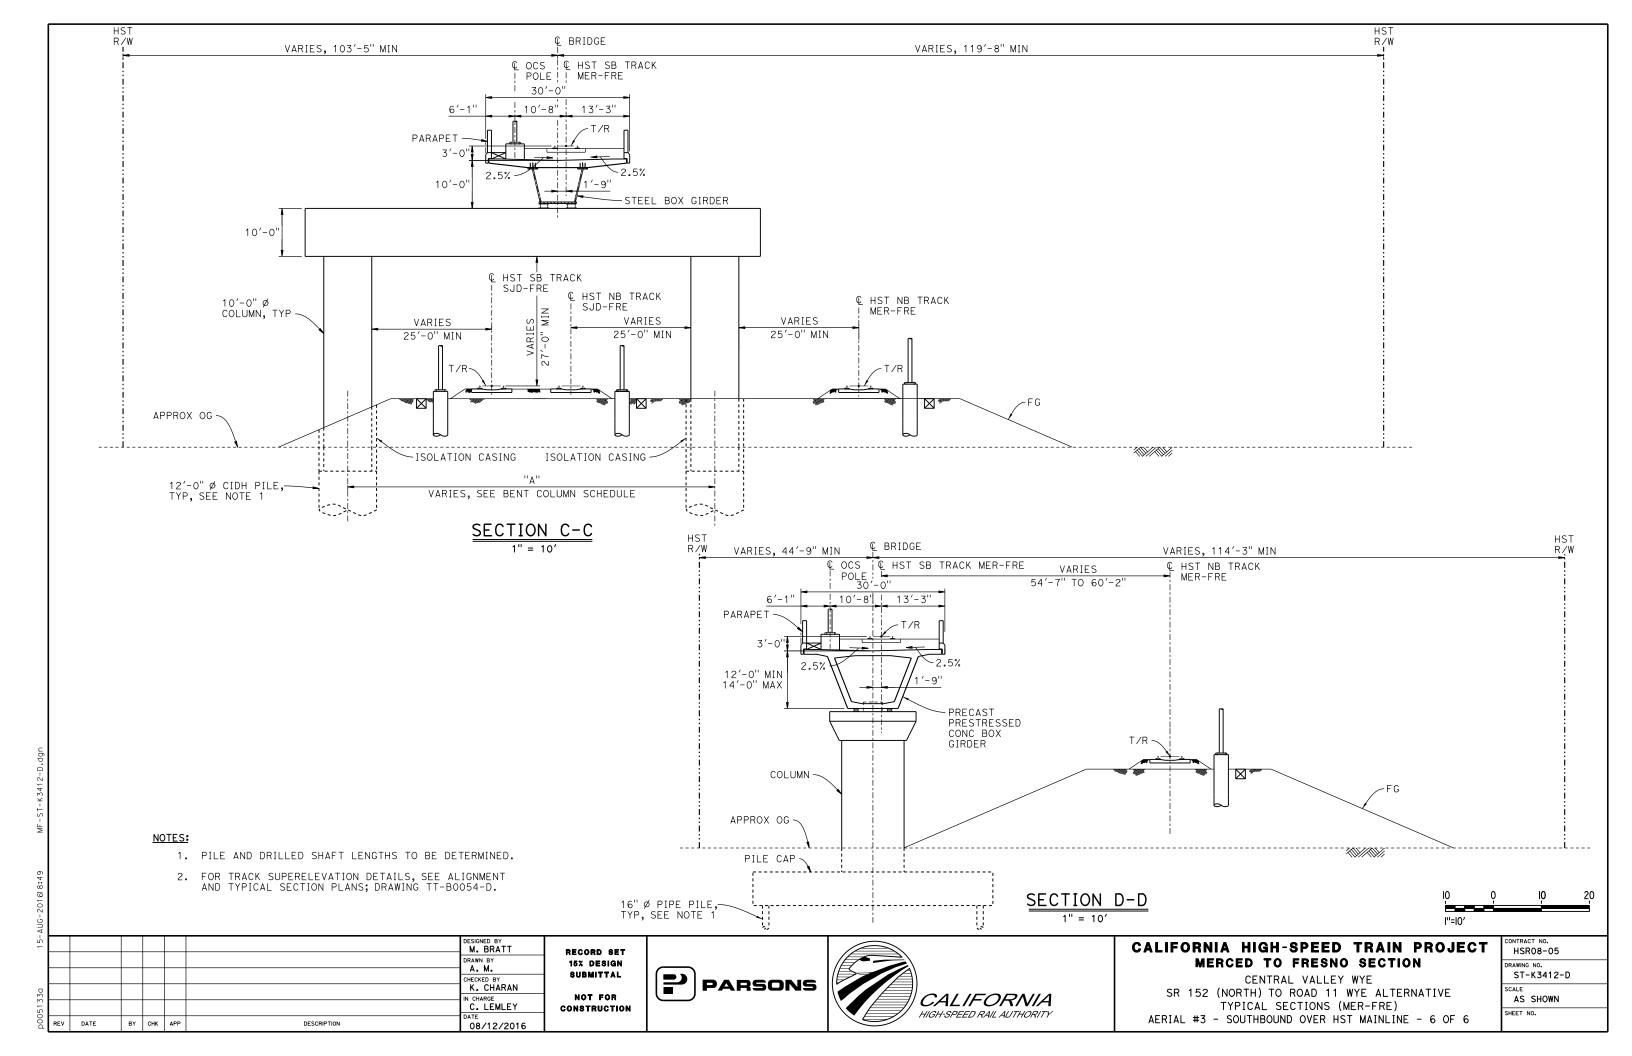

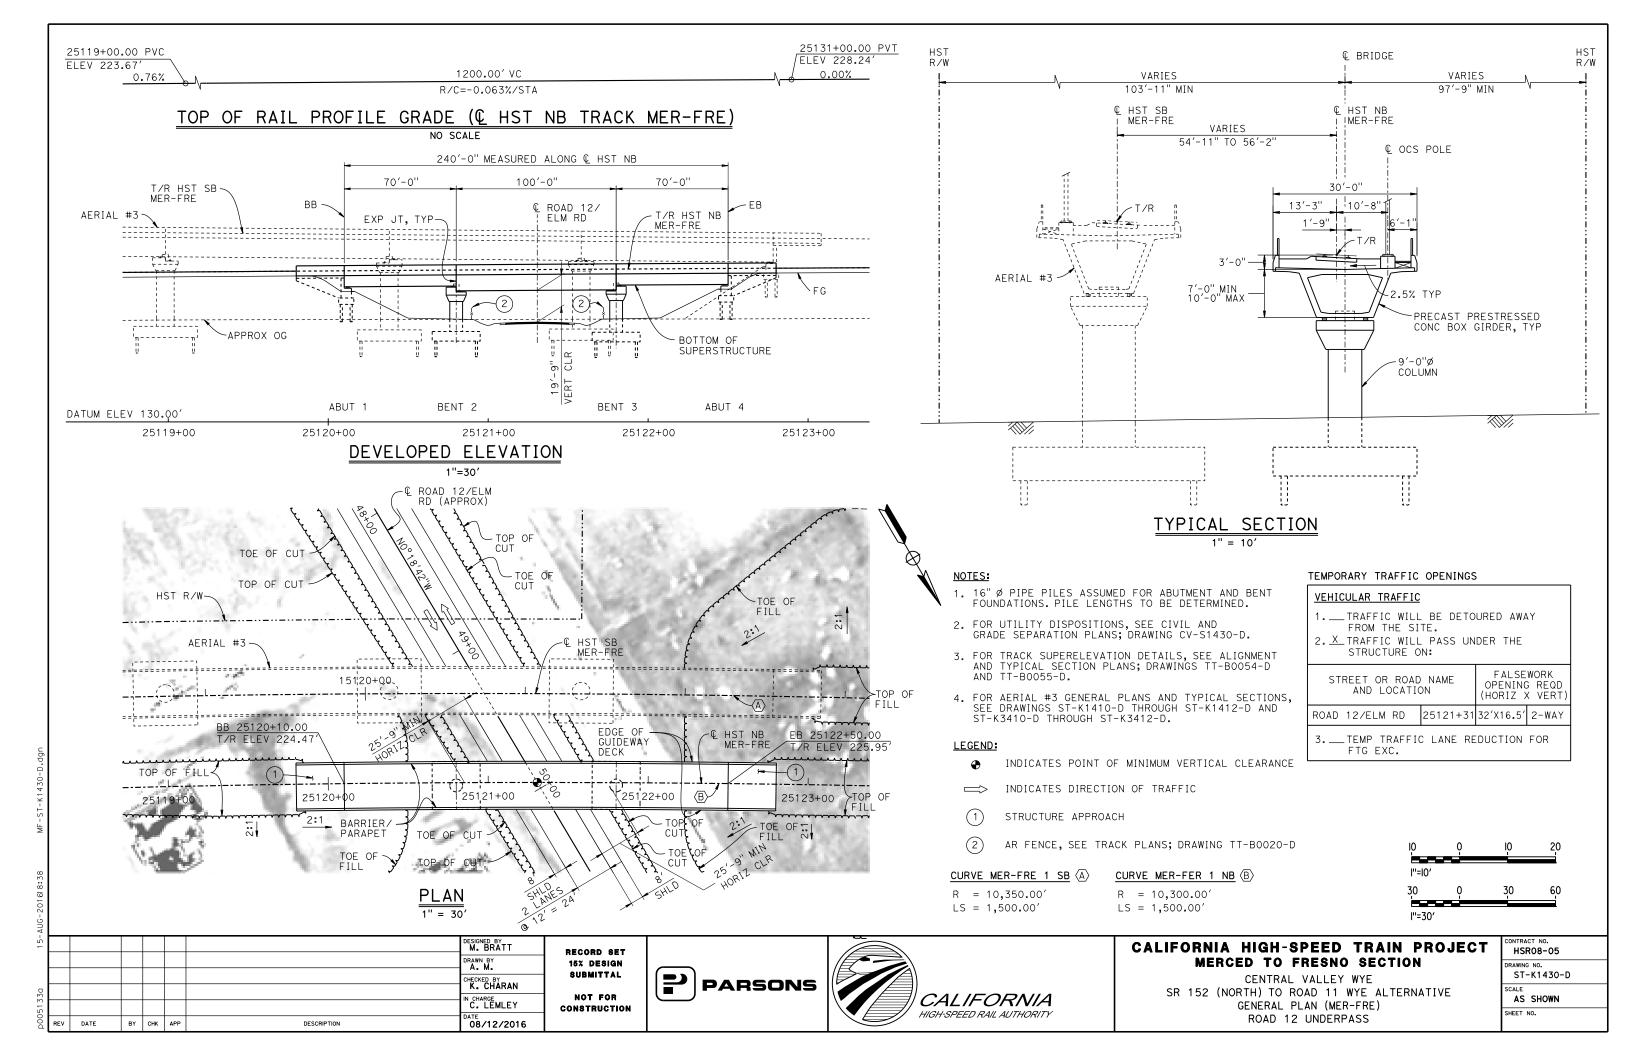

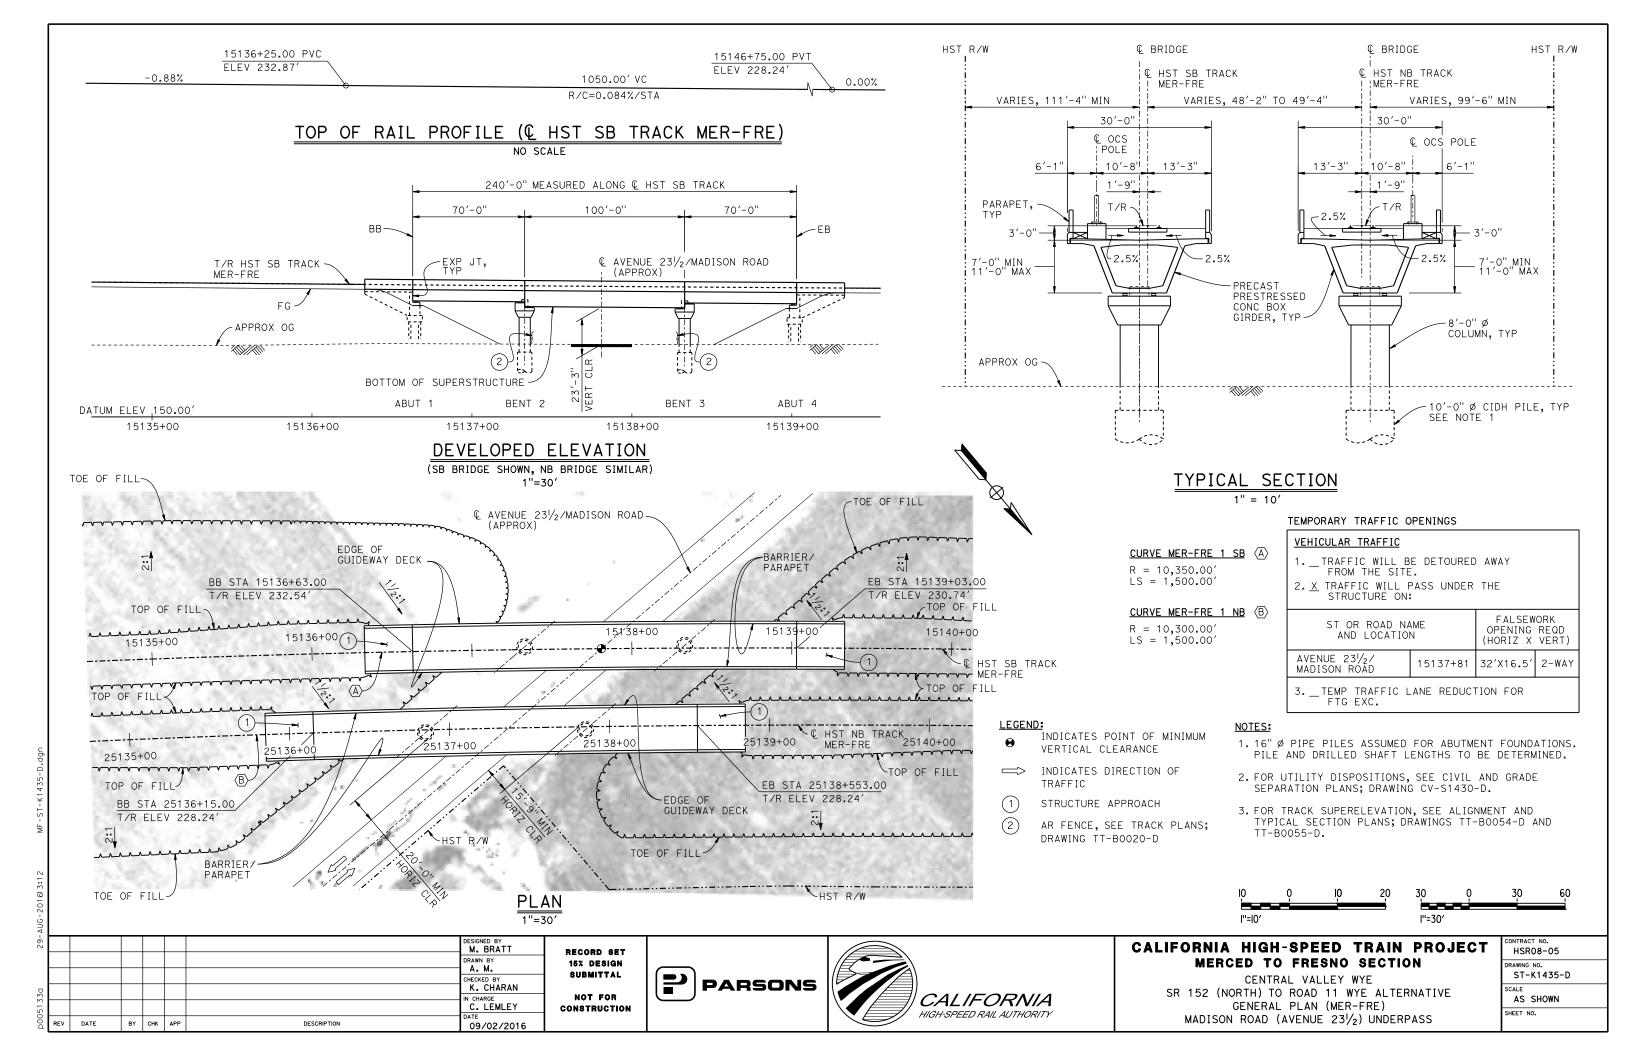

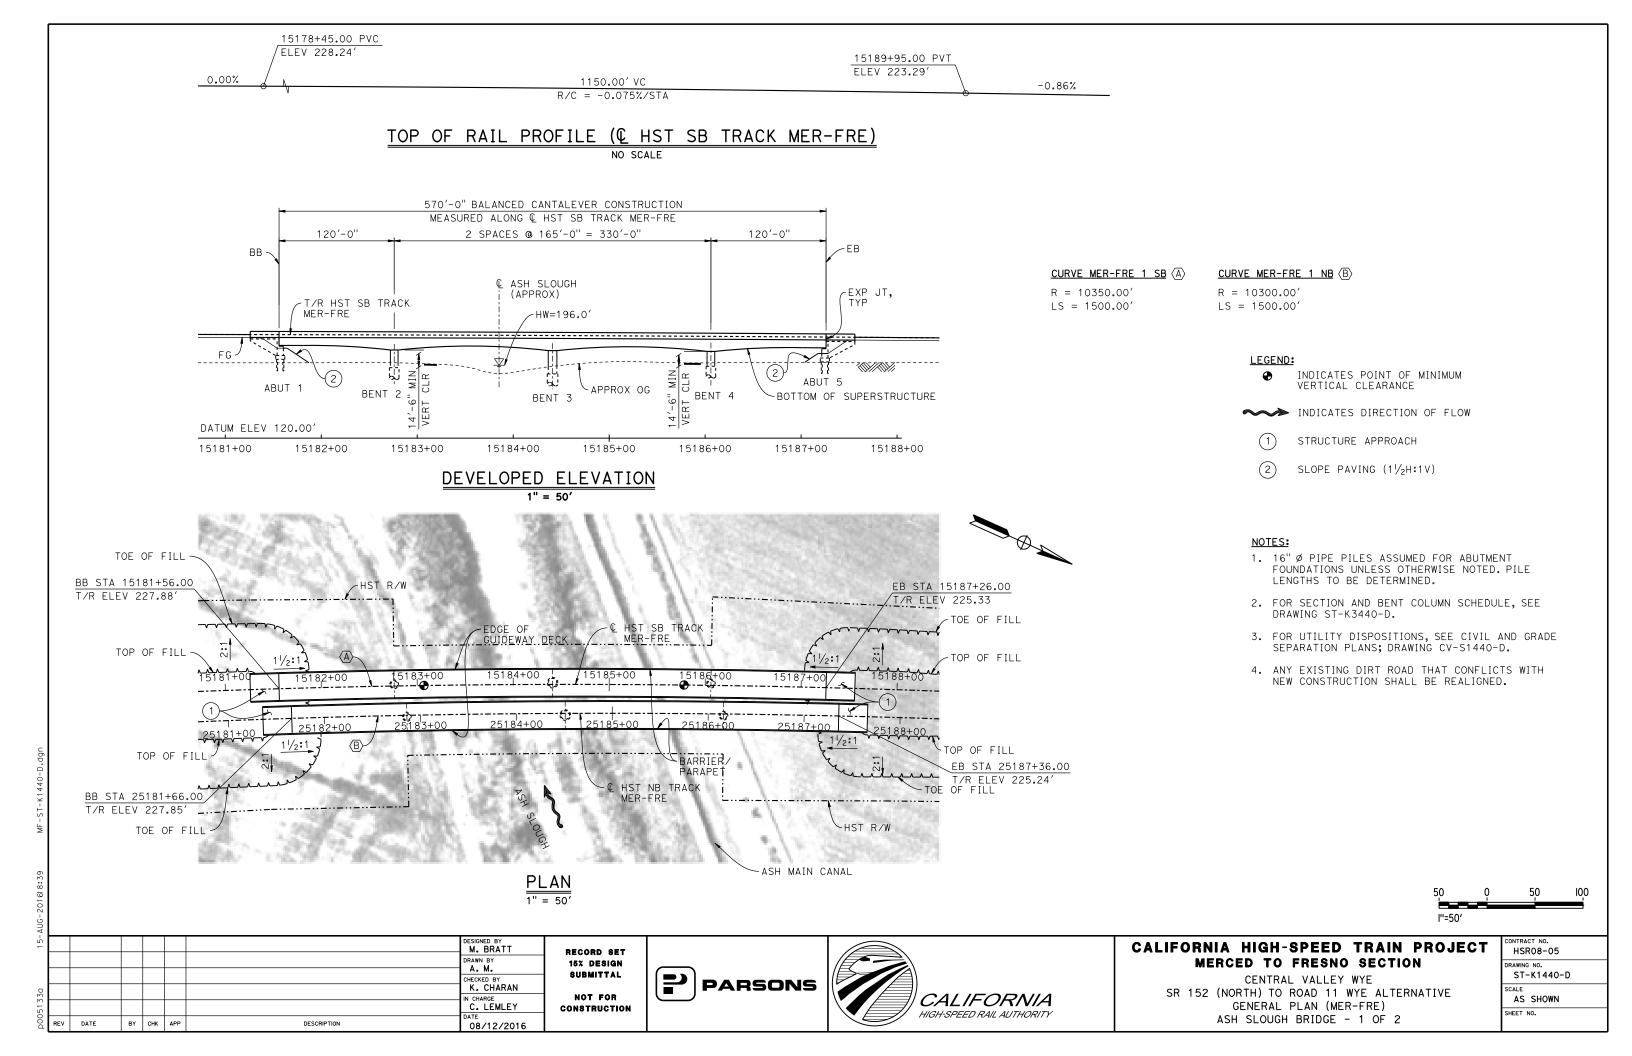

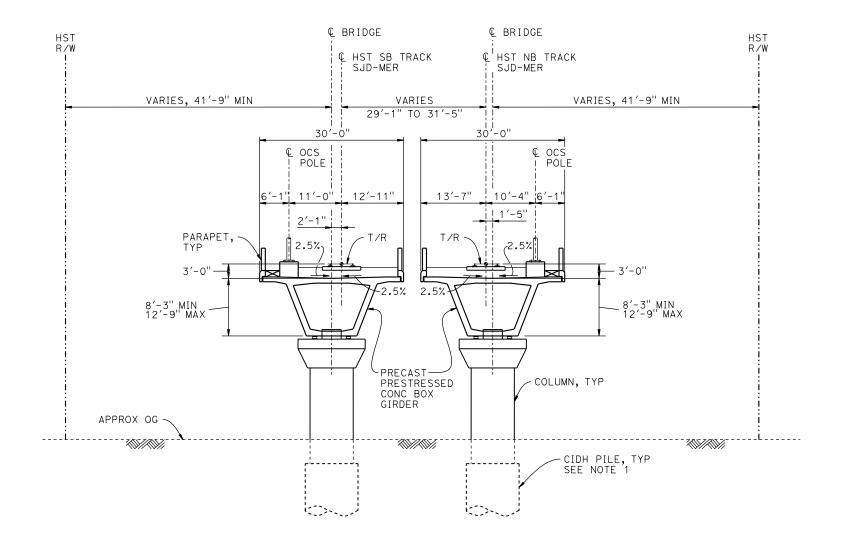

BENT COLUMN SCHEDULE					
BENT	COLUMN TYPE	CIDH TYPE			
2	7'-0" Ø	9'-0" Ø			
3	9'-0" ø	11'-0" Ø			
4	7'-0" Ø	9'-0" Ø			

TYPICAL SECTION

1" = 10'

NOTE:

- 1. 16" Ø PIPE PILES ASSUMED FOR ABUTMENT FOUNDATIONS. PILE AND DRILLED SHAFT LENGTHS TO BE DETERMINED.
- 2. FOR TRACK SUPERELEVATION DETAILS, SEE ALIGNMENT AND TYPICAL SECTION PLANS; DRAWING TT-B0054-D AND TT-B0055-D.



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0							CHECKED BY K. CHARAN	,
51330							IN CHARGE C. LEMLEY	 co
00d	REV	DATE	BY	снк	APP	DESCRIPTION	DATE 08/12/2016	

RECORD SET
15% DESIGN
SUBMITTAL
NOT FOR
CONSTRUCTION







CALIFORNIA HIGH-SPEED TRAIN PROJECT MERCED TO FRESNO SECTION

CENTRAL VALLEY WYE
SR 152 (NORTH) TO ROAD 11 WYE ALTERNATIVE
TYPICAL SECTION (MER-FRE)
ASH SLOUGH BRIDGE - 2 OF 2

CONTRACT NO.
HSR08-05
DRAWING NO.
ST-K3440-D
SCALE
AS SHOWN
SHEET NO.

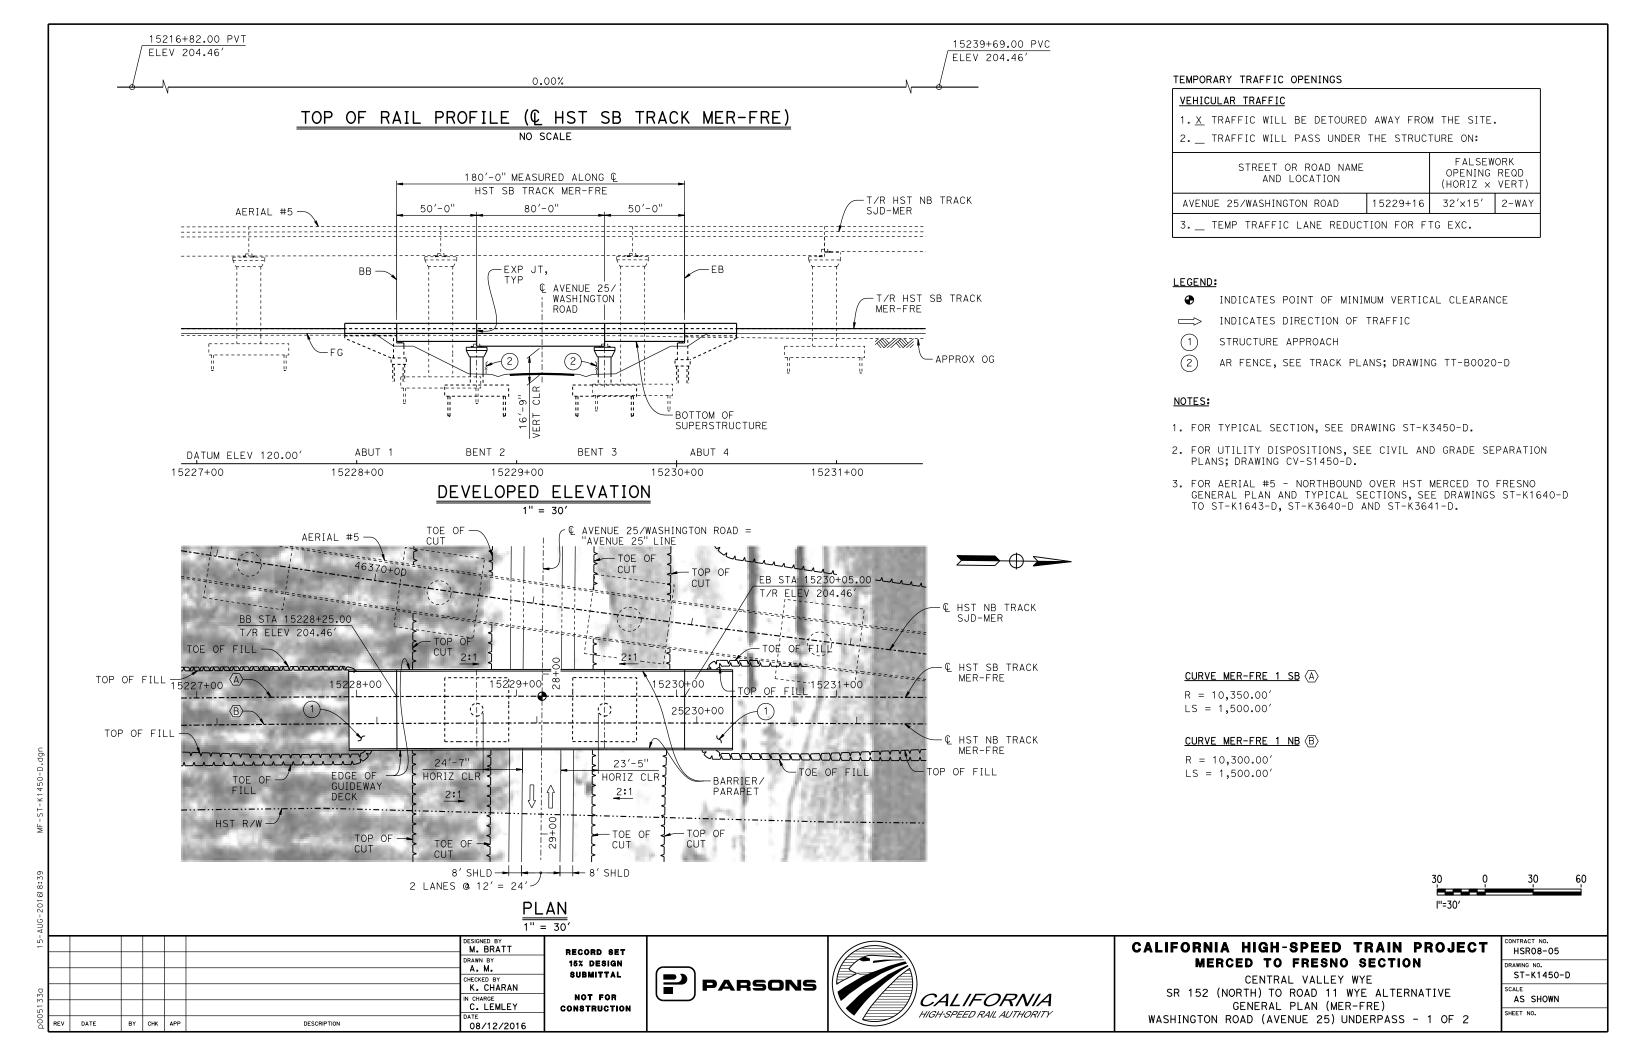

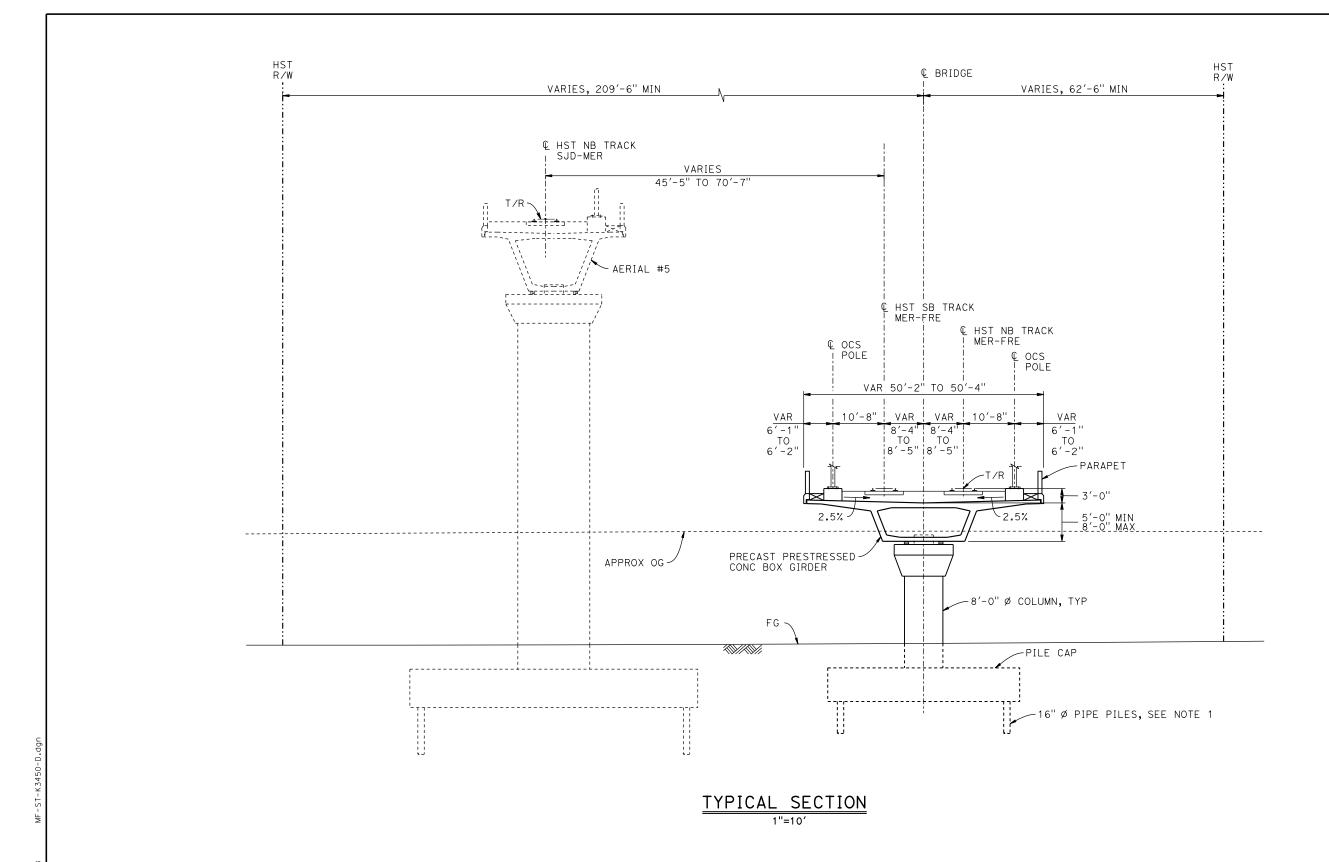

NOTES:

- 1. 16" Ø PIPE PILES ASSUMED FOR ABUTMENT AND BENT FOUNDATIONS. PILE LENGTHS TO BE DETERMINED.
- 2. FOR TRACK SUPERELEVATION DETAILS, SEE ALIGNMENT AND TYPICAL SECTION PLANS; DRAWINGS TT-B0054-D AND TT-B0055-D.



| DESIGNED BY | M. BRATT | DRAWN BY | A. M. | CHECKED BY | K. CHARAN | IN CHARGE | C. LEMLEY | COI

RECORD SET
15% DESIGN
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CONSTRUCTION







CALIFORNIA HIGH-SPEED TRAIN PROJECT MERCED TO FRESNO SECTION

CENTRAL VALLEY WYE
SR 152 (NORTH) TO ROAD 11 WYE ALTERNATIVE
TYPICAL SECTION (MER-FRE)
WASHINGTON ROAD (AVENUE 25) UNDERPASS - 2 OF 2


CONTRACT NO.
HSR08-05
DRAWING NO.
ST-K3450-D
SCALE
AS SHOWN
SHEET NO.
ST-K3450-D SCALE AS SHOWN

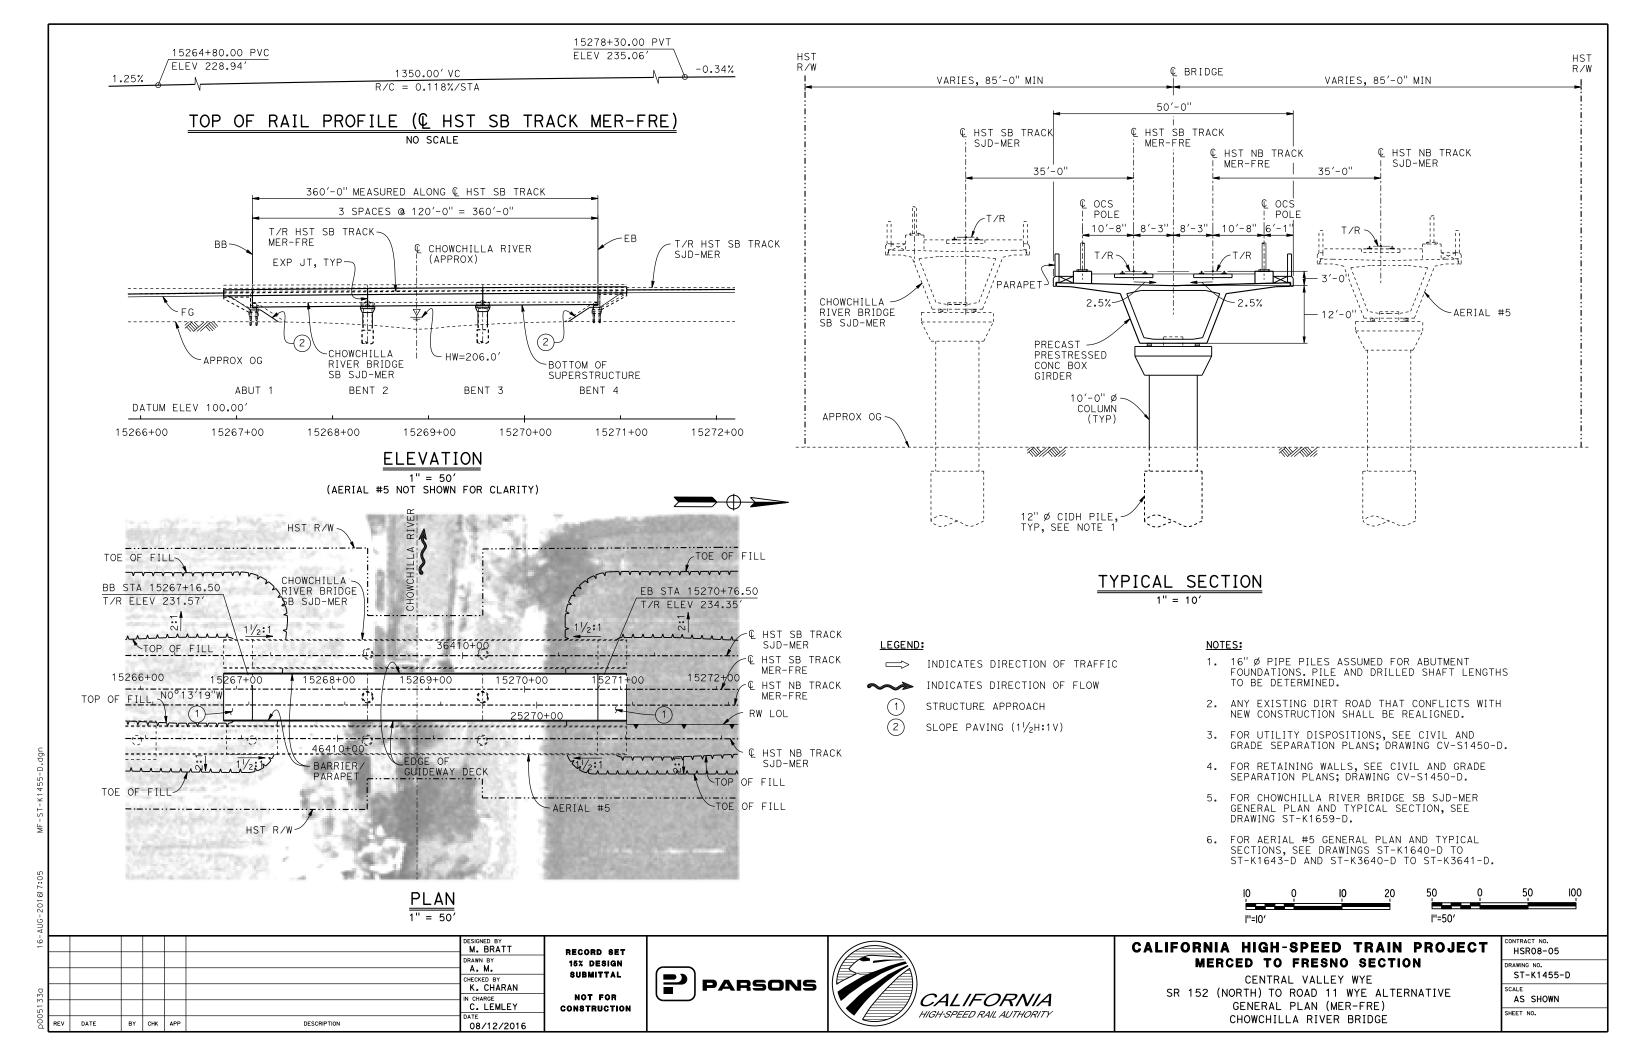

TOP OF RAIL PROFILE (HST SB TRACK MER-FRE) NO SCALE

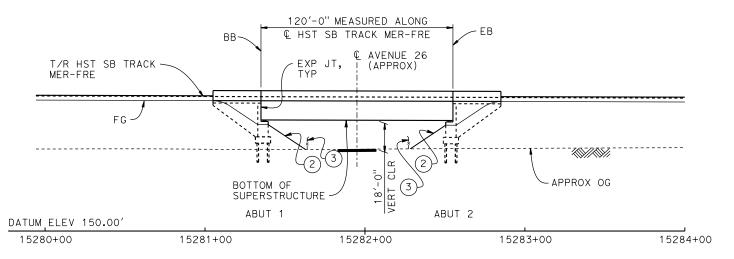

$\frac{\text{ELEVATION}}{1'' = 30'}$

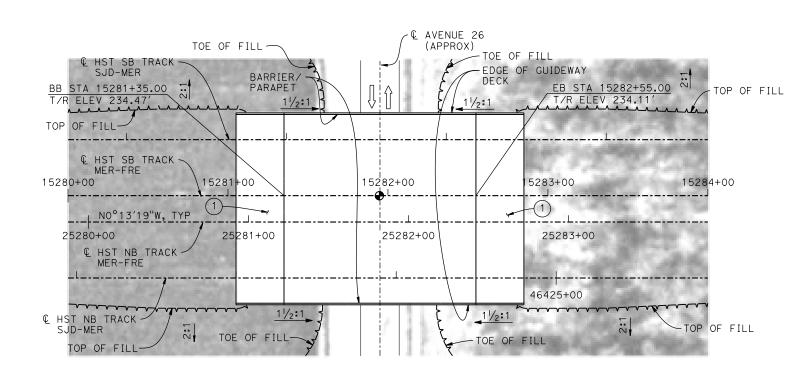

 $\frac{\mathsf{PLAN}}{\mathsf{1''} = 30'}$

DESCRIPTION

DATE

BY CHK APP

M. BRATT

K. CHARAN

IN CHARGE
C. LEMLEY


08/12/2016

DRAWN BY

RECORD SET
15% DESIGN
SUBMITTAL
NOT FOR
CONSTRUCTION





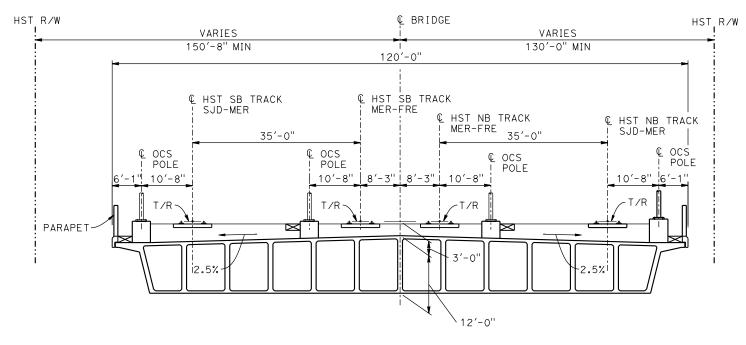

TYPICAL SECTION

LEGEND:

INDICATES POINT OF MINIMUM VERTICAL CLEARANCE

⇒ INDICATES DIRECTION OF TRAFFIC


- 1) STRUCTURE APPROACH
- 2 SLOPE PAVING (11/2H:11)
- 3 AR FENCE, SEE TRACK PLANS DRAWING TT-B0020-D

NOTES:

- 16" Ø PIPE PILES ASSUMED FOR ABUTMENT FOUNDATIONS. PILE LENGTHS TO BE DETERMINED.
- 2. FOR UTILITY DISPOSITIONS, SEE CIVIL AND GRADE SEPARATION PLANS; DRAWING CV-S1460-D.
- 3. ANY EXISTING DIRT ROAD THAT CONFLICTS WITH NEW CONSTRUCTION SHALL BE REALIGNED.

TEMPORARY TRAFFIC OPENINGS


<u>VE</u>	VEHICULAR TRAFFIC									
1.	1TRAFFIC WILL BE DETOURED AWAY FROM THE SITE.									
2.	2. X TRAFFIC WILL PASS UNDER THE STRUCTURE ON:									
	FALSEWO OPENING (HORIZ X	REQD								
AVE	ENUE 26	15281+95	32′X16.5′	2-WAY						
3.	3TEMP TRAFFIC LANE REDUCTION FOR FTG EXC.									

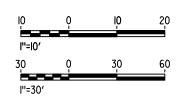



CALIFORNIA HIGH-SPEED TRAIN PROJECT MERCED TO FRESNO SECTION

CENTRAL VALLEY WYE
SR 152 (NORTH) TO ROAD 11 WYE ALTERNATIVE
GENERAL PLAN (MER-FRE)
AVENUE 26 UNDERPASS

CONTRACT NO. HSR08-05
ST-K1460-D
AS SHOWN
SHEET NO.

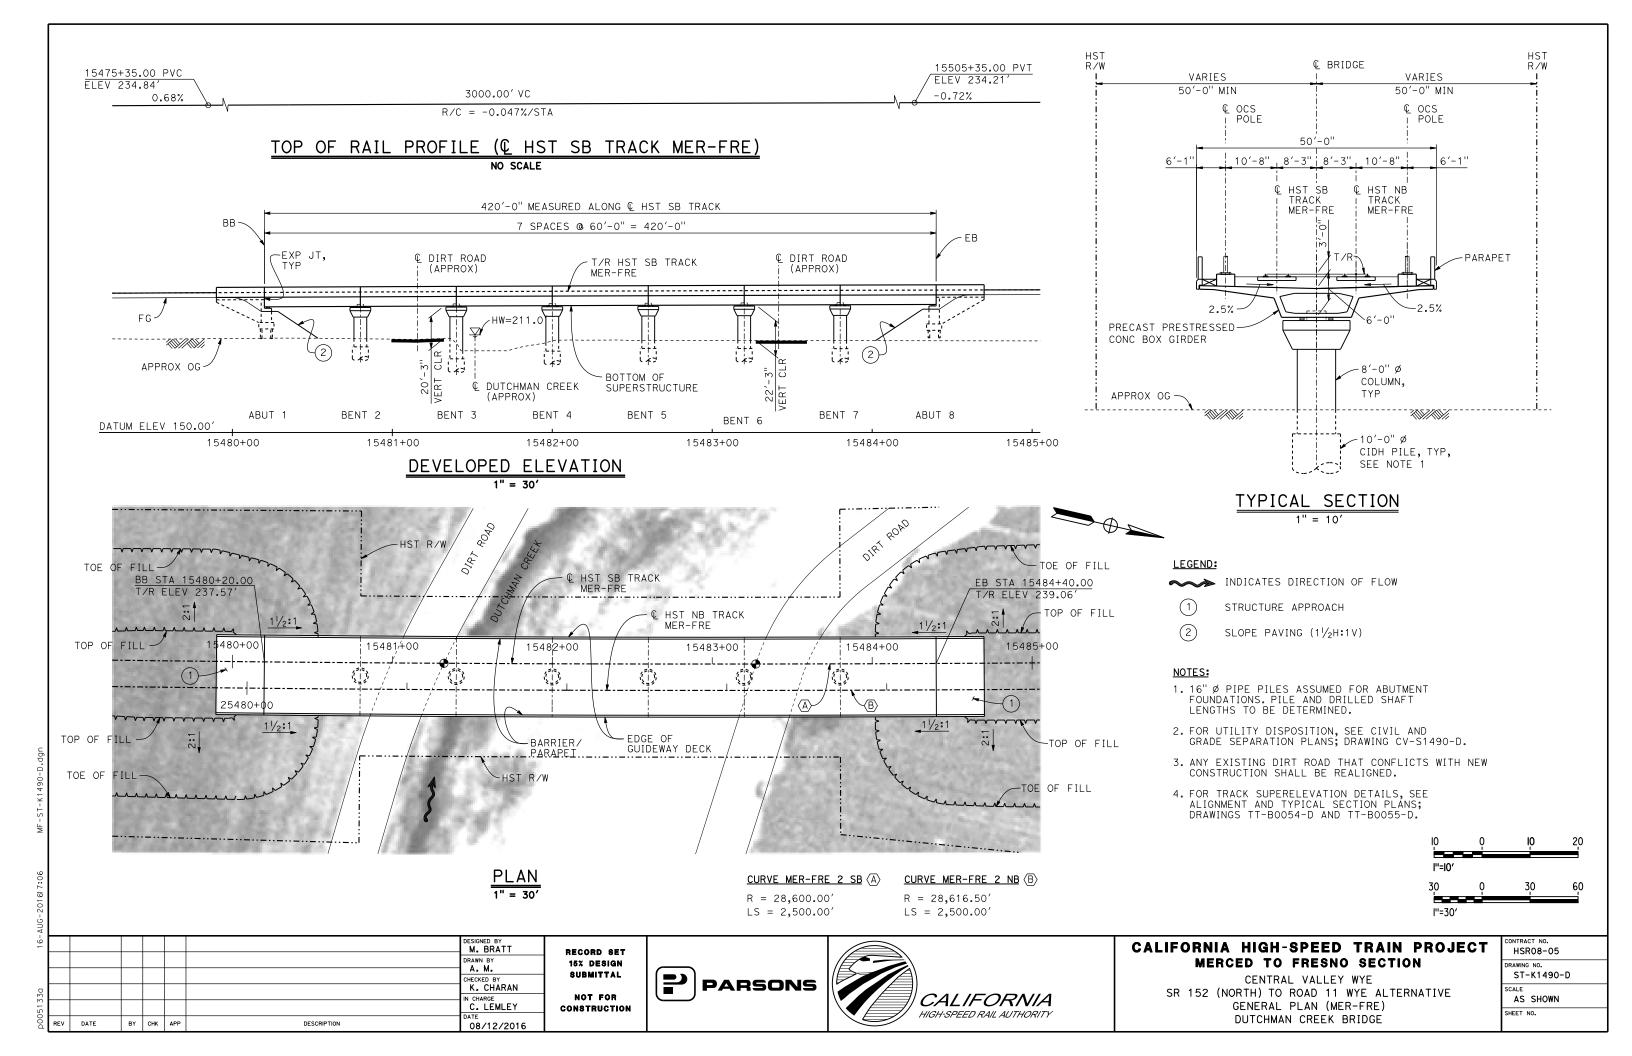

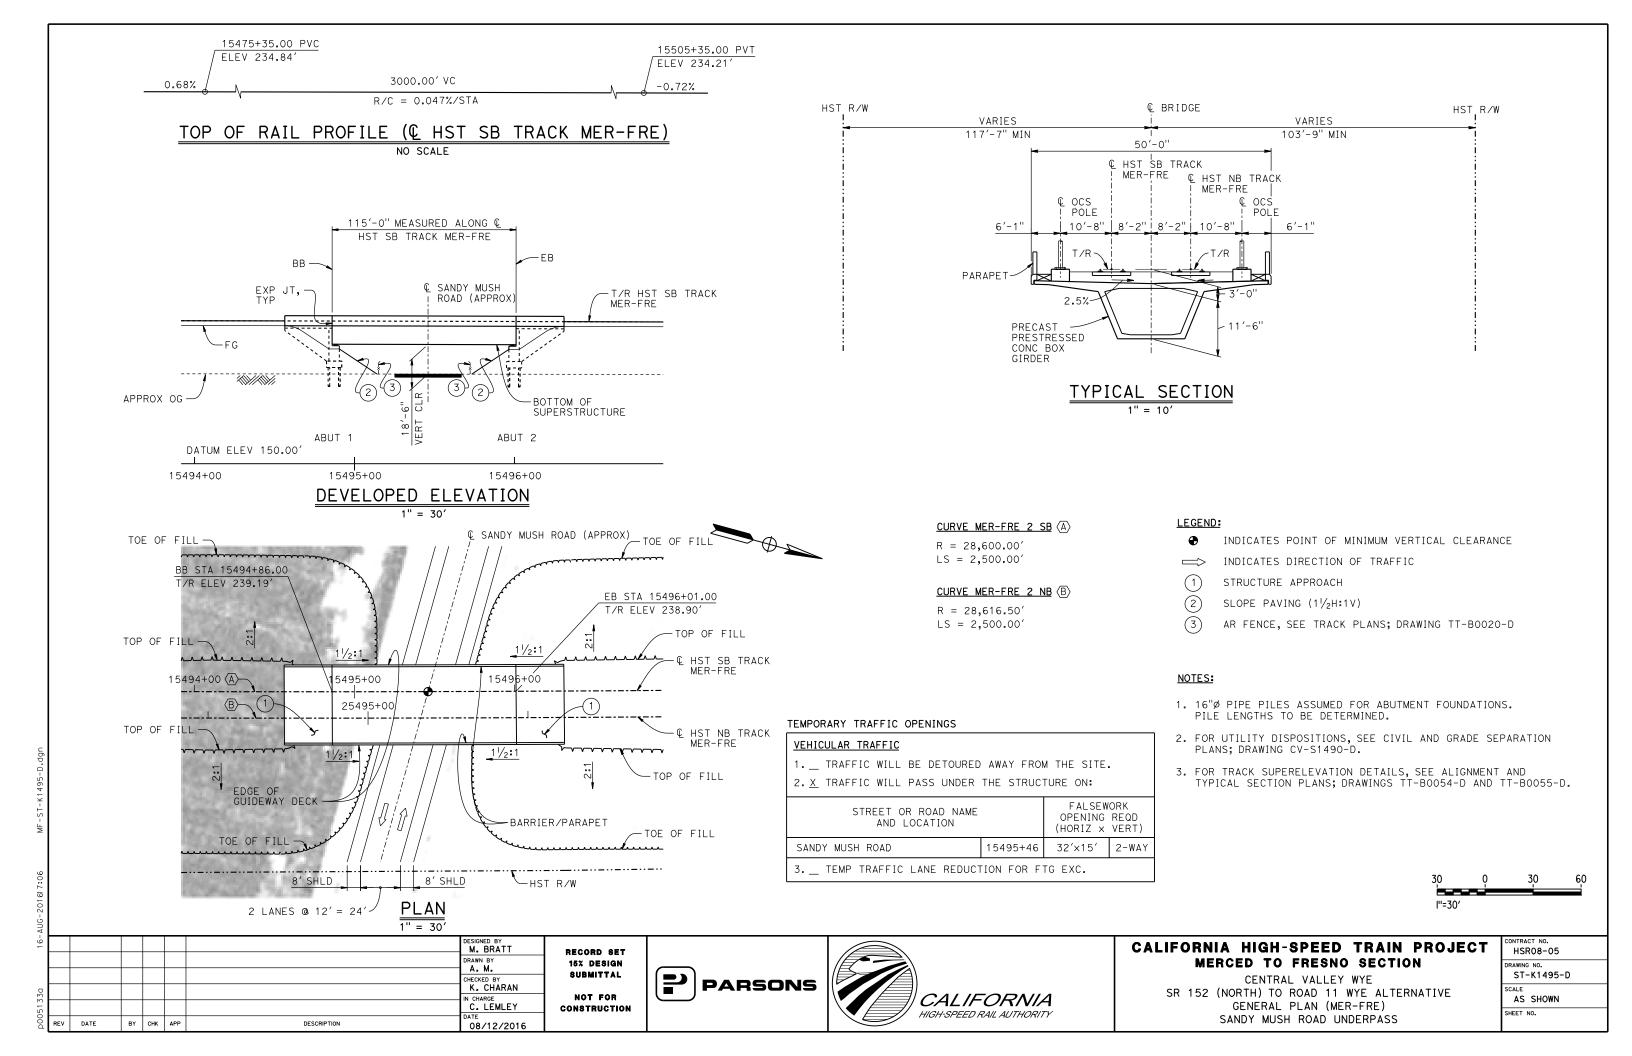

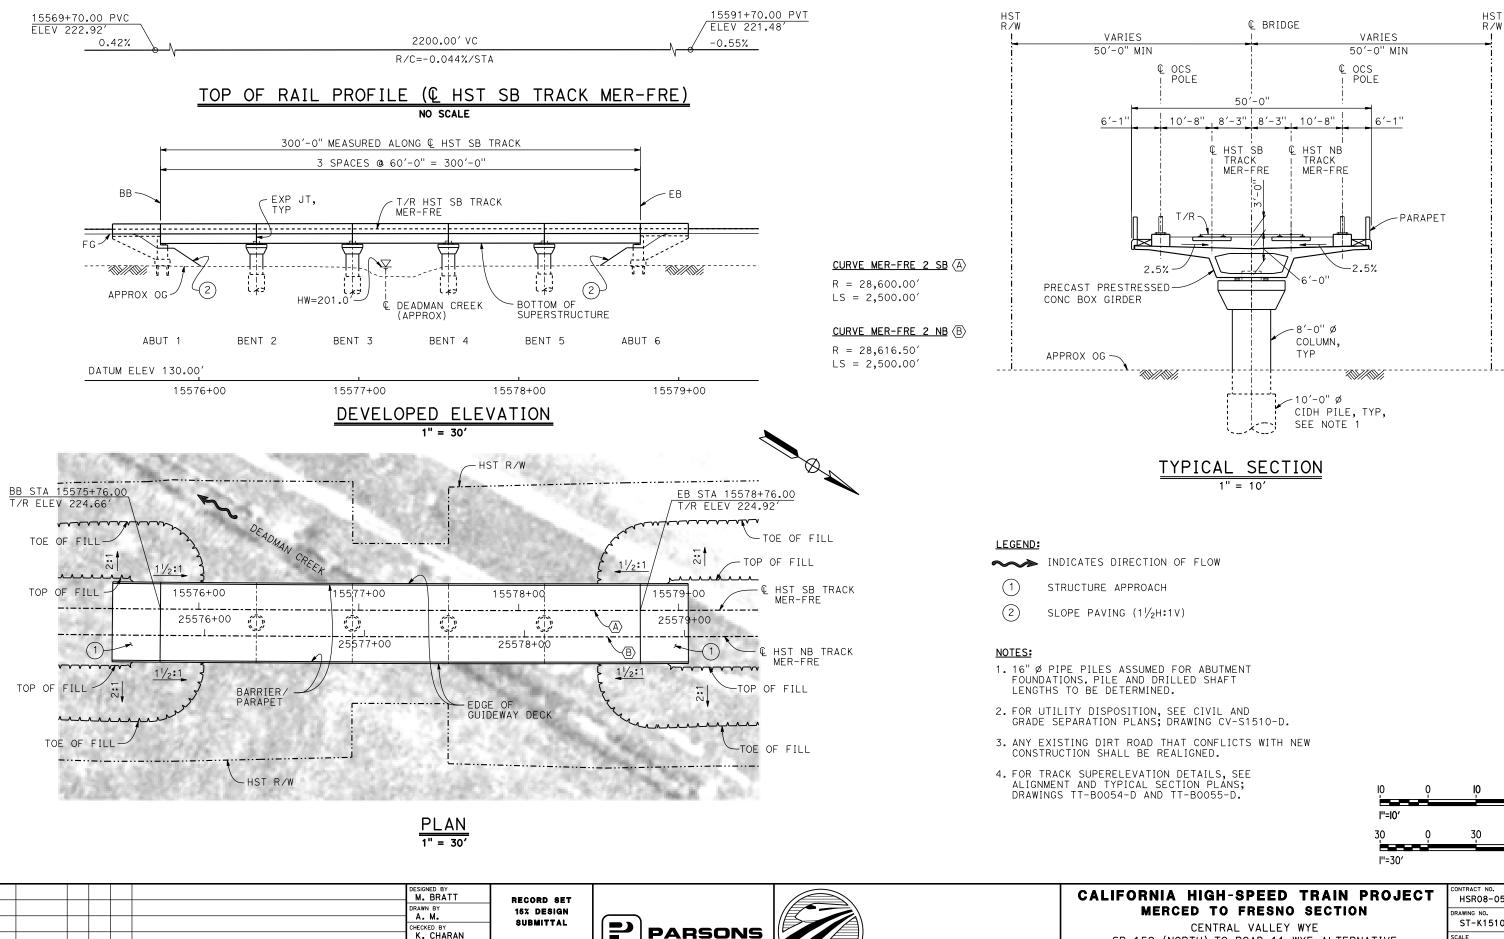

CALIFORNIA

HIGH-SPEED RAIL AUTHORITY

NOT FOR

CONSTRUCTION

IN CHARGE
C. LEMLEY

08/12/2016

DATE

BY CHK APP

DESCRIPTION

HSR08-05

DRAWING NO.

ST-K1510-D

SCALE

AS SHOWN

SHEET NO.


SR 152 (NORTH) TO ROAD 11 WYE ALTERNATIVE

GENERAL PLAN (MER-FRE)

DEADMAN CREEK BRIDGE No. 1

20


60

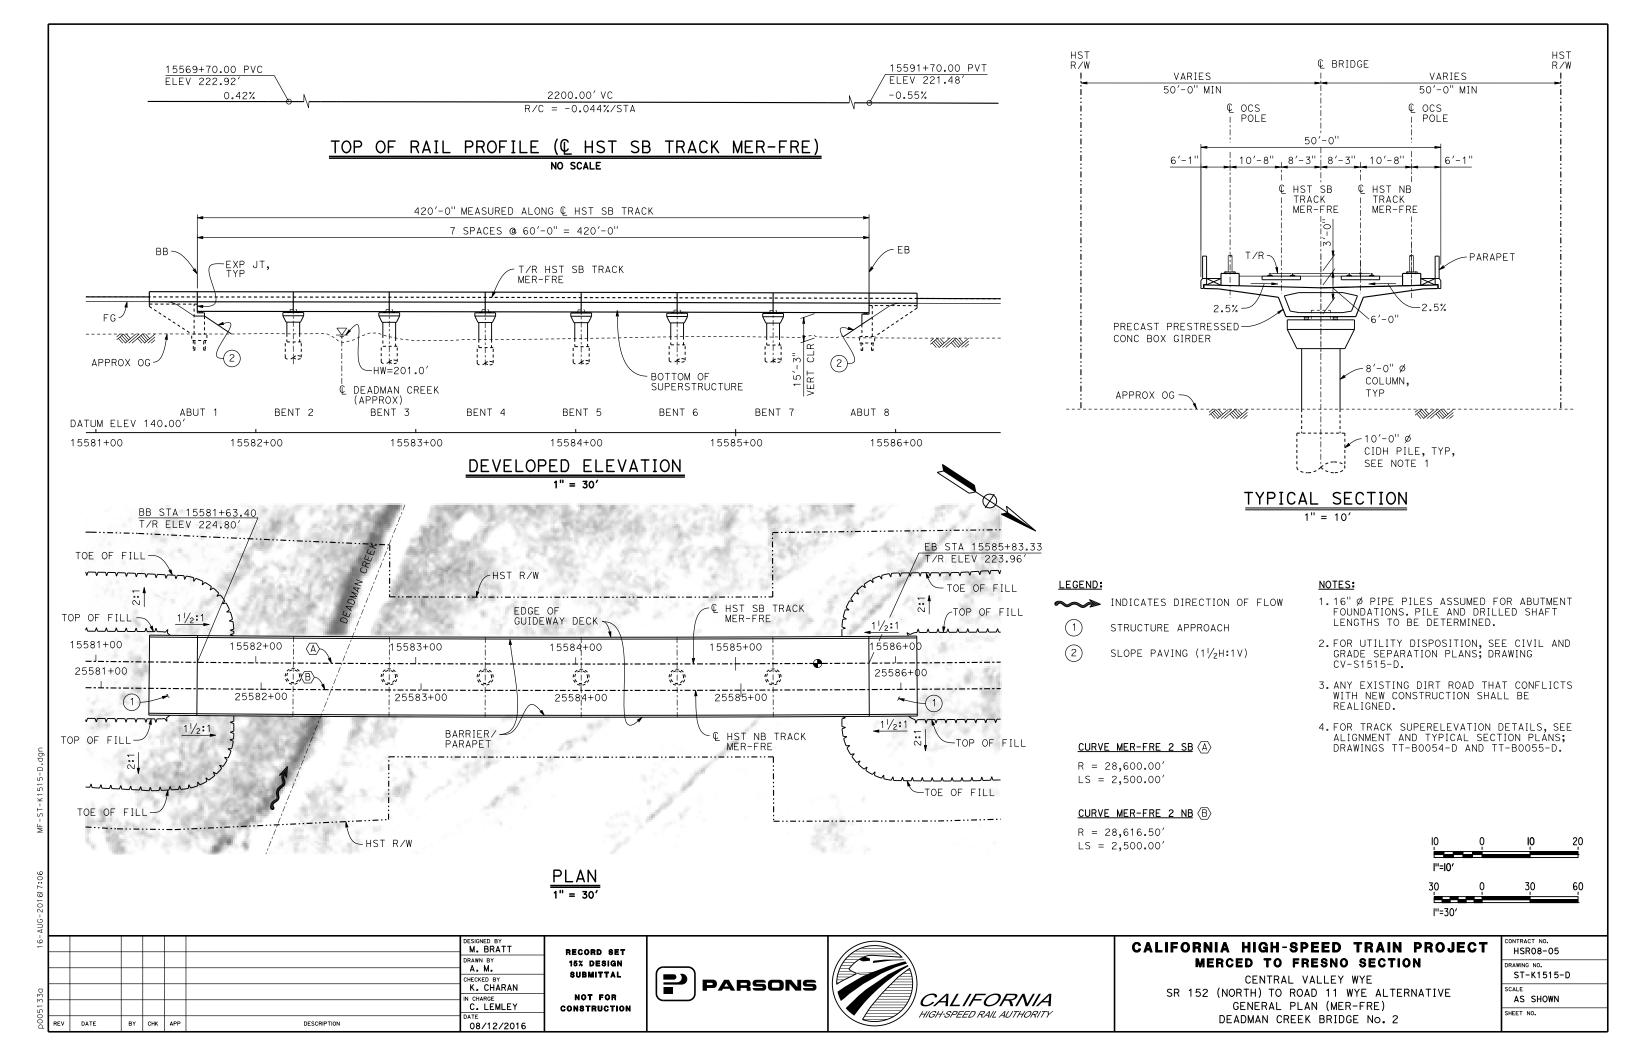

LEGEND: INDICATES POINT OF MINIMUM VERTICAL CLEARANCE 46160+92.99 PVT ELEV 179.90' ➤ INDICATES DIRECTION OF FLOW INDICATES DIRECTION OF TRAFFIC STRUCTURE APPROACH SLOPE PAVING $(1\frac{1}{2}H:1V)$ TOP OF RAIL PROFILE (& HST NB TRACK SJD-MER) TEMPORARY TRAFFIC OPENINGS 7080'-0" TOTAL LENGTH MEASURED ALONG € HST NB TRACK SJD-MER VEHICULAR TRAFFIC 21 SPACES @ 120'-0" = 2520'-0" 1. X TRAFFIC WILL BE DETOURED AWAY FROM THE SITE. BB 2. _ TRAFFIC WILL PASS UNDER THE STRUCTURE ON: T/R HST NB TRACK -EXP JT, TYP SJD-MER FALSEWORK ST OR ROAD NAME OPENING REQD AND LOCATION (HORIZ X VERT HEMLOCK RD 46211+10 32'X16.5' TEMP TRAFFIC LANE REDUCTION FOR FTG EXC. APPROX OG BOTTOM OF SUPERSTRUCTURE ABUT 1 BENT 3 BENT 5 BENT 7 BENT 9 BENT 11 BENT 13 BENT 15 BENT 17! BENT 2 BENT 4 BENT 6 BENT 8 BENT 10 BENT 12 BENT 14 BENT 16 DATUM ELEV 70.00' NOTES: 16" Ø PIPE PILES ASSUMED FOR ABUTMENT AND BENT FOUNDATIONS, UNLESS OTHERWISE NOTED. PILE LENGTHS TO BE DETERMINED. 46175+00 46180+00 46185+00 46190+00 DEVELOPED ELEVATION 2. FOR SECTIONS AND BENT COLUMN VERT: 1" = 50' HORIZ: 1" = 100' SCHEDULE, SEE DRAWINGS ST-K3610-D AND ST-K3611-D. 3. ANY EXISTING DIRT ROAD THAT CONFLICTS WITH NEW CONSTRUCTION SHALL BE REALIGNED. E HST SB TRACK SJD-MER EDGE OF 4. FOR RETAINING WALLS, SEE CIVIL AND C HST NB TRACK SJD-FRE GUIDEWAY DECK GRADE SEPARATION PLANS; DRAWINGS - L HST SB TRACK SJD-FRE CV-S1610-D AND CV-S1630-D. TOE OF FILL, TYP-C HST NB TRACK SJD-MER 5. FOR UTILITY DISPOSITIONS, SEE CIVIL AND GRADE SEPARATION PLANS; DRAWINGS CV-S1610-D AND CV-S1630-D. 6. FOR HEMLOCK RD (ROAD 9) INTERCHANGE GENERAL PLAN AND TYPICAL SECTION, SEE DRAWING ST-K1160-D. TOP OF FILL. 7. FOR HEMLOCK RD (ROAD 9) OVERHEAD TYP GENERAL PLAN AND TYPICAL SECTION, SEE DRAWING ST-K1620-D. TOE OF FILL, CURVE SJD-MER 1 NB (A) N89°54′47.414"E R = 12,000.00'LS = 1,500.00'I"=50' 200 PLAN I"=I00' M. BRATT CALIFORNIA HIGH-SPEED TRAIN PROJECT HSR08-05 RECORD SET MERCED TO FRESNO SECTION 15% DESIGN SUBMITTAL ST-K1610-D CENTRAL VALLEY WYE K. CHARAN **PARSONS** SR 152 (NORTH) TO ROAD 11 WYE ALTERNATIVE NOT FOR N CHARGE C. LEMLEY **CALIFORNIA** AS SHOWN GENERAL PLAN (SJD-MER) CONSTRUCTION HIGH-SPEED RAIL AUTHORITY SHEET NO. AERIAL #4 - NORTHBOUND OVER HST MAINLINE - 1 OF 5 BY CHK APP DESCRIPTION 08/12/2016

TOP OF RAIL PROFILE (& HST NB TRACK SJD-MER)

NO SCALE

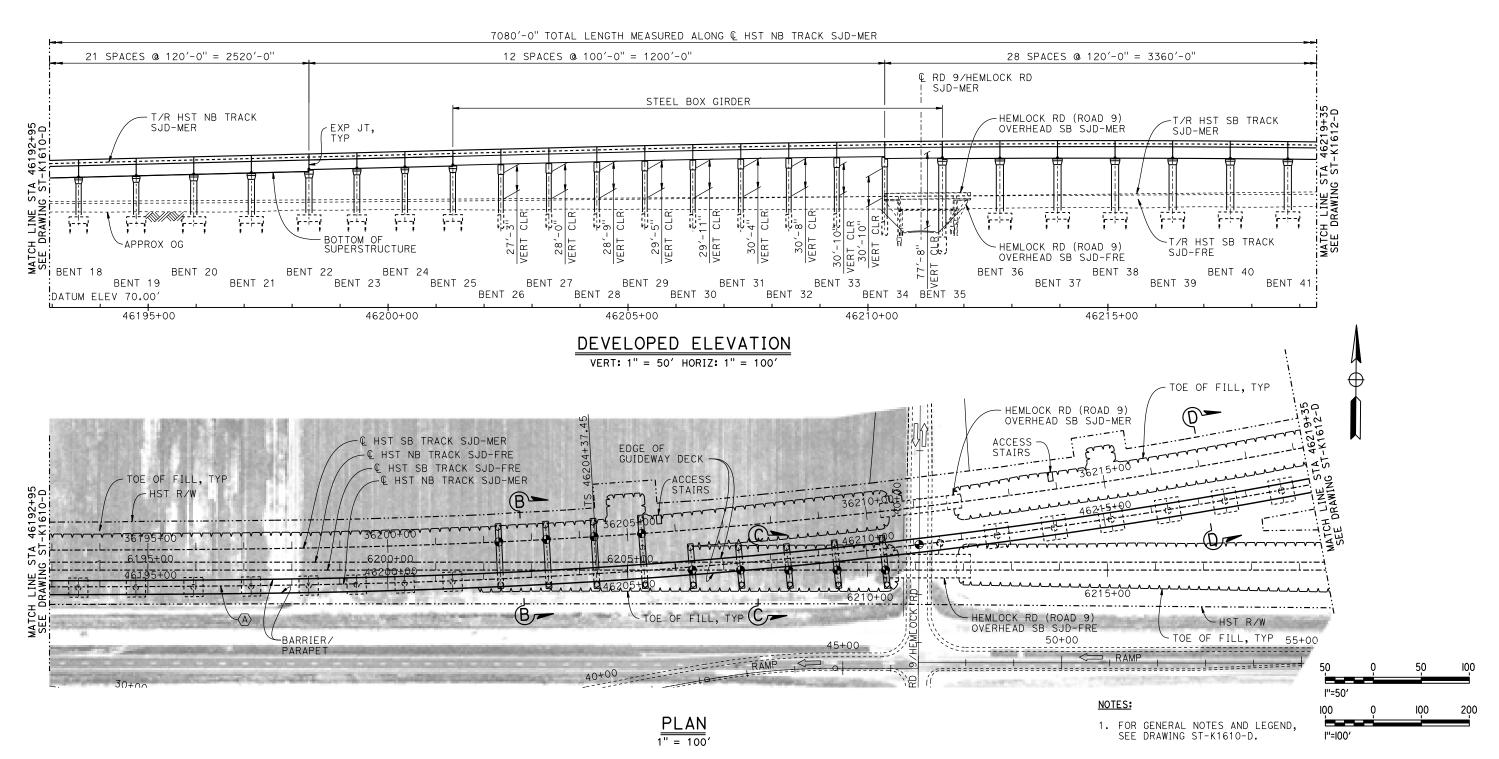

DESIGNED BY
M. BRATT

DRAWN BY
A. M.
CHECKED BY
K. CHARAN
IN CHARGE
C. LEMLEY

DATE

REV DATE BY CHK APP

DESCRIPTION

DESCRIPTION

DESCRIPTION

DATE
08/12/2016

RECORD SET
15% DESIGN
SUBMITTAL
NOT FOR
CONSTRUCTION








CALIFORNIA HIGH-SPEED TRAIN PROJECT MERCED TO FRESNO SECTION


CENTRAL VALLEY WYE
SR 152 (NORTH) TO ROAD 11 WYE ALTERNATIVE
GENERAL PLAN (SJD-MER)
AERIAL #4 - NORTHBOUND OVER HST MAINLINE - 2 OF 5


CONTRACT NO.
HSRO8-05
DRAWING NO.
ST-K1611-D
SCALE
AS SHOWN
SHEET NO.

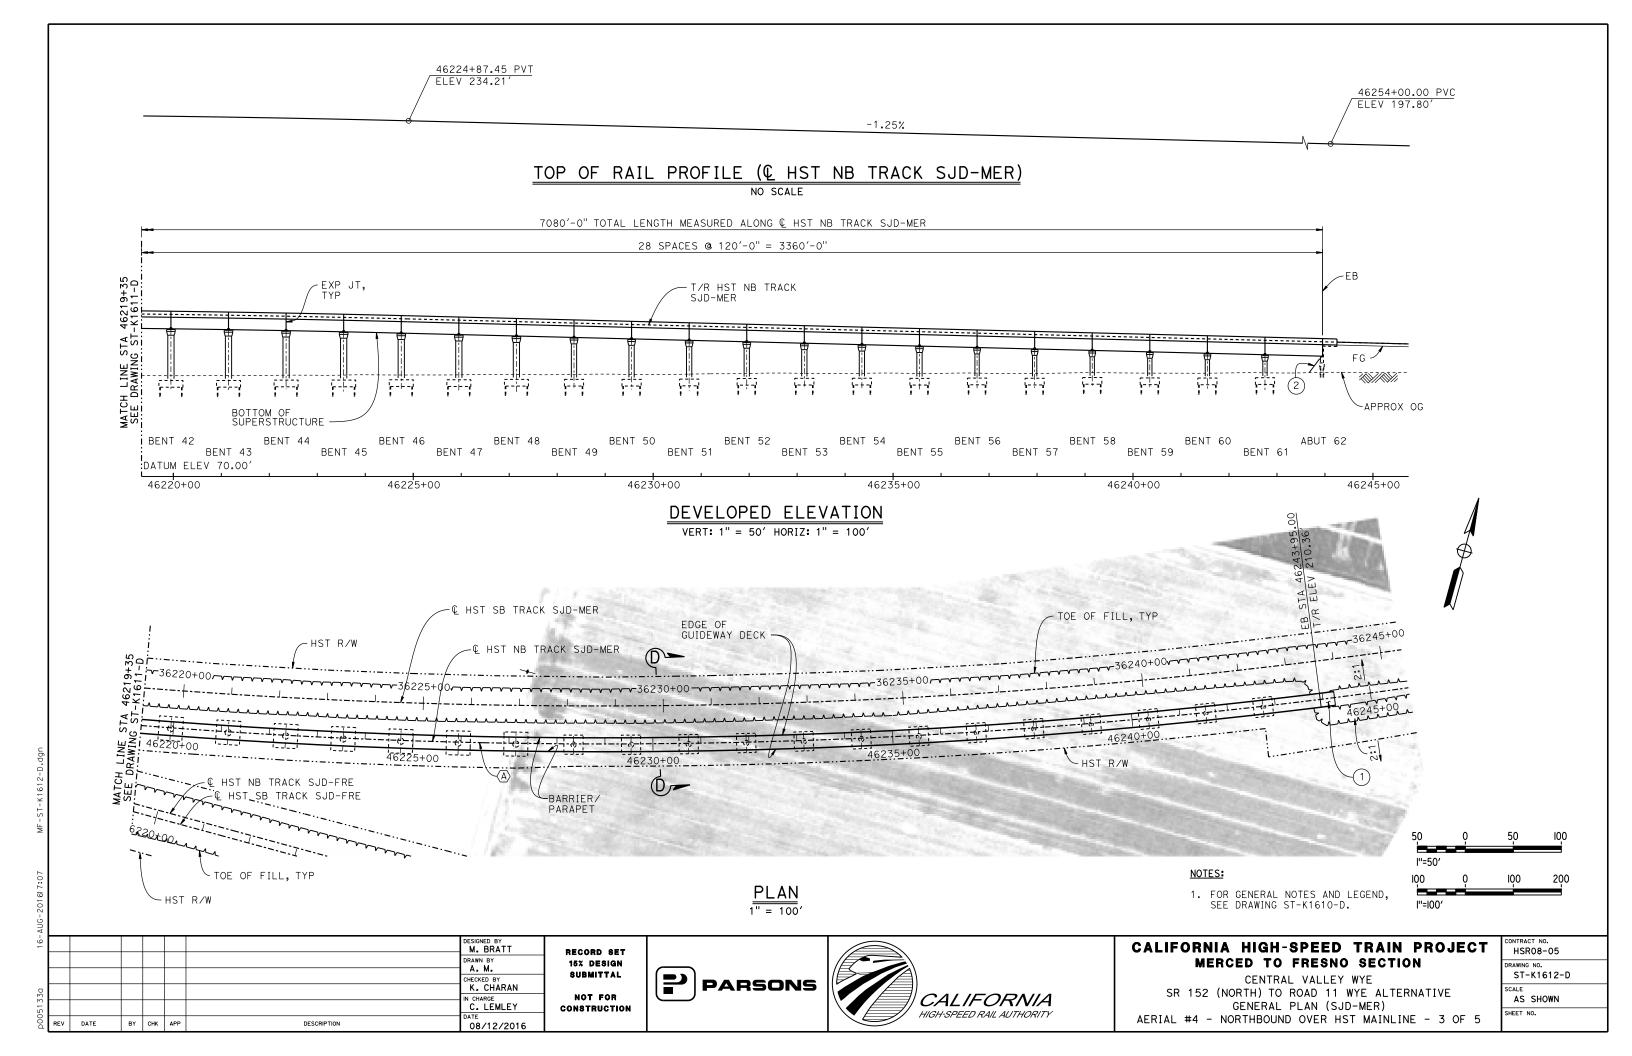

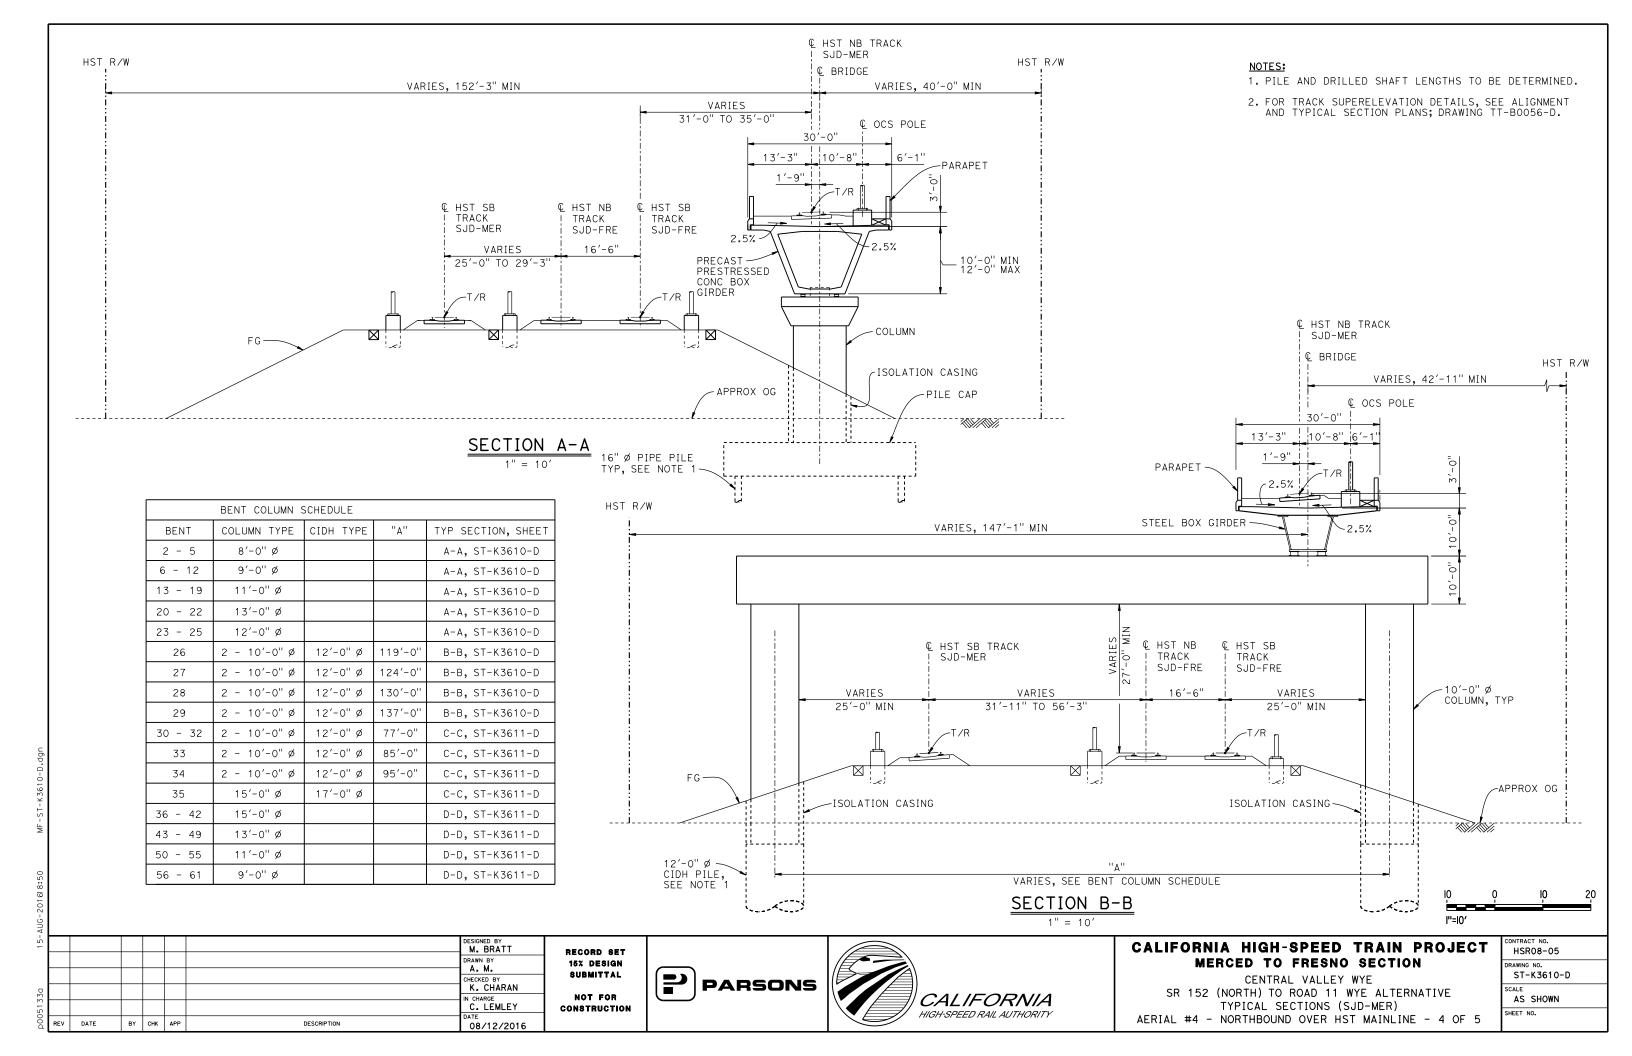

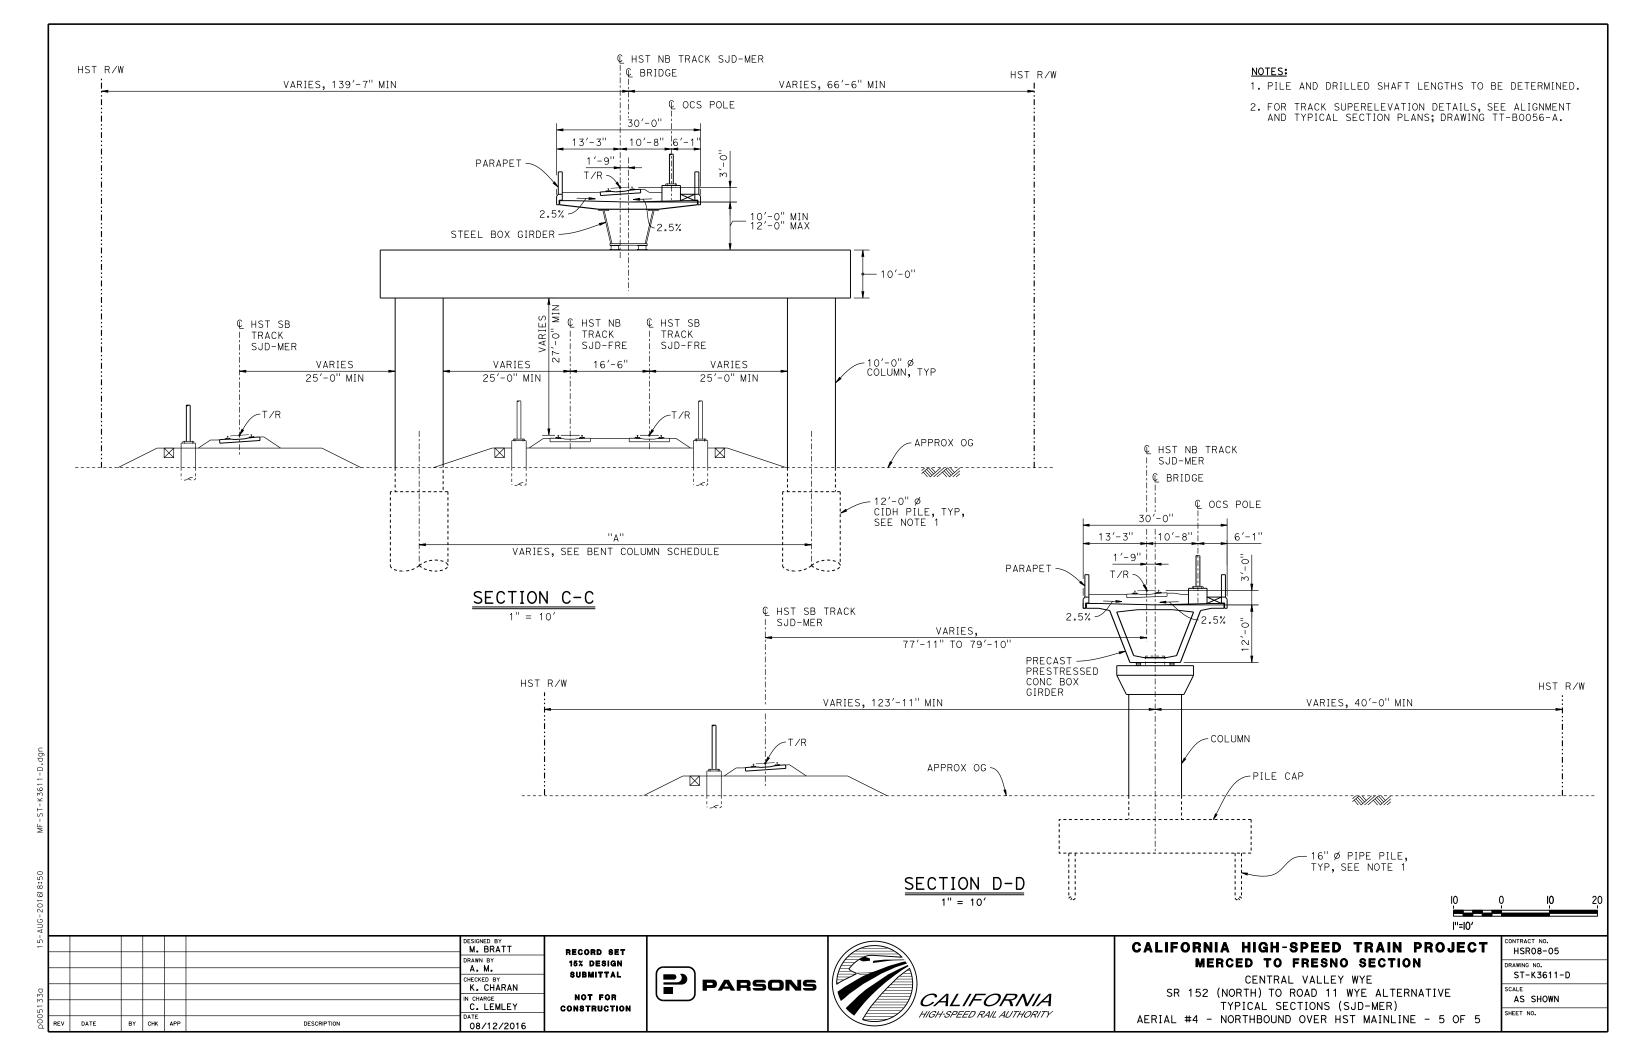

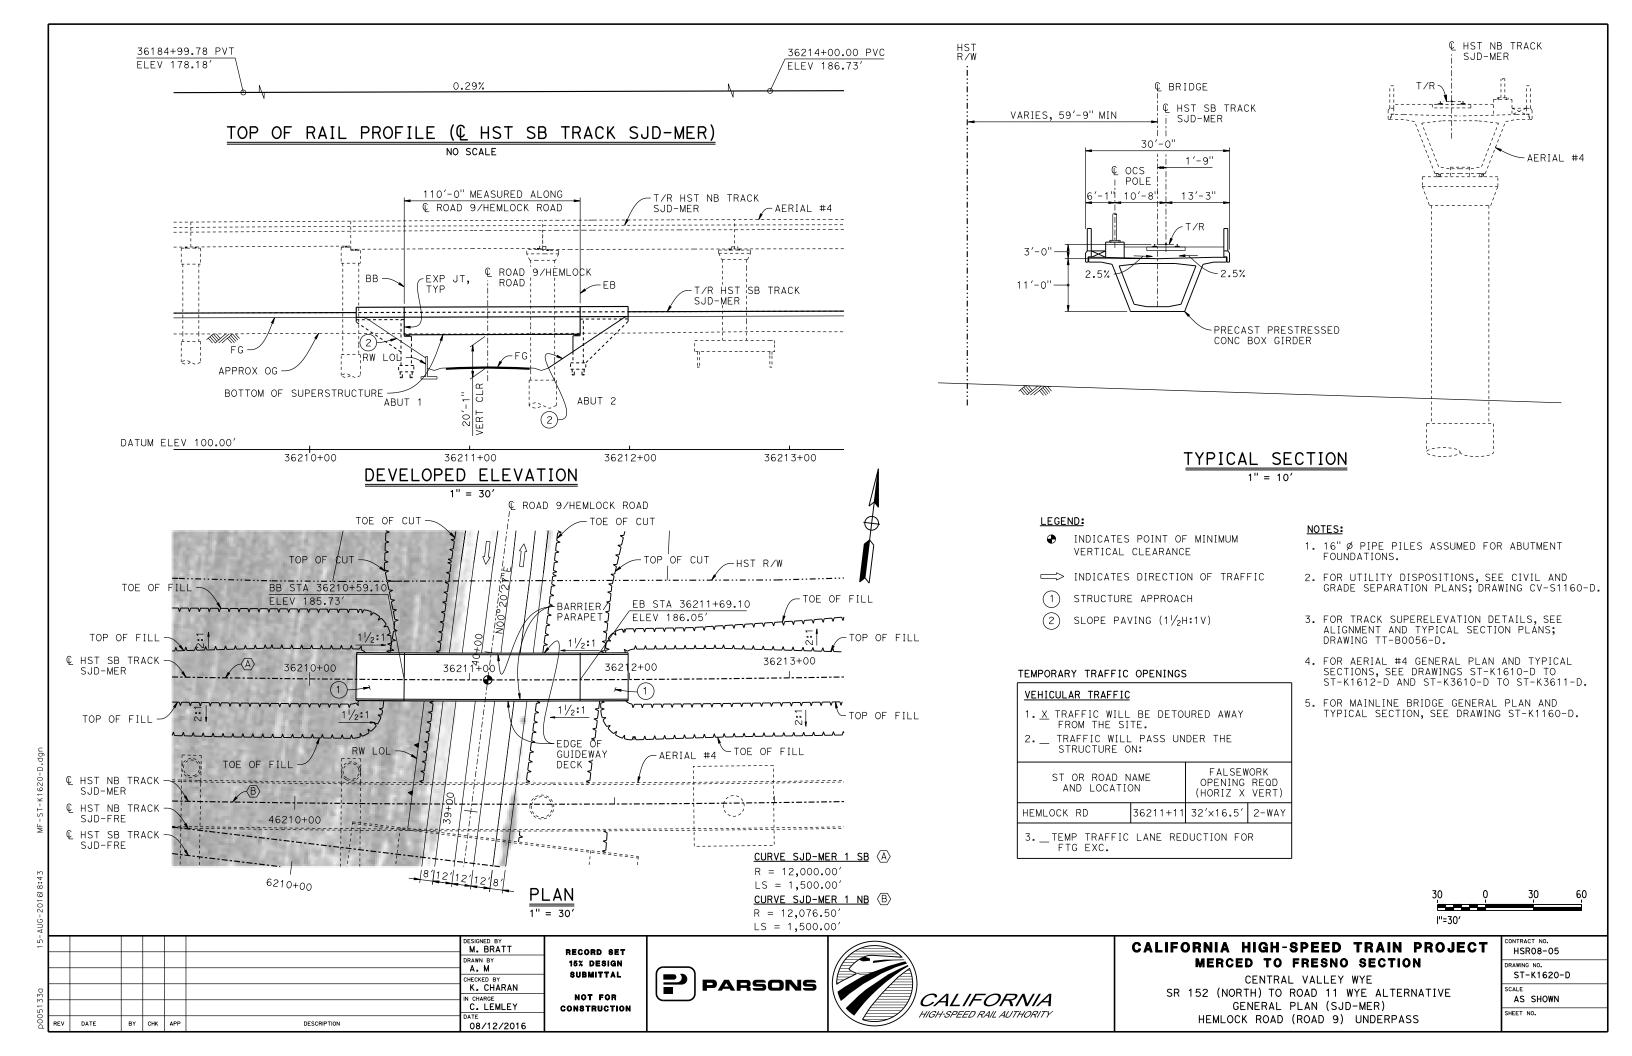

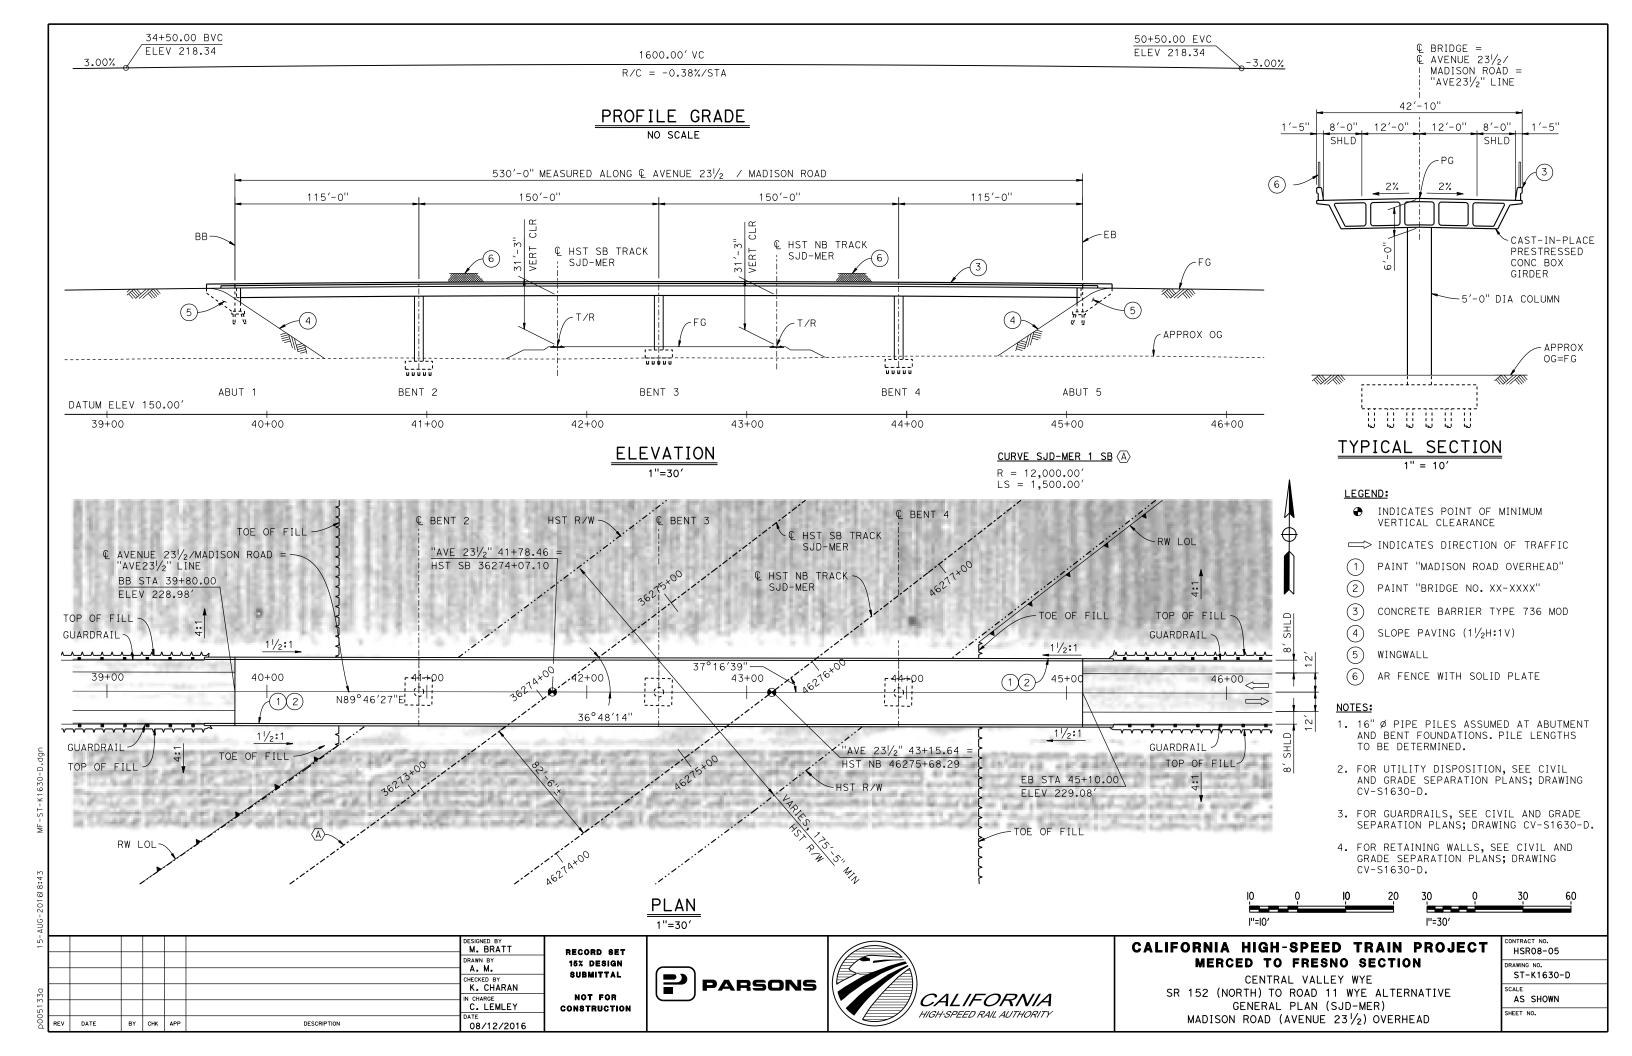

LEGEND: INDICATES POINT OF MINIMUM VERTICAL CLEARANCE 46320+00.00 PVT INDICATES DIRECTION OF TRAFFIC ELEV 208.30' 1.25% >>> INDICATES DIRECTION OF FLOW STRUCTURE APPROACH TOP OF RAIL PROFILE (& HST NB TRACK SJD-MER) SLOPE PAVING (1/2H:1V) NO SCALE CURVE SJD-MER 1 NB (A) R = 12,076.50'TEMPORARY TRAFFIC OPENINGS LS = 1,500.00'VEHICULAR TRAFFIC 8,310'-0" TOTAL LENGTH MEASURED ALONG & HST NB TRACK SJD-MER 1. \underline{X} TRAFFIC WILL BE DETOURED AWAY FROM THE SITE. 36 SPACES @ 120'-0'' = 4,320'-0''2. _ TRAFFIC WILL PASS UNDER THE STRUCTURE ON: FALSEWORK ST OR ROAD NAME OPENING REQD (HORIZ X VERT) AND LOCATION BB~ ROAD 11 REALIGNMENT 46359+08 32'X16.5' 2-WAY T/R HST SB TRACK TA-TS T/R HST NB TRACK EXP JT, SJD-MER MATCH LINE ST, SEE DRAWING S SJD-MER 46371+05 32'X16.5' AVENUE 25/WASHINGTON RD 2-WAY TYP 3. __ TEMP TRAFFIC LANE REDUCTION FOR FTG EXC. FG ~ (2)95 f 5 APPROX OG-BOTTOM OF NOTES: SUPERSTRUCTURE 1. 16" Ø PIPE PILES ASSUMED FOR ABUTMENT AND BENT FOUNDATIONS, UNLESS OTHERWISE NOTED. PILE LENGTHS ABUT 1 BENT 3 BENT 5 BENT 7 BENT 9 BENT 11 BENT 13 BENT 15 TO BE DETERMINED. BENT 2 BENT 4 BENT 6 BENT 8 BENT 10 BENT 12 BENT 14 BENT 16 DATUM ELEV 100.00° 2. FOR SECTIONS AND BENT COLUMN SCHEDULE, SEE DRAWINGS 46335+00 46330+00 46340+00 46345+00 ST-K3640-D AND ST-K3641-D. DEVELOPED ELEVATION 3. ANY EXISTING DIRT ROAD THAT CONFLICTS WITH NEW CONSTRUCTION SHALL BE REALIGNED. VERT: 1" = 50' HORIZ: 1" = 100 4. FOR UTILITY DISPOSITIONS, SEE CIVIL AND GRADE SEPARATION PLANS; DRAWINGS CV-S1640-D TO CV-S1660-D. 5. FOR GUARDRAILS, SEE CIVIL AND GRADE SEPARATION PLANS; DRAWINGS CV-S1640-D TO CV-S1660-D. 6. FOR RETAINING WALLS, SEE CIVIL AND GRADE SEPARATION PLANS; DRAWINGS CV-\$1640-D TO CV-\$1660-D. HST SB TRACK 7. FOR ROAD 11 OVERHEAD GENERAL PLAN AND TYPICAL SECTION, SEE DRAWING ST-K1650-D. 8. FOR WASHINGTON ROAD (AVENUE 25) UNDERPASS MER-FRE GENERAL PLAN AND TYPICAL SECTION, SEE DRAWINGS ST-K1450-D AND TOP 9. FOR WASHINGTON ROAD (AVENUE 25) UNDERPASS SJD-MER GENERAL 46345+00 PLAN AND TYPICAL SECTION, SEE DRAWING ST-K1655-D. 10.FOR CHOWCHILLA RIVER BRIDGE SB MER-FRE GENERAL PLAN AND BARRIER TYPICAL SECTION, SEE DRAWING ST-K1455-D. BARRIER PARAPF1 GUIDEWAY DECK S.ID-MFR 11.FOR CHOWCHILLA RIVER BRIDGE SB SJD-MER GENERAL PLAN AND TYPICAL SECTION, SEE DRAWING ST-K1659-D. PRIVATE FARM ROAD CLOSED 100 100 200 PLAN l"=50' l"=100' 1" = 100' M. BRATT CALIFORNIA HIGH-SPEED TRAIN PROJECT HSR08-05 RECORD SET MERCED TO FRESNO SECTION 15% DESIGN SUBMITTAL ST-K1640-D CENTRAL VALLEY WYE K. CHARAN **PARSONS** SR 152 (NORTH) TO ROAD 11 WYE ALTERNATIVE NOT FOR AS SHOWN N CHARGE C. LEMLEY **CALIFORNIA** GENERAL PLAN (SJD-MER) CONSTRUCTION HIGH-SPEED RAIL AUTHORITY SHEET NO. AERIAL #5 - NORTHBOUND OVER HST MERCED TO FRESNO - 1 OF 6 DATE BY CHK APP DESCRIPTION 08/12/2016

TOP OF RAIL PROFILE (@ HST NB TRACK SJD-MER) NO SCALE

PARSONS

NOT FOR


CONSTRUCTION

IN CHARGE
C. LEMLEY

08/12/2016

BY CHK APP

DESCRIPTION

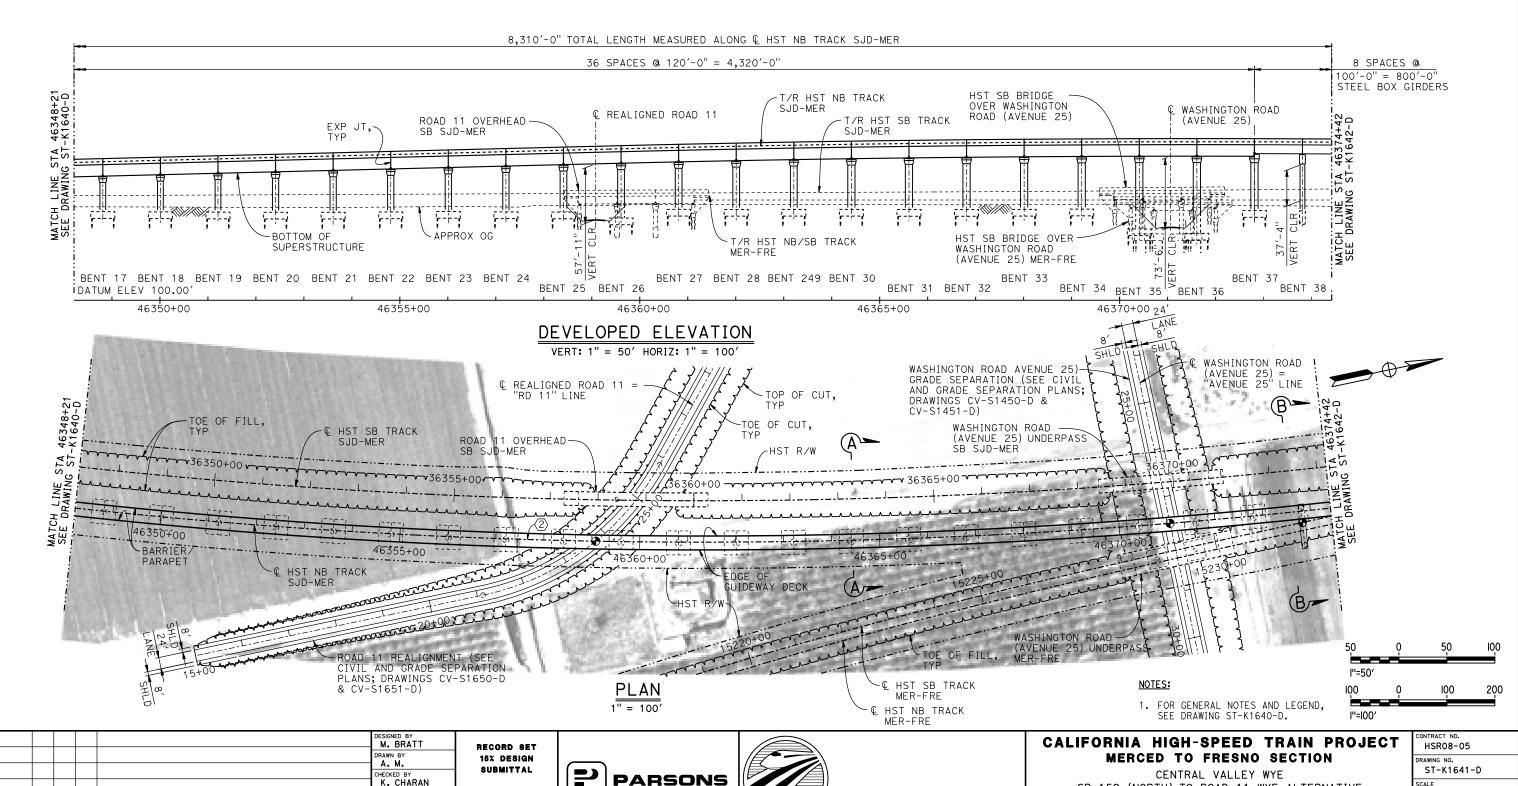

CALIFORNIA

HIGH-SPEED RAIL AUTHORITY

SR 152 (NORTH) TO ROAD 11 WYE ALTERNATIVE

GENERAL PLAN (SJD-MER)

AERIAL #5 - NORTHBOUND OVER HST MERCED TO FRESNO - 2 OF

AS SHOWN

SHEET NO.

DRAWN BY

DATE

BY CHK APP

DESCRIPTION

K. CHARAN

IN CHARGE
C. LEMLEY


08/12/2016

15% DESIGN Submittal

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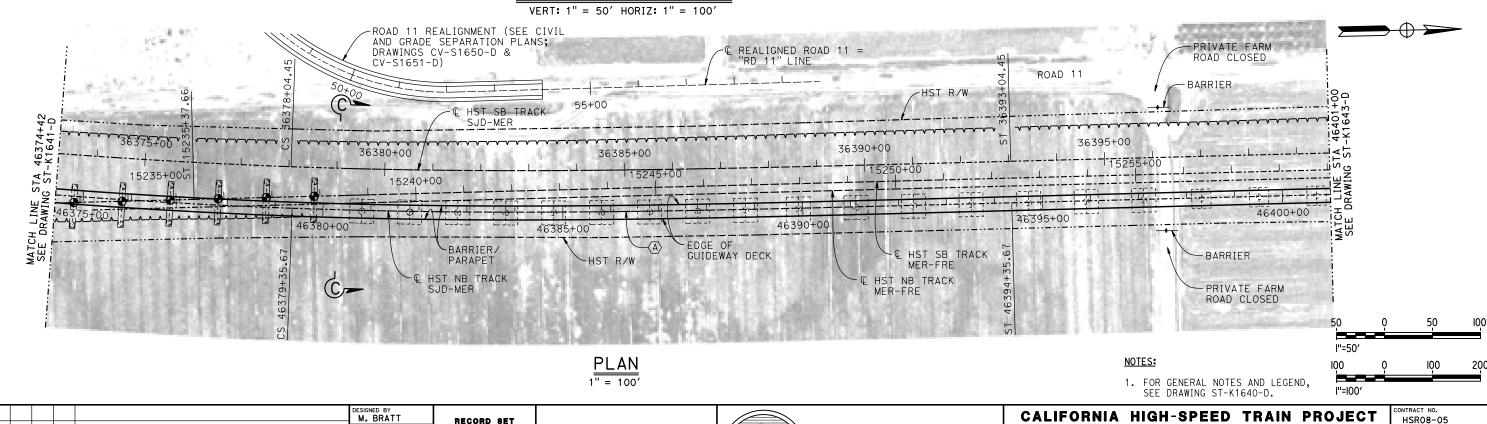
CONSTRUCTION

TOP OF RAIL PROFILE (HST NB TRACK SJD-MER)

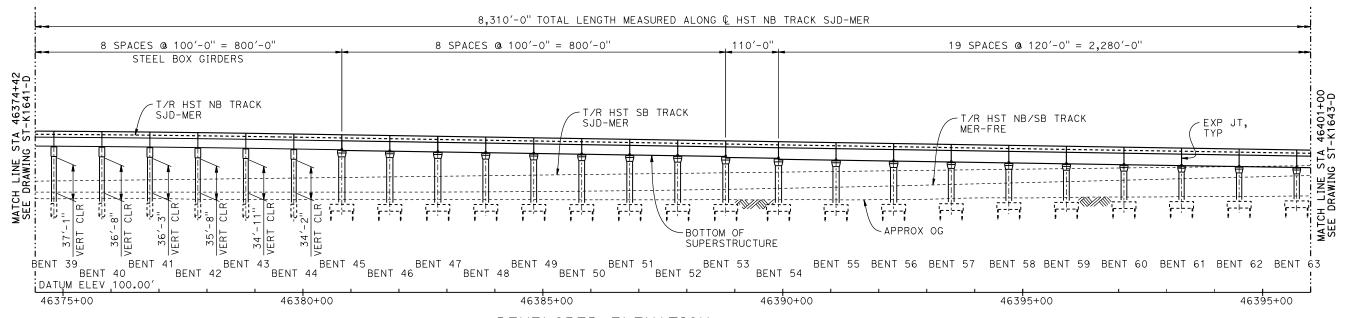

DEVELOPED ELEVATION

PARSONS



CALIFORNIA

HIGH-SPEED RAIL AUTHORITY

MERCED TO FRESNO SECTION

CENTRAL VALLEY WYE

SR 152 (NORTH) TO ROAD 11 WYE ALTERNATIVE

GENERAL PLAN (SJD-MER)


AERIAL #5 - NORTHBOUND OVER HST MERCED TO FRESNO - 3 OF

ST-K1642-D


AS SHOWN

SHEET NO.

TOP OF RAIL PROFILE (HST NB TRACK SJD-MER) NO SCALE

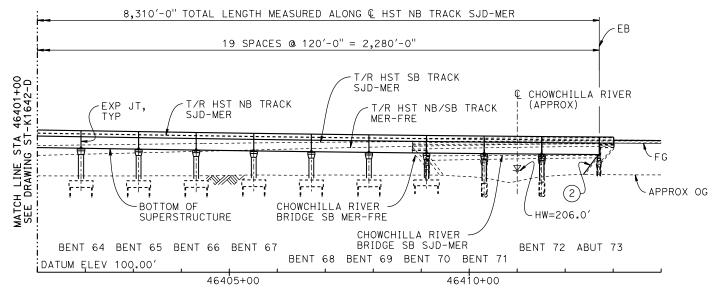


DEVELOPED ELEVATION

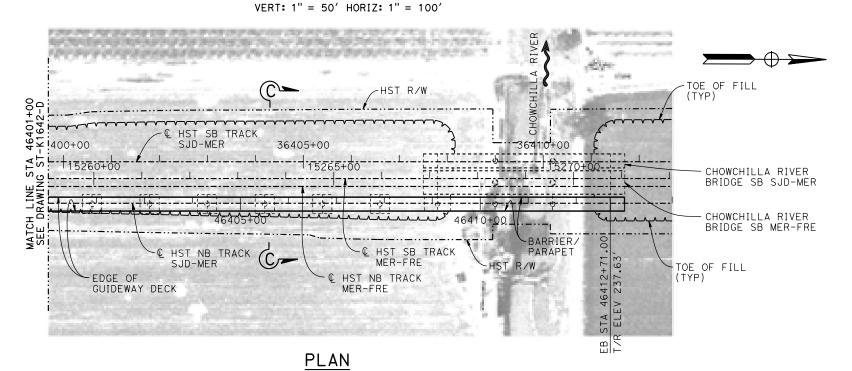

NOTES:

1. FOR GENERAL NOTES AND LEGEND, SEE DRAWING ST-K1640-D.

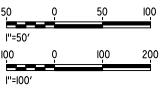

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							K. CHARAN IN CHARGE	ł
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RECORD SET
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SUBMITTAL
NOT FOR
CONSTRUCTION






CALIFORNIA HIGH-SPEED TRAIN PROJECT MERCED TO FRESNO SECTION


CENTRAL VALLEY WYE
SR 152 (NORTH) TO ROAD 11 WYE ALTERNATIVE
GENERAL PLAN (SJD-MER)
AERIAL #5 - NORTHBOUND OVER HST MERCED TO FRESNO - 4 OF


CONTRACT NO.
HSRO8-05
DRAWING NO.
ST-K1643-D
SCALE
AS SHOWN
SHEET NO.

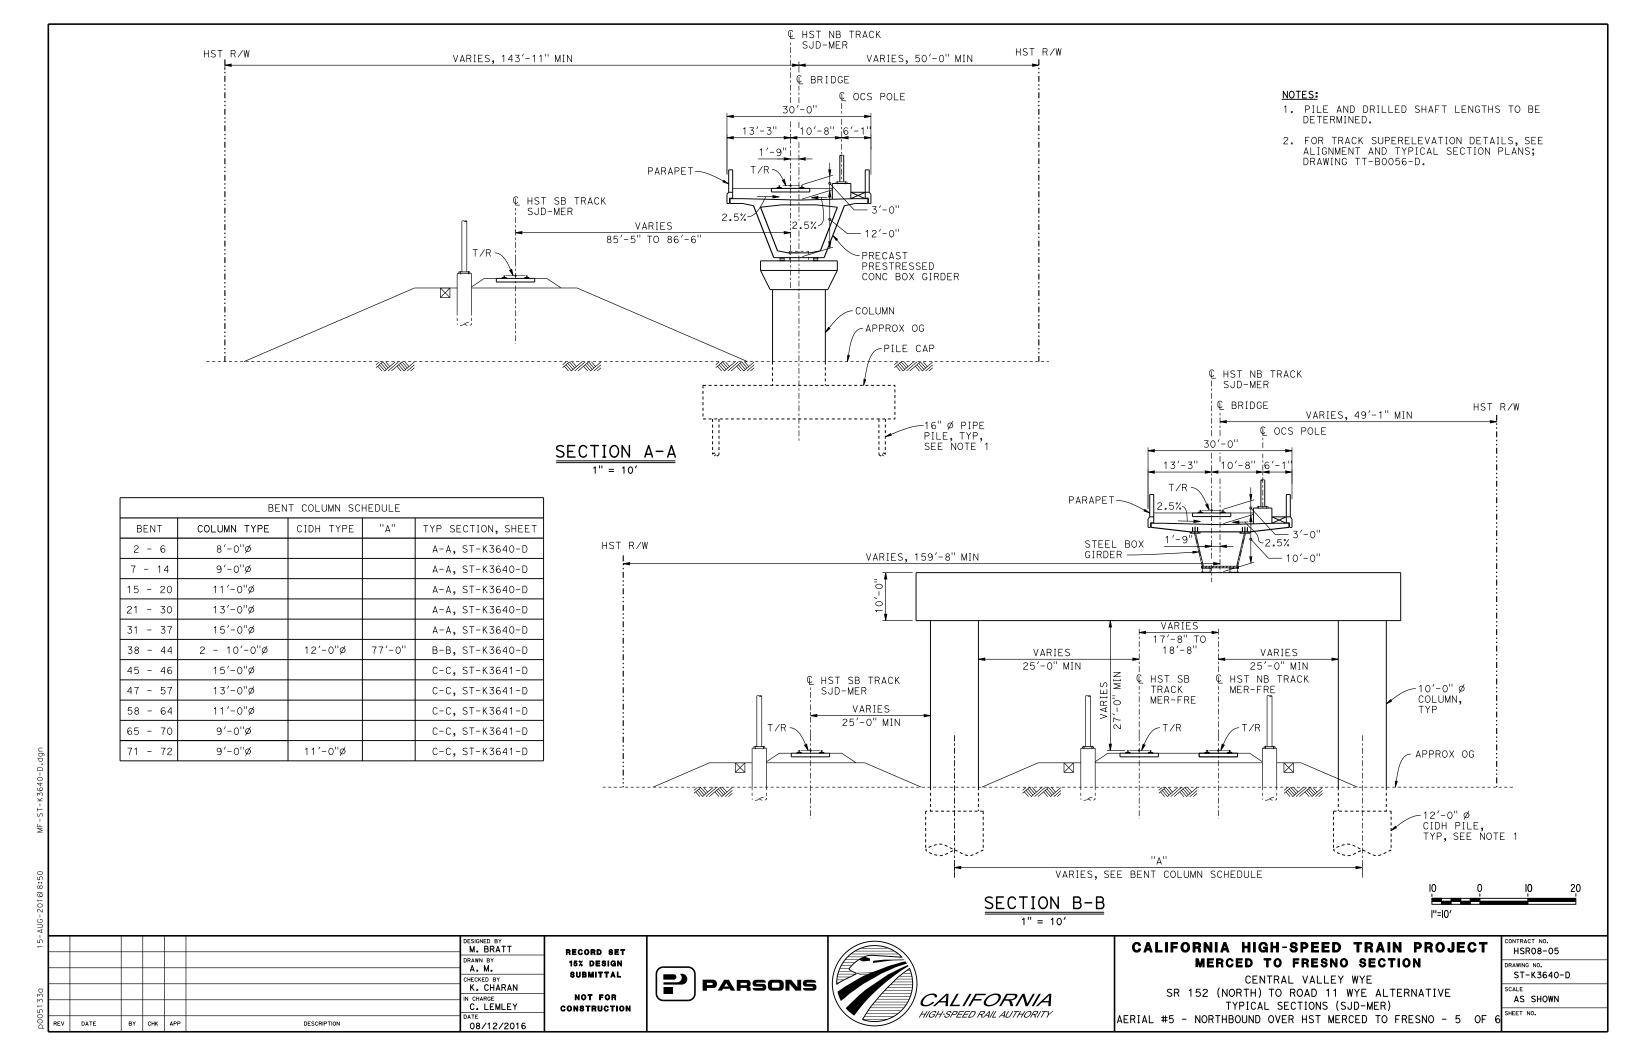

NOTES:

- 1. DRILLED SHAFT LENGTHS TO BE DETERMINED.
- FOR TRACK SUPERELEVATION DETAILS, SEE ALIGNMENT AND TYPICAL SECTION PLANS; DRAWING TT-B0056-D.

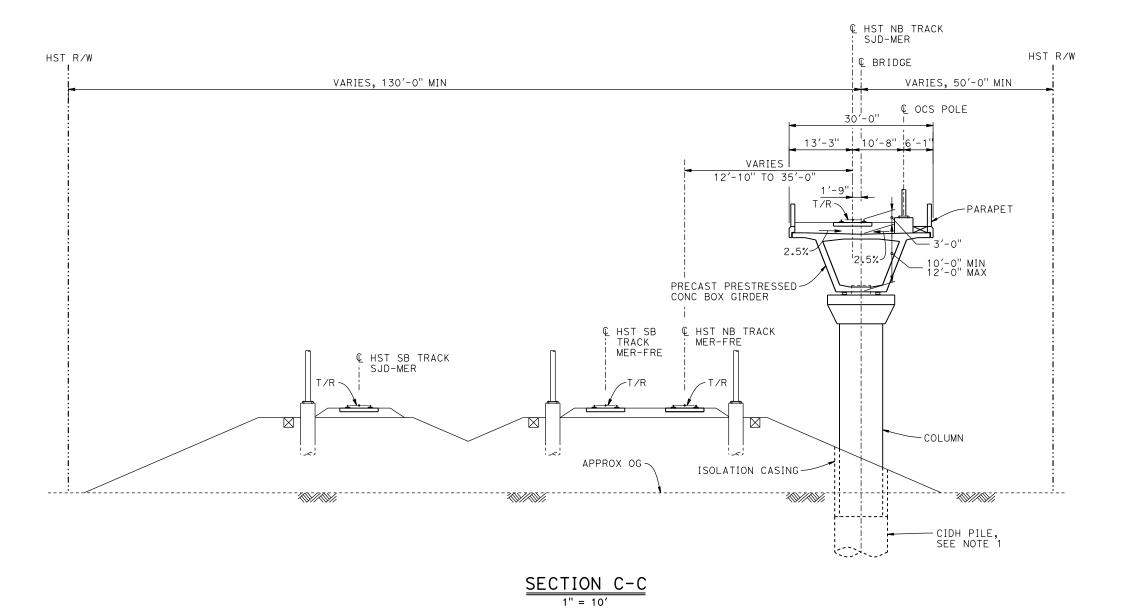

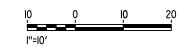

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							CHECKED BY K. CHARAN	8
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p0051	DE!	21.75	By/	01111		PERSONNELL	C. LEMLEY DATE	CO
ă	REV	DATE	BY	CHK	APP	DESCRIPTION	08/12/2016	

RECORD SET
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CONSTRUCTION






CALIFORNIA HIGH-SPEED TRAIN PROJECT MERCED TO FRESNO SECTION

CENTRAL VALLEY WYE


SR 152 (NORTH) TO ROAD 11 WYE ALTERNATIVE
TYPICAL SECTIONS (SJD-MER)

AERIAL #5 - NORTHBOUND OVER HST MERCED TO FRESNO - 6 OF 6


CONTRACT NO.
HSR08-05
DRAWING NO.
ST-K3641-D
SCALE
AS SHOWN
CHEET NO

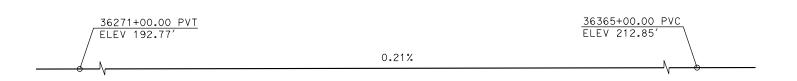

TOP OF RAIL PROFILE (HST SB TRACK SJD-MER) NO SCALE

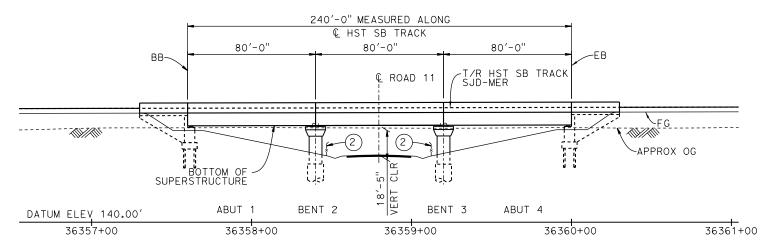


DEVELOPED ELEVATION

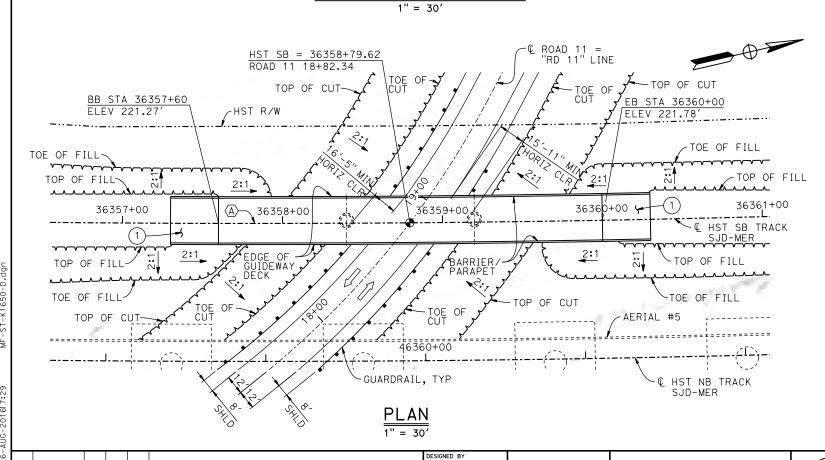

CURVE SJD-MER 1 SB (A)

R = 12,000.00'LS = 1,500.00'

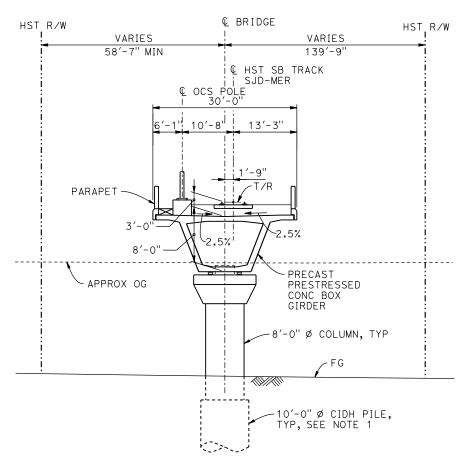

TYPICAL SECTION

TEMPORARY TRAFFIC OPENINGS

VEHICULAR TRAFFIC

- 1. TRAFFIC WILL BE DETOURED AWAY FROM THE SITE.
- 2. X TRAFFIC WILL PASS UNDER THE STRUCTURE ON:

ST OR ROAD N	FALSEWORK OPENING REQD (HORIZ X VERT)							
ROAD 11	36358+80	32′X15′	2-WAY					
3. X TEMP TRAFFIC LANE REDUCTION FOR								

NOTES:

- 1. 16" Ø PIPE PILE ASSUMED AT ABUTMENT FOUNDATIONS. PILE AND DRILLED SHAFT LENGTHS TO BE DETERMINED.
- 2. FOR UTILITY DISPOSITIONS, SEE CIVIL AND GRADE SEPARATION PLANS; DRAWING CV-R1650-D.
- 3. FOR GUARDRAILS, SEE CIVIL AND GRADE SEPARATION PLANS; DRAWING CV-R1650-D.
- 4. FOR TRACK SUPERELEVATION DETAILS, SEE ALIGNMENT AND TYPICAL SECTION PLANS; DRAWING TT-B0056-D.
- 5. FOR ROAD 11 REALIGNMENT, SEE CIVIL AND GRADE SEPARATION PLANS; DRAWING CV-R1650-D.
- 6. FOR AERIAL # 5 GENERAL PLAN AND TYPICAL SECTIONS, SEE DRAWINGS ST-K1640-D TO ST-K1643-D AND ST-K3640-D TO ST-K3641-D.

LEGEND:

- ◆ INDICATES POINT OF MINIMUM VERTICAL CLEARANCE
- (1) STRUCTURE APPROACH

FTG EXC.

2 AR FENCE, SEE TRACK PLANS; DRAWING TT-B0050-D



			M. BRATT
			DRAWN BY
			A. M. CHECKED BY
			K. CHARAN IN CHARGE
			C. LEMLEY

DESCRIPTION

BY CHK APP

RECORD SET
15% DESIGN
SUBMITTAL
NOT FOR
CONSTRUCTION

08/12/2016






CALIFORNIA HIGH-SPEED TRAIN PROJECT MERCED TO FRESNO SECTION


CENTRAL VALLEY WYE
SR 152 (NORTH) TO ROAD 11 WYE ALTERNATIVE
GENERAL PLAN (SJD-MER)
ROAD 11 UNDERPASS


CONTRACT NO.
HSR08-05
DRAWING NO.
ST-K1650-D
SCALE
AS SHOWN
SHEET NO.

TOP OF RAIL PROFILE (& HST SB TRACK SJD-MER)

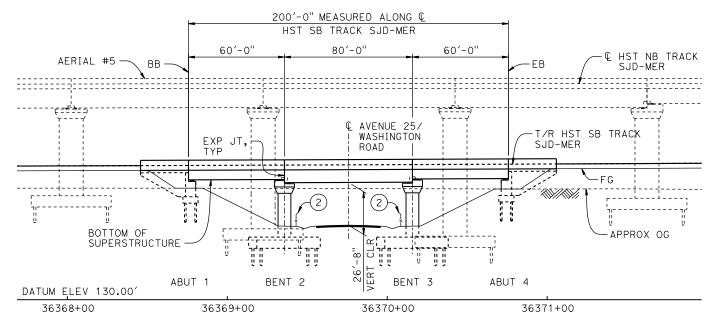

DEVELOPED ELEVATION 1" = 30'

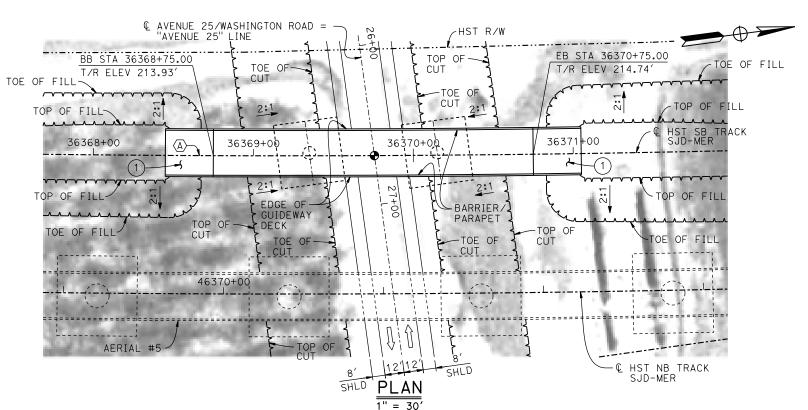

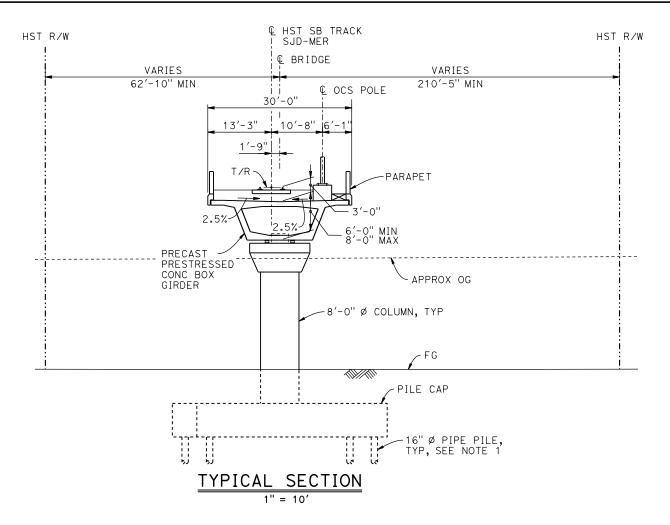

TEMPORARY TRAFFIC OPENINGS

VEHICULAR TRAFFIC

- 1. $\underline{\mathsf{X}}$ TRAFFIC WILL BE DETOURED AWAY FROM THE SITE.
- 2. _ TRAFFIC WILL PASS UNDER THE STRUCTURE ON:

STREET OR ROAD NAME AND LOCATION	FALSEW OPENING (HORIZ ×	REQD	
AVENUE 25/WASHINGTON ROAD	36369+76	32′x15′	2-WAY
TEMP TRAFFIC LANE REDUCT	ION FOR F	TG EXC.	

LEGEND:


- INDICATES POINT OF MINIMUM VERTICAL CLEARANCE
- INDICATES DIRECTION OF TRAFFIC
- STRUCTURE APPROACH
- AR FENCE, SEE TRACK PLANS; DRAWING TT-B0020-D


CURVE SJD-MER 1 SB (A)

R = 12,000.00'LS = 1,500.00'

NOTES:

- 1. 16"Ø PIPE PILES ASSUMED FOR ABUTMENT FOUNDATIONS. PILE LENGTHS TO BE DETERMINED.
- 2. FOR UTILITY DISPOSITIONS, SEE CIVIL AND GRADE SEPARATION PLANS; DRAWING CV-S1650-D.
- 3. FOR AERIAL #5 NORTHBOUND OVER HST MERCED TO FRESNO GENERAL PLAN AND TYPICAL SECTIONS, SEE DRAWINGS ST-K1640-D TO ST-K1643-D, ST-K3640-D AND ST-K3641-D.
- 4. FOR TRACK SUPERELEVATION DETAILS, SEE ALIGNMENT AND TYPICAL SECTION PLANS; DRAWING TT-B0056-D.

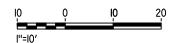

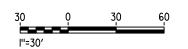

						DESIGNED BY M. BRATT
						DRAWN BY
						CHECKED BY
						K. CHARAN
						IN CHARGE
						C. LEMLEY
REV	DATE	BY	снк	APP	DESCRIPTION	DATE 08/12/2016

15% DESIGN **PARSONS** CONSTRUCTION

RECORD SET

SUBMITTAL

NOT FOR



CALIFORNIA HIGH-SPEED TRAIN PROJECT MERCED TO FRESNO SECTION

CENTRAL VALLEY WYE SR 152 (NORTH) TO ROAD 11 WYE ALTERNATIVE GENERAL PLAN (SJD-MER) WASHINGTON ROAD (AVENUE 25) UNDERPASS

HSRO8-05						
DRAWING NO. ST-K1655-D						
AS SHOWN						
SHEET NO.						

