


San Jose to Merced Section: San Jose to Central Valley Wye

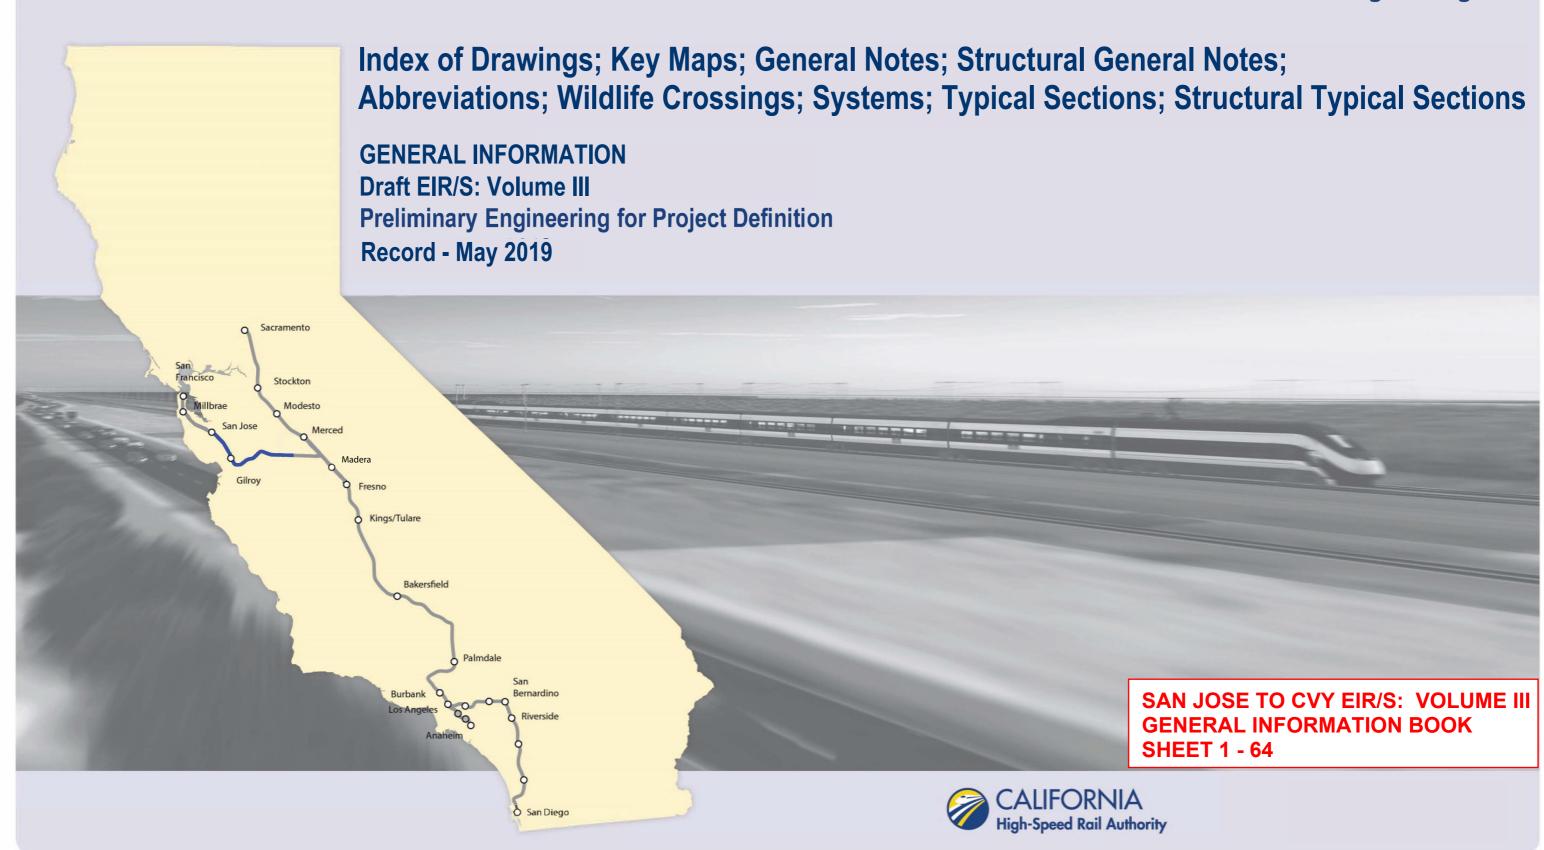





1111 Broadway
9th Floor
Oakland, CA 94607



ALIGNMENT OR FEATURE

N/A

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CALIFORNIA HIGH-SPEED TRAIN PROJECT SAN JOSE TO MERCED

GENERAL INDEX OF DRAWING SHEET 1 OF 2

•	CONTRACT NO. HSR15-34
	DRAWING NO. GE-AG101
	SCALE NONE
	SHEET NO.

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CHECKED BY	MAY 3, 2019
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GENERAL INFORMATION

DRAWING NO

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GE-AG101

GE-AG102

GE-A0101

GE-A0102

GE-A0103

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						DRAWN BY	SUBMITTAL
						CHECKED BY	MAY 3, 2019
						IN CHARGE	NOT FOR
REV	DATE	BY	СНК	APP	DESCRIPTION	DATE	CONSTRUCTION

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GE-C0008A

GE-C0009

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GE-C0011

GE-C0012

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ABBREVIATIONS

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SAN JOSE TO CVY EIR/S: VOLUME III **GENERAL INFORMATION BOOK** SHEET 5 OF 64

CALIFORNIA HIGH-SPEED TRAIN PROJECT **SAN JOSE TO MERCED** GENERAL INDEX OF DRAWING

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Γ	HSR15-34
	DRAWING NO. GE-AG102
	SCALE NONE


SHEET NO.

CALIFORNIA	
High-Speed Rail Authority	

BOOK 1A	Δ	COVER	SAN JOSE TO MERCED SECTION	N/A	SAN JOSE TO CENTRAL VALLEY WYE	ALTERNATIVE 1	
BOOK IA		COVEIX	SAN JOSE DIRIDON STATION APPROACH,	14/74	SAIV JOSE TO CEIVITAL VALLET WIL	ALILINATIVE I	+
BOOK 1A	В	GE-A0101	MONTEREY CORRIDOR, MORGAN HILL AND	SCOTT BLVD TO PACHECO PASS HWY	INDEX OF DRAWING	SHEET 1 OF 7	
500K 17K	J	027,0101	GILROY	36311 3213 1317(6)1233 17(3)11(1)		31121 2 31 7	
BOOK 1A	С	GE-D0101	GENERAL	ENTIRE ALTERNATIVE	KEY MAP	COMPOSITE PLAN	
BOOK 1A	D	GE-D0102	GENERAL	ENTIRE ALTERNATIVE	KEY MAP	SYSTEMS SITES	
CONADOCI	TE DI ANI	C					
OMPOSI	ITE PLAN	5					
AN JOSE DII	RIDON STA	TION APPROACH					
BOOK 1A	1	TT-D0151	SAN JOSE DIRIDON STATION APPROACH	SCOTT BLVD TO BROKAW RD	VIADUCT TO I-880	COMPOSITE PLAN, PROFILE AND CROSS SECTIONS	B2250+00 TO B2340+00
BOOK 1A	2	TT-D0152	SAN JOSE DIRIDON STATION APPROACH	I-880 TO W TAYLOR ST	VIADUCT TO I-880	COMPOSITE PLAN, PROFILE AND CROSS SECTIONS	B2340+00 TO B2430+00
BOOK 1A	3	TT-D0153	SAN JOSE DIRIDON STATION APPROACH	CINNABAR ST TO PARK AVE	VIADUCT TO I-880	COMPOSITE PLAN, PROFILE AND CROSS SECTIONS	B2430+00 TO B58+00
BOOK 1A	4	TT-D0301	SAN JOSE DIRIDON STATION APPROACH	PARK AVE TO WILLOW ST	VIADUCT TO I-880	COMPOSITE PLAN, PROFILE AND CROSS SECTIONS	B58+00 TO B125+00
ONTEREY (CORRIDOR						
BOOK 1A	5	TT-D0401	MONTEREY CORRIDOR	WILLOW ST, CURTNER AVE	VIADUCT/AT-GRADE	COMPOSITE PLAN, PROFILE AND CROSS SECTIONS	B125+00 TO B211+00
BOOK 1A	6	TT-D0601	MONTEREY CORRIDOR	COMMUNICATION HILL BLVD, ESFAHAN CT	VIADUCT	COMPOSITE PLAN, PROFILE AND CROSS SECTIONS	B211+00 TO B285+00
BOOK 1A	7	TT-D0602	MONTEREY CORRIDOR	CAPITOL EXPRESSWAY, SKYWAY DR	VIADUCT	COMPOSITE PLAN, PROFILE AND CROSS SECTIONS	B285+00 TO B373+00
BOOK 1A	8	TT-D0603	MONTEREY CORRIDOR	BRANHAM LN, BLOSSOM HILL RD	VIADUCT	COMPOSITE PLAN, PROFILE AND CROSS SECTIONS	B373+00 TO B462+00
BOOK 1A	9	TT-D0604	MONTEREY CORRIDOR	FORD RD	VIADUCT	COMPOSITE PLAN, PROFILE AND CROSS SECTIONS	B462+00 TO B552+00
ORGAN HI	LL AND GILI	ROY					
BOOK 1A	10	TT-D0701	MORGAN HILL AND GILROY	W VALLEY FREEWAY, MENARD DR	VIADUCT TO DOWNTOWN GILROY	COMPOSITE PLAN, PROFILE AND CROSS SECTIONS	B552+00 TO B730+00
BOOK 1A	11	TT-D0702	MORGAN HILL AND GILROY	METCALE RD, BLANCHARD RD	VIADUCT TO DOWNTOWN GILROY	COMPOSITE PLAN, PROFILE AND CROSS SECTIONS	B642+00 TO B732+00
BOOK 1A	12	TT-D0703	MORGAN HILL AND GILROY	BAILEY AVE, RICHMOND AVE	VIADUCT TO DOWNTOWN GILROY	COMPOSITE PLAN, PROFILE AND CROSS SECTIONS	B732+00 TO B8220+00
BOOK 1A	13	TT-D0704	MORGAN HILL AND GILROY	OGIER AVE	VIADUCT TO DOWNTOWN GILROY	COMPOSITE PLAN, PROFILE AND CROSS SECTIONS	B822+00 TO B905+00
BOOK 1A	14	TT-D0705	MORGAN HILL AND GILROY	KIRBY AVE	VIADUCT TO DOWNTOWN GILROY	COMPOSITE PLAN, PROFILE AND CROSS SECTIONS	B905+00 TO B995+00
BOOK 1A	15	TT-D0706	MORGAN HILL AND GILROY	BURNETT AVE, COCHRANE RD	VIADUCT TO DOWNTOWN GILROY	COMPOSITE PLAN, PROFILE AND CROSS SECTIONS	B995+00 TO B1085+00
BOOK 1A	16	TT-D0707	MORGAN HILL AND GILROY	E MAIN AVE, BARRETT AVE	VIADUCT TO DOWNTOWN GILROY	COMPOSITE PLAN, PROFILE AND CROSS SECTIONS	B1085+00 TO B1175+00
BOOK 1A	17	TT-D0708	MORGAN HILL AND GILROY	TENNANT AVE, E MIDDLE AVE	VIADUCT TO DOWNTOWN GILROY	COMPOSITE PLAN, PROFILE AND CROSS SECTIONS	B1175+00 TO B1265+00
BOOK 1A	18	TT-D0901	MORGAN HILL AND GILROY	CALIFORNIA AVE, COX AVE	VIADUCT TO DOWNTOWN GILROY	COMPOSITE PLAN, PROFILE AND CROSS SECTIONS	B1265+00 TO B1425+00
BOOK 1A	19	TT-D0902	MORGAN HILL AND GILROY	HIGHLAND AVE, LENA AVE	VIADUCT TO DOWNTOWN GILROY	COMPOSITE PLAN, PROFILE AND CROSS SECTIONS	B1425+00 TO B1509+00
BOOK 1A	20	TT-D0903	MORGAN HILL AND GILROY	MASTEN AVE, COHANSEY AVE	VIADUCT TO DOWNTOWN GILROY	COMPOSITE PLAN, PROFILE AND CROSS SECTIONS	B1509+00 TO B1598+00
BOOK 1A	21	TT-D0904	MORGAN HILL AND GILROY	FARRELL AVE, IOOF AVE	VIADUCT TO DOWNTOWN GILROY	COMPOSITE PLAN, PROFILE AND CROSS SECTIONS	B1598+00 TO B1685+00
BOOK 1A	22	TT-D0905	MORGAN HILL AND GILROY	LEWIS ST, LUCHESSA AVE	VIADUCT TO DOWNTOWN GILROY	COMPOSITE PLAN, PROFILE AND CROSS SECTIONS	B1685+00 TO B1767+00
BOOK 1A	23	TT-D0906	MORGAN HILL AND GILROY	US 101, CARNADERO AVE	VIADUCT TO DOWNTOWN GILROY	COMPOSITE PLAN, PROFILE AND CROSS SECTIONS	B1767+00 TO B1855+00
BOOK 1A	24	TT-D0907	MORGAN HILL AND GILROY	BLOOMFIELD AVE, SHELDON AVE	VIADUCT TO DOWNTOWN GILROY	COMPOSITE PLAN, PROFILE AND CROSS SECTIONS	B1855+00 TO B1930+0
BOOK 1A	25	TT-D0908	MORGAN HILL AND GILROY	PAJARO RIVER	VIADUCT TO DOWNTOWN GILROY	COMPOSITE PLAN, PROFILE AND CROSS SECTIONS	B1930+00 TO B2017+00
BOOK 1A	26	TT-D0909	MORGAN HILL AND GILROY	FRAZIER LAKE RD	VIADUCT TO DOWNTOWN GILROY	COMPOSITE PLAN, PROFILE AND CROSS SECTIONS	B2017+00 TO B2103+0
BOOK 1A	27	TT-D0910	MORGAN HILL AND GILROY	N/A	VIADUCT TO DOWNTOWN GILROY	UPRR FREIGHT AND TRANSITION TRACK PROFILES	
BOOK 1A	28	TT-D1201	MORGAN HILL AND GILROY	LAKE RD, LOVERS LANE	VIADUCT TO DOWNTOWN GILROY	COMPOSITE PLAN, PROFILE AND CROSS SECTIONS	B2103+00 TO B2193+0
BOOK 1A	29	TT-D1202	MORGAN HILL AND GILROY	SAN FELIPE RD, PACHECO PASS RD	VIADUCT TO DOWNTOWN GILROY	COMPOSITE PLAN, PROFILE AND CROSS SECTIONS	B2193+00 TO B2275+0
BOOK 1A	30	TT-D1203	MORGAN HILL AND GILROY	PACHECO PASS HWY	VIADUCT TO DOWNTOWN GILROY	COMPOSITE PLAN, PROFILE AND CROSS SECTIONS	B2275+00 TO B2362+0

SAN JOSE TO CVY EIR/S: VOLUME III **GENERAL INFORMATION BOOK** SHEET 6 OF 64

ADDITIONAL DESCRIPTION

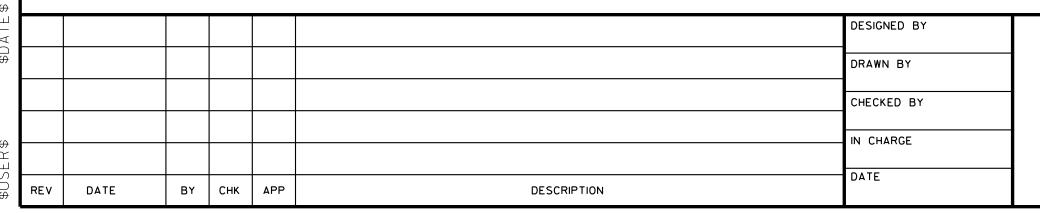

ALTERNATIVE 1 - VIADUCT TO DOWNTOWN GILROY

SUBSECTION

SHEET NO DRAWING NO

RECORD PEPD SUBMITTAL **MAY 3, 2019** NOT FOR CONSTRUCTION



GEOGRAPHIC LOCATION OR FEATURE





ALIGNMENT OR FEATURE

CALIFORNIA HIGH-SPEED TRAIN PROJECT **SAN JOSE TO MERCED**

SHEET DESCRIPTION

ALTERNATIVE 1 INDEX OF DRAWING SHEET 1 OF 7

•	CONTRACT NO. HSR15-34
	DRAWING NO. GE-A0101
	scale NONE
	SHEET NO.

						DESIGNED BY	
						DRAWN BY	
						CHECKED BY	
						IN CHARGE	
						DATE	
REV	DATE	BY	СНК	APP	DESCRIPTION		

ALTERNATIVE 1 - VIADUCT TO DOWNTOWN GILROY

SUBSECTION

SAN JOSE TO MERCED SECTION

PACHECO PASS, SAN JOAQUIN VALLEY

SAN JOSE DIRIDON STATION APPROACH,

MORGAN HILL AND GILROY

GENERAL

SHEET NO DRAWING NO

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BOOK 1B

BOOK 1B

BOOK 1B

BOOK 1B

COVER, INDEX OF DRAWING AND KEY MAPS

COVER

GE-A0102

GE-A0103

GE-D0101

RECORD PEPD SUBMITTAL MAY 3, 2019 NOT FOR CONSTRUCTION





SAN JOSE TO CVY EIR/S: VOLUME III
GENERAL INFORMATION BOOK
SHEET 7 OF 64

CALIFORNIA HIGH-SPEED TRAIN PROJECT SAN JOSE TO MERCED

SHEET DESCRIPTION

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COMPOSITE PLAN

ALTERNATIVE 1
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SHEET 2 OF 7

CONTRACT NO. HSR15-34
DRAWING NO. GE-A0102
scale NONE
SHEET NO.

ADDITIONAL DESCRIPTION

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BOOK 1B	E	GE-D0102	GENERAL	ENTIRE ALTERNATIVE	KEY MAP	SYSTEMS SITES	
COMPOS	ITE PLAN	S					
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	T T T T T T T T T T T T T T T T T T T	TT D4 404	DACUECO DACC	CD 452	TI IN IN IS	COMPOSITE DI AMI DECELLE AMED CECCICALICALIC	D2262.00 TO D2205.00
BOOK 1B	31	TT-D1401	PACHECO PASS	SR 152	TUNNEL	COMPOSITE PLAN, PROFILE AND CROSS SECTIONS	B2362+00 TO B3205+00
BOOK 1B	32	TT-D1402	PACHECO PASS	SERVICE ROAD 1	TUNNEL	COMPOSITE PLAN, PROFILE AND CROSS SECTIONS	B3205+00 TO B3295+00
BOOK 1B	33	TT-D1403	PACHECO PASS	N/A	TUNNEL	COMPOSITE PLAN, PROFILE AND CROSS SECTIONS	B3295+00 TO B3385+00
BOOK 1B	34	TT-D1404	PACHECO PASS	N/A	TUNNEL	COMPOSITE PLAN, PROFILE AND CROSS SECTIONS	B3385+00 TO B3475+00
BOOK 1B	35	TT-D1405	PACHECO PASS	SR 152	TUNNEL	COMPOSITE PLAN, PROFILE AND CROSS SECTIONS	B3475+00 TO B3565+00
BOOK 1B	36	TT-D1406	PACHECO PASS	N/A	TUNNEL	COMPOSITE PLAN, PROFILE AND CROSS SECTIONS	B3565+00 TO B3655+00
BOOK 1B	37	TT-D1407	PACHECO PASS	SR 152	TUNNEL	COMPOSITE PLAN, PROFILE AND CROSS SECTIONS	B3655+00 TO B3745+00
BOOK 1B	38	TT-D1408	PACHECO PASS	N/A	TUNNEL	COMPOSITE PLAN, PROFILE AND CROSS SECTIONS	B3745+00 TO B3835+00
BOOK 1B	39	TT-D1409	PACHECO PASS	N/A	TUNNEL	COMPOSITE PLAN, PROFILE AND CROSS SECTIONS	B3835+00 TO B3923+00
BOOK 1B	40	TT-D1410	PACHECO PASS	N/A	TUNNEL	COMPOSITE PLAN, PROFILE AND CROSS SECTIONS	B3923+00 TO B4014+00
BOOK 1B	41	TT-D1411	PACHECO PASS	MCCABE RD	TUNNEL	COMPOSITE PLAN, PROFILE AND CROSS SECTIONS	B4014+00 TO B4105+00
BOOK 1B	42	TT-D1412	PACHECO PASS	N/A	TUNNEL	COMPOSITE PLAN, PROFILE AND CROSS SECTIONS	B4105+00 TO B4196+00
BOOK 1B	43	TT-D1413	PACHECO PASS	N/A	TUNNEL	COMPOSITE PLAN, PROFILE AND CROSS SECTIONS	B4196+00 TO B4287+00
BOOK 1B	44	TT-D1414	PACHECO PASS	ROMERO RD N, SR 33	TUNNEL	COMPOSITE PLAN, PROFILE AND CROSS SECTIONS	B4287+00 TO B4372+00
AN JOAQU	IN VALLEY						
BOOK 1B	45	TT-D1601	SAN JOAQUIN VALLEY	FAHEY RD	HENRY MILLER ROAD	COMPOSITE PLAN, PROFILE AND CROSS SECTIONS	B4372+00 TO B4445+00
BOOK 1B	46	TT-D1602	SAN JOAQUIN VALLEY	CCID MAIN CANAL	HENRY MILLER ROAD	COMPOSITE PLAN, PROFILE AND CROSS SECTIONS	B4445+00 TO B4533+00
BOOK 1B	47	TT-D1603	SAN JOAQUIN VALLEY	INGOMAR GRADE RD	HENRY MILLER ROAD	COMPOSITE PLAN, PROFILE AND CROSS SECTIONS	B4533+00 TO B4614+00
BOOK 1B	48	TT-D1604	SAN JOAQUIN VALLEY	VOLTA RD, HENRY MILLER RD	HENRY MILLER ROAD	COMPOSITE PLAN, PROFILE AND CROSS SECTIONS	B4614+00 TO B4686+00
BOOK 1B	49	TT-D1605	SAN JOAQUIN VALLEY	MONROE AVE	HENRY MILLER ROAD	COMPOSITE PLAN, PROFILE AND CROSS SECTIONS	B4686+00 TO B4758+00
BOOK 1B	50	TT-D1606	SAN JOAQUIN VALLEY	BADGER FLAT RD, NANTES AVE	HENRY MILLER ROAD	COMPOSITE PLAN, PROFILE AND CROSS SECTIONS	B4758+00 TO B4846+00
BOOK 1B	51	TT-D1607	SAN JOAQUIN VALLEY	SR-165, SANTA FE GRADE	HENRY MILLER ROAD	COMPOSITE PLAN, PROFILE AND CROSS SECTIONS	B4846+00 TO B4932+00
BOOK 1B	52	TT-D1608	SAN JOAQUIN VALLEY	N/A	HENRY MILLER ROAD	COMPOSITE PLAN, PROFILE AND CROSS SECTIONS	B4932+00 TO B5020+00
DOOK 1D	53	TT-D1609	SAN JOAQUIN VALLEY	BAKER RD, DELTA RD	HENRY MILLER ROAD	COMPOSITE PLAN, PROFILE AND CROSS SECTIONS	B5020+00 TO B5109+00
BOOK 1B		TT-D1610	SAN JOAQUIN VALLEY	MIDWAY RD, BOX CAR RD	HENRY MILLER ROAD	COMPOSITE PLAN, PROFILE AND CROSS SECTIONS	B5109+00 TO B5193+00
BOOK 1B	54	I I DIOIO		·		•	DE 400 00 TO DE 200 00
	54 55	TT-D1611	SAN JOAQUIN VALLEY	TURNER ISLAND RD	HENRY MILLER ROAD	COMPOSITE PLAN, PROFILE AND CROSS SECTIONS	B5193+00 TO B5282+00

ALIGNMENT OR FEATURE

SAN JOSE TO CENTRAL VALLEY WYE

INDEX OF DRAWING

INDEX OF DRAWING

KEY MAP

GEOGRAPHIC LOCATION OR FEATURE

N/A

SR 152 TO CARLUCCI ROAD

STATIONS, COMPLEX STRUCTURES

ENTIRE ALTERNATIVE


BOOK 1B

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ВООК	SHEET NO	DRAWING NO	SUBSECTION	GEOGRAPHIC LOCATION OR FEATURE	ALIGNMENT OR FEATURE	SHEET DESCRIPTION	ADDITIONAL DESCRIPTION
ΓΑΤΙΟΝ	IS						
BOOK 1B	57	AR-C0101	SAN JOSE DIRIDON STATION APPROACH	SANTA CLARA ST, PARK AVE	VIADUCT TO I-880	SAN JOSE DIRIDON STATION	CONCEPTUAL SITE PLAN
BOOK 1B	58	AR-C0102	SAN JOSE DIRIDON STATION APPROACH	SANTA CLARA ST, PARK AVE	VIADUCT TO I-880	SAN JOSE DIRIDON STATION	DETAILED SITE PLAN
BOOK 1B	59	AR-F0101	SAN JOSE DIRIDON STATION APPROACH	SANTA CLARA ST, PARK AVE	VIADUCT TO I-880	SAN JOSE DIRIDON STATION	CONCOURSE PLAN
300K 1B	60	AR-Y0101	SAN JOSE DIRIDON STATION APPROACH	SANTA CLARA ST, PARK AVE	VIADUCT TO I-880	SAN JOSE DIRIDON STATION	CROSS SECTION
300K 1B	61	AR-Y0102	SAN JOSE DIRIDON STATION APPROACH	SANTA CLARA ST, PARK AVE	VIADUCT TO I-880	SAN JOSE DIRIDON STATION	MASSING DIAGRAM
300K 1B	62	AR-Y0103	SAN JOSE DIRIDON STATION APPROACH	SANTA CLARA ST, PARK AVE	VIADUCT TO I-880	SAN JOSE DIRIDON STATION	MASSING DIAGRAM
300K 1B	63	AR-Y0104	SAN JOSE DIRIDON STATION APPROACH	N/A	VIADUCT TO I-880	SAN JOSE DIRIDON STATION	FACILITY SIZING TABLE
300K 1B	64	AR-Y0105	SAN JOSE DIRIDON STATION APPROACH	N/A	VIADUCT TO I-880	SAN JOSE DIRIDON STATION	FACILITY SIZING TABLE
300K 1B	65	AR-Y0106	SAN JOSE DIRIDON STATION APPROACH	N/A	VIADUCT TO I-880	SAN JOSE DIRIDON STATION	FACILITY SIZING TABLE
300K 1B	66	AR-Y0107	SAN JOSE DIRIDON STATION APPROACH	N/A	VIADUCT TO I-880	SAN JOSE DIRIDON STATION	FACILITY SIZING TABLE
300K 1B	67	AR-C0901	MORGAN HILL AND GILROY	W 7TH ST, W 10TH ST	VIADUCT TO DOWNTOWN GILROY	DOWNTOWN GILROY STATION	CONCEPTUAL SITE PLAN
300K 1B	68	AR-C0902	MORGAN HILL AND GILROY	W 7TH ST, W 10TH ST	VIADUCT TO DOWNTOWN GILROY	DOWNTOWN GILROY STATION	DETAILED SITE PLAN
300K 1B	69	AR-F0901	MORGAN HILL AND GILROY	W 7TH ST, W 10TH ST	VIADUCT TO DOWNTOWN GILROY	DOWNTOWN GILROY STATION	CONCOURSE PLAN
OOK 1B	70	AR-Y0901	MORGAN HILL AND GILROY	W 7TH ST, W 10TH ST	VIADUCT TO DOWNTOWN GILROY	DOWNTOWN GILROY STATION	CROSS SECTION
BOOK 1B	71	AR-Y0902	MORGAN HILL AND GILROY	W 7TH ST, W 10TH ST	VIADUCT TO DOWNTOWN GILROY	DOWNTOWN GILROY STATION	MASSING DIAGRAM
300K 1B	72	AR-Y0903	MORGAN HILL AND GILROY	W 7TH ST, W 10TH ST	VIADUCT TO DOWNTOWN GILROY	DOWNTOWN GILROY STATION	MASSING DIAGRAM
300K 1B	73	AR-Y0904	MORGAN HILL AND GILROY	 N/A	VIADUCT TO DOWNTOWN GILROY	DOWNTOWN GILROY STATION	FACILITY SIZING TABLE
300K 1B	74	AR-Y0905	MORGAN HILL AND GILROY	N/A	VIADUCT TO DOWNTOWN GILROY	DOWNTOWN GILROY STATION	FACILITY SIZING TABLE
BOOK 1B	75	AR-Y0906	MORGAN HILL AND GILROY	N/A	VIADUCT TO DOWNTOWN GILROY	DOWNTOWN GILROY STATION	FACILITY SIZING TABLE
BOOK 1B	76	AR-Y0907	MORGAN HILL AND GILROY	N/A	VIADUCT TO DOWNTOWN GILROY	DOWNTOWN GILROY STATION	FACILITY SIZING TABLE
ructi	JRES						
BOOK 1B	77	ST-V0151	SAN JOSE DIRIDON STATION APPROACH	W TAYLOR ST	VIADUCT TO I-880	COMPLEX STRUCTURES	GENERAL PLAN 1 OF 2
BOOK 1B	78	ST-V0152	SAN JOSE DIRIDON STATION APPROACH	W SANTA CLARA ST	VIADUCT TO I-880	COMPLEX STRUCTURES	GENERAL PLAN 2 OF 2
300K 1B	79	ST-T0151	SAN JOSE DIRIDON STATION APPROACH	UPRR T-13, W TAYLOR ST	VIADUCT TO I-880	OVERPASSES AND UNDERPASSES	HEDDING ST AND TAYLOR S
300K 1B	80	ST-V0301	SAN JOSE DIRIDON STATION APPROACH	N/A	VIADUCT TO I-880	TYPICAL SECTIONS	SHEET 1 OF 3
300K 1B	81	ST-V0302	SAN JOSE DIRIDON STATION APPROACH	N/A	VIADUCT TO I-880	TYPICAL SECTIONS	SHEET 2 OF 3
BOOK 1B	82	ST-V0303	SAN JOSE DIRIDON STATION APPROACH	N/A	VIADUCT TO I-880	TYPICAL SECTIONS	SHEET 3 OF 3
300K 1B	83	ST-T0301	SAN JOSE DIRIDON STATION APPROACH	I-880, SR 85	VIADUCT TO I-880	CALTRANS STRUCTURES	GENERAL PLAN
BOOK 1B	84	ST-T0401	MONTEREY CORRIDOR	ALMADEN EXPY, CURTNER AVE	VIADUCT/AT-GRADE	OVERPASSES AND UNDERPASSES	GENERAL PLAN
BOOK 1B	85	ST-V0601	MONTEREY CORRIDOR	CAPITOL CALTRAIN, CAPITOL EXPY	VIADUCT	COMPLEX STRUCTURES	GENERAL PLAN 1 OF 2
BOOK 1B	86	ST-V0602	MONTEREY CORRIDOR	BLOSSOM HILL RD, BERNAL RD	VIADUCT	COMPLEX STRUCTURES	GENERAL PLAN 2 OF 2
BOOK 1B	87	ST-V0701	MORGAN HILL AND GILROY	BAILEY AVE, COCHRANE RD	VIADUCT TO DOWNTOWN GILROY	COMPLEX STRUCTURES	GENERAL PLAN 1 OF 2
OOK 1B	88	ST-V0702	MORGAN HILL AND GILROY	SB 101, LLAGAS CREEK	VIADUCT TO DOWNTOWN GILROY	COMPLEX STRUCTURES	GENERAL PLAN 2 OF 2
OOK 1B	89	ST-T0701	MORGAN HILL AND GILROY	BAILEY AVE, I-5	VIADUCT TO DOWNTOWN GILROY	CALTRANS STRUCTURES	GENERAL PLAN
BOOK 1B	90	ST-V0901	MORGAN HILL AND GILROY	US 101	VIADUCT TO DOWNTOWN GILROY	COMPLEX STRUCTURES	GENERAL PLAN
300K 1B	91	ST-V1401	PACHECO PASS	CALIFORNIA AQUEDUCT, CCID OUTSIDE CANAL	TUNNEL	COMPLEX STRUCTURES	GENERAL PLAN
	<u> </u>	J		5. 1 5 1. 1. 1. 1. 1. 1. 1. 1. 1. 1. 1. 1.			<u> </u>

SAN JOSE TO CVY EIR/S: VOLUME III GENERAL INFORMATION BOOK SHEET 8 OF 64

GENERAL PLAN

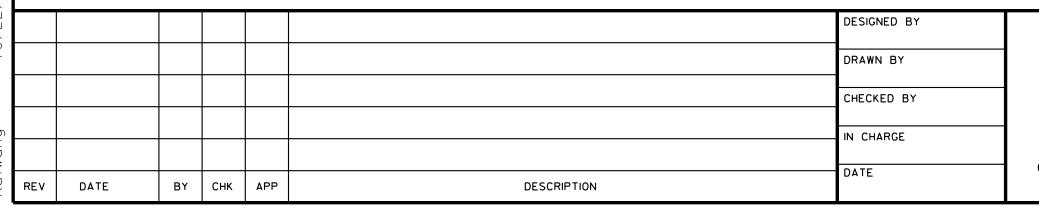

ST-V1601

SAN JOAQUIN VALLEY

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SAN LUIS WASTEWAY, LOS BANOS CREEK





HENRY MILLER ROAD

CALIFORNIA HIGH-SPEED TRAIN PROJECT SAN JOSE TO MERCED

COMPLEX STRUCTURES

ALTERNATIVE 1
INDEX OF DRAWING
SHEET 3 OF 7

CONTRACT NO. HSR15-34
DRAWING NO. GE-A0103
SCALE NONE
SHEET NO.


BOOK 1C

113

ALTERNA	ATIVE 1 - V	/IADUCT TO [DOWNTOWN GILROY				
ВООК	SHEET NO	DRAWING NO	SUBSECTION	GEOGRAPHIC LOCATION OR FEATURE	ALIGNMENT OR FEATURE	SHEET DESCRIPTION	ADDITIONAL DESCRIPTION
COVER, I	NDEX OF	DRAWING AI	ND KEY MAPS				
BOOK 1C	А	COVER	SAN JOSE TO MERCED SECTION	N/A	SAN JOSE TO CENTRAL VALLEY WYE	ALTERNATIVE 1	
BOOK 1C	В	GE-A0104	ENTIRE ALTERNATIVE	GRADE SEPARATIONS	INDEX OF DRAWING	SHEET 4 OF 7	
BOOK 1C	С	GE-A0105	ENTIRE ALTERNATIVE	MAINTENANCE OF WAY, TUNNELS	INDEX OF DRAWING	SHEET 5 OF 7	
BOOK 1C	D	GE-D0101	GENERAL	ENTIRE ALTERNATIVE	KEY MAP	COMPOSITE PLAN	
BOOK 1C	Е	GE-D0102	GENERAL	ENTIRE ALTERNATIVE	KEY MAP	SYSTEMS SITES	
ROADWA	AY						
SAN JOSE D	IRIDON STAT	TION APPROACH					
BOOK 1C	93	CV-T0151	SAN JOSE DIRIDON STATION APPROACH	CHESTNUT AVE, ELM ST	VIADUCT TO I-880	PLAN, PROFILE AND TYPICAL SECTIONS	WEST HEDDING STREET
BOOK 1C	94	CV-T0152	SAN JOSE DIRIDON STATION APPROACH	W TAYLOR ST, COLEMAN AVE	VIADUCT TO I-880	PLAN, PROFILE AND TYPICAL SECTIONS	WEST TAYLOR STREET
MONTEREY	CORRIDOR						
BOOK 1C	95	CV-S0601	MONTEREY CORRIDOR	CAPITOL EXPY, BLOSSOM HILL RD	VIADUCT	CIVIL DETAILS	
BOOK 1C	96	CV-T0401	MONTEREY CORRIDOR	WILLOW ST, W ALMA AVE	VIADUCT/AT-GRADE	GRADE SEPARATION LAYOUT, PROFILE, & CROSS SECTIONS	SR87 ON-RAMP
BOOK 1C	97	CV-T0402	MONTEREY CORRIDOR	CURTNER AVE	VIADUCT/AT-GRADE	GRADE SEPARATION LAYOUT, PROFILE, & CROSS SECTIONS	ALMADEN ROAD AND CURTNER
MORGAN H	IILL AND GILF	ROY					
BOOK 1C	98	CV-S0701	MORGAN HILL AND GILROY	ACCESS RD TO MONTEREY RD	VIADUCT TO DOWNTOWN GILROY	CIVIL DETAILS	
BOOK 1C	99	CV-S0901	MORGAN HILL AND GILROY	COHANSEY AVE, E LUCHESSA AVE	VIADUCT TO DOWNTOWN GILROY	CIVIL DETAILS	
BOOK 1C	100	CV-S1201	MORGAN HILL AND GILROY	LAKE RD, SR 152	VIADUCT TO DOWNTOWN GILROY	CIVIL DETAILS	
BOOK 1C	101	CV-T0704	MORGAN HILL AND GILROY	N/A	VIADUCT TO DOWNTOWN GILROY	GRADE SEPARATION LAYOUT, PROFILE, & CROSS SECTIONS	MONTEREY ROAD
BOOK 1C	102	CV-T0907	MORGAN HILL AND GILROY	BLOOMFIELD AVE, BLOSA AVE	VIADUCT TO DOWNTOWN GILROY	GRADE SEPARATION LAYOUT, PROFILE, & CROSS SECTIONS	BOLSA ROAD AND BLOOMFIELD
BOOK 1C	103	CV-T0909	MORGAN HILL AND GILROY	BLOOMFIELD ACCESS RD	VIADUCT TO DOWNTOWN GILROY	GRADE SEPARATION LAYOUT, PROFILE, & CROSS SECTIONS	BLOOMFIELD ACCESS ROAD
BOOK 1C	104	CV-G0901	MORGAN HILL AND GILROY	CARNADERO AVE, SHELDON AVE	VIADUCT/AT-GRADE TO DOWNTOWN GILROY	SOAP LAKE FLOOD PLAIN	DETAIL
PACHECO P	ASS						
BOOK 1C	105	CV-S1401	PACHECO PASS	ROMERO RD, CA-152	TUNNEL	CIVIL DETAILS	
SAN JOAQU	JIN VALLEY						
BOOK 1C	106	CV-S1601	SAN JOAQUIN VALLEY	MONTEREY RD, INGOMAR GRADE	HENRY MILLER ROAD	CIVIL DETAILS	
BOOK 1C	107	CV-T1603	SAN JOAQUIN VALLEY	VOLTA RD, HENRY MILLER RD	HENRY MILLER ROAD	GRADE SEPARATION LAYOUT, PROFILE, & CROSS SECTIONS	HENRY MILLER ROAD
BOOK 1C	108	CV-T1604	SAN JOAQUIN VALLEY	HENRY MILLER ACCESS	HENRY MILLER ROAD	GRADE SEPARATION LAYOUT, PROFILE, & CROSS SECTIONS	HENRY MILLER ACCESS
BOOK 1C	109	CV-T1606	SAN JOAQUIN VALLEY	HENRY MILLER RD, MERCEY SPRINGS RD	HENRY MILLER ROAD	GRADE SEPARATION LAYOUT, PROFILE, & CROSS SECTIONS	MERCEY SPRINGS ROAD
BOOK 1C	110	CV-T1609	SAN JOAQUIN VALLEY	DELTA RD	HENRY MILLER ROAD	GRADE SEPARATION LAYOUT, PROFILE, & CROSS SECTIONS	DELTA ROAD
BOOK 1C	111	CV-T1610	SAN JOAQUIN VALLEY	TURNER ISLAND RD, HENRY MILLER RD	HENRY MILLER ROAD	GRADE SEPARATION LAYOUT, PROFILE, & CROSS SECTIONS	TURNER ROAD
BOOK 1C	112	CV-T1611	SAN JOAQUIN VALLEY	CARLUCCI RD	HENRY MILLER ROAD	GRADE SEPARATION LAYOUT, PROFILE, & CROSS SECTIONS	CARLUCCI ROAD

SAN JOSE TO CVY EIR/S: VOLUME III **GENERAL INFORMATION BOOK** SHEET 9 OF 64

HUTCHINS ROAD

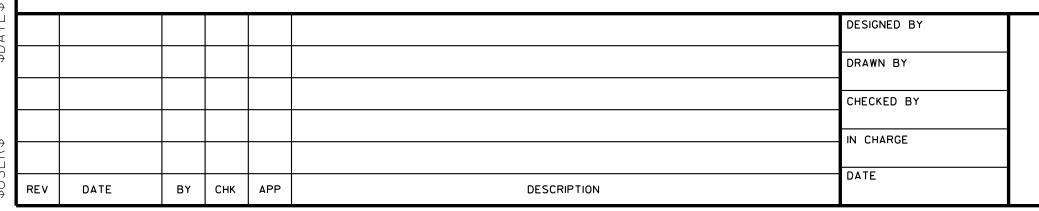

CV-T1612

SAN JOAQUIN VALLEY

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HUTCHINS RD





HENRY MILLER ROAD

CALIFORNIA HIGH-SPEED TRAIN PROJECT SAN JOSE TO MERCED

GRADE SEPARATION LAYOUT, PROFILE, & CROSS SECTIONS

ALTERNATIVE 1 INDEX OF DRAWING SHEET 4 OF 7

CONTRACT NO. HSR15-34
DRAWING NO.
SCALE
SHEET NO.
GE - AO104 SCALE NONE

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ВООК	SHEET NO	DRAWING NO	SUBSECTION	GEOGRAPHIC LOCATION OR FEATURE	ALIGNMENT OR FEATURE	SHEET DESCRIPTION	ADDITIONAL DESCRIPTION
/AINTE	NANCE OI	WAY					
BOOK 1C	114	MY-B0906	MORGAN HILL AND GILROY	CARNADERO AVE, SHELDON AVE	VIADUCT TO DOWNTOWN GILROY	MAINTENANCE OF WAY FACILITY	DETAIL PLAN
BOOK 1C	115	MY-B0907	MORGAN HILL AND GILROY	N/A	VIADUCT TO DOWNTOWN GILROY	MAINTENANCE OF WAY FACILITY	DETAIL PLAN
BOOK 1C	116	MY-B0908	MORGAN HILL AND GILROY	N/A	VIADUCT TO DOWNTOWN GILROY	MAINTENANCE OF WAY FACILITY	DETAIL PLAN
UNNELS	- PACHE	CO PASS					
BOOK 1C	117	TN-D1404	PACHECO PASS	N/A	TUNNEL	TUNNEL 2 - PORTAL 1	
BOOK 1C	118	TN-D1405	PACHECO PASS	ACCESS RD 1	TUNNEL	TUNNEL PORTAL 2 ACCESS ROAD	
ВООК 1С	119	TN-D1406	PACHECO PASS	CALIFORNIA AQUEDUCT	TUNNEL	TUNNEL PORTAL 2 ACCESS ROAD	
BOOK 1C	120	TN-D1407	PACHECO PASS	ACCESS RD 2	TUNNEL	TUNNEL PORTAL 2 ACCESS ROAD	
BOOK 1C	121	TN-D1408	PACHECO PASS	N/A	TUNNEL	LONGITUDINAL PROFILE	
BOOK 1C	122	TN-D1409	PACHECO PASS	N/A	TUNNEL	GRADING DETAIL	
BOOK 1C	123	TN-D1410	PACHECO PASS	N/A	TUNNEL	GRADING DETAIL	
BOOK 1C	124	TN-D1411	PACHECO PASS	N/A	TUNNEL	GRADING DETAIL	
BOOK 1C	125	TN-D1412	PACHECO PASS	N/A	TUNNEL	GRADING DETAIL	
BOOK 1C	126	TN-D1413	PACHECO PASS	I-5, FAHEY RD	TUNNEL	GRADING DETAIL	
BOOK 1C	127	TN-D1414	PACHECO PASS	N/A	TUNNEL	TUNNEL 2 - PORTAL 1	SECTIONS
BOOK 1C	128	TN-D1415	PACHECO PASS	N/A	TUNNEL	TUNNEL 2 - PORTAL 2	APPROACH 1
BOOK 1C	129	TN-D1416	PACHECO PASS	N/A	TUNNEL	TUNNEL 2 - PORTAL 2	APPROACH 2

SAN JOSE TO CVY EIR/S: VOLUME III GENERAL INFORMATION BOOK **SHEET 10 OF 64**

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CALIFORNIA HIGH-SPEED TRAIN PROJECT **SAN JOSE TO MERCED**

ALTERNATIVE 1 INDEX OF DRAWING SHEET 5 OF 7

CONTRACT NO. HSR15-34
DRAWING NO. GE-A0105
SCALE NONE
SHEET NO.

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						CHECKED BY	
						IN CHARGE	
						DATE	
REV	DATE	BY	СНК	APP	DESCRIPTION	DATE	

ALTERNATIVE 1 - VIADUCT TO DOWNTOWN GILROY

SUBSECTION

SAN JOSE TO MERCED SECTION

ENTIRE ALTERNATIVE

ENTIRE ALTERNATIVE

GENERAL

GENERAL

MONTEREY CORRIDOR

MONTEREY CORRIDOR

MORGAN HILL AND GILROY

SAN JOAQUIN VALLEY

SHEET NO DRAWING NO

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BOOK 1D

COVER, INDEX OF DRAWING AND KEY MAPS

COVER

GE-A0106

GE-A0107

GE-D0101

GE-D0102

CV-I0401

CV-I0402

CV-I0403

CV-10404

CV-I0405A

CV-I0405B

CV-I0405C

CV-I0406

CV-10407

CV-I0408

CV-I0409

CV-I0410

CV-I0411

CV-I0412

CV-I0413

CV-I1001

CV-I1002

CV-I1003

CV-I1004

CV-I1005

CV-I1006

CV-I1007

CV-I1601

CV-I1602

CV-I1603

CV-I1604

CV-I1605

CV-I1606

CV-I1607



GEOGRAPHIC LOCATION OR FEATURE

N/A

CONSTRUCTION STAGING

ALIGNMENT DATA TABLES

ENTIRE ALTERNATIVE

ENTIRE ALTERNATIVE

W ALMA AVE, CURTNER AVE

ALMADEN RD

ALMADEN RD

ALMADEN RD

ALMADEN RD

ALMADEN RD

SR 87, UPRR

SR 87, UPRR

SR 87, UPRR

SR 87, UPRR

UPRR

UPRR

N/A

BOLSA RD

BLOOMFIELD AVE, SHELDON AVE

BLOOMFIELD AVE, BOLSA RD

BLOOMFIELD AVE, SHELDON AVE

BLOOMFIELD AVE, BOLSA RD

BLOOMFIELD AVE, SHELDON AVE

INGOMAR GRDE RD, HENRY MILLER RD


HENRY MILLER RD

HENRY MILLER RD, MERCEY SPRINGS RD

HENRY MILLER RD, DELTA RD

HENRY MILLER RD, TURNER ISLAND RD

HENRY MILLER RD, CARLUCCI RD

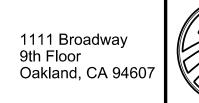



ALIGNMENT OR FEATURE

SAN JOSE TO CENTRAL VALLEY WYE

INDEX OF DRAWING

INDEX OF DRAWING

KEY MAP

KEY MAP

VIADUCT

VIADUCT

VIADUCT

VIADUCT

VIADUCT

VIADUCT TO DOWNTOWN GILROY

HENRY MILLER ROAD

SAN JOSE TO CVY EIR/S: VOLUME III **GENERAL INFORMATION BOOK SHEET 11 OF 64**

CALIFORNIA HIGH-SPEED TRAIN PROJECT SAN JOSE TO MERCED

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CONSTRUCTION STAGING PLAN-PHASE 1-STAGES 3

CONSTRUCTION STAGING PLAN-PHASE 2

CONSTRUCTION STAGING PLAN-PHASE 3

CONSTRUCTION STAGING-PHASE 1-STAGE 1

CONSTRUCTION STAGING-PHASE 1-STAGE 2

CONSTRUCTION STAGING-PHASE 1-STAGE 3

CONSTRUCTION STAGING-PHASE 2

CONSTRUCTION STAGING-PHASE 3

CONSTRUCTION STAGING-PHASE 1-STAGES 1 & 2

CONSTRUCTION STAGING-PHASE 1-STAGES 3

CONSTRUCTION STAGING-PHASE 2

CONSTRUCTION STAGING-PHASE 3

CONSTRUCTION STAGING-PHASE 1

CONSTRUCTION STAGING-PHASES 2 & 3

CONSTRUCTION PHASING / STAGING PLAN

CONSTRUCTION PHASING / STAGING PLAN - STAGE 1

CONSTRUCTION PHASING / STAGING PLAN - STAGE 1

CONSTRUCTION PHASING / STAGING PLAN - STAGE 2

CONSTRUCTION PHASING / STAGING PLAN - STAGE 2

CONSTRUCTION PHASING / STAGING PLAN - STAGE 3

CONSTRUCTION PHASING / STAGING PLAN - STAGE 3

CONSTRUCTION STAGING PLAN

CONSTRUCTION STAGING PLAN

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CONSTRUCTION STAGING PLAN

CONSTRUCTION STAGING PLAN

ALTERNATIVE 1 INDEX OF DRAWING SHEET 6 OF 7

CONTRACT NO. HSR15-34
DRAWING NO. GE-A0106
scale NONE
SHEET NO.

ADDITIONAL DESCRIPTION

CALTRAIN/UPRR RELOCATION-STA

CALTRAIN/UPRR RELOCATION-STA

CALTRAIN/UPRR RELOCATION-STA

CALTRAIN/UPRR RELOCATION-STA

ALMADEN RD UNDERPASS

MODIFY EXISTING ALMADEN

MODIFY EXISTING ALMADEN

MODIFY EXISTING ALMADEN

MODIFY EXISTING ALMADEN

MODIFY EXISTING CURTNER

MODIFY EXISTING CURTNER

GENERAL NOTES

BLOOMFIELD AVENUE GRADE

GENERAL NOTES

HENRY MILLER ROAD GRADE

HENRY MILLER ROAD GRADE

SR-165 / MERCEY SPRINGS ROAD

DELTA ROAD GRADE SEPARATION

TURNER ISLAND ROAD GRADE

CARLUCCI ROAD GRADE

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CHECKED BY	MAY 3, 2019
IN CHARGE	NOT FOR
DATE	CONSTRUCTION


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OOK 1D	150	TT DO101 IN/	CAN IOSE DIDIDON STATION ADDDOACH	NI / A	VIADUCT TO I-880	TDACK ALICNIA/ENT DATA TADI C	CLIDVE NO C100 AND C10
	159	TT-B0101-JM	SAN JOSE DIRIDON STATION APPROACH	N/A		TRACK ALIGNMENT DATA TABLE	CURVE NO. C189 AND C19
OOK 1D	160	TT-B0102-JM	SAN JOSE DIRIDON STATION APPROACH	N/A	VIADUCT TO L880	TRACK ALIGNMENT DATA TABLE	CURVE NO. C191 AND C19
OK 1D	161 162	TT-B0103-JM	SAN JOSE DIRIDON STATION APPROACH	N/A	VIADUCT TO L880	TRACK ALIGNMENT DATA TABLE	CURVE NO. C193
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OK 1D	163	TT-B0105	MONTEREY CORRIDOR	N/A	VIADUCT TO I-880	B2 TRACK ALIGNMENT DATA TABLE	CURVE NO. C103 AND C1
OK 1D	164	TT-B0106	MONTEREY CORRIDOR	N/A	VIADUCT/AT-GRADE	B2 TRACK ALIGNMENT DATA TABLE	CURVE NO. C105 AND C1
OK 1D	165	TT-B0107	MONTEREY CORRIDOR	N/A	VIADUCT/AT-GRADE	B2 TRACK ALIGNMENT DATA TABLE	CURVE NO. C107
OK 1D	166	TT-B0108	MONTEREY CORRIDOR	N/A	VIADUCT	B2 TRACK ALIGNMENT DATA TABLE	CURVE NO. C108 AND C1
OOK 1D	167	TT-B0109	MONTEREY CORRIDOR	N/A	TRACK GUIDEWAY	B2 TRACK ALIGNMENT DATA TABLE	CURVE NO. C110 AND C1
OOK 1D	168	TT-B0110	MONTEREY CORRIDOR	N/A	TRACK GUIDEWAY	B2 TRACK ALIGNMENT DATA TABLE	CURVE NO. C112
OOK 1D	169	TT-B0111	MORGAN HILL AND GILROY	N/A	TRACK GUIDEWAY	B2 TRACK ALIGNMENT DATA TABLE	CURVE NO. C113 AND C13
00K 1D	170	TT-B0112	MORGAN HILL AND GILROY	N/A	TRACK GUIDEWAY	B2 TRACK ALIGNMENT DATA TABLE	CURVE NO. C115 AND C1
OOK 1D	171	TT-B0113	MORGAN HILL AND GILROY	N/A	TRACK GUIDEWAY	B2 TRACK ALIGNMENT DATA TABLE	CURVE NO. C117 AND C1
OOK 1D	172	TT-B0114	MORGAN HILL AND GILROY	N/A	TRACK GUIDEWAY	B2 TRACK ALIGNMENT DATA TABLE	CURVE NO. C119 AND C1
BOOK 1D	173	TT-B0115	MORGAN HILL AND GILROY	N/A	TRACK GUIDEWAY	B2 TRACK ALIGNMENT DATA TABLE	CURVE NO. C121
OOK 1D	174	TT-B0116	MORGAN HILL AND GILROY	N/A	TRACK GUIDEWAY	B2 TRACK ALIGNMENT DATA TABLE	CURVE NO. C122
OOK 1D	175	TT-B0117	MORGAN HILL AND GILROY	N/A	TRACK GUIDEWAY	B2 TRACK ALIGNMENT DATA TABLE	CURVE NO. C123
OOK 1D	176	TT-B0118	MORGAN HILL AND GILROY	N/A	TRACK GUIDEWAY	B2 TRACK ALIGNMENT DATA TABLE	CURVE NO. C124 AND C1
OOK 1D	177	TT-B0119	MORGAN HILL AND GILROY	N/A	TRACK GUIDEWAY	B2 TRACK ALIGNMENT DATA TABLE	CURVE NO. C126
BOOK 1D	178	TT-B0120	MORGAN HILL AND GILROY	N/A	TRACK GUIDEWAY	B2 TRACK ALIGNMENT DATA TABLE	CURVE NO. C127 AND C1
BOOK 1D	179	TT-B0121	MORGAN HILL AND GILROY	N/A	TRACK GUIDEWAY	B2 TRACK ALIGNMENT DATA TABLE	CURVE NO. C129
OOK 1D	180	TT-B0122	MORGAN HILL AND GILROY	N/A	TRACK GUIDEWAY	B2 TRACK ALIGNMENT DATA TABLE	CURVE NO. C130
300K 1D	181	TT-B0123	PACHECO PASS	N/A	TRACK GUIDEWAY	B2 TRACK ALIGNMENT DATA TABLE	CURVE NO. C131
300K 1D	182	TT-B0124	PACHECO PASS	N/A	TRACK GUIDEWAY	B2 TRACK ALIGNMENT DATA TABLE	CURVE NO. C132 AND C1
OOK 1D	183	TT-B0125	PACHECO PASS	N/A	TRACK GUIDEWAY	B2 TRACK ALIGNMENT DATA TABLE	CURVE NO. C134 AND C1
OOK 1D	184	TT-B0126	PACHECO PASS	N/A	TRACK GUIDEWAY	B2 TRACK ALIGNMENT DATA TABLE	CURVE NO. C136
BOOK 1D	185	TT-B0127	SAN JOAQUIN VALLEY	N/A	TRACK GUIDEWAY	B2 TRACK ALIGNMENT DATA TABLE	CURVE NO. C137
300K 1D	186	TT-B0128	SAN JOAQUIN VALLEY	N/A	TRACK GUIDEWAY	B2 TRACK ALIGNMENT DATA TABLE	CURVE NO. C138 AND C1
BOOK 1D	187	TT-B0129	SAN JOAQUIN VALLEY	N/A	TRACK GUIDEWAY	B2 TRACK ALIGNMENT DATA TABLE	CURVE NO. C140
300K 1D	188	TT-B0130	MORGAN HILL AND GILROY	N/A	TRACK GUIDEWAY	B1 TRACK ALIGNMENT DATA TABLE	CURVE NO. C230
300K 1D	189	TT-B0131	MORGAN HILL AND GILROY	N/A	TRACK GUIDEWAY	B1 TRACK ALIGNMENT DATA TABLE	CURVE NO. C231 AND C23
300K 1D	190	TT-B0132	PACHECO PASS	N/A	TRACK GUIDEWAY	B1 TRACK ALIGNMENT DATA TABLE	CURVE NO. C232 AND C2
BOOK 1D	191	TT-B0133	PACHECO PASS	N/A	TRACK GUIDEWAY	B1 TRACK ALIGNMENT DATA TABLE	CURVE NO. C234 AND C2
300K 1D	192	TT-B0134	PACHECO PASS	N/A	TRACK GUIDEWAY	B1 TRACK ALIGNMENT DATA TABLE	CURVE NO. C236
			IMENT DATA TABLE				
BOOK 1D	193	CV-B0101	MONTEREY CORRIDOR	N/A	VIADUCT	ALIGNMENT DATA TABLE	

GEOGRAPHIC LOCATION OR FEATURE

SAN JOSE TO CVY EIR/S: VOLUME III **GENERAL INFORMATION BOOK SHEET 12 OF 64**

ADDITIONAL DESCRIPTION

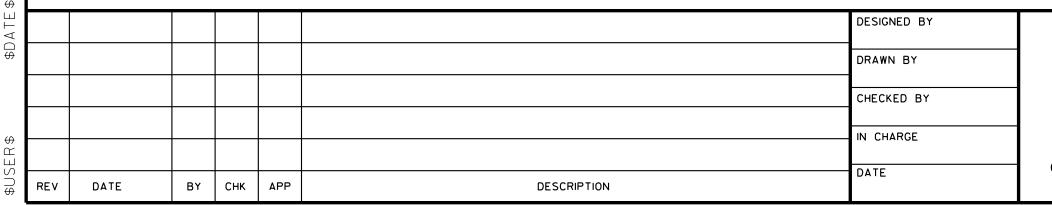

ALTERNATIVE 1 - VIADUCT TO DOWNTOWN GILROY

TRACK GUIDEWAY HORIZONTAL ALIGNMENT DATA TABLE

SUBSECTION

SHEET NO DRAWING NO

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ALIGNMENT OR FEATURE

CALIFORNIA HIGH-SPEED TRAIN PROJECT **SAN JOSE TO MERCED**

SHEET DESCRIPTION

ALTERNATIVE 1 INDEX OF DRAWING SHEET 7 OF 7

CONTRACT NO. HSR15-34
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OVEK, IND	EX OF DRAW	ING AND KE	Y IVIAPS				
BOOK 2A	А	COVER	SAN JOSE TO MERCED SECTION	N/A	SAN JOSE TO CENTRAL VALLEY WYE	ALTERNATIVE 2	EMABNKMENT TO DOWNTOWN GILROY
			SAN JOSE DIRIDON STATION APPROACH,				
BOOK 2A	В	GE-A0205	MONTEREY CORRIDOR, MORGAN HILL AND	SCOTT BLVD TO PACHECO PASS HWY	INDEX OF DRAWING	SHEET 1 OF 8	
			GILROY				
BOOK 2A	C	GE-D0201	GENERAL	ENTIRE ALTERNATIVE	KEY MAP	COMPOSITE PLAN	
BOOK 2A	D	GE-D0202	GENERAL	ENTIRE ALTERNATIVE	KEY MAP	SYSTEMS SITES	
OMPOSITI	PLANS						
AN JOSE DIRIC	OON STATION AP	PROACH					
BOOK 2A	1	TT-D0251	SAN JOSE DIRIDON STATION APPROACH	SCOTT BLVD TO BENTON ST	VIADUCT TO SCOTT BLVD	COMPOSITE PLAN, PROFILE AND TYPICAL SECTIONS	B2250+00 TO B2340+00
BOOK 2A	2	TT-D0252	SAN JOSE DIRIDON STATION APPROACH	NEWHALL ST TO W TAYLOR ST	VIADUCT TO SCOTT BLVD	COMPOSITE PLAN, PROFILE AND TYPICAL SECTIONS	B2340+00 TO B2430+00
BOOK 2A	3	TT-D0253	SAN JOSE DIRIDON STATION APPROACH	CINNABAR ST TO PARK AVE	VIADUCT TO SCOTT BLVD	COMPOSITE PLAN, PROFILE AND TYPICAL SECTIONS	B2430+00 TO B58+00
BOOK 2A	4	TT-D0301	SAN JOSE DIRIDON STATION APPROACH	PARK AVE TO WILLOW ST	VIADUCT TO SCOTT BLVD	COMPOSITE PLAN, PROFILE AND CROSS SECTIONS	B58+00 TO B125+00
ONTEREY CO	RRIDOR					,	
BOOK 2A	5	TT-D0401	MONTEREY CORRIDOR	WILLOW ST, CURTNER AVE	VIADUCT/AT-GRADE	COMPOSITE PLAN, PROFILE AND CROSS SECTIONS	B125+00 TO B211+00
BOOK 2A	6	TT-D0501	MONTEREY CORRIDOR	COMMUNICATION HILL BLVD TO ESFAHAN CT	AT-GRADE	COMPOSITE PLAN, PROFILE AND CROSS SECTIONS	B211+00 TO B286+00
BOOK 2A	7	TT-D0502	MONTEREY CORRIDOR	CAPITOL EXPY TO SKYWAY DR	AT-GRADE	COMPOSITE PLAN, PROFILE AND CROSS SECTIONS	B286+00 TO B374+00
BOOK 2A	8	TT-D0503	MONTEREY CORRIDOR	VALLEYHAVEN WAY TO BLOSSOM HILL RD	AT-GRADE	COMPOSITE PLAN, PROFILE AND CROSS SECTIONS	B374+00 TO B462+00
BOOK 2A	9	TT-D0504	MONTEREY CORRIDOR	BLOSSOM HILL RD TO SR 85	AT-GRADE	COMPOSITE PLAN, PROFILE AND CROSS SECTIONS	B462+00 TO B552+00
ORGAN HILL	AND GILROY					,	
BOOK 2A	10	TT-D0801	MORGAN HILL AND GILROY	SR 85 TO FORSUM RD	EMBANKMENT TO DOWNTOWN GILROY	COMPOSITE PLAN, PROFILE AND CROSS SECTIONS	B552+00 TO B730+00
BOOK 2A	11	TT-D0802	MORGAN HILL AND GILROY	METCALF RD TO BLANCHARD RD	EMBANKMENT TO DOWNTOWN GILROY	COMPOSITE PLAN, PROFILE AND CROSS SECTIONS	B730+00 TO B818+00
BOOK 2A	12	TT-D0803	MORGAN HILL AND GILROY	BAILEY AVE TO RICHMOND AVE	EMBANKMENT TO DOWNTOWN GILROY	COMPOSITE PLAN, PROFILE AND CROSS SECTIONS	B818+00 TO B907+00
BOOK 2A	13	TT-D0804	MORGAN HILL AND GILROY	FOX LN TO MONTE AVE	EMBANKMENT TO DOWNTOWN GILROY	COMPOSITE PLAN, PROFILE AND CROSS SECTIONS	B907+00 TO B966+00
BOOK 2A	14	TT-D0805	MORGAN HILL AND GILROY	OAK AVE TO BURNETT AVE	EMBANKMENT TO DOWNTOWN GILROY	COMPOSITE PLAN, PROFILE AND CROSS SECTIONS	B966+00 TO B1086+00
BOOK 2A	15	TT-D0806	MORGAN HILL AND GILROY	PEEBLES AVE TP E CENTRAL AVE	EMBANKMENT TO DOWNTOWN GILROY	COMPOSITE PLAN, PROFILE AND CROSS SECTIONS	B1086+00 TO B1175+00
BOOK 2A	16	TT-D0807	MORGAN HILL AND GILROY	MAIN AVE TO TENNANT AVE	EMBANKMENT TO DOWNTOWN GILROY	COMPOSITE PLAN, PROFILE AND CROSS SECTIONS	B1175+00 TO B1265+00
BOOK 2A	17	TT-D0808	MORGAN HILL AND GILROY	BUTTERFIELD BLVD TO E MIDDLE AVE	EMBANKMENT TO DOWNTOWN GILROY	COMPOSITE PLAN, PROFILE AND CROSS SECTIONS	B1265+00 TO B1354+00
BOOK 2A	18	TT-D0907	MORGAN HILL AND GILROY	BLOOMFIELD AVE TO SHELDON AVE	VIADUCT TO DOWNTOWN GILROY	COMPOSITE PLAN, PROFILE AND CROSS SECTIONS	B1855+00 TO B1930+00
BOOK 2A	19	TT-D0908	MORGAN HILL AND GILROY	PAJARO RIVER	VIADUCT TO DOWNTOWN GILROY	COMPOSITE PLAN, PROFILE AND CROSS SECTIONS	B1930+00 TO B2017+00
BOOK 2A	20	TT-D0909	MORGAN HILL AND GILROY	FRAZIER LAKE RD	VIADUCT TO DOWNTOWN GILROY	COMPOSITE PLAN, PROFILE AND CROSS SECTIONS	B2017+00 TO B2103+00
BOOK 2A	21	TT-D0910	MORGAN HILL AND GILROY	N/A	VIADUCT TO DOWNTOWN GILROY	UPRR FREIGHT AND TRANSITION TRACK PROFILES	
BOOK 2A	22	TT-D1001	MORGAN HILL AND GILROY	CALIFORNIA AVE TO HIGHLAND AVE	EMBANKMENT TO DOWNTOWN GILROY	COMPOSITE PLAN, PROFILE AND CROSS SECTIONS	B1354+00 TO B1443+00
BOOK 2A	23	TT-D1002	MORGAN HILL AND GILROY	CHURCH AVE TO MASTEN AVE	EMBANKMENT TO DOWNTOWN GILROY	COMPOSITE PLAN, PROFILE AND CROSS SECTIONS	B1443+00 TO B1531+00
BOOK 2A	24	TT-D1003	MORGAN HILL AND GILROY	RUCKER AVE TO LAS ANIMAS AVE	EMBANKMENT TO DOWNTOWN GILROY	COMPOSITE PLAN, PROFILE AND CROSS SECTIONS	B1531+00 TO B1616+00
BOOK 2A	25	TT-D1004	MORGAN HILL AND GILROY	LEAVESLEY RD TO IOOF AVE	EMBANKMENT TO DOWNTOWN GILROY	COMPOSITE PLAN, PROFILE AND CROSS SECTIONS	B1616+00 TO B1685+00
BOOK 2A	26	TT-D1005	MORGAN HILL AND GILROY	LEWIS ST TO E LUCHESSA AVE	EMBANKMENT TO DOWNTOWN GILROY	COMPOSITE PLAN, PROFILE AND CROSS SECTIONS	B1685+00 TO B1767+00
BOOK 2A	27	TT-D1006	MORGAN HILL AND GILROY	US 101 TO MAYOCK RD	EMBANKMENT TO DOWNTOWN GILROY	COMPOSITE PLAN, PROFILE AND CROSS SECTIONS	B1767+00 TO B1855+00
BOOK 2A	28	TT-D1007	MORGAN HILL AND GILROY	N/A	EMBANKMENT TO DOWNTOWN GILROY	UPRR FREIGHT TRACK PROFILE	
BOOK 2A	29	TT-D1201	MORGAN HILL AND GILROY	LAKE RD TO LOVERS LANE	VIADUCT TO DOWNTOWN GILROY	COMPOSITE PLAN, PROFILE AND CROSS SECTIONS	B2103+00 TO B2193+00
BOOK 2A	30	TT-D1202	MORGAN HILL AND GILROY	SAN FELIPE RD TO PACHECO PASS RD	VIADUCT TO DOWNTOWN GILROY	COMPOSITE PLAN, PROFILE AND CROSS SECTIONS	B2193+00 TO B2275+00
BOOK 2A	31	TT-D1203	MORGAN HILL AND GILROY	PACHECO PASS HWY	VIADUCT TO DOWNTOWN GILROY	COMPOSITE PLAN, PROFILE AND CROSS SECTIONS	B2275+00 TO B2362+00

SAN JOSE TO CVY EIR/S: VOLUME III GENERAL INFORMATION BOOK SHEET 13 OF 64

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CALIFORNIA HIGH-SPEED TRAIN PROJECT SAN JOSE TO MERCED

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INDEX OF DRAWING
SHEET 1 OF 8

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BOOK 2B	Α	COVER	SAN JOSE TO MERCED SECTION	N/A	SAN JOSE TO CENTRAL VALLEY WYE	ALTERNATIVE 2	EMABNKMENT TO DOWNTOWN GILROY
BOOK 2B	,,	COVER	PACHECO PASS, SAN JOAQUIN VALLEY; SAN	1377	37117332 13 321111112 771221 7712	/ LETERIO / LETE	ENWISH TO BOWN TOWN CIENCE
воок 2в	B	GE-A0202	JOSE DIRIDON STATION APPROACH, MORGAN	SR 152 TO CARLUCCI ROAD, STATIONS	INDEX OF DRAWING	SHEET 2 OF 8	
500K 25		02 7.0202	HILL AND GILROY		III DIVINITO	311221 2 31 3	
BOOK 2B	C	GE-A0203	ENTIRE ALTERNATIVE	STATIONS, COMPLEX STRUCTURES	INDEX OF DRAWING	SHEET 3 OF 8	
BOOK 2B	D	GE-D0201	GENERAL	ENTIRE ALTERNATIVE	KEY MAP	COMPOSITE PLAN	
BOOK 2B	E	GE-D0202	GENERAL	ENTIRE ALTERNATIVE	KEY MAP	SYSTEMS SITES	
	21 4 4 1 4				<u> </u>		
COMPOSITE	PLANS						
PACHECO PASS							
BOOK 2B	32	TT-D1401	PACHECO PASS	N/A	TUNNEL	COMPOSITE PLAN, PROFILE AND CROSS SECTIONS	B2362+00 TO B3205+00
BOOK 2B	33	TT-D1402	PACHECO PASS	SERVICE ROAD 1	TUNNEL	COMPOSITE PLAN, PROFILE AND CROSS SECTIONS	B3205+00 TO B3295+00
BOOK 2B	34	TT-D1403	PACHECO PASS	N/A	TUNNEL	COMPOSITE PLAN, PROFILE AND CROSS SECTIONS	B3295+00 TO B3385+00
BOOK 2B	35	TT-D1404	PACHECO PASS	N/A	TUNNEL	COMPOSITE PLAN, PROFILE AND CROSS SECTIONS	B3385+00 TO B3475+00
BOOK 2B	36	TT-D1405	PACHECO PASS	SR 152	TUNNEL	COMPOSITE PLAN, PROFILE AND CROSS SECTIONS	B3475+00 TO B3565+00
BOOK 2B	37	TT-D1406	PACHECO PASS	N/A	TUNNEL	COMPOSITE PLAN, PROFILE AND CROSS SECTIONS	B3565+00 TO B3655+00
BOOK 2B	38	TT-D1407	PACHECO PASS	SR 152	TUNNEL	COMPOSITE PLAN, PROFILE AND CROSS SECTIONS	B3655+00 TO B3745+00
BOOK 2B	39	TT-D1408	PACHECO PASS	N/A	TUNNEL	COMPOSITE PLAN, PROFILE AND CROSS SECTIONS	B3745+00 TO B3835+00
BOOK 2B	40	TT-D1409	PACHECO PASS	N/A	TUNNEL	COMPOSITE PLAN, PROFILE AND CROSS SECTIONS	B3835+00 TO B3923+00
BOOK 2B	41	TT-D1410	PACHECO PASS	N/A	TUNNEL	COMPOSITE PLAN, PROFILE AND CROSS SECTIONS	B3923+00 TO B4014+00
BOOK 2B	42	TT-D1411	PACHECO PASS	MCCABE RD	TUNNEL	COMPOSITE PLAN, PROFILE AND CROSS SECTIONS	B4014+00 TO B4105+00
BOOK 2B	43	TT-D1412	PACHECO PASS	N/A	TUNNEL	COMPOSITE PLAN, PROFILE AND CROSS SECTIONS	B4105+00 TO B4196+00
BOOK 2B	44	TT-D1413	PACHECO PASS	N/A	TUNNEL	COMPOSITE PLAN, PROFILE AND CROSS SECTIONS	B4196+00 TO B4287+00
BOOK 2B	45	TT-D1414	PACHECO PASS	ROMERO RD N, SR 33	TUNNEL	COMPOSITE PLAN, PROFILE AND CROSS SECTIONS	B4287+00 TO B4372+00
SAN JOAQUIN V	ALLEY						
BOOK 2B	46	TT-D1601	SAN JOAQUIN VALLEY	FAHEY RD	HENRY MILLER ROAD	COMPOSITE PLAN, PROFILE AND CROSS SECTIONS	B4377+00 TO B4445+00
BOOK 2B	47	TT-D1602	SAN JOAQUIN VALLEY	CCID MAIN CANAL	HENRY MILLER ROAD	COMPOSITE PLAN, PROFILE AND CROSS SECTIONS	B4445+00 TO B4533+00
BOOK 2B	48	TT-D1603	SAN JOAQUIN VALLEY	INGOMAR GRADE RD	HENRY MILLER ROAD	COMPOSITE PLAN, PROFILE AND CROSS SECTIONS	B4533+00 TO B4614+00
BOOK 2B	49	TT-D1604	SAN JOAQUIN VALLEY	VOLTA RD TO HENRY MILLER RD	HENRY MILLER ROAD	COMPOSITE PLAN, PROFILE AND CROSS SECTIONS	B4614+00 TO B4686+00
BOOK 2B	50	TT-D1605	SAN JOAQUIN VALLEY	MONROE AVE	HENRY MILLER ROAD	COMPOSITE PLAN, PROFILE AND CROSS SECTIONS	B4686+00 TO B4758+00
BOOK 2B	51	TT-D1606	SAN JOAQUIN VALLEY	BADGER FLAT RD TO NANTES AVE	HENRY MILLER ROAD	COMPOSITE PLAN, PROFILE AND CROSS SECTIONS	B4758+00 TO B4846+00
BOOK 2B	52	TT-D1607	SAN JOAQUIN VALLEY	SR 165 TO SANTA FE GRDE	HENRY MILLER ROAD	COMPOSITE PLAN, PROFILE AND CROSS SECTIONS	B4846+00 TO B4932+00
BOOK 2B	53	TT-D1608	SAN JOAQUIN VALLEY	N/A	HENRY MILLER ROAD	COMPOSITE PLAN, PROFILE AND CROSS SECTIONS	B4932+00 TO B5020+00
BOOK 2B	54	TT-D1609	SAN JOAQUIN VALLEY	BAKER RD TO DELTA RD	HENRY MILLER ROAD	COMPOSITE PLAN, PROFILE AND CROSS SECTIONS	B5020+00 TO B5109+00
BOOK 2B	55	TT-D1610	SAN JOAQUIN VALLEY	MIDWAY RD TO BOX CAR RD	HENRY MILLER ROAD	COMPOSITE PLAN, PROFILE AND CROSS SECTIONS	B5109+00 TO B5193+00
BOOK 2B	56	TT-D1611	SAN JOAQUIN VALLEY	TURNER ISLAND RD	HENRY MILLER ROAD	COMPOSITE PLAN, PROFILE AND CROSS SECTIONS	B5193+00 TO B5282+00
BOOK 2B	57	TT-D1612	SAN JOAQUIN VALLEY	CARLUCCI RD	HENRY MILLER ROAD	COMPOSITE PLAN, PROFILE AND CROSS SECTIONS	B5282+00 TO 5337+28.93

SAN JOSE TO CVY EIR/S: VOLUME III GENERAL INFORMATION BOOK SHEET 14 OF 64

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CALIFORNIA HIGH-SPEED TRAIN PROJECT **SAN JOSE TO MERCED**

ALTERNATIVE 2 INDEX OF DRAWING SHEET 2 OF 8

CONTRACT NO. HSR15-34
DRAWING NO. GE-A0202
SCALE NONE
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CALIFORNIA AQUEDUCT, CCID OUTSIDE CANAL

SAN LUIS WASTEWAY, LOS BANOS CREEK





TUNNEL HENRY MILLER ROAD

SAN JOSE TO CVY EIR/S: VOLUME III **GENERAL INFORMATION BOOK SHEET 15 OF 64** CONTRACT NO. CALIFORNIA HIGH-SPEED TRAIN PROJECT

GENERAL PLAN

GENERAL PLAN

SAN JOSE TO MERCED ALTERNATIVE 2 INDEX OF DRAWING SHEET 3 OF 8

COMPLEX STRUCTURES

COMPLEX STRUCTURES

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ВООК	SHEET NO	DRAWING NO	SUBSECTION	GEOGRAPHIC LOCATION	ALIGNMENT OR FEATURE	SHEET DESCRIPTION	ADDITIONAL DESCRIPTION
ATIONS							
BOOK 2B	58	AR-C0101	SAN JOSE DIRIDON STATION APPROACH	SANTA CLARA ST, PARK AVE	VIADUCT TO I-880	SAN JOSE DIRIDON STATION	CONCEPTUAL SITE PLAN
BOOK 2B	59	AR-C0102	SAN JOSE DIRIDON STATION APPROACH	SANTA CLARA ST, PARK AVE	VIADUCT TO I-880	SAN JOSE DIRIDON STATION	DETAILED SITE PLAN
BOOK 2B	60	AR-F0101	SAN JOSE DIRIDON STATION APPROACH	SANTA CLARA ST, PARK AVE	VIADUCT TO I-880	SAN JOSE DIRIDON STATION	CONCOURSE PLAN
BOOK 2B	61	AR-Y0101	SAN JOSE DIRIDON STATION APPROACH	SANTA CLARA ST, PARK AVE	VIADUCT TO I-880	SAN JOSE DIRIDON STATION	CROSS SECTION
BOOK 2B	62	AR-Y0102	SAN JOSE DIRIDON STATION APPROACH	SANTA CLARA ST, PARK AVE	VIADUCT TO I-880	SAN JOSE DIRIDON STATION	MASSING DIAGRAM
BOOK 2B	63	AR-Y0103	SAN JOSE DIRIDON STATION APPROACH	SANTA CLARA ST, PARK AVE	VIADUCT TO I-880	SAN JOSE DIRIDON STATION	MASSING DIAGRAM
BOOK 2B	64	AR-Y0104	SAN JOSE DIRIDON STATION APPROACH	N/A	VIADUCT TO I-880	SAN JOSE DIRIDON STATION	FACILITY SIZING TABLE
BOOK 2B	65	AR-Y0105	SAN JOSE DIRIDON STATION APPROACH	N/A	VIADUCT TO I-880	SAN JOSE DIRIDON STATION	FACILITY SIZING TABLE
BOOK 2B	66	AR-Y0106	SAN JOSE DIRIDON STATION APPROACH	N/A	VIADUCT TO I-880	SAN JOSE DIRIDON STATION	FACILITY SIZING TABLE
BOOK 2B	67	AR-Y0107	SAN JOSE DIRIDON STATION APPROACH	N/A	VIADUCT TO I-880	SAN JOSE DIRIDON STATION	FACILITY SIZING TABLE
BOOK 2B	68	AR-C1001	MORGAN HILL AND GILROY	W 7TH ST TO E 10TH ST	EMBANKMENT TO DOWNTOWN GILROY	DOWNTOWN GILROY STATION	GENERAL SITE PLAN
BOOK 2B	69	AR-C1002	MORGAN HILL AND GILROY	W 7TH ST TO E 10TH ST	EMBANKMENT TO DOWNTOWN GILROY	DOWNTOWN GILROY STATION	DETAILED SITE PLAN
BOOK 2B	70	AR-F1001	MORGAN HILL AND GILROY	N/A	EMBANKMENT TO DOWNTOWN GILROY	DOWNTOWN GILROY STATION	CONCOURSE PLAN
BOOK 2B	71	AR-Y1001	MORGAN HILL AND GILROY	N/A	EMBANKMENT TO DOWNTOWN GILROY	DOWNTOWN GILROY STATION	SECTION
BOOK 2B	72	AR-Y1002	MORGAN HILL AND GILROY	W 7TH ST TO E 10TH ST	EMBANKMENT TO DOWNTOWN GILROY	DOWNTOWN GILROY STATION	MASSING DIAGRAM 1
BOOK 2B	73	AR-Y1003	MORGAN HILL AND GILROY	W 7TH ST TO E 10TH ST	EMBANKMENT TO DOWNTOWN GILROY	DOWNTOWN GILROY STATION	MASSING DIAGRAM 2
BOOK 2B	74	AR-Y1004	MORGAN HILL AND GILROY	N/A	EMBANKMENT TO DOWNTOWN GILROY	DOWNTOWN GILROY STATION	FACILITY SIZING TABLE
BOOK 2B	75	AR-Y1005	MORGAN HILL AND GILROY	N/A	EMBANKMENT TO DOWNTOWN GILROY	DOWNTOWN GILROY STATION	FACILITY SIZING TABLE
BOOK 2B	76	AR-Y1006	MORGAN HILL AND GILROY	N/A	EMBANKMENT TO DOWNTOWN GILROY	DOWNTOWN GILROY STATION	FACILITY SIZING TABLE
воок 2в	77	AR-Y1007	MORGAN HILL AND GILROY	N/A	EMBANKMENT TO DOWNTOWN GILROY	DOWNTOWN GILROY STATION	FACILITY SIZING TABLE
RUCTURI	ES						
BOOK 2B	78	ST-V0251	SAN JOSE DIRIDON STATION APPROACH	LAFAYETTE ST	VIADUCT TO SCOTT BLVD	COMPLEX STRUCTURES	GENERAL PLAN 1 OF 5
BOOK 2B	79	ST-V0252	SAN JOSE DIRIDON STATION APPROACH	DE LA CRUZ BLVD	VIADUCT TO SCOTT BLVD	COMPLEX STRUCTURES	GENERAL PLAN 2 OF 5
BOOK 2B	80	ST-V0253	SAN JOSE DIRIDON STATION APPROACH	ENTON ST, I 880	VIADUCT TO SCOTT BLVD	COMPLEX STRUCTURES	GENERAL PLAN 3 OF 5
BOOK 2B	81	ST-V0254	SAN JOSE DIRIDON STATION APPROACH	W TAYLOR ST	VIADUCT TO SCOTT BLVD	COMPLEX STRUCTURES	GENERAL PLAN 4 OF 5
BOOK 2B	82	ST-V0255	SAN JOSE DIRIDON STATION APPROACH	W SANTA CLARA ST	VIADUCT TO SCOTT BLVD	COMPLEX STRUCTURES	GENERAL PLAN 5 OF 5
BOOK 2B	83	ST-T0251	SAN JOSE DIRIDON STATION APPROACH	DE LA CRUZ BLVD	VIADUCT TO SCOTT BLVD	OVERPASSES AND UNDERPASSES	DE LA CRUZ BLVD
воок 2в	84	ST-T0252	SAN JOSE DIRIDON STATION APPROACH	STOCKTON AVE, UPRR	VIADUCT TO SCOTT BLVD	OVERPASSES AND UNDERPASSES	WEST HEDDING STREET
воок 2в	85	ST-T0401	MONTEREY CORRIDOR	ALMADEN EXPY, CURTNER AVE	VIADUCT/AT-GRADE	OVERPASSES AND UNDERPASSES	GENERAL PLAN
воок 2в	86	ST-V0501	MONTEREY CORRIDOR	ST HWY 82	AT-GRADE	COMPLEX STRUCTURES	GENERAL PLAN
BOOK 2B	87	ST-T0501	MONTEREY CORRIDOR	SKYWAY DR, CHYNOWETH AVE	AT-GRADE	UNDERPASSES	GENERAL PLAN
воок 2в	88	ST-T0502	MONTEREY CORRIDOR	CAPITOL EXPY, BLOSSOM HILL RD	AT-GRADE	MODIFY EXISTING BRIDGES	GENERAL PLAN 1 OF 2
воок 2в	89	ST-T0503	MONTEREY CORRIDOR	SR 85, BAILEY AVE	AT-GRADE	MODIFY EXISTING BRIDGES	GENERAL PLAN 2 OF 2
BOOK 2B	90	ST-T0801	MORGAN HILL AND GILROY	MADRONE PKWY, DUNNE AVE	EMBANKMENT TO DOWNTOWN GILROY	UNDERPASSES	GENERAL PLAN 1 OF 2
BOOK 2B	91	ST-T0802	MORGAN HILL AND GILROY	SAN PEDRO AVE, SAN MARTIN AVE	EMBANKMENT TO DOWNTOWN GILROY	UNDERPASSES	GENERAL PLAN 2 OF 2
ВООК 2В	92	ST-T1001	MORGAN HILL AND GILROY	MASTEN AVE, LAS ANIMAS AVE	EMBANKMENT TO DOWNTOWN GILROY	UNDERPASSES	GENERAL PLAN 1 OF 3
BOOK 2B	93	ST-T1002	MORGAN HILL AND GILROY	LEAVESLEY RD, CASEY LN	EMBANKMENT TO DOWNTOWN GILROY	UNDERPASSES	GENERAL PLAN 2 OF 3
BOOK 2B	94	ST-T1003	MORGAN HILL AND GILROY	OLD GILROY ST, E 10TH ST	EMBANKMENT TO DOWNTOWN GILROY	UNDERPASSES	GENERAL PLAN 3 OF 3
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RECORD PEPD SUBMITTAL MAY 3, 2019 NOT FOR

CONSTRUCTION



GEOGRAPHIC LOCATION

N/A

GRADE SEPARATIONS

ENTIRE ALTERNATIVE

ENTIRE ALTERNATIVE

COLEMAN AVE, DE LA CRUZ BLVD

DE LA CRUZ BLVD

STOCKTON AVE, ELM ST

WILLOW ST, W ALMA AVE

CURTNER AVE

SKYWAY DR

SKYWAY DR

BRANHAM LN

CHYNOWETH AVE

BLOSSOM HILL RD, BRANHAM LN

BAILEY AVE, COCHRANE RD

SAN MARTIN AVE, BLANCHARD RD

COX AVE, E LUCHESSA AVE

PALM AVE

LIVE OAK AVE

MADRONE PKWY

MAIN AVE, SAN PEDRO AVE

TENNANT AVE, BUTTERFIELD BLVD

E MIDDLE AVE

E MIDDLE AVE

W SAN MARTIN AVE

CHURCH AVE, MASTEN AVE

MASTEN AVE

MASTEN AVE, RUCKER AVE

COHANSEY AVE

LEAVESLEY RD, OLD GILROY ST

E 9TH ST, E 10TH ST

US 101, MAYOCK RD

ALIGNMENT OR FEATURE

SAN JOSE TO CENTRAL VALLEY WYE

INDEX OF DRAWING

KEY MAP

KEY MAP

VIADUCT TO SCOTT BLVD

VIADUCT TO SCOTT BLVD

VIADUCT TO SCOTT BLVD

VIADUCT/AT-GRADE

VIADUCT/AT-GRADE

AT-GRADE

AT-GRADE

AT-GRADE

AT-GRADE

AT-GRADE

EMBANKMENT TO DOWNTOWN GILROY

EMBANKMENT TO DOWNTOWN GILROY

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EMBANKMENT TO DOWNTOWN GILROY

EMBANKMENT TO DOWNTOWN GILROY

SHEET DESCRIPTION

ALTERNATIVE 2

SHEET 4 OF 8

COMPOSITE PLAN

SYSTEMS SITES

PLAN, PROFILE AND TYPICAL SECTIONS - SHEET 1 OF 2

PLAN, PROFILE AND TYPICAL SECTIONS - SHEET 2 OF 2

PLAN, PROFILE AND TYPICAL SECTIONS

GRADE SEPARATION LAYOUT, PROFILE, & CROSS SECTIONS

CIVIL DETAILS

CIVIL DETAILS

CIVIL DETAILS

GRADE SEPARATION LAYOUT, PROFILE, & CROSS SECTIONS





SAN JOSE TO CVY EIR/S: VOLUME III **GENERAL INFORMATION BOOK SHEET 16 OF 64**

ADDITIONAL DESCRIPTION

EMABNKMENT TO DOWNTOWN GILROY

DE LA CRUZ AVENUE

DE LA CRUZ AVENUE

WEST HEDDING STREET

SR87 ON-RAMP

ALMADEN ROAD AND CURTNER AVENUE

SKYWAY DRIVE - DESIGN VARIANT A

SKYWAY DRIVE - DESIGN VARIANT B

BRANHAM LANE

CHYNOWETH AVE

PED PATH - MULTIPLE LOCATIONS

PALM AVE

LIVE OAK AVE

MADRONE PARKWAY

MAIN AVE, DUNNE AVE, AND SAN PEDRO AVE

TENNANT AVE AND RAILROAD AVE

EAST MIDDLE AVE

MONTEREY ROAD PAST EAST MIDDLE AVE

SAN MARTIN AVE

CHURCH AVE

MASTEN AVE

MONTEREY ROAD AND RUCKER AVE

BUENA VISTA

COHANSEY AVENUE LEAVESLY RD TO OLD GILROY

9TH ST AND 10TH ST

US 101

CALIFORNIA HIGH-SPEED TRAIN PROJECT SAN JOSE TO MERCED

ALTERNATIVE 2 INDEX OF DRAWING SHEET 4 OF 8

CONTRACT NO.
HSR15-34
DRAWING NO.
GE-A0204
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ALTERNATIVE 2 - EMBANKMENT TO DOWNTOWN GILROY

SHEET NO

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SAN JOSE DIRIDON STATION APPROACH

COVER, INDEX OF DRAWING AND KEY MAPS

BOOK

BOOK 2C

BOOK 2C

BOOK 2C

BOOK 2C

ROADWAY

BOOK 2C

MONTEREY CORRIDOR

MORGAN HILL AND GILROY

DRAWING NO

COVER

GE-A0204

GE-D0201

GE-D0202

CV-T0251

CV-T0252

CV-T0253

CV-T0401

CV-T0402

CV-T0501

CV-T0502

CV-T0503

CV-T0504

CV-T0505

CV-S0801

CV-S0802

CV-S1001

CV-T0803

CV-T0804

CV-T0805

CV-T0806

CV-T0807

CV-T0808

CV-T0809

CV-T0810

CV-T1001

CV-T1002

CV-T1003

CV-T1004

CV-T1005

CV-T1006

CV-T1007

CV-T1008

SUBSECTION

SAN JOSE TO MERCED SECTION

ENTIRE ALTERNATIVE

GENERAL

GENERAL

SAN JOSE DIRIDON STATION APPROACH

SAN JOSE DIRIDON STATION APPROACH

SAN JOSE DIRIDON STATION APPROACH

MONTEREY CORRIDOR

MONTEREY CORRIDOR

MONTEREY CORRIDOR

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MONTEREY CORRIDOR

MONTEREY CORRIDOR

MORGAN HILL AND GILROY

1111 Broadway 9th Floor Oakland, CA 94607

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ВООК	SHEET NO	DRAWING NO	SUBSECTION	GEOGRAPHIC LOCATION	ALIGNMENT OR FEATURE	SHEET DESCRIPTION	ADDITIONAL DESCRIPTION
BOOK 2D	А	COVER	SAN JOSE TO MERCED SECTION	N/A	SAN JOSE TO CENTRAL VALLEY WYE	ALTERNATIVE 2	EMABNKMENT TO DOWNTOWN GILROY
BOOK 2D	В	GE-A0205	ENTIRE ALTERNATIVE	GRADE SEPARATIONS, MAINTENANCE OF WAY, TUNNELS	INDEX OF DRAWING	SHEET 5 OF 8	
BOOK 2D	С	GE-D0201	GENERAL	ENTIRE ALTERNATIVE	KEY MAP	COMPOSITE PLAN	
BOOK 2D	D	GE-D0202	GENERAL	ENTIRE ALTERNATIVE	KEY MAP	SYSTEMS SITES	
DADWAY							
DADWAY-PAG	CHECO PASS						
BOOK 2D	126	CV-S1401	PACHECO PASS	ROMERO RD, CA-152	TUNNEL	CIVIL DETAILS	
DADWAY - SA	N JOAQUIN VAL	LEY					
BOOK 2D	127	CV-S1601	SAN JOAQUIN VALLEY	MONTEREY RD, INGOMAR GRADE	HENRY MILLER ROAD	CIVIL DETAILS	
BOOK 2D	128	CV-T1603	SAN JOAQUIN VALLEY	VOLTA RD AT HENRY MILLER RD	HENRY MILLER ROAD	GRADE SEPARATION LAYOUT, PROFILE, & CROSS SECTIONS	HENRY MILLER ROAD
BOOK 2D	129	CV-T1604	SAN JOAQUIN VALLEY	HENRY MILLER ACCESS	HENRY MILLER ROAD	GRADE SEPARATION LAYOUT, PROFILE, & CROSS SECTIONS	HENRY MILLER ACCESS
BOOK 2D	130	CV-T1606	SAN JOAQUIN VALLEY	HENRY MILLER RD AT MERCEY SPRINGS RD	HENRY MILLER ROAD	GRADE SEPARATION LAYOUT, PROFILE, & CROSS SECTIONS	MERCEY SPRINGS ROAD
BOOK 2D	131	CV-T1609	SAN JOAQUIN VALLEY	DELTA RD	HENRY MILLER ROAD	GRADE SEPARATION LAYOUT, PROFILE, & CROSS SECTIONS	DELTA ROAD
BOOK 2D	132	CV-T1610	SAN JOAQUIN VALLEY	TURNER ISLAND RD AT HENRY MILLER RD	HENRY MILLER ROAD	GRADE SEPARATION LAYOUT, PROFILE, & CROSS SECTIONS	TURNER ROAD
BOOK 2D	133	CV-T1611	SAN JOAQUIN VALLEY	CARLUCCI RD	HENRY MILLER ROAD	GRADE SEPARATION LAYOUT, PROFILE, & CROSS SECTIONS	CARLUCCI ROAD
BOOK 2D	134	CV-T1612	SAN JOAQUIN VALLEY	HUTCHINS RD	HENRY MILLER ROAD	GRADE SEPARATION LAYOUT, PROFILE, & CROSS SECTIONS	HUTCHINS ROAD
1AINTENA	NCE OF WAY	1					
BOOK 2D	135	MY-B1007	MORGAN HILL AND GILROY	N/A	EMBANKMENT TO DOWNTOWN GILROY	MAINTENANCE OF WAY FACILITY	TYPICAL SECTIONS
BOOK 2D	136	MY-B1008	MORGAN HILL AND GILROY	N/A	EMBANKMENT TO DOWNTOWN GILROY	MAINTENANCE OF WAY FACILITY	UPRR PROFILE AND GEOMETRY FOR MOV
JNNELS -	PACHECO PA	SS		<u> </u>			
BOOK 2D	137	TN-D1404	PACHECO PASS	N/A	TUNNEL	TUNNEL 2 - PORTAL 1	
BOOK 2D	138	TN-D1405	PACHECO PASS	ACCESS RD 1	TUNNEL	TUNNEL PORTAL 2 ACCESS ROAD	
BOOK 2D	139	TN-D1406	PACHECO PASS	CALIFORNIA AQUEDUCT	TUNNEL	TUNNEL PORTAL 2 ACCESS ROAD	
BOOK 2D	140	TN-D1407	PACHECO PASS	ACCESS RD 2	TUNNEL	TUNNEL PORTAL 2 ACCESS ROAD	
BOOK 2D	141	TN-D1408	PACHECO PASS	N/A	TUNNEL	LONGITUDINAL PROFILE	
BOOK 2D	142	TN-D1409	PACHECO PASS	N/A	TUNNEL	GRADING DETAIL	
BOOK 2D	143	TN-D1410	PACHECO PASS	N/A	TUNNEL	GRADING DETAIL	
BOOK 2D	144	TN-D1411	PACHECO PASS	N/A	TUNNEL	GRADING DETAIL	
BOOK 2D	145	TN-D1412	PACHECO PASS	N/A	TUNNEL	GRADING DETAIL	
BOOK 2D	146	TN-D1413	PACHECO PASS	I-5, FAHEY RD	TUNNEL	GRADING DETAIL	
BOOK 2D	147	TN-D1414	PACHECO PASS	N/A	TUNNEL	TUNNEL 2 - PORTAL 1	SECTIONS
D001/05	148	TN-D1415	PACHECO PASS	N/A	TUNNEL	TUNNEL 2 - PORTAL 2	APPROACH 1
BOOK 2D	140	111 01413	17(6)1260 17(33	14//1	TOTATEL	10111122 10111122	711110710111

SAN JOSE TO CVY EIR/S: VOLUME III GENERAL INFORMATION BOOK **SHEET 17 OF 64**

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RECORD PEPD SUBMITTAL MAY 3, 2019 NOT FOR CONSTRUCTION







CALIFORNIA HIGH-SPEED TRAIN PROJECT **SAN JOSE TO MERCED**


ALTERNATIVE 2 INDEX OF DRAWING SHEET 5 OF 8

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ВООК	SHEET NO	DRAWING NO	SUBSECTION	GEOGRAPHIC LOCATION	ALIGNMENT OR FEATURE	SHEET DESCRIPTION	ADDITIONAL DESCRIPTION
OVER, IND	EX OF DRAW	ING AND KEY I	MAPS				
BOOK 2E	А	COVER	SAN JOSE TO MERCED SECTION	N/A	SAN JOSE TO CENTRAL VALLEY WYE	ALTERNATIVE 2	EMABNKMENT TO DOWNTOWN GILROY
BOOK 2E	В	GE-A0206	ENTIRE ALTERNATIVE	CONSTRUCTION STAGING	INDEX OF DRAWING	SHEET 6 OF 8	
BOOK 2E	С	GE-A0207	ENTIRE ALTERNATIVE	CONSTRUCTION STAGING	INDEX OF DRAWING	SHEET 7 OF 8	
BOOK 2E	D	GE-A0208	ENTIRE ALTERNATIVE	ALIGNMENT DATA TABLES	INDEX OF DRAWING	SHEET 8 OF 8	
BOOK 2E	Е	GE-D0201	GENERAL	ENTIRE ALTERNATIVE	KEY MAP	COMPOSITE PLAN	
BOOK 2E	F	GE-D0202	GENERAL	ENTIRE ALTERNATIVE	KEY MAP	SYSTEMS SITES	
ONSTRUC [*]	TION STAGIN	G					
BOOK 2E	150	CV-I0501	MONTEREY CORRIDOR	CAPITOL EXPY	AT-GRADE	CONSTRUCTION STAGING-PHASE 1	MODIFY EXISTING CAPITOL EXPRESSWAY OVERHEAD
BOOK 2E	151	CV-I0502	MONTEREY CORRIDOR	CAPITOL EXPY	AT-GRADE	CONSTRUCTION STAGING-PHASE 2	MODIFY EXISTING CAPITOL EXPRESSWAY OVERHEAD
BOOK 2E	152	CV-I0503	MONTEREY CORRIDOR	CAPITOL EXPY	AT-GRADE	CONSTRUCTION STAGING-PHASE 3	MODIFY EXISTING CAPITOL EXPRESSWAY OVERHEAD
BOOK 2E	153	CV-I0504	MONTEREY CORRIDOR	SKYWAY DR	AT-GRADE	CONSTRUCTION STAGING-PHASE 1	SKYWAY DRIVE UNDERCROSSING
BOOK 2E	154	CV-I0505	MONTEREY CORRIDOR	SKYWAY DR	AT-GRADE	CONSTRUCTION STAGING-PHASE 2 & 3	SKYWAY DRIVE UNDERCROSSING
BOOK 2E	155	CV-I0506	MONTEREY CORRIDOR	BRANHAM LN	AT-GRADE	CONSTRUCTION STAGING-PHASE 1	BRANHAM LANE UNDERCROSSING
BOOK 2E	156	CV-I0507	MONTEREY CORRIDOR	BRANHAM LN	AT-GRADE	CONSTRUCTION STAGING-PHASE 2 & 3	BRANHAM LANE UNDERCROSSING
BOOK 2E	157	CV-I0508	MONTEREY CORRIDOR	CHYNOWETH AVE	AT-GRADE	CONSTRUCTION STAGING-PHASE 1	CHYNOWETH AVENUE UNDERCROSSING
BOOK 2E	158	CV-I0509	MONTEREY CORRIDOR	CHYNOWETH AVE	AT-GRADE	CONSTRUCTION STAGING-PHASE 2 & 3	CHYNOWETH AVENUE UNDERCROSSING
BOOK 2E	159	CV-I0801	MORGAN HILL AND GILROY	MAIN AVE, BUTTERFIELD BLVD	EMBANKMENT TO DOWNTOWN GILROY	CONSTRUCTION STAGING PLAN-PHASE 1-STAGE 1	DOWNTOWN MORGAN HILL
BOOK 2E	160	CV-I0802	MORGAN HILL AND GILROY	MAIN AVE, BUTTERFIELD BLVD	EMBANKMENT TO DOWNTOWN GILROY	CONSTRUCTION STAGING PLAN-PHASE 1-STAGE 2	DOWNTOWN MORGAN HILL
BOOK 2E	161	CV-I0803	MORGAN HILL AND GILROY	MAIN AVE, BUTTERFIELD BLVD	EMBANKMENT TO DOWNTOWN GILROY	CONSTRUCTION STAGING PLAN-PHASE 2-STAGE 1	DOWNTOWN MORGAN HILL
BOOK 2E	162	CV-I0804	MORGAN HILL AND GILROY	MAIN AVE, BUTTERFIELD BLVD	EMBANKMENT TO DOWNTOWN GILROY	CONSTRUCTION STAGING PLAN-PHASE 2-STAGE 2	DOWNTOWN MORGAN HILL
BOOK 2E	163	CV-I0805	MORGAN HILL AND GILROY	MAIN AVE, BUTTERFIELD BLVD	EMBANKMENT TO DOWNTOWN GILROY	CONSTRUCTION STAGING PLAN-PHASE 3-STAGE 1	DOWNTOWN MORGAN HILL
BOOK 2E	164	CV-I0806	MORGAN HILL AND GILROY	MAIN AVE, BUTTERFIELD BLVD	EMBANKMENT TO DOWNTOWN GILROY	CONSTRUCTION STAGING PLAN-PHASE 3-STAGE 2	DOWNTOWN MORGAN HILL
BOOK 2E	165	CV-I0807	MORGAN HILL AND GILROY	MAIN AVE, BUTTERFIELD BLVD	EMBANKMENT TO DOWNTOWN GILROY	CONSTRUCTION STAGING PLAN-PHASE 3-STAGE 3	DOWNTOWN MORGAN HILL
BOOK 2E	166	CV-I0808	MORGAN HILL AND GILROY	MAIN AVE, BUTTERFIELD BLVD	EMBANKMENT TO DOWNTOWN GILROY	CONSTRUCTION STAGING PLAN-PHASE 4-STAGE 1	DOWNTOWN MORGAN HILL
BOOK 2E	167	CV-I0809	MORGAN HILL AND GILROY	MAIN AVE, BUTTERFIELD BLVD	EMBANKMENT TO DOWNTOWN GILROY	CONSTRUCTION STAGING PLAN-PHASE 4-STAGE 2	DOWNTOWN MORGAN HILL
BOOK 2E	168	CV-I0810	MORGAN HILL AND GILROY	MAIN AVE, BUTTERFIELD BLVD	EMBANKMENT TO DOWNTOWN GILROY	CONSTRUCTION STAGING PLAN-PHASE 4-STAGE 3	DOWNTOWN MORGAN HILL
BOOK 2E	169	CV-I0811	MORGAN HILL AND GILROY	MAIN AVE, BUTTERFIELD BLVD	EMBANKMENT TO DOWNTOWN GILROY	CONSTRUCTION STAGING PLAN-PHASE 5-STAGE 1	DOWNTOWN MORGAN HILL
BOOK 2E	170	CV-I0812	MORGAN HILL AND GILROY	MAIN AVE, BUTTERFIELD BLVD	EMBANKMENT TO DOWNTOWN GILROY	CONSTRUCTION STAGING PLAN-PHASE 5-STAGE 2	DOWNTOWN MORGAN HILL
BOOK 2E	171	CV-I0813	MORGAN HILL AND GILROY	MAIN AVE, BUTTERFIELD BLVD	EMBANKMENT TO DOWNTOWN GILROY	CONSTRUCTION STAGING PLAN-PHASE 5-STAGE 3	DOWNTOWN MORGAN HILL
BOOK 2E	172	CV-I0814	MORGAN HILL AND GILROY	MAIN AVE, BUTTERFIELD BLVD	EMBANKMENT TO DOWNTOWN GILROY	CONSTRUCTION STAGING PLAN-PHASE 6	DOWNTOWN MORGAN HILL
BOOK 2E	173	CV-I0815	MORGAN HILL AND GILROY	MIDDLE AVE	EMBANKMENT TO DOWNTOWN GILROY	CONSTRUCTION STAGING PLAN-PHASE 1-STAGE 1	MIDDLE AVENUE GRADE SEPARATION
BOOK 2E	174	CV-I0816	MORGAN HILL AND GILROY	MIDDLE AVE	EMBANKMENT TO DOWNTOWN GILROY	CONSTRUCTION STAGING PLAN-PHASE 1-STAGE 2	MIDDLE AVENUE GRADE SEPARATION
BOOK 2E	175	CV-I0817	MORGAN HILL AND GILROY	MIDDLE AVE	EMBANKMENT TO DOWNTOWN GILROY	CONSTRUCTION STAGING PLAN-PHASE 2-STAGE 1	MIDDLE AVENUE GRADE SEPARATION
BOOK 2E	176	CV-I0818	MORGAN HILL AND GILROY	MIDDLE AVE	EMBANKMENT TO DOWNTOWN GILROY	CONSTRUCTION STAGING PLAN-PHASE 2-STAGE 2	MIDDLE AVENUE GRADE SEPARATION

SAN JOSE TO CVY EIR/S: VOLUME III GENERAL INFORMATION BOOK SHEET 18 OF 64



RECORD PEPD SUBMITTAL MAY 3, 2019 NOT FOR

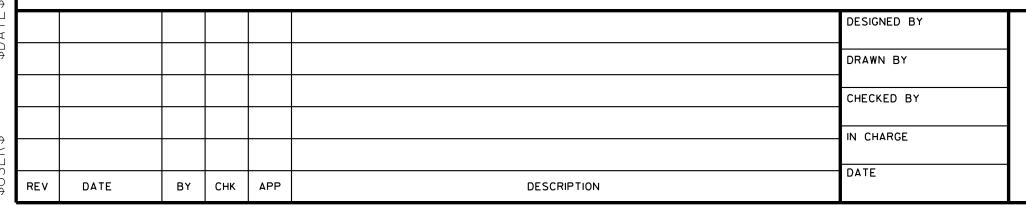CONSTRUCTION







CALIFORNIA HIGH-SPEED TRAIN PROJECT **SAN JOSE TO MERCED**


ALTERNATIVE 2 INDEX OF DRAWING SHEET 6 OF 8

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BOOK 2E	177	CV-I0819	MORGAN HILL AND GILROY	SAN MARTIN AVE	EMBANKMENT TO DOWNTOWN GILROY	CONSTRUCTION STAGING PLAN-PHASE 1-STAGE 1	SAN MARTIN AVENUE GRADE SEPARATION
BOOK 2E	178	CV-I0820	MORGAN HILL AND GILROY	SAN MARTIN AVE	EMBANKMENT TO DOWNTOWN GILROY	CONSTRUCTION STAGING PLAN-PHASE 1-STAGE 2	SAN MARTIN AVENUE GRADE SEPARATION
BOOK 2E	179	CV-I0821	MORGAN HILL AND GILROY	SAN MARTIN AVE	EMBANKMENT TO DOWNTOWN GILROY	CONSTRUCTION STAGING PLAN-PHASE 2-STAGE 1	SAN MARTIN AVENUE GRADE SEPARATION
OOK 2E	180	CV-I0822	MORGAN HILL AND GILROY	SAN MARTIN AVE	EMBANKMENT TO DOWNTOWN GILROY	CONSTRUCTION STAGING PLAN-PHASE 2-STAGE 2	SAN MARTIN AVENUE GRADE SEPARATION
OOK 2E	181	CV-I1012	MORGAN HILL AND GILROY	CHURCH AVE	EMBANKMENT TO DOWNTOWN GILROY	CONSTRUCTION STAGING PLAN-PHASE 1-STAGE 1	CHURCH AVENUE GRADE SEPARATION
OOK 2E	182	CV-I1013	MORGAN HILL AND GILROY	CHURCH AVE	EMBANKMENT TO DOWNTOWN GILROY	CONSTRUCTION STAGING PLAN-PHASE 1-STAGE 2	CHURCH AVENUE GRADE SEPARATION
OOK 2E	183	CV-I1014	MORGAN HILL AND GILROY	CHURCH AVE	EMBANKMENT TO DOWNTOWN GILROY	CONSTRUCTION STAGING PLAN-PHASE 2-STAGE 1	CHURCH AVENUE GRADE SEPARATION
OOK 2E	184	CV-I1015	MORGAN HILL AND GILROY	CHURCH AVE	EMBANKMENT TO DOWNTOWN GILROY	CONSTRUCTION STAGING PLAN-PHASE 2-STAGE 2	CHURCH AVENUE GRADE SEPARATION
OOK 2E	185	CV-I1016	MORGAN HILL AND GILROY	MASTEN AVE	EMBANKMENT TO DOWNTOWN GILROY	CONSTRUCTION STAGING PLAN-PHASE 1-STAGE 1	MASTEN AVENUE GRADE SEPARATION
OOK 2E	186	CV-I1017	MORGAN HILL AND GILROY	MASTEN AVE	EMBANKMENT TO DOWNTOWN GILROY	CONSTRUCTION STAGING PLAN-PHASE 1-STAGE 2	MASTEN AVENUE GRADE SEPARATION
OOK 2E	187	CV-I1018	MORGAN HILL AND GILROY	MASTEN AVE	EMBANKMENT TO DOWNTOWN GILROY	CONSTRUCTION STAGING PLAN-PHASE 2-STAGE 1	MASTEN AVENUE GRADE SEPARATION
OOK 2E	188	CV-I1019	MORGAN HILL AND GILROY	MASTEN AVE	EMBANKMENT TO DOWNTOWN GILROY	CONSTRUCTION STAGING PLAN-PHASE 2-STAGE 2	MASTEN AVENUE GRADE SEPARATION
OOK 2E	189	CV-I1020	MORGAN HILL AND GILROY	MASTEN AVE	EMBANKMENT TO DOWNTOWN GILROY	CONSTRUCTION STAGING PLAN-PHASE 3-STAGE 1	MASTEN AVENUE GRADE SEPARATION
OK 2E	190	CV-I1021	MORGAN HILL AND GILROY	MASTEN AVE	EMBANKMENT TO DOWNTOWN GILROY	CONSTRUCTION STAGING PLAN-PHASE 3-STAGE 2	MASTEN AVENUE GRADE SEPARATION
OK 2E	191	CV-I1022	MORGAN HILL AND GILROY	RUCKER AVE	EMBANKMENT TO DOWNTOWN GILROY	CONSTRUCTION STAGING PLAN-PHASE 1-STAGE 1	RUCKER AVENUE GRADE SEPARATION
OOK 2E	192	CV-I1023	MORGAN HILL AND GILROY	RUCKER AVE	EMBANKMENT TO DOWNTOWN GILROY	CONSTRUCTION STAGING PLAN-PHASE 1-STAGE 2	RUCKER AVENUE GRADE SEPARATION
OOK 2E	193	CV-I1024	MORGAN HILL AND GILROY	RUCKER AVE	EMBANKMENT TO DOWNTOWN GILROY	CONSTRUCTION STAGING PLAN-PHASE 2-STAGE 1	RUCKER AVENUE GRADE SEPARATION
OOK 2E	194	CV-I1024	MORGAN HILL AND GILROY	RUCKER AVE	EMBANKMENT TO DOWNTOWN GILROY	CONSTRUCTION STAGING PLAN-PHASE 2-STAGE 2	RUCKER AVENUE GRADE SEPARATION
OOK 2E	195	CV-I1025	MORGAN HILL AND GILROY	RUCKER AVE	EMBANKMENT TO DOWNTOWN GILROY	CONSTRUCTION STAGING PLAN-PHASE 3	RUCKER AVENUE GRADE SEPARATION
OOK 2E	196	CV-I1020	MORGAN HILL AND GILROY	BUENA VISTA AVE	EMBANKMENT TO DOWNTOWN GILROY	CONSTRUCTION STAGING PLAN-PHASE 1-STAGE 1	BUENA VISTA AVENUE GRADE SEPARATION
OK 2E	197	CV-I1028	MORGAN HILL AND GILROY	BUENA VISTA AVE	EMBANKMENT TO DOWNTOWN GILROY	CONSTRUCTION STAGING PLAN-PHASE 1-STAGE 2	BUENA VISTA AVENUE GRADE SEPARATION
OK 2E	198	CV-I1029	MORGAN HILL AND GILROY	BUENA VISTA AVE	EMBANKMENT TO DOWNTOWN GILROY	CONSTRUCTION STAGING PLAN-PHASE 2-STAGE 1	BUENA VISTA AVENUE GRADE SEPARATION
OK 2E	199	CV-I1030	MORGAN HILL AND GILROY	BUENA VISTA AVE	EMBANKMENT TO DOWNTOWN GILROY	CONSTRUCTION STAGING PLAN-PHASE 2-STAGE 2	BUENA VISTA AVENUE GRADE SEPARATION
OOK 2E	200	CV-I1031	MORGAN HILL AND GILROY	BUENA VISTA AVE	EMBANKMENT TO DOWNTOWN GILROY	CONSTRUCTION STAGING PLAN-PHASE 3-STAGE 1	BUENA VISTA AVENUE GRADE SEPARATION
OOK 2E	201	CV-I1032	MORGAN HILL AND GILROY	BUENA VISTA AVE	EMBANKMENT TO DOWNTOWN GILROY	CONSTRUCTION STAGING PLAN-PHASE 3-STAGE 2	BUENA VISTA AVENUE GRADE SEPARATION
OOK 2E	202	CV-I1038	MORGAN HILL AND GILROY	LEAVESLEY RD, US 101	EMBANKMENT TO DOWNTOWN GILROY	CONSTRUCTION STAGING PLAN-PHASE 1-STAGE 1	DOWNTOWN GILROY
OOK 2E	203	CV-I1039	MORGAN HILL AND GILROY	LEAVESLEY RD, US 101	EMBANKMENT TO DOWNTOWN GILROY	CONSTRUCTION STAGING PLAN-PHASE 1-STAGE 2	DOWNTOWN GILROY
OK 2E	204	CV-I1040	MORGAN HILL AND GILROY	LEAVESLEY RD, US 101	EMBANKMENT TO DOWNTOWN GILROY	CONSTRUCTION STAGING PLAN-PHASE 1-STAGE 3	DOWNTOWN GILROY
OOK 2E	205	CV-I1041	MORGAN HILL AND GILROY	LEAVESLEY RD, US 101	EMBANKMENT TO DOWNTOWN GILROY	CONSTRUCTION STAGING PLAN-PHASE 1-STAGE 4	DOWNTOWN GILROY
OK 2E	206	CV-I1042	MORGAN HILL AND GILROY	LEAVESLEY RD, US 101	EMBANKMENT TO DOWNTOWN GILROY	CONSTRUCTION STAGING PLAN-PHASE 2-STAGE 1	DOWNTOWN GILROY
OK 2E	207	CV-I1043	MORGAN HILL AND GILROY	LEAVESLEY RD, US 101	EMBANKMENT TO DOWNTOWN GILROY	CONSTRUCTION STAGING PLAN-PHASE 2-STAGE 2	DOWNTOWN GILROY
OK 2E	208	CV-I1044	MORGAN HILL AND GILROY	LEAVESLEY RD, US 101	EMBANKMENT TO DOWNTOWN GILROY	CONSTRUCTION STAGING PLAN-PHASE 3-STAGE 1	DOWNTOWN GILROY
OK 2E	209	CV-I1045	MORGAN HILL AND GILROY	LEAVESLEY RD, US 101	EMBANKMENT TO DOWNTOWN GILROY	CONSTRUCTION STAGING PLAN-PHASE 3-STAGE 2	DOWNTOWN GILROY
OK 2E	210	CV-I1046	MORGAN HILL AND GILROY	LEAVESLEY RD, US 101	EMBANKMENT TO DOWNTOWN GILROY	CONSTRUCTION STAGING PLAN-PHASE 3-STAGE 3	DOWNTOWN GILROY
OK 2E	211	CV-I1047	MORGAN HILL AND GILROY	LEAVESLEY RD, US 101	EMBANKMENT TO DOWNTOWN GILROY	CONSTRUCTION STAGING PLAN-PHASE 3-STAGE 4	DOWNTOWN GILROY
OK 2E	212	CV-I1048	MORGAN HILL AND GILROY	LEAVESLEY RD, US 101	EMBANKMENT TO DOWNTOWN GILROY	CONSTRUCTION STAGING PLAN-PHASE 4-STAGE 1	DOWNTOWN GILROY
OK 2E	213	CV-I1049	MORGAN HILL AND GILROY	LEAVESLEY RD, US 101	EMBANKMENT TO DOWNTOWN GILROY	CONSTRUCTION STAGING PLAN-PHASE 4-STAGE 2	DOWNTOWN GILROY
OK 2E	214	CV-I1050	MORGAN HILL AND GILROY	LEAVESLEY RD, US 101	EMBANKMENT TO DOWNTOWN GILROY	CONSTRUCTION STAGING PLAN-PHASE 4-STAGE 3	DOWNTOWN GILROY
OK 2E	215	CV-I1051	MORGAN HILL AND GILROY	LEAVESLEY RD, US 101	EMBANKMENT TO DOWNTOWN GILROY	CONSTRUCTION STAGING PLAN-PHASE 4-STAGE 5	DOWNTOWN GILROY
OK 2E	216	CV-I1052	MORGAN HILL AND GILROY	LEAVESLEY RD, US 101	EMBANKMENT TO DOWNTOWN GILROY	CONSTRUCTION STAGING PLAN-PHASE 5-STAGE 1	DOWNTOWN GILROY
OK 2E	217	CV-I1601	SAN JOAQUIN VALLEY	N/A	HENRY MILLER ROAD	CONSTRUCTION STAGING PLAN	GENERAL NOTES
OK 2E	218	CV-I1602	SAN JOAQUIN VALLEY	INGOMAR GRADE RD AT HENRY MILLER RD	HENRY MILLER ROAD	CONSTRUCTION STAGING PLAN	HENRY MILLER ROAD GRADE SEPARATION
OK 2E	219	CV-I1603	SAN JOAQUIN VALLEY	HENRY MILLER RD	HENRY MILLER ROAD	CONSTRUCTION STAGING PLAN	HENRY MILLER ROAD GRADE SEPARATION
OK 2E	220	CV-I1604	SAN JOAQUIN VALLEY	HENRY MILLER RD AT MERCEY SPRINGS RD	HENRY MILLER ROAD	CONSTRUCTION STAGING PLAN	SR-165 / MERCEY SPRINGS ROAD GRADE SEPARA
OK 2E	221	CV-I1605	SAN JOAQUIN VALLEY	HENRY MILLER RD AT DELTA RD	HENRY MILLER ROAD	CONSTRUCTION STAGING PLAN	DELTA ROAD GRADE SEPARATION
OOK 2E	222	CV-I1606	SAN JOAQUIN VALLEY	HENRY MILLER RD AT TURNER ISLAND RD	HENRY MILLER ROAD	CONSTRUCTION STAGING PLAN	TURNER ISLAND ROAD GRADE SEPARATION
OOK 2E	223	CV-I1607	SAN JOAQUIN VALLEY	HENRY MILLER RD AT CARLUCCI RD	HENRY MILLER ROAD	CONSTRUCTION STAGING PLAN	CARLUCCI ROAD GRADE SEPARATION

SAN JOSE TO CVY EIR/S: VOLUME III GENERAL INFORMATION BOOK **SHEET 19 OF 64**



ALTERNATIVE 2 - EMBANKMENT TO DOWNTOWN GILROY

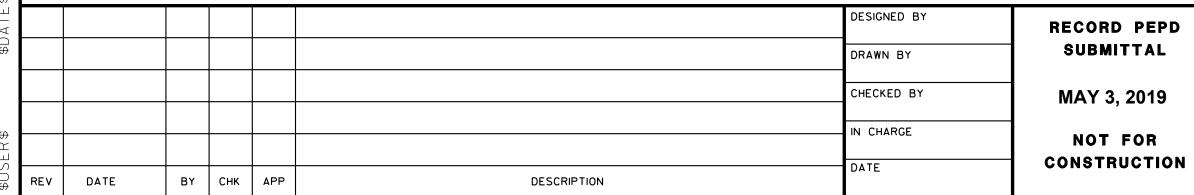RECORD PEPD SUBMITTAL **MAY 3, 2019** NOT FOR







CALIFORNIA HIGH-SPEED TRAIN PROJECT **SAN JOSE TO MERCED**

ALTERNATIVE 2 INDEX OF DRAWING SHEET 7 OF 8

1	CONTRACT NO. HSR15-34
	DRAWING NO. GE-A0207
	scale NONE
	SHEET NO.

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ALTERNATIVE 2 - EMBANKMENT TO DOWNTOWN GILROY

TRACK GUIDEWAY HORIZONTAL ALIGNMENT DATA TABLE

SHEET NO

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BOOK

BOOK 2E

DRAWING NO

TT-B0201-JM

TT-B0202-JM

TT-B0201

TT-B0202

TT-B0203

TT-B0204

TT-B0205

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TT-B0120

TT-B0121

TT-B0122

TT-B0123

TT-B0124

TT-B0125

TT-B0126

TT-B0127

TT-B0128

TT-B0129

TT-B0130

TT-B0131

TT-B0132

TT-B0133

TT-B0134

CV-B0101

CV-T0201

ROADWAY HORIZONTAL ALIGNMENT DATA TABLE

SUBSECTION

SAN JOSE DIRIDON STATION APPROACH

SAN JOSE DIRIDON STATION APPROACH

MORGAN HILL AND GILROY

MORGAN HILL AND GILROY

GILROY

GILROY

GILROY

GILROY

GILROY

DOWNTOWN GILROY

DOWNTOWN GILROY

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MORGAN HILL AND GILROY

MORGAN HILL AND GILROY

MORGAN HILL AND GILROY

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PACHECO PASS

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SAN JOAQUIN VALLEY

SAN JOAQUIN VALLEY

SAN JOAQUIN VALLEY

MORGAN HILL AND GILROY

MORGAN HILL AND GILROY

PACHECO PASS

PACHECO PASS

PACHECO PASS

MONTEREY CORRIDOR

MORGAN HILL AND GILROY

NTB

GEOGRAPHIC LOCATION

N/A

ALIGNMENT OR FEATURE

VIADUCT TO SCOTT BLVD

VIADUCT TO SCOTT BLVD

TRACK GUIDEWAY

VIADUCT

VIADUCT TO DOWNTOWN GILROY

SHEET DESCRIPTION

TRACK ALIGNMENT DATA TABLE

TRACK ALIGNMENT DATA TABLE

B2 TRACK ALIGNMENT DATA TABLE

B2 TRACK ALIGNMENT DATA TABLE

B2 TRACK ALIGNMENT DATA TABLE

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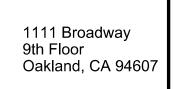
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SAN JOSE TO CVY EIR/S: VOLUME III **GENERAL INFORMATION BOOK SHEET 20 OF 64**

ADDITIONAL DESCRIPTION

CURVE NO. C183 AND C184

CURVE NO. C185 AND C186

CURVE NO. C301 AND C302

CURVE NO. C303 AND C304

CURVE NO. C305 AND C306

CURVE NO. C307 AND C308

CURVE NO. C309 AND C310

CURVE NO. C311 AND C312

CURVE NO. C313 AND C314

CURVE NO. C315 AND C316

CURVE NO. C317 AND C318

CURVE NO. C319 AND C320

CURVE NO. C321

CURVE NO. C127 AND C128

CURVE NO. C129

CURVE NO. C130

CURVE NO. C131

CURVE NO. C132 AND C133

CURVE NO. C134 AND C135

CURVE NO. C136

CURVE NO. C137

CURVE NO. C138 AND C139

CURVE NO. C140

CURVE NO. C230

CURVE NO. C231 AND C231A

CURVE NO. C232 AND C233

CURVE NO. C234 AND C235

CURVE NO. C236

CALIFORNIA HIGH-SPEED TRAIN PROJECT **SAN JOSE TO MERCED**

ALTERNATIVE 2 INDEX OF DRAWING SHEET 8 OF 8


CONTRACT NO. HSR15-34
DRAWING NO. GE-A0208
scale NONE
SHEET NO.

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ВООК	SHEET NO	DRAWING NO	SUBSECTION	GEOGRAPHIC LOCATION	ALIGNMENT OR FEATURE	SHEET DESCRIPTION	ADDITIONAL DESCRIPTION
COVER, IND	EX OF DRAV	VING AND KE	Y MAPS				
BOOK 3A	А	COVER	SAN JOSE TO MERCED SECTION	N/A	SAN JOSE TO CENTRAL VALLEY WYE	ALTERNATIVE 3	VIADUCT TO EAST GILROY
воок за	В	GE-A0301	SAN JOSE DIRIDON STATION APPROACH, MONTEREY CORRIDOR, MORGAN HILL AND GILROY	SCOTT BLVD TO PACHECO PASS HWY	INDEX OF DRAWING	SHEET 1 OF 7	
BOOK 3A	С	GE-D0301	GENERAL	ENTIRE ALTERNATIVE	KEY MAP	COMPOSITE PLAN	
BOOK 3A	D	GE-D0302	GENERAL	ENTIRE ALTERNATIVE	KEY MAP	SYSTEMS SITES	
COMPOSITE	PLANS						
AN JOSE DIRID	OON STATION AF	PPROACH					
воок за	1	TT-D0251	SAN JOSE DIRIDON STATION APPROACH	SCOTT BLVD TO BENTON ST	VIADUCT TO SCOTT BLVD	COMPOSITE PLAN, PROFILE AND TYPICAL SECTIONS	B2250+00 TO B2340+00
воок за	2	TT-D0252	SAN JOSE DIRIDON STATION APPROACH	NEWHALL ST TO W TAYLOR ST	VIADUCT TO SCOTT BLVD	COMPOSITE PLAN, PROFILE AND TYPICAL SECTIONS	B2340+00 TO B2430+00
BOOK 3A	3	TT-D0253	SAN JOSE DIRIDON STATION APPROACH	CINNABAR ST TO PARK AVE	VIADUCT TO SCOTT BLVD	COMPOSITE PLAN, PROFILE AND TYPICAL SECTIONS	B2430+00 TO B58+00
BOOK 3A	4	TT-D0301	SAN JOSE DIRIDON STATION APPROACH	PARK AVE TO WILLOW ST	VIADUCT TO I-880	COMPOSITE PLAN, PROFILE AND CROSS SECTIONS	B58+00 TO B125+00
ONTEREY COI	RRIDOR						
BOOK 3A	5	TT-D0401	MONTEREY CORRIDOR	WILLOW ST TO CURTNER AVE	VIADUCT/AT-GRADE	COMPOSITE PLAN, PROFILE AND CROSS SECTIONS	B125+00 TO B211+00
BOOK 3A	6	TT-D0601	MONTEREY CORRIDOR	COMMUNICATION HILL BLVD TO ESFAHAN CT	VIADUCT	COMPOSITE PLAN, PROFILE AND CROSS SECTIONS	B211+00 TO B285+00
BOOK 3A	7	TT-D0602	MONTEREY CORRIDOR	CAPITOL EXPY TO SKYWAY DR	VIADUCT	COMPOSITE PLAN, PROFILE AND CROSS SECTIONS	B285+00 TO B373+00
BOOK 3A	8	TT-D0603	MONTEREY CORRIDOR	BRANHAM LN TO BLOSSOM HILL RD	VIADUCT	COMPOSITE PLAN, PROFILE AND CROSS SECTIONS	B373+00 TO B462+00
BOOK 3A	9	TT-D0604	MONTEREY CORRIDOR	FORD RD	VIADUCT	COMPOSITE PLAN, PROFILE AND CROSS SECTIONS	B462+00 TO B552+00
ORGAN HILL	AND GILROY						
BOOK 3A	10	TT-D0701	MORGAN HILL AND GILROY	W VALLEY FREEWAY TO MENARD DR	VIADUCT TO DOWNTOWN GILROY	COMPOSITE PLAN, PROFILE AND CROSS SECTIONS	B552+00 TO B730+00
BOOK 3A	11	TT-D0702	MORGAN HILL AND GILROY	METCALF RD TO BLANCHARD RD	VIADUCT TO DOWNTOWN GILROY	COMPOSITE PLAN, PROFILE AND CROSS SECTIONS	B642+00 TO B732+00
BOOK 3A	12	TT-D0703	MORGAN HILL AND GILROY	BAILEY AVE TO RICHMOND AVE	VIADUCT TO DOWNTOWN GILROY	COMPOSITE PLAN, PROFILE AND CROSS SECTIONS	B732+00 TO B8220+00
BOOK 3A	13	TT-D0704	MORGAN HILL AND GILROY	OGIER AVE	VIADUCT TO DOWNTOWN GILROY	COMPOSITE PLAN, PROFILE AND CROSS SECTIONS	B822+00 TO B905+00
BOOK 3A	14	TT-D0705	MORGAN HILL AND GILROY	KIRBY AVE	VIADUCT TO DOWNTOWN GILROY	COMPOSITE PLAN, PROFILE AND CROSS SECTIONS	B905+00 TO B995+00
BOOK 3A	15	TT-D0706	MORGAN HILL AND GILROY	BURNETT AVE TO COCHRANE RD	VIADUCT TO DOWNTOWN GILROY	COMPOSITE PLAN, PROFILE AND CROSS SECTIONS	B995+00 TO B1085+00
BOOK 3A	16	TT-D0707	MORGAN HILL AND GILROY	E MAIN AVE TO BARRETT AVE	VIADUCT TO DOWNTOWN GILROY	COMPOSITE PLAN, PROFILE AND CROSS SECTIONS	B1085+00 TO B1175+00
BOOK 3A	17	TT-D0708	MORGAN HILL AND GILROY	TENNANT AVE TO E MIDDLE AVE	VIADUCT TO DOWNTOWN GILROY	COMPOSITE PLAN, PROFILE AND CROSS SECTIONS	B1175+00 TO B1265+00
BOOK 3A	18	TT-D1101	MORGAN HILL AND GILROY	E SAN MARTIN	VIADUCT TO EAST GILROY	COMPOSITE PLAN, PROFILE AND CROSS SECTIONS	B1265+00 TO B1425+00
BOOK 3A	19	TT-D1102	MORGAN HILL AND GILROY	CHURCH AVE	VIADUCT TO EAST GILROY	COMPOSITE PLAN, PROFILE AND CROSS SECTIONS	B1425+00 TO B1505+00
BOOK 3A	20	TT-D1103	MORGAN HILL AND GILROY	MASTEN AVE TO BUENA VISTA AVE	VIADUCT TO EAST GILROY	COMPOSITE PLAN, PROFILE AND CROSS SECTIONS	B1505+00 TO B1594+00
BOOK 3A	21	TT-D1104	MORGAN HILL AND GILROY	COHANSEY AVE TO LEAVESLEY RD	VIADUCT TO EAST GILROY	COMPOSITE PLAN, PROFILE AND CROSS SECTIONS	B1594+00 TO B1683+00
BOOK 3A	22	TT-D1105	MORGAN HILL AND GILROY	GILMAN RD TO HOLSCLAW RD	VIADUCT TO EAST GILROY	COMPOSITE PLAN, PROFILE AND CROSS SECTIONS	B1683+00 TO B1770+00
BOOK 3A	23	TT-D1106	MORGAN HILL AND GILROY	SR 152 TO JONES CREEK	VIADUCT TO EAST GILROY	COMPOSITE PLAN, PROFILE AND CROSS SECTIONS	B1770+00 TO B1859+00
BOOK 3A	24	TT-D1107	MORGAN HILL AND GILROY	N/A	VIADUCT TO EAST GILROY	UPRR FREIGHT TRACK PROFILE	
BOOK 3A	25	TT-D1301	MORGAN HILL AND GILROY	BLOOMFIELD AVE	VIADUCT TO EAST GILROY	COMPOSITE PLAN, PROFILE AND CROSS SECTIONS	B1859+00 TO B1957+00
BOOK 3A	26	TT-D1302	MORGAN HILL AND GILROY	MILLERS CANAL TO LAKE RD	VIADUCT TO EAST GILROY	COMPOSITE PLAN, PROFILE AND CROSS SECTIONS	B1957+00 TO B2044+00
BOOK 3A	27	TT-D1303	MORGAN HILL AND GILROY	LOVERS LN	VIADUCT TO EAST GILROY	COMPOSITE PLAN, PROFILE AND CROSS SECTIONS	B2044+00 TO B2130+00
BOOK 3A	28	TT-D1304	MORGAN HILL AND GILROY	SR 152	VIADUCT TO EAST GILROY	COMPOSITE PLAN, PROFILE AND CROSS SECTIONS	B2130+00 TO B2215+00
BOOK 3A	29	TT-D1305	MORGAN HILL AND GILROY	SR 152	VIADUCT TO EAST GILROY	COMPOSITE PLAN, PROFILE AND CROSS SECTIONS	B2215+00 TO B2291+73.48

SAN JOSE TO CVY EIR/S: VOLUME III **GENERAL INFORMATION BOOK SHEET 21 OF 64**



RECORD PEPD SUBMITTAL MAY 3, 2019 NOT FOR CONSTRUCTION

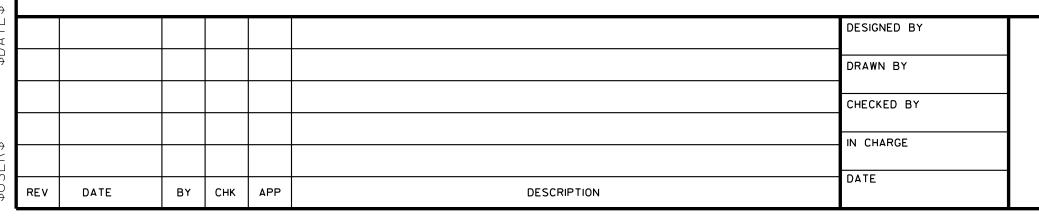





CALIFORNIA HIGH-SPEED TRAIN PROJECT **SAN JOSE TO MERCED**

ALTERNATIVE 3 INDEX OF DRAWING SHEET 1 OF 7

CONTRACT NO. HSR15-34
DRAWING NO. GE-A0301
scale NONE
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ALTERNATIVE 3 - VIADUCT TO EAST GILROY

COVER, INDEX OF DRAWING AND KEY MAPS

SHEET NO

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BOOK

BOOK 3B

BOOK 3B

BOOK 3B

BOOK 3B

BOOK 3B

PACHECO PASS

BOOK 3B

SAN JOAQUIN VALLEY

COMPOSITE PLANS

DRAWING NO

COVER

GE-A0302

GE-A0303

GE-D0301

GE-D0302

TT-D1401

TT-D1402

TT-D1403

TT-D1404

TT-D1405

TT-D1406

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TT-D1609

TT-D1610

TT-D1611

TT-D1612

SUBSECTION

SAN JOSE TO MERCED SECTION

PACHECO PASS, SAN JOAQUIN VALLEY

SAN JOSE DIRIDON STATION APPROACH,

MORGAN HILL AND GILROY

GENERAL

GENERAL

PACHECO PASS

SAN JOAQUIN VALLEY

RECORD PEPD SUBMITTAL MAY 3, 2019 NOT FOR

CONSTRUCTION



GEOGRAPHIC LOCATION

N/A

SR 152 TO CARLUCCI ROAD

STATIONS

ENTIRE ALTERNATIVE

ENTIRE ALTERNATIVE

N/A

SERVICE ROAD 1

N/A

N/A

SR 152

N/A

SR 152

N/A

N/A

N/A

MCCABE RD

N/A

N/A

ROMERO RD N TO SR 33

FAHEY RD

CCID MAIN CANAL

INGOMAR GRADE RD

VOLTA RD TO HENRY MILLER RD

MONROE AVE

BADGER FLAT RD TO NANTES AVE

SR 165 TO SANTA FE GRADE

N/A

BAKER RD TO DELTA RD

MIDWAY RD TO BOX CAR RD

TURNER ISLAND RD

CARLUCCI RD





SAN JOSE TO CVY EIR/S: VOLUME III **GENERAL INFORMATION BOOK SHEET 22 OF 64**

ADDITIONAL DESCRIPTION

VIADUCT TO EAST GILROY

B2362+00 TO B3205+00

B3205+00 TO B3295+00

B3295+00 TO B3385+00

B3385+00 TO B3475+00

B3475+00 TO B3565+00

B3565+00 TO B3655+00

B3655+00 TO B3745+00

B3745+00 TO B3835+00

B3835+00 TO B3923+00

B3923+00 TO B4014+00

B4014+00 TO B4105+00

B4105+00 TO B4196+00

B4196+00 TO B4287+00

B4287+00 TO B4372+00

B4372+00 TO B4445+00

B4445+00 TO B4533+00

B4533+00 TO B4614+00

B4614+00 TO B4686+00

B4686+00 TO B4758+00

B4758+00 TO B4846+00

B4846+00 TO B4932+00

B4932+00 TO B5020+00

B5020+00 TO B5109+00

B5109+00 TO B5193+00

B5193+00 TO B5282+00

B5282+00 TO B5366+28.52

CALIFORNIA HIGH-SPEED TRAIN PROJECT **SAN JOSE TO MERCED** ALTERNATIVE 3

INDEX OF DRAWING

SHEET 2 OF 7

CONTRACT NO. HSR15-34
H3K13-34
DRAWING NO.
GE-A0302
SCALE
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SHEET NO.

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ALIGNMENT OR FEATURE

SAN JOSE TO CENTRAL VALLEY WYE

INDEX OF DRAWING

INDEX OF DRAWING

KEY MAP

KEY MAP

TUNNEL

TUNNEL

TUNNEL

HENRY MILLER ROAD

HENRY MILLER ROAD

HENRY MILLER ROAD

HENRY MILLER ROAD

HENRY MILLER ROAD

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HENRY MILLER ROAD

HENRY MILLER ROAD

HENRY MILLER ROAD

SHEET DESCRIPTION

ALTERNATIVE 3

SHEET 2 OF 7

SHEET 3 OF 7

COMPOSITE PLAN

SYSTEMS SITES

COMPOSITE PLAN, PROFILE AND CROSS SECTIONS

BY CHK APP

	I	1	
			IN CHARGE
			CHECKED BY
			DRAWN BY
			DESIGNED BY

DESCRIPTION

ALTERNATIVE 3 - VIADUCT TO EAST GILROY

SHEET NO

ВООК

DRAWING NO

SUBSECTION

RECORD PEPD SUBMITTAL

MAY 3, 2019 NOT FOR CONSTRUCTION



1111 Broadway 9th Floor Oakland, CA 94607



SAN JOSE TO CVY EIR/S: VOLUME III GENERAL INFORMATION BOOK **SHEET 23 OF 64**

ADDITIONAL DESCRIPTION

CALIFORNIA HIGH-SPEED TRAIN PROJECT **SAN JOSE TO MERCED** ALTERNATIVE 3 INDEX OF DRAWING

SHEET 3 OF 7

SHEET DESCRIPTION

CONTRACT NO. HSR15-34
DRAWING NO. GE-A0303
scale NONE
SHEET NO.

ATIONS							
воок зв	56	AR-C0101	SAN JOSE DIRIDON STATION APPROACH	SANTA CLARA ST TO PARK AVE	VIADUCT TO I-880	SAN JOSE DIRIDON STATION	CONCEPTUAL SITE PLAN
воок зв	57	AR-C0102	SAN JOSE DIRIDON STATION APPROACH	SANTA CLARA ST TO PARK AVE	VIADUCT TO I-880	SAN JOSE DIRIDON STATION	DETAILED SITE PLAN
воок зв	58	AR-F0101	SAN JOSE DIRIDON STATION APPROACH	SANTA CLARA ST TO PARK AVE	VIADUCT TO I-880	SAN JOSE DIRIDON STATION	CONCOURSE PLAN
ВООК ЗВ	59	AR-Y0101	SAN JOSE DIRIDON STATION APPROACH	SANTA CLARA ST TO PARK AVE	VIADUCT TO I-880	SAN JOSE DIRIDON STATION	CROSS SECTION
BOOK 3B	60	AR-Y0102	SAN JOSE DIRIDON STATION APPROACH	SANTA CLARA ST TO PARK AVE	VIADUCT TO I-880	SAN JOSE DIRIDON STATION	MASSING DIAGRAM
BOOK 3B	61	AR-Y0103	SAN JOSE DIRIDON STATION APPROACH	SANTA CLARA ST TO PARK AVE	VIADUCT TO I-880	SAN JOSE DIRIDON STATION	MASSING DIAGRAM
BOOK 3B	62	AR-Y0104	SAN JOSE DIRIDON STATION APPROACH	N/A	VIADUCT TO I-880	SAN JOSE DIRIDON STATION	FACILITY SIZING TABLE
BOOK 3B	63	AR-Y0105	SAN JOSE DIRIDON STATION APPROACH	N/A	VIADUCT TO I-880	SAN JOSE DIRIDON STATION	FACILITY SIZING TABLE
BOOK 3B	64	AR-Y0106	SAN JOSE DIRIDON STATION APPROACH	N/A	VIADUCT TO I-880	SAN JOSE DIRIDON STATION	FACILITY SIZING TABLE
BOOK 3B	65	AR-Y0107	SAN JOSE DIRIDON STATION APPROACH	N/A	VIADUCT TO I-880	SAN JOSE DIRIDON STATION	FACILITY SIZING TABLE
BOOK 3B	66	AR-C1101	MORGAN HILL AND GILROY	LAS ANIMAS AVE TO LEAVESLEY RD	VIADUCT TO EAST GILROY	EAST GILROY STATION - VIADUCT	CONCEPTUAL SITE PLAN
BOOK 3B	67	AR-C1102	MORGAN HILL AND GILROY	LEAVESLEY RD	VIADUCT TO EAST GILROY	EAST GILROY STATION - VIADUCT	DETAILED SITE PLAN
BOOK 3B	68	AR-F1101	MORGAN HILL AND GILROY	N/A	VIADUCT TO EAST GILROY	EAST GILROY STATION - VIADUCT	CONCOURSE PLAN
BOOK 3B	69	AR-Y1101	MORGAN HILL AND GILROY	N/A	VIADUCT TO EAST GILROY	EAST GILROY STATION - VIADUCT	CROSS SECTION
BOOK 3B	70	AR-Y1102	MORGAN HILL AND GILROY	N/A	VIADUCT TO EAST GILROY	EAST GILROY STATION - VIADUCT	MASSING DIAGRAM
BOOK 3B	71	AR-Y1103	MORGAN HILL AND GILROY	N/A	VIADUCT TO EAST GILROY	EAST GILROY STATION - VIADUCT	MASSING DIAGRAM
воок зв	72	AR-Y1104	MORGAN HILL AND GILROY	N/A	VIADUCT TO EAST GILROY	EAST GILROY STATION - VIADUCT	FACILITY SIZING TABLE
BOOK 3B	73	AR-Y1105	MORGAN HILL AND GILROY	N/A	VIADUCT TO EAST GILROY	EAST GILROY STATION - VIADUCT	FACILITY SIZING TABLE
воок зв	74	AR-Y1106	MORGAN HILL AND GILROY	N/A	VIADUCT TO EAST GILROY	EAST GILROY STATION - VIADUCT	FACILITY SIZING TABLE

ALIGNMENT OR FEATURE

GEOGRAPHIC LOCATION

	SHEET NO	DRAWING NO	SUBSECTION	GEOGRAPHIC LOCATION	ALIGNMENT OR FEATURE	SHEET DESCRIPTION	ADDITIONAL DESCRIPTION
ВООК		<u>'</u>		GEOGRAFFIIC EOCATION	ALIGINIVIENT ON LEATONE	SHEET DESCRIPTION	ADDITIONAL DESCRIPTION
OVER, IND	DEX OF DRAW	/ING AND KEY	MAPS				
воок зс	А	COVER	SAN JOSE TO MERCED SECTION	N/A	SAN JOSE TO CENTRAL VALLEY WYE	ALTERNATIVE 3	VIADUCT TO EAST GILROY
воок зс	В	GE-A0304	ENTIRE ALTERNATIVE	COMPLEX STRUCTURES, GRADE SEPARATIONS	INDEX OF DRAWING	SHEET 4 OF 7	
воок зс	С	GE-D0301	GENERAL	ENTIRE ALTERNATIVE	KEY MAP	COMPOSITE PLAN	
воок зс	D	GE-D0302	GENERAL	ENTIRE ALTERNATIVE	KEY MAP	SYSTEMS SITES	
TRUCTUR	ES						
воок зс	75	ST-V0151	SAN JOSE DIRIDON STATION APPROACH	W TAYLOR ST	VIADUCT TO I-880	COMPLEX STRUCTURES	GENERAL PLAN 1 OF 2
BOOK 3C	76	ST-V0152	SAN JOSE DIRIDON STATION APPROACH	W SANTA CLARA ST	VIADUCT TO I-880	COMPLEX STRUCTURES	GENERAL PLAN 2 OF 2
BOOK 3C	77	ST-T0151	SAN JOSE DIRIDON STATION APPROACH	UPRR T-13, W TAYLOR ST	VIADUCT TO I-880	OVERPASSES AND UNDERPASSES	HEDDING ST AND TAYLOR ST
BOOK 3C	78	ST-V0301	SAN JOSE DIRIDON STATION APPROACH	N/A	VIADUCT TO I-880	TYPICAL SECTIONS	SHEET 1 OF 3
BOOK 3C	79	ST-V0302	SAN JOSE DIRIDON STATION APPROACH	N/A	VIADUCT TO I-880	TYPICAL SECTIONS	SHEET 2 OF 3
BOOK 3C	80	ST-V0303	SAN JOSE DIRIDON STATION APPROACH	N/A	VIADUCT TO I-880	TYPICAL SECTIONS	SHEET 3 OF 3
воок зс	81	ST-T0301	SAN JOSE DIRIDON STATION APPROACH	I-880, SR 85	VIADUCT TO I-880	CALTRANS STRUCTURES	GENERAL PLAN
воок зс	82	ST-T0401	MONTEREY CORRIDOR	ALMADEN EXPY, CURTNER AVE	VIADUCT/AT-GRADE	OVERPASSES AND UNDERPASSES	GENERAL PLAN
BOOK 3C	83	ST-V0601	MONTEREY CORRIDOR	CAPITOL CALTRAIN, CAPITOL EXPY	VIADUCT	COMPLEX STRUCTURES	GENERAL PLAN 1 OF 2
BOOK 3C	84	ST-V0602	MONTEREY CORRIDOR	BLOSSOM HILL RD, BERNAL RD	VIADUCT	COMPLEX STRUCTURES	GENERAL PLAN 2 OF 2
BOOK 3C	85	ST-V0701	MORGAN HILL AND GILROY	BAILEY AVE, COCHRANE RD	VIADUCT TO DOWNTOWN GILROY	COMPLEX STRUCTURES	GENERAL PLAN 1 OF 2
BOOK 3C	86	ST-V0702	MORGAN HILL AND GILROY	US 101, LLAGAS CREEK	VIADUCT TO DOWNTOWN GILROY	COMPLEX STRUCTURES	GENERAL PLAN 2 OF 2
BOOK 3C	87	ST-T0701	MORGAN HILL AND GILROY	BAILEY AVE, I-5	VIADUCT TO DOWNTOWN GILROY	CALTRANS STRUCTURES	GENERAL PLAN
BOOK 3C	88	ST-V0901	MORGAN HILL AND GILROY	US 101	VIADUCT TO DOWNTOWN GILROY	COMPLEX STRUCTURES	GENERAL PLAN
BOOK 3C	89	ST-V1101	MORGAN HILL AND GILROY	US 101, LLAGAS CREEK	VIADUCT TO EAST GILROY	COMPLEX STRUCTURES	GENERAL PLAN
воок зс	90	ST-V1401	PACHECO PASS	CALIFORNIA AQUEDUCT, CCID OUTSIDE CANAL	TUNNEL	COMPLEX STRUCTURES	GENERAL PLAN
BOOK 3C	91	ST-V1601	SAN JOAQUIN VALLEY	SAN LUIS WASTEWAY, LOS BANOS CREEK	HENRY MILLER ROAD	COMPLEX STRUCTURES	GENERAL PLAN
ROADWAY							
CADVAI							
	OON STATION AP	PROACH					
	OON STATION AP	PROACH CV-T0151	SAN JOSE DIRIDON STATION APPROACH	CHESTNUT AVE, ELM ST	VIADUCT TO I-880	PLAN, PROFILE AND TYPICAL SECTIONS	WEST HEDDING STREET
AN JOSE DIRII		T	SAN JOSE DIRIDON STATION APPROACH SAN JOSE DIRIDON STATION APPROACH	CHESTNUT AVE, ELM ST W TAYLOR ST, COLEMAN AVE	VIADUCT TO I-880 VIADUCT TO I-880	PLAN, PROFILE AND TYPICAL SECTIONS PLAN, PROFILE AND TYPICAL SECTIONS	WEST HEDDING STREET WEST TAYLOR STREET
BOOK 3C	92 93	CV-T0151		· · · · · · · · · · · · · · · · · · ·	+		
BOOK 3C	92 93	CV-T0151		· · · · · · · · · · · · · · · · · · ·	VIADUCT TO I-880		
BOOK 3C BOOK 3C BOOK 3C	92 93 RRIDOR	CV-T0151 CV-T0152	SAN JOSE DIRIDON STATION APPROACH	W TAYLOR ST, COLEMAN AVE	VIADUCT TO I-880 ROADWAY - MONTEREY CORRIDOR	PLAN, PROFILE AND TYPICAL SECTIONS	
BOOK 3C BOOK 3C BOOK 3C BOOK 3C	92 93 RRIDOR 94	CV-T0151 CV-T0152 CV-S0601	SAN JOSE DIRIDON STATION APPROACH MONTEREY CORRIDOR	CAPITOL EXPY, BLOSSOM HILL RD	VIADUCT TO I-880 ROADWAY - MONTEREY CORRIDOR VIADUCT	PLAN, PROFILE AND TYPICAL SECTIONS CIVIL DETAILS	WEST TAYLOR STREET
BOOK 3C	92 93 RRIDOR 94 95 96	CV-T0151 CV-T0152 CV-S0601 CV-T0401	SAN JOSE DIRIDON STATION APPROACH MONTEREY CORRIDOR MONTEREY CORRIDOR	CAPITOL EXPY, BLOSSOM HILL RD WILLOW ST, W ALMA AVE	VIADUCT TO I-880 ROADWAY - MONTEREY CORRIDOR VIADUCT VIADUCT/AT-GRADE	PLAN, PROFILE AND TYPICAL SECTIONS CIVIL DETAILS GRADE SEPARATION LAYOUT, PROFILE, & CROSS SECTIONS	WEST TAYLOR STREET SR87 ON-RAMP
BOOK 3C	92 93 RRIDOR 94 95 96	CV-T0151 CV-T0152 CV-S0601 CV-T0401 CV-T0402	SAN JOSE DIRIDON STATION APPROACH MONTEREY CORRIDOR MONTEREY CORRIDOR MONTEREY CORRIDOR	CAPITOL EXPY, BLOSSOM HILL RD WILLOW ST, W ALMA AVE CURTNER AVE	VIADUCT TO I-880 ROADWAY - MONTEREY CORRIDOR VIADUCT VIADUCT/AT-GRADE VIADUCT/AT-GRADE ROADWAY - MONTEREY CORRIDOR	CIVIL DETAILS GRADE SEPARATION LAYOUT, PROFILE, & CROSS SECTIONS GRADE SEPARATION LAYOUT, PROFILE, & CROSS SECTIONS	WEST TAYLOR STREET SR87 ON-RAMP
BOOK 3C	92 93 RRIDOR 94 95 96 RRIDOR	CV-T0151 CV-T0152 CV-S0601 CV-T0401	SAN JOSE DIRIDON STATION APPROACH MONTEREY CORRIDOR MONTEREY CORRIDOR	CAPITOL EXPY, BLOSSOM HILL RD WILLOW ST, W ALMA AVE	VIADUCT TO I-880 ROADWAY - MONTEREY CORRIDOR VIADUCT VIADUCT/AT-GRADE VIADUCT/AT-GRADE	PLAN, PROFILE AND TYPICAL SECTIONS CIVIL DETAILS GRADE SEPARATION LAYOUT, PROFILE, & CROSS SECTIONS	WEST TAYLOR STREET SR87 ON-RAMP
BOOK 3C	92 93 RRIDOR 94 95 96 RRIDOR	CV-T0151 CV-T0152 CV-S0601 CV-T0401 CV-T0402	SAN JOSE DIRIDON STATION APPROACH MONTEREY CORRIDOR MONTEREY CORRIDOR MONTEREY CORRIDOR MONTEREY CORRIDOR	CAPITOL EXPY, BLOSSOM HILL RD WILLOW ST, W ALMA AVE CURTNER AVE COHANSEY AVE, LAS ANIMAS AVE	VIADUCT TO I-880 ROADWAY - MONTEREY CORRIDOR VIADUCT VIADUCT/AT-GRADE VIADUCT/AT-GRADE ROADWAY - MONTEREY CORRIDOR VIADUCT TO EAST GILROY	CIVIL DETAILS GRADE SEPARATION LAYOUT, PROFILE, & CROSS SECTIONS GRADE SEPARATION LAYOUT, PROFILE, & CROSS SECTIONS CIVIL DETAILS	SR87 ON-RAMP ALMADEN ROAD AND CURTNER AVENUE
BOOK 3C	92 93 RRIDOR 94 95 96 RRIDOR 97 98	CV-T0151 CV-T0152 CV-S0601 CV-T0401 CV-T0402 CV-S1101 CV-T1102	SAN JOSE DIRIDON STATION APPROACH MONTEREY CORRIDOR MONTEREY CORRIDOR MONTEREY CORRIDOR MORGAN HILL AND GILROY MORGAN HILL AND GILROY	CAPITOL EXPY, BLOSSOM HILL RD WILLOW ST, W ALMA AVE CURTNER AVE COHANSEY AVE, LAS ANIMAS AVE LAS ANIMAS AVE, LEAVESLEY RD	VIADUCT TO I-880 ROADWAY - MONTEREY CORRIDOR VIADUCT VIADUCT/AT-GRADE VIADUCT/AT-GRADE ROADWAY - MONTEREY CORRIDOR VIADUCT TO EAST GILROY VIADUCT TO EAST GILROY	CIVIL DETAILS GRADE SEPARATION LAYOUT, PROFILE, & CROSS SECTIONS GRADE SEPARATION LAYOUT, PROFILE, & CROSS SECTIONS CIVIL DETAILS CIVIL DETAILS GRADE SEPARATION LAYOUT, PROFILE, & CROSS SECTIONS	SR87 ON-RAMP ALMADEN ROAD AND CURTNER AVENUE LAS ANIMAS AVE AND LEAVESLEY RD
BOOK 3C	92 93 RRIDOR 94 95 96 RRIDOR 97 98 99	CV-T0151 CV-T0152 CV-S0601 CV-T0401 CV-T0402 CV-S1101 CV-T1102 CV-T1105	SAN JOSE DIRIDON STATION APPROACH MONTEREY CORRIDOR MONTEREY CORRIDOR MONTEREY CORRIDOR MORGAN HILL AND GILROY MORGAN HILL AND GILROY MORGAN HILL AND GILROY	CAPITOL EXPY, BLOSSOM HILL RD WILLOW ST, W ALMA AVE CURTNER AVE COHANSEY AVE, LAS ANIMAS AVE LAS ANIMAS AVE, LEAVESLEY RD SR 152	VIADUCT TO I-880 ROADWAY - MONTEREY CORRIDOR VIADUCT VIADUCT/AT-GRADE VIADUCT/AT-GRADE ROADWAY - MONTEREY CORRIDOR VIADUCT TO EAST GILROY VIADUCT TO EAST GILROY VIADUCT TO EAST GILROY	CIVIL DETAILS GRADE SEPARATION LAYOUT, PROFILE, & CROSS SECTIONS GRADE SEPARATION LAYOUT, PROFILE, & CROSS SECTIONS CIVIL DETAILS GRADE SEPARATION LAYOUT, PROFILE, & CROSS SECTIONS GRADE SEPARATION LAYOUT, PROFILE, & CROSS SECTIONS GRADE SEPARATION LAYOUT, PROFILE, & CROSS SECTIONS	SR87 ON-RAMP ALMADEN ROAD AND CURTNER AVENUE LAS ANIMAS AVE AND LEAVESLEY RD SR 152
BOOK 3C	92 93 PRRIDOR 94 95 96 PRRIDOR 97 98 99 100 101	CV-T0151 CV-T0152 CV-S0601 CV-T0401 CV-T0402 CV-T1102 CV-T1105 CV-T1106	MONTEREY CORRIDOR MONTEREY CORRIDOR MONTEREY CORRIDOR MONTEREY CORRIDOR MORGAN HILL AND GILROY MORGAN HILL AND GILROY MORGAN HILL AND GILROY MORGAN HILL AND GILROY	CAPITOL EXPY, BLOSSOM HILL RD WILLOW ST, W ALMA AVE CURTNER AVE COHANSEY AVE, LAS ANIMAS AVE LAS ANIMAS AVE, LEAVESLEY RD SR 152 HOLSCLAW RD, FRAZIER LAKE RD	VIADUCT TO I-880 ROADWAY - MONTEREY CORRIDOR VIADUCT VIADUCT/AT-GRADE VIADUCT/AT-GRADE ROADWAY - MONTEREY CORRIDOR VIADUCT TO EAST GILROY	CIVIL DETAILS GRADE SEPARATION LAYOUT, PROFILE, & CROSS SECTIONS GRADE SEPARATION LAYOUT, PROFILE, & CROSS SECTIONS CIVIL DETAILS GRADE SEPARATION LAYOUT, PROFILE, & CROSS SECTIONS GRADE SEPARATION LAYOUT, PROFILE, & CROSS SECTIONS GRADE SEPARATION LAYOUT, PROFILE, & CROSS SECTIONS GRADE SEPARATION LAYOUT, PROFILE, & CROSS SECTIONS	SR87 ON-RAMP ALMADEN ROAD AND CURTNER AVENUE LAS ANIMAS AVE AND LEAVESLEY RD SR 152 HOLC1 -2, SR 152-2 AND FRAZIER LAKE ROA
BOOK 3C	92 93 RRIDOR 94 95 96 RRIDOR 97 98 99 100 101 AND GILROY	CV-T0151 CV-T0152 CV-S0601 CV-T0401 CV-T0402 CV-T1102 CV-T1105 CV-T1106 CV-G1101	MONTEREY CORRIDOR MONTEREY CORRIDOR MONTEREY CORRIDOR MONTEREY CORRIDOR MORGAN HILL AND GILROY	CAPITOL EXPY, BLOSSOM HILL RD WILLOW ST, W ALMA AVE CURTNER AVE COHANSEY AVE, LAS ANIMAS AVE LAS ANIMAS AVE, LEAVESLEY RD SR 152 HOLSCLAW RD, FRAZIER LAKE RD SR 152	ROADWAY - MONTEREY CORRIDOR VIADUCT VIADUCT/AT-GRADE VIADUCT/AT-GRADE ROADWAY - MONTEREY CORRIDOR VIADUCT TO EAST GILROY ROADWAY - MORGAN HILL AND GILROY	CIVIL DETAILS GRADE SEPARATION LAYOUT, PROFILE, & CROSS SECTIONS GRADE SEPARATION LAYOUT, PROFILE, & CROSS SECTIONS CIVIL DETAILS GRADE SEPARATION LAYOUT, PROFILE, & CROSS SECTIONS SOAP LAKE FLOOD PLAIN	SR87 ON-RAMP ALMADEN ROAD AND CURTNER AVENUE LAS ANIMAS AVE AND LEAVESLEY RD SR 152 HOLC1 -2, SR 152-2 AND FRAZIER LAKE ROA
BOOK 3C	92 93 RRIDOR 94 95 96 RRIDOR 97 98 99 100 101 AND GILROY	CV-T0151 CV-T0152 CV-S0601 CV-T0401 CV-T0402 CV-S1101 CV-T1102 CV-T1105 CV-T1106 CV-G1101 CV-S0701	MONTEREY CORRIDOR MONTEREY CORRIDOR MONTEREY CORRIDOR MONTEREY CORRIDOR MORGAN HILL AND GILROY	CAPITOL EXPY, BLOSSOM HILL RD WILLOW ST, W ALMA AVE CURTNER AVE COHANSEY AVE, LAS ANIMAS AVE LAS ANIMAS AVE, LEAVESLEY RD SR 152 HOLSCLAW RD, FRAZIER LAKE RD SR 152 ACCESS RD TO MONTEREY RD	ROADWAY - MONTEREY CORRIDOR VIADUCT VIADUCT/AT-GRADE VIADUCT/AT-GRADE ROADWAY - MONTEREY CORRIDOR VIADUCT TO EAST GILROY VIADUCT TO DOWNTOWN GILROY	CIVIL DETAILS GRADE SEPARATION LAYOUT, PROFILE, & CROSS SECTIONS GRADE SEPARATION LAYOUT, PROFILE, & CROSS SECTIONS CIVIL DETAILS GRADE SEPARATION LAYOUT, PROFILE, & CROSS SECTIONS SOAP LAKE FLOOD PLAIN CIVIL DETAILS	SR87 ON-RAMP ALMADEN ROAD AND CURTNER AVENUE LAS ANIMAS AVE AND LEAVESLEY RD SR 152 HOLC1 -2, SR 152-2 AND FRAZIER LAKE ROA
BOOK 3C	92 93 RRIDOR 94 95 96 RRIDOR 97 98 99 100 101 AND GILROY 102 103	CV-T0151 CV-T0152 CV-S0601 CV-T0401 CV-T0402 CV-S1101 CV-T1102 CV-T1105 CV-T1106 CV-G1101 CV-S0701 CV-S0901	MONTEREY CORRIDOR MONTEREY CORRIDOR MONTEREY CORRIDOR MONTEREY CORRIDOR MORGAN HILL AND GILROY	CAPITOL EXPY, BLOSSOM HILL RD WILLOW ST, W ALMA AVE CURTNER AVE COHANSEY AVE, LAS ANIMAS AVE LAS ANIMAS AVE, LEAVESLEY RD SR 152 HOLSCLAW RD, FRAZIER LAKE RD SR 152 ACCESS RD TO MONTEREY RD COHANSEY AVE, E LUCHESSA AVE	ROADWAY - MONTEREY CORRIDOR VIADUCT VIADUCT/AT-GRADE VIADUCT/AT-GRADE VIADUCT/AT-GRADE ROADWAY - MONTEREY CORRIDOR VIADUCT TO EAST GILROY VIADUCT TO DOWNTOWN GILROY VIADUCT TO DOWNTOWN GILROY	CIVIL DETAILS GRADE SEPARATION LAYOUT, PROFILE, & CROSS SECTIONS GRADE SEPARATION LAYOUT, PROFILE, & CROSS SECTIONS CIVIL DETAILS GRADE SEPARATION LAYOUT, PROFILE, & CROSS SECTIONS SOAP LAKE FLOOD PLAIN CIVIL DETAILS CIVIL DETAILS	SR87 ON-RAMP ALMADEN ROAD AND CURTNER AVENUE LAS ANIMAS AVE AND LEAVESLEY RD SR 152 HOLC1 -2, SR 152-2 AND FRAZIER LAKE ROA
BOOK 3C	92 93 PRRIDOR 94 95 96 PRRIDOR 97 98 99 100 101 AND GILROY 102 103 104	CV-T0151 CV-T0152 CV-S0601 CV-T0401 CV-T0402 CV-S1101 CV-T1102 CV-T1105 CV-T1106 CV-G1101 CV-S0701 CV-S0901 CV-S1201	MONTEREY CORRIDOR MONTEREY CORRIDOR MONTEREY CORRIDOR MONTEREY CORRIDOR MORGAN HILL AND GILROY	CAPITOL EXPY, BLOSSOM HILL RD WILLOW ST, W ALMA AVE CURTNER AVE COHANSEY AVE, LAS ANIMAS AVE LAS ANIMAS AVE, LEAVESLEY RD SR 152 HOLSCLAW RD, FRAZIER LAKE RD SR 152 ACCESS RD TO MONTEREY RD	ROADWAY - MONTEREY CORRIDOR VIADUCT VIADUCT/AT-GRADE VIADUCT/AT-GRADE ROADWAY - MONTEREY CORRIDOR VIADUCT TO EAST GILROY VIADUCT TO DEAST GILROY VIADUCT TO DOWNTOWN GILROY VIADUCT TO DOWNTOWN GILROY VIADUCT TO DOWNTOWN GILROY VIADUCT TO DOWNTOWN GILROY	CIVIL DETAILS GRADE SEPARATION LAYOUT, PROFILE, & CROSS SECTIONS GRADE SEPARATION LAYOUT, PROFILE, & CROSS SECTIONS CIVIL DETAILS GRADE SEPARATION LAYOUT, PROFILE, & CROSS SECTIONS SOAP LAKE FLOOD PLAIN CIVIL DETAILS CIVIL DETAILS CIVIL DETAILS	SR87 ON-RAMP ALMADEN ROAD AND CURTNER AVENUE LAS ANIMAS AVE AND LEAVESLEY RD SR 152 HOLC1 -2, SR 152-2 AND FRAZIER LAKE ROA DETAIL
BOOK 3C	92 93 PRRIDOR 94 95 96 PRRIDOR 97 98 99 100 101 AND GILROY 102 103 104 105	CV-T0151 CV-T0152 CV-S0601 CV-T0401 CV-T0402 CV-S1101 CV-T1102 CV-T1105 CV-T1106 CV-G1101 CV-S0701 CV-S0901 CV-S1201 CV-T0704	MONTEREY CORRIDOR MONTEREY CORRIDOR MONTEREY CORRIDOR MORGAN HILL AND GILROY MORGAN HILL AND GILROY	CAPITOL EXPY, BLOSSOM HILL RD WILLOW ST, W ALMA AVE CURTNER AVE COHANSEY AVE, LAS ANIMAS AVE LAS ANIMAS AVE, LEAVESLEY RD SR 152 HOLSCLAW RD, FRAZIER LAKE RD SR 152 ACCESS RD TO MONTEREY RD COHANSEY AVE, E LUCHESSA AVE LAKE RD, SR 152	ROADWAY - MONTEREY CORRIDOR VIADUCT VIADUCT/AT-GRADE VIADUCT/AT-GRADE ROADWAY - MONTEREY CORRIDOR VIADUCT TO EAST GILROY VIADUCT TO DOWNTOWN GILROY	CIVIL DETAILS GRADE SEPARATION LAYOUT, PROFILE, & CROSS SECTIONS GRADE SEPARATION LAYOUT, PROFILE, & CROSS SECTIONS CIVIL DETAILS GRADE SEPARATION LAYOUT, PROFILE, & CROSS SECTIONS SOAP LAKE FLOOD PLAIN CIVIL DETAILS CIVIL DETAILS CIVIL DETAILS GRADE SEPARATION LAYOUT, PROFILE, & CROSS SECTIONS	SR87 ON-RAMP ALMADEN ROAD AND CURTNER AVENUE LAS ANIMAS AVE AND LEAVESLEY RD SR 152 HOLC1 -2, SR 152-2 AND FRAZIER LAKE ROA DETAIL MONTEREY ROAD
BOOK 3C	92 93 PRRIDOR 94 95 96 PRRIDOR 97 98 99 100 101 AND GILROY 102 103 104	CV-T0151 CV-T0152 CV-S0601 CV-T0401 CV-T0402 CV-S1101 CV-T1102 CV-T1105 CV-T1106 CV-G1101 CV-S0701 CV-S0901 CV-S1201	MONTEREY CORRIDOR MONTEREY CORRIDOR MONTEREY CORRIDOR MONTEREY CORRIDOR MORGAN HILL AND GILROY	CAPITOL EXPY, BLOSSOM HILL RD WILLOW ST, W ALMA AVE CURTNER AVE COHANSEY AVE, LAS ANIMAS AVE LAS ANIMAS AVE, LEAVESLEY RD SR 152 HOLSCLAW RD, FRAZIER LAKE RD SR 152 ACCESS RD TO MONTEREY RD COHANSEY AVE, E LUCHESSA AVE	ROADWAY - MONTEREY CORRIDOR VIADUCT VIADUCT/AT-GRADE VIADUCT/AT-GRADE ROADWAY - MONTEREY CORRIDOR VIADUCT TO EAST GILROY VIADUCT TO DEAST GILROY VIADUCT TO DOWNTOWN GILROY VIADUCT TO DOWNTOWN GILROY VIADUCT TO DOWNTOWN GILROY VIADUCT TO DOWNTOWN GILROY	CIVIL DETAILS GRADE SEPARATION LAYOUT, PROFILE, & CROSS SECTIONS GRADE SEPARATION LAYOUT, PROFILE, & CROSS SECTIONS CIVIL DETAILS GRADE SEPARATION LAYOUT, PROFILE, & CROSS SECTIONS SOAP LAKE FLOOD PLAIN CIVIL DETAILS CIVIL DETAILS CIVIL DETAILS	SR87 ON-RAMP ALMADEN ROAD AND CURTNER AVENUE LAS ANIMAS AVE AND LEAVESLEY RD SR 152 HOLC1 -2, SR 152-2 AND FRAZIER LAKE ROA DETAIL

SAN JOSE TO CVY EIR/S: VOLUME III **GENERAL INFORMATION BOOK SHEET 24 OF 64**

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J						DESIGNED BY	RECORD PEPD
-						DRAWN BY	SUBMITTAL
						CHECKED BY	MAY 3, 2019
<u></u>						IN CHARGE	NOT FOR
-						DATE	CONSTRUCTION
REV	DATE	BY	СНК	APP	DESCRIPTION		







CALIFORNIA HIGH-SPEED TRAIN PROJECT **SAN JOSE TO MERCED**

ALTERNATIVE 3 INDEX OF DRAWING SHEET 4 OF 7

T	
	CONTRACT NO. HSR15-34
	DRAWING NO. GE-A0304
	scale NONE
	SHEET NO.

BOOK 3D	А	COVER	SAN JOSE TO MERCED SECTION	N/A	SAN JOSE TO CENTRAL VALLEY WYE	ALTERNATIVE 3	VIADUCT TO EAST GILROY
BOOK 3D	В	GE-A0305	ENTIRE ALTERNATIVE	GRADE SEPARATIONSMAINTENANCE OF WAY, TUNNELS	INDEX OF DRAWING	SHEET 5 OF 7	
BOOK 3D	С	GE-D0301	GENERAL	ENTIRE ALTERNATIVE	KEY MAP	COMPOSITE PLAN	
BOOK 3D	D	GE-D0302	GENERAL	ENTIRE ALTERNATIVE	KEY MAP	SYSTEMS SITES	
DADWAY							
CHECO PASS							
BOOK 3D	109	CV-S1401	PACHECO PASS	ROMERO RD, CA-152	TUNNEL	CIVIL DETAILS	
N JOAQUIN	VALLEY						
BOOK 3D	110	CV-S1601	SAN JOAQUIN VALLEY	MONTEREY RD, INGOMAR GRADE	HENRY MILLER ROAD	CIVIL DETAILS	
BOOK 3D	111	CV-T1603	SAN JOAQUIN VALLEY	VOLTA RD, HENRY MILLER RD	HENRY MILLER ROAD	GRADE SEPARATION LAYOUT, PROFILE, & CROSS SECTIONS	HENRY MILLER ROAD
BOOK 3D	112	CV-T1604	SAN JOAQUIN VALLEY	HENRY MILLER ACCESS	HENRY MILLER ROAD	GRADE SEPARATION LAYOUT, PROFILE, & CROSS SECTIONS	HENRY MILLER ACCESS
BOOK 3D	113	CV-T1606	SAN JOAQUIN VALLEY	HENRY MILLER RD AT MERCEY SPRINGS RD	HENRY MILLER ROAD	GRADE SEPARATION LAYOUT, PROFILE, & CROSS SECTIONS	MERCEY SPRINGS ROAD
BOOK 3D	114	CV-T1609	SAN JOAQUIN VALLEY	DELTA RD	HENRY MILLER ROAD	GRADE SEPARATION LAYOUT, PROFILE, & CROSS SECTIONS	DELTA ROAD
BOOK 3D	115	CV-T1610	SAN JOAQUIN VALLEY	TURNER ISLAND RD AT HENRY MILLER RD	HENRY MILLER ROAD	GRADE SEPARATION LAYOUT, PROFILE, & CROSS SECTIONS	TURNER ROAD
BOOK 3D	116	CV-T1611	SAN JOAQUIN VALLEY	CARLUCCI RD	HENRY MILLER ROAD	GRADE SEPARATION LAYOUT, PROFILE, & CROSS SECTIONS	CARLUCCI ROAD
BOOK 3D	117	CV-T1612	SAN JOAQUIN VALLEY	HUTCHINS RD	HENRY MILLER ROAD	GRADE SEPARATION LAYOUT, PROFILE, & CROSS SECTIONS	HUTCHINS ROAD
IAINTENA	NCE OF WAY	Y					
BOOK 3D	118	MY-B0906	MORGAN HILL AND GILROY	CARNADERO AVE TO SHELDON AVE	VIADUCT TO DOWNTOWN GILROY	MAINTENANCE OF WAY FACILITY	DETAIL PLAN
BOOK 3D	119	MY-B0907	MORGAN HILL AND GILROY	CARNADERO AVE TO SHELDON AVE	VIADUCT TO DOWNTOWN GILROY	MAINTENANCE OF WAY FACILITY	DETAIL PLAN
BOOK 3D	120	MY-B0908	MORGAN HILL AND GILROY	N/A	VIADUCT TO DOWNTOWN GILROY	MAINTENANCE OF WAY FACILITY	DETAIL PLAN
BOOK 3D	121	MY-B1106	MORGAN HILL AND GILROY	N/A	VIADUCT TO EAST GILROY	MAINTENANCE OF WAY FACILITY	DETAIL PLAN
BOOK 3D	122	MY-B1107	MORGAN HILL AND GILROY	SR 152, JONES CREEK	VIADUCT TO EAST GILROY	MAINTENANCE OF WAY FACILITY	TYPICAL SECTIONS
BOOK 3D	123	MY-B1108	MORGAN HILL AND GILROY	N/A	VIADUCT TO EAST GILROY	MAINTENANCE OF WAY FACILITY	PLAN AND TYPICAL SECTIONS
JNNELS -	PACHECO PA	NSS					
BOOK 3D	124	TN-D1301	PACHECO PASS	PACHECO PASS RD	TUNNEL	TUNNEL 1 - PORTAL 1	
BOOK 3D	125	TN-D1302	PACHECO PASS	SR 152	TUNNEL	TUNNEL 1 - PORTAL 2	
BOOK 3D	126	TN-D1404	PACHECO PASS	N/A	TUNNEL	TUNNEL 2 - PORTAL 1	
BOOK 3D	127	TN-D1405	PACHECO PASS	ACCESS RD 1	TUNNEL	TUNNEL PORTAL 2 ACCESS ROAD	
BOOK 3D	128	TN-D1406	PACHECO PASS	CALIFORNIA AQUEDUCT	TUNNEL	TUNNEL PORTAL 2 ACCESS ROAD	
	129	TN-D1407	PACHECO PASS	ACCESS RD 2	TUNNEL	TUNNEL PORTAL 2 ACCESS ROAD	
BOOK 3D	130	TN-D1408	PACHECO PASS	N/A	TUNNEL	LONGITUDINAL PROFILE	
BOOK 3D BOOK 3D	121	TN-D1409	PACHECO PASS	N/A	TUNNEL	GRADING DETAIL	
	131	TN-D1410	PACHECO PASS	N/A	TUNNEL	GRADING DETAIL	
BOOK 3D	131	111-01410				GRADING DETAIL	
BOOK 3D BOOK 3D		TN-D1410 TN-D1411	PACHECO PASS	N/A	TUNNEL	0.0.0.0.0000000000000000000000000000000	
BOOK 3D BOOK 3D BOOK 3D	132 133 134		PACHECO PASS PACHECO PASS	N/A N/A	TUNNEL	GRADING DETAIL	
BOOK 3D BOOK 3D BOOK 3D	132 133	TN-D1411					
BOOK 3D	132 133 134	TN-D1411 TN-D1412	PACHECO PASS	N/A	TUNNEL	GRADING DETAIL	SECTIONS
BOOK 3D BOOK 3D BOOK 3D BOOK 3D BOOK 3D BOOK 3D	132 133 134 135	TN-D1411 TN-D1412 TN-D1413	PACHECO PASS PACHECO PASS	N/A I-5, FAHEY RD	TUNNEL TUNNEL	GRADING DETAIL GRADING DETAIL	SECTIONS APPROACH 1

ALIGNMENT OR FEATURE

SHEET DESCRIPTION

SAN JOSE TO CVY EIR/S: VOLUME III **GENERAL INFORMATION BOOK SHEET 25 OF 64**

ADDITIONAL DESCRIPTION

						DESIGNED BY	RECORD PEPD
-						DRAWN BY	SUBMITTAL
						CHECKED BY	MAY 3, 2019
D						IN CHARGE	NOT FOR
REV	DATE	BY	СНК	APP	DESCRIPTION	DATE	CONSTRUCTION

ALTERNATIVE 3 - VIADUCT TO EAST GILROY

SHEET NO

BOOK

DRAWING NO

SUBSECTION



GEOGRAPHIC LOCATION





CALIFORNIA HIGH-SPEED TRAIN PROJECT **SAN JOSE TO MERCED**

ALTERNATIVE 3 INDEX OF DRAWING SHEET 5 OF 7

CONTRACT NO. HSR15-34
GE-A0305
scale NONE
SHEET NO.

						DESIGNED BY
						DRAWN BY
						CHECKED BY
						IN CHARGE
						DATE
REV	DATE	BY	СНК	APP	DESCRIPTION	DATE

RECORD PEPD SUBMITTAL **MAY 3, 2019** NOT FOR

CONSTRUCTION







SAN JOSE TO CVY EIR/S: VOLUME III GENERAL INFORMATION BOOK **SHEET 26 OF 64**

CALIFORNIA HIGH-SPEED TRAIN PROJECT **SAN JOSE TO MERCED**

ALTERNATIVE 3 INDEX OF DRAWING SHEET 6 OF 7

1	CONTRACT NO. HSR15-34
	DRAWING NO. GE-A0306
	scale NONE
	SHEET NO.

ALTERNATIV	/E 3 - VIADU	CT TO EAST GIL	.ROY				
ВООК	SHEET NO	DRAWING NO	SUBSECTION	GEOGRAPHIC LOCATION	ALIGNMENT OR FEATURE	SHEET DESCRIPTION	ADDITIONAL DESCRIPTION
COVER, IND	EX OF DRAV	VING AND KEY	MAPS				
BOOK 3E	Α	COVER	SAN JOSE TO MERCED SECTION	N/A	SAN JOSE TO CENTRAL VALLEY WYE	ALTERNATIVE 3	VIADUCT TO EAST GILROY
BOOK 3E	В	GE-A0306	ENTIRE ALTERNATIVE	CONSTRUCTION STAGING	INDEX OF DRAWING	SHEET 6 OF 7	
BOOK 3E	С	GE-D0301	GENERAL	ENTIRE ALTERNATIVE	KEY MAP	COMPOSITE PLAN	
BOOK 3E	D	GE-D0302	GENERAL	ENTIRE ALTERNATIVE	KEY MAP	SYSTEMS SITES	
CONSTRUCT	TION STAGIN	IG					
BOOK 3E	139	CV-I0401	MONTEREY CORRIDOR	W ALMA AVE, CURTNER AVE	VIADUCT	CONSTRUCTION STAGING PLAN-PHASE 1-STAGES 1 & 2	CALTRAIN/UPRR RELOCATION-STA 149+00 TO 288+00
BOOK 3E	140	CV-I0402	MONTEREY CORRIDOR	W ALMA AVE, CURTNER AVE	VIADUCT	CONSTRUCTION STAGING PLAN-PHASE 1-STAGES 3	CALTRAIN/UPRR RELOCATION-STA 149+00 TO 288+00
BOOK 3E	141	CV-I0403	MONTEREY CORRIDOR	W ALMA AVE, CURTNER AVE	VIADUCT	CONSTRUCTION STAGING PLAN-PHASE 2	CALTRAIN/UPRR RELOCATION-STA 149+00 TO 288+00
BOOK 3E	142	CV-10404	MONTEREY CORRIDOR	W ALMA AVE, CURTNER AVE	VIADUCT	CONSTRUCTION STAGING PLAN-PHASE 3	CALTRAIN/UPRR RELOCATION-STA 149+00 TO 288+00
BOOK 3E	143	CV-I0405A	MONTEREY CORRIDOR	ALMADEN RD	VIADUCT	CONSTRUCTION STAGING-PHASE 1-STAGE 1	ALMADEN RD UNDERPASS
BOOK 3E	144	CV-I0405B	MONTEREY CORRIDOR	ALMADEN RD	VIADUCT	CONSTRUCTION STAGING-PHASE 1-STAGE 2	ALMADEN RD UNDERPASS
BOOK 3E	145	CV-I0405C	MONTEREY CORRIDOR	ALMADEN RD	VIADUCT	CONSTRUCTION STAGING-PHASE 1-STAGE 3	ALMADEN RD UNDERPASS
BOOK 3E	146	CV-10406	MONTEREY CORRIDOR	ALMADEN RD	VIADUCT	CONSTRUCTION STAGING-PHASE 2	ALMADEN RD UNDERPASS
BOOK 3E	147	CV-I0407	MONTEREY CORRIDOR	ALMADEN RD	VIADUCT	CONSTRUCTION STAGING-PHASE 3	ALMADEN RD UNDERPASS
BOOK 3E	148	CV-10408	MONTEREY CORRIDOR	SR 87, UPRR	VIADUCT	CONSTRUCTION STAGING-PHASE 1-STAGES 1 & 2	MODIFY EXISTING ALMADEN EXPRESSWAY OVERHEAD
BOOK 3E	149	CV-10409	MONTEREY CORRIDOR	SR 87, UPRR	VIADUCT	CONSTRUCTION STAGING-PHASE 1-STAGES 3	MODIFY EXISTING ALMADEN EXPRESSWAY OVERHEAD
BOOK 3E	150	CV-I0410	MONTEREY CORRIDOR	SR 87, UPRR	VIADUCT	CONSTRUCTION STAGING-PHASE 2	MODIFY EXISTING ALMADEN EXPRESSWAY OVERHEAD
BOOK 3E	151	CV-I0411	MONTEREY CORRIDOR	SR 87, UPRR	VIADUCT	CONSTRUCTION STAGING-PHASE 3	MODIFY EXISTING ALMADEN EXPRESSWAY OVERHEAD
BOOK 3E	152	CV-I0412	MONTEREY CORRIDOR	UPRR	VIADUCT	CONSTRUCTION STAGING-PHASE 1	MODIFY EXISTING CURTNER AVENUE OVERHEAD
BOOK 3E	153	CV-I0413	MONTEREY CORRIDOR	UPRR	VIADUCT	CONSTRUCTION STAGING-PHASES 2 & 3	MODIFY EXISTING CURTNER AVENUE OVERHEAD
BOOK 3E	154	CV-I1001	MORGAN HILL AND GILROY	N/A	VIADUCT TO DOWNTOWN GILROY	CONSTRUCTION PHASING / STAGING PLAN	GENERAL NOTES
BOOK 3E	155	CV-I1002	MORGAN HILL AND GILROY	BOLSA RD	VIADUCT TO DOWNTOWN GILROY	CONSTRUCTION PHASING / STAGING PLAN - STAGE 1	BLOOMFIELD AVENUE GRADE SEPARATION - SHEET 1 OF 2
BOOK 3E	156	CV-I1003	MORGAN HILL AND GILROY	BLOOMFIELD AVE, SHELDON AVE	VIADUCT TO DOWNTOWN GILROY	CONSTRUCTION PHASING / STAGING PLAN - STAGE 1	BLOOMFIELD AVENUE GRADE SEPARATION - SHEET 2 OF 2
BOOK 3E	157	CV-I1004	MORGAN HILL AND GILROY	BLOOMFIELD AVE, BOLSA RD	VIADUCT TO DOWNTOWN GILROY	CONSTRUCTION PHASING / STAGING PLAN - STAGE 2	BLOOMFIELD AVENUE GRADE SEPARATION - SHEET 1 OF 2
BOOK 3E	158	CV-I1005	MORGAN HILL AND GILROY	BLOOMFIELD AVE, SHELDON AVE	VIADUCT TO DOWNTOWN GILROY	CONSTRUCTION PHASING / STAGING PLAN - STAGE 2	BLOOMFIELD AVENUE GRADE SEPARATION - SHEET 2 OF 2
BOOK 3E	159	CV-I1006	MORGAN HILL AND GILROY	BLOOMFIELD AVE, BOLSA RD	VIADUCT TO DOWNTOWN GILROY	CONSTRUCTION PHASING / STAGING PLAN - STAGE 3	BLOOMFIELD AVENUE GRADE SEPARATION - SHEET 1 OF 2
BOOK 3E	160	CV-I1007	MORGAN HILL AND GILROY	BLOOMFIELD AVE, SHELDON AVE	VIADUCT TO DOWNTOWN GILROY	CONSTRUCTION PHASING / STAGING PLAN - STAGE 3	BLOOMFIELD AVENUE GRADE SEPARATION - SHEET 2 OF 2
BOOK 3E	161	CV-I1101	MORGAN HILL AND GILROY	N/A	VIADUCT TO EAST GILROY	GENERAL NOTES	CONSTRUCTION PHASING / STAGING PLAN
BOOK 3E	162	CV-I1102	MORGAN HILL AND GILROY	SR 152	VIADUCT TO EAST GILROY	CONSTRUCTION STAGING PLAN - STAGE 1	SR 152/FRAZIER LAKE RD GRADE SEPARATIONS
BOOK 3E	163	CV-I1103	MORGAN HILL AND GILROY	FRAZIER LAKE RD	VIADUCT TO EAST GILROY	CONSTRUCTION STAGING PLAN - STAGE 1	SR 152/FRAZIER LAKE RD GRADE SEPARATIONS
BOOK 3E	164	CV-I1104	MORGAN HILL AND GILROY	SR 152, FRAZIER LAKE RD	VIADUCT TO EAST GILROY	CONSTRUCTION STAGING PLAN - STAGE 2	SR 152/FRAZIER LAKE RD GRADE SEPARATIONS
BOOK 3E	165	CV-I1105	MORGAN HILL AND GILROY	SR 152	VIADUCT TO EAST GILROY	CONSTRUCTION STAGING PLAN - STAGE 2	SR 152/FRAZIER LAKE RD GRADE SEPARATIONS
BOOK 3E	166	CV-l1106	MORGAN HILL AND GILROY	SR 152	VIADUCT TO EAST GILROY	CONSTRUCTION STAGING PLAN - STAGE 2	SR 152/FRAZIER LAKE RD GRADE SEPARATIONS
BOOK 3E	167	CV-I1107	MORGAN HILL AND GILROY	FRAZIER LAKE ROAD	VIADUCT TO EAST GILROY	CONSTRUCTION STAGING PLAN - STAGE 2	SR 152/FRAZIER LAKE RD GRADE SEPARATIONS
BOOK 3E	168	CV-I1108	MORGAN HILL AND GILROY	SR 152	VIADUCT TO EAST GILROY	CONSTRUCTION STAGING PLAN - STAGE 3	SR 152/FRAZIER LAKE RD GRADE SEPARATIONS
BOOK 3E	169	CV-I1109	MORGAN HILL AND GILROY	SR 152	VIADUCT TO EAST GILROY	CONSTRUCTION STAGING PLAN - STAGE 3	SR 152/FRAZIER LAKE RD GRADE SEPARATIONS
BOOK 3E	170	CV-I1110	MORGAN HILL AND GILROY	SR 152	VIADUCT TO EAST GILROY	CONSTRUCTION STAGING PLAN - STAGE 3	SR 152/FRAZIER LAKE RD GRADE SEPARATIONS
BOOK 3E	171	CV-I1601	SAN JOAQUIN VALLEY	N/A	HENRY MILLER ROAD	CONSTRUCTION STAGING PLAN	GENERAL NOTES
BOOK 3E	172	CV-I1602	SAN JOAQUIN VALLEY	INGOMAR GRADE RD AT HENRY MILLER RD	HENRY MILLER ROAD	CONSTRUCTION STAGING PLAN	HENRY MILLER ROAD GRADE SEPARATION
BOOK 3E	173	CV-I1603	SAN JOAQUIN VALLEY	HENRY MILLER RD	HENRY MILLER ROAD	CONSTRUCTION STAGING PLAN	HENRY MILLER ROAD GRADE SEPARATION
BOOK 3E	174	CV-I1604	SAN JOAQUIN VALLEY	HENRY MILLER RD AT MERCEY SPRINGS RD	HENRY MILLER ROAD	CONSTRUCTION STAGING PLAN	SR-165 / MERCEY SPRINGS ROAD GRADE SEPARATION
BOOK 3E	175	CV-l1605	SAN JOAQUIN VALLEY	HENRY MILLER RD AT DELTA RD	HENRY MILLER ROAD	CONSTRUCTION STAGING PLAN	DELTA ROAD GRADE SEPARATION
BOOK 3E	176	CV-l1606	SAN JOAQUIN VALLEY	HENRY MILLER RD AT TURNER ISLAND RD	HENRY MILLER ROAD	CONSTRUCTION STAGING PLAN	TURNER ISLAND ROAD GRADE SEPARATION
BOOK 3E	177	CV-I1607	SAN JOAQUIN VALLEY	HENRY MILLER RD AT CARLUCCI RD	HENRY MILLER ROAD	CONSTRUCTION STAGING PLAN	CARLUCCI ROAD GRADE SEPARATION

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						CHECKED BY
						IN CHARGE
REV	DATE	BY	СНК	APP	DESCRIPTION	DATE

ALTERNATIVE 3 - VIADUCT TO EAST GILROY

COVER, INDEX OF DRAWING AND KEY MAPS

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BOOK

BOOK 3F

DRAWING NO

COVER

GE-A0307

GE-D0301

GE-D0302

TT-B0101-JM

TT-B0102-JM

TT-B0103-JM

TT-B0104

TT-B0105

TT-B0106

TT-B0107

TT-B0108

TT-B0109

TT-B0110

TT-B0111

TT-B0112

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TT-B0115

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TT-B0302

TT-B0303

TT-B0304

CV-B0101

ROADWAY HORIZONTAL ALIGNMENT DATA TABLE

TRACK GUIDEWAY HORIZONTAL ALIGNMENT DATA TABLE

SUBSECTION

SAN JOSE TO MERCED SECTION

ENTIRE ALTERNATIVE

GENERAL

GENERAL

SAN JOSE DIRIDON STATION APPROACH

MONTEREY CORRIDOR

MONTEREY CORRIDOR

MONTEREY CORRIDOR

MONTEREY CORRIDOR

MONTEREY CORRIDOR

MONTEREY CORRIDOR

MORGAN HILL AND GILROY

PACHECO PASS

PACHECO PASS

PACHECO PASS

PACHECO PASS

SAN JOAQUIN VALLEY

SAN JOAQUIN VALLEY

SAN JOAQUIN VALLEY

MORGAN HILL AND GILROY

MORGAN HILL AND GILROY

PACHECO PASS

PACHECO PASS

PACHECO PASS

DOWNTOWN GILROY

DOWNTOWN GILROY

GILROY TO PACHECO

GILROY TO PACHECO

MONTEREY CORRIDOR

RECORD PEPD SUBMITTAL MAY 3, 2019 NOT FOR

CONSTRUCTION



GEOGRAPHIC LOCATION

N/A

ALIGNMENT DATA TABLES

ENTIRE ALTERNATIVE

ENTIRE ALTERNATIVE

N/A



ALIGNMENT OR FEATURE

SAN JOSE TO CENTRAL VALLEY WYE

INDEX OF DRAWING

KEY MAP

KEY MAP

VIADUCT TO I-880

VIADUCT/AT-GRADE

VIADUCT/AT-GRADE

VIADUCT

TRACK GUIDEWAY

VIADUCT

SAN JOSE TO CVY EIR/S: VOLUME III GENERAL INFORMATION BOOK SHEET 27 OF 64 IFORNIA HIGH-SPEED TRAIN PROJECT CONTRACT NO. HSR15-34

ADDITIONAL DESCRIPTION

VIADUCT TO EAST GILROY

CURVE NO. C189 AND C190

CURVE NO. C191 AND C192

CURVE NO. C193

CURVE NO. C101 AND C102

CURVE NO. C103 AND C104

CURVE NO. C105 AND C106

CURVE NO. C107

CURVE NO. C108 AND C109

CURVE NO. C110 AND C111

CURVE NO. C112

CURVE NO. C113 AND C114

CURVE NO. C115 AND C116

CURVE NO. C117 AND C118

CURVE NO. C119 AND C120

CURVE NO. C121

CURVE NO. C122

CURVE NO. C123

CURVE NO. C124 AND C125

CURVE NO. C126

CURVE NO. C127 AND C128

CURVE NO. C129

CURVE NO. C130

CURVE NO. C131

CURVE NO. C132 AND C133

CURVE NO. C134 AND C135

CURVE NO. C136

CURVE NO. C137

CURVE NO. C138 AND C139

CURVE NO. C140

CURVE NO. C230

CURVE NO. C231 AND C231A

CURVE NO. C232 AND C233

CURVE NO. C234 AND C235

CURVE NO. C236

CURVE NO. C501 AND C502

CURVE NO. C503

CURVE NO. C504

CURVE NO. C604

CALIFORNIA HIGH-SPEED TRAIN PROJECT SAN JOSE TO MERCED

SHEET DESCRIPTION

ALTERNATIVE 3

SHEET 7 OF 7

COMPOSITE PLAN

SYSTEMS SITES

TRACK ALIGNMENT DATA TABLE

TRACK ALIGNMENT DATA TABLE

TRACK ALIGNMENT DATA TABLE

B2 TRACK ALIGNMENT DATA TABLE

B2 TRACK ALIGNMENT DATA TABLE

B2 TRACK ALIGNMENT DATA TABLE

B1 TRACK ALIGNMENT DATA TABLE

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B2 TRACK ALIGNMENT DATA TABLE

B2 TRACK ALIGNMENT DATA TABLE

B1 TRACK ALIGNMENT DATA TABLE

ALIGNMENT DATA TABLE


ALTERNATIVE 3
INDEX OF DRAWING
SHEET 7 OF 7

CONTRACT NO.
HSR15-34
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GE-A0307
SCALE
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SHEET NO.

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BOOK	SHEET NO	DRAWING NO	SUBSECTION	GEOGRAPHIC LOCATION	ALIGNMENT OR FEATURE	SHEET DESCRIPTION	ADDITIONAL DESCRIPTION
COVER, IND	EX OF DRAV	VING AND KE	Y MAPS				
BOOK 4A	Α	COVER	SAN JOSE TO MERCED SECTION	N/A	SAN JOSE TO CENTRAL VALLEY WYE	ALTERNATIVE 4	
BOOK 4A	В	GE-A0401	CP COAST TO GILROY	SCOTT BLVD TO MILLER CANAL	INDEX OF DRAWING	SHEET 1 OF 6	
BOOK 4A	С	GE-D0401	GENERAL	ENTIRE ALTERNATIVE	KEY MAP	COMPOSITE PLAN	
BOOK 4A	D	GE-D0402	GENERAL	ENTIRE ALTERNATIVE	KEY MAP	SYSTEMS SITES	SHEET 1 OF 2
COMPOSITE	PLANS						
AN JOSE DIRID	ON STATION AI	PPROACH (CP COA	AST TO GILROY)				
BOOK 4A	1	TT-D4001	SAN JOSE DIRIDON STATION APPROACH (CP COAST TO GILROY)	SCOTT BLVD TO BENTON ST	BLENDED AT-GRADE ALTERNATIVE	COMPOSITE PLAN, PROFILE AND TYPICAL SECTIONS	B2782+86 TO B2952+50
BOOK 4A	2	TT-D4002	SAN JOSE DIRIDON STATION APPROACH (CP COAST TO GILROY)	NEWHALL ST TO EMORY ST	BLENDED AT-GRADE ALTERNATIVE	COMPOSITE PLAN, PROFILE AND TYPICAL SECTIONS	B2952+50 TO B3029+40
BOOK 4A	3	TT-D4003	SAN JOSE DIRIDON STATION APPROACH (CP COAST TO GILROY)	W TAYLOR ST TO SAN CARLOS ST	BLENDED AT-GRADE ALTERNATIVE	COMPOSITE PLAN, PROFILE AND TYPICAL SECTIONS	B3029+40 TO B3112+50
BOOK 4A	4	TT-D4004	SAN JOSE DIRIDON STATION APPROACH (CP COAST TO GILROY)	I-280 TO HWY 87	BLENDED AT-GRADE ALTERNATIVE	COMPOSITE PLAN, PROFILE AND TYPICAL SECTIONS	B3112+50 TO B3161+50
BOOK 4A	5	TT-D4005	SAN JOSE DIRIDON STATION APPROACH (CP	WILLOW ST TO CURTNER AVE	BLENDED AT-GRADE ALTERNATIVE	COMPOSITE PLAN, PROFILE AND CROSS SECTIONS	B3161+50 TO B3249+50
MONTEREY COR	RRIDOR (CP COA	AST TO GILROY)					
BOOK 4A	6	TT-D4006	MONTEREY CORRIDOR (CP COAST TO GILROY)	COMMUNICATION HILL BLVD TO ESFAHAN CT	BLENDED AT-GRADE ALTERNATIVE	COMPOSITE PLAN, PROFILE AND CROSS SECTIONS	B3249+50 TO B324+50
BOOK 4A	7	TT-D4007	CP COAST TO GILROY	CAPIITOL EXPRESSWAY TO SKYWAY DR	BLENDED AT-GRADE ALTERNATIVE	COMPOSITE PLAN, PROFILE AND CROSS SECTIONS	B324+50 TO B411+50
BOOK 4A	8	TT-D4008	CP COAST TO GILROY	BRANHAM LANE TO BLOSSOM HILL RD	BLENDED AT-GRADE ALTERNATIVE	COMPOSITE PLAN, PROFILE AND CROSS SECTIONS	B411+50 TO B501+00
BOOK 4A	9	TT-D4009	CP COAST TO GILROY	FORD RD TO CA-85	BLENDED AT-GRADE ALTERNATIVE	COMPOSITE PLAN, PROFILE AND CROSS SECTIONS	B501+00 TO B590+70
BOOK 4A	10	TT-D4010	CP COAST TO GILROY	BERNAL RD TO FORSUM RD	BLENDED AT-GRADE ALTERNATIVE	COMPOSITE PLAN, PROFILE AND CROSS SECTIONS	B590+70 TO B679+50
BOOK 4A	11	TT-D4011	CP COAST TO GILROY	METCALF RD TO EMADO AVE	BLENDED AT-GRADE ALTERNATIVE	COMPOSITE PLAN, PROFILE AND CROSS SECTIONS	B679+50 TO B767+50
10RGAN HILL A	AND GILROY (C	P COAST TO GILRO	OY)				
BOOK 4A	12	TT-D4012	CP COAST TO GILROY	BAILEY AVE TO RICHMOND AVE	BLENDED AT-GRADE ALTERNATIVE	COMPOSITE PLAN, PROFILE AND CROSS SECTIONS	B767+50 TO B856+50
BOOK 4A	13	TT-D4013	CP COAST TO GILROY	FOX LN TO MIRAMONTE AVE	BLENDED AT-GRADE ALTERNATIVE	COMPOSITE PLAN, PROFILE AND CROSS SECTIONS	B856+50 TO B945+50
BOOK 4A	14	TT-D4014	CP COAST TO GILROY	LIVE OAK AVE TO TILTON AVE	BLENDED AT-GRADE ALTERNATIVE	COMPOSITE PLAN, PROFILE AND CROSS SECTIONS	B945+50 TO B1036+00
BOOK 4A	15	TT-D4015	CP COAST TO GILROY	PEEBLES AVE TO E CENTRAL AVE	BLENDED AT-GRADE ALTERNATIVE	COMPOSITE PLAN, PROFILE AND CROSS SECTIONS	B1036+00 TO B1125+00
BOOK 4A	16	TT-D4016	CP COAST TO GILROY	MAIN AVE TO TENNANT AVE	BLENDED AT-GRADE ALTERNATIVE	COMPOSITE PLAN, PROFILE AND CROSS SECTIONS	B1125+00 TO B1215+00
BOOK 4A	17	TT-D4017	CP COAST TO GILROY	BUTTERFIELD BLVD TO E MIDDLE AVE	BLENDED AT-GRADE ALTERNATIVE	COMPOSITE PLAN, PROFILE AND CROSS SECTIONS	B1215+00 TO B1304+00
BOOK 4A	18	TT-D4018	CP COAST TO GILROY	CALIFORNIA AVE TO HIGHLAND AVE	BLENDED AT-GRADE ALTERNATIVE	COMPOSITE PLAN, PROFILE AND CROSS SECTIONS	B1304+00 TO B1393+00
BOOK 4A	19	TT-D4019	CP COAST TO GILROY	CHURCH AVE TO MASTEN AVE	BLENDED AT-GRADE ALTERNATIVE	COMPOSITE PLAN, PROFILE AND CROSS SECTIONS	B1393+00 TO B1481+00
BOOK 4A	20	TT-D4020	CP COAST TO GILROY	RUCKER AVE TO LAS ANIMAS AVE	BLENDED AT-GRADE ALTERNATIVE	COMPOSITE PLAN, PROFILE AND CROSS SECTIONS	B1481+00 TO B1566+00
BOOK 4A	21	TT-D4021	CP COAST TO GILROY	LAS ANIMAS AVE TO IOOF AVE	BLENDED AT-GRADE ALTERNATIVE	COMPOSITE PLAN, PROFILE AND CROSS SECTIONS	B1566+00 TO B1635+00
BOOK 4A	22	TT-D4022	CP COAST TO GILROY	LEWIS ST TO E LUCHESSA AVE	BLENDED AT-GRADE ALTERNATIVE	COMPOSITE PLAN, PROFILE AND CROSS SECTIONS	B1635+00 TO B1717+00
BOOK 4A	23	TT-D4023	CP COAST TO GILROY	US 101 TO CARNADERO AVE	BLENDED AT-GRADE ALTERNATIVE	COMPOSITE PLAN, PROFILE AND CROSS SECTIONS	B1717+00 TO B1805+00
BOOK 4A	24	TT-D4024	CP COAST TO GILROY	BLOOMFIELD AVE TO SHELDON RD	BLENDED AT-GRADE ALTERNATIVE	COMPOSITE PLAN, PROFILE AND CROSS SECTIONS	B1805+00 TO B1880+00
BOOK 4A	25	TT-D4025	CP COAST TO GILROY	PAJARO RIVER TO MILLER CANAL	BLENDED AT-GRADE ALTERNATIVE	COMPOSITE PLAN, PROFILE AND CROSS SECTIONS	B1880+00 TO B1938+35

SAN JOSE TO CVY EIR/S: VOLUME III **GENERAL INFORMATION BOOK SHEET 28 OF 64**

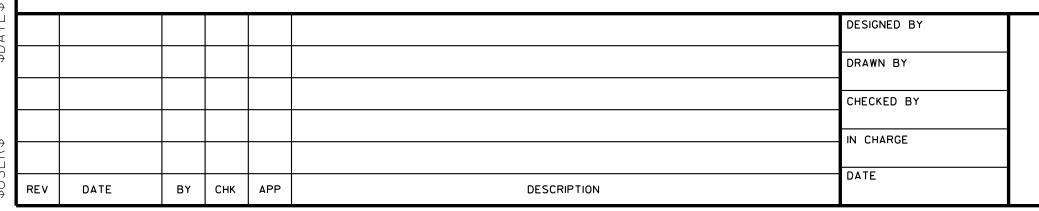

RECORD PEPD SUBMITTAL MAY 3, 2019 NOT FOR CONSTRUCTION







CALIFORNIA HIGH-SPEED TRAIN PROJECT **SAN JOSE TO MERCED**

ALTERNATIVE 4 INDEX OF DRAWING SHEET 1 OF 6

CONTRACT NO.
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ВООК	SHEET NO	DRAWING NO	SUBSECTION	GEOGRAPHIC LOCATION	ALIGNMENT OR FEATURE	SHEET DESCRIPTION	ADDITIONAL DESCRIPTION
OVER, IND	EX OF DRAV	VING AND KE	Y MAPS				
BOOK 4B	А	COVER	SAN JOSE TO MERCED SECTION	N/A	SAN JOSE TO CENTRAL VALLEY WYE	ALTERNATIVE 4	
воок 4в	В	GE-A0402	MORGAN HILL AND GILROY, PACHECO PASS, SAN JOAQUIN VALLEY	PAJARO RIVER TO CARLUCCI ROAD	INDEX OF DRAWING	SHEET 2 OF 6	
BOOK 4B	С	GE-D0401	GENERAL	ENTIRE ALTERNATIVE	KEY MAP	COMPOSITE PLAN	
BOOK 4B	D	GE-D0402	GENERAL	ENTIRE ALTERNATIVE	KEY MAP	SYSTEMS SITES	SHEET 1 OF 2
OMPOSITI	E PLANS						
ORGAN HILL	AND GILROY						
BOOK 4B	26	TT-D0908	MORGAN HILL AND GILROY	PAJARO RIVER	VIADUCT TO DOWNTOWN GILROY	COMPOSITE PLAN, PROFILE AND CROSS SECTIONS	B1930+00 TO B2017+00
BOOK 4B	27	TT-D0909	MORGAN HILL AND GILROY	FRAZIER LAKE RD	VIADUCT TO DOWNTOWN GILROY	COMPOSITE PLAN, PROFILE AND CROSS SECTIONS	B2017+00 TO B2103+00
BOOK 4B	28	TT-D0910	MORGAN HILL AND GILROY	N/A	VIADUCT TO DOWNTOWN GILROY	UPRR FREIGHT AND TRANSITION TRACK PROFILES	
BOOK 4B	29	TT-D1201	MORGAN HILL AND GILROY	LAKE RD TO LOVERS LANE	VIADUCT TO DOWNTOWN GILROY	COMPOSITE PLAN, PROFILE AND CROSS SECTIONS	B2103+00 TO B2193+00
BOOK 4B	30	TT-D1202	MORGAN HILL AND GILROY	SAN FELIPE RD TO PACHECO PASS RD	VIADUCT TO DOWNTOWN GILROY	COMPOSITE PLAN, PROFILE AND CROSS SECTIONS	B2193+00 TO B2275+00
BOOK 4B	31	TT-D1203	MORGAN HILL AND GILROY	PACHECO PASS HWY	VIADUCT TO DOWNTOWN GILROY	COMPOSITE PLAN, PROFILE AND CROSS SECTIONS	B2275+00 TO B2362+00
ACHECO PASS							
BOOK 4B	32	TT-D1401	PACHECO PASS	N/A	TUNNEL	COMPOSITE PLAN, PROFILE AND CROSS SECTIONS	B2362+00 TO B3205+00
BOOK 4B	33	TT-D1402	PACHECO PASS	SERVICE ROAD 1	TUNNEL	COMPOSITE PLAN, PROFILE AND CROSS SECTIONS	B3205+00 TO B3295+00
BOOK 4B	34	TT-D1403	PACHECO PASS	N/A	TUNNEL	COMPOSITE PLAN, PROFILE AND CROSS SECTIONS	B3295+00 TO B3385+00
BOOK 4B	35	TT-D1404	PACHECO PASS	N/A	TUNNEL	COMPOSITE PLAN, PROFILE AND CROSS SECTIONS	B3385+00 TO B3475+00
BOOK 4B	36	TT-D1405	PACHECO PASS	SR 152	TUNNEL	COMPOSITE PLAN, PROFILE AND CROSS SECTIONS	B3475+00 TO B3565+00
BOOK 4B	37	TT-D1406	PACHECO PASS	N/A	TUNNEL	COMPOSITE PLAN, PROFILE AND CROSS SECTIONS	B3565+00 TO B3655+00
BOOK 4B	38	TT-D1407	PACHECO PASS	SR 152	TUNNEL	COMPOSITE PLAN, PROFILE AND CROSS SECTIONS	B3655+00 TO B3745+00
BOOK 4B	39	TT-D1408	PACHECO PASS	N/A	TUNNEL	COMPOSITE PLAN, PROFILE AND CROSS SECTIONS	B3745+00 TO B3835+00
BOOK 4B	40	TT-D1409	PACHECO PASS	N/A	TUNNEL	COMPOSITE PLAN, PROFILE AND CROSS SECTIONS	B3835+00 TO B3923+00
BOOK 4B	41	TT-D1410	PACHECO PASS	N/A	TUNNEL	COMPOSITE PLAN, PROFILE AND CROSS SECTIONS	B3923+00 TO B4014+00
BOOK 4B	42	TT-D1411	PACHECO PASS	MCCABE RD	TUNNEL	COMPOSITE PLAN, PROFILE AND CROSS SECTIONS	B4014+00 TO B4105+00
BOOK 4B	43	TT-D1412	PACHECO PASS	N/A	TUNNEL	COMPOSITE PLAN, PROFILE AND CROSS SECTIONS	B4105+00 TO B4196+00
BOOK 4B	44	TT-D1413	PACHECO PASS	N/A	TUNNEL	COMPOSITE PLAN, PROFILE AND CROSS SECTIONS	B4196+00 TO B4287+00
BOOK 4B	45	TT-D1414	PACHECO PASS	ROMERO RD N TO SR 33	TUNNEL	COMPOSITE PLAN, PROFILE AND CROSS SECTIONS	B4287+00 TO B4372+00
AN JOAQUIN '	VALLEY						
BOOK 4B	46	TT-D1601	SAN JOAQUIN VALLEY	FAHEY RD	HENRY MILLER ROAD	COMPOSITE PLAN, PROFILE AND CROSS SECTIONS	B4372+00 TO B4445+00
BOOK 4B	47	TT-D1602	SAN JOAQUIN VALLEY	CCID MAIN CANAL	HENRY MILLER ROAD	COMPOSITE PLAN, PROFILE AND CROSS SECTIONS	B4445+00 TO B4533+00
BOOK 4B	48	TT-D1603	SAN JOAQUIN VALLEY	INGOMAR GRADE RD	HENRY MILLER ROAD	COMPOSITE PLAN, PROFILE AND CROSS SECTIONS	B4533+00 TO B4614+00
BOOK 4B	49	TT-D1604	SAN JOAQUIN VALLEY	VOLTA RD TO HENRY MILLER RD	HENRY MILLER ROAD	COMPOSITE PLAN, PROFILE AND CROSS SECTIONS	B4614+00 TO B4686+00
BOOK 4B	50	TT-D1605	SAN JOAQUIN VALLEY	LEVEE ROAD TO MONROE AVE	HENRY MILLER ROAD	COMPOSITE PLAN, PROFILE AND CROSS SECTIONS	B4686+00 TO B4758+00
BOOK 4B	51	TT-D1606	SAN JOAQUIN VALLEY	BADGER FLAT RD TO NANTES AVE	HENRY MILLER ROAD	COMPOSITE PLAN, PROFILE AND CROSS SECTIONS	B4758+00 TO B4846+00
BOOK 4B	52	TT-D1607	SAN JOAQUIN VALLEY	SR-165 TO SANTA FE GRADE	HENRY MILLER ROAD	COMPOSITE PLAN, PROFILE AND CROSS SECTIONS	B4846+00 TO B4932+00
BOOK 4B	53	TT-D1608	SAN JOAQUIN VALLEY	N/A	HENRY MILLER ROAD	COMPOSITE PLAN, PROFILE AND CROSS SECTIONS	B4932+00 TO B5020+00
BOOK 4B	54	TT-D1609	SAN JOAQUIN VALLEY	BAKER RD TO DELTA RD	HENRY MILLER ROAD	COMPOSITE PLAN, PROFILE AND CROSS SECTIONS	B5020+00 TO B5109+00
BOOK 4B	55	TT-D1610	SAN JOAQUIN VALLEY	MIDWAY RD TO BOX CAR RD	HENRY MILLER ROAD	COMPOSITE PLAN, PROFILE AND CROSS SECTIONS	B5109+00 TO B5193+00
BOOK 4B	56	TT-D1611	SAN JOAQUIN VALLEY	TURNER ISLAND RD	HENRY MILLER ROAD	COMPOSITE PLAN, PROFILE AND CROSS SECTIONS	B5193+00 TO B5282+00
BOOK 4B	57	TT-D1612	SAN JOAQUIN VALLEY	CARLUCCI RD	HENRY MILLER ROAD	COMPOSITE PLAN, PROFILE AND CROSS SECTIONS	B5282+00 TO B5366+28.52

SAN JOSE TO CVY EIR/S: VOLUME III GENERAL INFORMATION BOOK **SHEET 29 OF 64**

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CALIFORNIA HIGH-SPEED TRAIN PROJECT **SAN JOSE TO MERCED**

ALTERNATIVE 4 INDEX OF DRAWING SHEET 2 OF 6

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OVER IND	EX OF DRAV	VING AND KEY	/ ΜΔΡς				
BOOK 4C	Δ Δ	COVER	SAN JOSE TO MERCED SECTION	N/A	SAN JOSE TO CENTRAL VALLEY WYE	ALTERNATIVE 4	
BOOK 4C	В	GE-A0403	SAN JOSE TO WERCED SECTION SAN JOSE DIRIDON STATION APPROACH, MORGAN HILL AND GILROY	STATIONS	INDEX OF DRAWING	SHEET 3 OF 6	
BOOK 4C	С	GE-D0401	GENERAL	ENTIRE ALTERNATIVE	KEY MAP	COMPOSITE PLAN	
BOOK 4C	D	GE-D0402	GENERAL	ENTIRE ALTERNATIVE	KEY MAP	SYSTEMS SITES	SHEET 1 OF 2
TATIONS							
BOOK 4C	58	AR-C0201	SAN JOSE DIRIDON STATION APPROACH	SANTA CLARA ST TO PARK AVE	BLENDED AT-GRADE ALTERNATIVE	SAN JOSE DIRIDON STATION	CONCEPTUAL SITE PLAN
BOOK 4C	59	AR-C0202	SAN JOSE DIRIDON STATION APPROACH	SANTA CLARA ST TO PARK AVE	BLENDED AT-GRADE ALTERNATIVE	SAN JOSE DIRIDON STATION	DETAILED SITE PLAN
BOOK 4C	60	AR-F0201	SAN JOSE DIRIDON STATION APPROACH	N/A	BLENDED AT-GRADE ALTERNATIVE	SAN JOSE DIRIDON STATION	CONCOURSE PLAN
BOOK 4C	61	AR-Y0201	SAN JOSE DIRIDON STATION APPROACH	N/A	BLENDED AT-GRADE ALTERNATIVE	SAN JOSE DIRIDON STATION	CROSS SECTION
BOOK 4C	62	AR-Y0202	SAN JOSE DIRIDON STATION APPROACH	N/A	BLENDED AT-GRADE ALTERNATIVE	SAN JOSE DIRIDON STATION	MASSING DIAGRAM 1
BOOK 4C	63	AR-Y0203	SAN JOSE DIRIDON STATION APPROACH	N/A	BLENDED AT-GRADE ALTERNATIVE	SAN JOSE DIRIDON STATION	MASSING DIAGRAM 2
BOOK 4C	64	AR-Y0204	SAN JOSE DIRIDON STATION APPROACH	N/A	BLENDED AT-GRADE ALTERNATIVE	SAN JOSE DIRIDON STATION	FACILITY SIZING TABLE
BOOK 4C	65	AR-Y0205	SAN JOSE DIRIDON STATION APPROACH	N/A	BLENDED AT-GRADE ALTERNATIVE	SAN JOSE DIRIDON STATION	FACILITY SIZING TABLE
BOOK 4C	66	AR-Y0206	SAN JOSE DIRIDON STATION APPROACH	N/A	BLENDED AT-GRADE ALTERNATIVE	SAN JOSE DIRIDON STATION	FACILITY SIZING TABLE
BOOK 4C	67	AR-C1201	MORGAN HILL AND GILROY	E 6TH ST TO E 10TH ST	BLENDED AT-GRADE ALTERNATIVE	DOWNTOWN GILROY STATION	GENERAL SITE PLAN
BOOK 4C	68	AR-C1202	MORGAN HILL AND GILROY	E 6TH ST TO E 10TH ST	BLENDED AT-GRADE ALTERNATIVE	DOWNTOWN GILROY STATION	DETAILED SITE PLAN
BOOK 4C	69	AR-F1201	MORGAN HILL AND GILROY	N/A	BLENDED AT-GRADE ALTERNATIVE	DOWNTOWN GILROY STATION	CONCOURSE PLAN
BOOK 4C	70	AR-Y1201	MORGAN HILL AND GILROY	N/A	BLENDED AT-GRADE ALTERNATIVE	DOWNTOWN GILROY STATION	SECTION
BOOK 4C	71	AR-Y1202	MORGAN HILL AND GILROY	N/A	BLENDED AT-GRADE ALTERNATIVE	DOWNTOWN GILROY STATION	MASSING DIAGRAM 1
BOOK 4C	72	AR-Y1203	MORGAN HILL AND GILROY	N/A	BLENDED AT-GRADE ALTERNATIVE	DOWNTOWN GILROY STATION	MASSING DIAGRAM 2
BOOK 4C	73	AR-Y1204	MORGAN HILL AND GILROY	N/A	BLENDED AT-GRADE ALTERNATIVE	DOWNTOWN GILROY STATION	FACILITY SIZING TABLE
BOOK 4C	74	AR-Y1205	MORGAN HILL AND GILROY	N/A	BLENDED AT-GRADE ALTERNATIVE	DOWNTOWN GILROY STATION	FACILITY SIZING TABLE
BOOK 4C	75	AR-Y1206	MORGAN HILL AND GILROY	N/A	BLENDED AT-GRADE ALTERNATIVE	DOWNTOWN GILROY STATION	FACILITY SIZING TABLE

SAN JOSE TO CVY EIR/S: VOLUME III GENERAL INFORMATION BOOK **SHEET 30 OF 64**

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1111 Broadway 9th Floor Oakland, CA 94607



CALIFORNIA HIGH-SPEED TRAIN PROJECT **SAN JOSE TO MERCED**


ALTERNATIVE 4 INDEX OF DRAWING SHEET 3 OF 6

CONTRACT NO. HSR15-34
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ВООК	SHEET NO	DRAWING NO	SUBSECTION	GEOGRAPHIC LOCATION	ALIGNMENT OR FEATURE	SHEET DESCRIPTION	ADDITIONAL DESCRIPTION
COVER, INDE	EX OF DRAV	VING AND KEY	MAPS				
BOOK 4D	Α	COVER	SAN JOSE TO MERCED SECTION	N/A	SAN JOSE TO CENTRAL VALLEY WYE	ALTERNATIVE 4	
BOOK 4D	В	GE-A0404	ENTIRE ALTERNATIVE	COMPLEX STRUCTURES, GRADE SEPARATIONS, MAINTENANCE OF WAY	INDEX OF DRAWING	SHEET 4 OF 6	
BOOK 4D	С	GE-D0401	GENERAL	ENTIRE ALTERNATIVE	KEY MAP	COMPOSITE PLAN	
BOOK 4D	D	GE-D0402	GENERAL	ENTIRE ALTERNATIVE	KEY MAP	SYSTEMS SITES	SHEET 1 OF 2
STRUCTURE							
BOOK 4D	76	ST-T4001	CP COAST TO GILROY	I-280 TO HWY 87	BLENDED AT-GRADE ALTERNATIVE	UNDERPASSES	GENERAL PLAN 1 OF 4
BOOK 4D	77	ST-T4002	CP COAST TO GILROY	N/A	BLENDED AT-GRADE ALTERNATIVE	UNDERPASSES	GENERAL PLAN 2 OF 4
BOOK 4D	78	ST-T4003	CP COAST TO GILROY	N/A	BLENDED AT-GRADE ALTERNATIVE	UNDERPASSES	GENERAL PLAN 3 OF 4
BOOK 4D	79	ST-T4004	CP COAST TO GILROY	N/A	BLENDED AT-GRADE ALTERNATIVE	UNDERPASSES	GENERAL PLAN 4 OF 4
BOOK 4D	80	ST-V4001	CP COAST TO GILROY	UPRR	BLENDED AT-GRADE ALTERNATIVE	COMPLEX STRUCTURES	GENERAL PLAN
BOOK 4D	81	ST-V1401	PACHECO PASS	CALIFORNIA AQUEDUCT TO CCID OUTSIDE CANAL	TUNNEL	COMPLEX STRUCTURES	GENERAL PLAN
BOOK 4D	82	ST-V1601	SAN JOAQUIN VALLEY	SAN LUIS WASTEWAY TO LOS BANOS CREEK	HENRY MILLER ROAD	COMPLEX STRUCTURES	GENERAL PLAN
BOOK 4D ACHECO PASS	83	CV-S4001	CP COAST TO GILROY	EMADO AVE TO FOX LANE	BLENDED AT-GRADE ALTERNATIVE	CIVIL DETAILS	
BOOK 4D	84	CV-S1401	PACHECO PASS	ROMERO RD TO CA-152	TUNNEL	CIVIL DETAILS	
AN JOAQUIN V		CV-31401	PACHECO PASS	ROWERO ND TO CA-132	TOININEL	CIVIL DETAILS	
BOOK 4D	85	CV-S1601	SAN JOAQUIN VALLEY	MONTEREY RD TO INGOMAR GRADE	HENRY MILLER ROAD	CIVIL DETAILS	
BOOK 4D	86	CV-T1603	SAN JOAQUIN VALLEY	VOLTA RD TO HENRY MILLER RD	HENRY MILLER ROAD	GRADE SEPARATION LAYOUT, PROFILE, & CROSS SECTIONS	HENRY MILLER ROAD
BOOK 4D	87	CV-T1604	SAN JOAQUIN VALLEY	HENRY MILLER ACCESS	HENRY MILLER ROAD	GRADE SEPARATION LAYOUT, PROFILE, & CROSS SECTIONS	HENRY MILLER ACCESS
BOOK 4D	88	CV-T1606	SAN JOAQUIN VALLEY	HENRY MILLER RD TO MERCEY SPRINGS RD	HENRY MILLER ROAD	GRADE SEPARATION LAYOUT, PROFILE, & CROSS SECTIONS	MERCEY SPRINGS ROAD
BOOK 4D	89	CV-T1609	SAN JOAQUIN VALLEY	DELTA RD	HENRY MILLER ROAD	GRADE SEPARATION LAYOUT, PROFILE, & CROSS SECTIONS	DELTA ROAD
BOOK 4D	90	CV-T1610	SAN JOAQUIN VALLEY	TURNER ISLAND RD TO HENRY MILLER RD	HENRY MILLER ROAD	GRADE SEPARATION LAYOUT, PROFILE, & CROSS SECTIONS	TURNER ROAD
BOOK 4D	91	CV-T1611	SAN JOAQUIN VALLEY	CARLUCCI RD	HENRY MILLER ROAD	GRADE SEPARATION LAYOUT, PROFILE, & CROSS SECTIONS	CARLUCCI ROAD
BOOK 4D	92	CV-T1612	SAN JOAQUIN VALLEY	HUTCHINS RD	HENRY MILLER ROAD	GRADE SEPARATION LAYOUT, PROFILE, & CROSS SECTIONS	HUTCHINS ROAD
MAINTENAN	ICE OF WA	Υ					
BOOK 4D	93	MY-D4100	CP COAST TO GILROY	CARNADERO AVE TO UPRR	BLENDED AT-GRADE ALTERNATIVE	MOWF DETAIL	SHEET 1 OF 4
BOOK 4D	94	MY-D4101	CP COAST TO GILROY	BLOOMFIELD RD	BLENDED AT-GRADE ALTERNATIVE	MOWF DETAIL	SHEET 2 OF 4
BOOK 4D	95	MY-D4102	CP COAST TO GILROY	N/A	BLENDED AT-GRADE ALTERNATIVE	MOWF DETAIL	SHEET 3 OF 4
BOOK 4D	96	MY-D4103	CP COAST TO GILROY	N/A	BLENDED AT-GRADE ALTERNATIVE	MOWF DETAIL	SHEET 4 OF 4
BOOK 4D	97	MY-D4104	CP COAST TO GILROY	N/A	BLENDED AT-GRADE ALTERNATIVE	UPRR PROFILE FOR MOWF	SHEET 1 OF 2
BOOK 4D	98	MY-D4105	CP COAST TO GILROY	N/A	BLENDED AT-GRADE ALTERNATIVE	UPRR PROFILE FOR MOWF	SHEET 2 OF 2
BOOK 4D	99	MY-D4106	CP COAST TO GILROY	N/A	BLENDED AT-GRADE ALTERNATIVE	MAINTENANCE OF WAY FACILITY	UPRR AND MOWF ACCESS GEOMETR

SAN JOSE TO CVY EIR/S: VOLUME III **GENERAL INFORMATION BOOK SHEET 31 OF 64**



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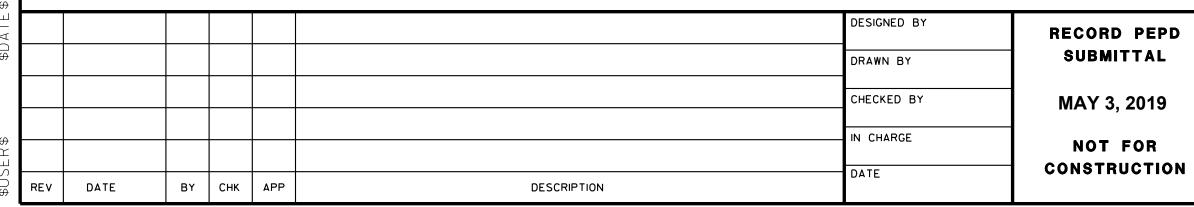
CALIFORNIA HIGH-SPEED TRAIN PROJECT **SAN JOSE TO MERCED**

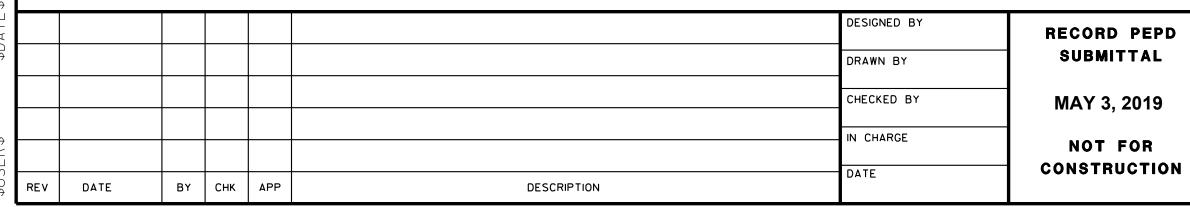ALTERNATIVE 4 INDEX OF DRAWING SHEET 4 OF 6

CONTRACT NO.
HSR15-34
DRAWING NO.
GE-A0404
SCALE
NONE
SHEET NO.

LTERNATI	/E 4 - CP CO	AST TO DOWNT	TOWN GILROY				
ВООК	SHEET NO	DRAWING NO	SUBSECTION	GEOGRAPHIC LOCATION	ALIGNMENT OR FEATURE	SHEET DESCRIPTION	ADDITIONAL DESCRIPTION
OVER, IND	EX OF DRAV	VING AND KEY I	MAPS				
BOOK 4E	А	COVER	SAN JOSE TO MERCED SECTION	N/A	SAN JOSE TO CENTRAL VALLEY WYE	ALTERNATIVE 4	
BOOK 4E	В	GE-A0405	ENTIRE ALTERNATIVE	TUNNELS, CONSTRUCTION STAGING	INDEX OF DRAWING	SHEET 5 OF 6	
BOOK 4E	С	GE-A0406	ENTIRE ALTERNATIVE	ALIGNMENT DATA TABLES	INDEX OF DRAWING	SHEET 6 OF 6	
BOOK 4E	D	GE-D0401	GENERAL	ENTIRE ALTERNATIVE	KEY MAP	COMPOSITE PLAN	
BOOK 4E	E	GE-D0402	GENERAL	ENTIRE ALTERNATIVE	KEY MAP	SYSTEMS SITES	SHEET 1 OF 2
JNNELS - F	PACHECO PA	SS					
BOOK 4E	100	TN-D1404	PACHECO PASS	N/A	TUNNEL	TUNNEL 2 - PORTAL 1	
BOOK 4E	101	TN-D1405	PACHECO PASS	ACCESS RD 1	TUNNEL	TUNNEL PORTAL 2 ACCESS ROAD	
BOOK 4E	102	TN-D1406	PACHECO PASS	CALIFORNIA AQUEDUCT	TUNNEL	TUNNEL PORTAL 2 ACCESS ROAD	
BOOK 4E	103	TN-D1407	PACHECO PASS	ACCESS RD 2	TUNNEL	TUNNEL PORTAL 2 ACCESS ROAD	
BOOK 4E	104	TN-D1408	PACHECO PASS	N/A	TUNNEL	LONGITUDINAL PROFILE	
BOOK 4E	105	TN-D1409	PACHECO PASS		TUNNEL	GRADING DETAIL	
BOOK 4E	106	TN-D1410	PACHECO PASS	N/A	TUNNEL	GRADING DETAIL	
BOOK 4E	107	TN-D1411	PACHECO PASS	N/A	TUNNEL	GRADING DETAIL	
BOOK 4E	108	TN-D1412	PACHECO PASS	N/A	TUNNEL	GRADING DETAIL	
BOOK 4E	109	TN-D1413	PACHECO PASS	I-5, FAHEY RD	TUNNEL	GRADING DETAIL	
BOOK 4E	110	TN-D1414	PACHECO PASS	N/A	TUNNEL	TUNNEL 2 - PORTAL 1	SECTIONS
BOOK 4E	111	TN-D1415	PACHECO PASS	N/A	TUNNEL	TUNNEL 2 - PORTAL 2	APPROACH 1
BOOK 4E	112	TN-D1416	PACHECO PASS	N/A	TUNNEL	TUNNEL 2 - PORTAL 2	APPROACH 2
ONSTRUCT	TION STAGIN	IG					
BOOK 4E	113	CV-I1601	SAN JOAQUIN VALLEY	N/A	HENRY MILLER ROAD	CONSTRUCTION STAGING PLAN	GENERAL NOTES
BOOK 4E	114	CV-I1602	SAN JOAQUIN VALLEY	INGOMAR GRADE RD AT HENRY MILLER RD	HENRY MILLER ROAD	CONSTRUCTION STAGING PLAN	HENRY MILLER ROAD GRADE SEPARATION
BOOK 4E	115	CV-I1603	SAN JOAQUIN VALLEY	HENRY MILLER RD	HENRY MILLER ROAD	CONSTRUCTION STAGING PLAN	HENRY MILLER ROAD GRADE SEPARATION
BOOK 4E	116	CV-I1604	SAN JOAQUIN VALLEY	HENRY MILLER RD AT MERCEY SPRINGS RD	HENRY MILLER ROAD	CONSTRUCTION STAGING PLAN	SR-165 / MERCEY SPRINGS ROAD GRADE SEPARA
BOOK 4E	117	CV-I1605	SAN JOAQUIN VALLEY	HENRY MILLER RD AT DELTA RD	HENRY MILLER ROAD	CONSTRUCTION STAGING PLAN	DELTA ROAD GRADE SEPARATION
BOOK 4E	118	CV-I1606	SAN JOAQUIN VALLEY	HENRY MILLER RD AT TURNER ISLAND RD	HENRY MILLER ROAD	CONSTRUCTION STAGING PLAN	TURNER ISLAND ROAD GRADE SEPARATION
BOOK 4E	119	CV-I1607	SAN JOAQUIN VALLEY	HENRY MILLER RD AT CARLUCCI RD	HENRY MILLER ROAD	CONSTRUCTION STAGING PLAN	CARLUCCI ROAD GRADE SEPARATION

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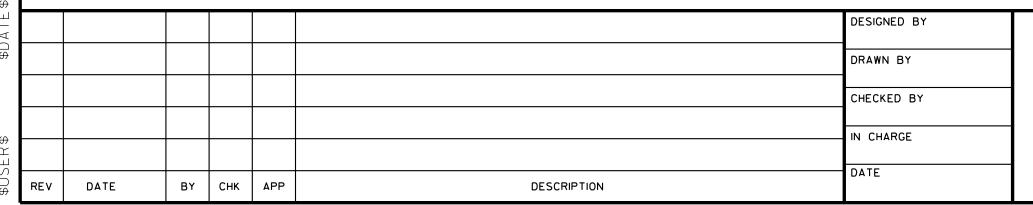
CALIFORNIA HIGH-SPEED TRAIN PROJECT **SAN JOSE TO MERCED**

ALTERNATIVE 4 INDEX OF DRAWING SHEET 5 OF 6

CONTRACT NO. HSR15-34
DRAWING NO. GE-A0405
SCALE NONE
SHEET NO.

K 4E	120	TT-B4001	ALTERNATIVE 4	N/A	MT3 TRACK ALIGNMENT DATA TABLE	CURVE NO. C401 TO C404	CURVE NO. C401 TO C404
)K 4E	121	TT-B4001	ALTERNATIVE 4	N/A	MT3 TRACK ALIGNMENT DATA TABLE	CURVE NO. C405 TO C408	CURVE NO. C405 TO C408
OK 4E	122	TT-B4002	ALTERNATIVE 4	N/A	MT3 TRACK ALIGNMENT DATA TABLE	CURVE NO. C409 TO C414	CURVE NO. C403 TO C408
OK 4E	123	TT-B4003	ALTERNATIVE 4	N/A	MT3 TRACK ALIGNMENT DATA TABLE	CURVE NO. C415 TO C418	CURVE NO. C415 TO C418
OK 4E	124	TT-B4004	ALTERNATIVE 4	N/A	MT3 TRACK ALIGNMENT DATA TABLE	CURVE NO. C419	CURVE NO. C419
OOK 4E	125	TT-B4006	ALTERNATIVE 4	N/A	MT3 TRACK ALIGNMENT DATA TABLE	CURVE NO. C420 TO C423	CURVE NO. C420 TO C423
OOK 4E	126	TT-B4007	ALTERNATIVE 4	N/A	MT3 TRACK ALIGNMENT DATA TABLE	CURVE NO. C424 TO C427	CURVE NO. C424 TO C427
OOK 4E	127	TT-B4007	ALTERNATIVE 4	N/A	MT3 TRACK ALIGNMENT DATA TABLE	CURVE NO. C424 TO C427 CURVE NO. C428 TO C431	CURVE NO. C424 TO C427
300K 4E	128	TT-B4009	ALTERNATIVE 4	N/A	MT3 TRACK ALIGNMENT DATA TABLE	CURVE NO. C432 TO C435	CURVE NO. C432 TO C435
300K 4E 300K 4E	129	TT-B4010	ALTERNATIVE 4	N/A	MT3 TRACK ALIGNMENT DATA TABLE	CURVE NO. C432 TO C439	CURVE NO. C432 TO C433
BOOK 4E	130	TT-B4011	ALTERNATIVE 4	N/A	MT3 TRACK ALIGNMENT DATA TABLE	CURVE NO. C440 TO C443	CURVE NO. C440 TO C443
BOOK 4E	131	TT-B4012	ALTERNATIVE 4	N/A	MT3 TRACK ALIGNMENT DATA TABLE	CURVE NO. C444 TO C447	CURVE NO. C444 TO C447
BOOK 4E	132	TT-B4013	ALTERNATIVE 4	N/A	MT3 TRACK ALIGNMENT DATA TABLE	CURVE NO. C448 TO C451	CURVE NO. C448 TO C451
OOK 4E	133	TT-B4014	ALTERNATIVE 4	N/A	MT3 TRACK ALIGNMENT DATA TABLE	CURVE NO. C452 TO C453	CURVE NO. C452 TO C453
BOOK 4E	134	TT-B0120	MORGAN HILL AND GILROY	N/A	TRACK GUIDEWAY	B2 TRACK ALIGNMENT DATA TABLE	CURVE NO. C127 AND C128
BOOK 4E	135	TT-B0121	MORGAN HILL AND GILROY	N/A	TRACK GUIDEWAY	B2 TRACK ALIGNMENT DATA TABLE	CURVE NO. C129
BOOK 4E	136	TT-B0122	MORGAN HILL AND GILROY	N/A	TRACK GUIDEWAY	B2 TRACK ALIGNMENT DATA TABLE	CURVE NO. C130
BOOK 4E	137	TT-B0123	PACHECO PASS	N/A	TRACK GUIDEWAY	B2 TRACK ALIGNMENT DATA TABLE	CURVE NO. C131
BOOK 4E	138	TT-B0124	PACHECO PASS	N/A	TRACK GUIDEWAY	B2 TRACK ALIGNMENT DATA TABLE	CURVE NO. C132 AND C133
BOOK 4E	139	TT-B0125	PACHECO PASS		TRACK GUIDEWAY	B2 TRACK ALIGNMENT DATA TABLE	CURVE NO. C134 AND C135
BOOK 4E	140	TT-B0126	PACHECO PASS	 N/A	TRACK GUIDEWAY	B2 TRACK ALIGNMENT DATA TABLE	CURVE NO. C136
BOOK 4E	141	TT-B0127	SAN JOAQUIN VALLEY	N/A	TRACK GUIDEWAY	B2 TRACK ALIGNMENT DATA TABLE	CURVE NO. C137
BOOK 4E	142	TT-B0128	SAN JOAQUIN VALLEY	N/A	TRACK GUIDEWAY	B2 TRACK ALIGNMENT DATA TABLE	CURVE NO. C138 AND C139
OOK 4E	143	TT-B0129	SAN JOAQUIN VALLEY	N/A	TRACK GUIDEWAY	B2 TRACK ALIGNMENT DATA TABLE	CURVE NO. C140
OOK 4E	144	TT-B0130	MORGAN HILL AND GILROY	N/A	TRACK GUIDEWAY	B1 TRACK ALIGNMENT DATA TABLE	CURVE NO. C230
300K 4E	145	TT-B0131	MORGAN HILL AND GILROY	N/A	TRACK GUIDEWAY	B1 TRACK ALIGNMENT DATA TABLE	CURVE NO. C231 AND C231A
OOK 4E	146	TT-B0132	PACHECO PASS	N/A	TRACK GUIDEWAY	B1 TRACK ALIGNMENT DATA TABLE	CURVE NO. C232 AND C233
BOOK 4E	147	TT-B0133	PACHECO PASS	N/A	TRACK GUIDEWAY	B1 TRACK ALIGNMENT DATA TABLE	CURVE NO. C234 AND C235
BOOK 4E	148	TT-B0134	PACHECO PASS	N/A	TRACK GUIDEWAY	B1 TRACK ALIGNMENT DATA TABLE	CURVE NO. C236

SAN JOSE TO CVY EIR/S: VOLUME III **GENERAL INFORMATION BOOK SHEET 33 OF 64**



ALTERNATIVE 4 - CP COAST TO DOWNTOWN GILROY

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CALIFORNIA HIGH-SPEED TRAIN PROJECT **SAN JOSE TO MERCED**

ALTERNATIVE 4 INDEX OF DRAWING SHEET 6 OF 6

CONTRACT NO. HSR15-34
DRAWING NO. GE-A0406
scale NONE
SHEET NO.


ALTERNATIVE 1 BOOK INDEX

BOOK 1A: COMPOSITE PLAN, PROFILE AND CROSS SECTIONS

BOOK 1B: COMPOSITE PLAN, PROFILE AND CROSS SECTIONS, STATIONS, STRUCTURES

BOOK 1C: ROADWAY, MAINTENANCE OF WAY, TUNNELS -PACHECO PASS

BOOK 1D: CONSTRUCTION STAGING, ALIGNMENT DATA TABLES

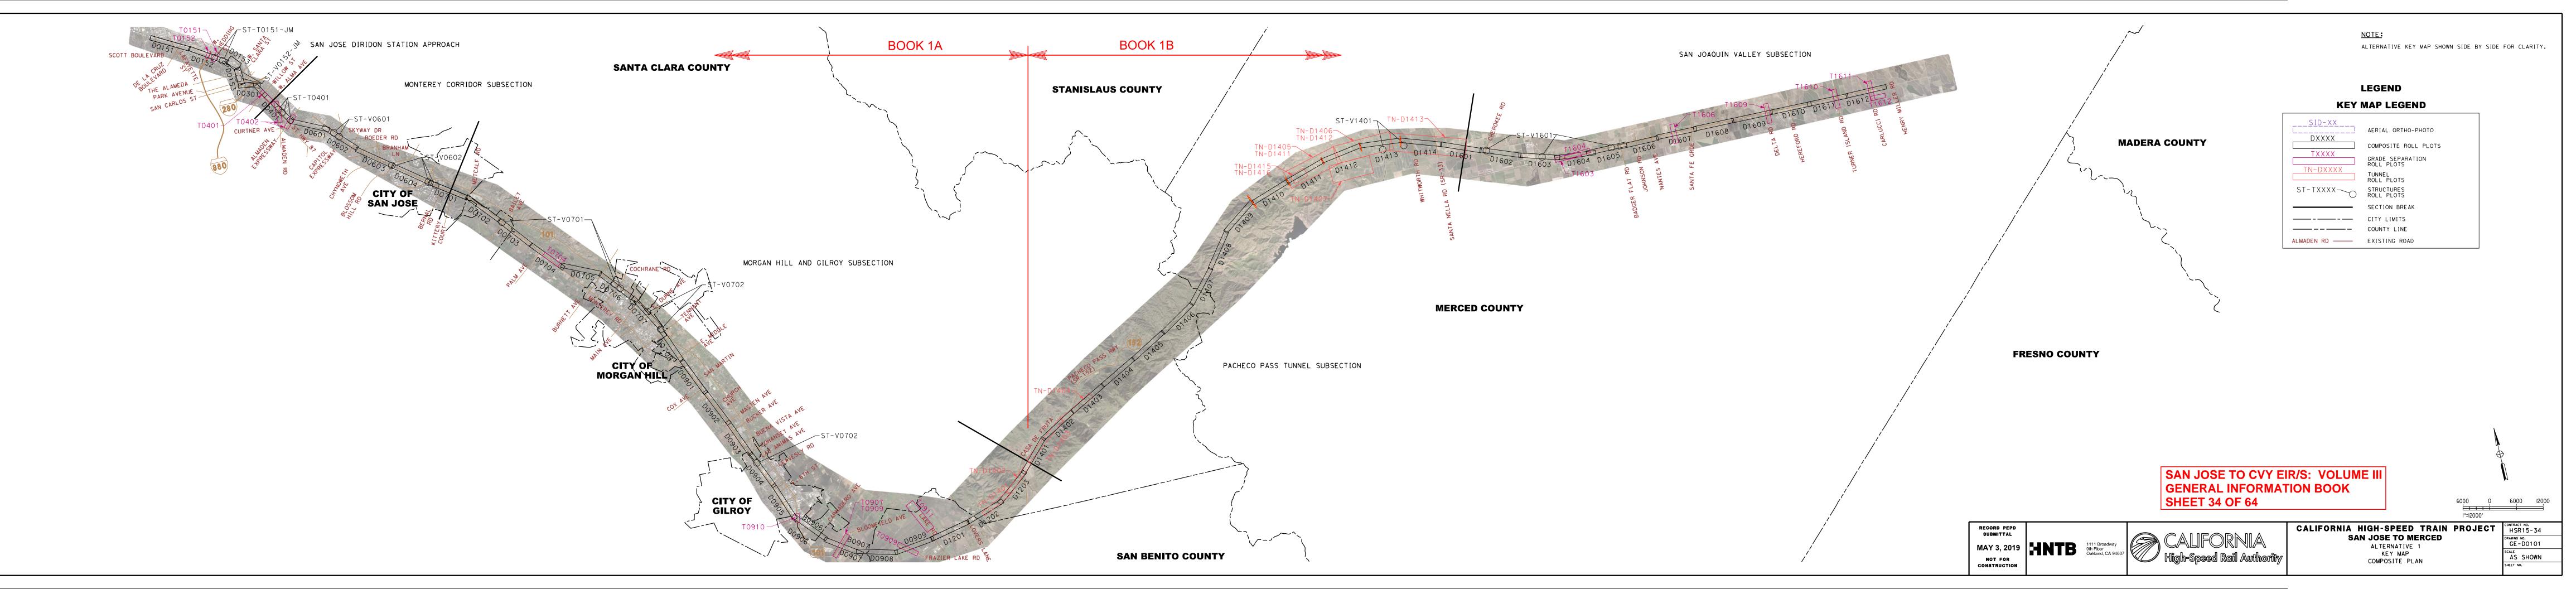

ALTERNATIVE 2 BOOK INDEX


BOOK 2A: COMPOSITE PLAN, PROFILE AND CROSS SECTIONS

BOOK 2B: COMPOSITE PLAN, PROFILE AND CROSS SECTIONS, STATIONS, STRUCTURES

BOOK 2C: ROADWAY

BOOK 2D: ROADWAY, MAINTENANCE OF WAY, TUNNELS - PACHECO PASS

BOOK 2E: CONSTRUCTION STAGING, ALIGNMENT DATA TABLES

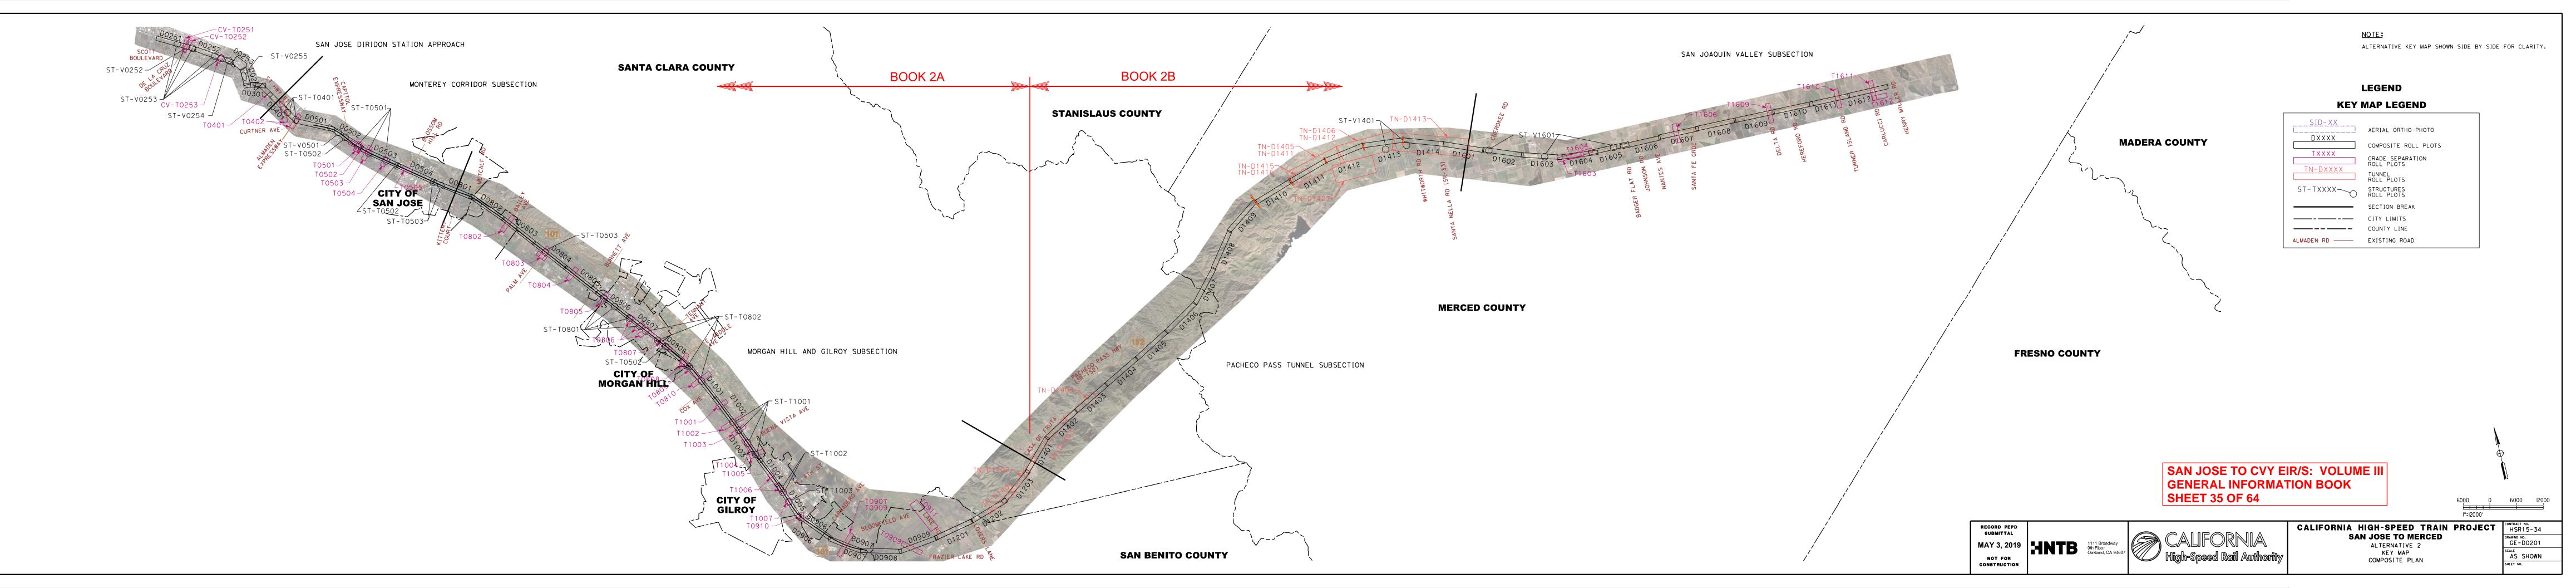

ALTERNATIVE 3 BOOK INDEX

BOOK 3A: COMPOSITE PLAN, PROFILE AND CROSS SECTIONS


BOOK 3B: COMPOSITE PLAN, PROFILE AND CROSS SECTIONS, STATIONS

BOOK 3C: STRUCTURES, ROADWAY

BOOK 3D: ROADWAY, MAINTENANCE OF WAY, TUNNELS -PACHECO PASS

BOOK 3E: CONSTRUCTION STAGING

BOOK 3F: ALIGNMENT DATA TABLES

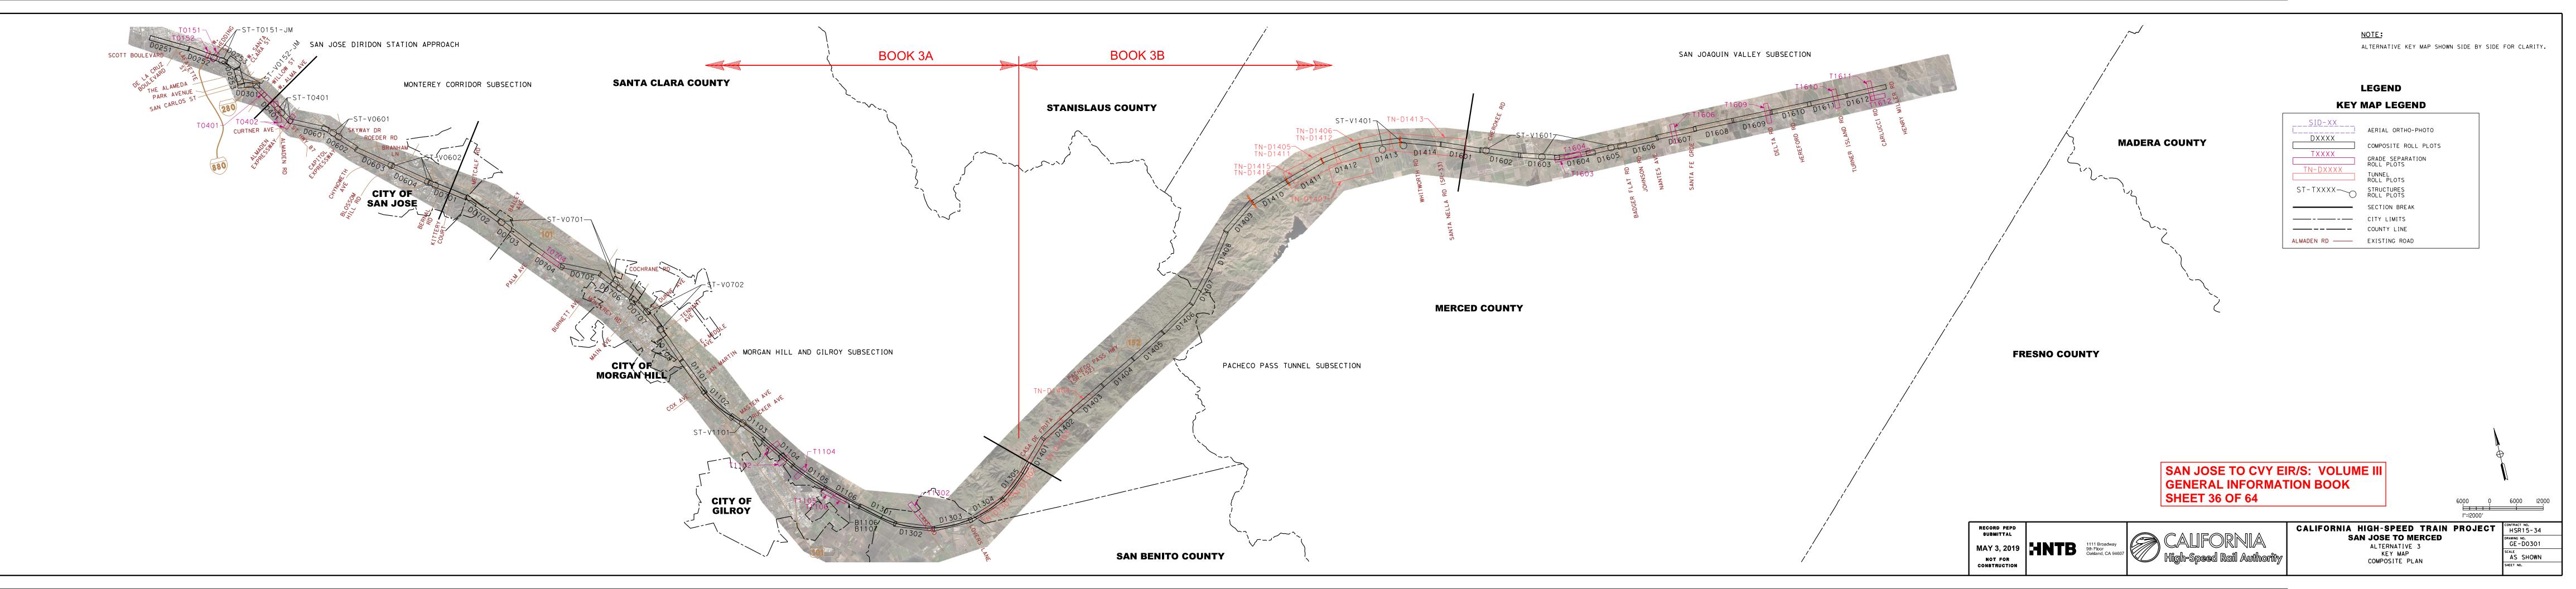

ALTERNATIVE 4 BOOK INDEX


BOOK 4A: COMPOSITE PLAN, PROFILE AND CROSS SECTIONS

BOOK 4B: COMPOSITE PLAN, PROFILE AND CROSS SECTIONS

BOOK 4C: STATIONS

BOOK 4D: STRUCTURES, ROADWAY,
MAINTENANCE OF WAY

BOOK 4E: TUNNELS - PACHECO PASS, CONSTRUCTION STAGING, ALIGNMENT DATA TABLES

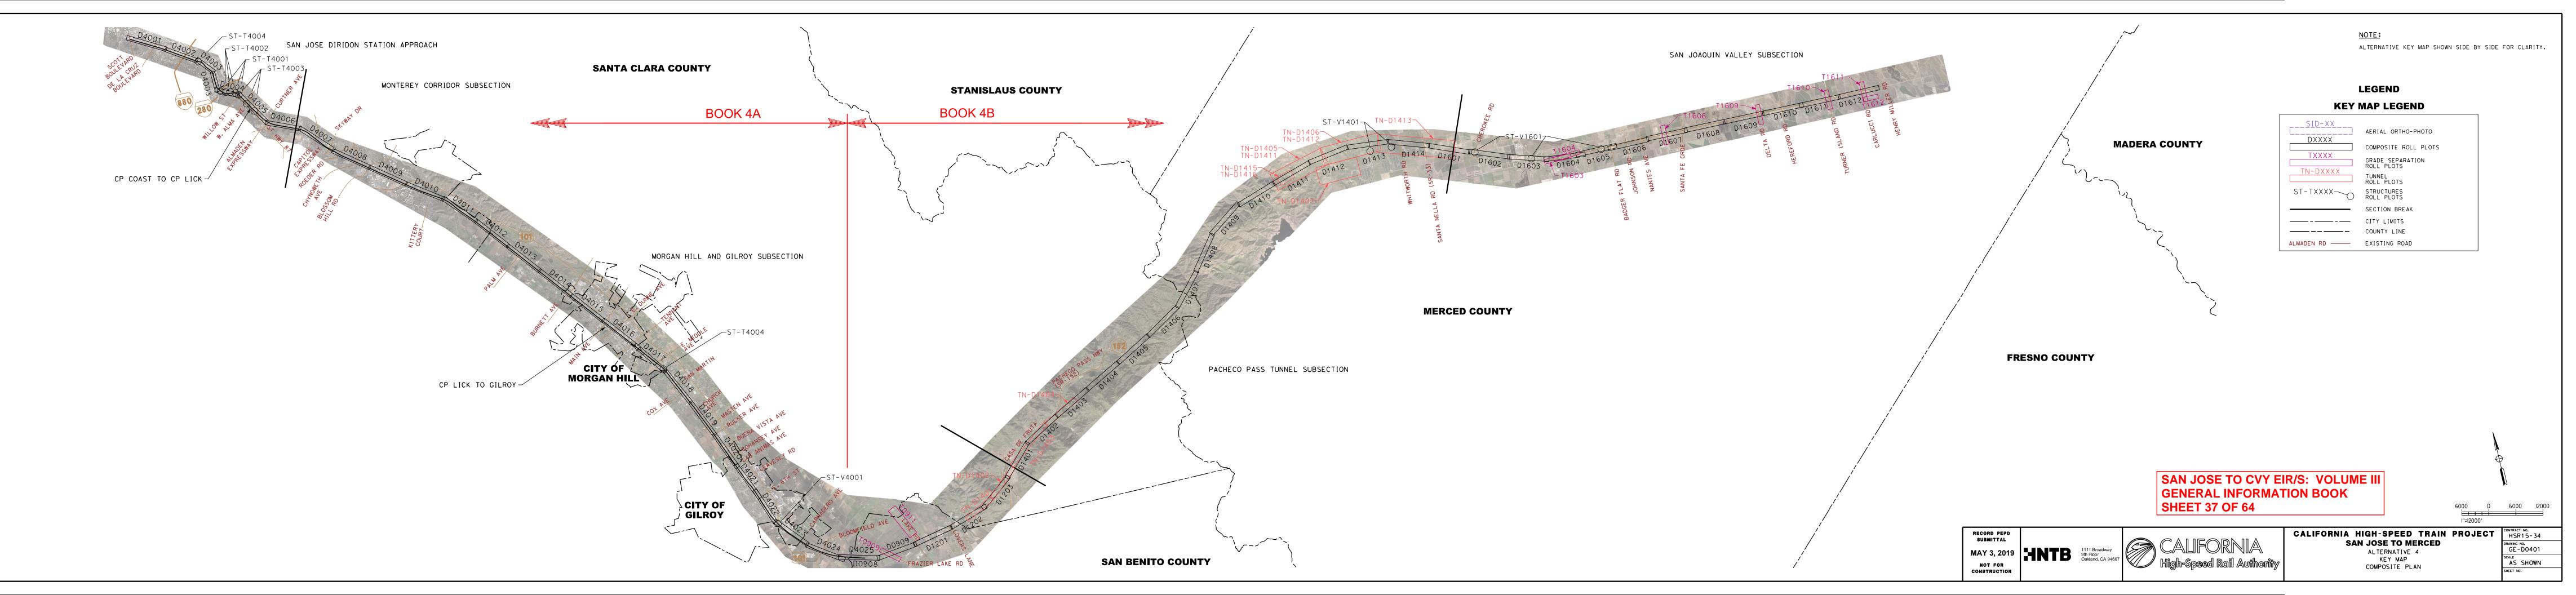

- AERIAL BASE MAPPING DATED NOVEMBER 2016 WAS PROVIDED BY TOWILL, INC..
- TOPOGRAPHIC BASE MAPPING DATED 2015 WAS PROVIDED
- 4. THE HORIZONTAL DATUM IS NAD83 AND THE VERTICAL DATUM IS NAVD88.

TRACK GENERAL NOTES

- 1. HST TRACK DESIGN IS PER HST TECHNICAL MEMORANDUM 2.1.2 ALIGNMENT DESIGN STANDARDS FOR HIGH-SPEED TRAIN OPERATION, 2.1.3 TURNOUTS AND STATION TRACKS, AND 2.1.8 TURNOUTS AND YARD TRACKS. TRACK DESIGN FOR BLENDED OPERATIONS IS PER CALTRAIN DESIGN CRITERIA CHAPTER 2 (MODIFIED).
- 2. STATIONING INCREASES FROM NORTH TO SOUTH. CONTROL STATIONING IS ON B2/MT3 TRACK.
- 3. THE PROFILE CORRESPONDS TO THE ELEVATION AT THE TOP OF LOW RAIL ON THE B2/MT3 TRACK. THE LENGTHS OF LINES ARE BASED ON THE CENTER OF TRACK ALIGNMENT. UNLESS SEPARATE TRACK PROFILES ARE GIVEN, TRACKS PARALLEL TO THE DESIGNATED TRACK AT THE SAME TOP OF RAIL ELEVATIONS PROJECTED ON EITHER PERPENDICULAR OR RADIAL LINES FROM THE DESIGNATED TRACK CENTERLINES.
- 4. TRACK HORIZONTAL CURVE INFORMATION PROVIDED IN TRACK GEOMETRY DATA DRAWINGS.
- TRACK ALIGNMENT CURVATURE IS CHORD DEFINED.
- 6. FOR TRACK SPACING AND DIMENSIONS RELATIVE TO OTHER DESIGN ELEMENTS SEE COMPOSITE ROLL PLOT TYPICAL SECTIONS.
- 7. FOR STRUCTURAL DETAILS REFER TO TUNNEL AND STRUCTURE TYPICAL SECTIONS DRAWINGS.
- 8. FOR STRUCTURAL IMPROVEMENTS AND VERTICAL CLEARANCE FROM TOP OF RAIL TO STRUCTURE ELEMENTS, SEE STRUCTURE DRAWINGS.
- 9. FOR HST STATIONS, SEE STATIONS DRAWINGS.
- 10. FOR ROADWAY CROSSINGS IMPACTS AND IMPROVEMENTS, SEE ROADWAY PLAN, PROFILE AND TYPICAL SECTION DRAWINGS.
- 11. DETAILED TRACK PLAN AND PROFILE SHEETS FOR RELOCATION OF FREIGHT CONNECTIONS, STORAGE TRACKS, TRACK SIDING AND MINOR UPRR TRACK MODIFICATIONS ARE NOT INCLUDED.
- 12. DIMENSIONS OF INTRUSION BARRIER SHOWN CONCEPTUALLY ON TYPICALS AND TO BE CONFIRMED BY FINAL DESIGNER.

CIVIL GENERAL NOTES


- 1. ALL ROADWAY GEOMETRY DESIGN IS PER THE FOLLOWING STANDARDS:
 - FOR HIGH SPEED TRAIN FACILITIES, FOLLOW CALIFORNIA HIGH SPEED RAIL TECHNICAL MEMORANDUM.
 - FOR STATE HIGHWAY FACILITIES, FOLLOW CALTRANS STANDARD DRAWINGS AND SPECIFICATIONS.
 - FOR CITY AND COUNTY STREETS, FOLLOW CITY AND COUNTY STANDARDS, AASHTO "GEOMETRIC DESIGN OF HIGHWAYS AND STREETS" (LATEST EDITION), AND FHWA "MUTCD" (LATEST EDITION) OR AS DIRECTED BY LOCAL JURISDICTION IN CHARGE.
- 2. ALL KNOWN MAJOR UTILITIES ARE SHOWN ON THE PLANS. MAJOR UTILITIES ARE SUBSURFACE, ABOVE GROUND, OR OVERHEAD FACILITY USED FOR TRANSMISSION, RÉGARDLESS OF SHAPE SIZE, SHAPE, OR METHOD OF CONVEYANCE. PLEASE REFERENCE THE SECTION UTILITY REPORT FOR A DISCUSSION OF HIGH VS. LOW RISK AND MINOR UTILITIES.
- 3. UTILITIES WITHOUT DISPOSITIONS ARE ASSUMED TO BE AT AN EXISTING DEPTH OR HEIGHT THAT WILL NOT BE IMPACTED BY WORK.
- 4. RETAINING WALL TYPES ARE NOT SHOWN DUE TO CURRENT LACK OF GEOTECHNICAL BORINGS. IT CAN BE ASSUMED FOR COST PURPOSES THAT ALL FILL RETAINING WALLS ARE MSE AND THAT ALL CUT RETAINING WALLS ARE SOIL NAIL. PRELIMINARY RETAINING WALL TYPES WILL BE FINALIZED BASED ON 30% GEOTECHNICAL EXPLORATION.
- MAJOR WATERCOURSES, IRRIGATION CANALS, AND BODIES OF WATER ARE SHOWN ON THE PLANS. FOR FURTHER INFORMATION REGARDING DRAINAGE DESIGN, PLEASE REFER TO THE FOLLOWING:
 - HYDROLOGY AND HYDRAULICS REPORT
 - FLOODPLAIN IMPACTS ASSESSMENT REPORT - STORM WATER MANAGEMENT REPORT
- WHERE PROPOSED ROADWAY ROW AND ROADWAY TCE LINES CROSS PERPENDICULAR TO EXISTING ROADWAY ROW LINES, IT IS ASSUMED THESE LINES SHOW A DEMARCATION OF CONSTRUCTION LIMITS. THEY ARE NOT TO BE CONSTRUED AS A JURISDICTIONAL TRANSFER.
- 7. EMERGENCY VEHICLE ACCESS (22' WIDTH) SHALL BE PROVIDED WHERE SPACE IS AVAILABLE. FOR MONTEREY VIADUCT, EMERGENCY VEHICLE TO UTILIZE MONTEREY ROAD FOR EMERGENCY ACCESS.
- 8. PER TM 2.8.1, SECTION 3.3.6, FOR GROUND LEVEL LESS THAN 10' BELOW THE UNDERSIDE OF THE STRUCTURE, AERIAL STRUCTURE SECTION SHALL BE PROTECTED WITH AR FENCING LOCATED TWO FEET FROM THE DRIP-LINE OF THE STRUCTURE.
- 9. THE FLOODPLAIN ZONE LIMIT LINES SHOWN ARE FROM EXISTING FEMA MAPS. CERTAIN AREAS OF EACH ALTERNATIVE HAVE ON-GOING FLOODPLAIN MODELING EFFORTS THAT WILL CHANGE THE LOCATION OF THE FLOODPLAIN LIMIT LINES.
- 10. ACCESS RESTRICTION (AR) FENCING TO BE PROVIDED IN ACCORDANCE WITH HSR DIRECTIVE DRAWING DD-CV-006 (FROM HSR 13-06 BOOK 3. PART 3. SUBPART 1). AND THE FOLLOWING:
 - AR FENCING TO BE PLACED ALONG THE PERIMETER OF HSR RE-CONTOURED SLOPES PROXIMATE TO THE GUIDEWAY AND ALONG THE TOP OF WILDLIFE UNDERCROSSING INGWALLS AND HEADWALLS BETWEEN CASA DE FRUTA FIELDS AND THE VIADUCT APPROACH TO THE WEST PORTAL OF TUNNEL 2.
 - PERMANENT FIELD FENCING (3-FOOT-TALL, 3 STRANDS WIRE OR AD-TYPE, WITH NO-TRESPASS SIGNAGE) TO BE PLACED AT THE OUTER ROW PERIMETER OF HSR-MANAGED SLOPES TO ALLOW WILDLIFE PASSAGE AND ACCESS TO WILDLIFE UNDERCROSSINGS.

GRADING DESIGN ASSUMPTIONS


- 1. CUT AND FILL LINES (CONFORMING TO EXISTING GROUND):
 - 2:1 SLOPES FOR AT-GRADE TRACKS
 - 4'FROM OPEN TRENCH OUTER WALLS - 4:1 SLOPES FOR ROADWAY EMBANKMENTS
- 2. RETAINING WALLS ARE PROPOSED WHEN 2:1 SLOPES WOULD CONFORM OUTSIDE OF THE EXISTING OR PROPOSED RIGHT OF WAY.

WILDLIFE CROSSING NOTES

1. VIADUCTS IDENTIFIED AS REQUIRED FOR WILDLIFE MOVEMENT CANNOT BE CONVERTED TO ANOTHER STRUCTURE TYPE WITHOUT ADDITIONAL ENVIRONMENTAL ANALYSIS AND DOCUMENTATION.

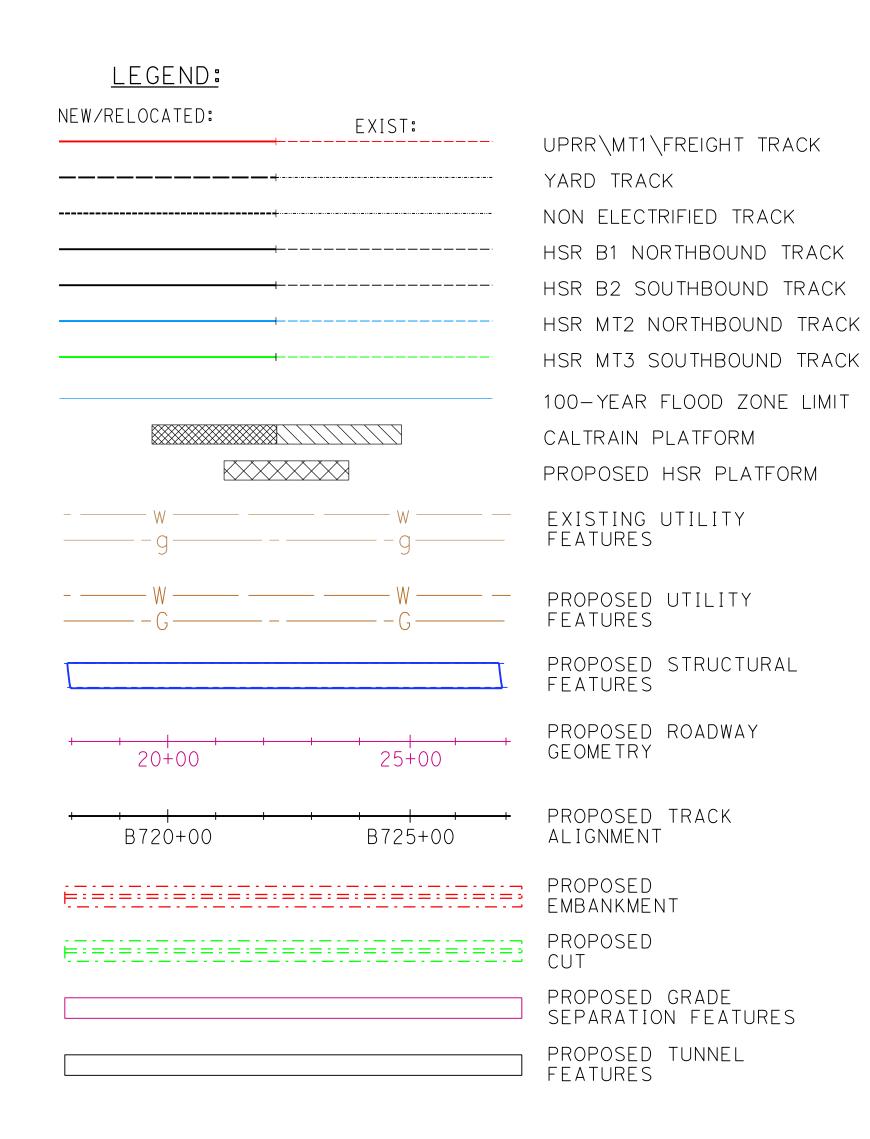

SAN JOSE TO CVY EIR/S: VOLUME III **GENERAL INFORMATION BOOK SHEET 38 OF 64**

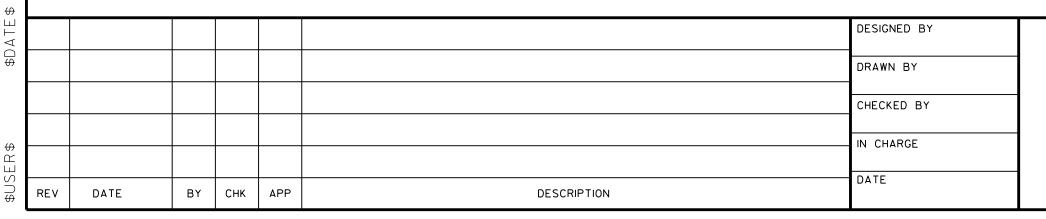

RECORD PEPD SUBMITTAL

MAY 3, 2019

NOT FOR CONSTRUCTION HNTB



CALIFORNIA HIGH-SPEED TRAIN PROJECT **SAN JOSE TO MERCED**

GENERAL GENERAL NOTES

CONTRACT NO. HSR15-34
DRAWING NO. GE-BOOO1
scale NONE
SHEET NO.

SPECIFICATIONS FOR DESIGN AND CONSTRUCTION

- 1. ALL STRUCTURAL GENERAL NOTES SHALL BE READ IN CONJUNCTION WITH THE GENERAL STRUCTURAL DIRECTIVE NOTES.
- 2. STRUCTURAL ELEMENTS SHALL FOLLOW THE AESTHETIC REQUIREMENTS OF TM
- 3. ALL DESIGN VARIANCES MUST BE APPROVED BY HSR.

DESIGN METHOD

- 1. AERIAL GUIDEWAY SUPERSTRUCTURE DEPTH IS BASED ON TM 200.11 AND TM 200.12 FOR DEDICATED TRACKS. FOR BLENDED TRACKS, THE SUPERSTRUCTURE DEPTH IS BASED ON CALTRAIN STANDARDS FOR DESIGN AND MAINTENANCE OF STRUCTURES (2003).
- 2. BRIDGE SOFFITS OVER WATERWAYS ARE SHOWN TO BE 2 FT MINIMUM ABOVE HIGH WATER LEVEL.
- 3. AERIAL GUIDEWAY SUPERSTRUCTURE WIDTH AND CONFIGURATION IS BASED ON DIRECTIVE DRAWINGS DD-ST-100 AND DD-ST-101 FROM CP4.

GENERAL

- 1. THE STRUCTURES SHOWN ON THESE DRAWINGS ARE REPRESENTED IN THEIR FINAL CONFIGURATION. ALL DIMENSIONS ARE BASED ON MINIMUM SPACIAL AND CLEARANCE REQUIREMENTS, AND DO NOT INCLUDE CONSTRUCTION TOLERANCES. CONTRACTOR SHALL ACCOUNT FOR APPROPRIATE CONSTRUCTION TOLERANCES.
- 2. COMPLEX STRUCTURES AS DEFINED IN TM 2.10.4 ARE IDENTIFIED ON THE COMPOSITE PLAN, PROFILE, AND SECTION DRAWINGS.
- 3. BRIDGE SUPERSTRUCTURE CONSTRUCTION METHOD CAN BE CAST-IN-PLACE OR PRECAST WITH A CONSTANT CROSS-SECTION FROM BEGIN BRIDGE TO END BRIDGE, UNLESS NOTED OTHERWISE. AT LOCATIONS WHERE THE SUPERSTRUCTURE CROSS-SECTION VARIES IT IS ASSUMED THAT BALANCED CANTILEVER OR CAST-IN-PLACE SHORED CONSTRUCTION WILL BE USED. BALANCED CANTILEVER IS ASSUMED TO BE CAST-IN-PLACE SEGMENTAL CONSTRUCTION.
- 4. VERTICAL CLEARANCES ARE BASED ON TRACK INFORMATION AND EXISTING GROUND SURVEY PROVIDED BY TOWILL INC.
- 5. VERTICAL CLEARANCES ALLOW FOR 4'-0" FOR BALANCED CANTILEVER TEMPORARY FALSEWORK DEPTH AND 2'-9" TEMPORARY FALSEWORK DEPTH AT ALL OTHER LOCATIONS, EXCEPT WHERE STEEL OR PC/PS BRIDGES ARE USED.
- 6. FALSEWORK OPENINGS ARE PROVIDED TO ALLOW TEMPORARY CLEARANCE OF 15'-0" FOR 16'-6" PERMANENT CLEARANCE.
- 7. FALSEWORK OPENINGS ARE PROVIDED TO ALLOW TEMPORARY CLEARANCE OF 14'-0" FOR 15'-0" PERMANENT CLEARANCE.
- 8. ROADWAY AND PEDESTRIAN OVERPASS STRUCTURES SHOULD BE ELECTRICALLY GROUNDED AND BONDED IN ORDER FOR THE OCS WIRES TO PASS BENEATH AND BE ATTACHED TO THE STRUCTURE, IF NECESSARY. THIS APPLIES TO NEW AND EXISTING STRUCTURES.
- EXISTING ROADWAY AND PEDESTRIAN OVERPASS STRUCTURES WITHOUT AN EXISTING FENCE SHALL HAVE A FENCE INSTALLED ON BOTH SIDES. THE LENGTH OF FENCING SHALL EXTEND 50FT PAST THE OUTSIDE TRACKS.

MATERIAL PROPERTIES

SEE GENERAL STRUCTURAL DIRECTIVE NOTES.

CONCRETE COVER

SEE GENERAL STRUCTURAL DIRECTIVE NOTES.

SEISMIC LOADING AND DESIGN

- 1. AERIAL GUIDEWAY COLUMNS, PILE CAPS, AND PILES HAVE BEEN SIZED BASED ON ASCE 7-10 ARS INFORMATION FROM THE USGS WEBSITE AND DESIGN CRITERIA FROM CP4 FOR DEDICATED TRACKS. FOR BLENDED TRACKS, THE SUBSTRUCTURE SIZING IS BASED ON CALTRAIN STANDARDS FOR DESIGN AND MAINTENANCE OF STRUCTURES (2003).
- 2. SITE SPECIFIC ARS CURVE INFORMATION ARE NOT PROVIDED AT THIS PHASE.
- 3. HIGHWAY BRIDGES CROSSING OVER THE HIGH SPEED TRAIN ARE NOT REQUIRED TO BE DESIGNED FOR OBE STRENGTH V LOAD COMBINATION.

SAN JOSE TO CVY EIR/S: VOLUME III **GENERAL INFORMATION BOOK SHEET 39 OF 64**

DESIGNED BY CHECKED BY IN CHARGE CONSTRUCTION DATE BY CHK APP DESCRIPTION

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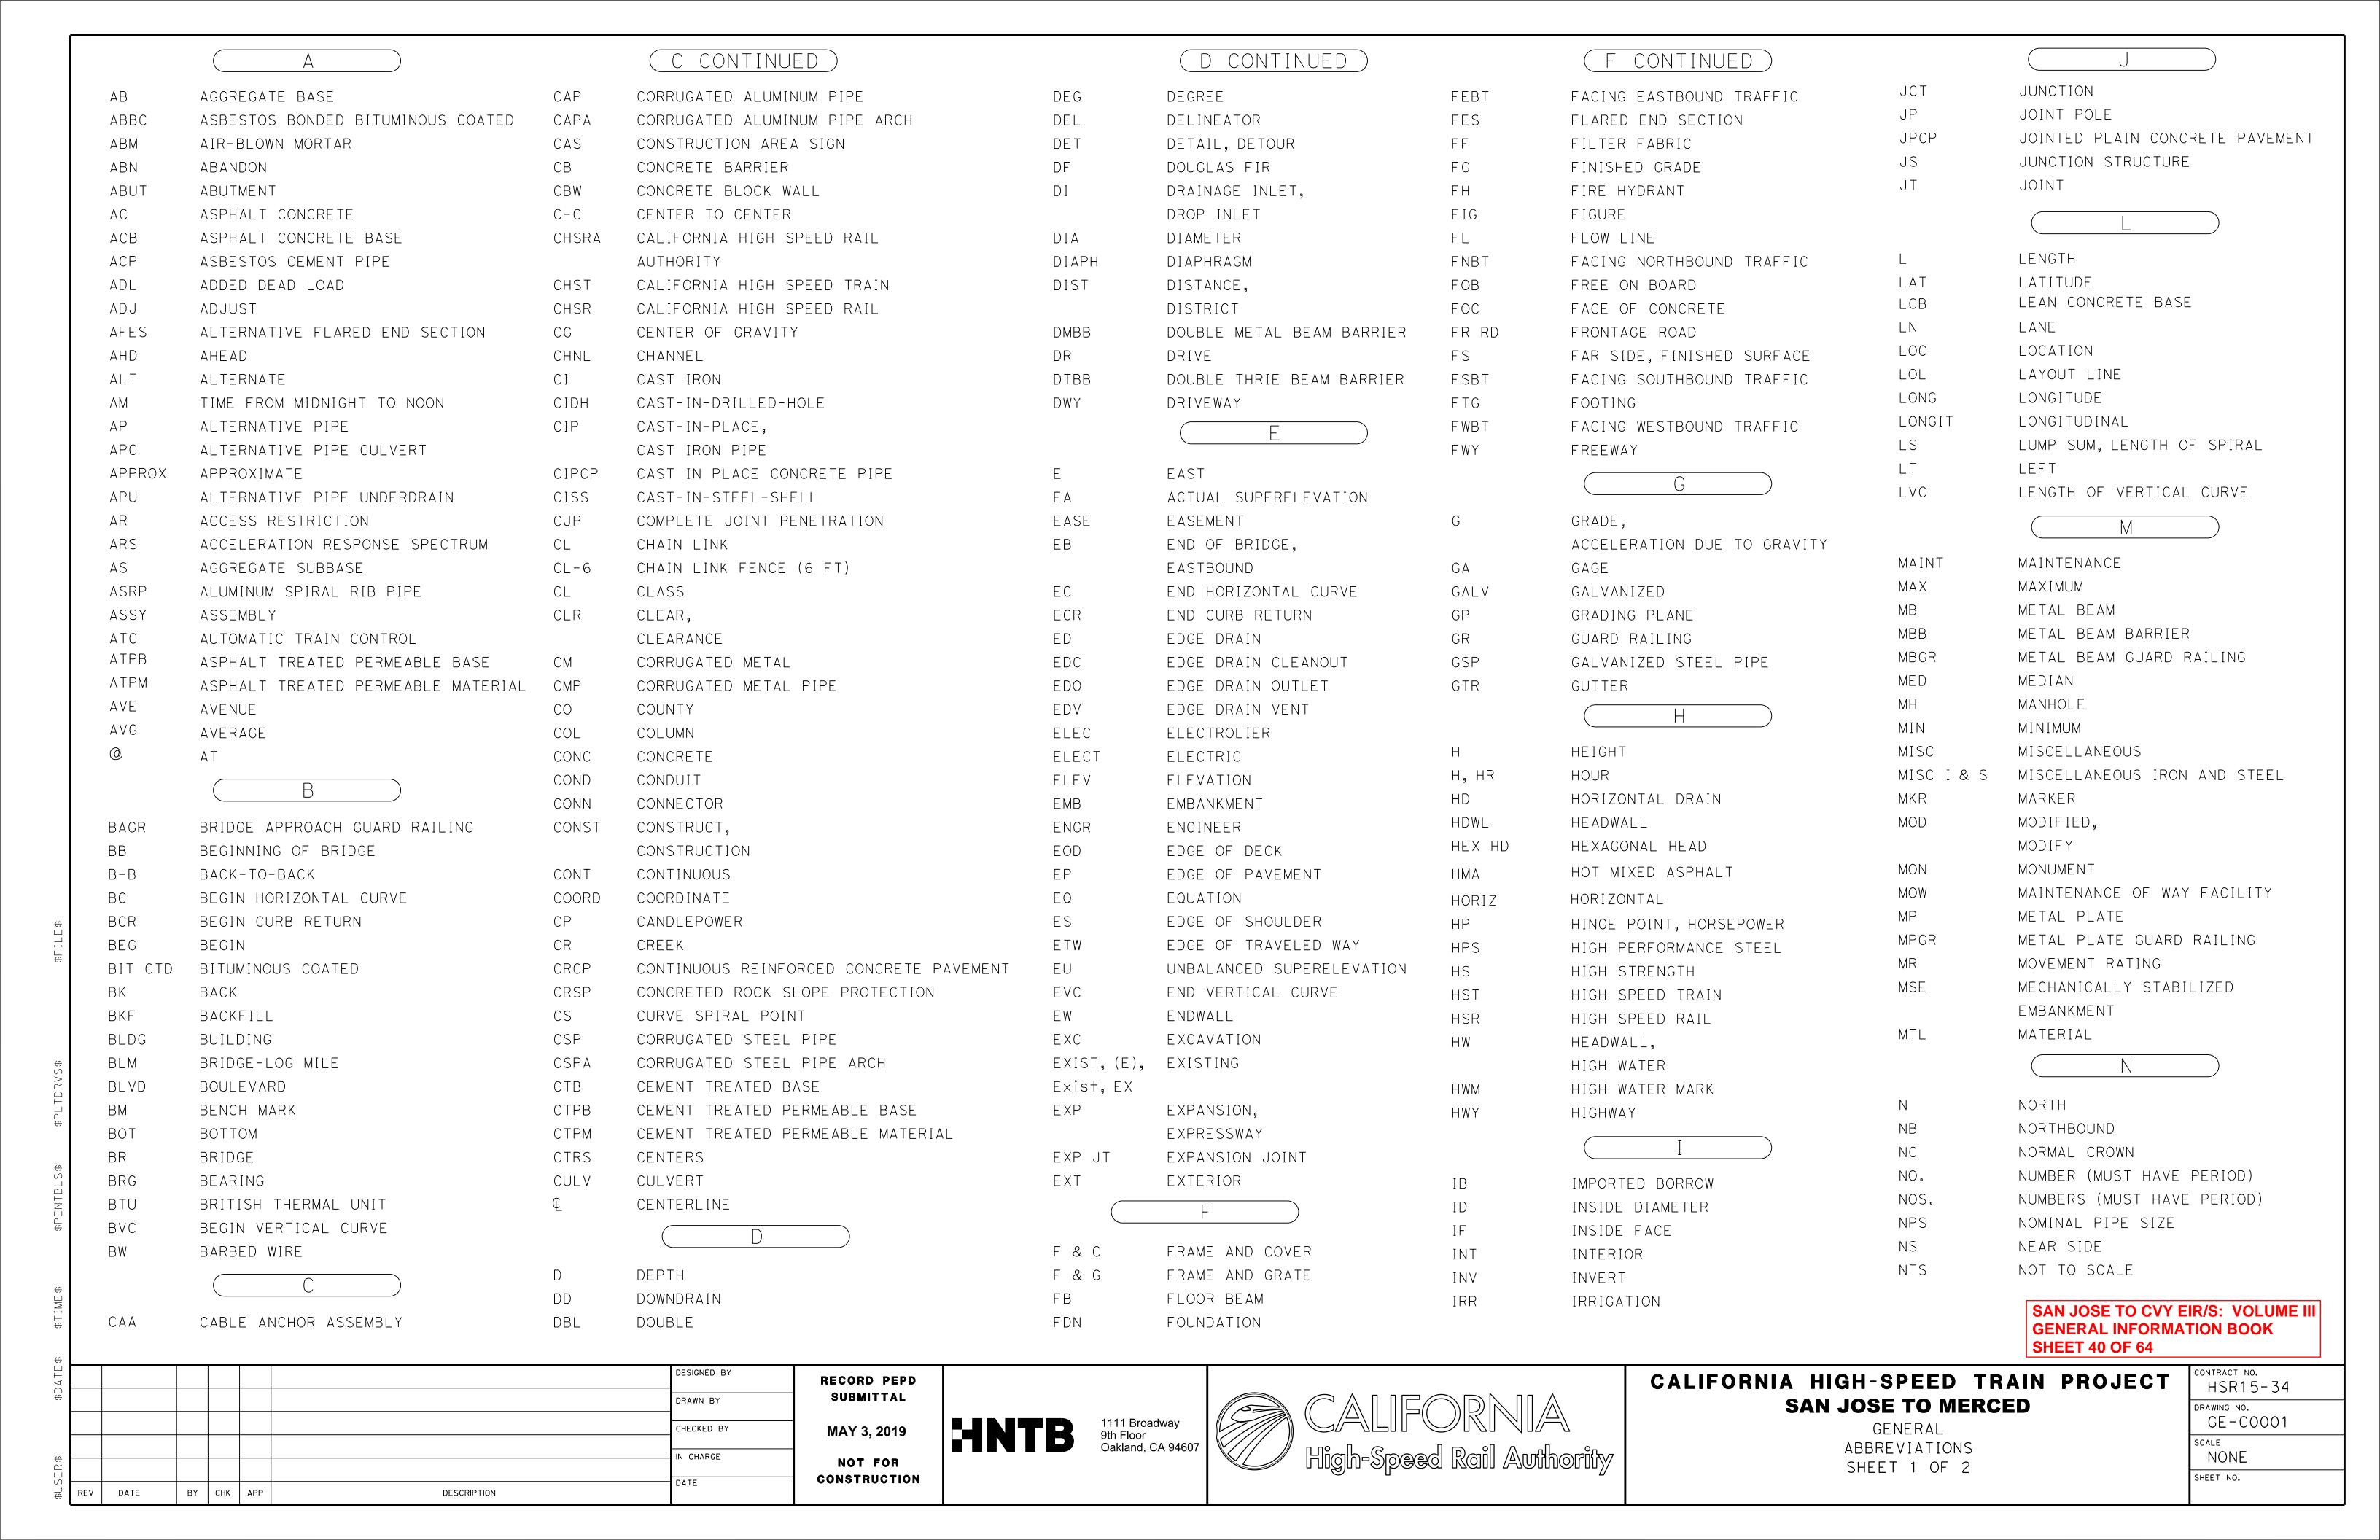


CALIFORNIA HIGH-SPEED TRAIN PROJECT SAN JOSE TO MERCED

GENERAL STRUCTURAL GENERAL NOTES

HSR15-34
DRAWING NO. GE-B0002
scale NONE
NONE

SHEET NO.



JSER\$ \$DAT				DRAWN BY CHECKED BY IN CHARGE DATE RECORD PEPD SUBMITTAL RECORD PEPD SUBMITTAL CHECKED BY MAY 3, 2019 RECORD PEPD SUBMITTAL CONSTRUCTION	HNTE	1111 Broadway 9th Floor Oakland, CA 9460	CALIFORN High-Speed Rail A	IIA Authority	CALIFORNIA HIGH-SPEED TR SAN JOSE TO MERCI GENERAL ABBREVIATIONS SHEET 2 OF 2		DRAWING NO. GE-COOO2 SCALE NONE SHEET NO.
₽ - E			ı	DESIGNED BY				1		SHEET 41 OF 64	CONTRACT NO.
\$TIME	13, 5/3	POINT OF SWITCH, PRESTRESSED	SD	STORM DRAIN			RANSITION			SAN JOSE TO CVY E	
⊕ Ы	PS&E PS, P/S	PLANS, SPECIFICATIONS AND ESTIMATES POINT OF SWITCH,		SLOTTED CORRUGATED STEEL SPIRAL CURVE POINT	,		OP OF RAIL			SAN JOSE TO CAN F	ID/S: VOLUME III
	PRVC PS&E		SC	,			REATED PERMEABLE MATERIAL RACTION POWER SUBSTATION				
ਰਾ	PRVC	POINT OF REVERSE VERTICAL CURVE	SC SB	SOUTHBOUND SAND CUSHION,			REATED PERMEABLE MATERIAL				
\$PEN	PROP	PAVEMENT REINFORCING FABRIC PROPOSED	SA-RT SB	STAND ALONE RADIO TOWER			REATED PERMEABLE BASE RACTION POWER FACILITY				
ITBL	PRC PRF	POINT OF REVERSE CURVE		STRUCTURAL ALUMINUM PLATE			ELEPHONE POLE REATED PERMEARIE BASE				
\$ S		PERFORATED PLASTIC PIPE	SALV SAPP	SALVAGE STRUCTURAL ALLIMINUM PLATE			OTAL FLEPHONE POLE				
	PPL PPP	PREFORMED PERMEABLE LINER	SAE	STRUCTURE APPROACH EMBANI			OP OF GRADE				
3PL	DDI	POWER POLE	СЛГ	SUPPLEMENT			EMPORARY				
_TDR		PLASTIC PIPE,	5	SOUTH,			ELEPHONE				
3 N S &	PP	PIPE PILE,	C	SOUTU			EMPORARY CONSTRUCTION EASEMENT	YRS	YEARS		
4				(S				YR	YEAR		
	POVC	POINT OF TANGENT POINT OF VERTICAL CURVE	1 / / /	NOTE WAT			RAFFIC CONTROL BOX				
	POT	POINT OF END	RWY	RAILWAY			OP OF CURB		Y		
	POE	POINT OF END	R/W, ROW	RIGHT OF WAY			IMBER	XING	CROSSING		
\$⊬	POC	POINT OF HORIZONTAL CURVE		RETAINING WALL			O BE DETERMINED	X SEC	CROSS SECTION		
ILE	POB	POINT OF BEGINNING	RW	REDWOOD,			HRIE BEAM BARRIER				
φ	PN	PAVING NOTCH	RTE	ROUTE			ANGENT		X		
	1 141	TIME FROM NOON TO MIDNIGHT	RT-RADIO	RADIO TOWER			ABLET	WWLOL	WINGWALL LAYOUT LINE		
	PM	POST MILE,	RT	RIGHT		T S	EMI – TANGENT	WW	WINGWALL		
	P/L	PROPERTY LINE	RSP	ROCK SLOPE PROTECTION				WV	WATER VALVE		
	P,PL	PLATE	RR	RAILROAD		3	T	WT	WEIGHT		
	PJP	PARTIAL JOINT PENETRATION		REFERENCE POINT			URFACE 4 SIDES	WSP	WELDED STEEL PIPE		
	PITO	POINT OF INTERSECTION TURNOUT	RP	RADIUS POINT,			YMMETRICAL	WS	WATER SURFACE		
	PI	POINT OF INTERSECTION	RM	ROAD-MIXED			EWER	WM	WIRE MESH		
	PG&E	PACIFIC GAS AND ELECTRIC	RDWY	ROADWAY			OUND WALL	WH	WEEP HOLE		
	PG	PROFILE GRADE	REV	REVISED			IDEWALK,	WB	WESTBOUND		
	PERM MTL	PERMEABLE MATERIAL	RET	RETAINING			URFACING		WIDTH		
	PED UC	PEDESTRIAN UNDERCROSSING	REPL	REPLACEMENT			TRUCTURE	W	WEST,		
	PED OC	PEDESTRIAN OVERCROSSING	REL	RELOCATE			TANDARD				
	PED	PEDESTRIAN	· · ·	REINFORCING	•		INGLE THRIE BEAM BARRIER		W		
	PCVC	POINT OF COMPOUND VERTICAL CURVE	REINF	REINFORCED, REINFORCEMENT.	9		TATION	VOL	VOLUME		
	- ·	PRESTRESSED CONCRETE PIPE	RD	ROAD			PIRAL TANGENT POINT	VIA	VIADUCT		
	PCP	PERFORATED CONCRETE PIPE,	RCPA	REINFORCED CONCRETE PIPE			TREET,	VERT	VERTICAL		
	. 55	PORTLAND CEMENT CONCRETE	RCP	REINFORCED CONCRETE PIPE			TEEL SPIRAL RIB PIPE	VCP	VITRIFIED CLAY PIPE		
	PCC	POINT OF COMPOUND CURVE,	RCB	REINFORCED CONCRETE BOX			TRUCTURAL STEEL PLATE PIPE ARCH	VC	VERTICAL CURVE		
	. 🔾	PRECAST	RCA	REINFORCED CONCRETE ARCH			TRUCTURAL STEEL PLATE PIPE	VAR	VARIABLE		
	PC	POINT OF CURVATURE,	R/C	RATE OF CHANGE			TRUCTURAL STEEL PLATE ARCH		DESIGN SPEED		
	PB	PULL BOX	R & S	REMOVE AND SALVAGE			TRUCTURAL SECTION DRAIN	V	VALVE,		
	PAP	PERFORATED ALUMINUM PIPE	R & D	REMOVE AND DISPOSE			TRAP AND SADDLE BRACKET METHOD		V		
	Р	PAGE	R	RADIUS			LOPE STAKE				
		P					TATE ROUTE	UPRR	UNION PACIFIC RAIL ROAD		
	OT I		Q I I	QUAINTITT			LOTTED PLASTIC PIPE	UP	UNDERPASS		
	O-O OPP	OPPOSITE	QTY	QUANTITY			PECIAL, PECIFICATIONS	UON	UNLESS OTHERWISE NOTED		
	0H 0-0	OVERHEAD OUT TO OUT		Q			ELECTED MATERIAL	UD	UNDERDRAIN		
	OGAC	OPEN GRADED ASPHALT CONCRETE	PVT	POINT OF VERTICAL TANGENT			TATION LINE FLECTED MATERIAL	UC	UNDERCROSSING		
	OG	ORIGINAL GROUND	PVMT	PAVEMENT POINT OF VERTICAL TANCENT			IMILAR Tation line				
	OF OC	OUTSIDE FACE	PVI	POINT OF VERTICAL INTERSE			HEET IMIL AD				
	OD	OUTSIDE DIAMETER		POINT OF VERTICAL INTERSE			HOULDER		TYPICAL		
	OCS	OVERHEAD CONTACT SYSTEM	PVC	POLYVINYL CHLORIDE,			UBGRADE		TANGENT SPIRAL POINT		
	00	OVERCROSSING	PT	POINT OF TANGENCY			EPARATION		TUBULAR STEEL,		
	OBLR	OBLITERATE	PSP	PERFORATED STEEL PIPE			ECOND, SECTION	TYP	TRAFFIC SIGNAL,		
								TS	TRANSVERSE,		
				(P CONTINUED)			(S CONTINUED)		(T CONTINUED)		

DESCRIPTION

BY CHK APP

CONSTRUCTION

BY CHK APP

DESCRIPTION

SHEET NO.

SHEET 2 OF 8

SHEET NO.

NOT FOR

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DATE

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DATE

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SCALE


NONE

SHEET NO.


WILDLIFE CROSSING DETAILS

SHEET 3 OF 8

- 2. FOR CULVERTS BURIED MORE THAN 1.5' BELOW EXISTING GROUND, AN ENGINEERING SOLUTION WILL BE REQUIRED.
- 3. DIMENSIONS SHOWN IN WILDLIFE CROSSING TABLE (SHEETS GE-COO10 TO GE-COO12) REPRESENT OPENING OF CULVERT.
- 4. FOR CONCRETE BARRIER WILDLIFE PASSAGEWAY (TYPE ML) DETAIL, REFER TO CALTRANS STD PLANS A76L.
- 5. MAINTAIN EXISTING PROFILE OF MONTEREY RD.
- 6. WILDLIFE CROSSING CULVERT ASSUMED STRUCTURE DEPTH OF 2', EXCEPT THE TOP SLABS UNDER THE RAILROADS WHICH ARE 4'THICK FOR 40' WIDE CULVERTS AND 3'FOR 30'WIDE CULVERTS.
- 7. PROFILE IS OF EXISTING CURRENT DESIGN CONDITIONS.
- 8. FINAL DESIGNER TO MAXIMIZE VERTICAL CLEARANCE UP TO 15'HIGH. MINIMUM DIMENSIONS ARE SPECIFIED ON SHEETS GE-COO10 THROUGH GE-C0012.
- 9. FOR WILDLIFE CROSSING AT STATION "B2" 689+50.00, THE PROPOSED WILDLIFE CROSSING CONSISTS OF THREE CULVERTS: TWO 30'X11.1' AND ONE 40'X10.1' CULVERT. ASSUMES INVERT IS THE SAME FOR ALL THREE CULVERTS.
- 10. "WILDLIFE OPENINGS" ARE U-SECTIONS THAT DO NOT HAVE A TOP SLAB ALLOWING LIGHT TO ENTER THE WILDLIFE CROSSING.
- 11. APPROACHES TO WILDLIFE CROSSINGS WILL NOT BE BLOCKED BY AR OR AD FENCING. IF NECESSARY TO DELINEATE ROW, 3-STRAND WILDLIFE PERMEABLE FENCING WILL BE USED. ACCESS TO HSR ROW WIL TYPICALLY BE RESTRICTED WITH AR FENCING ON WING WALLS AND ON TOP OF THE BOX CULVERT AS SHOWN IN THE 10'X4.1' AND 10'X3' WILDLIFE CROSSING DETAIL. GATES ARE PROVIDED FOR MAINTENANCE ACCESS. SEE DIRECTIVE DRAWING DD-CV-006 FOR AR FENCING DETAIL FROM HSR 13-06 BOOK 3, PART E, SUBPART 1.
- 12. TO MINIMIZE TRESPASSING, FEATURES SUCH AS BOULDERS WILL BE PLACED ON THE APPROACH SLOPES AND WITHIN UNDERCROSSINGS.

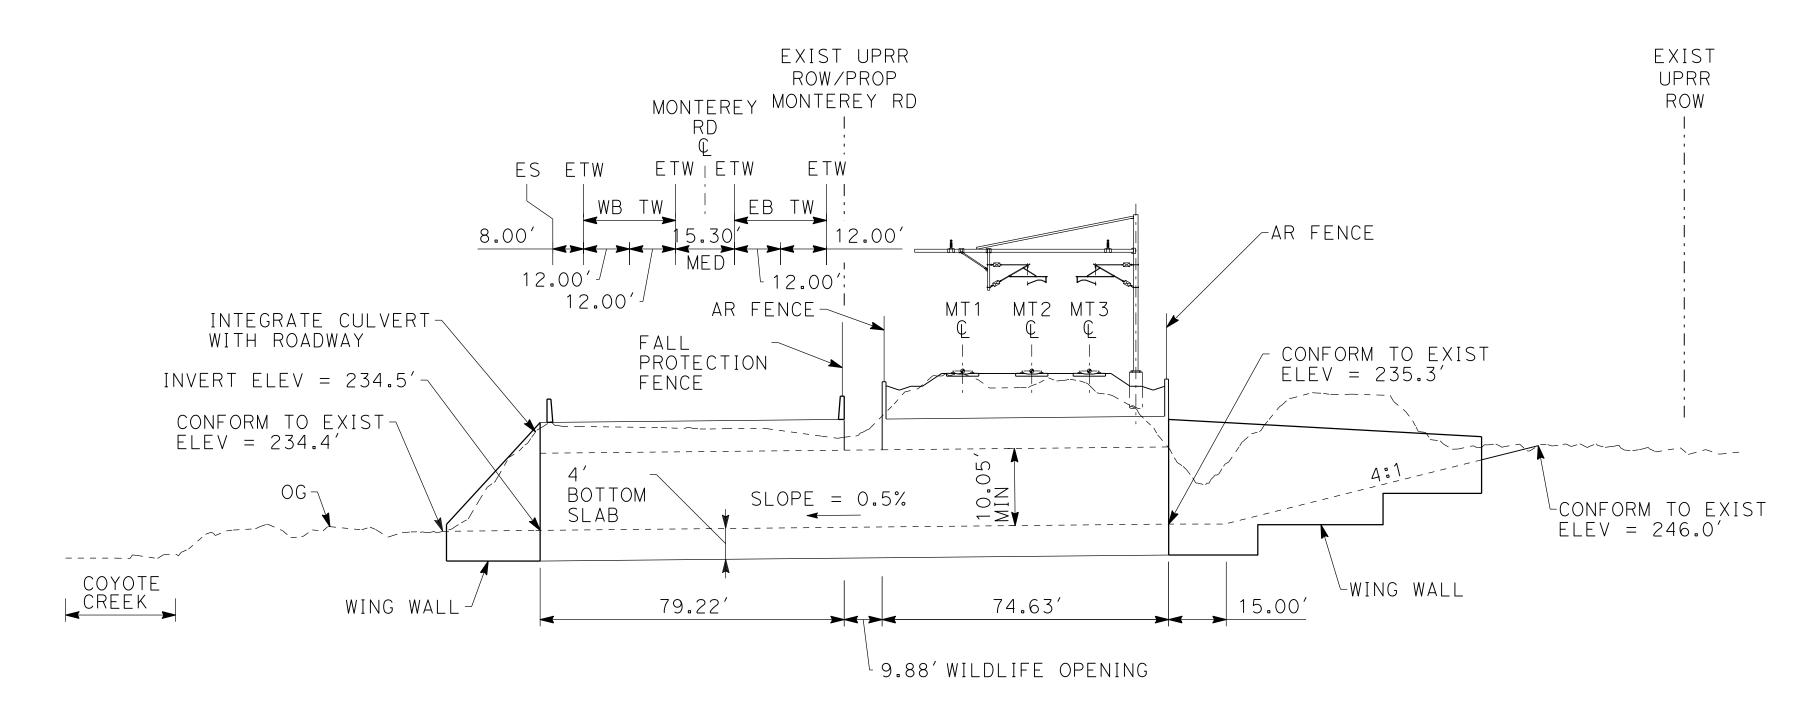

ALTERNATIVE 4 "B2" B689+50 40'X10.1' WILDLIFE CROSSING

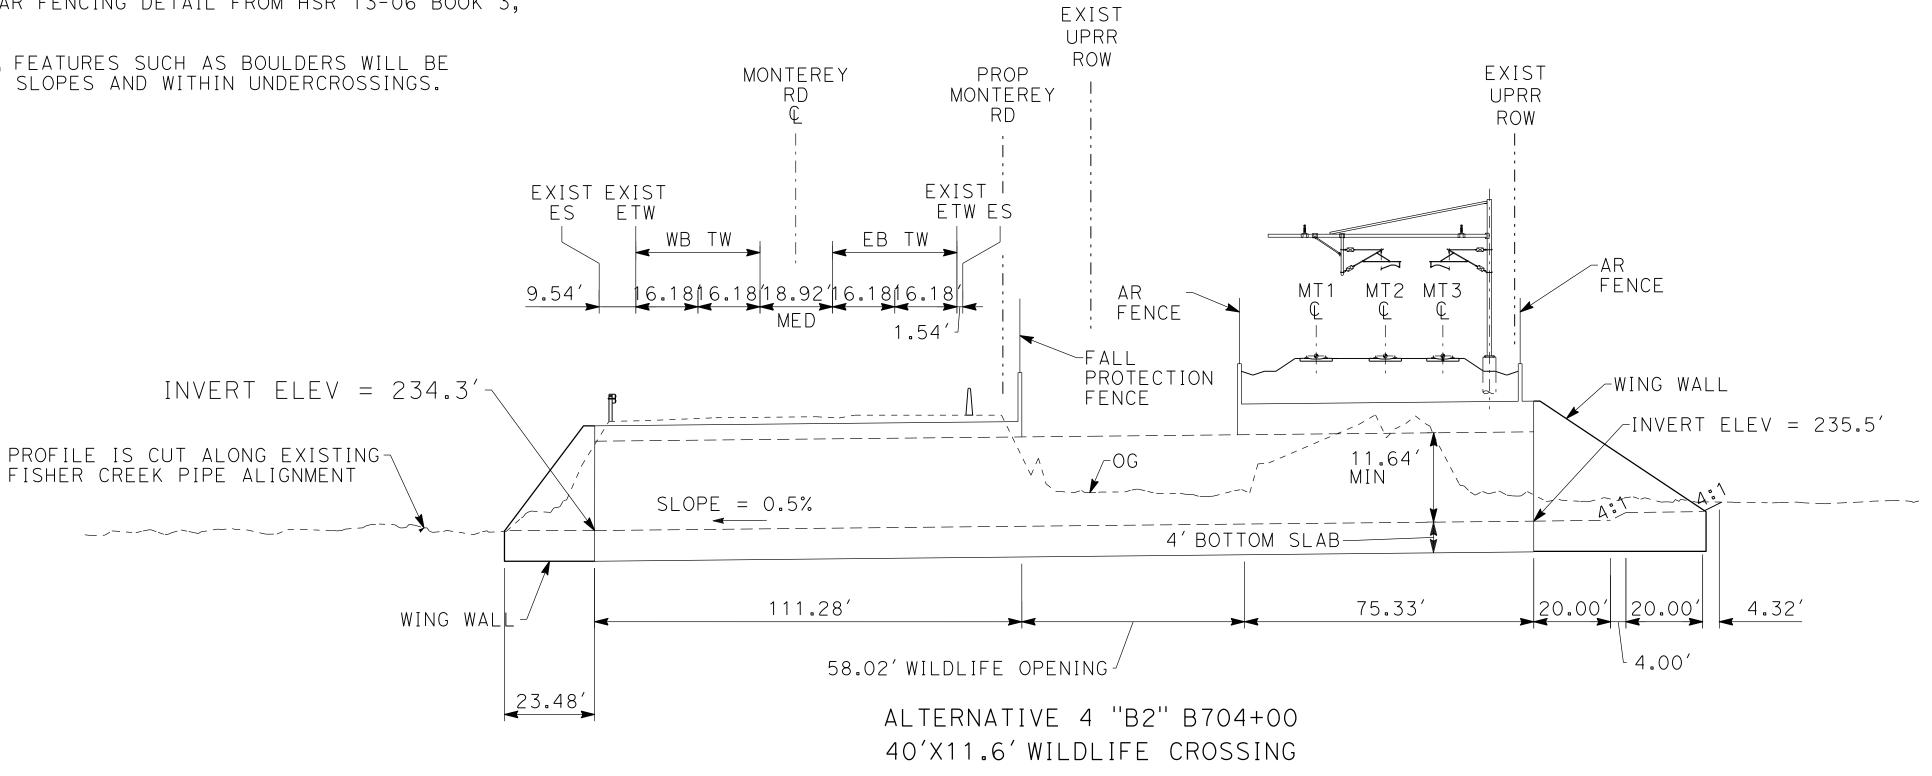

SAN JOSE TO CVY EIR/S: VOLUME III **GENERAL INFORMATION BOOK SHEET 45 OF 64**

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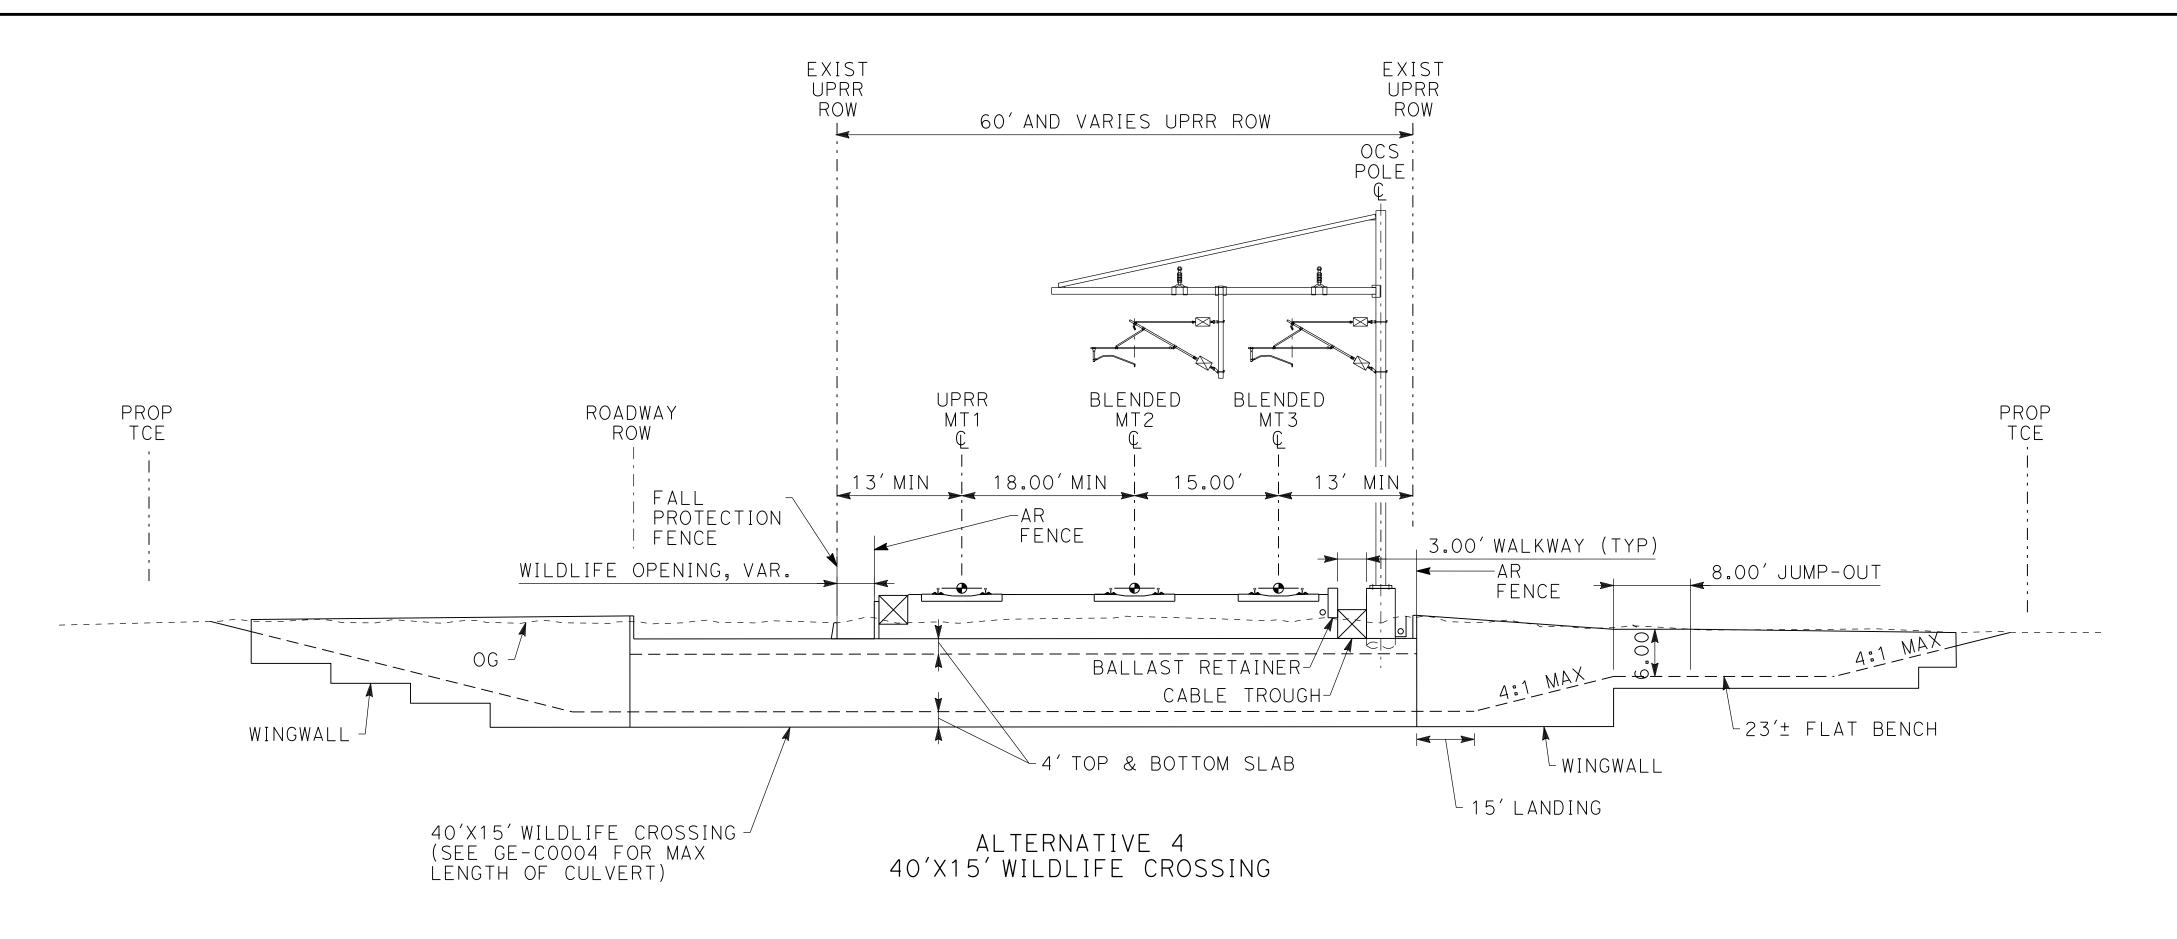
CALIFORNIA HIGH-SPEED TRAIN PROJECT **SAN JOSE TO MERCED**


GENERAL WILDLIFE CROSSING DETAILS SHEET 4 OF 8

CONTRACT NO. HSR15-34
DRAWING NO. GE-COOO6
scale NONE
SHEET NO.

- 2. FOR CULVERTS BURIED MORE THAN 1.5' BELOW EXISTING GROUND, AN ENGINEERING SOLUTION WILL BE REQUIRED.
- 3. DIMENSIONS SHOWN IN WILDLIFE CROSSING TABLE (SHEETS GE-COO10 TO GE-COO12) REPRESENT OPENING OF CULVERT.
- 4. FOR CONCRETE BARRIER WILDLIFE PASSAGEWAY (TYPE ML) DETAIL, REFER TO CALTRANS STD PLANS A76L.
- 5. APPROACHES TO WILDLIFE CROSSINGS WILL NOT BE BLOCKED BY AR OR AD FENCING. IF NECESSARY TO DELINEATE ROW, 3-STRAND WILDLIFE PERMEABLE FENCING WILL BE USED. ACCESS TO HSR ROW WIL TYPICALLY BE RESTRICTED WITH AR FENCING ON WING WALLS AND ON TOP OF THE BOX CULVERT AS SHOWN IN THE 10'X4.1' AND 10'X3' WILDLIFE CROSSING DETAIL. GATES ARE PROVIDED FOR MAINTENANCE ACCESS. SEE DIRECTIVE DRAWING DD-CV-006 FOR AR FENCING DETAIL FROM HSR 13-06 BOOK 3, PART E, SUBPART 1.
- TO MINIMIZE TRESPASSING, FEATURES SUCH AS BOULDERS WILL BE PLACED ON THE APPROACH SLOPES AND WITHIN UNDERCROSSINGS.

7.



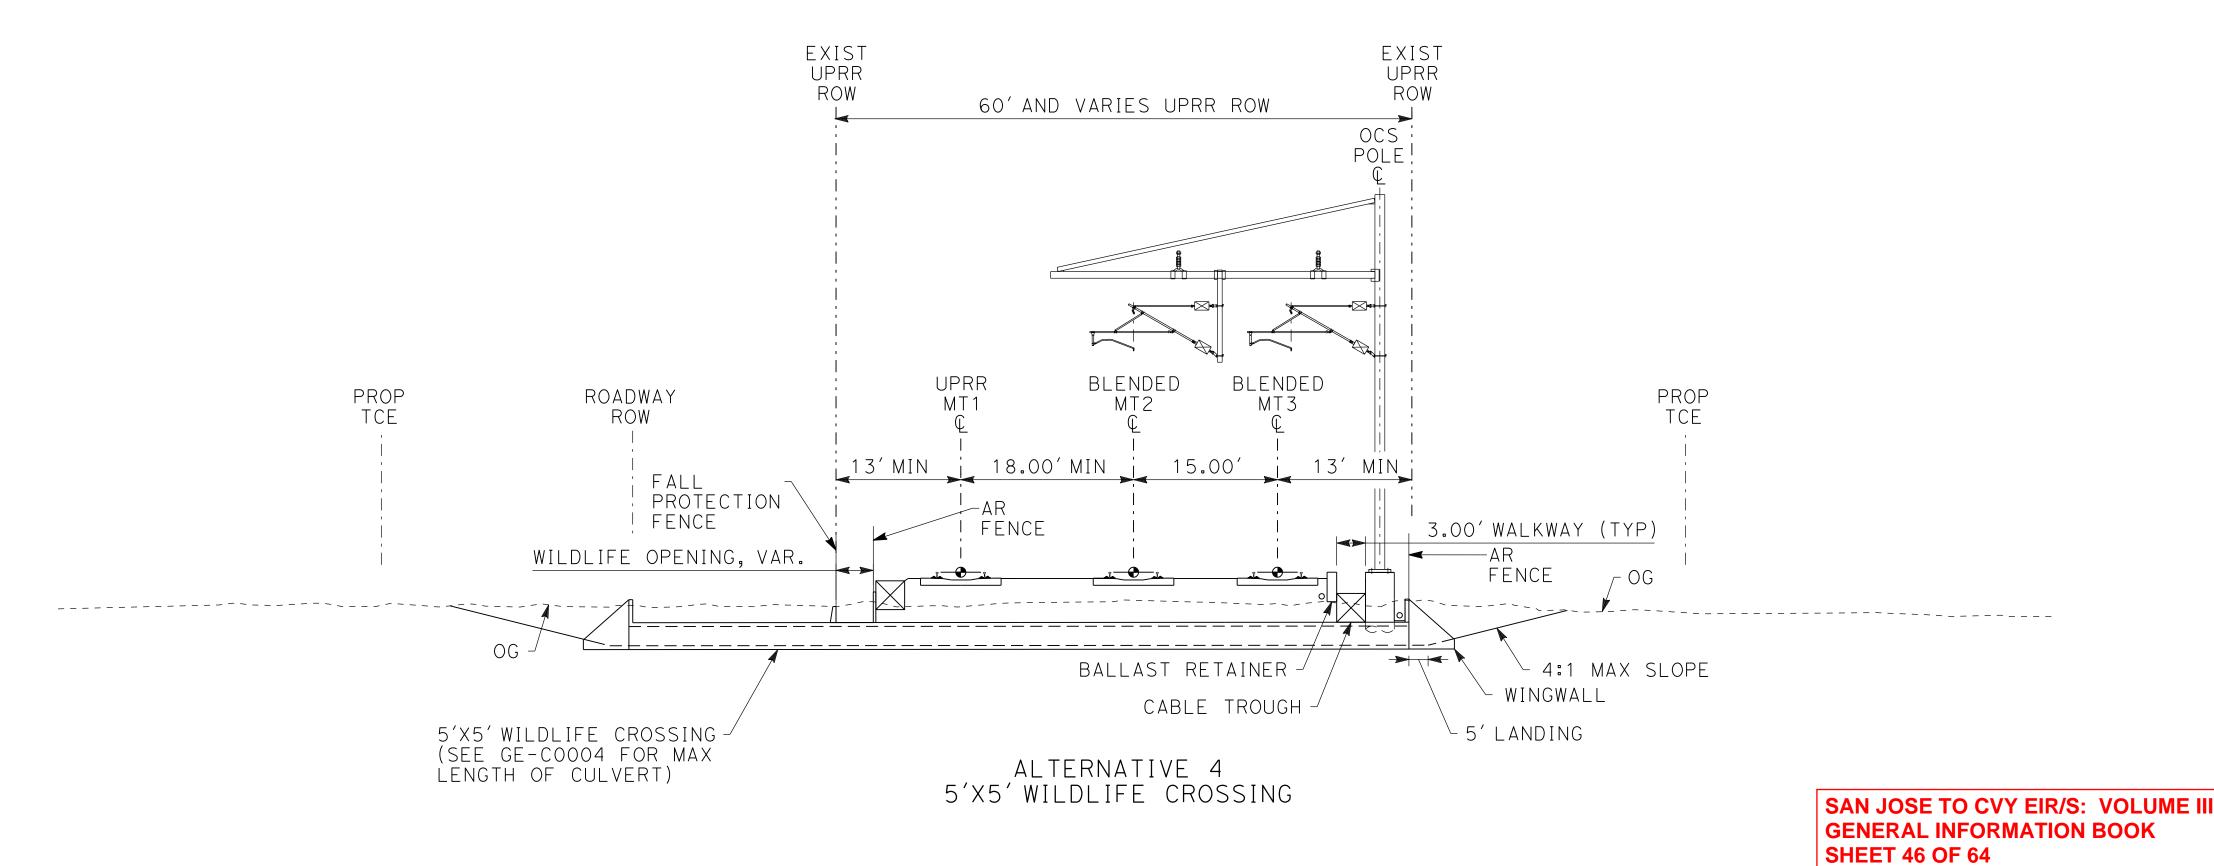

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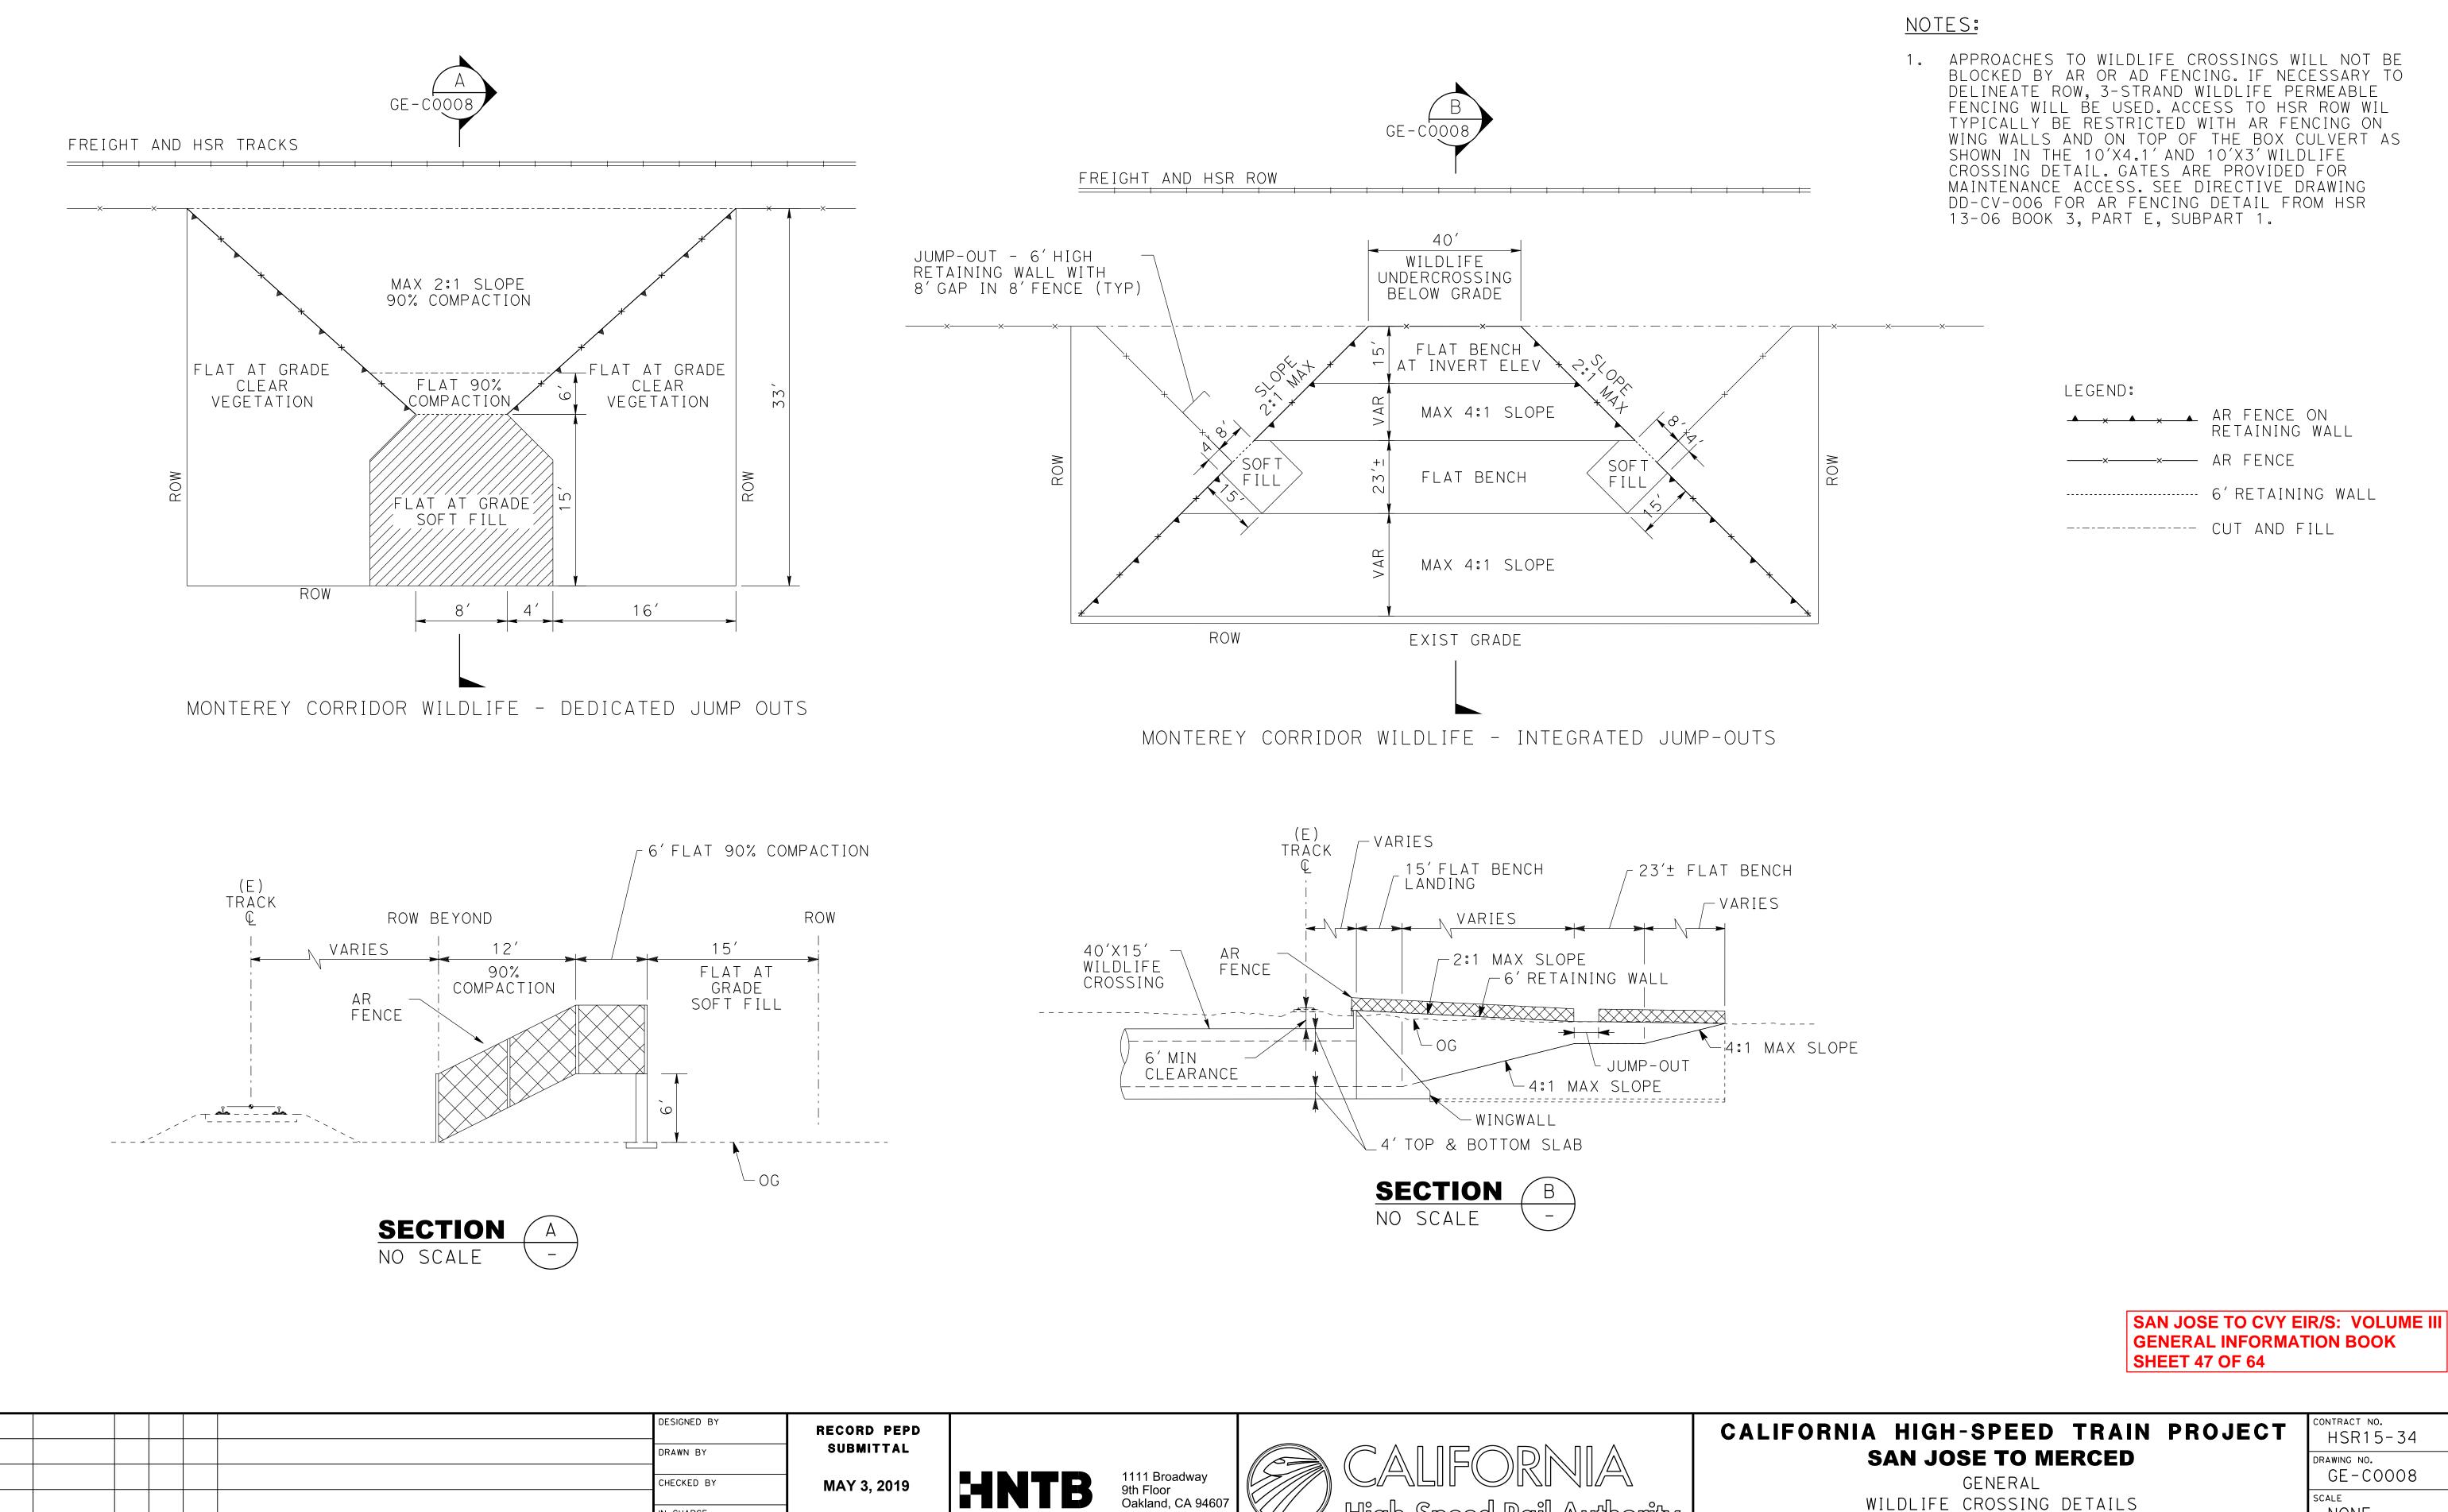
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CALIFORNIA HIGH-SPEED TRAIN PROJECT SAN JOSE TO MERCED

GENERAL WILDLIFE CROSSING DETAILS SHEET 5 OF 8

HSR15-34
DRAWING NO. GE-COOO7
scale NONE
SHEET NO.



MAY 3, 2019

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CONSTRUCTION

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IN CHARGE

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DESCRIPTION

BY CHK APP

GE-C0008 SCALE NONE SHEET NO.


GENERAL

WILDLIFE CROSSING DETAILS

SHEET 6 OF 8

NOTES:

1. SEE DIRECTIVE DRAWING DD-CV-006 FOR AR FENCING DETAIL FROM HSR 13-06 BOOK 3, PART E, SUBPART 1.

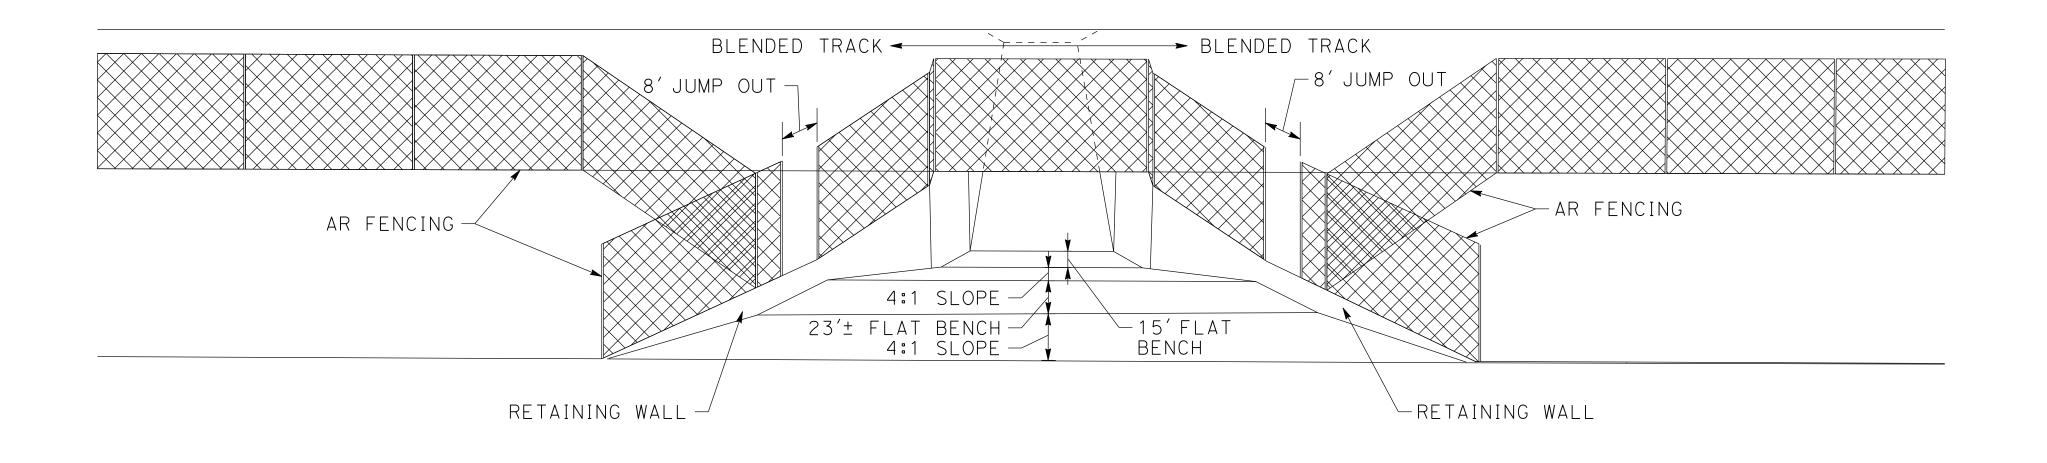

SAN JOSE TO CVY EIR/S: VOLUME III **GENERAL INFORMATION BOOK SHEET 48 OF 64**

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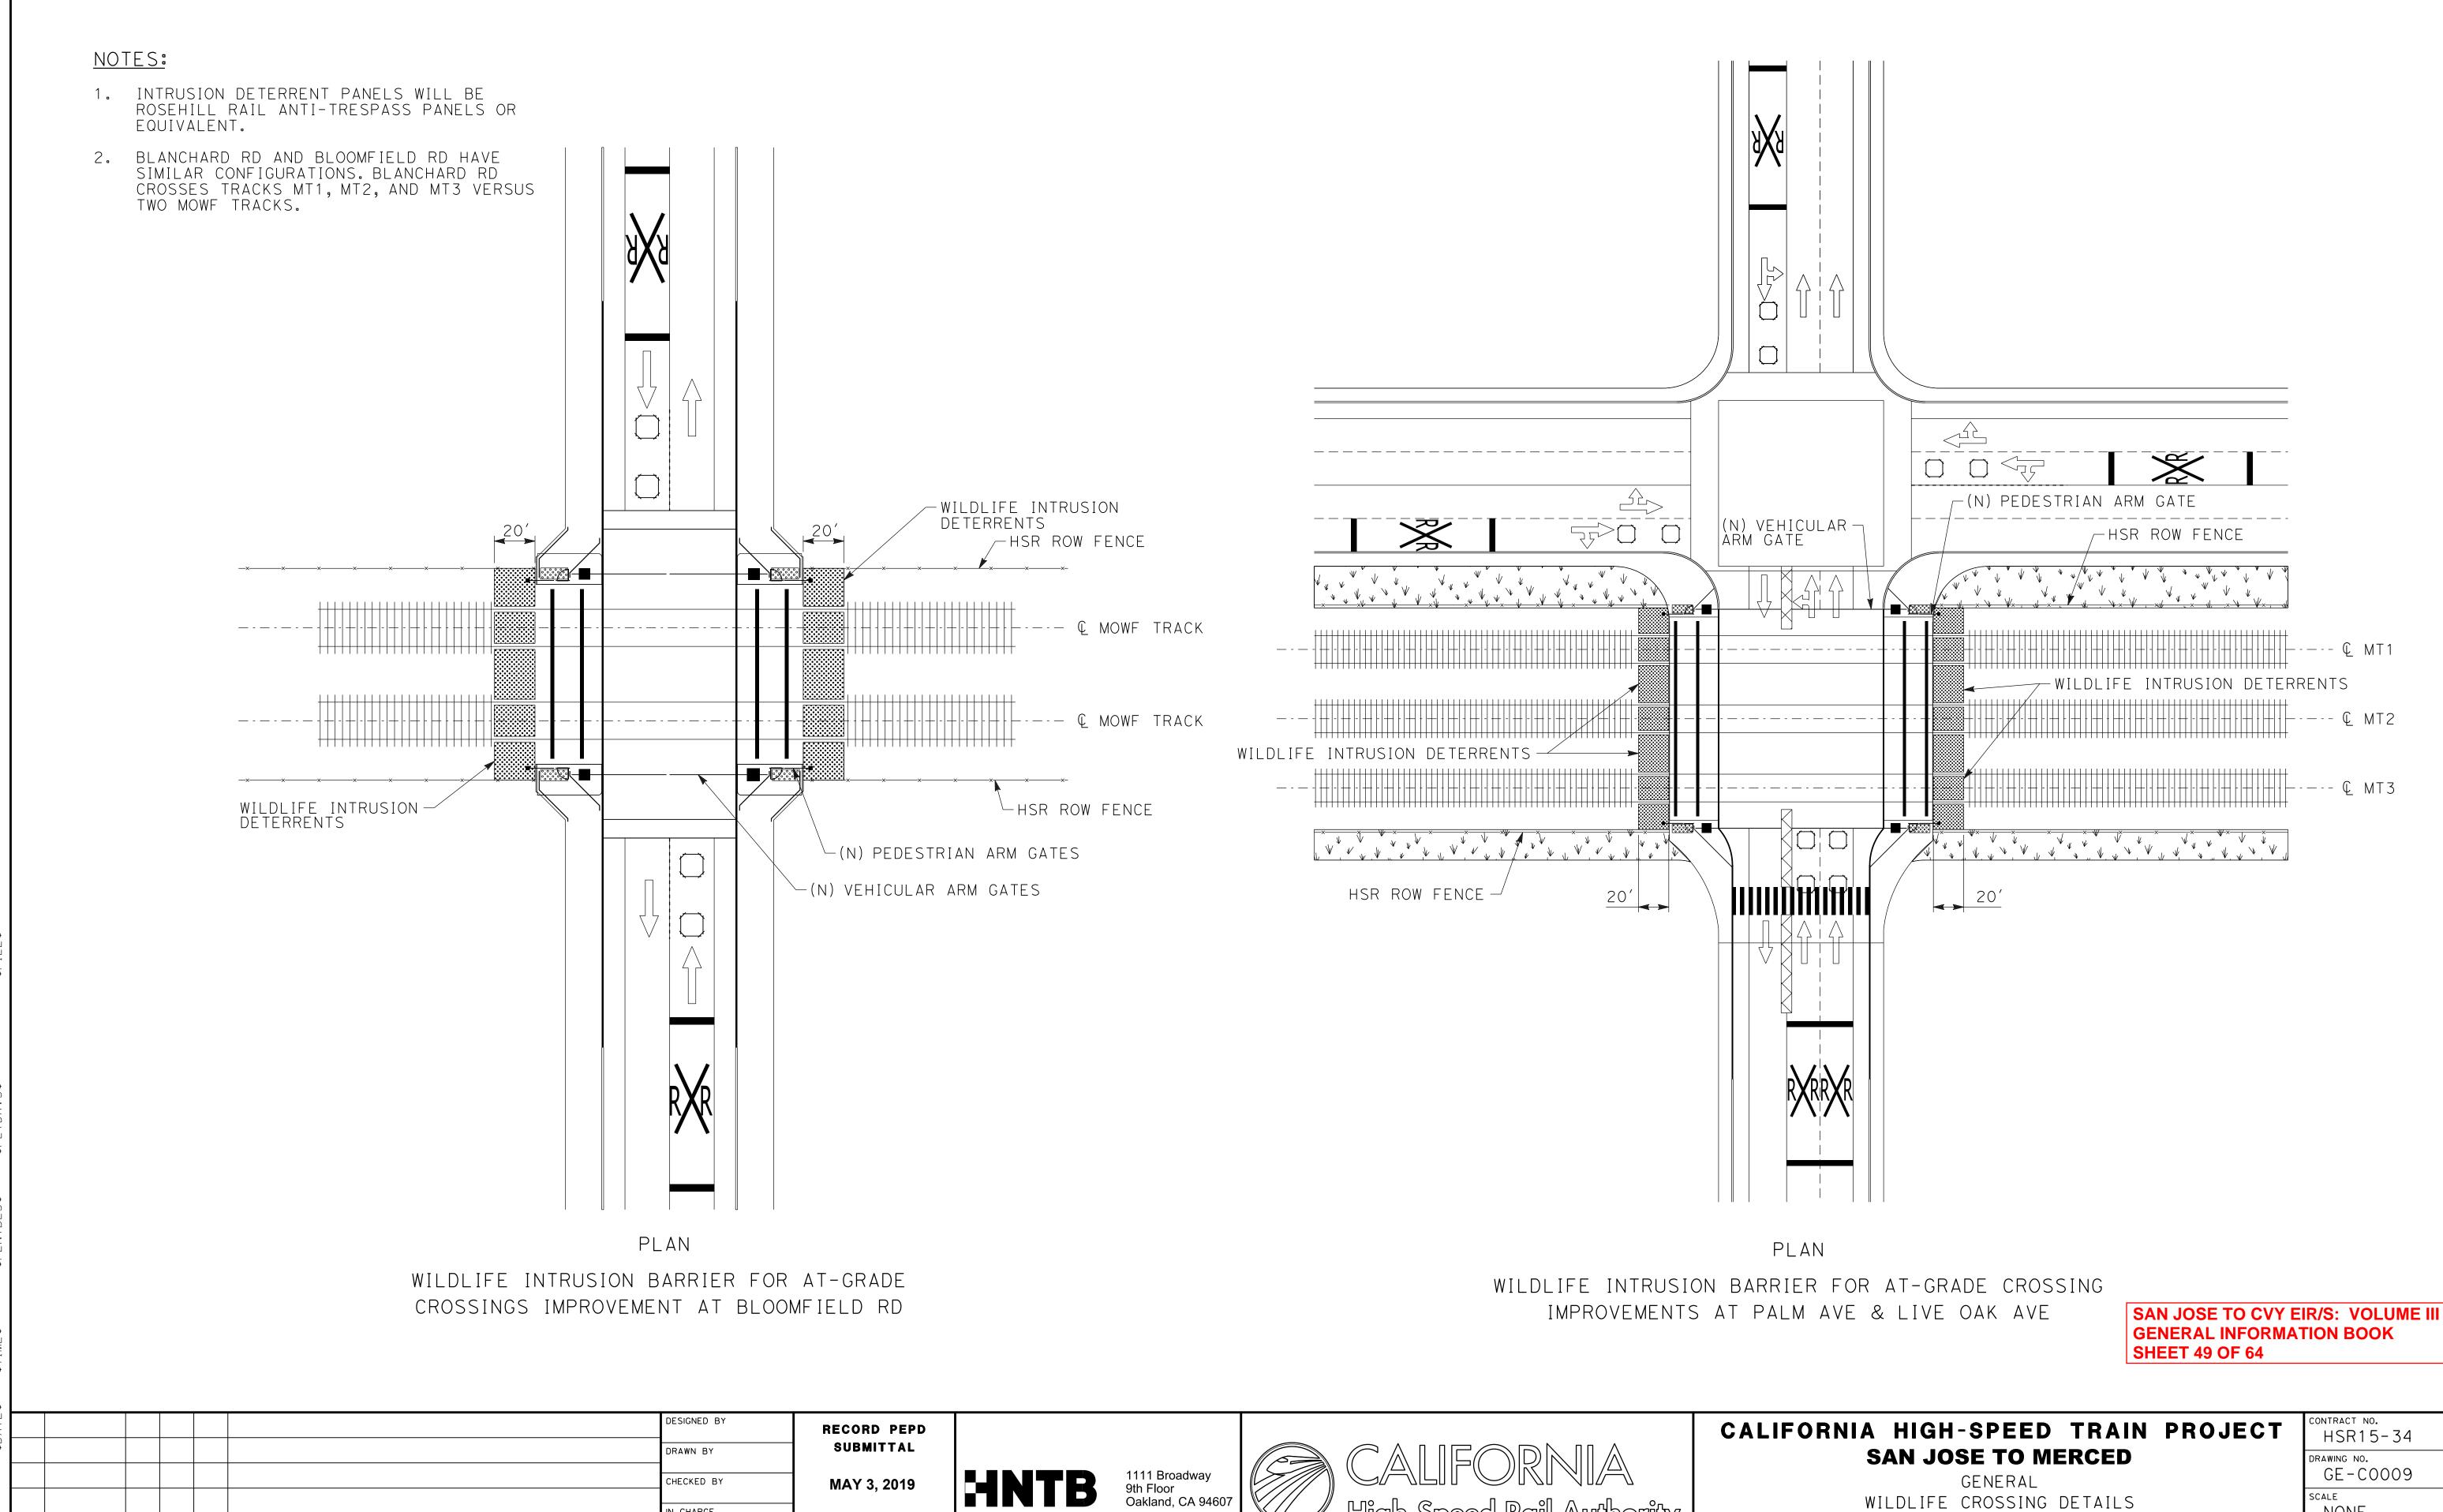


CALIFORNIA HIGH-SPEED TRAIN PROJECT **SAN JOSE TO MERCED**

WILDLIFE CORRIDOR DETAIL SHEET 7 OF 8

CONTRACT NO. HSR 15-34
DRAWING NO. GE-COOO8A
SCALE

NONE SHEET NO.



GENERAL

WILDLIFE CROSSING DETAILS

SHEET 8 OF 8

NONE

SHEET NO.

HNTB

MAY 3, 2019

NOT FOR

CONSTRUCTION

CHECKED BY

IN CHARGE

DESCRIPTION

BY CHK APP

Feature ID	Alt. 1	Alt. 2	Alt. 3	Alt. 4	Station	Max. Depth of Crossing Below Existing Grade (Feet)		Min. Height (Feet)	Crossing Under Monterey (Feet, rounded to nearest foot)	U-section (Feet, rounded to	Crossing Under HSR (Feet, rounded to nearest foot)	U-section (Feet, rounded to	Crossing Under UPRR (Feet, rounded to nearest foot)
Morgan Hi				Ait. 7	Station	l (reed	(reec)	(reet)	Hearest 100t)	Healest 100tj	Hearest 100ty	nearest rooty	Hearest 100t)
CV0d	X		X		648+15	-17	30	8.1		108		6	75
CV0e	Х		Х		649+25	-19	40	8.6		111		6	72
CV0f	Х		Х		650+35	-18	30	9.1		113		8	68
F1	Х		Х		664+64	-4	40	9.1		109			
CV0a		Х			739+75	-19	30	9.8	82	19	57	21	63
CV0b		Х			740+00	-19	40	8.8	82	19	57	21	63
CV0c		Х			740+25	-19	30	9.8	82	19	57	21	63
F2		X			754+36	-4	40	11	96	8	63	21	64
CV1		Х			810+50	-25	40	15	74	16	57	13	81
CV2	**********	Х		<u> </u>	873+00	-25	40	15	78	19	57	9	60
CV3		X			893+00	-12	5	5	78	19	57	9	60
D40	~~~~~~~~~~~~~~~~~~~~~~~~~~~~~~~~~~~~~~	X		***************************************	917+00	-25	40	15	78	20	57	20	63
D41		X			925+00	-12	5	5	78	17	<u>57</u>	18	74
D42		X			946+00	-12	5	5	78	13	57	15	94
CV4		X			1022+00	-25	40	15	78	13	57	14	77
CV5a				X	689+00	-20	30	11.1	79 70	10		75 75	
CV5b				X	689+50	-20	40	10.1	79 70	10		75	
CV5c	Take to the second		****	X	689+70	-20	30	11.1	79	10 58	The state of the s	75 75	Same and the second
F4 CV6				X	704+00 760+00	-4 -23	40 40	11.6 15	111 78	33		81	
CV7	*******	The state of the s		X	822+50	-25	40	15	78		144		The second secon
CV8				X	843+50	-12	5	5	79	14	<u> </u>	60	1.1
CV9	14	To a first the extreme of		X	862+00	-22	40	15	77	23		63	Tallet 1
CV10			-	X	874+50	-9	5	5	84	17		74	
CV11				Х	901+50	-10	5	5	78	6		94	
CV 12				Χ	971+50	-21	40	15	81	10		77	
CV13				Х	1079+00	0	5	5		· · · · · · · · · · · · · · · · · · ·		134	
Pacheco Pa	ass Subsec	tion											
RR1	Х	Х	Х	Х	4083+00	0	10	4.1			86		
RR3	Х	X	Х	X	4204+75	-0.7	10	4.1	***************************************	•••	86	Market and a second a second and a second and a second and a second and a second an	
RR4	Х	X	X	Х	4224+50	0	10	4.1			101		
RR5	Х	Х	X	Х	4238+33	0	10	4.1	gar t		101		
C7	Х	X	Х	Х	4262+00	0	10	4.1			101		
C8	Х	X	Х	X	4280+00	0	10	4.1			101		
C9	X	X	X	X	4298+00	0	10	4.1			101		
C10	X	X	X	X	4331+00	0	10	4.1			101		
C11	X	X	X	X	4344+50	0	10	4.1			101		
C86	X	X	X	X	4357+60	0	10	4.1			101		
C13	X	X	X	X	4380+00	0	10	4.1			101	and the second s	
C14	X	X	X	X	4388+00	0	10	4.1	+ % + %		101	The state of the s	
C15	X	X	X	X	4397+00	0	10	4.1			101		
C16 C17	X	X	X	X	4419+00 4426+00	0	10 10	4.1 4.1			101 101		
C.1		 	· ^	 	1 1720100		10	Т. ж.	I		101	•	

SAN JOSE TO CVY EIR/S: VOLUME III GENERAL INFORMATION BOOK SHEET 50 OF 64

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CALIFORNIA HIGH-SPEED TRAIN PROJECT **SAN JOSE TO MERCED**

GENERAL WILDLIFE CROSSING TABLES SHEET 1 OF 3

CONTRACT NO. HSR15-34
DRAWING NO. GE-COO10
scale NONE
SHEET NO.

Feature ID	X	Alt. 2	Alt. 3	Alt. 4		Max. Depth of Crossing Below Existing Grade (Feet)		Min. Height (Feet) 4.1	Crossing Under Monterey (Feet, rounded to nearest foot)	U-section (Feet, rounded to nearest foot)	Crossing Under HSR (Feet, rounded to nearest foot) 101	U-section (Feet, rounded to nearest foot)	Crossing Under UPRR (Feet, rounded to nearest foot)
San Joaqui	i		l ,	T	4404.00	l a	10	1 2	1		70	1	
C85	X	X	X	X	4494+00	0	10	3	-		73		
C84	X	X	X	X	4504+00	0	10	3	-		73 73	on a paragraphic p	
C83	X	X	X	X	4515+50	0	10	3	-				
C19		X	X	X	4528+00	0	10	3	-		73	un entre conference de la conference de	
C20	X	X	X	X	4536+00	0	10	3	-		73	Assessed Property Control of the Con	
C21	X	X	X	X	4627+00	0	10	3	-		73		
C22	X	X	X	X	4639+00	0	10	3			73		
C82	X		X	X	4650+00	-1.7	10	<u> </u>	-	ere i de la companya	71		
HM1	X	X	X	X	HMR 25+00	 	10	3	<u> </u>	·	73		
HM2	X	X	X	X	HMR 48+00	······································	10	3	-		73		
D43	X	X	X	X	4668+00	-2.5	10	3	-		55	***************************************	
D44	X	X	X	X	4676+00	-2	10	3			59		
C24	X	X	X	X	4686+60	0	10	3	-		73	generating and the second property of the sec	
C25	X	X	X	X	4697+70	0	10	3			73	esecutive processes and the security processes are security p	
C79	X	X	X	X	4706+00	0	10	3			73		
C26	X	X	X	X	4713+30	0	10	3			73	***************************************	
C27	X	X	X	X	4775+30	0	10	3			73		
C28	X	X	X	X	4784+00	0	10	3			73		
C78	X	X	X	X	4790+48	0	10	3			73		
C29	X	X	X	X	4797+00	0	10	3			73		
C77	X	X	X	X	4804+57	0	10	3			73	-	
C30	X	X	X	X	4811+00	0	10	3		grande (f. 1865) 1940 - Grande Grande (f. 1865) 1940 - Francisco (f. 1865)	73		
C31	X	X	X	X	4817+00	0	10	3			73	***************************************	
C32	X	X	X	X	4823+71	0	10	3			73		Ş
C76	X	X	X	X	4829+66	0	10	3	_		73	general grant of the control of the	
C33	X	X	X	X	4838+37	0	10	3	-		73	**************************************	
C34	X	X	X	X	4848+00	0	10	3				derivative de la constant de la cons	
C75	X	X	X	X	4854+54	0	10	3	-	e transport de la companya de la co	73	are consequently and a second a	
C35	X	X	X	X	4863+66	-0.5	10	3	-		73	descendances	
C74	X	X	X	X	4871+52	-1.2	10	3	1		73	eveneral property of the control of	
C36	X	X	X	X	4880+00	-2.1	10	3	<u> </u>		71	and an analysis of the same of	
C73	X	X	X	X	4893+80	-1.5	10	3			71	shream throws the street of th	a sergangan
C37	X	X	X	X	4898+85	-1.8	10	3			71	secretary productions of the secretary production of the secretary productions of the secretary productions of the secretary production of the secret	
D45	X	X	X	X	4909+00	-1.5	10	3	1		71	***************************************	
D46	X	X	X	X	4928+00	0	10	3	-		73	**************************************	
C40	X	X	X	X	4932+24	0	10	3			73		
C41	X	X	X	X	4941+52	0	10	3					
C43	X	X	X	X	5054+30	0	10	3			73		
C44	X	X	X	X	5065+45	0	10	3			73		
C71	X	X	X	X	5075+39	0	10	5	4		73	•	
C70	X	X	X	X	5082+50	-1.3	10	3	-		73	**************************************	
C69	Х	X	Х	X	5092+00	-0.2	10	3	J		73	**************************************	

SAN JOSE TO CVY EIR/S: VOLUME III GENERAL INFORMATION BOOK **SHEET 51 OF 64**

DESIGNED BY DRAWN BY CHECKED BY IN CHARGE CONSTRUCTION DATE BY CHK APP DESCRIPTION

RECORD PEPD SUBMITTAL MAY 3, 2019 NOT FOR



CALIFORNIA HIGH-SPEED TRAIN PROJECT **SAN JOSE TO MERCED**

GENERAL WILDLIFE CROSSING TABLES SHEET 2 OF 3

CONTRACT NO. HSR15-34
GE-COO11
scale NONE
SHEET NO.

Feature ID Alt. 1

C47

C67

C48

C49

C66

C65

C63

C62

C61

D47

C56

C60

C59

Χ

Alt. 2

Χ

Alt. 3

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Χ

Alt. 4

Station

5103+00

5109+50

5118+20

5125+60

5133+79

5144+72

5152+70

5164+59

5174+00

5189+34

5194+00

5220+85

5227+00

5235+72

5247+48

5276+80

5288+00

5299+00

5313+00

5323+50

5331+00

8 Д							DESIGNED BY
\$DAIE							DRAWN BY
							CHECKED BY
₩ Υ							IN CHARGE
SCVET S	REV	DATE	BY	СНК	APP	DESCRIPTION	DATE

RECORD PEPD SUBMITTAL **MAY 3, 2019** NOT FOR

CONSTRUCTION



Crossing

Under

Monterey

(Feet,

rounded to

Min. Height

(Feet)

3

3

Crossing

Under HSR

(Feet,

rounded to

69

73

73

71

U-section

(Feet,

rounded to

nearest foot) nearest foot)

U-section

(Feet,

rounded to

nearest foot) | nearest foot) | nearest foot)

Crossing

Under UPRR

(Feet,

rounded to

TypeL_16

Max. Depth of

Crossing

Below

(Feet)

-1.3

-1.5

0

0

0

0

-0.4

0

-0.3

0

0

-0.4

0

-0.9

0

-0.4

-0.8

-0.2

0

-1.6

Existing Grade Min. Width

(Feet)

10

10

Proposed Locations for Type L Concrete Barrier Wildlife Passageway Breaks. **Updated Station Location (Under** Feature ID (Design Changes.kmz) Alt. 2 Alt. 3 Alt. 1) Alt. 1 TypeL_1 639+00 TypeL_2 651+50 TypeL_3 665+00 689+50 TypeL_4 TypeL_5 707+00 TypeL_8 766+60 TypeL_9 771+60 TypeL_10 786+00 797+50 TypeL_11 TypeL_12 808+60 TypeL_13 835+00 858+70 TypeL_14 864+80 TypeL_15 823+50


SAN JOSE TO CVY EIR/S: VOLUME III **GENERAL INFORMATION BOOK SHEET 52 OF 64**


CALIFORNIA HIGH-SPEED TRAIN PROJECT **SAN JOSE TO MERCED**


GENERAL WILDLIFE CROSSING TABLES SHEET 3 OF 3


CONTRACT NO. HSR15-34
DRAWING NO. GE-CO012
scale NONE
SHEET NO.

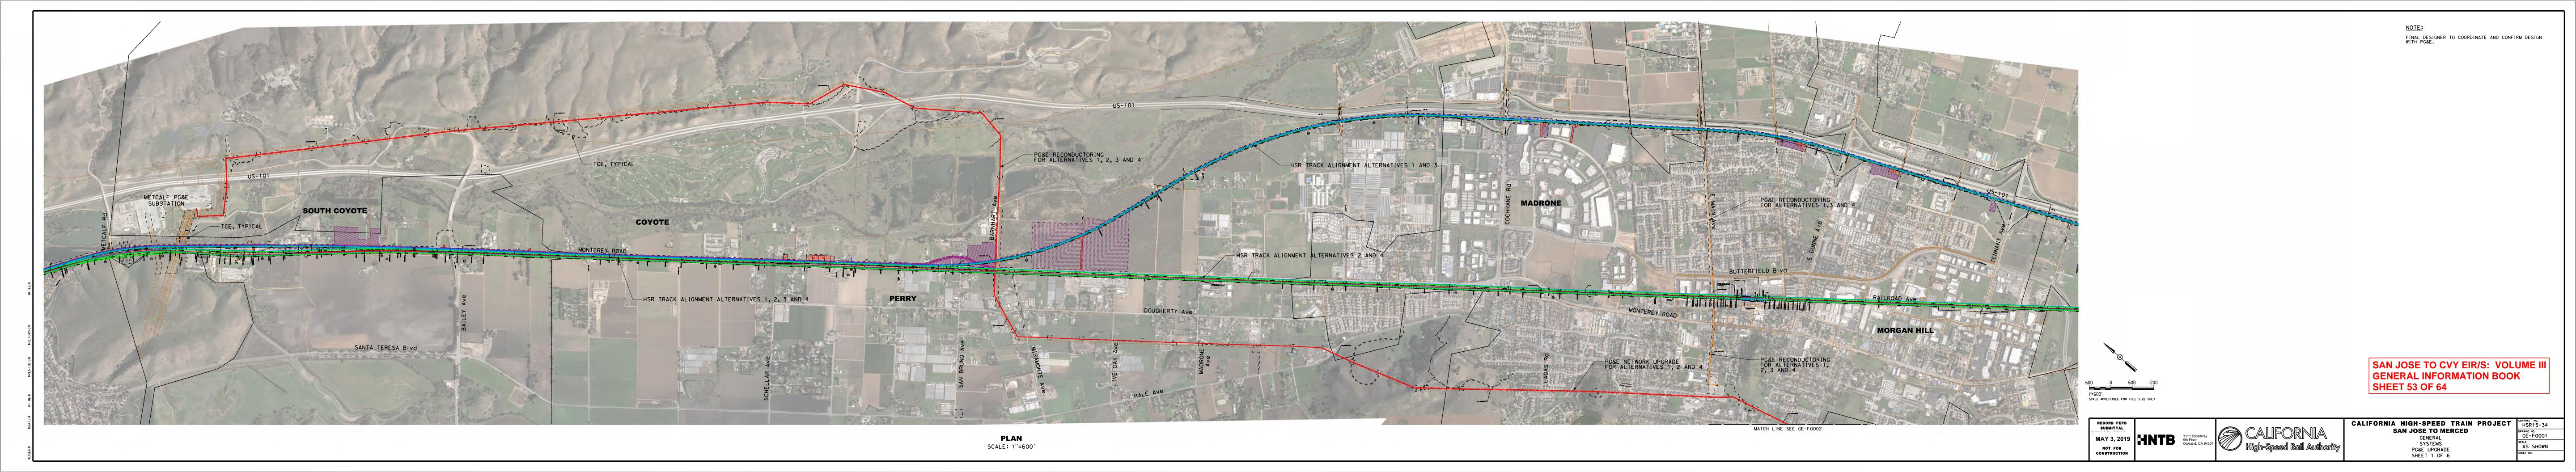


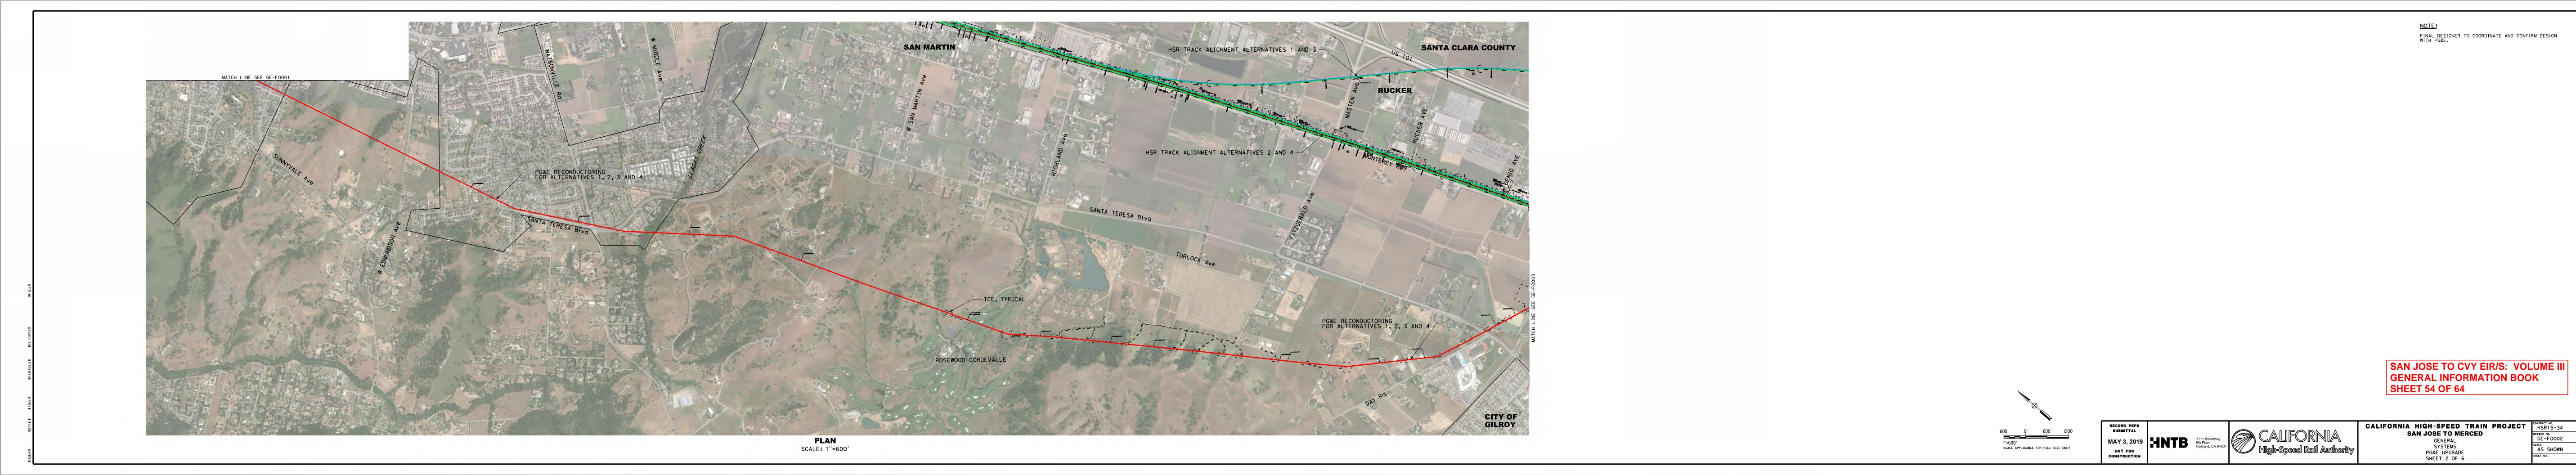


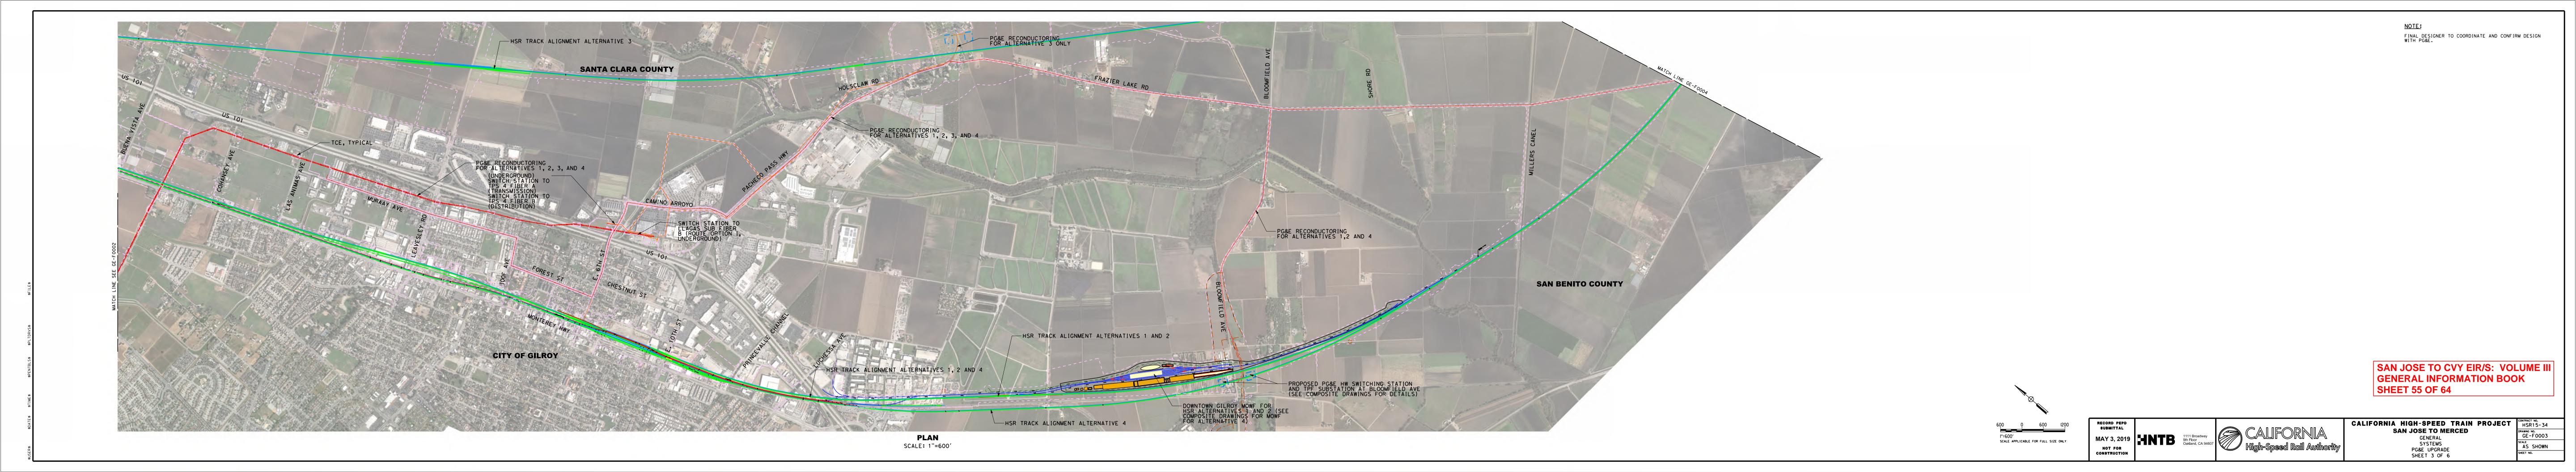

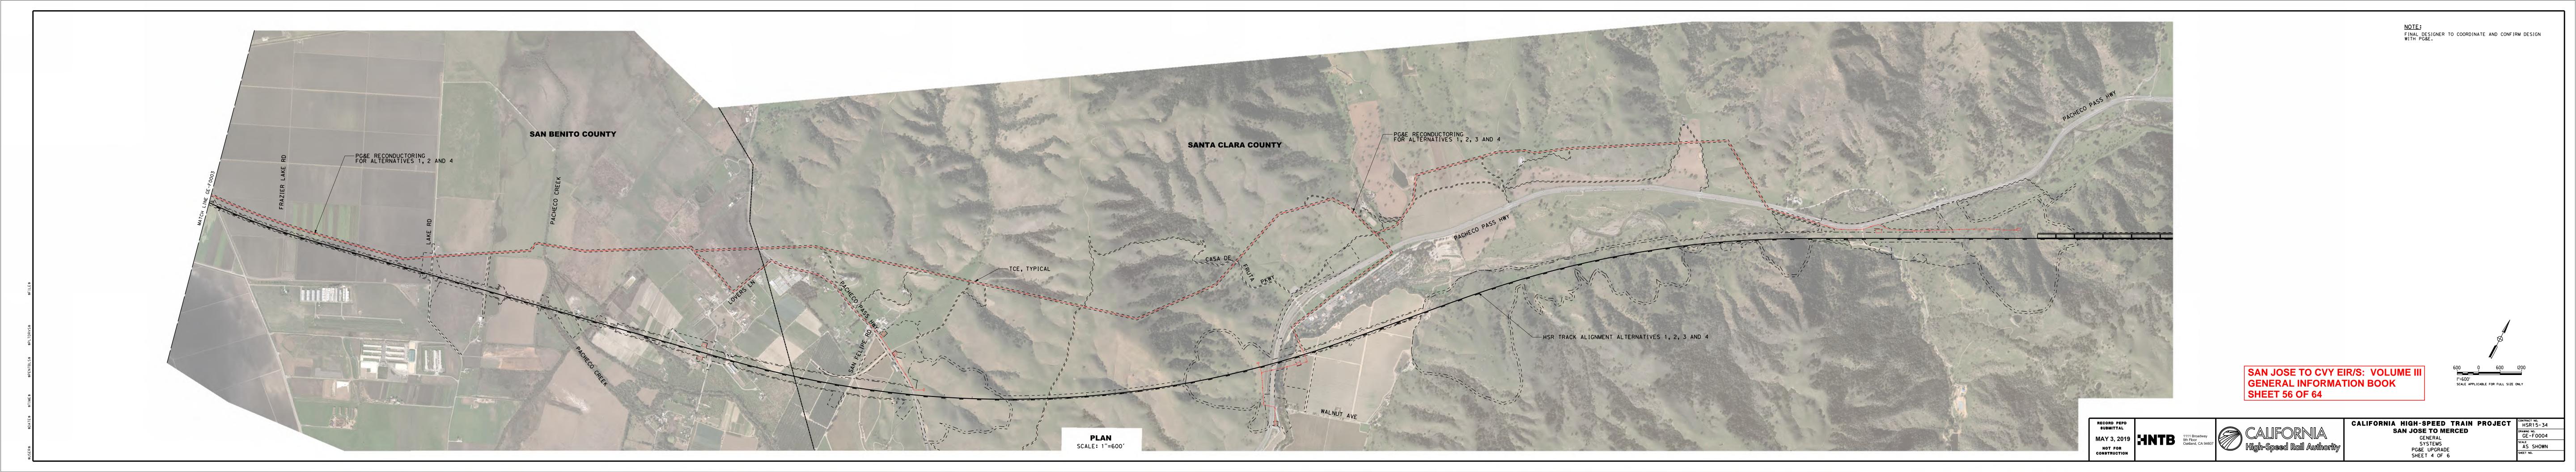

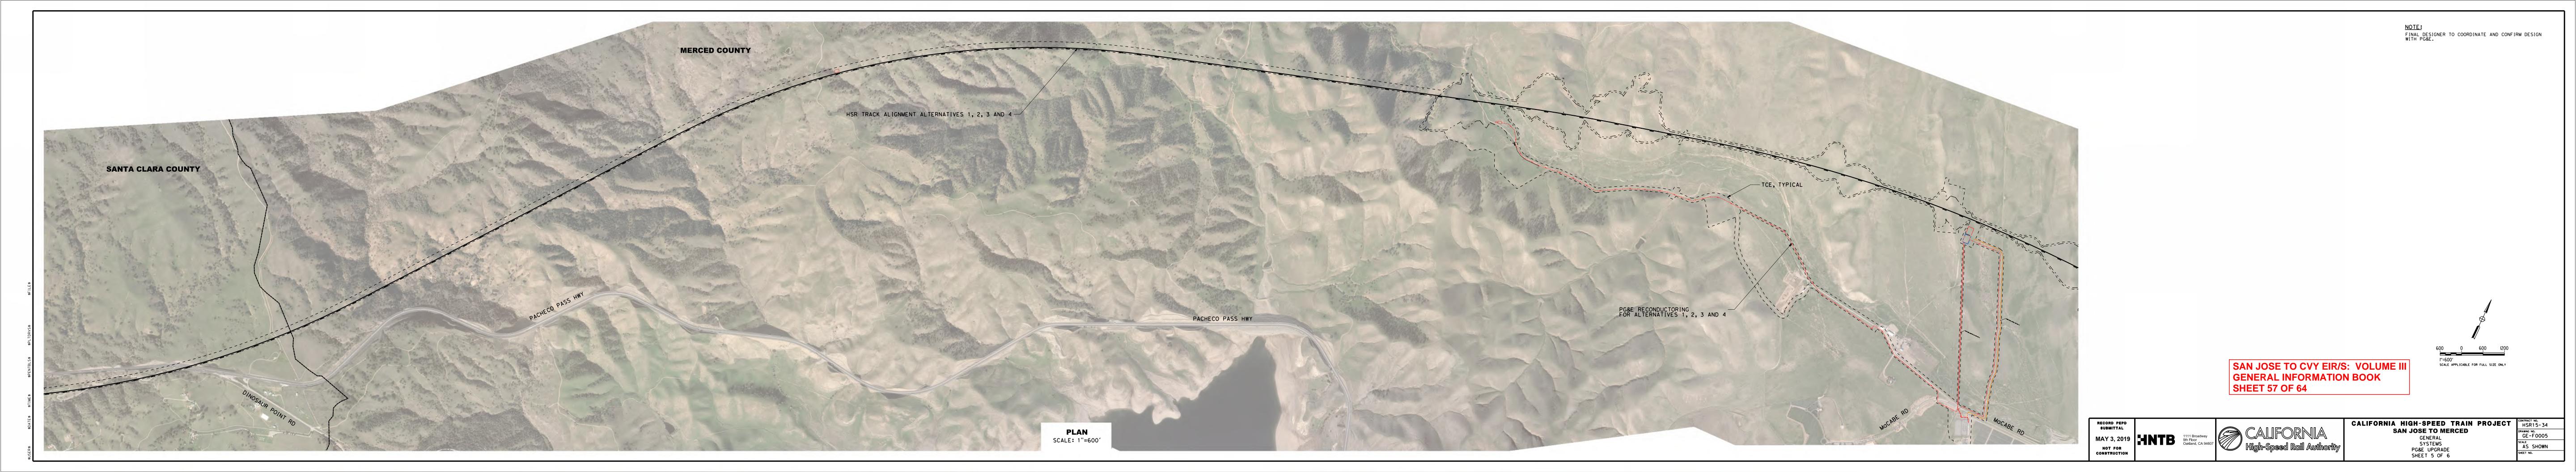

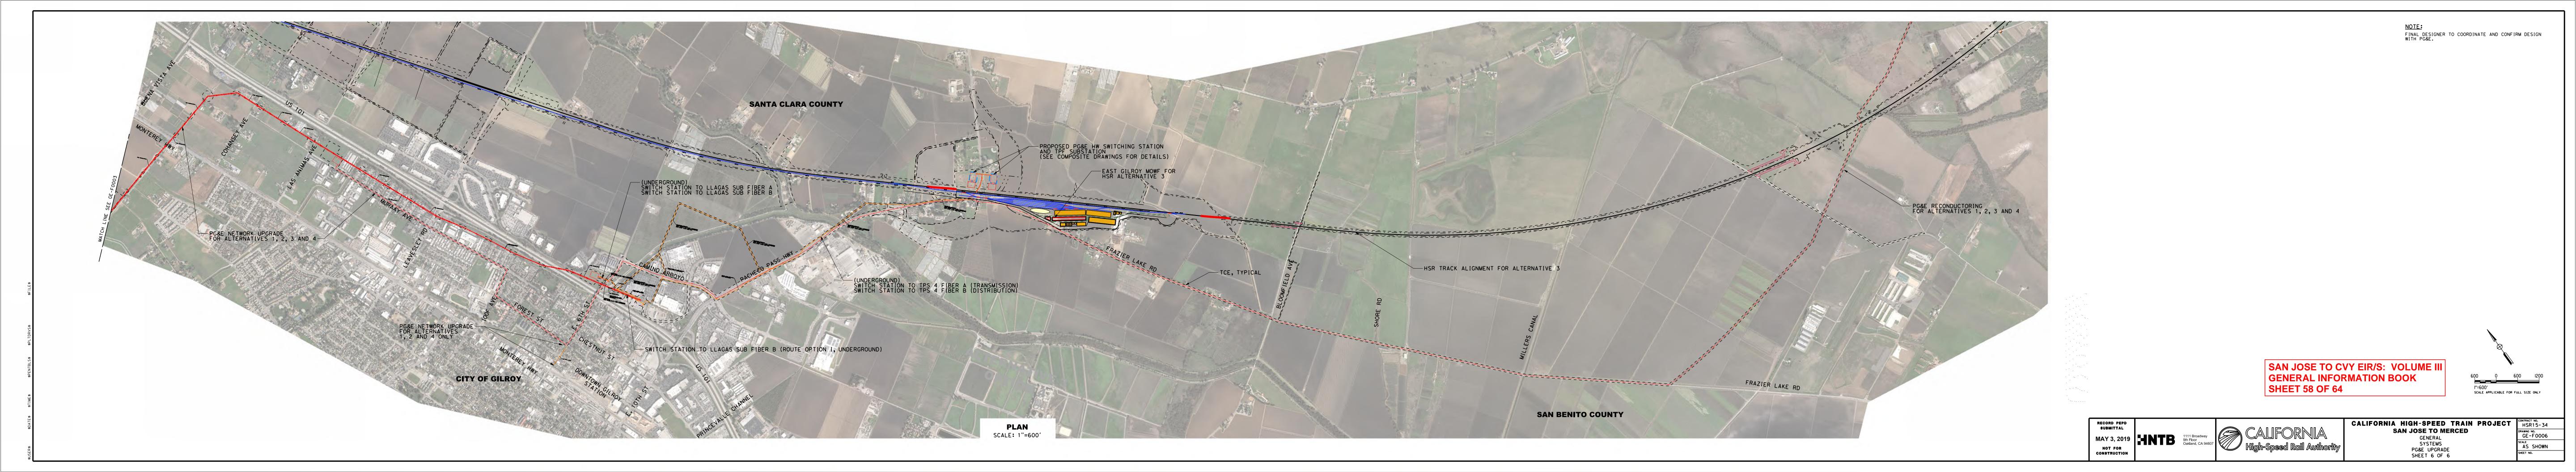

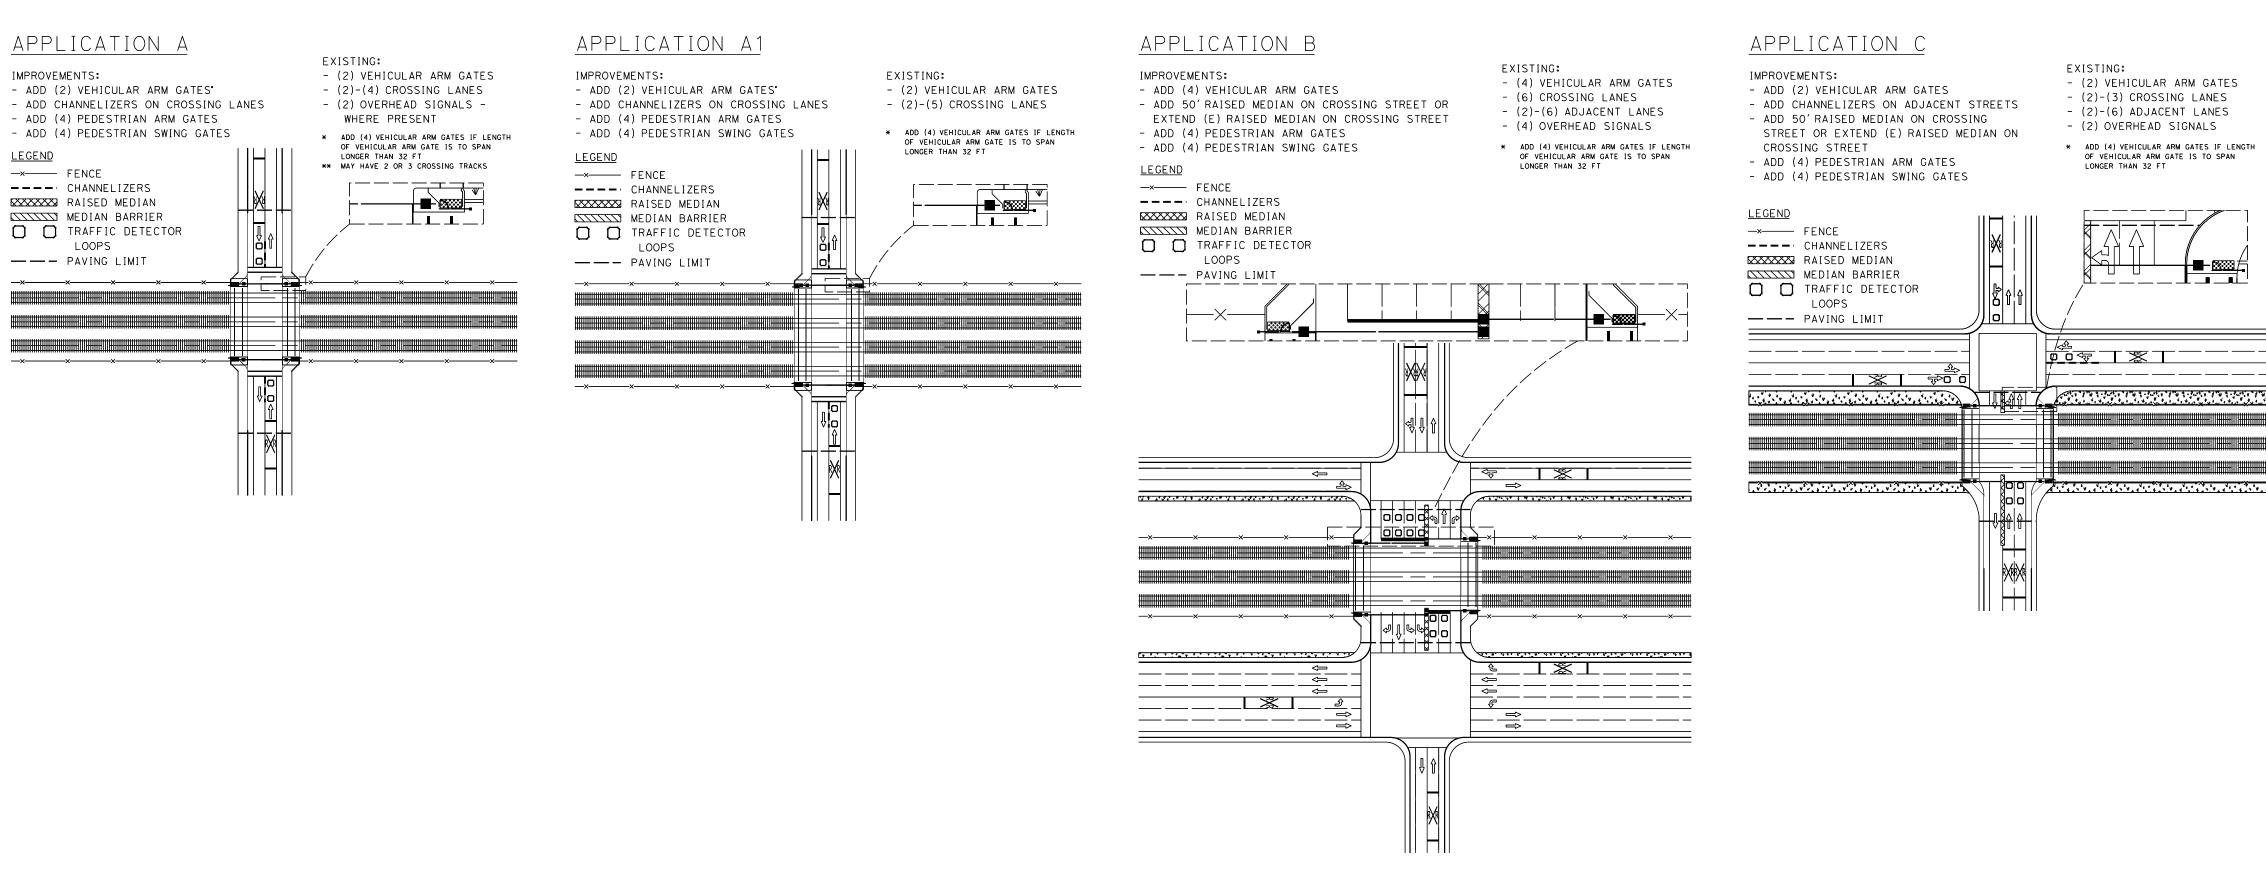

<u>application</u> c

LOOPS

IMPROVEMENTS:

- (2) VEHICULAR ARM GATES - ADD (2) VEHICULAR ARM GATES - (2)-(3) CROSSING LANES - ADD CHANNELIZERS ON ADJACENT STREETS - (2)-(6) ADJACENT LANES - ADD 50'RAISED MEDIAN ON CROSSING STREET OR EXTEND (E) RAISED MEDIAN ON

- (2) OVERHEAD SIGNALS * ADD (4) VEHICULAR ARM GATES IF LENGTH OF VEHICULAR ARM GATE IS TO SPAN LONGER THAN 32 FT

STREET OR EXTEND (E) RAISED MEDIAN ON CROSSING STREET - ADD (4) PEDESTRIAN ARM GATES - ADD (4) PEDESTRIAN SWING GATES

> ---- FENCE --- CHANNELIZERS RAISED MEDIAN MEDIAN BARRIER TRAFFIC DETECTOR ── ── PAVING LIMIT

- ADD 50'RAISED MEDIAN ON CROSSING

<u>☆☆☆, ・ 4, ∵~4, 、 4 4, 、 4 4, 、 4 4, 、 4 4, 、 4 4, 、 4 4, 、 4 4, 、 4 4, </u> 1 ↑ ★初八 | ▽ ■

EXISTING:

<u>APPLICATION C1</u> IMPROVEMENTS:

EXISTING: - ADD (2) VEHICULAR ARM GATES - (2) VEHICULAR ARM GATES - ADD CHANNELIZERS ON ADJACENT STREETS - (2)-(7) CROSSING LANES WHERE NO MEDIAN EXISTING - (5)-(8) ADJACENT LANES

> - (4) OVERHEAD SIGNALS * ADD (4) VEHICULAR ARM GATES IF LENGTH OF VEHICULAR ARM GATE IS TO SPAN

<u>LEGEND</u>

— — — PAVING LIMIT

..... <u>《笔字表》,《《表》,《《表》,《《表》,《表》,《表》,《表》,《表》(集》)。《表》,《表》,《表》,《表》,《表》,《表》,《表》,《表》,《表》,《表</u>

<u>APPLICATION C2</u>

IMPROVEMENTS:

EXISTING: - (2) VEHICULAR ARM GATES - ADD (2) VEHICULAR ARM GATES - (2)-(3) CROSSING LANES - ADD CHANNELIZERS ON ADJACENT STREETS

- (2)-(6) ADJACENT LANES WHERE NO MEDIAN EXISTING - (2)-(3) OVERHEAD SIGNALS -ADD 50' RAISED MEDIAN ON CROSSING WHERE PRESENT

STREET OR EXTEND (E) RAISED MEDIAN ON * ADD (4) VEHICULAR ARM GATES IF LENGT OF VEHICULAR ARM GATE IS TO SPAN CROSSING STREET - ADD (4) PEDESTRIAN ARM GATES

- ADD (4) PEDESTRIAN SWING GATES - TRAFFIC SIGNALS TO BE ADDED WHERE NOT

—×----- FFNCF

--- CHANNELIZERS RAISED MEDIAN MEDIAN BARRIER TRAFFIC DETECTOR

<u>APPLICATION D</u>

- ADD 50' RAISED MEDIAN ON CROSSING STREET OR EXTEND (E) RAISED MEDIAN ON CROSSING

- ADD (4) PEDESTRIAN ARM GATES

- ADD (4) PEDESTRIAN SWING GATES ADD (2) PEDESTRIAN BARRIER

* ADD (4) VEHICULAR ARM GATES IF LENGTH OF VEHICULAR ARM GATE IS TO SPAN LONGER THAN 32 FT

----- FENCE

- ADD 50' RAISED MEDIAN ON CROSSING STREET

OR EXTEND (E) RAISED MEDIAN ON CROSSING

--- CHANNELIZERS RAISED MEDIAN

LOOPS ── ── PAVING LIMIT

LOOPS ── ── ── PAVING LIMIT PEDESTRIAN BARRIER

______ ______

<u>LEGEND</u>

—×—— FENCE

--- CHANNELIZERS

RAISED MEDIAN

MEDIAN BARRIER

TRAFFIC DETECTOR

IMPROVEMENTS: - ADD (4) VEHICULAR ARM GATES

 (4) VEHICULAR ARM GATES (4) CROSSING LANES - (7)-(8) ADJACENT LANES - (4) OVERHEAD SIGNALS

- ADD (4) PEDESTRIAN ARM GATES

- ADD (4) PEDESTRIAN SWING GATES ADD (1) PEDESTRIAN BARRIER

- (4) OVERHEAD SIGNALS

* ADD (4) VEHICULAR ARM GATES IF LENGTH OF VEHICULAR ARM GATE IS TO SPAN LONGER THAN 32 FT

- (4) VEHICULAR ARM GATES

- (4) CROSSING LANES

- (7) ADJACENT LANES

STEEL PEDESTRIAN BARRIER WITH

NO PED CROSSING SIGN (R9-3A) -

MEDIAN BARRIER TRAFFIC DETECTOR

GENERAL INFORMATION BOOK

SHEET 59 OF 64

<u>APPLICATION D1</u>

- ADD (3) VEHICULAR ARM GATES

IMPROVEMENTS:

STEEL PEDESTRIAN BARRIER WITH

, NO PED CROSSING SIGN (R9-3A)


PEDESTRIAN BARRIER ______ _____ _______

ROAD CLOSURE <u>APPLICATION</u>

1. TYPE III BARRICADES (A73C) WITH RED AND WHITE

RETROREFLECTIVE STRIPES. 2. TYPE 4 OBJECT MARKERS (OM4-2).

3. ADVANCE WARNING SIGNS MUST BE INSTALLED IN CONFORMANCE WITH CAMUTCD.

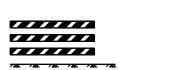

CONSTRUCTION MATERIALS AND SUPPORTS AS SPECIFIED IN THE SPECIFICATIONS.

NOTES AND ASSUMPTIONS:

Station Grade Crossing No. of Lanes Tracks Street ROW Median Proximity of Proximity of Street City. Vehicle Ped Tracks Max Fill Median Sidewalk New Footprint Intrusion Raise Add'l Appli- Crossing Adjacent TOR Install N

1. ALL EXISTING STREET WIDTHS, MEASURED FROM GOOGLE EARTH, ARE EITHER EP OR CURB-TO-CURB MEASUREMENTS

2. RIGHT OF WAY WIDTH MEASURED FROM "SANTACLARA PARCELS OWNERSHIP_WITHIN500FT_SHP.DWG" CAD FILE.

3. DAYLIGHT WIDTH IS THE TOTAL WIDTH OF IMPROVEMENTS INCLUDING MEDIAN, STREET LANES CURB TO CURB, 10-12' SIDEWALKS, 2' BUFFER, 2:1 SLOPE TO EXISTING GRADE, 2' BUFFER.

4. PAVING LIMITS SHOWN ARE APPROXIMATE. ACTUAL PAVING LIMITS WILL DEPEND ON FINISH GRADE PROFILES.

5. ALL CROSSING GATE EQUIPMENT SHALL BE MINIMUM 10' CLEAR OF


6. THE DETAILS PROVIDED INDICATE TYPICAL APPLICATIONS, NOT A DESIGN CRITERIA. IF SPECIFIC SITE CONDITIONS PRECLUDE USE OF A DETAIL, ADDITIONAL MEASURE MAY BE DEEMED NECESSARY FOR SAFE OPERATION.


ONLY FACE OF RAILS SHOWN. BARRICADE

SAN JOSE TO CVY EIR/S: VOLUME III SUBMITTAL MAY 3, 2019 **HNTB**



CALIFORNIA HIGH-SPEED TRAIN PROJECT CONTRACT NO. HSR15-34 SAN JOSE TO MERCED SEGMENT SCHEDULE OF QUAD GATES

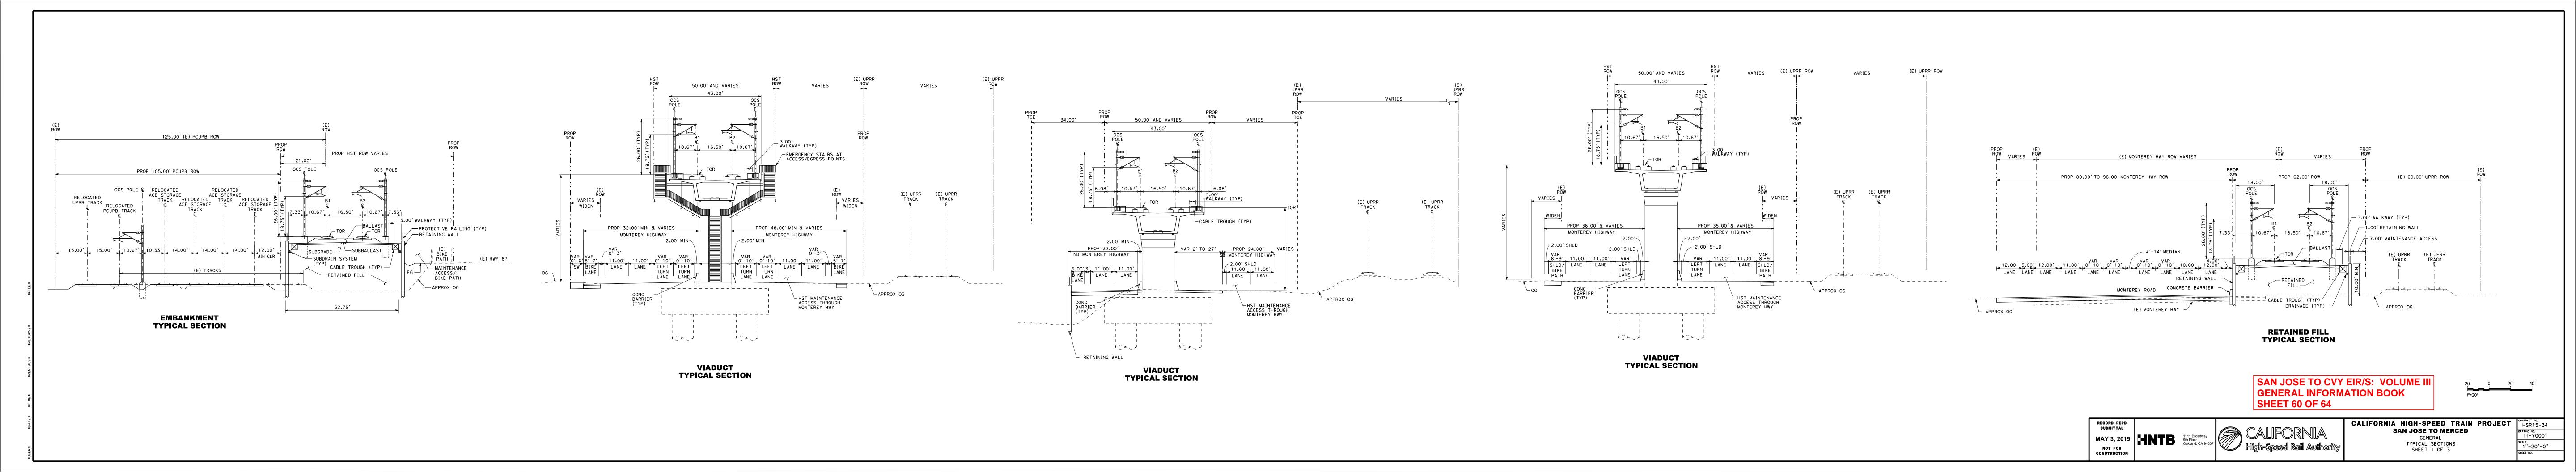

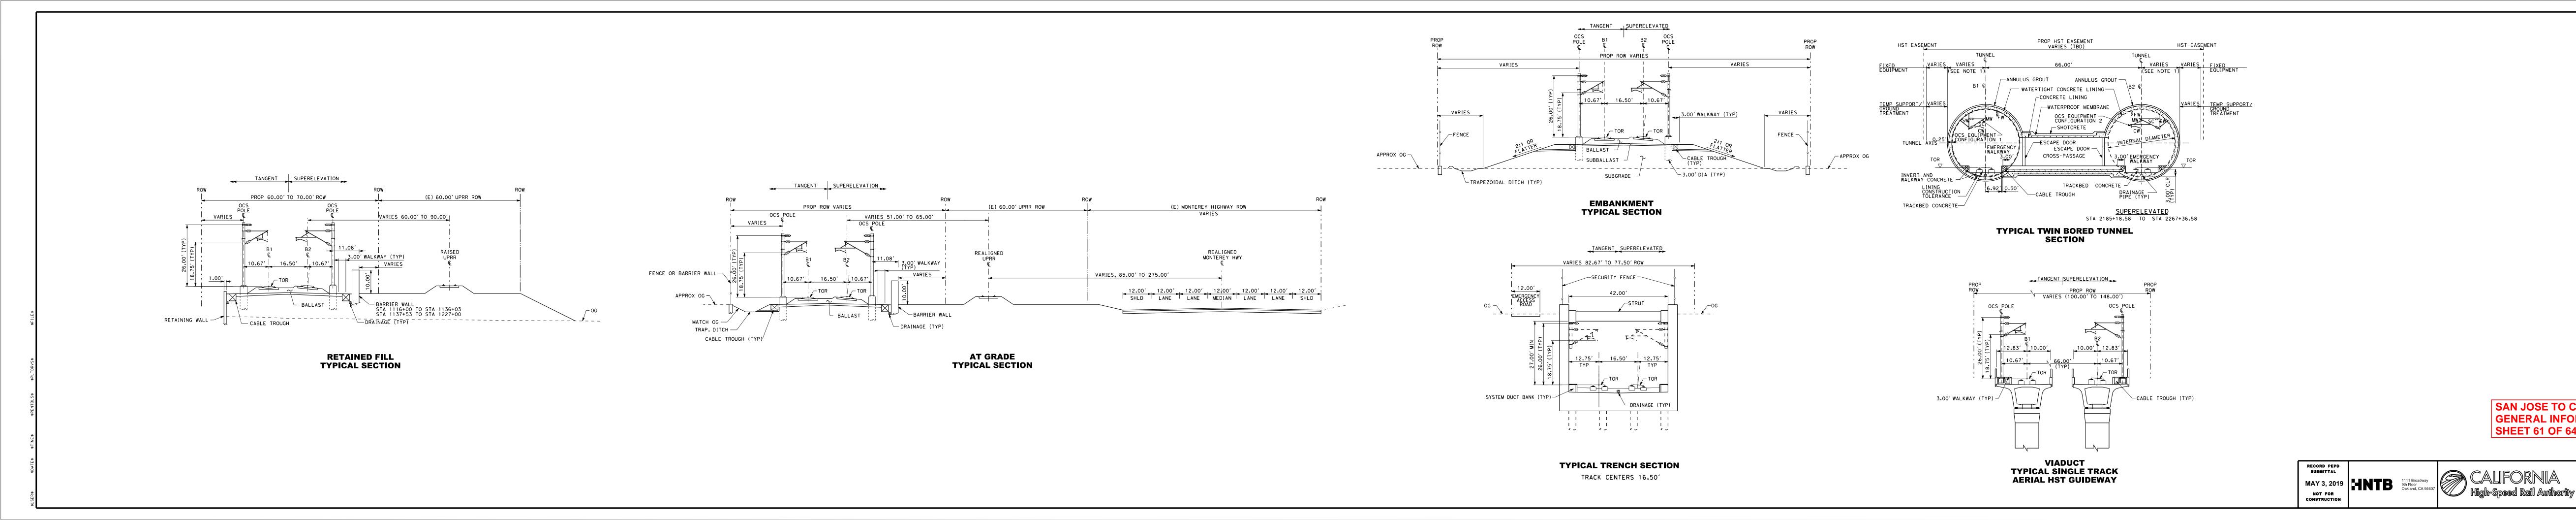

SAN JOSE TO CVY EIR/S: VOLUME III GENERAL INFORMATION BOOK


SHEET 61 OF 64

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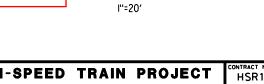
CALIFORNIA HIGH-SPEED TRAIN PROJECT
SAN JOSE TO MERCED

CONTRACT NO.
HSR15DRAWING NO.

GENERAL TYPICAL SECTIONS SHEET 2 OF 3

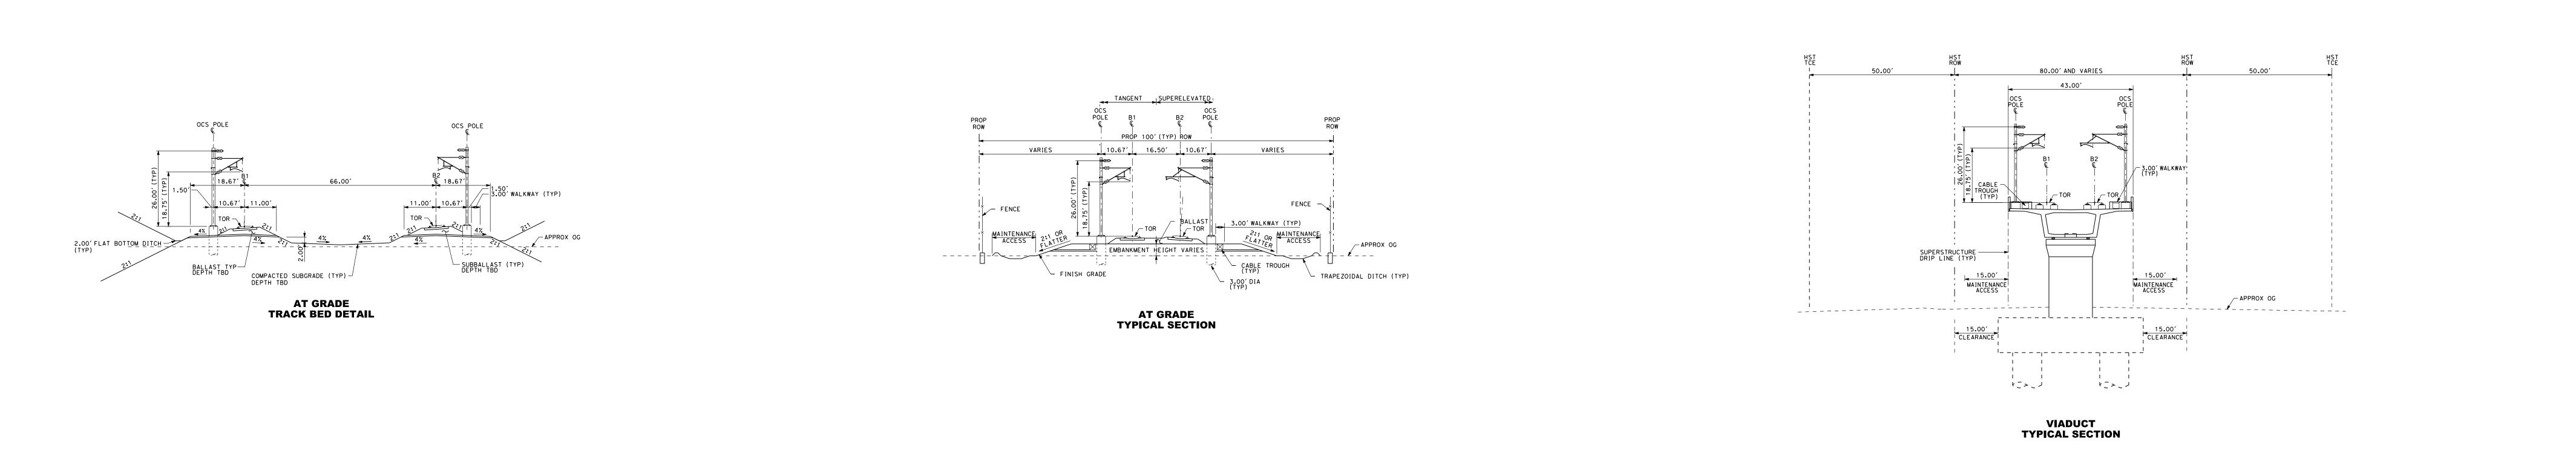



SAN JOSE TO CVY EIR/S: VOLUME III GENERAL INFORMATION BOOK **SHEET 62 OF 64**




CALIFORNIA HIGH-SPEED TRAIN PROJECT
SAN JOSE TO MERCED

GENERAL
TYPICAL SECTIONS
SHEET 3 OF 3

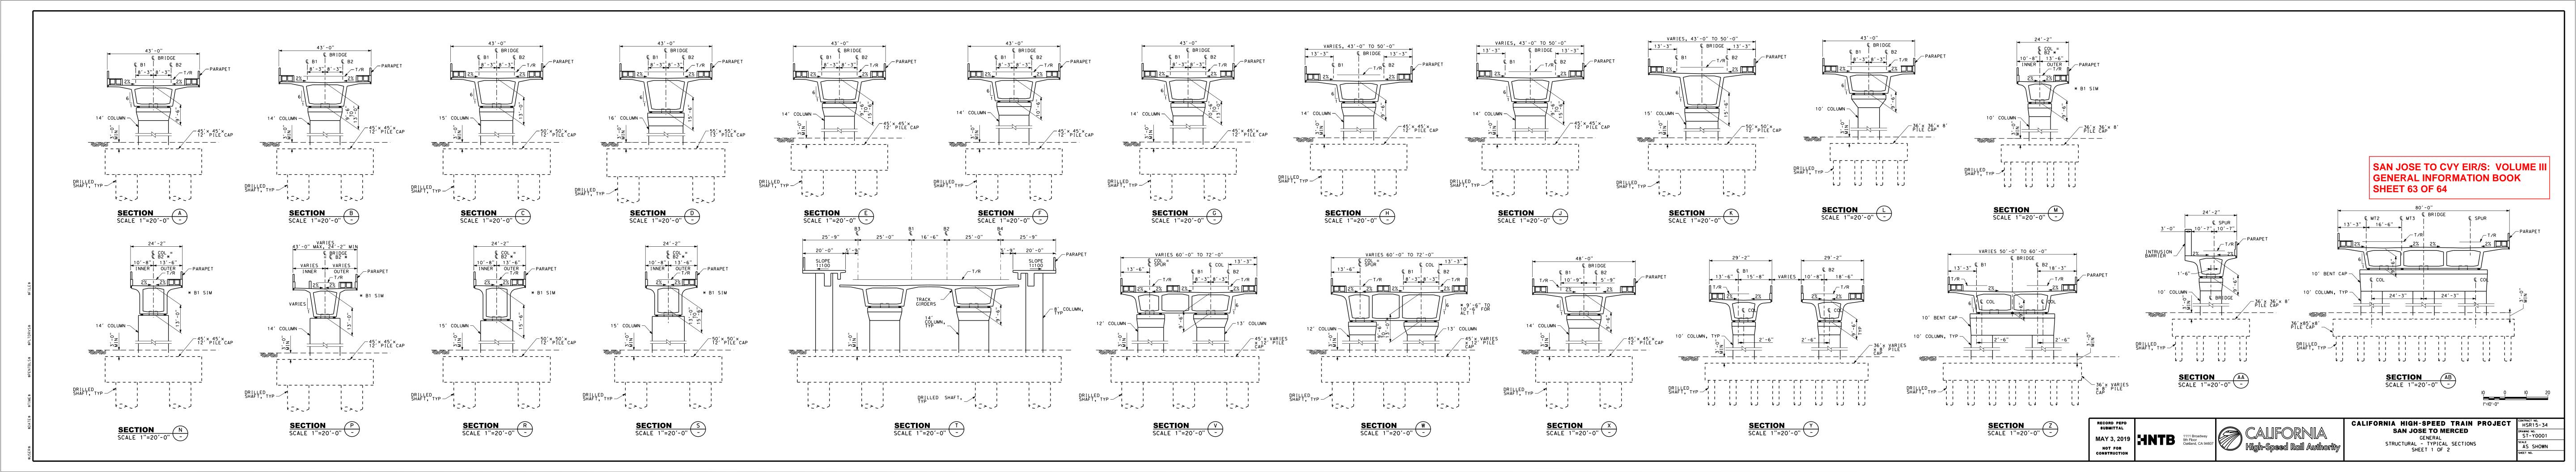


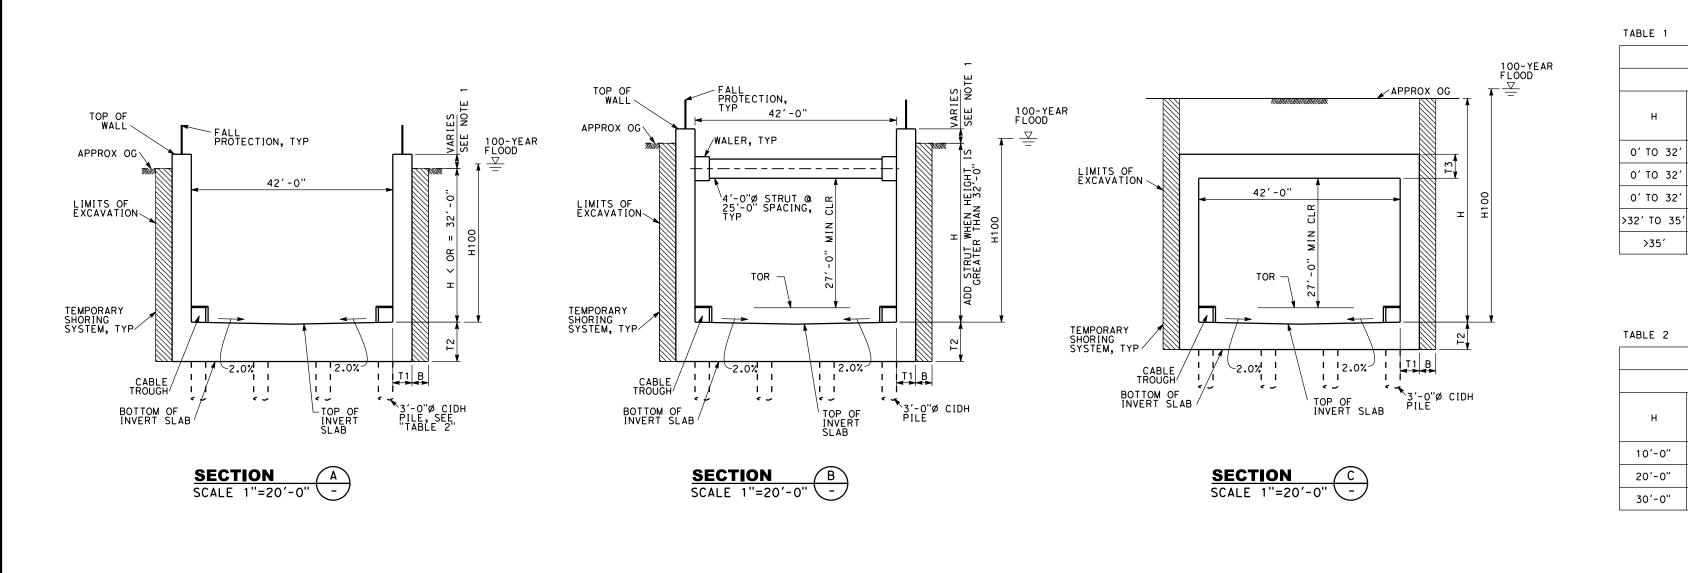

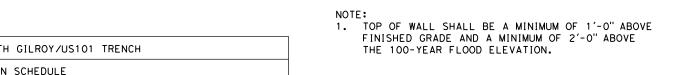


		ALT 1 AND	ALT 2 SC	OUTH GILRO	OY/US101	TRENCH		
			DIMENS	ION SCHE	DULE			
Н	Н100		B NO. OF STRUTS	Т1	Т2	T3, AS APPLICABLE	3'-0" CIDH PILES	
		В					NO. OF ROWS	LONG. SPACING
TO 32'	10'-0"	4'-0"	N/A	3'-0"	4'-0"	N/A	N/A	N/A
TO 32'	15'-0"	4'-0"	N/A	4'-0"	6'-0"	N/A	N/A	N/A
TO 32'	30'-0"	4'-0"	N/A	4'-0"	5′-0"	N/A	4	12'-6"
TO 35'	35'-0"	4'-0"	1	4'-0"	5′-0"	5'-0"	4	12'-6"
×35′	45'-0"	6'-0"	1	4'-0"	5′-0"	5′-0"	4	12'-6"

		ALT 2 SOL	JTH SAN JO	OSE/CAPIT	OL EXPRES	SWAY TRENCH		
			DIMENS	SION SCHE	DULE			
Н	н100		NO. OF T1 T2	T1 T2	T7 AC	3'-0" C	IDH PILES	
		В			Т2	T3, AS APPLICABLE	NO. OF ROWS	LONG. SPACING
10'-0"	N/A	4'-0"	N/A	1′-6"	2'-0"	N/A	N/A	N/A
20'-0"	N/A	4'-0"	N/A	3′-0"	4'-0"	N/A	N/A	N/A
30'-0"	N/A	4'-0"	N/A	4'-0"	5′-0"	N/A	N/A	N/A

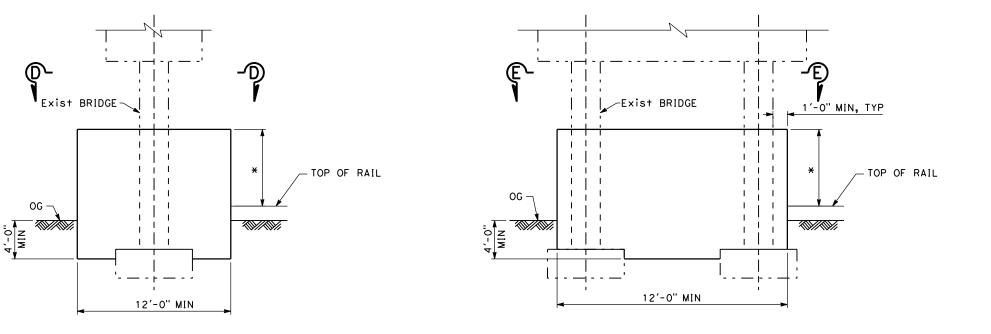

SINGLE COLUMN

MULTI - COLUMN

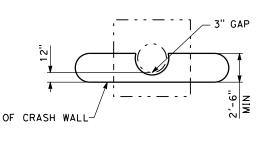

SECTION D

SECTION E

* 6'-0" MINIMUM FOR PIERS FROM 12 FT TO 25 FT CLEAR FROM THE CENTERLINE OF EXISTING OR PROPOSED TRACK. 12'-0" MINIMUM FOR PIERS LESS THAN 12 FT CLEAR FROM THE CENTERLINE OF EXISTING OR PROPOSED TRACK.

CRASH WALL DETAILS
SCALE NTS

SAN JOSE TO CVY EIR/S: VOLUME III GENERAL INFORMATION BOOK **SHEET 64 OF 64**



CALIFORNIA HIGH-SPEED TRAIN PROJECT
SAN JOSE TO MERCED
GENERAL
STRUCTURAL - TYPICAL SECTIONS
SHEET 2 OF 2

CONTRACT NO.
HSR15-34
DRAWING NO.
ST-Y0002
SCALE
AS SHOWN
SHEET NO.

1°=10'-0"